Agenda 10-23-2025

# Town of Pittsford Design Review & Historic Preservation Board AGENDA October 23, 2025

This agenda is subject to change.

Please take notice that the Town of Pittsford Design Review & Historic Preservation Board will hold the following meeting on October 23, 2025, in the Lower-Level Meeting Room of Pittsford Town Hall, 11 S. Main Street, and beginning at 6:00PM local time.

#### HISTORIC PRESERVATION DISCUSSION

### **RESIDENTIAL APPLICATIONS: RENOVATIONS & ADDITIONS**

#### 22 Charter Oaks Drive

Applicant is requesting design review of a 704 square foot addition to the existing garage.

## 246 Long Meadow Circle

Applicant is requesting design change to a previously approved, 1,200-square-foot, two-story, attached garage on the side of the home.

## 90 Stoneleigh Court

Applicant is requesting design review of a 672 square foot attached 2 car garage addition.

## 4048 East Avenue

Applicant is requesting design review of a 647 square foot detached 2 bay single story garage.

#### 21 Barrington Hills

Applicant is requesting design review for an approximately 103 square foot addition to existing home.

### **6 Ryder Cup Circle**

Applicant is requesting design review for a 48 square foot addition to front of existing home.

## **RESIDENTIAL APPLICATIONS: NEW HOMES**

## 526 Mendon Road

Applicant is requesting design review for the construction of a one-story single-family home approximately 12,231 square feet. This property is zoned Residential Neighborhood (RN).

### **33 Sutton Point**

Applicant is requesting design review for the construction of a one-story single-family home approximately 3700 square feet. This property is zoned Residential Neighborhood (RN).

Agenda 10-23-2025

## **DEMOLITION APPLICATIONS:**

## 71 Knollwood Drive

Applicant is requesting Board approval to demolish the existing 3,420-square-foot, two-story, single-family home, with the intent to build a 6,510-square-foot, two-story, single-family home (with finished basement) on the property. This property is zoned Residential Neighborhood (RN).

The next meeting is scheduled for Thursday, November 13, 2025, at 6PM.

#### **DRAFT MINUTES 100925**

# DESIGN REVIEW & HISTORIC PRESERVATION BOARD MINUTES OCTOBER 09, 2025

Minutes of the Town of Pittsford Design Review and Historic Preservation Board meeting held on Thursday, October 09, 2025, at 6:00 PM local time. The meeting took place in the Lower-Level Meeting Room of Pittsford Town Hall, 11 S. Main Street.

PRESENT: Paul Whitbeck, Kathleen Cristman, Jim Vekasy, Bonnie Salem

ABSENT: Dirk Schneider, Dave Wigg, John Mitchell

ALSO PRESENT: Anthony Caruso, Fire Marshal; Anna Piazza, Building Department Assistant; Robert Koegel,

Town Attorney; Cathy Koshykar, Town Board Liaison

**ATTENDANCE**: There were 7 members of the public present.

Design Review and Historic Preservation Board (DRHPB) Member Jim Vekasy called the meeting to order at 6:00PM.

### HISTORIC PRESERVATION DISCUSSION

Board Member Salem stated that there were no updates to discuss.

## **RESIDENTIAL APPLICATIONS: RENOVATIONS & ADDITIONS**

#### 18 Old Lyme Road

Applicant is returning to request design review for a 240 square-foot garage addition to the side of the home.

Jim Pippin, of 18 Old Lyme Road, introduced the application. Mr. Pippin is requesting design review for a 240 square-foot garage addition to the side of the home. He stated that the project came before the Board last year and explained that he is back with a revised application. Mr. Pippin is proposing to bump out the existing garage 8 feet. He clarified that he is proposing the project without the dormers and second floor as seen on the rendering presented. All finishes and materials will match the existing garage.

Board Member Cristman motioned to approve the application for a 240 square-foot garage addition to the side of the home without the dormers and second story as seen on the rendering presented. This motion was seconded by Board Member Whitbeck. Following a unanimous voice vote, the application was approved, none opposed.

## 15 Rockdale Meadows

Applicant is requesting design review to convert an existing rear deck into an enclosed porch.

Jim Brasley, Architect, introduced the application. Mr. Brasley is requesting design review to convert an existing rear deck into an enclosed porch. He explained that the existing deck structure will remain and that he will add new posts and beams. Mr. Brasley stated that the color and trim will match the existing home and noted that the gable end will have a shake-style vinyl siding.

#### **DRAFT MINUTES 100925**

Board Member Vekasy motioned to approve the application to convert an existing rear deck into an enclosed porch, as submitted. This motion was seconded by Board Member Salem. Following a unanimous voice vote, the application was approved, none opposed.

#### 4044A East Avenue

Applicant is requesting design review to construct a 322 square-foot second floor addition.

Justin Hamilton, of 4044A East Avenue and Hamilton Stern Construction, introduced the application. Mr. Hamilton is requesting design review to construct a 322 square-foot second floor addition. The addition will have two open gables along with the windows, and the eave line will line up with the existing eave on the home. The bathroom window will be changed from a double casement to a single casement window and the gable will have glass on the front and back so that you are able to see through it.

Board Member Whitbeck motioned to approve the application for a 322 square-foot second floor addition, as submitted. This motion was seconded by Board Member Vekasy. Following a unanimous voice vote, the application was approved, none opposed.

#### **RESIDENTIAL APPLICATIONS: NEW HOMES**

## **68 Coventry Ridge**

Applicant is requesting design review for the construction of a two-story single-family home approximately 3,613 square-feet that is located in the Coventry Ridge Subdivision.

Chris Pagan, of Spall Homes/Spall Realtors Corp, introduced the application. Mr. Pagan is requesting design review for the construction of a two-story single-family home approximately 3,613 square-feet that is located in the Coventry Ridge Subdivision. He stated that this will be the final home on Coventry Ridge. Mr. Pagan also clarified that a deck is not being proposed with the home.

Board Member Salem motioned to approve the application for the construction of a two-story single family new home approximately 3,613 square-feet that is located in the Coventry Ridge Subdivision, as submitted. This motion was seconded by Board Member Cristman. Following a unanimous voice vote, the application was approved, none opposed.

### 33 Sutton Point

Applicant is requesting design review for the construction of a one-story single-family home approximately 3,700 square-feet.

Shawna and Michael Hayes, of 33 Sutton Point, introduced the application. Mr. Hayes is requesting design review for the construction of a one-story single-family home approximately 3,700 square-feet. Mr. Hayes discussed recently buying the home after the original home was damaged in a fire in July 2023. The home was brought down to the first level after the fire. Mr. Hayes plans to remove the siding and reuse the existing garage. Board Member Salem asked the applicant about the dormers on the front elevation and the applicant stated that they are false dormers because there is no second floor. The rendering presented has vertical siding throughout, but Mr. and Mrs. Hayes stated that they would like to do a mix of vertical siding and possibly stone and horizontal siding on the front facade. Board Member Vekasy advised that the stone material either needs to wrap around the corner or get boxed into the trim. Board Member Salem commented that the home will look very different than the rendering presented with the siding ideas that the applicant discussed. Anthony Caruso, Fire Marshal, explained that the Board needs to know exactly where the various types of siding will go on the elevations and asked them to submit revised elevations with their final siding choices. The applicant confirmed that they will come back to the Board with revised final plans.

## **DRAFT MINUTES 100925**

## **MEETING MINUTES REVIEW**

The minutes of September 25, 2025 were approved following a motion by Board Member Salem. This motion was seconded by Board Member Cristman. Following a unanimous voice vote, the minutes were approved, none opposed.


Board Member Vekasy closed the meeting at 6:43PM.

Respectfully submitted,

\_\_\_\_

Anna Piazza Building Department Assistant

OFFICIAL MINUTES ARE ON FILE IN THE OFFICE OF THE BUILDING DEPARTMENT

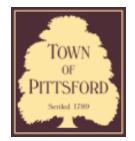

## **Town of Pittsford**

Department of Public Works 11 South Main Street Pittsford, New York 14534

Permit # B25-000089

Phone: 585-248-6250 FAX: 585-248-6262

## DESIGN REVIEW AND HISTORIC PRESERVATION BOARD REFERRAL OF APPLICATION

Property Address: 22 Charter Oaks Drive PITTSFORD, NY 14534

**Tax ID Number:** 178.06-3-51

Zoning District: RN Residential Neighborhood

Owner: Kalb, Adam Christopher

**Applicant:** RX Remodeling and Construction Inc.


App	lica	tion	Type:		
				_	

<b>✓</b>	Residential Design Review	$\Box$	Build to Line Adjustment
<b>Y</b>	§185-205 (B)	$\cup$	§185-17 (B) (2)
	Commercial Design Review	$\overline{}$	Building Height Above 30 Feet
	§185-205 (B)		§185-17 (M)
	Signage	$\overline{}$	Corner Lot Orientation
	§185-205 (C)		§185-17 (K) (3)
	Certificate of Appropriateness	$\overline{}$	Flag Lot Building Line Location
	§185-197		§185-17 (L) (1) (c)
	Landmark Designation	$\overline{}$	Undeveloped Flag Lot Requirements
	§185-195 (2)	$\cup$	§185-17 (L) (2)
	Informal Review		


**Project Description:** Applicant is returning to request design review of a 704 Sq Ft. addition to existing garage.

Meeting Date: October 23, 2025

## RN Residential Neighborhood Zoning

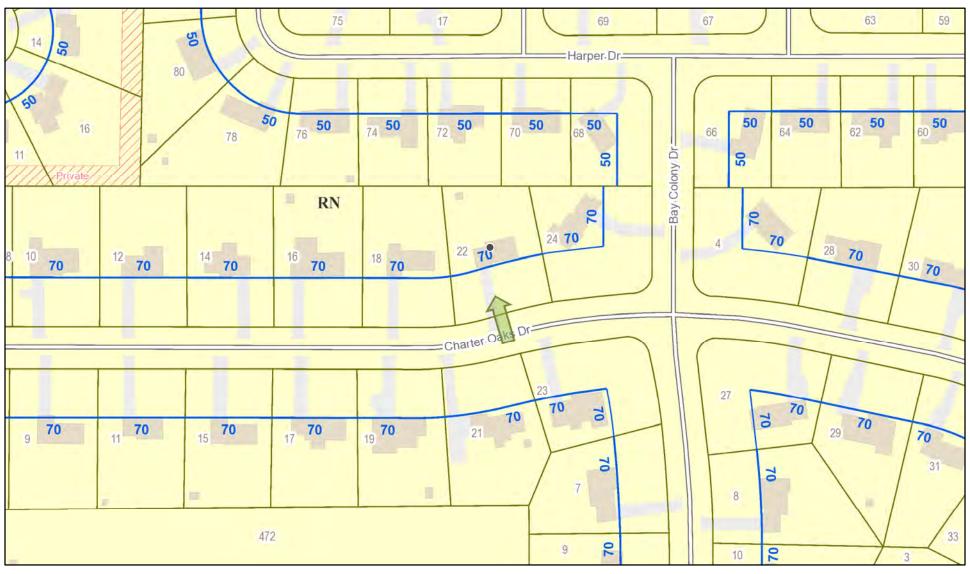



Printed August 18, 2025

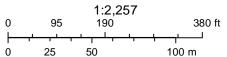

Town of Pittsford GIS

The information depicted on this map is representational and should be used for general reference purposes only. No warranties, expressed or implied, are provided for the data or its use or interpretation.

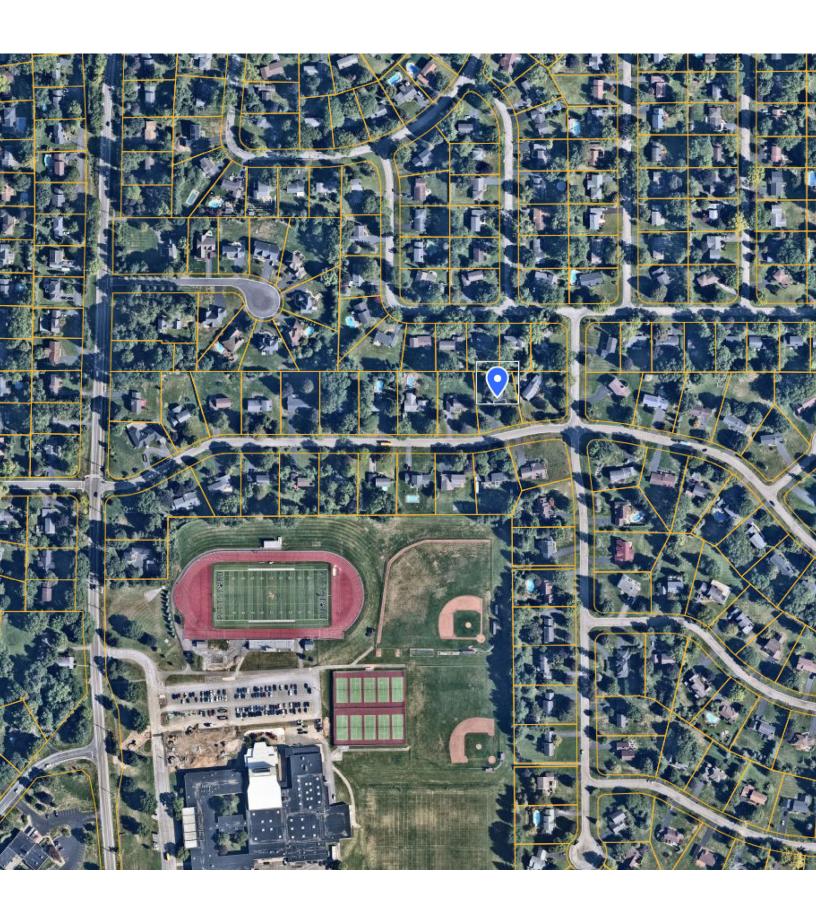

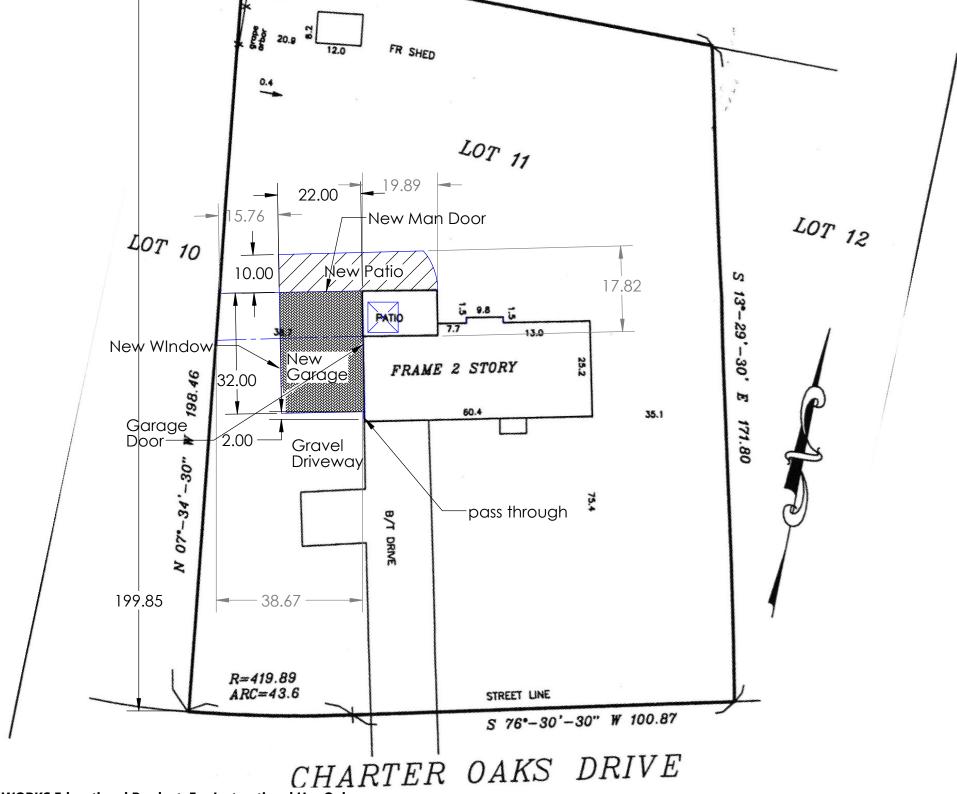

**SOLIDWORKS Educational Product. For Instructional Use Only.** 



22 CHARTER OAKS DRIVE 1/4"=1'-0" (TT)


PROPOSED DOWNSZED EXITING OVERHEAD DOOR AND NEW WINDOW EXISTING GARAGE
OVERHANG AND -INSTALLED SILL HEIGHT TO MATCH FRINT WINDOWS 5/12 5/12 PROPOSED - GARAGE

22 - 0 3068, PEESUN DOUR PASS TREMEN PRO POSED CARAGE 321-011. ATTHCHED ACK 200 16'-0" OHD

> 1/4"=11.0" T





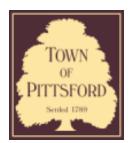

## **Town of Pittsford**

Department of Public Works 11 South Main Street Pittsford, New York 14534

Permit # B24-00078

Phone: 585-248-6250 FAX: 585-248-6262

## DESIGN REVIEW AND HISTORIC PRESERVATION BOARD REFERRAL OF APPLICATION

Property Address: 246 Long Meadow Circle PITTSFORD, NY 14534

**Tax ID Number:** 151.13-1-38

Zoning District: RN Residential Neighborhood

Owner: Sherman, Neal E

**Applicant:** Gaetano Abbate Contacting & Consulting

Ap	plicati	ion T	vpe:
			,


<b>/</b>	Residential Design Review	Build to Line Adjustment
	§185-205 (B)	§185-17 (B) (2)
	Commercial Design Review	Building Height Above 30 Feet
	§185-205 (B)	§185-17 (M)
	Signage	Corner Lot Orientation
	§185-205 (C)	§185-17 (K) (3)
	Certificate of Appropriateness	Flag Lot Building Line Location
	§185-197	§185-17 (L) (1) (c)
	Landmark Designation	Undeveloped Flag Lot Requirements
	§185-195 (2)	§185-17 (L) (2)
	Informal Review	

**Project Description:** Applicant is requesting design changes for a previously approved 1,200-square-foot, two-story, attached garage on the side of the home.

Meeting Date: October 23, 2025




## RN Residential Neighborhood Zoning

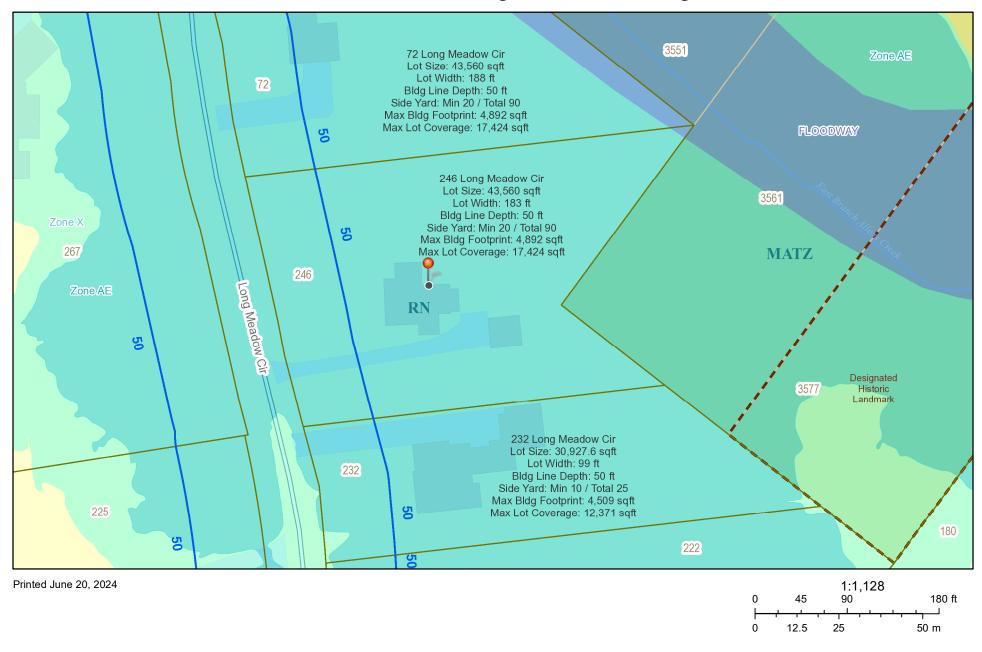

Town of Pittsford GIS




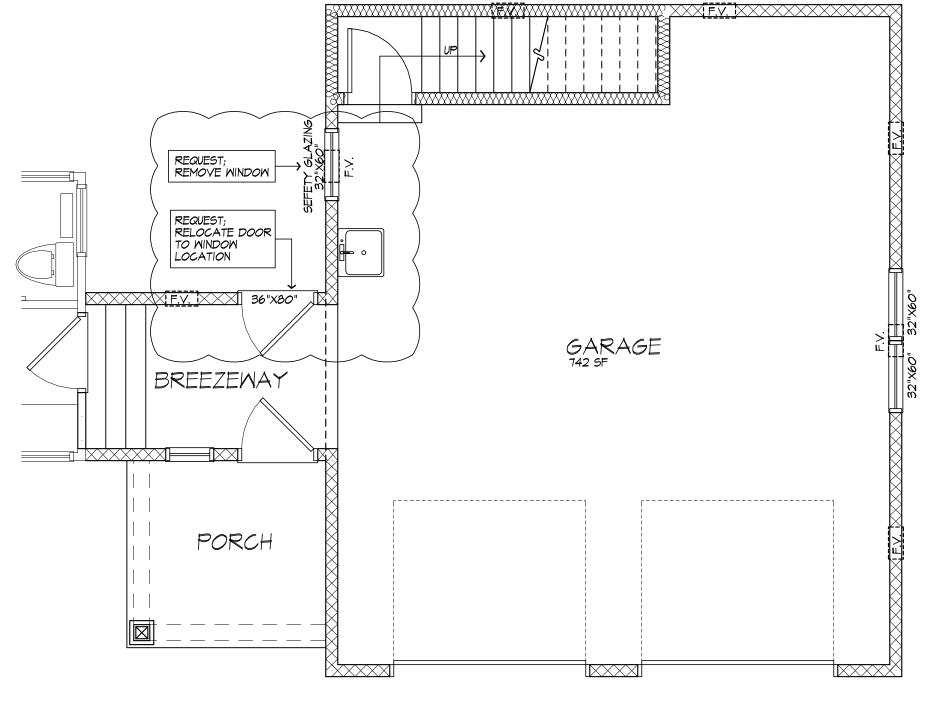


APPROVED DESIGN



APPROVED SIDE ELEVATION

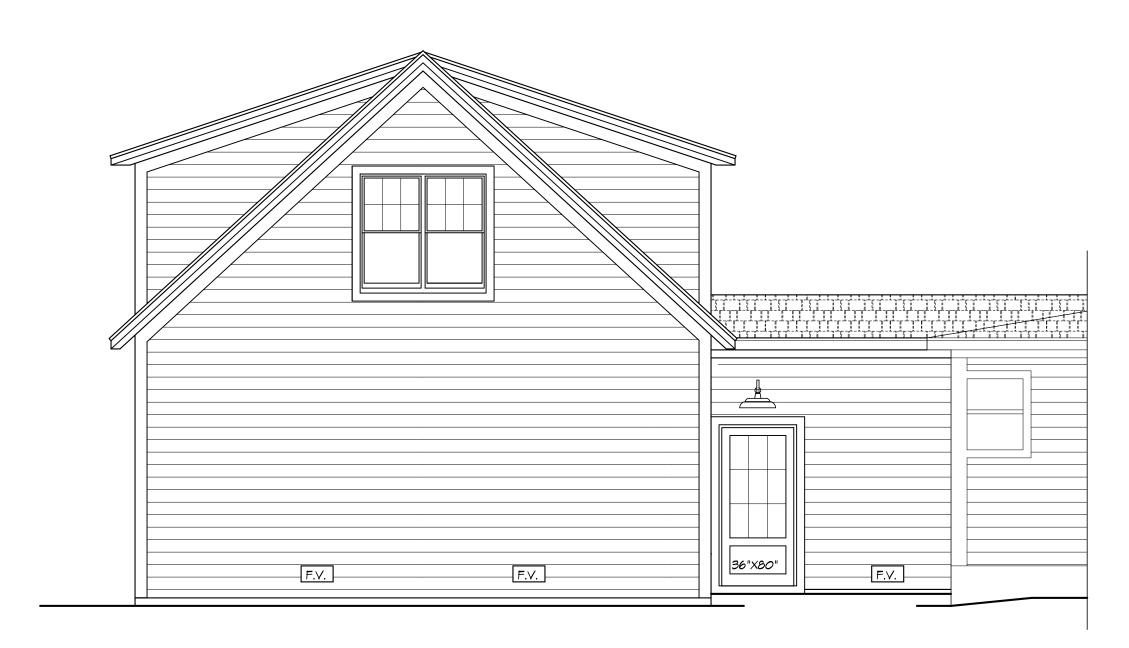


APPROVED REAR ELEVATION

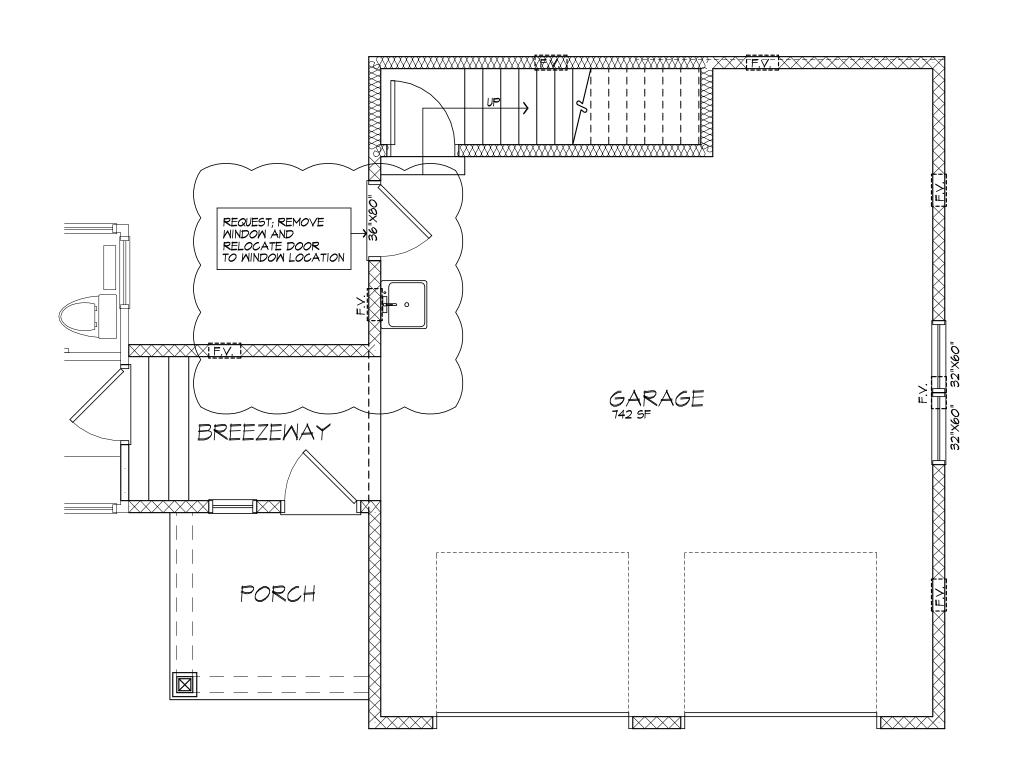


MODIFICATION REQUESTED

MOVE REAR BREEZEWAY DOOR TO WINDOW LOCATION NEAR STAIRS

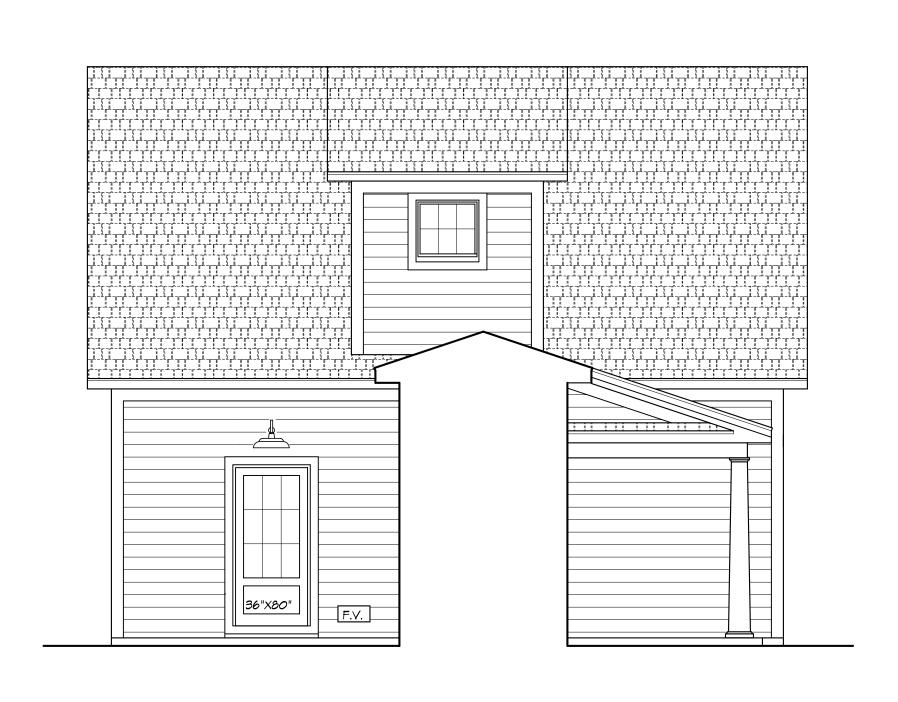

MODIFICATION REQUESTED

MOVE REAR BREEZEWAY DOOR TO WINDOW LOCATION NEAR STAIRS

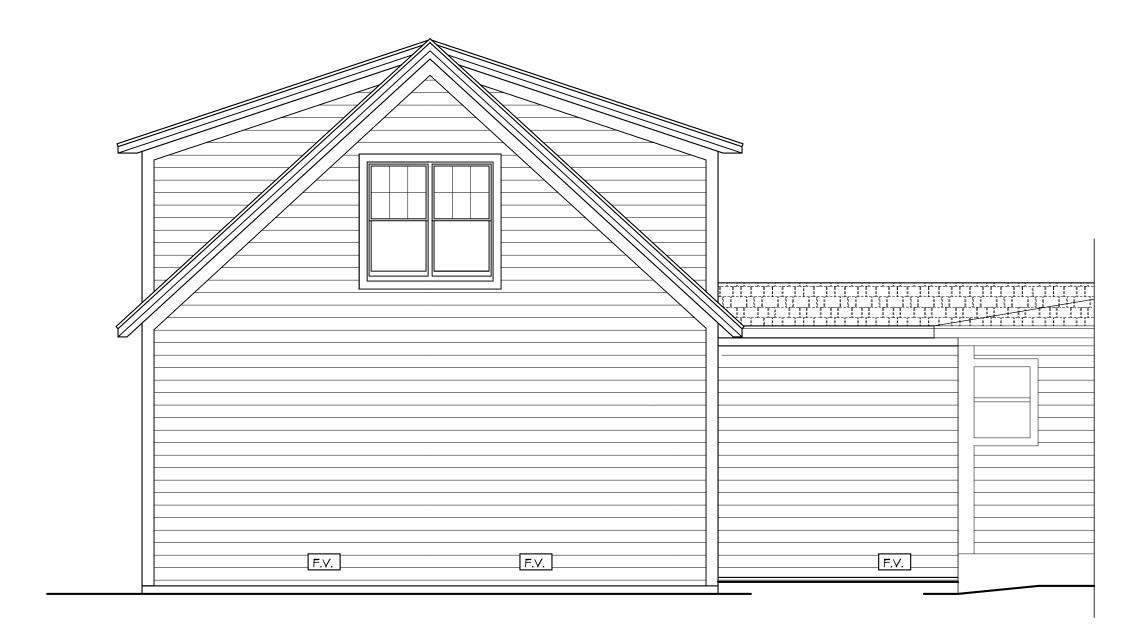


MODIFICATION REQUESTED

MOVE REAR BREEZEWAY DOOR TO WINDOW LOCATION
NEAR STAIRS

NEAL & PAMELA SHERMAN

GARAGE ADDITION TO RESIDENCE

246 LONG MEADOW CIRCLE

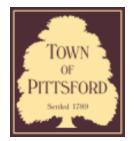

## **Town of Pittsford**

Department of Public Works 11 South Main Street Pittsford, New York 14534

Permit # B25-000125

Phone: 585-248-6250 FAX: 585-248-6262

## DESIGN REVIEW AND HISTORIC PRESERVATION BOARD REFERRAL OF APPLICATION

Property Address: 90 Stoneleigh Court ROCHESTER, NY 14618

**Tax ID Number:** 138.18-1-10

**Zoning District:** RN Residential Neighborhood

Owner: Duran, Michael Applicant: Duran, Michael

Ar	lac	ica	itio	n	Τνι	oe:
	, p				. , ,	~~:

Residential Design Review §185-205 (B)	Build to Line Adjustment §185-17 (B) (2)
Commercial Design Review §185-205 (B)	Building Height Above 30 Feet §185-17 (M)
Signage §185-205 (C)	Corner Lot Orientation §185-17 (K) (3)
Certificate of Appropriateness §185-197	Flag Lot Building Line Location §185-17 (L) (1) (c)
Landmark Designation §185-195 (2)	Undeveloped Flag Lot Requirements §185-17 (L) (2)
Informal Review	


**Project Description:** Applicant is requesting design review of a 672 square foot attached 2 car garage addition.

Meeting Date: October 23, 2025


## Residential Neighborhood Zoning




10/15/2025, 1:22:21 PM

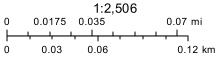

Town of Pittsford GIS

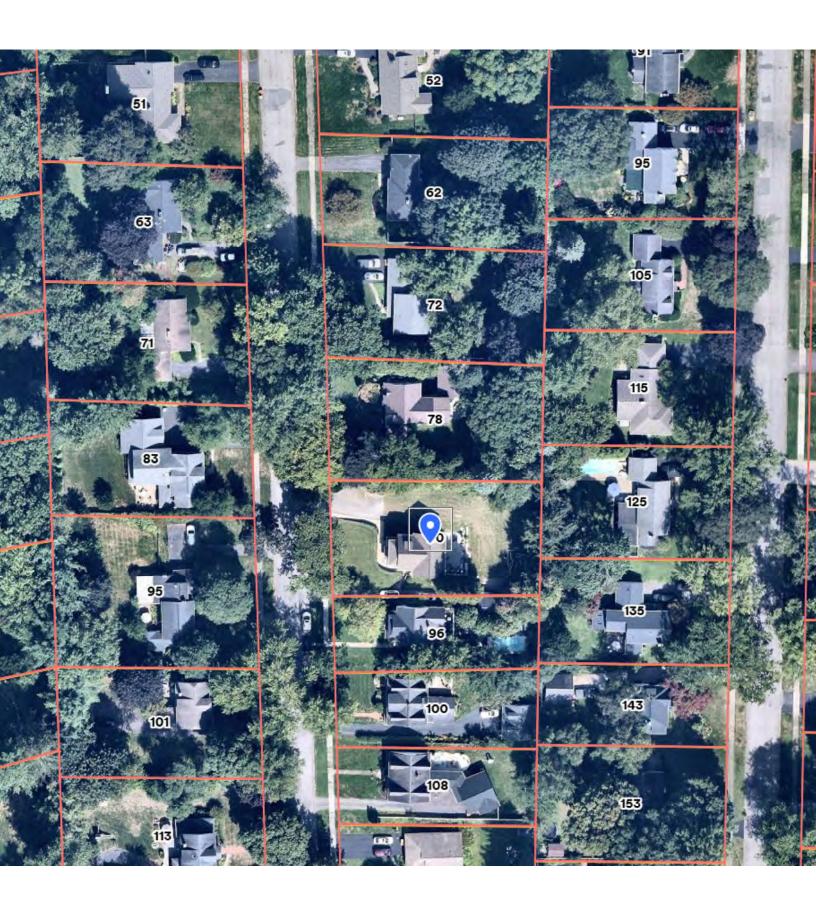

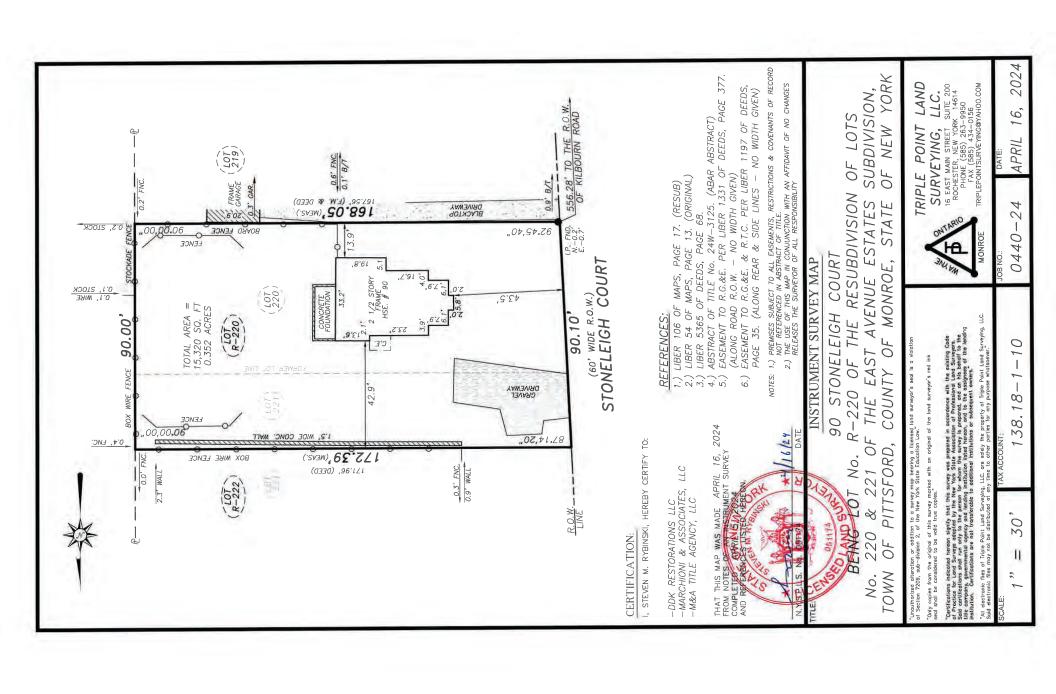


## **ARCHITECTURAL SITE PLAN NOTES**

UNLESS OTHERWISE NOTED OR APPROVED, PROPOSED CONSTRUCTION TO BE LOCATED WITHIN BUILDABLE ENVELOPE WITH RESPECT TO ALL APPLICABLE SETBACKS INCLUDING, BUT NOT LIMITED TO, SIDE, FRONT & REAR SETBACKS AS DEFINED BY LOCAL ZONING REGULATIONS.


DESIGN AND CONSTRUCTION OF SEPTIC, DRIVEWAY, UTILITY, AUXILIARY STRUCTURES & CONSTRUCTION SHALL BE PER MUNICIPAL ZONING, ADOPTED BUILDING CODE & JURISDICTIONAL REGULATIONS, &/OR APPROVED ENGINEERED SITE DESIGN.

WHERE APPLICABLE, REFER TO ENGINEERED SITE DRAWINGS FOR REQUIREMENTS RELATED TO EROSION AND SEDIMENTATION CONTROL

CONSTRUCTION SEQUENCING PER APPROVED ENGINEERED SITE DRAWINGS, WHERE

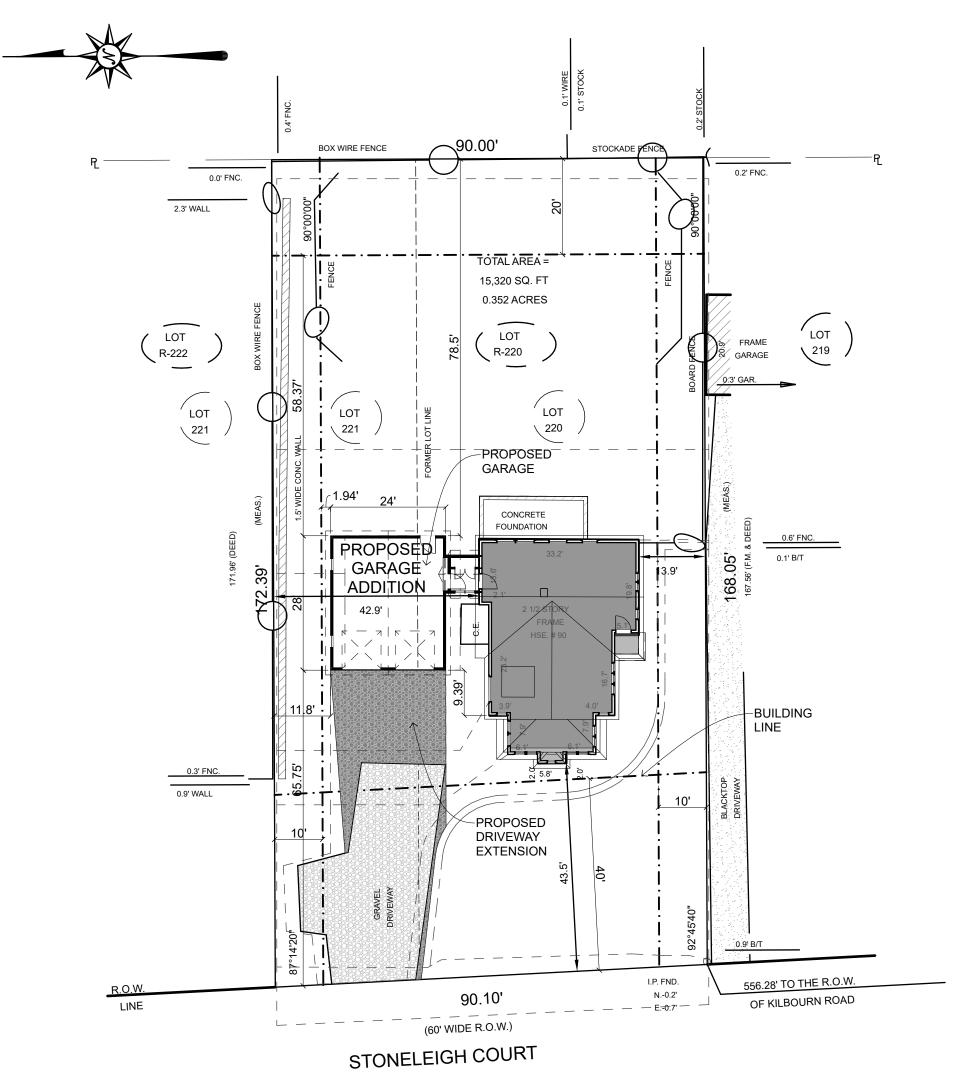



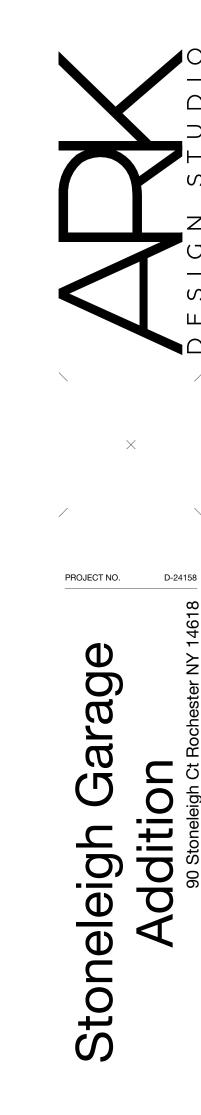

ISSUED 7/29/25 Permit Set

SCALE 1/4"-1'-0"

Architectural Site Plan

**AS1.0** 

## **GENERAL FOUNDATION & SLAB NOTES**

FINAL FOOTING DEPTHS & CONFIGURATIONS ARE SUBJECT TO REST ON UNDISTURBED SOIL AND MAINTAIN FROST DEPTHS PER CLIMATIC AND GEOGRAPHIC DESIGN CRITERIA, UNLESS OTHERWISE NOTED.

A PRESUMPTIVE SOIL BEARING CAPACITY OF 2000 PSF HAS BEEN ASSUMED IN LIEU OF A COMPLETE GEOTECHNICAL EVALUATION. IF REQUIRED, THE CONTRACTOR SHALL BE RESPONSIBLE FOR HIRING A SOILS ENGINEER TO VERIFY SUB-GRADE CONDITIONS AND SUBSTANTIATE ACTUAL BEARING CAPACITY.

PROVIDE PERIMETER FOUNDATION DRAIN PIPE PITCHED @ 1/8":12" TO DAYLIGHT OR A PREPARED 1'-0" DEEP, 2'-0" DIAMETER GRAVEL BED OR SUMP PUMP AS REQUIRED BY OWNER. DRAINPIPE TO BE 4" PERFORATED PIPE W/ HOLES ORIENTED DOWNWARD.

CONTROL JOINTS TO BE PROVIDED FOR ALL CONCRETE SLABS OVER 900 SF.

IT IS RECOMMENDED THAT RADON MITIGATION PIPING BE PLACED UNDER SLAB TO AN ELBOW ABOVE SLAB. PROVIDE PVC VENT PIPE TO EXTERIOR. CONTRACTOR TO VERIFY INSTALLATION W/ OWNER.

ALL SUBBASE TO BE COMPACTED IN MAXIMUM 6" LIFTS.

PROVIDE CLOSED CELL FOAM SILL SEALER & 2x PRESSURE TREATED SILL PLATE FLUSH TO EXTERIOR EDGE OF ALL FOUNDATION WALLS. SECURE w/ ANCHOR BOLTS.

PROVIDE (2) PRESSURE TREATED 2X4 @ PERIMETER OF WINDOW & DOOR ROUGH OPENINGS IN FOUNDATION WALLS

PROVIDE (1) PRESSURE TREATED 2x ON TOP OF STEEL BEAMS.

ALL EXTERIOR CONCRETE SLABS, FOUNDATION WALLS, AND FOUNDATION PIERS TO BE MIN 4000 PSI CONC.

ALL INTERIOR CONCRETE SLABS TO BE MIN 3000 PSI CONC.

MAXIMUM ALLOWED HEIGHT OF BACKFILL SHALL BE 6 INCHES BELOW TOP OF FOUNDATION WALL.

DO NOT USE EXPANSIVE SOIL OR TOPSOIL FOR BACKFILL.

BACKFILL SHALL NOT BE PLACED AGAINST THE WALL UNTIL WALL HAS SUFFICIENT STRENGTH AND HAS BEEN ANCHORED TO THE FLOOR ABOVE, OR HAS BEEN SUFFICIENTLY BRACED TO PREVENT DAMAGE BY BACKFILL.

SILL PLATE MUST BE BOLTED WITHIN 12 INCHES OF THE END OF ALL PLATE SECTIONS.

CONCRETE WALLS BELOW GRADE WITH SOIL ON ONE SIDE: VERTICAL REINFORCING SHALL BE PLACED WITH THE CENTER AXIS OF THE BAR BEING LOCATED 1 1/2" FROM THE INTERIOR FACE OF THE CONCRETE (ON THE TENSION SIDE OF THE WALL).

CONCRETE WALLS BELOW GRADE WITH SOIL ON BOTH SIDES OR WALLS ABOVE GRADE: VERTICAL REINFORCING SHALL BE PLACED WITH THE CENTER AXIS OF THE BAR AT THE CENTER AXIS OF THE WALL.


CONCRETE WALL OPENINGS: PROVIDE MIN (2) #4 VERTICAL BARS AT EACH SIDE OF OPENINGS. MAINTAIN COVER OF 1 1/2". BARS SHALL EXTEND VERTICALLY FOR THE FULL HEIGHT OF THE WALL POUR. PROVIDE (2) #4 HORIZONTAL BARS AT THE BASE AND TOP OF THE OPENING EXTENDING MIN 24" BEYOND EACH SIDE OF THE OPENING.

PROVIDE ADDITIONAL (4) #5 VERTICAL BARS IN FOUNDATION WALLS & #3 HORIZ CAGE STIRRUPS @ 12" OC BELOW ALL POINT LOAD LOCATIONS

FOUNDATION PLAN SCALE: 1/4" = 1'-0"

PROVIDE (2) FULL HEIGHT VERTICAL BARS AT ALL CORNERS IN FOUNDATION WALLS, SIZE EQ TO WALL REINFORCEMENT.

MINIMUM REINFORCING LAP LENGTH TO BE 40x BAR DIAMETER.

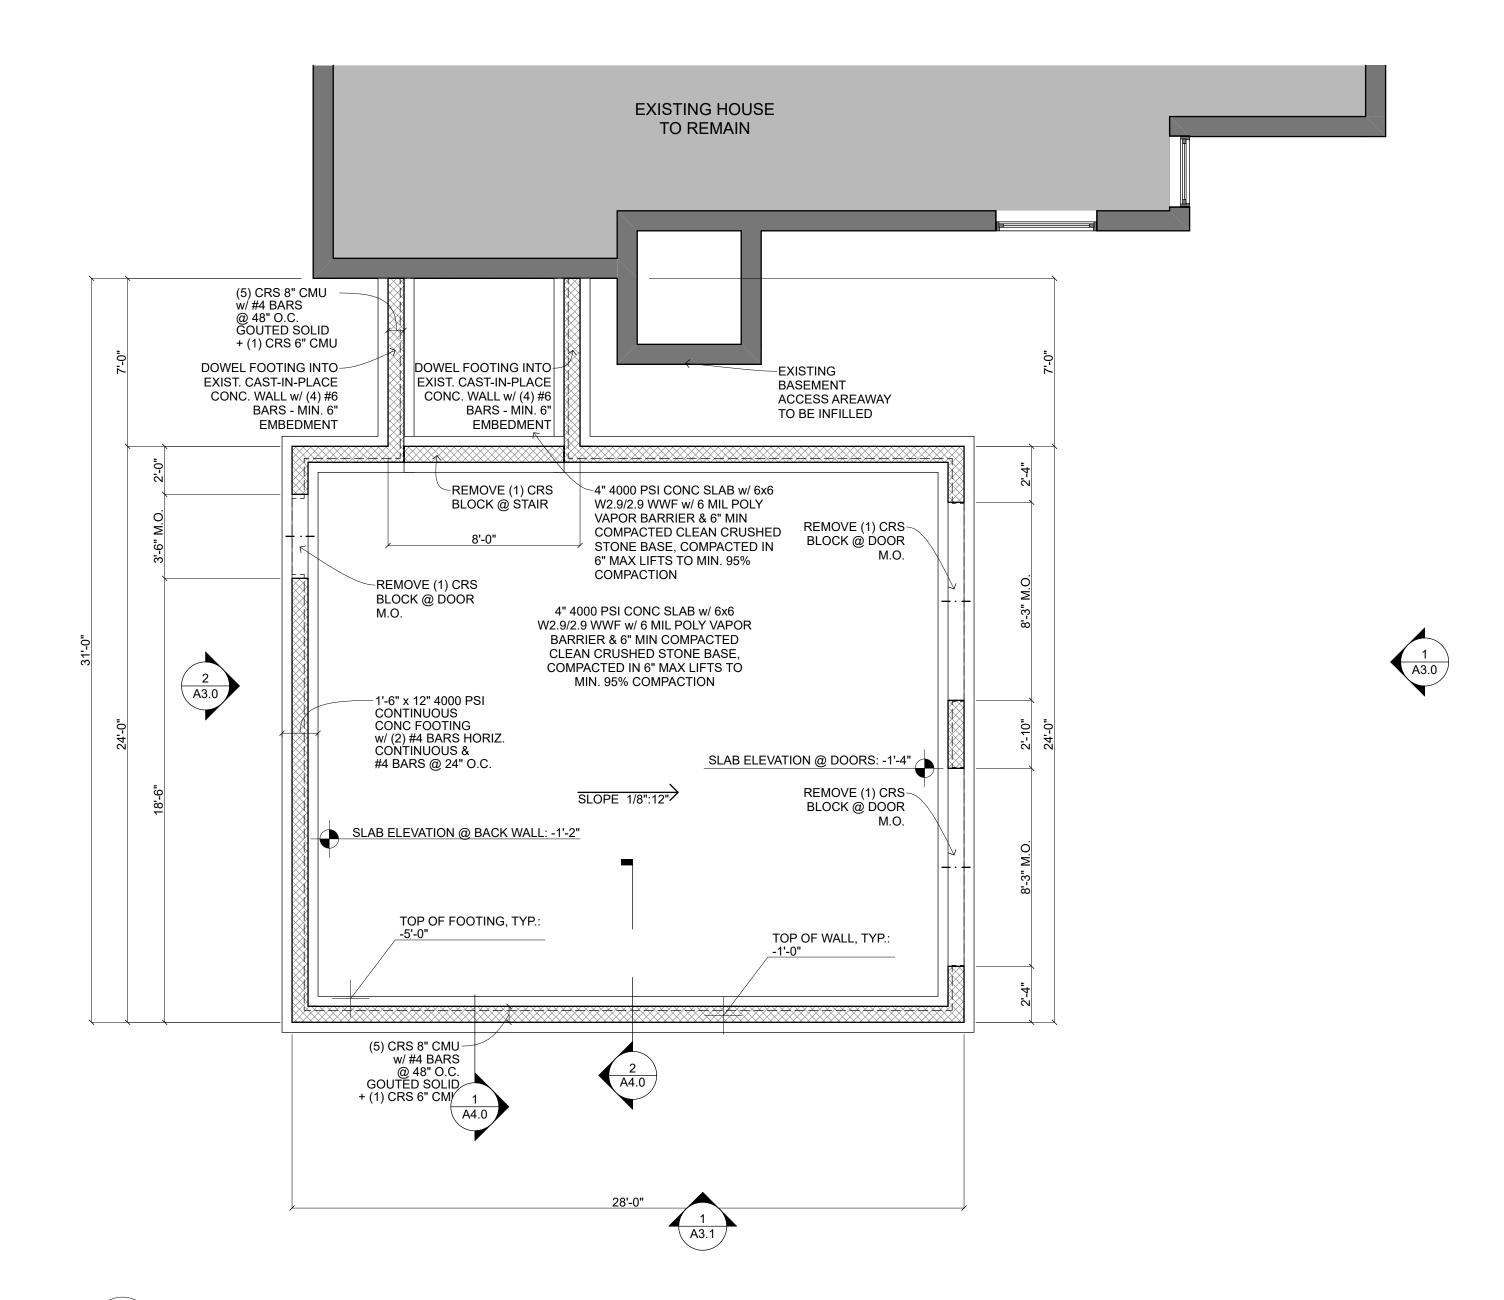



FOOTINGS SHALL BE STEPPED AS REQUIRED BY SITE CONDITIONS TO BEAR ON UNDISTURBED SOILS AND MAINTAIN 42" MIN. DEPTH BELOW FINISHED GRADE

Plan

PROJECT NO.

toneleigh

ISSUED

SCALE

Permit Set


D-24158

ぢ

7/29/25

1/4"-1'-0"

Δ1 Λ

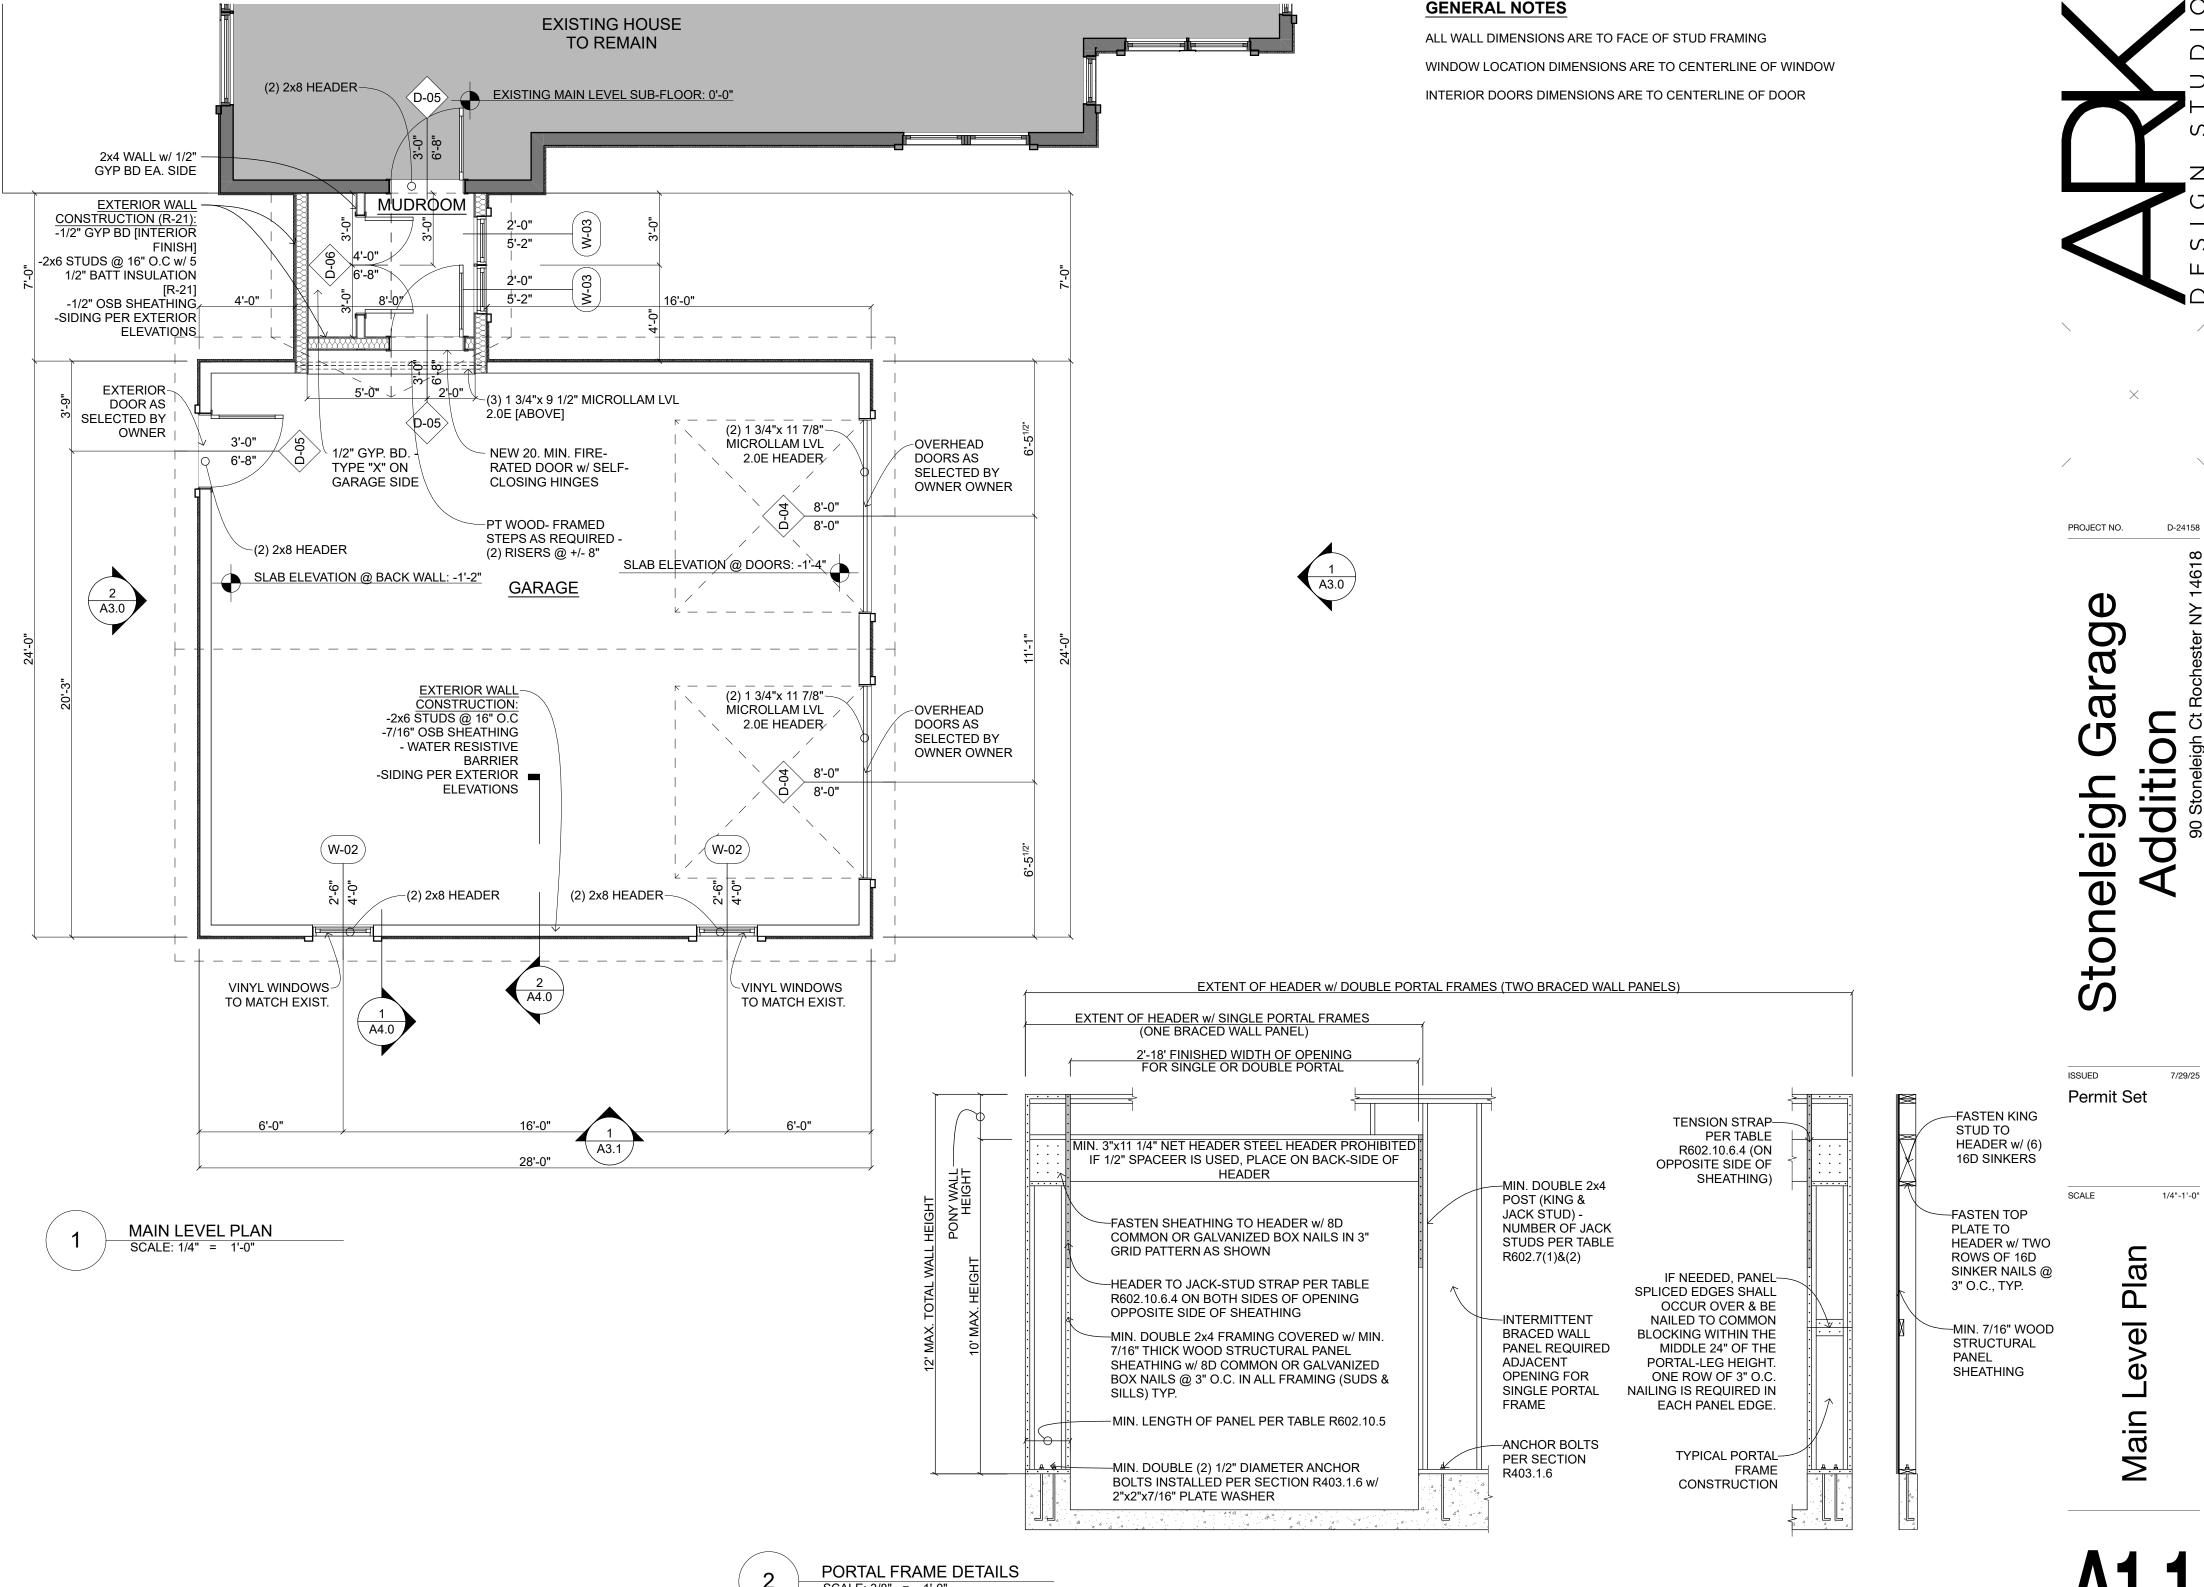


## **GENERAL ROOF FRAMING NOTES**

PRE-MANUFACTURED TRUSSES TO BE ENGINEERED AND PROVIDED BY CERTIFIED TRUSS MANUFACTURER IN ACCORDANCE WITH ALL APPLICABLE LOCAL AND STATE BUILDING CODES IN EFFECT AT THE TIME OF CONSTRUCTION AND SHALL ACCOUNT FOR ALL IMPOSED RELEVANT LIVE AND DEAD LOADS

TRUSS LAYOUT AND DESIGN PER MANUFACTURER - LAYOUT AS SHOWN IS FOR CONCEPTUAL PURPOSES ONLY

FINAL TRUSS DESIGN AND LAYOUT SHALL BE APPROVED BY OWNER/BUILDER PRIOR TO FABRICATION


GIRDER TRUSSES SHALL BE ENGINEERED BY MANUFACTURER WITH RELEVANT CONNECTORS

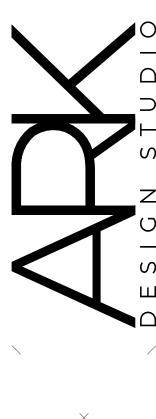


D-24158


7/29/25


1/4"-1'-0"

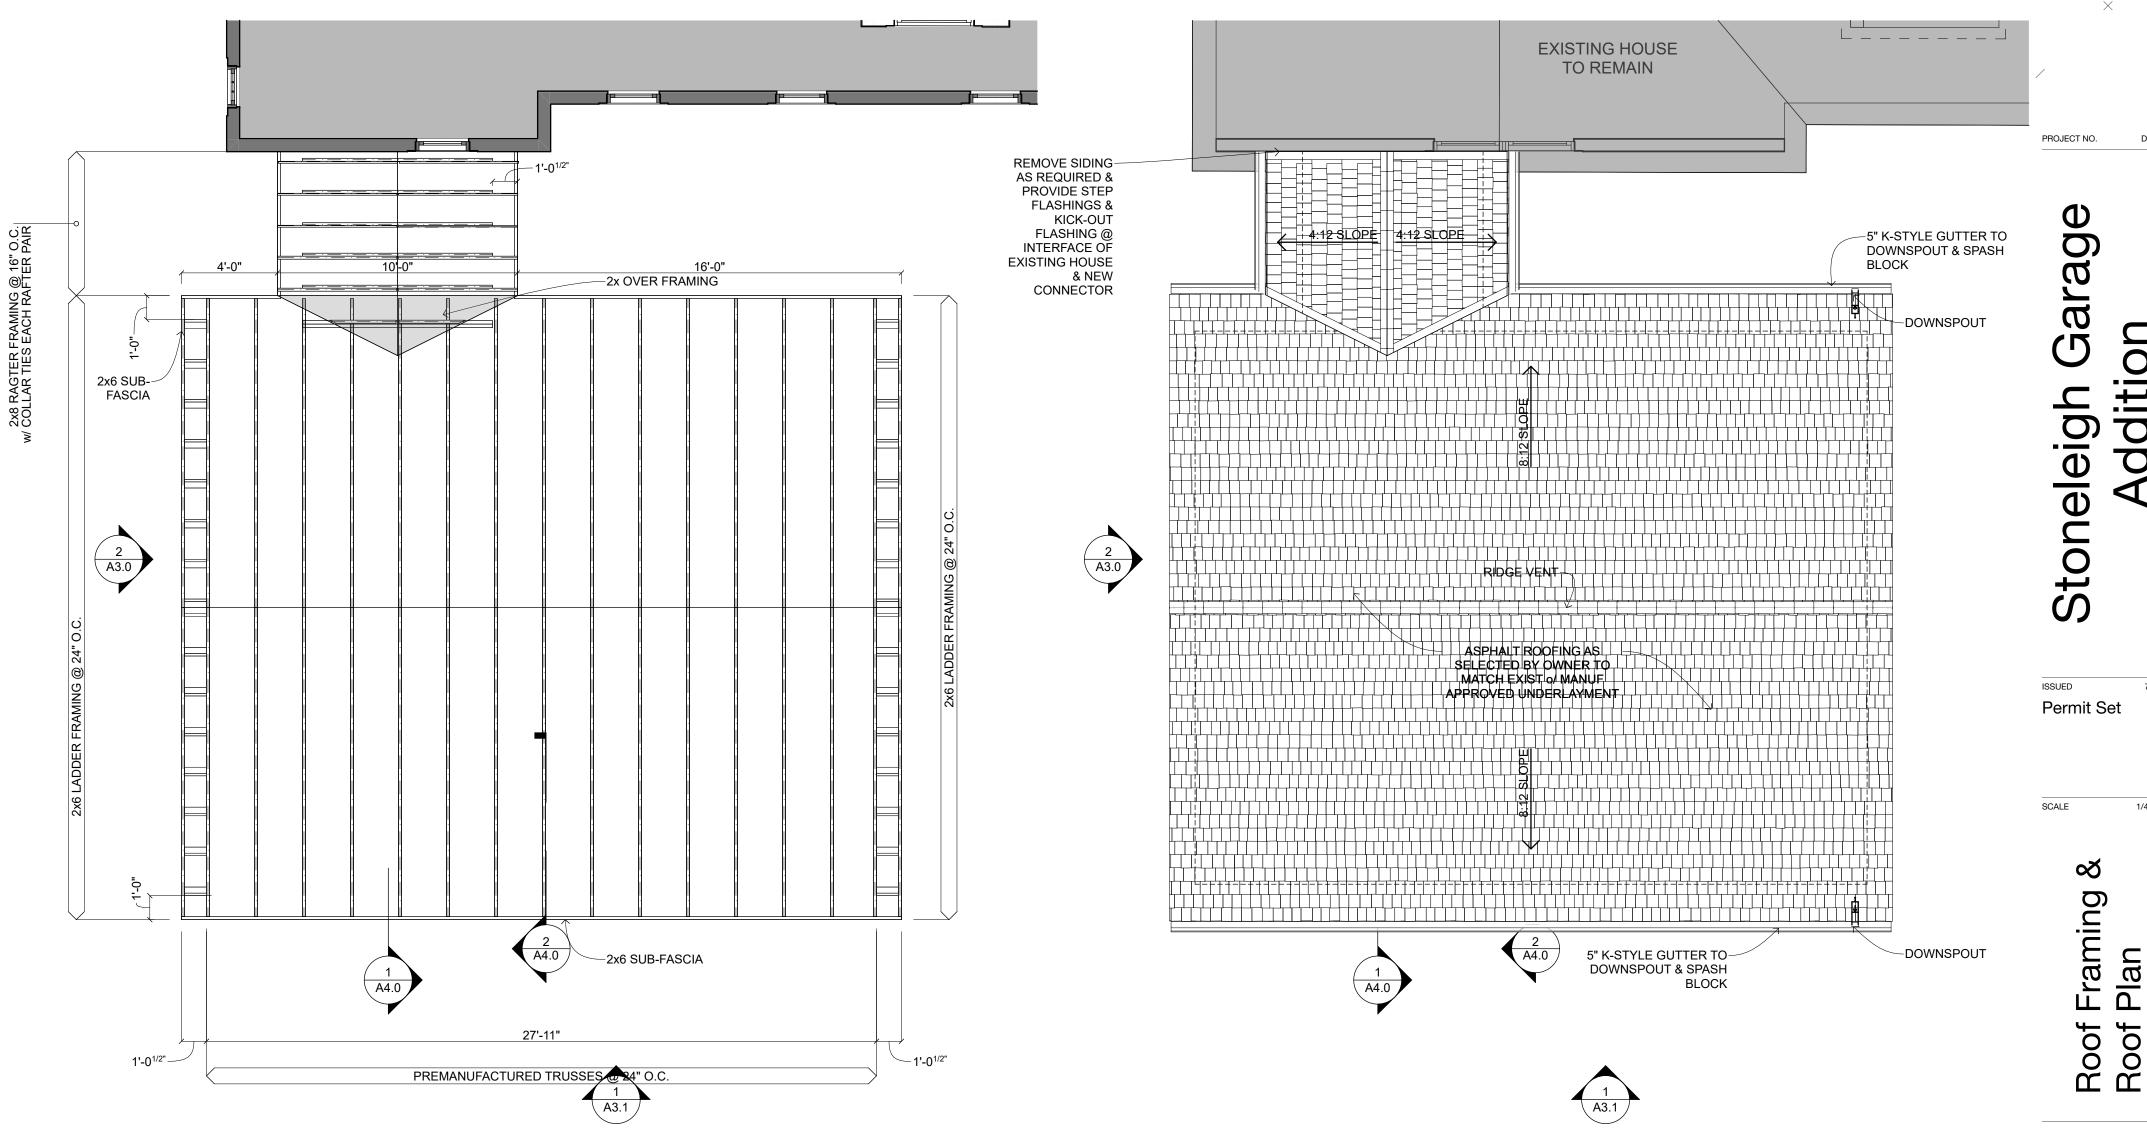


## **ELECTRICAL SYMBOLS** 110 DUPLEX OUTLET 110 QUAD OUTLET 110 SWITCHED OUTLET 110 FLOOR OUTLET GROUND FAULT INTERRUPTER OUTLET WATERPROOF EXTERIOR OUTLET 220 OUTLET SWITCH 3-WAY SWITCH DIMMER SWITCH DOOR ACTUATED SWITCH MOTION DETECTING SWITCH MPD MULTI-POINT DIMMIER SMOKE DETECTOR SMOKE/CARBON MONOXIDE DETECTOR CEILING JUNCTION BOX — LED STRIP/TRACK LIGHTING **EMERGENCY LIGHTING - BATTERY** 4" RECESSED LIGHT $\square_{R-5}$ 5" RECESSED LIGHT S-+0" $\square$ WALL MOUNTED LIGHT ES-+0" $\square$ EXTERIOR WALL MOUNTED LIGHT CEILING MOUNTED LIGHT EXTERIOR CEILING MOUNTED LIGHT PENDANT MOUNTED LIGHT CHANDELIER LIGHT **VENTILATION FAN VENTILATION FAN+LIGHT** VANITY LIGHT BAR UNDER CABINET LIGHT ■ LED UTILITY LIGHT

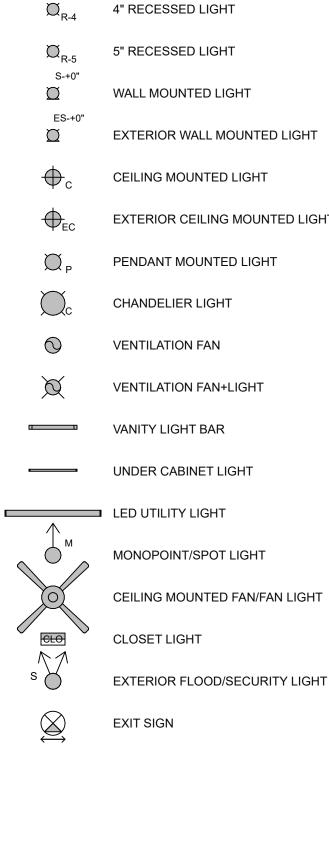

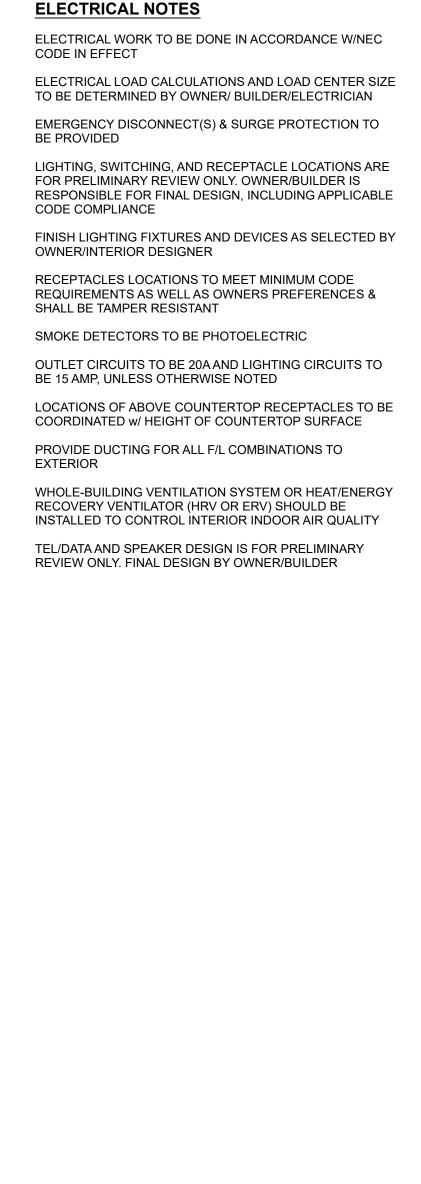

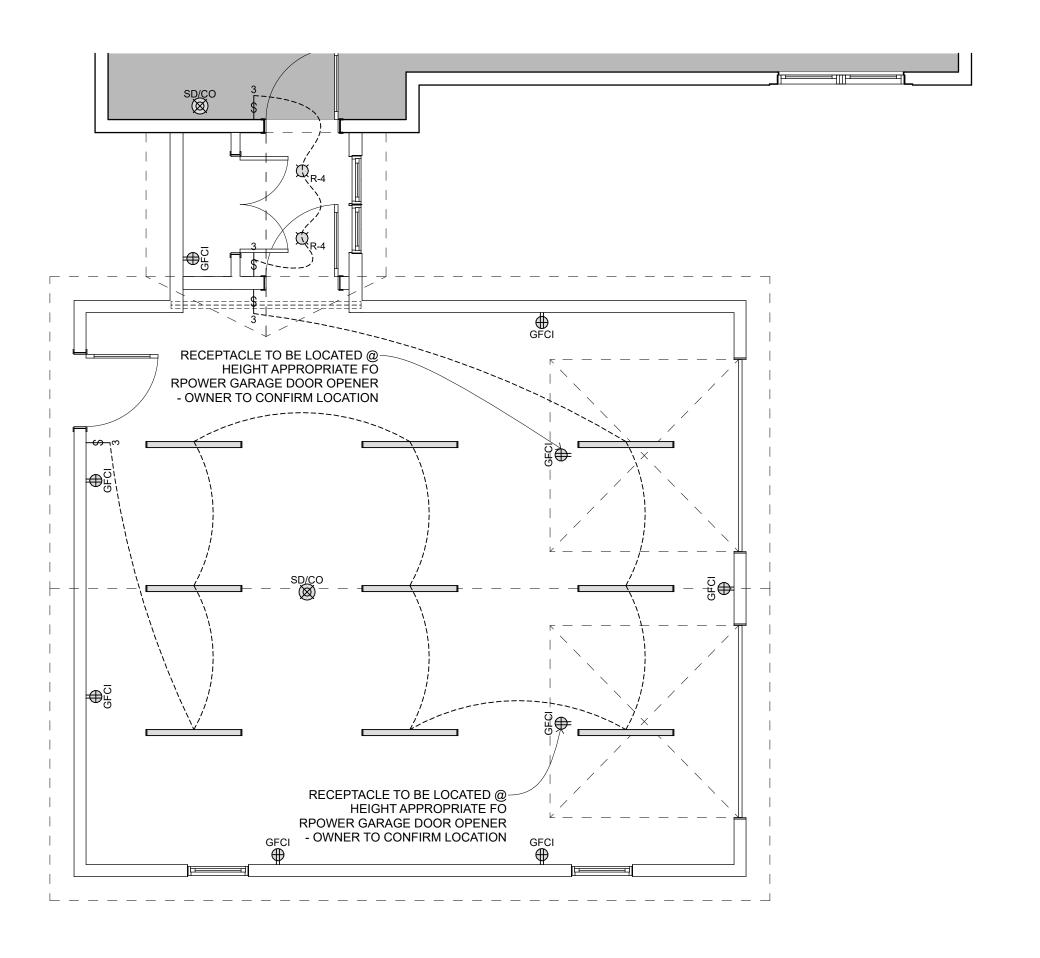

MAIN LEVEL RCP SCALE: 1/4" = 1'-0"

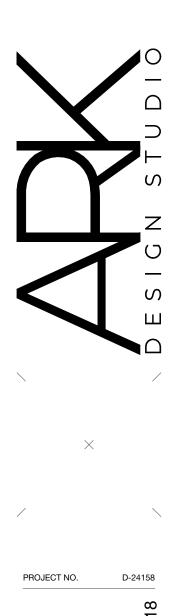

Stoneleigh


ISSUED 7/29/25 Permit Set


SCALE

1/4"-1'-0"

Д

Main Level RC

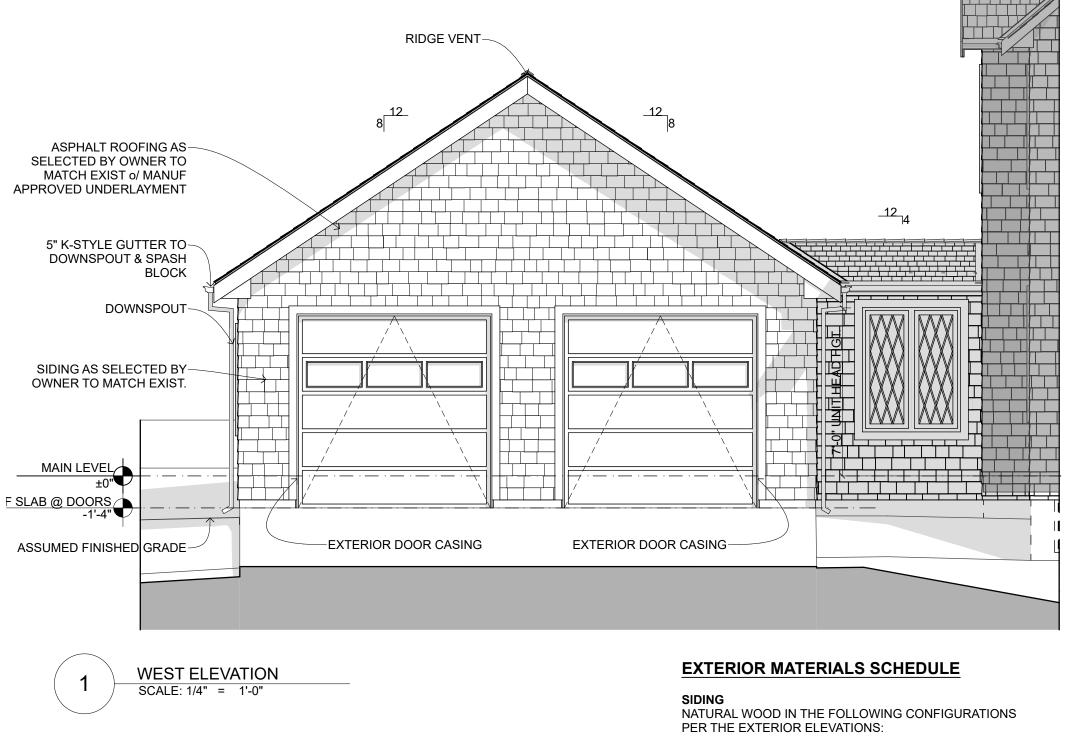

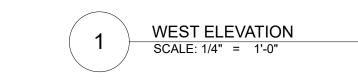

ASPHALT ROOFING AS SELECTED BY OWNER TO MATCH EXIST o/ MANUF APPROVED UNDERLAYMENT

RIDGE VENT

-EXTERIOR DOOR CASING

8 12

√5" K-STYLE GUTTER TO DOWNSPOUT & SPASH BLOCK

-DOWNSPOUT

-SIDING AS SELECTED BY OWNER TO MATCH EXIST.



-ASSUMED FINISHED GRADE

ASPHALT TO MATCH EXISTING AS SELECTED BY OWNER

SPLASH BLOCKS

**DECKING** 

- SHINGLE TO MATCH EXISTING

COMPOSITE/PVC TO MATCH EXISTING - VENTING AS REQUIRED

**FASCIA** 

COMPOSITE/PVC TO MATCH EXISTING - 3/4x8

THE FOLLOWING SIZES AS APPLICABLE:

LP SMART SIDE OR DIAMOND KOTE PREFINISHED IN

-CORNER BOARDS - N/A -WINDOW CASING --FRIEZE BOARDS -5/4x4

-BAND BOARDS -N/A -BELLY BOARDS -N/A -DECK SKIRT BOARDS - N/A -WRAPPED POSTS - N/A -WRAPPED BEAMS - N/A

ROOFING

5" K-STYLE w/ CORRESPONDING DOWNSPOUTS TO

PROJECT NO. D-24158

Stoneleigh

ISSUED 7/29/25

Permit Set

SCALE

1/4"-1'-0"

Exterior Elevations

4 12

## **EXTERIOR MATERIALS SCHEDULE**

## SIDING

NATURAL WOOD IN THE FOLLOWING CONFIGURATIONS PER THE EXTERIOR ELEVATIONS:

- SHINGLE TO MATCH EXISTING

#### SOFFITS

COMPOSITE/PVC TO MATCH EXISTING - VENTING AS REQUIRED

## **FASCIA**

COMPOSITE/PVC TO MATCH EXISTING - 3/4x8

## TOIM

LP SMART SIDE OR DIAMOND KOTE PREFINISHED IN THE FOLLOWING SIZES AS APPLICABLE:

-CORNER BOARDS - N/A
-WINDOW CASING - 5/4x4
-FRIEZE BOARDS - 5/4x4
-BAND BOARDS - N/A
-BELLY BOARDS - N/A
-DECK SKIRT BOARDS - N/A
-WRAPPED POSTS - N/A
-WRAPPED BEAMS - N/A

## ROOFING

ASPHALT TO MATCH EXISTING AS SELECTED BY OWNER

## **GUTTERS**

5" K-STYLE w/ CORRESPONDING DOWNSPOUTS TO SPLASH BLOCKS

## DECKING

N/A

MAIN LEVEL


ASPHALT ROOFING AS— SELECTED BY OWNER TO MATCH EXIST o/ MANUF APPROVED UNDERLAYMENT

SIDING AS SELECTED BY-OWNER TO MATCH EXIST.

EXTERIOR WINDOW-CASING

ASSUMED FINISHED GRADE

NORTH ELEVATION SCALE: 1/4" = 1'-0"

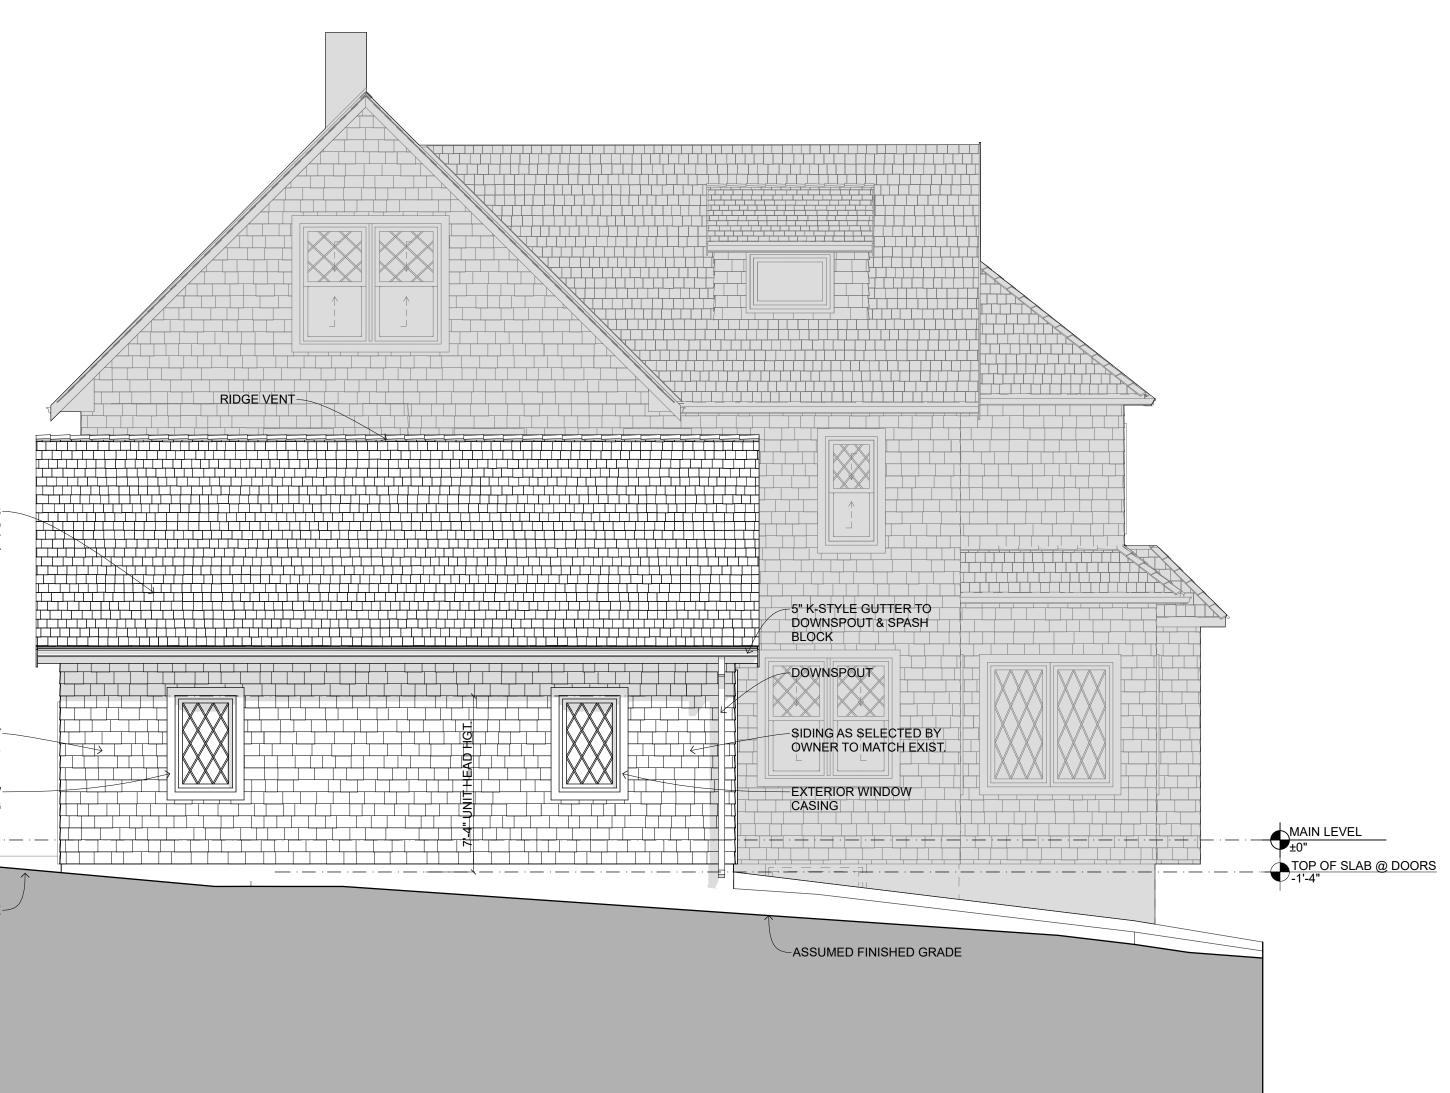

D-24158

PROJECT NO.

D-24158

Stoneleigh Garage Addition

ISSUED

SCALE

Permit Set


Exterior Elevations


7/29/25

1/4"-1'-0"



9.0 Stoneleigh Ct. Proposed Garage Rendering 10/14/25

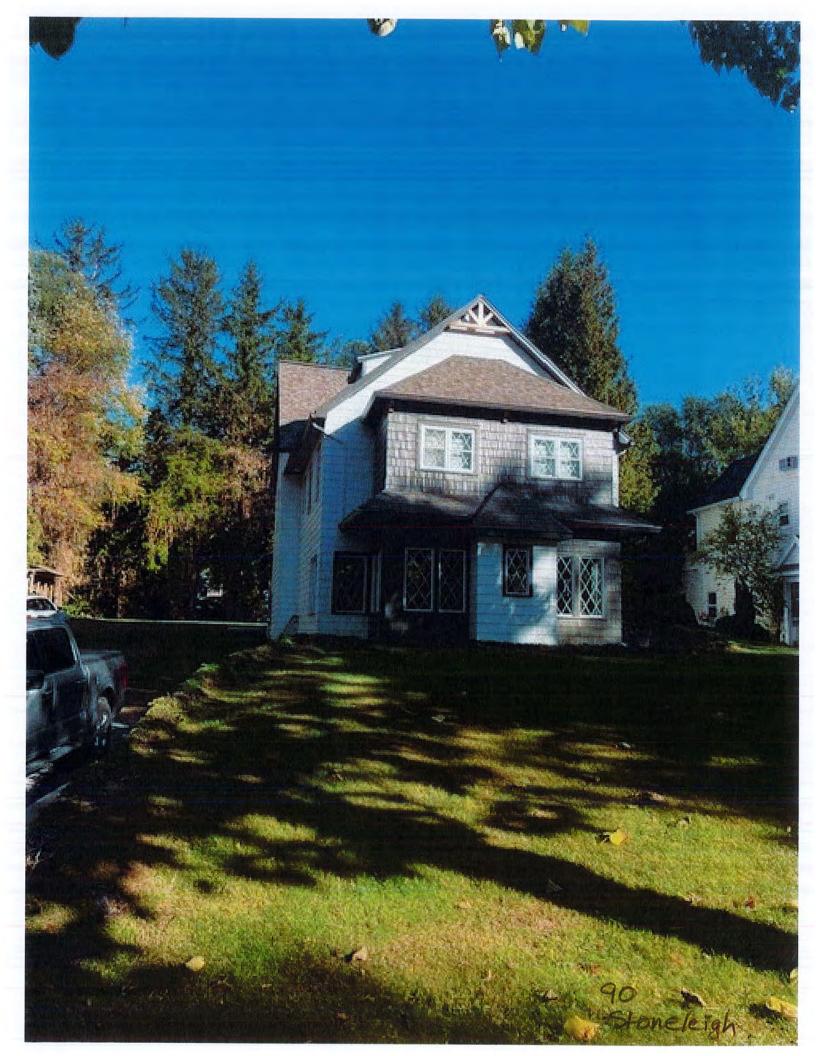

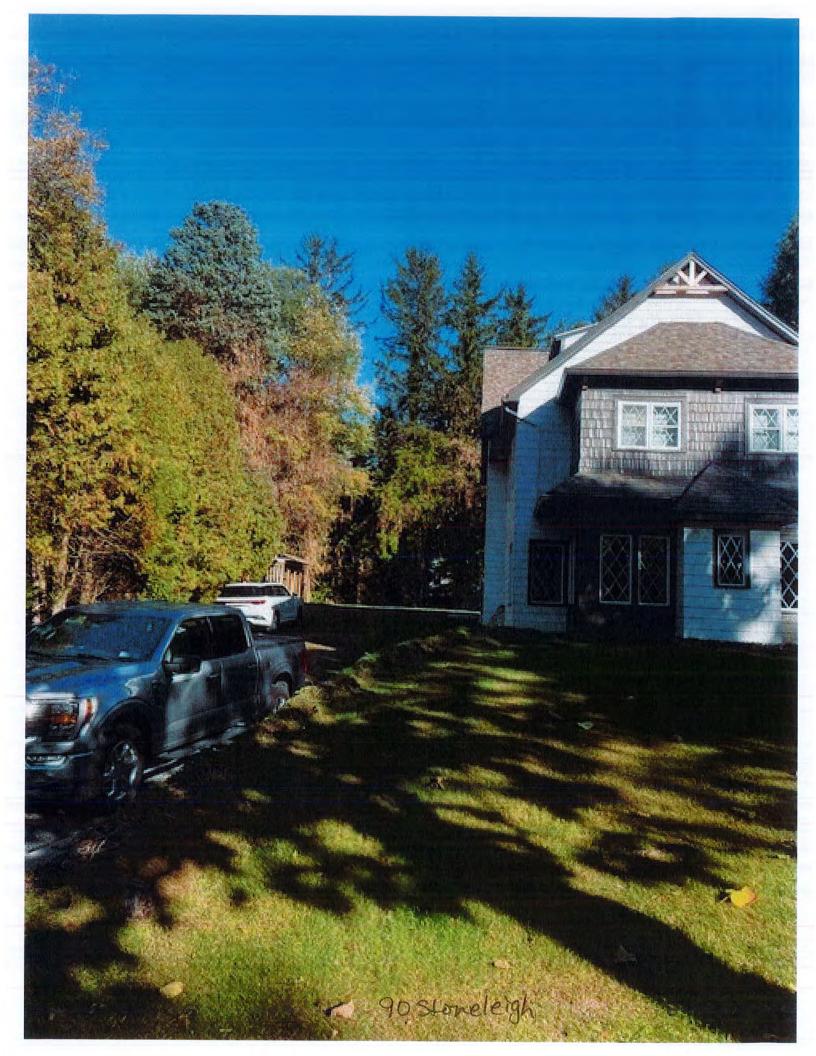



## **Town of Pittsford**

Department of Public Works 11 South Main Street Pittsford. New York 14534

Permit # RA25-000177

Phone: 585-248-6250 FAX: 585-248-6262

## DESIGN REVIEW AND HISTORIC PRESERVATION BOARD REFERRAL OF APPLICATION

Property Address: 4048 East Avenue ROCHESTER, NY 14618

**Tax ID Number:** 151.10-1-7.1

Zoning District: RN Residential Neighborhood

Owner: Coughlin, Daniel M

**Applicant:** The Workshop Home Services Inc.


Дp	plica	atio	n Ty	pe:
, , ,	V	40.0	,	P .

٠.	Residential Design Review	Build to Line Adjustment
<b>✓</b>	§185-205 (B)	§185-17 (B) (2)
	Commercial Design Review	Building Height Above 30 Feet
	§185-205 (B)	§185-17 (M)
	Signage	Corner Lot Orientation
	§185-205 (C)	§185-17 (K) (3)
	Certificate of Appropriateness	Flag Lot Building Line Location
	§185-197	§185-17 (L) (1) (c)
	Landmark Designation	Undeveloped Flag Lot Requirements
	§185-195 (2)	§185-17 (L) (2)
	Informal Review	

**Project Description:** Applicant is requesting design review of a 647 square foot detached 2 bay single story garage.


Meeting Date: October 23, 2025

## Residential Neighborhood Zoning

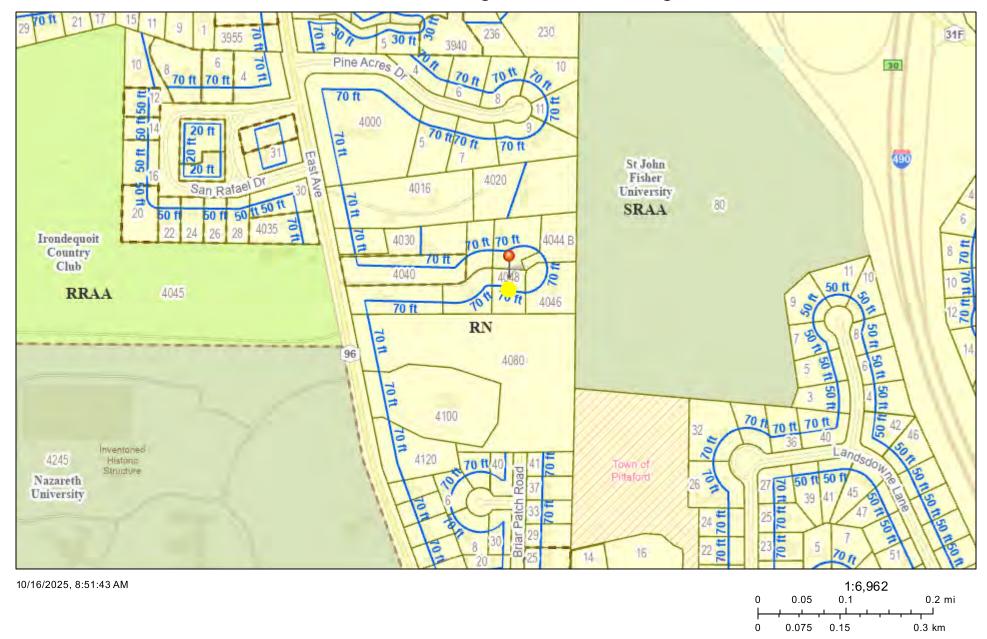

Town of Pittsford GIS



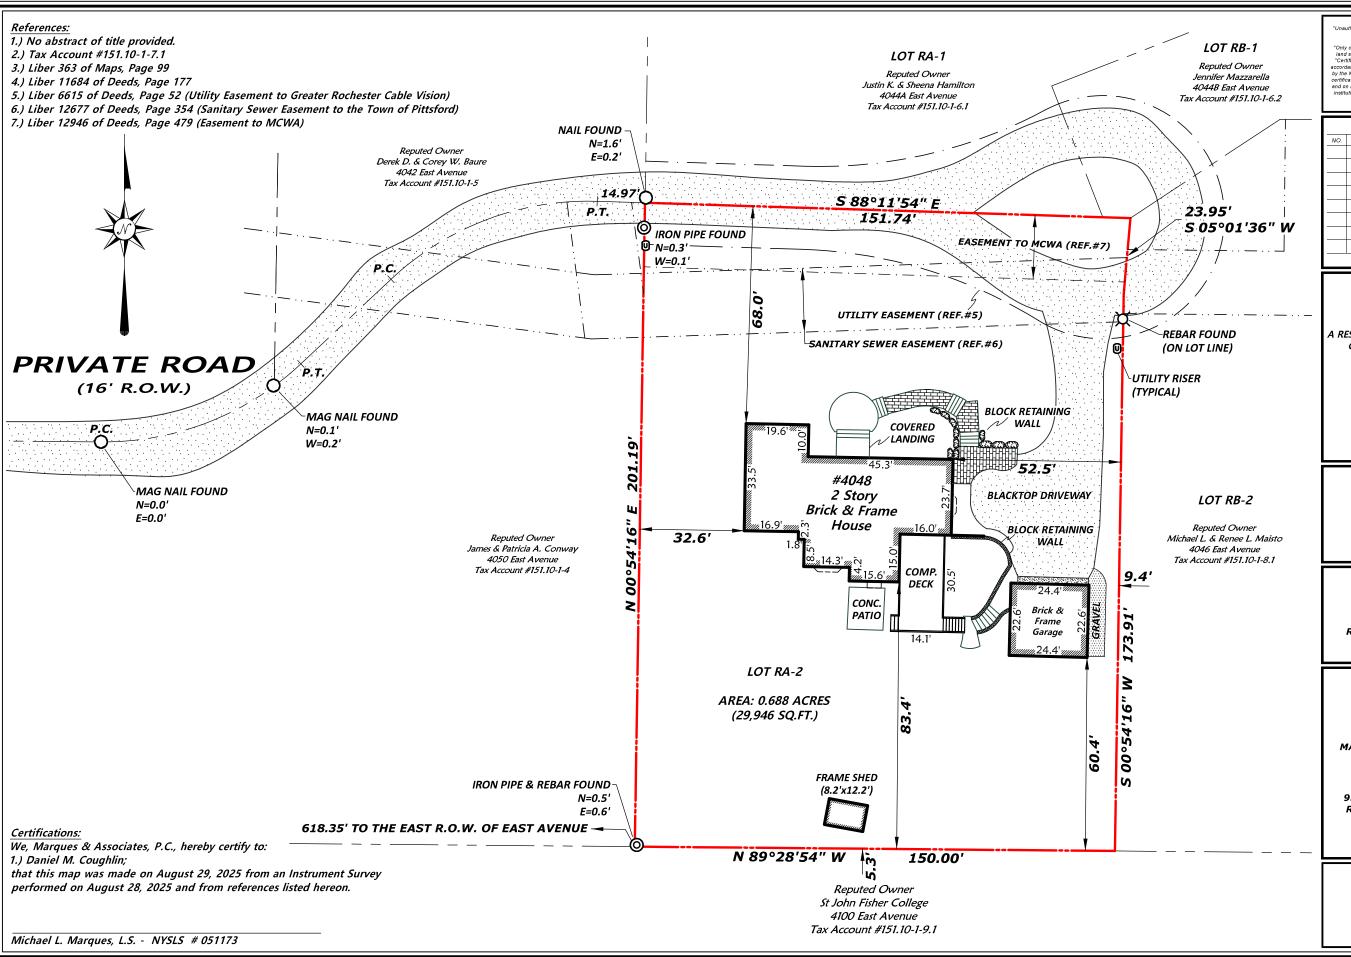

"Unauthorized alterations or addition to a survey map bearing a licensed land surveyor's seal is a violation of Section 7209, sub-section 2, of the New York State Education Law,"
"Only copies from the original of this survey marked with an original of the land surveyor's embossed seal shall be considered valid true copies." Certifications indicated hereon signify that this survey was prepared in accordance with the existing Code of Practice for Land Surveyors adopted by the New York State Association of Professional Land Surveyors adopted and on his behalf to the title company, governmental agency, and lending institution. Certifications are not transferable to additional institutions or

		REVISIONS:	
NO.	DATE	DESCRIPTION	BY

SHOWING:

4048 EAST AVENUE

LOT RA-2 A RESUBDIVISION OF LOT A AND LOT B OF THE WHELAN SUBDIVISION AND OTHER LANDS (4046 & 4048 EAST AVENUE)

> BEING A RESUBDIVISION OF PART OF LAND OF THE ELMER E. FAIRCHILD PROPERTY

TOWN OF PITTSFORD

MONROE COUNTY

NEW YORK

DRAWING TITLE:

Instrument Survey Map

PREPARED FOR:

c/o Daniel M. Coughlin 4048 East Avenue Rochester, New York 14618



MARQUES & ASSOCIATES, P.C. LAND SURVEYING ENGINEERING

930 East Avenue, Suite 1000 Rochester, New York 14607 585-723-1820 www.marquespc.com

Date: August 29, 2025 Project #: 2025033 Scale: 1"=30' Drawn by: MLM

# Coughlin Garage Addition Town of PITTSFORD, NY

STRUCTURAL LOADING DESIGN CRITERIA 40 20 L/860 80 20 L/860 40 30 L/860 10 5 L/240 20 L/240 30 L/240 NOTE. ASSURED SAFE SOIL BEARING CAPACITY IS 2,000 PSF AT MIN, PROST DEPTH, VALLES MAY BE INCREASED IF SITE SPECIFIC SOIL CLASSIFICATION OR LOAD BEARING TEST DATA IS INSULATION AND FENESTRATION REQUIREMENTS BY COMPONENT: TABLE NIO2.12 2020 RESIDENTIAL CODE

CLIMATE PENESTRATION SKYLIGHT FENESTRATION SHECK MOOD FRAME MALL R-VALUE R-VALUE BASEMENT MALL R-VALUE DEPTH CELINO R-VALUE 15 / 14 20 OR

CLIMATIC & GEOGRAPHICAL	DESIGN CRITERIA:
-TABLE REGIST() 2020 RESIDENTIAL	CODE

SPROUND	NIND	989MC		NBJECT TO DAM	ME FROM		KE SHELD	
LOAD	(mph)	DESIGN CATEGORY	MEATHERING	PROST LINE DEPTH	TERMITE	DEGAY	UNDERLAYMENT REQUIRED	FLOOD HAZARDS
40	115	В	SEVERE	42*	SLIGHT TO MODERATE	NONE TO SLIGHT	YES	но

### LIST OF DRAWINGS:

A-0.0 Cover Sheet A-I I

Foundation & Floor Plans Roof Plan & Building Section A-2.I A-3.I Exterior Elevations



2 LOCATION MAP

### GENERAL NOTES & CODE

PORCHES, BALCONES, AND RAISED FLOORS SREATER THAN SO' ABY, FLIR OR GRADE SHALL HAVE A HALF

MY GLAZING IN MALLS

### GENERAL NOTES:

- THIS SET OF PLANS HAS BEEN DESIGNED AND SHALL BE BELT TO COMPLY HITH THE RESIDENTIAL CODE OF INTS MAIN METER AND REMOVEMENT AND REMOVEMENT OF EXISTING (F APPLICABLE TO PROJUCT).

- STAR TO HAVE HEIGHTS FIELD VERFED AND SHOP DRANNES APPROVED PRICE TO FABRICATION. STAR CONSTRUCTION SHALL CONSTRUCTION SHALL CONSTRUCTION SHALL CONSTRUCTION SHALL CONSTRUCTION SHALL CONSTRUCT AND SHALL CONSTRUCT AND SHALL CONSTRUCT AND SHALL CONSTRUCT AND ACCURE TO A CONTROLLY PARAMACINET.
- STARRIELLS TO BE A MIX OF \$6' IN WIDTH AND HAVE A CONSISTENT HEAD HEIGHT TO FINISHED CELLING OF 6'-6"
- A LANDING IS NOT REQUIRED AT TOP OF INTERIOR STARS PROVIDED A DOOR DOES NOT SKING OVER STARS
- HANDRAILS AND EXTENSIONS SHALL SE 54" TO 55" ABOVE NOSING OF TREADS AND SE CONTINUES.


- HADRALS PROJECTING FROM A WALL SHALL HAVE LEAST IN BETWEEN THE WALL AND THE HANDRALL BIOS OF THE HADRALS SHALL BE RETURNED OR SHALL HAVE BOLD TO TREAT HE

ADDITIONS & RENOVATIONS:

- FOR NEW CONSTRUCTION SMOKE DETECTING ALARM DEVICES SHALL BE DIRECT WIRED AND CONFORM TO THE RESIDENTIAL CODE OF K.Y.S.

### BUILDING ENVELOPE TESTING:

# EXCILIONE ENVILOPE TESTING. A.L. Bey responsa, commence note comparty fith Act so of slader door testing segments a country is section. The section of section section section voice state, and also section voice state section section voice state section voice state section voice state section voice state section voice sec

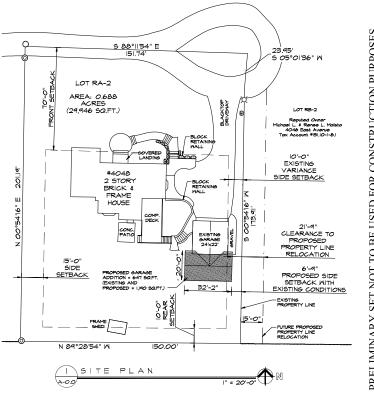

PURPOSES CONSTRUCTION Coughlin ge Addition Garage FOR USED BE70 NOT SET **PRELIMINARY** iż Fi

ġ.

WORKS

DESIGN ARCHITE

### FOUNDATION NOTES:

- ALL CONCRETE TO BE A MIN. OF 3,000 PSI (UNLESS OTHERWISE NOTED).
- THE HEIGHT OF BACK FILL SHALL NOT EXCEED 8 FEET. BACK FILL MATERIAL SHALL BE CLEAN, FREE OF DEBRIS, MELL DRAINED MATERIAL.
- . FINAL FOOTING DEPTHS AND CONFIGURATIONS ARE SUB-ECT TO SUBSURFACE CONDITIONS, ALL POOTINGS TO REST ON INDISTURBED SOIL OF MINIMM BEARING CAPACITY OF 2,000 PSF. ALL FOOTINGS ARE TO EXTEND BELOW THE FROOTINGS ARE TO SOIL OF MINIMO SAME TO FOOTINGS ARE TO THE PROOF TO FOOTINGS WE'VE TO FOOTINGS WE'VE REQUIRED.
- THE CONCRETE USED FOR FOOTINGS AND FOUNDATION WALLS (NOT EXPOSED TO THE WEATHER) SHALL HAVE A MINIMAM STRENGTH OF 2500 PSI AND SHALL BE ARE ENTRAINED AS REQUIRED THE RESIDENTIAL CODE OF NEW YORK STATE.
- TOP OF WALL TO EXTEND A MIN. OF 8" ABOVE FINISHED GRADE.
- SARAGE SLAB IS A MINIMIM OF 4"
  THICK OVER STEGOHOME VAPOR
  BARRIER (IO MIL) OVER 4" CRUSHED
  STONE, TOP OF SLAB ELEVATION TO BE
  AS NOTED, BASEMENT SLAB SHALL BE
  4000 PS.1 (26 DAY COMPRESSIVE
- T. PORCHES, CARPORT SLABS AND STEPS EXPOSED TO MEATHER AND GARAGE SLABS SHALL BE 4,000 P.S.I. (20 DAY COMPRESSIVE STRENSTH) CONCRETE
- REINFORMS

  REVOIL PRINCETER FORDATION
  PERFORATED FAX DAMANIES FITCHED

  REPARADIO TO JUES 2-0" DAMATIKE

  GAVALI BED OR EXTERIOR SAMP PARP

  GAVALI BED OR EXTERIOR SAMP PARP

  GAVALI BED OR EXTERIOR

  GAVE TO THE TOTAL THE TOTAL

  GAVE TO THE TOTAL

  CALLED TO THE TOTAL

  CALLED TO THE TOTAL

  CALLED TO THE TOTAL

  CALLED TO THE TOTAL

  TH
- PROVIDE DEEP SCORE CONTROL JOINTS AT MIDPOINTS OF ALL GARAGE SLABS, BOTH DIRECTIONS
- PROVIDE & EXPANSION JOINT MATERIAL BETMEEN ALL CONCRETE SLABS ON ABUTTING CONCRETE OR MASONRY WALLS OCCURRING IN EXTERIOR OR UNHEATED INTERIOR AREAS.
- ALL COMPACTED SOIL TO BE COMPACTED IN 12" LIFTS.
- BALL PROME DATE OF THE AND TO SHARE AND TO RIN FLIGHT WITH EXTENCE EDGE OF TOWNSHIP AND TO REAL PLANT AND THE AND TO REAL PLANT AND THE AND TH
- CMU FOUNDATION WALL SYSTEM SEE CMU NOTES & TYPICAL DETAILS.
- PROVIDE TERMITE PROTECTION AS REQUIRED BY LOCAL CODES.
- 16. SEALABLE COVER SAMP IS NEEDED IF SOIL OTHER THAN GROUP I (TABLE 405.1). SAMP TO BE 24\* BELON THE BOTTOM OF THE BASEMENT FLOOR. SUMP TO DISCHARGE BY GRAVITY OR NECHANICAL MEANS INTO A APPROVED PRAINAGE SYSTEM.
- IT. EXCEPT WHERE REQUIRED TO BE MATER/PROPIED BY SECTION RADS., POADATON MALLS THAT RETAIN EARTH AND USABLE SPACE SHALL BE DAMPROPIED PROVING OF PROTING TO FINISHED GRADE WITH A BITANNIOLE-BASED COATING OR OTHER APPROVIED DAMPROOPING MATERIAL.
- IB. BUILDER TO VERIFY ALL SOIL
  CONDITIONS BEFORE CONSTRUCTING
  FOUNDATION. IF POOR CONDITIONS ARE
  DISCOVERED CONTACT DESIGN WORKS
  ARCHITECTURE.

### CAST-IN-PLACE CONCRETE AND REINFORCING:

- BEFORE PLACING CONCRETE REFER TO ARCHITECTURAL, MECHANICAL AND ELECTRICAL DRAWINGS FOR BLOCKOUTS AND EMBEDDED ITEMS.
- 2. CHAMPER ALL EXPOSED EDGES OF CONCRETE %'X 45 DEGREES UNLESS OTHERWISE NOTED.
- ALL ANCHOR BOLTS ARE TO BE SET WITH TEMPLATES. ANCHOR BOLT PROJECTIONS NOTED OR SHOWN ON DRAWINGS SHALL BE MEASURED FROM ROUSH CONCRETE AND NOT FROM GROUT.
- ALL REINFORCING STEEL SHALL BE CONTINUOUS AROUND CORNERS.
- 5. WELDING OF REINFORGING STEEL IS NOT
- THE USE OF DEFORMED REINFORGING STEEL OR ANCHORS ON EMBEDDED ITEMS IS NOT PERMITTED.
- SLABS ON GRADE SHALL BE REINFORCED WITH ONE LAYER 6X6 W2.9kM2.9 WELDED WIRE MESH.
- THE FOLLOWING MINIMUM PROTECTION OF REINFORCING SHALL BE MAINTAINED.
   FOOTINGS 3'
   CONCRETE EXPOSED TO EARTH OR NEATHER 2' 1/2"

### C.M.U. NOTES:

- CONCRETE MASONRY UNITS HOLLOW LOAD BEARING CONCRETE BLOCK SHALL BE 8"x16" NOMINAL FACE WITH THICKNESS AS SHOWN ON DRAWINGS.
- 2. MORTAR MORTAR SHALL BE TYPE 5.
- TRUSSED HORIZONTAL REINFORCING SHALL BE PROVIDED AT 16" O.C. HORIZONTALLY.
- BLOCKS SHALL BE LAID IN REGULAR BOND PATTERN WITH JOINTS OF %" UNIFORM THICKNESS.
- 5. WHERE VERTICAL REINFORCING IS CALLED FOR ON PLANS FILL CELLS FULL HEIGHT WITH CONCRETE OF SPECIFIED STRENGTH.
- ALL ANCHOR BOLTS TO BE SET IN MASONEY SHALL BE SET NITH TEMPLATES, ANCHOR BOLT PROJECTIONS SHOWN OR NOTED ON DRAWINGS SHALL BE MEASURED FROM TOP OF BLOCK AND NOT FROM


### FLOOR PLAN NOTES:


- ALL EXTERIOR DIMENSIONS ARE FROM OUTSIDE EDGE OF SHEATHING OR CENTERLINE OF STRUCTURAL MEMBER
- 2. ALL INTERIOR STUD DIMENSIONS ARE FROM
- 3. ALL EXTERIOR FRAMED WALLS TO BE 2x6 e
- ALL INTERIOR WALLS TO BE 2x4 16° O.C. (UN.O.)
- 6. DOUBLE TRIMMERS AT ALL 4'-O' OPENINGS


(A-2.I)

 ALL SPOT ELEVATIONS ARE TAKEN FROM O'-O" DATUM OF MAIN LEVEL SUB-FLOOR (U.N.O.)

- INDICATES (9) STUD POST, GLUED AND NAILED (U.N.O.)
- REFER TO EXTERIOR ELEVATION FOR WINDOW
- COORDINATE LOCATION OF UTILITY METERS MITH SITE PLAN AND LOCATE AWAY FROM PUBLIC VIEW, VISUAL IMPACT SHALL BE MINIMIZED, I.E. MOUNT AS LOW AS POSSIBLE.
- CONTRACTOR TO COORDINATE ALL CLOSET SHELVING AND CABINETRY REQUIREMENTS, CONTRACTOR TO FIELD VERIFY ALL CABINET DIMENSIONS PRIOR TO FABRICATION.
- PREFABRICATED FIREPLACE CONSTRUCTION SHALL MEET OR EXCEED ALL APPLICABLE CODES NEGACIONIO USE OF PIRE SEPARATION CODES NEGACIONIO USE OF PIRE SEPARATION MEET OR EXCEED CODE. OVERALL FILLE HEIGHT SHALL BE COORDINATED TO MATCH REPORT SHAND ON FLANS, AND SHALL NOT EXCEED THE TOP OF CHARBET OF ASSET AS CONSTRUCTION.
- PROVIDE COMBUSTION AIR VENTS, WITH SCREEN AND BACK DAMPER, FOR FIREPLACES, WOOD STOVES AND ANY APPLIANCE WITH AN OPEN FLAME.
- BATHROOMS AND UTILITY ROOMS SHALL BE VENTED TO THE OUTSIDE WITH A MINIMAN OF A TO GTH FAN, OR WITH A HHOLE HOUSE VENTILATION HEAT RECOVERY SYSTEM. RANSE HOODS SHALL ALSO BE VENTED TO THE OUTSIDE.
- RANGE HOODS WITH A CFM OF 400 OR GREATER SHALL BE PROVIDED WITH MAKEUP AIR FROM EXTERIOR TO MAINTAIN NEUTRAL INTERIOR AIR PRESSURE.

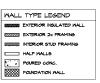

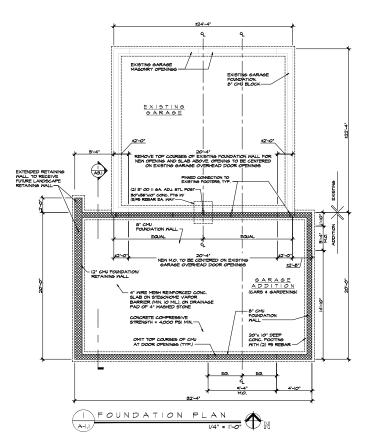

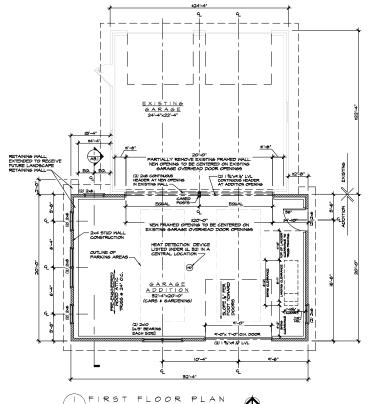

DESIGN Main PURPOSES CONSTRUCTION Addition <u>⊇</u> 4048 EAST AVE Town of Pittsford Monroe County, NY Cough 960 Dan Garag FOR USED [T] B Scale:
AS NC
Drawn by:
AMM
Checked by:
Checked by: 70 NOT SET PRELIMINARY

્રં

rork orks.

New

KKS RE

WORK ECTUR

Z

ш


### CONSTRUCTION AND FRAMING NOTES:

- JOISTS, HEADERS, AND BEAMS SHALL BE EASTERN HF no. 2 OR BETTER UNLESS NOTED OTHERWISE.

   F. To-lioo PSI, FV=TS PSI,
  E-1,500,000

   DOUS FIR. Fb=1400 PSI, FV=45 PSI,
  E-1,400,000
- ALL HEADERS SHALL BE FREE FROM ALL SPLITS, CHECKS OR SHAKES.
- "LVL" BEAMS SHALL HAVE BENDING STRESS FB=2600 PSI. E= 2.0M PSI.
- BEAMS TO FOUNDATION POCKETS SHALL HAVE [6" CLEARANCE FROM MASONRY [6" AIRSPACE THREE (3) SIDES IW STEEL SHIMS AND SOLID CMU CORES AT BEARINS).
- 6. UNLESS OTHERNISE NOTED PROVIDE A 2x PLATE BOLITED TO TOP FLANGE OF ALL STEEL BEAMS WITH %" DIAMETER BOLTS STAGGERED AT 48" ON CENTER.
- ALL WOOD PLATES IN CONTACT WITH CONCRETE SHALL BE 'PRESSURE TREATED' UNLESS SEPARATED BY SILL SEALER MATERIAL,
- ALL WOOD IN CONTACT WITH THE GROAD, EMBEDDED IN CONCRETE IN DIRECT CONTACT WITH THE GROAD, OR EMBEDDED IN CONCRETE EXPORED TO THE NEATHER THAT SUPPORTS PREVANENT STRUCTURES SHALL BE APPROVED PRESSURE-PRESSERVATIVE-TREATED MOOD SUITABLE FOR GROADE CONTACT USE.
- IO. DOUBLE FLOOR JOISTS AT FLOOR OPENINGS.
- II. PROVIDE DOUBLE STUDS (MIN.) UNDER BEAMS W SOLID BLKG, TO FNDN, (NV SOLID CMU CORES AT POINT LOAD), COL. OR BEAM FOR PROPER SUPPORT AND LOAD TRANSFER.
- FLOOR CONSTRUCTION, %" TONGUE AND GROOVE ADVANTECH SUBFLOOR, GLUED AND NAILED (U.N.O.)
- IS. FLOOR FRAMING LAYOUT SHALL BE COORDINATED WITH GENERAL AND HVAC CONTRACTORS TO PROVIDE ACCESS CHASES AND UNOBSTRUCTED RUNS FOR HVAC DUCT WORK.
- 14. ALL INTERIOR WALLS SHALL BE COVERED WITH ½"
  SYPSUM BOARD, WITH METAL CORNER
  REINFORCING, TAPE FLOAT AND SAND, (3 COATS) KEINFORCING, TAPE FLOAT AND SAND, (3 COATS)
  USE \$1, 67PSUM BOARD ON CEILINGS NIEN
  SUPPORTING MEMBERS ARE 24" O.C. OR GREATER,
  USE \$1, 6YPSUM BOARD ON CEILING MEMBERS LESS
  THAN 24" O.C.

- ALL WALLS TO RECEIVE TILE SHALL BE CEMENTITIOUS BACKER BOARD IN SHOWERS AND AROUND TUBS.
- I6. USE (I) LAYER \$' FC TYPE "X" SYPSUM BOARD & SARASE MALLS AND CEILINGS. CEILING TO BE \$' FIRE CODE TYPE X IF HABITABLE SPACE ABOVE ALL JOINTS TO BE TAPED, SEALED AND PAINT FINISH.
- MINDOW AND EXTERIOR DOOR HEADERS AS NOTED ON PLAN.
- IB. PROVIDE REQUIRED FLASHINS TO MEET OR EXCEED ACCEPTABLE COMMON BUILDING PRACTICE WHERE RISED AND AT ROOF CHANGES, HORIZ. ABUTMENTS (PORCHES & DECKS), PROJECTIONS, VALENTS, OPENINGS... ETC.
- ALL PRE-ENGINEERED ROOF & FLOOR SYSTEMS TO BE CERTIFIED BY THE MANUFACTURER. INCLUDING FINAL SIZING AND ENGINEERING, PRIDGING AND BLOCKING, THRUPHETRATIONS, BEARING CONDITIONS AND CONNECTIONS.
- PROVIDE BRIDGING MERRE JOISTS EXCEEDING A NOMINAL 2 INCHES BY (2 INCHES SHALL BE SPROKTED CATREALLY BY BLOCKING, DIAGONAL BRIDGING (MOOD OR METAL), OR A CONTINUOUS I INCH BY 3 INCH STRIP MALID ACROSS THE BOTTOM OF JOISTS PERPENDICILAR TO JOISTS AT INTERVALS NOT EXCEEDING 5 FIET.
- PROVIDE RUST-INHIBITIVE PAINT TO STEEL COLUMNS EXCEPT FOR CORROSION RESISTANT OR TREATED STEEL.
- 22. ALL AREAS OF HABITABLE SPACE WILL BE PROVIDED WITH OPENINGS FOR EMERGENCY EGRESS OF 5 5° AT FIRST FLOOR AND 5.1 5° AT SECOND FLOOR. ALL SILLS TO BE WITHIN 44° OF FINSH FLOOR FOR ESRESS OPENINGS.
- 23. FIRE BLOCKING SHALL BE PROVIDED IN CONCEALED MALL AND STAIR SPACES AT THE FLOOR AND CEILING (ALSO 12" SING ON INDEPENDE OF STAIRS IN INCOMED ACCESSIBLE SPACES), PORRED SPACES AT INTERVALS NOT EXCEEDING 10 FT, CONCEALED JOIST SPACES AT BEANS AND BERRING MAD BERRING MAD DEPARTS AND BEANS AND BERRING MAD DEPARTS AND DEPARTS AND
- 24. ALL 6AS APPLIANCES TO BE DIRECTLY VENTED TO ROOF OR EXTERIOR TERMINATION ADDRESSIN ALL REQUIREMENTS PER MANIFACTURERS SPECIFICATIONS.
- 25. FOR INSULATION VALUES, REFER TO RESCHECK.

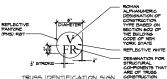

TRUSS IDENTIFICATION SIGN

Ψ.	FLOOR FRAMING, INCLUDING GIRDERS AND BEAMS
·R·	ROOF FRAMING
TR.	FLOOR AND ROOF FRAMING



HEAD

### ROOF & ATTIC NOTES:

, APPROVED BITUTHANE WATER SHIELD PRODUCT (Ia, GRACE ICE AND WATER SHIELD) TO BE APPLIED TO ALL EAVES AND VALLEYS.

ROOF PITCH	9:12 OR LE95	9:12 - 6:12	6:12 OR GREATER
WATER SHEILD *	ENTIRE ROOF	5'-0"	3-0"

- \* DIMENSION FROM EXTERIOR FACE OF WALL UP ROOF SLOPE
- USE A RUBBER MEMBRANE ROOF ON ALL ROOFS WITH A PITCH OF LESS THAN 3:12.
- 2. SO# FELT RECOMMENDED UNDER METAL ROOF (IF APPLICABLE).
- S. ENLIGHED ATTIC SPACES MIGHT HAVE A HIN NET FREE
  VENTLATING AREA OF 160 OF THE AREA OF VENTED SPACE,
  WITH THE EXCEPTION OF 566 BRIGH ALLOWED IN CILIMATE ZONES
  INSTALLED ON THE WARM-IN-MINITER SIDE OF THE CELLING OR
  NOT LESS THAN 4-06 AND INFORMET THAN 500 OF THE
  REQUIRED VENTLATING AREA IS PROVIDED BY VENTLATIONS IN
  THE UPPER PROVINCIA OF THAT OR RAPITER SPACE (1806-03).
- ROOF CAVITIES THAT EXCEED 30 SF, REQUIRE ACCESS OF 22%20' WITH HEADROOM ABOVE THE OPENING OF AT LEAST 30' MOST BE LOCATED IN A HALLMAY OR OTHER READILY ACCESSIBLE LOCATION (R-801).

- FROVIDE REQUIRED FLASHING TO MEET OR EXCEED COMMON BUILDING PRACTICE IN-ERE REQUIRED AND AT ROOF CHANGES, PROJECTIONS, VALLEYS, ETC. INSTALL DIVERTIES FLASHING AYALY FROM INVERE THE EAVE OF A SLOPED ROOF INTERSECT A VERTICAL SIDEMAIN.
- 6. FINAL ON CENTER ROOF RAFTER LAYOUT BY BUILDER.
- BUILDER TO MAINTAIN PROPER VENTILATION GAP PER DETAILS IN ALL RAFTER BAYS.

ý.

WORKS

Z

ш


AVE Sford tu. N

4048 EAST AV Town of Pittsfor Monroe County, 1

FINAL GUTTER AND DOWNSPOUT SIZES AND LOCATIONS TBD BY SITE ENGINEER, OWNER, AND/OR CONTRACTOR. DOWNSPOUTS SHALL BE TIED INTO STORM NATER SYSTEM IF AVAILABLE OR EMPTY ONTO SPLASHBLOCKS.


### TRUSSES (IF APPLICABLE TO PROJECT)

- 9. TRUSSES SHOWN AS CONCEPTUAL DESIGN ONLY.
- IO. TRUSSES TO BE ENGINEERED AND SUPPLIED BY CERTIFIED TRUSS MANUFACTURER.
- II. FINAL DESIGN BY TRUSS MANUFACTURER TO BE APPROVED BY OWNER PRIOR TO FABRICATION.
- PROVIDE HURRICANE TIE FOR EACH TRUSS, USE SIMPSON H2.5 UNLESS NOTED OTHERWISE.

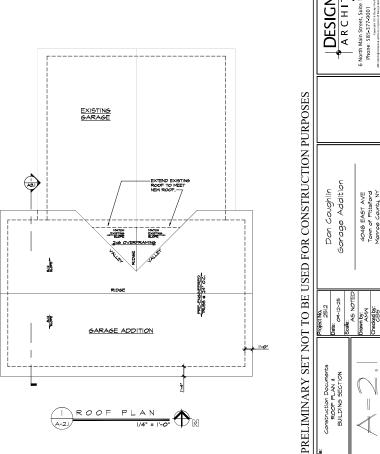


ROOF PLAN

- A N

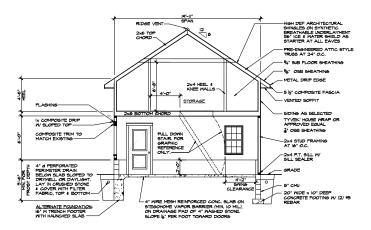

3 BUILDING SECTION 1/4" = 1'-0'

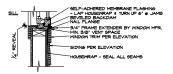

3/8" MIN. VENT SPACE HOUSEARAP


1/4" REVEAL


WINDOW TRIM PER ELEVATION 9/8" MIN. VENT SPACE

HOUSEARAP - FOLD INWARD AS JAMB LINER - JAMB EXTENSION AS REQ'D

JAMB EXIDION AS READ
HOUSEMRAP - SEAL ALL SEAMS
NAIL FLANGE
SELF-ADHERED MEMBRANE FLASHING

2 WINDOW DETAILS I-I/2" = I'-0"

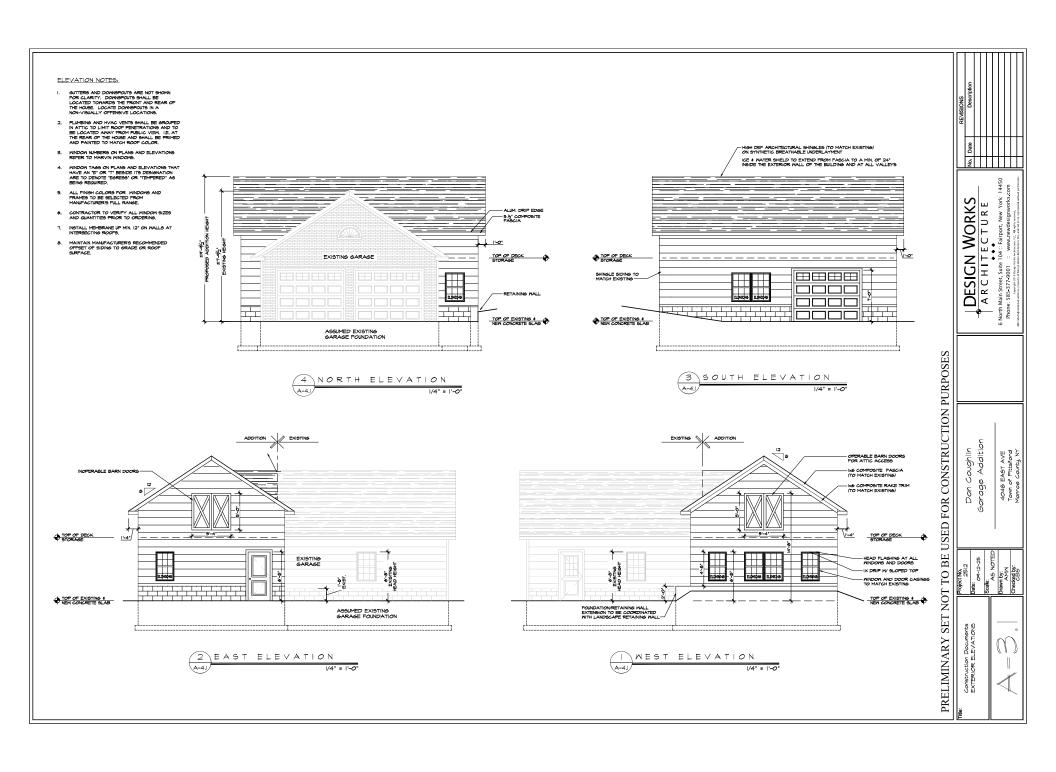

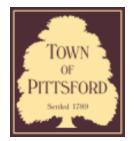

## **Town of Pittsford**

Department of Public Works 11 South Main Street Pittsford. New York 14534

Permit # B25-000126

Phone: 585-248-6250 FAX: 585-248-6262

# DESIGN REVIEW AND HISTORIC PRESERVATION BOARD REFERRAL OF APPLICATION

Property Address: 21 Barrington Hills PITTSFORD, NY 14534

**Tax ID Number:** 177.08-1-10

Zoning District: RN Residential Neighborhood

Owner: Luthra, Vinod K

**Applicant:** Barrington Residential

### **Application Type:**

-12 12		
<b>✓</b>	Residential Design Review §185-205 (B)	Build to Line Adjustment §185-17 (B) (2)
	Commercial Design Review §185-205 (B)	Building Height Above 30 Feet §185-17 (M)
	Signage §185-205 (C)	Corner Lot Orientation §185-17 (K) (3)
	Certificate of Appropriateness §185-197	Flag Lot Building Line Location §185-17 (L) (1) (c)
	Landmark Designation §185-195 (2)	Undeveloped Flag Lot Requirements §185-17 (L) (2)
	Informal Review	


**Project Description:** Applicant is requesting design review for an approximately 103 square foot addition to existing home.

Meeting Date: October 23, 2025

# Residential Neighborhood Zoning





10/15/2025, 1:57:39 PM

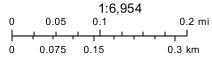

Town of Pittsford GIS

The information depicted on this map is representational and should be used for general reference purposes only. No warranties, expressed or implied, are provided for the data or its use or interpretation.

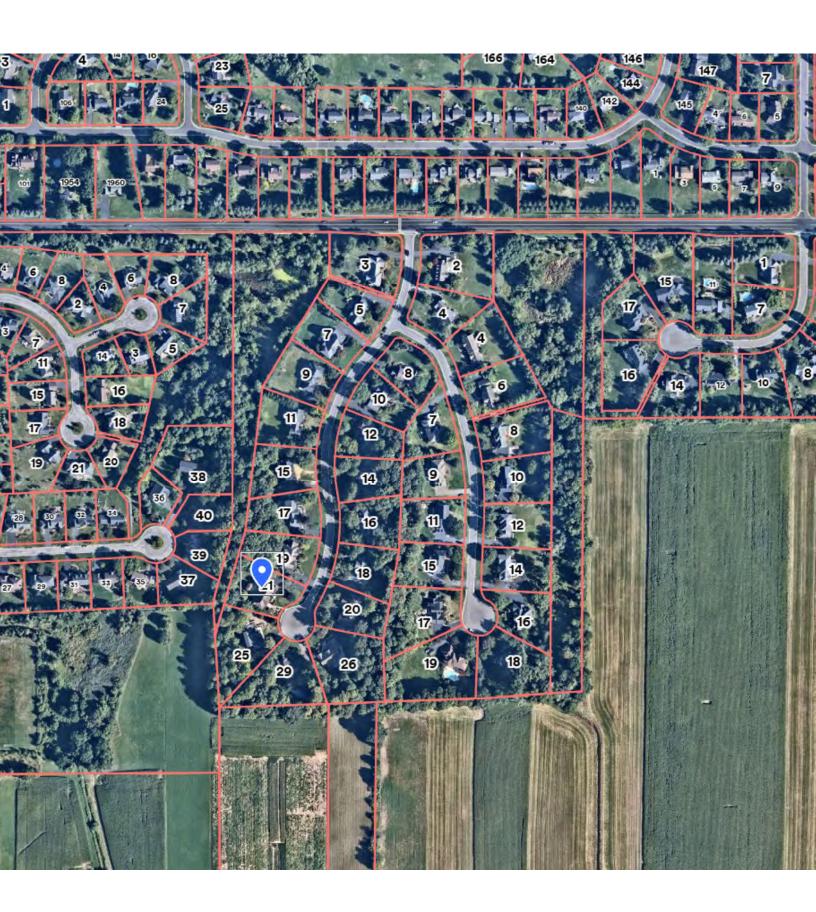

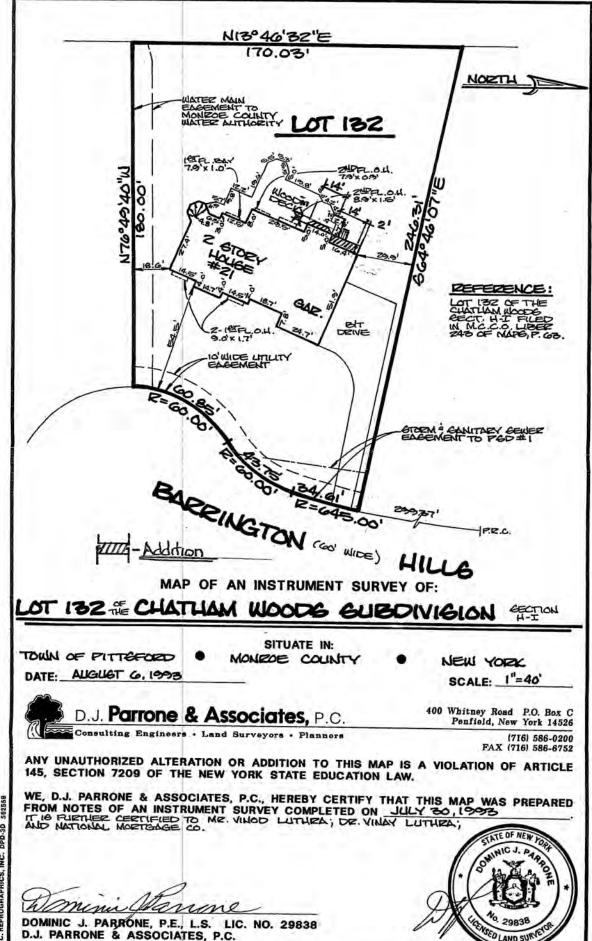

# ADDITION/RENOVATION

LUTHRA RESIDENCE
21 BARRINGTON HILLS
PITTSFORD, NEW YORK

# CLIENT:

VINOD & VINAY LUTHRA 21 BARRINGTON HILLS PITTSFORD, NEW YORK

# ARCHITECT:

JAMES FAHY DESIGN ASSOCIATES
ARCHITECTURE & ENGINEERING P.C.
2024 W. HENRIETTA RD., SUITE 3K
ROCHESTER, NY 14623
TEL. (585) 272-1650
E-MAIL: INFO@JAMESFAHY.COM
WEBSITE: WWW.JAMESFAHY.COM

# **DRAWING INDEX:**


# ARCHITECTURAL:

- T1.0 TITLE SHEET
- T2.0 MATERIAL & GUIDE SPECIFICATIONS
- T3.0 2020 ECCCNYS REQUIREMENTS
- T4.0 ARCHITECTURAL ABBREVIATION & SYMBOL INDEXES
- A1.0 ELEVATIONS
- A2.0 DEMOLITION & PROPOSED FOUNDATION PLAN
- A3.0 DEMOLITION & PROPOSED FIRST FLOOR PLAN
- A4.0 NOT USED
- A5.0 NOT USED
- A6.0 SECTIONS, TYP. WALL SECTIONS & DETAILS


# STRUCTURAL:

S1.0 ROOF FRAMING PLAN

mes Fahy Design Associa chitecture & Engineering Faw. Henrietta Rd. Suite 3K rester, New York 14623 585) 272-1650 all: info@jamesfahy.com site: www.jamesfahy.com

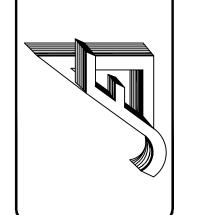

DDITION/RENOVATI
21 BARRINGTON HILLS
PITTSFORD, NEW YORK

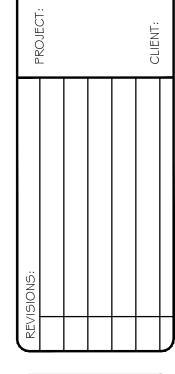

JOB NO.
A25-087

PROJECT NO.
ADDITION


CONSTRUCTION DOCUMENTS


DATE:

DRAWING NO.

10-10-2025

TI.0

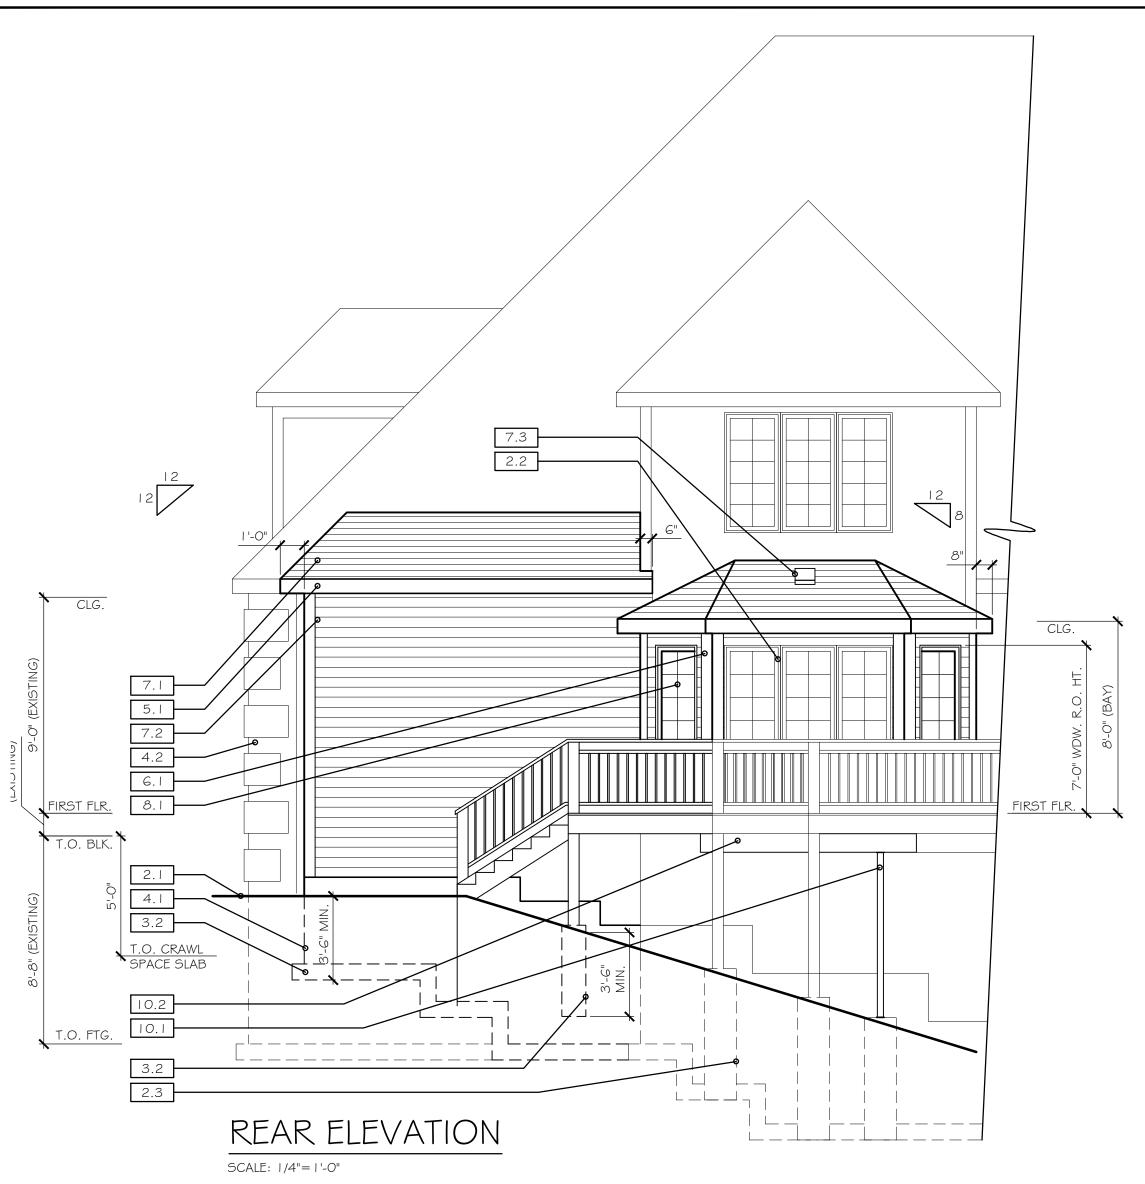

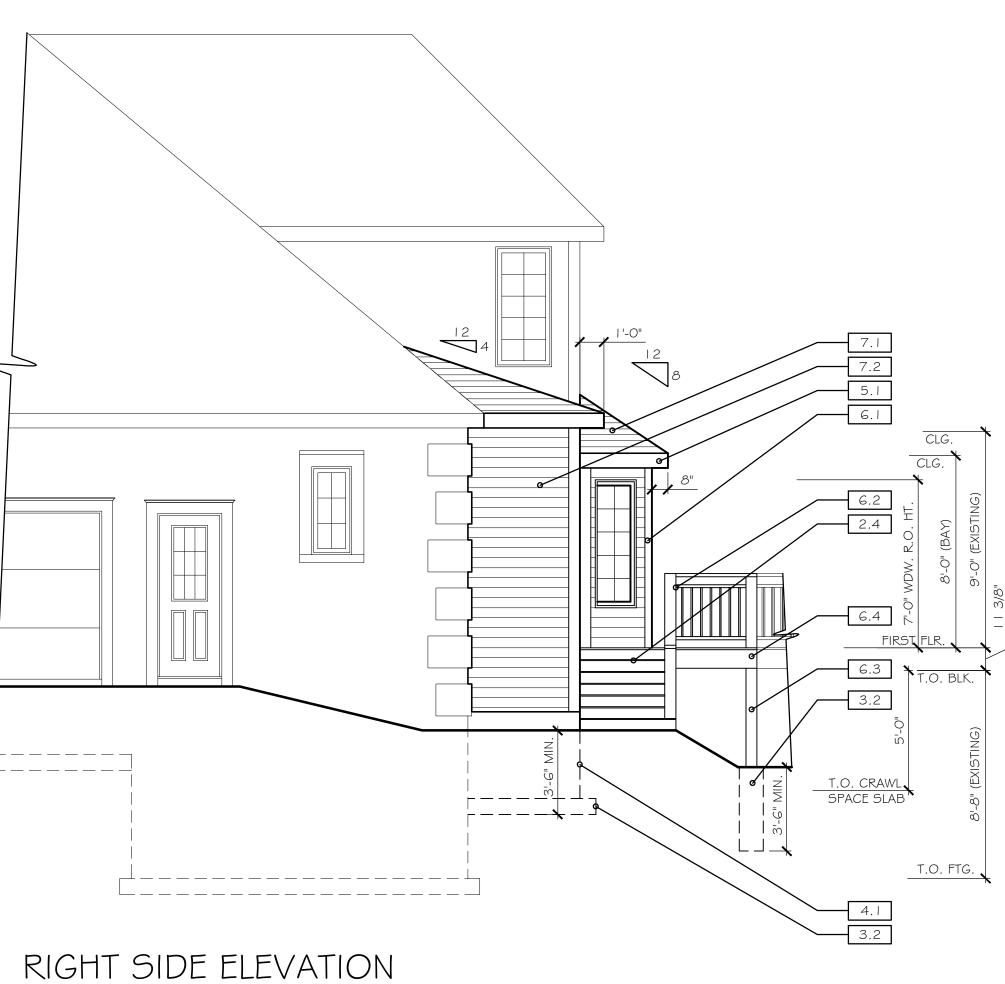

SCALE: 1/4"=1'-0"

# ELEVATION SPECIFICATION NOTES: ALL EXTERIOR ROOFING, SIDING, TRIM, & FASICA TO MATCH EXISTING

2.2 EXISTING WINDOW TO BE REMOVED \$ REUSED @NEW BAY

2.3 EXISTING 'SONOTUBE' FOOTING TO REMAIN

2.4 REMOVE & REUSE EXISTING DECK STAIRS

3. I CONCRETE SPREAD FOOTING. REFER TO FOUNDATION PLAN FOR SIZING

3.2 | 2"Ø CONCRETE 'SONOTUBE' FOOTING

# 4.0 MASONRY

4. I CONCRETE BLOCK FOUNDATION WALL, REFER TO FOUNDATION PLAN FOR SIZING

5.1 5" ALUMINUM 'K' GUTTER WITH DOWNSPOUTS

# S.O WOODS, PLASTICS & COMPOSITES

6.2 6" P.T. POST & RAILING TO MATCH EXISTING

6.3 6" P.T. POST TO CONCRETE FTG.

6.4 DECKING TO MATCH EXISTING O/ P.T. 2x10 DECK JST. @16" O.C.

### 7.0 THERMAL & MOISTURE PROTECTION

7. I 25 YEAR MIN. ARCHITECTURAL FIBERGLASS / ASPHALT SHINGLES. MFR., TYPE & COLOR T.B.D. 7.2 VINYL CLAPBOARD SIDING. MFR., TYPE \$ COLOR T.B.D.

# 7.3 ROOF VENT AS SELECTED

8.0 OPENINGS 8. I ANDERSEN 400 SERIES LOW E CASEMENT WINDOW

# U-VALUE .30 \$ SHGC .29

0.0 SPECIALTIES 10.1 3"Ø STEEL COLUMN

# 10.2 W8x10 STEEL BEAM

26.1 PROVIDE WALL OR CEILING MOUNTED LIGHTING AT ENTRY DOORS AND OVERHEAD GARAGE DOOR LOCATIONS.

31.1 GRADE VARIES (REFER TO SITE ENGINEERS GRADING PLAN)

# PRESCRIPTIVE ENERGY EFFICIENCY

THIS BUILDINGS THERMAL ENVELOPE CONFORMS TO THE MINIMUM PRESCRIPTIVE REQUIREMENTS SET FORTH IN SECTION 402 AND TABLE 402.1.2 (PARTIAL SHOWN BELOW) IN THE 2020 ENERGY CONSERVATION CONSTRUCTION CODE OF NEW YORK STATE FOR CLIMATE ZONES 5 \$ 6.

### PARTIAL TABLE R402.1.2 INSULATION AND FENESTRATION REQUIREMENTS BY COMPONENT a

INSOLYTION AND TENESTICE	TON RECONCINENTS DI COM	I ONEMI a
ENVELOPE COMPONENT	REQD. ZONE 5	<u>ACTUAL</u>
FENESTRATION U-FACTOR b SKYLIGHT U-FACTOR ceiling R-Value WOOD FRAME WALL R-VALUE MASS WALL R-VALUE FLOOR R-VALUE BASEMENT WALL R-VALUE SLAB R-VALUE \$ DEPTH d CRAWL SPACE WALL R-VALUE c	0.30 0.55 49 20 or  3+5 <sup>h</sup>  3/17 30 <sup>g</sup>  5/19  0, 2ft  5/19	0.30 NA 49 TOTAL 2 I NA 30 I 5, FULL HT. NA NA

### For SI: I foot = 304.8 mm.

a. R-values are minimums. U-factors and SHGC are maximums. When insulation is installed in a cavity which is less than the label or design thickness of the insulation, the installed R-value of the insulation shall not be less than the R-value specified in the table.

b. The fenestration U-factor column excludes skylights. The SHGC column applies to all glazed fenestration. Exception: Skylights may be excluded from glazed fenestration SHGC requirements in

climate zones I through 3 where the SHGC for such skylights does not exceed 0.30. c. "15/19" means R-15 continuous insulation on the interior or exterior of the home or R-19 cavity insulation at the interior of the basement wall. "15/19" shall be permitted to be met with R-13 cavity insulation on the interior of the basement wall plus R-5 continuous insulation on the interior or exterior

d. R-5 shall be added to the required slab edge R-values for heated slabs. Insulation depth shall be

"10/13" means R-10 continuous insulation on the interior or exterior of the home or R-13 cavity insulation at the interior of the basement wall.

- the depth of the footing or 2 feet, whichever is less in Climate Zones 1 through 3 for heated slabs. e. There are no SHGC requirements in the Marine Zone.
- f. Basement wall insulation is not required in warm-humid locations as defined by Figure R301.1 and
- g. Or insulation sufficient to fill the framing cavity, R-19 minimum. h. The first value is cavity insulation, the second value is continuous insulation, so "13+5" means
- R-13 cavity insulation plus R-5 continuous insulation.

1. The second R-value applies when more than half the insulation is on the interior of the mass wall. R402.2.2 CEILINGS WITHOUT ATTIC SPACES (VAULTED CEILINGS

WHERE SECTION R402.1.2 REQUIRES INSULATION R-VALUES GREATER THAT R-30 IN THE CEILING AND THE DESIGN OF THE ROOF / CEILING ASSEMBLY DOES NOT ALLOW SUFFICIENT SPACE FOR THE REQUIRED INSULATION, THE MINIMUM REQUIRED INSULATION R-VALUE FOR SUCH ROOF / CEILING ASSEMBLIES SHALL BE R-30. INSULATION SHALL EXTEND OVER THE TOP OF THE WALL PLATE TO THE OUTER EDGE OF SUCH PLATE AND SHALL NOT BE COMPRESSED. THIS REDUCTION OF INSULATION FOR THE REQUIREMENTS OF SECTION R402.1.2 SHALL BE LIMITED TO 500 SQUARE FEET OR 20 PERCENT OF THE TOTAL INSULATED CEILING AREA, WHICHEVER IS LESS. THIS REDUCTION SHALL NOT APPLY TO THE U-FACTOR ALTERNATIVE APPROACH IN SECTION R402.1.4 AND THE TOTAL UA ALTERNATIVE IN SECTION R402.1.5.

# GENERAL CONSTRUCTION NOTES

- . Construction shall conform to the 2020 Residential Building code of New York State
- B. Comply with all local, state and federal codes and regulations. General Contractor is responsible for all materials, construction methods
- D. General Contractor to verify all existing conditions, requirements, notes and dimensions prior to start of construction. Notify the Architect if conditions
- vary from those shown on the documents. E. General Contractor to provide adequate support of existing foundation walls, load bearing walls and partitions during demolition and construction. . Contractors are responsible for coordinating work with other trades
- wherever they overlap. G. When materials and/or finishes are found to be absent, or when existing way, contractor shall provide patching, painting and materials of same type and
- quality as to match adjacent existing surfaces unless otherwise noted. H. Provide all blocking, furring and shimming as necessary for installation and completion of the work.
- I. All new work shall be plumb, level and square. Scribe and make fit all new work to existing. J. All details are subject to change due to existing field conditions. Contractor
- must notify owner and architect of same. K. All dimensions are face of wall to face of wall (rough).
- $\overline{16}$ " o.c. as noted. M. No site visits will be made by this Architect. Contractor shall assume all
- responsibility for changes to these drawings. N. Coordinate interior doors/hardware, wood trim and finishes, and exterior finish materials (siding, roofing etc.) to match existing. Final selection by owner
- and general contractor unless otherwise specified. O. Call UFPO before you dig. 1-800-962-7962 P. All exterior below-grade walls to receive one (1) coat foundation coat and
- two (2) coats of tar Q. Coordinate the installation of continuous aluminum gutters and downspouts to match existing. Downspouts are to be located in field and approved by owner. All downspouts are to run to precast concrete splashblocks, or to
- underground conductors per local code. R. Design and coordination of all sitework, including finish grading and
- hydroseeding, by contractor. <u>3.</u> Design and coordination of electric, plumbing, and HVAC system installation by contractor. Verify capacity and location of existing utilities/services prior to construction.

of the construction and major architectural elements of construction.

T. To the best of our knowledge, belief and professional judgment, these plans are in compliance with the State of New York Energy Code. J. These documents do not purport to show all items and procedures required for a complete installation. The intent is to indicate the general scope for the project, in terms of the architectural design concept, the location/dimensions

# GENERAL DEMOLITION NOTES

- It is the contractor's responsibility to familiarize themselves with all details involved in selective demolition. Specific instructions on each item will not be
- All plumbing, electrical and HVAC fixtures, doors, trim and any other items which the owner indicates they want to save shall be removed by the contractor, stored and maintained in good condition per the owner's directions for future reuse. The owner shall provide the contractor with the list of all such
- C. Contractor to remove all existing walls, doors, and finishes not shown to remain. Infill wall openings as required and patch surfaces to match adjacent
- D. Remove all existing lighting, wiring, and devices as required to complete work. Remove all abandoned conduit and wire. Terminate at nearest active
- Remove all existing water, sewer, storm and vent piping as required to complete work. Remove all abandoned piping. Cap at nearest active main or
- F. Remove all existing ductwork, piping and related HVAC systems as required to complete work. Cap all ductwork and piping at nearest active main riser. Coordinate removal of all associate power and plumbing services with other
- . Contractor may be required to go beyond the contract area to reach the first shutoff valve, main or electrical panel. When this happens, the contractor
- shall remove and repair existing finish surfaces as required. H. All existing floor, wall and ceiling finishes in areas to be renovated shall be removed down to subfloor/rough framing as required. Prepare existing surfaces
- to receive new finish materials. I. The contractor shall be responsible for the salvage of existing materials as required for patching existing areas to remain. Wherever removals occur, disturbed surfaces should be patched to match adjacent existing.
- J. The contractor shall coordinate the demolition work with the owner's use of the premises. All work to be scheduled and coordinated with owner.
- K. The contractor shall provide fireproof and dustproof partitions around the construction area during all demolition and construction work. . The contractor shall maintain safe access to all designated exits for the
- building occupants during construction. M. Storage for contractor's equipment and debris must be kept inside the contract area.
- N. Dumpsters for construction debris are to be provided by contractor. All debris to be hauled off site upon removal by contractor. O. If materials are suspected to contain asbestos, contractor is to immediately
- inform owner and architect. All existing materials known to contain asbestos that are to be removed should be done so in accordance with established A.H.E.R.A. regulations.

COPYRIGHT NOTICE: THESE PLANS ARE PROTECTED UNDER FEDERAL COPYRIGHT LAWS BY JAMES FAHY DESIGN. ANY REPRODUCTION, OR MODIFICATION OF THESE PLANS, IN WHOLE OR IN PART, WITHOUT THE EXPRESS WRITTEN CONSENT OF JAMES FAHY DESIGN IS A VIOLATION OF COPYRIGHT LAWS. CLIENT RIGHTS ARE LIMITED TO ONE-TIME USE FOR CONSTRUCTION OF THESE PLANS.

UNAUTHORIZED ALTERATIONS OR ADDITIONS TO THIS DRAWING IS A VIOLATION OF THE NEW YORK STATE EDUCATION LAW, ARTICLE 145, SECTION

Copyright © 2025 James Fahy, P.E., P.C All rights reserved.

NO.	DATE	BY	DESCRIPTION
-+			
-+			
		1	
_			
-+			
		1	
$\dashv$			
$\dashv$			
$\dashv$		+	

PROJECT:

ADDITION/RENOVATION 21 BARRINGTON HILLS PITTSFORD, NY

VINOD LUTHRA

DRAWING TITLE:

REAR & RIGHT SIDE ELEVATIONS


CONSTRUCTION DOCUMENTS


	JOB NO. A25-087	PROJECT NO. ADDITION
	DRAWN BY: DAY	DRAWING NO:
	CHECKED BY: JRF	$A \cap A$
	DATE.	

10-10-2025

tel: 585-272-1650

e-mail: info@jamesfahy.com website: www.jamesfahy.com

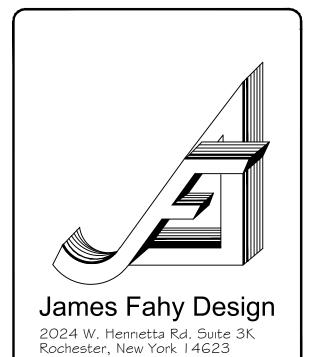

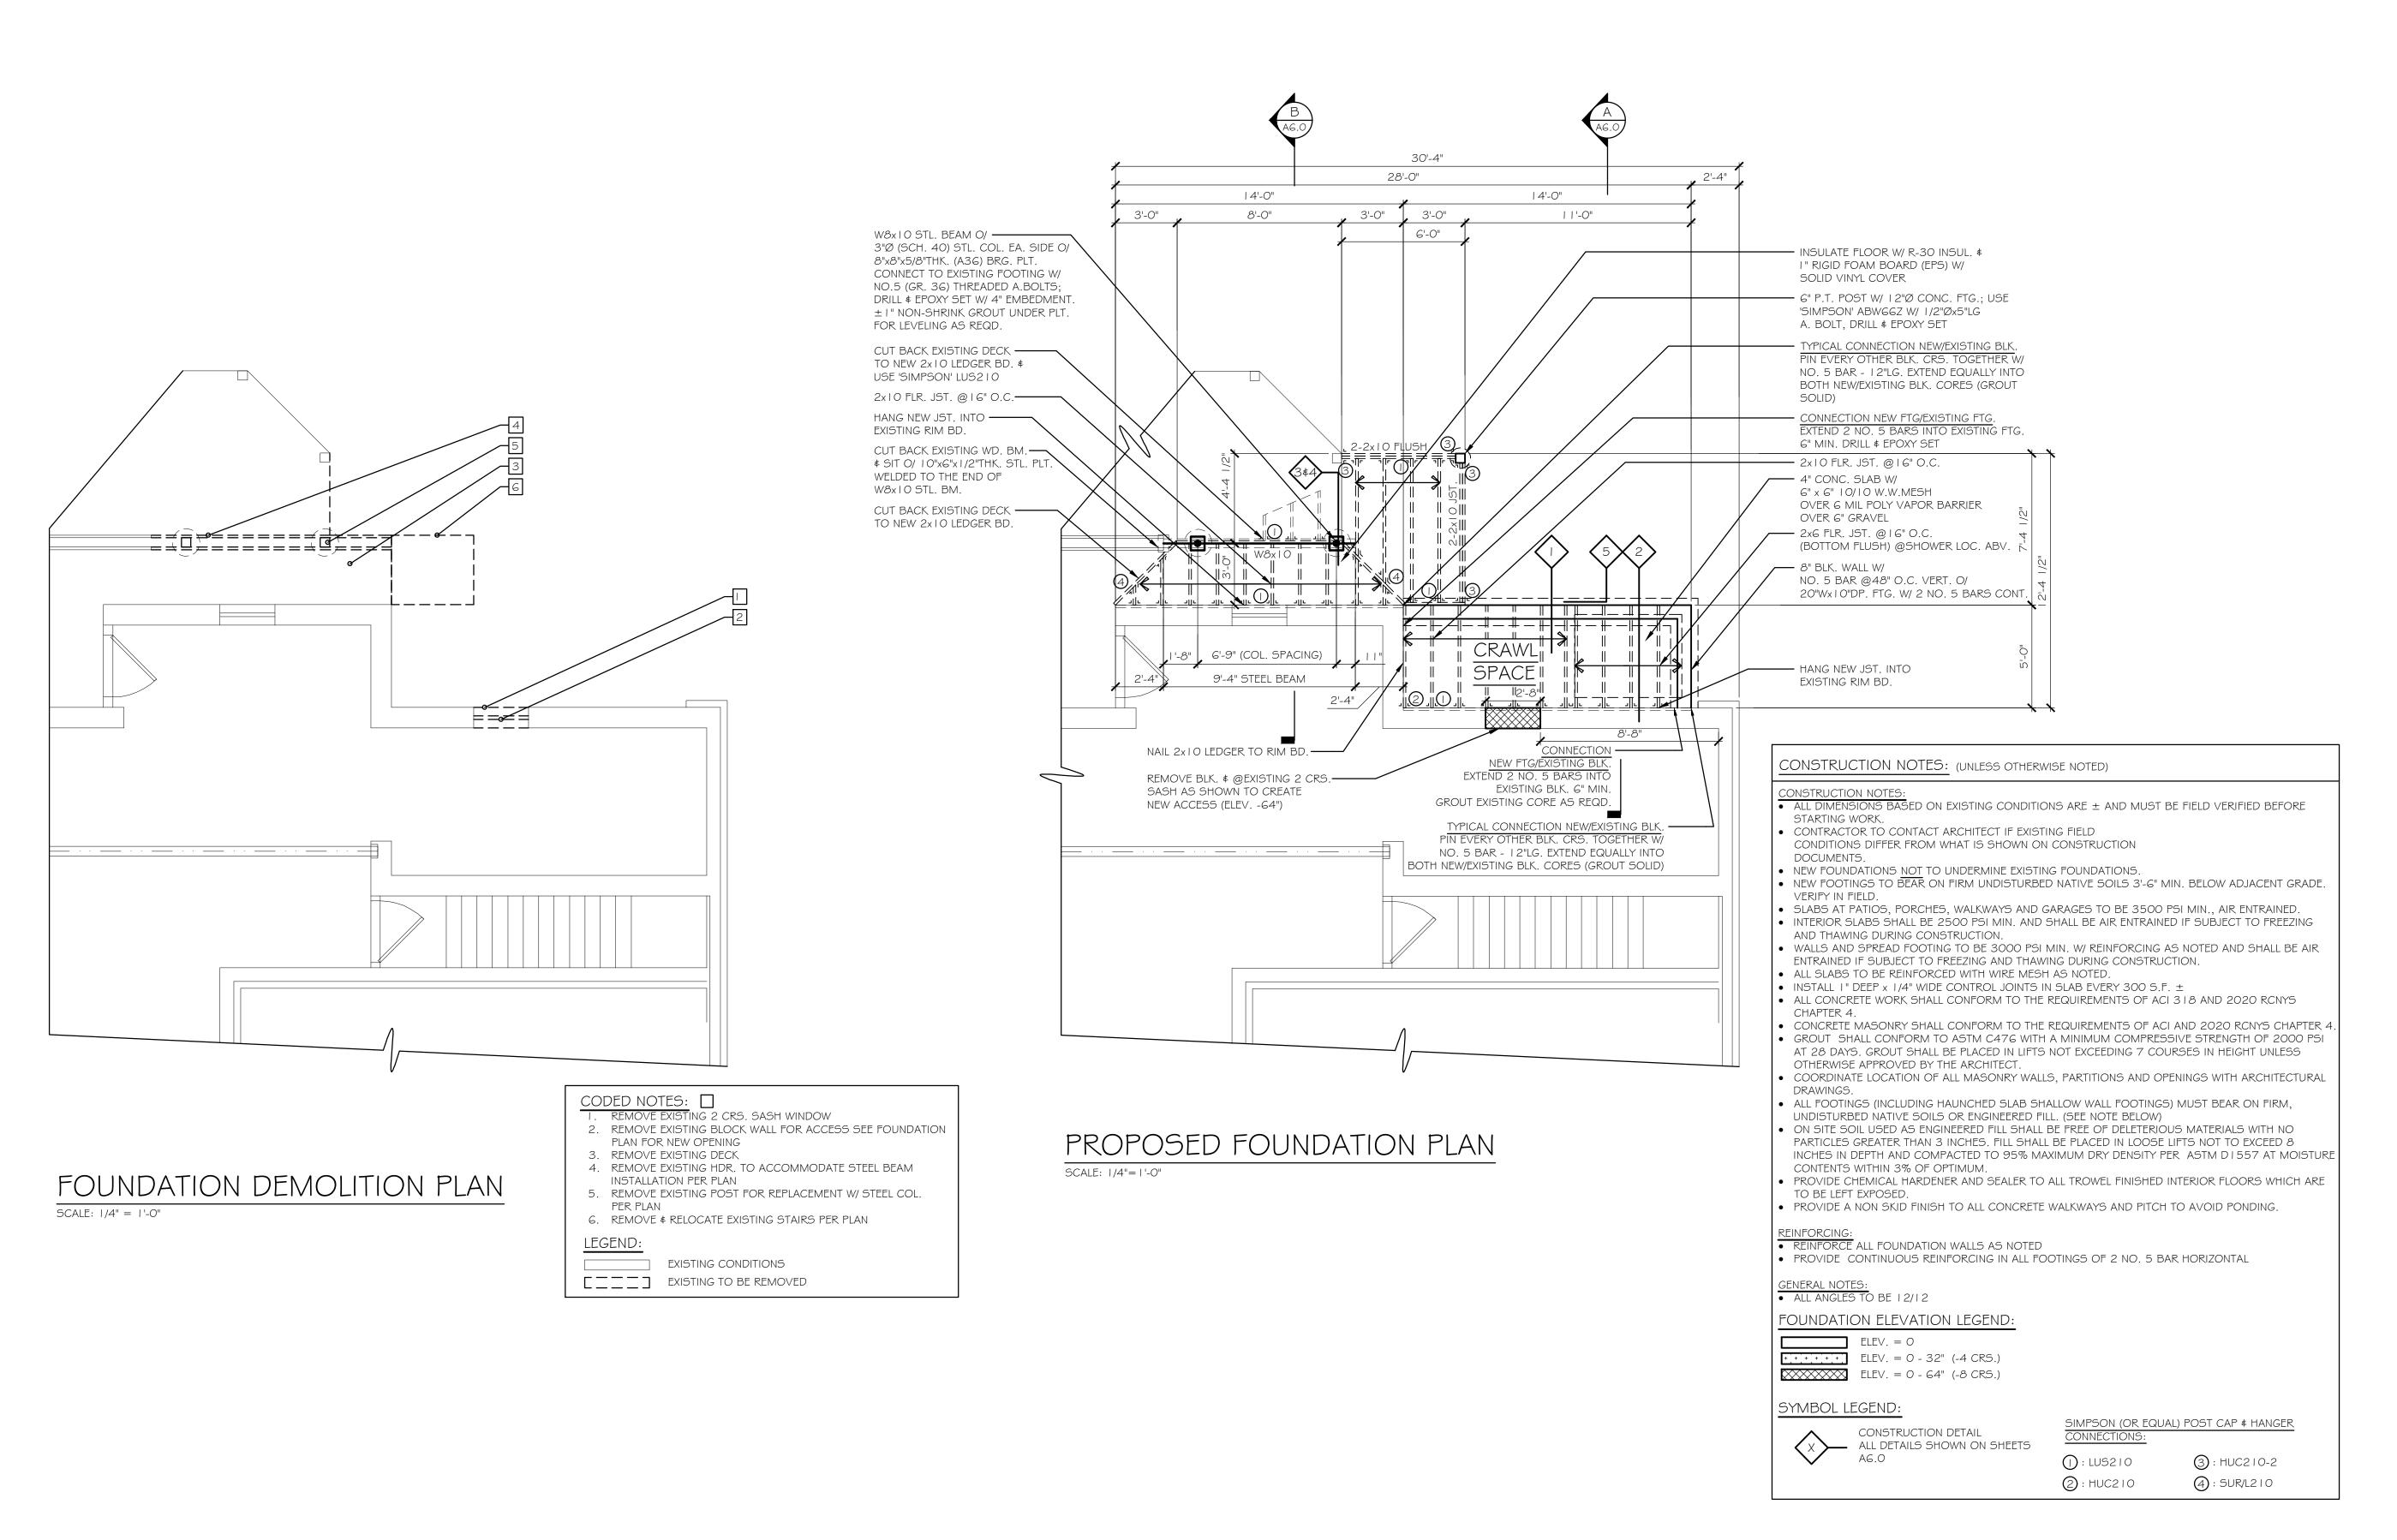

COPYRIGHT NOTICE:
THESE PLANS ARE PROTECTED UNDER FEDERAL
COPYRIGHT LAWS BY JAMES FAHY DESIGN. ANY
REPRODUCTION, OR MODIFICATION OF THESE
PLANS, IN WHOLE OR IN PART, WITHOUT THE
EXPRESS WRITTEN CONSENT OF JAMES FAHY
DESIGN IS A VIOLATION OF COPYRIGHT LAWS.
CLIENT RIGHTS ARE LIMITED TO ONE-TIME USE
FOR CONSTRUCTION OF THESE PLANS.

UNAUTHORIZED ALTERATIONS OR ADDITIONS TO THIS DRAWING IS A VIOLATION OF THE NEW YOR STATE EDUCATION LAW, ARTICLE 145, SECTION

Copyright <sup>©</sup> 2025 James Fahy, P.E., P.C. All rights reserved.

МО	DATE	BY	DESCRIPTION
N∪.	DAIL	T I	DEJUNII HUN
+			
-+			
$\dashv$			
-+			
+			

PROJECT:

ADDITION/RENOVATION 21 BARRINGTON HILLS PITTSFORD, NY

CLIE

VINOD LUTHRA


DRAWING TITLE:

DEMOLITION & PROPOSED FOUNDATION PLAN


PHASE:
CONSTRUCTION DOCUMENTS

JOB NO. A25-087	PROJECT NO. ADDITION
DRAWN BY: DAY	DRAWING NO:
CHECKED BY: JRF	A2 0
DATE	

10-10-2025

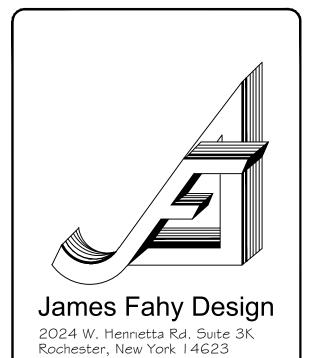

tel: 585-272-1650 e-mail: info@jamesfahy.com website: www.jamesfahy.com

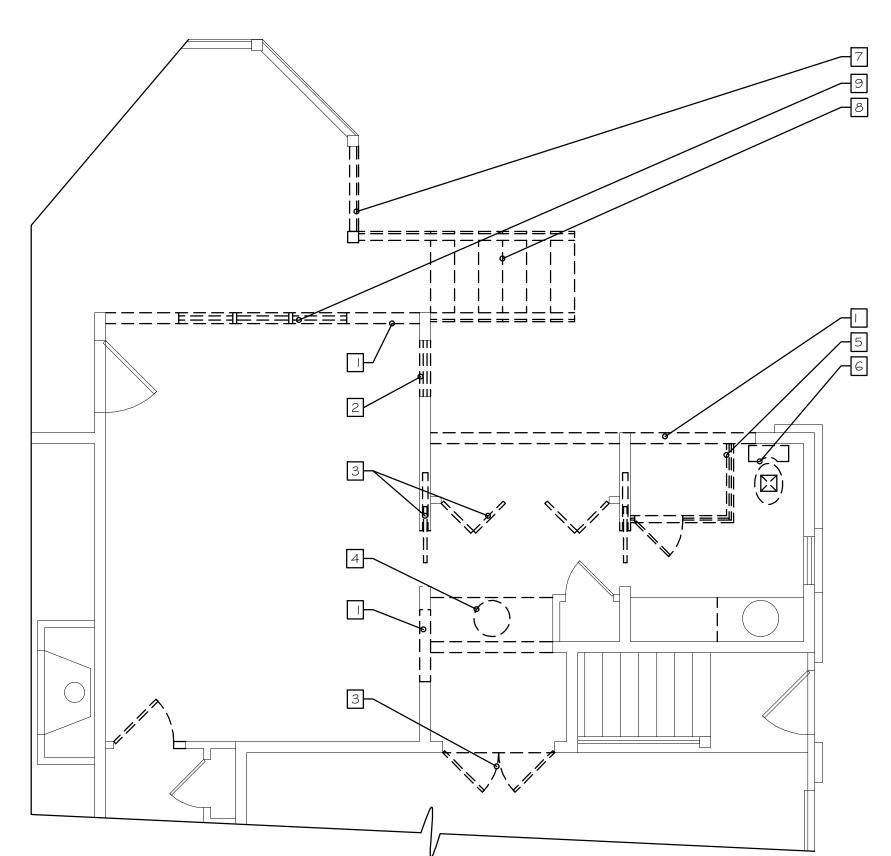

FIRST FLOOR DEMOLITION PLAN SCALE: 1/4" = 1'-0"

GENERAL DEMOLITION NOTES:

A. It is the contractor's responsibility to familiarize themselves with all details involved in selective demolition. Specific instructions on each item will not be given.

B. All plumbing, electrical and HVAC fixtures, doors, trim and any other items which the owner indicates they want to save shall be removed by the contractor, stored and maintained in good condition per the owner's directions for future reuse. The owner shall provide the contractor with the list of all such items.

C. Contractor to remove all existing walls, doors, and finishes not shown to remain. Infill wall openings as required and patch surfaces to match adjacent existing.

D. Remove all existing lighting, wiring, and devices as required to complete work. Remove all abandoned conduit and wire. Terminate at nearest active panel.

E. Not Used Remove all existing ductwork, piping and related HVAC systems as required to complete work. Cap all ductwork and piping at nearest active main riser. Coordinate removal of all associate power and plumbing services with other trades.

<u>G.</u> Contractor may be required to go beyond the contract area to reach the first shutoff valve, main or electrical panel. When this happens, the contractor shall remove and repair existing finish surfaces as required. H. All existing floor, wall and ceiling finishes in areas to be renovated shall be removed down to subfloor/rough framing as required. Prepare existing surfaces to receive new finish materials.

. The contractor shall be responsible for the salvage of existing materials as required for patching existing areas to remain. Wherever removals occur, disturbed surfaces should be patched to match adjacent

J. The contractor shall coordinate the demolition work with the owner's use of the premises. All work to be scheduled and coordinated with

K. The contractor shall provide fireproof and dustproof partitions around the construction area during all demolition and construction work. .. The contractor shall maintain safe access to all designated exits for The building occupants during construction.

M. Storage for contractor's equipment and debris must be kept inside N. Dumpsters for construction debris are to be provided by contractor.

All debris to be hauled off site upon removal by contractor. O. If materials are suspected to contain asbestos, contractor is to immediately inform owner and architect. All existing materials known to contain asbestos that are to be removed should be done so in accordance with established A.H.E.R.A. regulations.

CODED NOTES: 

I. REMOVE EXISTING WALL TO LIMITS SHOWN

2. REMOVE EXISTING WINDOWS \$ ALL COMPONENTS 3. REMOVE EXISTING DOOR \$ ALL COMPONENTS

4. REMOVE EXISTING VANITY

5. REMOVE EXISTING SHOWER 6. REMOVE EXISTING TOILET

7. REMOVE EXISTING DECK TO LIMITS SHOWN 8. REMOVE & REUSE EXISTING DECK STAIRS PER PLAN


9. REMOVE \$ REUSE EXISTING WINDOWS PER PLAN

SCALE: 1/4"=1'-0"

LEGEND:

EXISTING CONDITIONS

EXISTING TO BE REMOVED

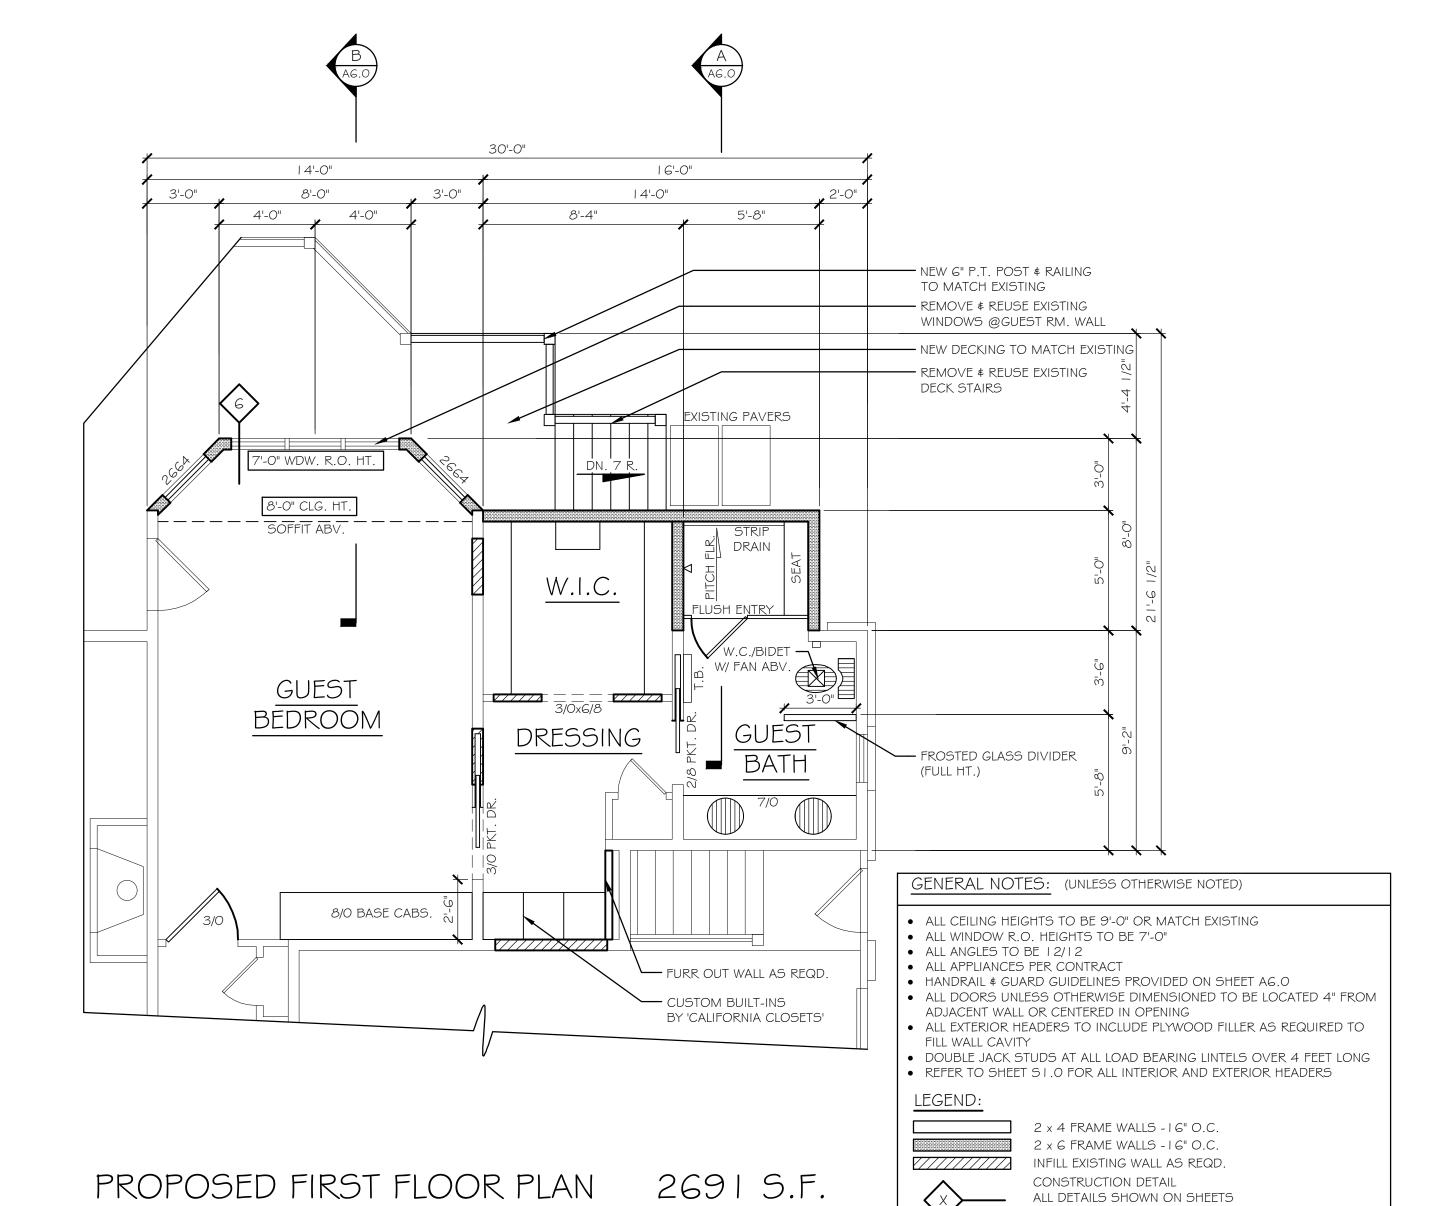

2588 S.F. EXISTING

103 S.F. NEW

COPYRIGHT NOTICE: THESE PLANS ARE PROTECTED UNDER FEDERAL COPYRIGHT LAWS BY JAMES FAHY DESIGN. ANY REPRODUCTION, OR MODIFICATION OF THESE PLANS, IN WHOLE OR IN PART, WITHOUT THE EXPRESS WRITTEN CONSENT OF JAMES FAHY DESIGN IS A VIOLATION OF COPYRIGHT LAWS. CLIENT RIGHTS ARE LIMITED TO ONE-TIME USE FOR CONSTRUCTION OF THESE PLANS.

UNAUTHORIZED ALTERATIONS OR ADDITIONS TO THIS DRAWING IS A VIOLATION OF THE NEW YORK STATE EDUCATION LAW, ARTICLE 145, SECTION

Copyright © 2025 James Fahy, P.E., P.C. All rights reserved.

NO	DATE	BY	DESCRIPTION
NU.	DAIL	Dĭ	DESCRIPTION
		+	
		+	
		-	
		+	
		+	
		+	

PROJECT: ADDITION/RENOVATION 21 BARRINGTON HILLS PITTSFORD, NY

VINOD LUTHRA


DRAWING TITLE:

FIRST FLOOR PLAN

DEMOLITION & PROPOSED


CONSTRUCTION DOCUMENTS

- 1		
	JOB NO. A25-087	PROJECT NO. ADDITION
	DRAWN BY: DAY	DRAWING NO:
	CHECKED BY: JRF	A30
	DATE: 10-10-2025	110.0

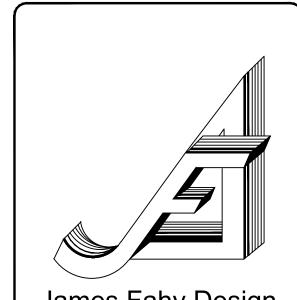

James Fahy Design 2024 W. Henrietta Rd. Suite 3K Rochester, New York 14623

tel: 585-272-1650 e-mail: info@jamesfahy.com website: www.jamesfahy.com

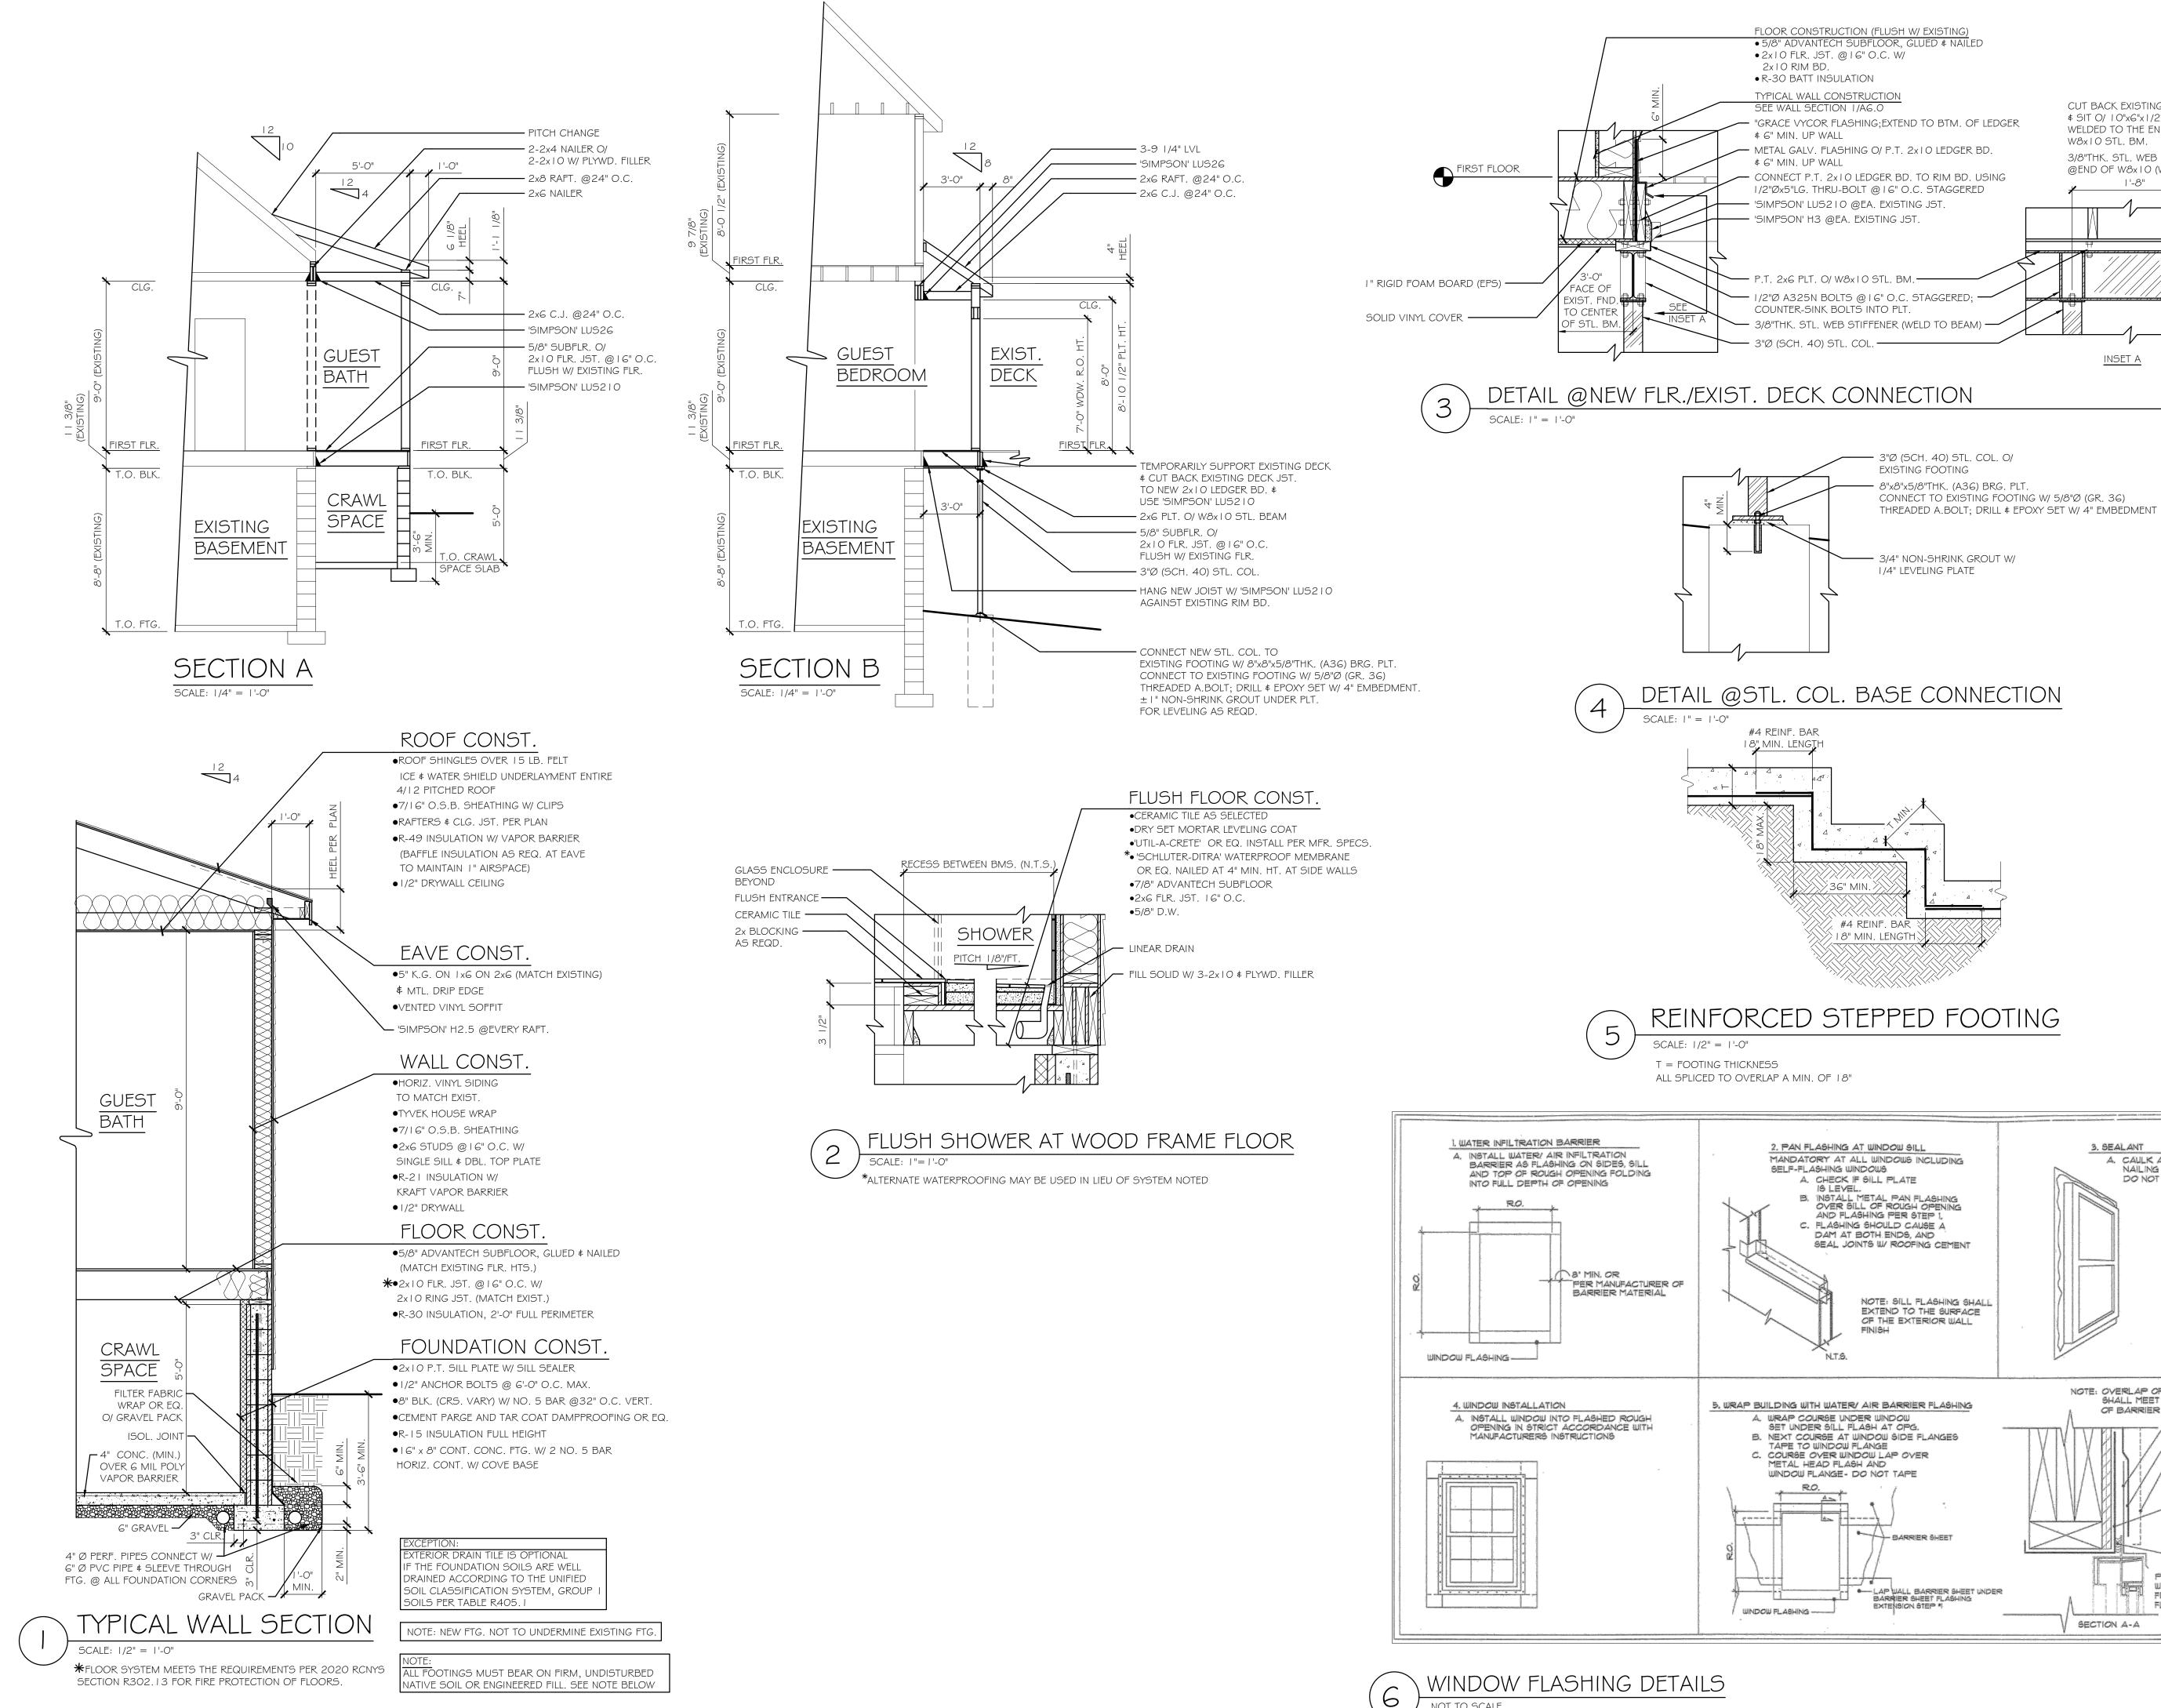

COPYRIGHT NOTICE: THESE PLANS ARE PROTECTED UNDER FEDERAL COPYRIGHT LAWS BY JAMES FAHY DESIGN. AN REPRODUCTION, OR MODIFICATION OF THESE PLANS, IN WHOLE OR IN PART, WITHOUT THE EXPRESS WRITTEN CONSENT OF JAMES FAHY DESIGN IS A VIOLATION OF COPYRIGHT LAWS. CLIENT RIGHTS ARE LIMITED TO ONE-TIME USE FOR CONSTRUCTION OF THESE PLANS. UNAUTHORIZED ALTERATIONS OR ADDITIONS TO THIS DRAWING IS A VIOLATION OF THE NEW YORK STATE EDUCATION LAW, ARTICLE 145, SECTION

CUT BACK EXISTING WD. BM. —

WELDED TO THE END OF

W8x10 STL. BM.

3. SEALANT

A. CAULK ALONG BACK OF NAILING FIN ON 3 SIDES ONLY DO NOT CAULK BOTTOM

NOTE: OVERLAP OF AIR/ WATER BARRIER SHALL MEET MIN. RECOMMENDATIONS

ALUM. HEAD FLASHING

8' MIN. VERTICAL

-AIR / WATER BARRIER

INFILTRATION BARRIER FLASHING (SEE STEP I) MUST EXTEND OVER

ENTIRE OPENING DEPTH

-Caulk (See Step 3)

PROVIDE SEALANT TAPE

WHERE NAILS FOR EXTERIOR

FINISH PENETRATE

- LINE OF EXTERIOR

OF BARRIER MFR.

SECTION A-A

\$ SIT O/ 10"x6"x1/2"THK. STL. PLT.

3/8"THK. STL. WEB STIFFENER ----

@END OF W8x10 (WELD TO BEAM)

Copyright © 2025 James Fahy, P.E., P.C All rights reserved.

**REVISIONS:** NO. DATE BY DESCRIPTION

PROJECT: ADDITION/RENOVATION 21 BARRINGTON HILLS PITTSFORD, NY

# DETAILS

DATE:


10-10-2025

VINOD LUTHRA

DRAWING TITLE: SECTIONS, TYP. WALL SECTIONS

CONSTRUCTION DOCUMENTS


PROJECT NO. JOB NO. A25-087 ADDITION DRAWING NO: DRAWN BY: DAY CHECKED BY: JRF

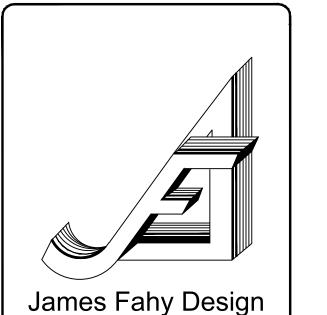


2024 W. Henrietta Rd. Suite 3K Rochester, New York 14623

e-mail: info@jamesfahy.com website: www.jamesfahy.com

tel: 585-272-1650

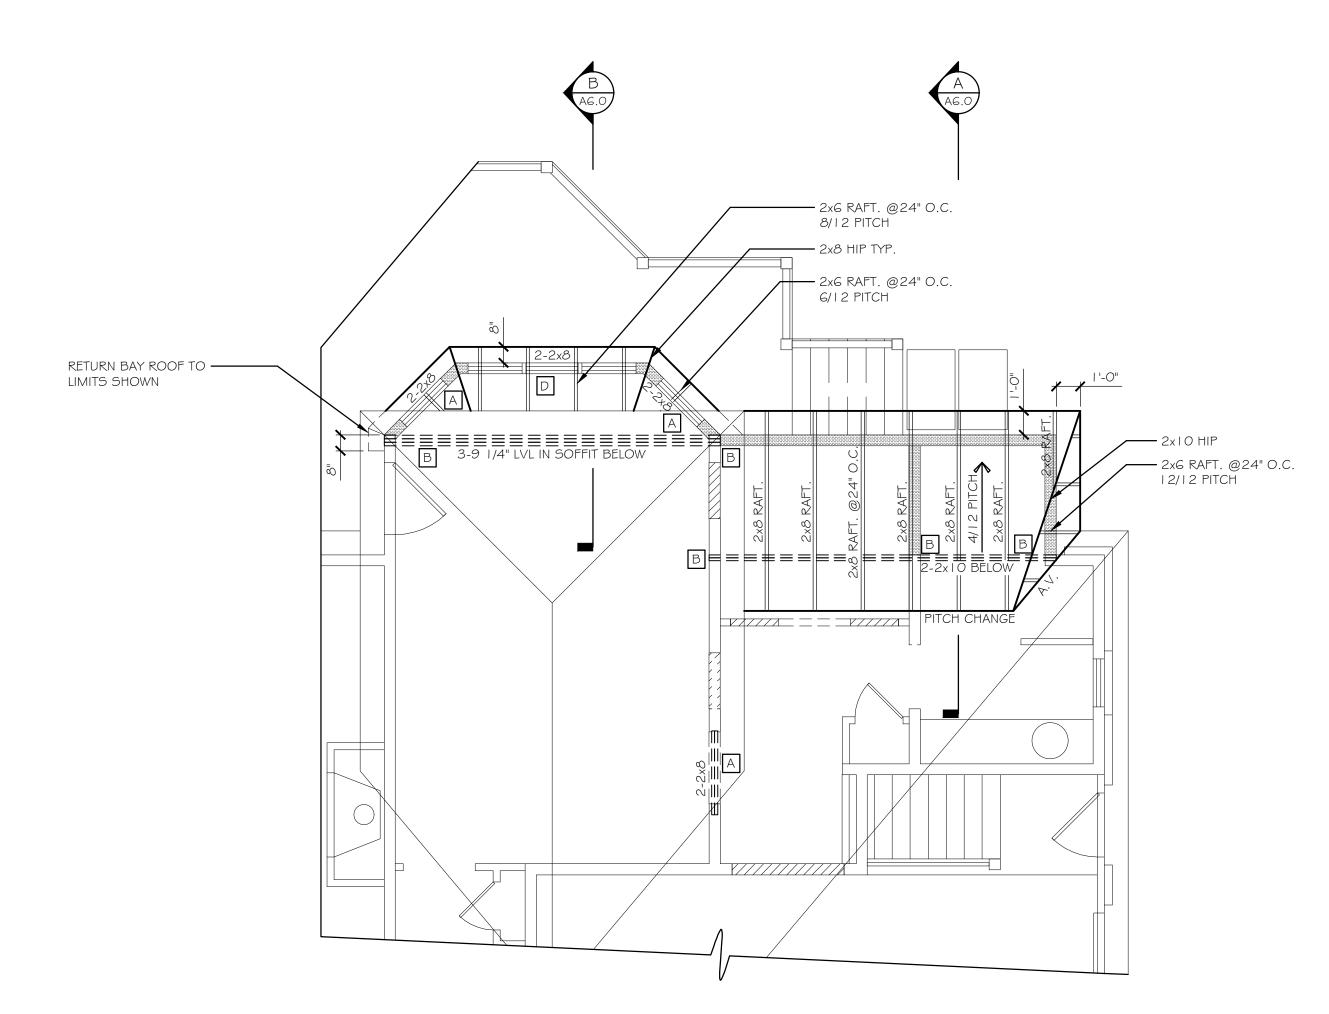

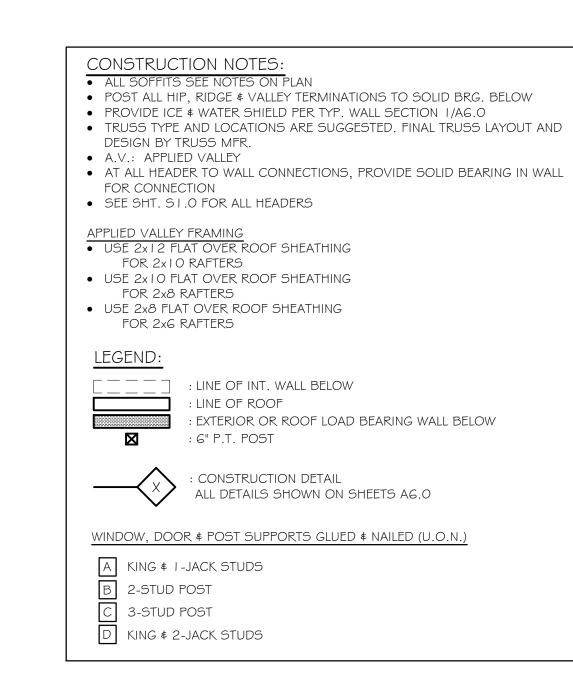

ROOF FRAMING PLAN

SCALE: 1/4"=1'-0"

COPYRIGHT NOTICE:
THESE PLANS ARE PROTECTED UNDER FEDERAL
COPYRIGHT LAWS BY JAMES FAHY DESIGN. ANY
REPRODUCTION, OR MODIFICATION OF THESE
PLANS, IN WHOLE OR IN PART, WITHOUT THE
EXPRESS WRITTEN CONSENT OF JAMES FAHY
DESIGN IS A VIOLATION OF COPYRIGHT LAWS.
CLIENT RIGHTS ARE LIMITED TO ONE-TIME USE
FOR CONSTRUCTION OF THESE PLANS.

UNAUTHORIZED ALTERATIONS OR ADDITIONS TO THIS DRAWING IS A VIOLATION OF THE NEW YORK STATE EDUCATION LAW, ARTICLE 145, SECTION 7209.

Copyright © 2025 James Fahy, P.E., P.C. All rights reserved.

NO.	DATE	BY	DESCRIPTION

PROJECT:

ADDITION/RENOVATION 21 BARRINGTON HILLS PITTSFORD, NY

CLIENT:


VINOD LUTHRA

DRAWING TITLE:

ROOF FRAMING PLAN

PHASE:
CONSTRUCTION DOCUMENTS

JOB NO. A25-087	PROJECT NO. ADDITION
DRAWN BY: DAY	DRAWING NO:
CHECKED BY: JRF	910
DATE: 10-10-2025	

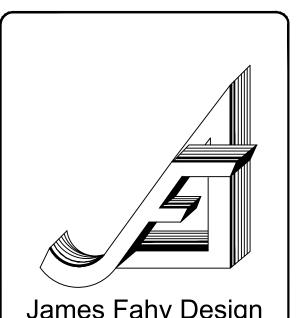

James Fahy Design
2024 W. Henrietta Rd. Suite 3K

2024 W. Henrietta Rd. Suite 3K Rochester, New York 14623 tel: 585-272-1650 e-mail: info@jamesfahy.com website: www.jamesfahy.com









## **Town of Pittsford**

Department of Public Works 11 South Main Street Pittsford. New York 14534

Permit # B25-000124

Phone: 585-248-6250 FAX: 585-248-6262

# DESIGN REVIEW AND HISTORIC PRESERVATION BOARD REFERRAL OF APPLICATION

Property Address: 6 Ryder Cup Circle PITTSFORD, NY 14534

**Tax ID Number:** 163.07-1-38

Zoning District: RN Residential Neighborhood

Owner: Tao, Wen-Hua

**Applicant:** Keystone Custom Decks LLC


			_ 4 *		_	
Δ	nn	חור	· STI	Λn	- 11/	pe:
$\boldsymbol{-}$	$oldsymbol{v}$		·au	vii	v	ve.


· ·	Residential Design Review	Build to Line Adjustment
	§185-205 (B) Commercial Design Review	§185-17 (B) (2)  Building Height Above 30 Feet
	§185-205 (B)	§185-17 (M)
	Signage	Corner Lot Orientation
	§185-205 (C)	§185-17 (K) (3)
	Certificate of Appropriateness	Flag Lot Building Line Location
	§185-197	§185-17 (L) (1) (c)
	Landmark Designation	Undeveloped Flag Lot Requirements
	§185-195 (2)	§185-17 (L) (2)
	Informal Review	

**Project Description:** Applicant is requesting design review for a 48 square foot addition to front of existing home.

Meeting Date: October 23, 2025

# Residential Neighborhood Zoning

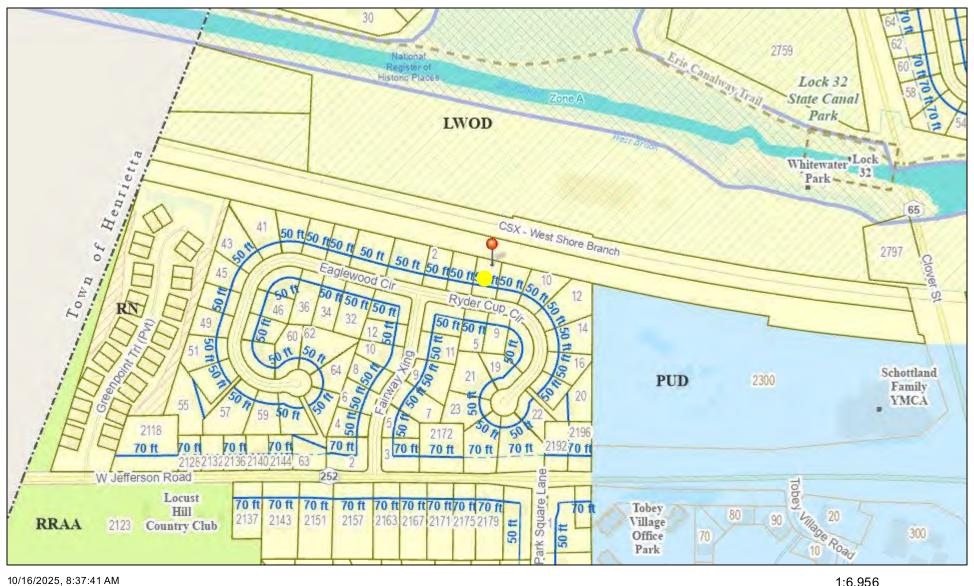

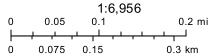

Town of Pittsford GIS



### INSTRUMENT SURVEY MAP

THOMAS H. DeYAGER PROFESSIONAL LAND SURVEYOR 93 Castle Acres Drive Webster, N.Y. 14580 PHONE: 671-0420 Street 6 Ryder Cup Circle Lot No. 38

Subdivision Fairway Crossing

Porcel of Town of Pittsford - County of Monroe - State of New York

References Liber 250 of Maps, pages 55, 56 & 57.

Public Abstract Corporation, Search No. 53815/38

Subject to: Declaration of Covenants. Easements and Restrictions per Liber 7383 of Deeds, page 177. Greater Rochester Cablevision per Liber 7353 of Deeds, page 60. also, Rochester Gas & Electric Corporation and Rochester Telephone Corporation per Liber 7328 of Deeds, page 134. S-77°43'43"-E 110.16 Minimum Setback: = 50.0' Side 15.00' LOT LOT LOT 38 39 N. St 36.1 Drivaway 50.9 to wide Utility Egsement per Sub. 9 110.00 S-80°46'15"-E R.O.W. Line RYDER CUP (60'wide) CIRCLE "Unauthorized alteration or addition to a survey map bearing a licensed land surveyor's seal is a violation of Section 7209, subdivision 2, of the New York State Education Law." SCALE 1" =30 I hereby certify to the following that this map was made from notes of an instrument Survey: Republic National Bank, its successors and/or assigns:
Bansbach, Zoghlin, Wicks & Whal, P.C.;

. The title insurance company insuring the mortgage:

. Jawaid Khan.

Signed,

Doted January 30, 1997

PROFESSIONAL LAND SURVEYOR NO. 49850

THOMAS H. DOYAGER



Wennie Tao 6 Ryder Cup Circle Pittsford, NY 14534 585-317-3672

315-227-2288

PORCH CROSS SECTION









## **Town of Pittsford**

Department of Public Works 11 South Main Street Pittsford, New York 14534

Permit # D25-00006

Phone: 585-248-6250 FAX: 585-248-6262

# DESIGN REVIEW AND HISTORIC PRESERVATION BOARD REFERRAL OF APPLICATION

Property Address: 526 Mendon Road PITTSFORD, NY 14534

**Tax ID Number:** 178.03-1-80.1

Zoning District: RN Residential Neighborhood

Applicant: James Fahy Design Associates Architecture & Engineering P.C.

_		_
$\Lambda$	lication	11/00:
	IICAIIOII	1711
, ,pp		

	Residential Design Review	$\Box$	Build to Line Adjustment
<b>~</b>	§185-205 (B)	$\cup$	§185-17 (B) (2)
	Commercial Design Review		Building Height Above 30 Feet
	§185-205 (B)	$\cup$	§185-17 (M)
	Signage		Corner Lot Orientation
$\cup$	§185-205 (C)	$\cup$	§185-17 (K) (3)
	Certificate of Appropriateness		Flag Lot Building Line Location
$\cup$	§185-197	$\cup$	§185-17 (L) (1) (c)
	Landmark Designation		Undeveloped Flag Lot Requirements
$\cup$	§185-195 (2)	$\cup$	§185-17 (L) (2)
	Informal Review		

**Project Description:** Applicant is requesting design review for the construction of a one-story single-family home approximately 12,231 square feet. This property is zoned Residential Neighborhood (RN).

Meeting Date: October 23, 2025

# RN Residential Neighborhood Zoning



Town of Pittsford GIS

195

55


390

110

780 ft

220 m



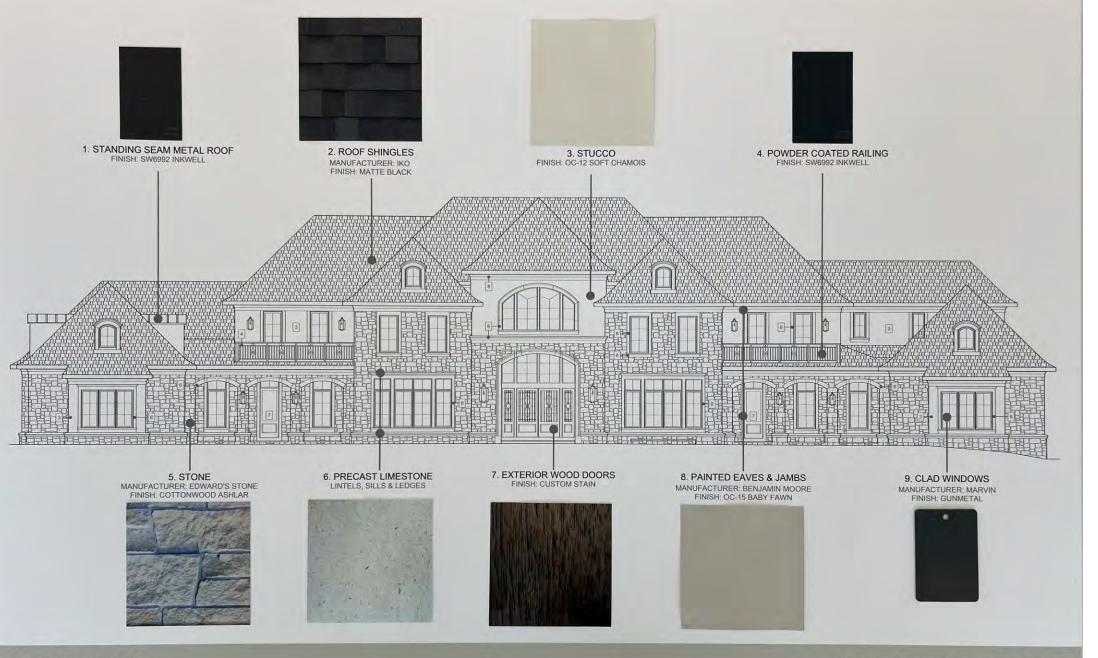

### © 2025 Malvern Views LLC. All Rights Reserved.

This material, including all plans, designs, and presentations, is the exclusive property of Malvern Views LLC and is protected under United States and international copyright law. Unauthorized reproduction, distribution, exhibition, or public display—whether in print, digital, or any other form—is strictly prohibited and may result in civil and criminal penalties. This work is provided for private viewing only. For licensing or permission requests, please contact: management@melroc.com



- 3. Stucco
- 4. Powder Coated Railings
- 6. Precast Limestone Lintels, Sills & Ledges
- 7. Stained Wood Exterior Doors & Garage Doors
- 8. Painted Eaves & Jams



viewing only.

For licensing or permission requests, please contact: management@melroc.com

criminal penalties.This work

is provided for private

Unauthorized reproduction, distribution, exhibition, or public display—whether in print, digital, or any other

Malvern Views LLC and is protected under United States and international

copyright law.

plans, designs, and presentations, is the exclusive property of

form—is strictly prohibited

and may result in civil and

© 2025 Malvern Views LLC.
All Rights Reserved.
This material, including all

# 526 MENDON ROAD

PITTSFORD, NEW YORK



# CLIENT:

MALVERN VIEWS LLC

# **ARCHITECT:**

JAMES FAHY DESIGN ASSOCIATES ARCHITECTURE & ENGINEERING P.C. 2024 W. HENRIETTA RD. SUITE 3K ROCHESTER, NY 14623

TEL. (585) 272-1650 E-MAIL: info@jamesfahy.com WEBSITE: www.jamesfahy.com

# **DRAWING INDEX:**

T1.0 TITLE SHEET

A1.0 FRONT ELEVATION & COURTYARD ELEVATIONS

A1.1 RIGHT & LEFT SIDE ELEVATIONS


A1.2 REAR & FAMILY ROOM ELEVATIONS

A2.1 LOWER LEVEL PLAN

A3.0 FIRST FLOOR PLAN

A4.0 SECOND FLOOR PLAN

James Fahy Design Associa Architecture & Engineering I 2024 W. Henretta Rd. Suite 3K Rochester, New York 14623 tel. (585) 272-1650 e-mail: info@jamesfahy.com

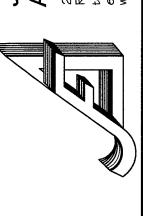

PITTSFORD, NEW YORK

CLIENT:

MALVERN VIEWS LLC

JOB NO.
A24-063


PROJECT NO.
20-12231-3

PHASE:
PRELIMINARY
PLAN


DATE: 9-15-2025

DRAWING NO.



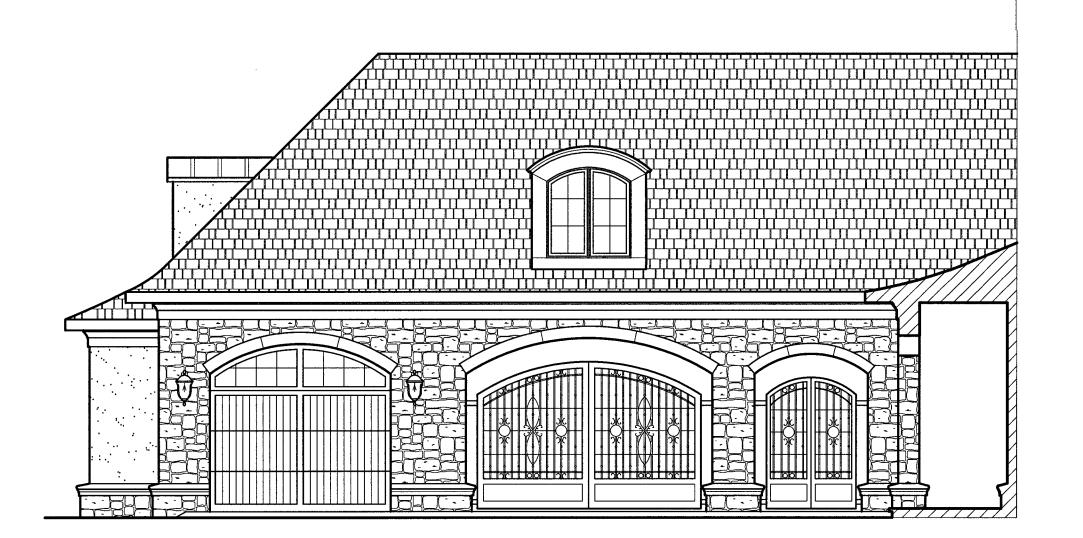

lest side courtyard elevation
scale: 3/16"=1'-0"

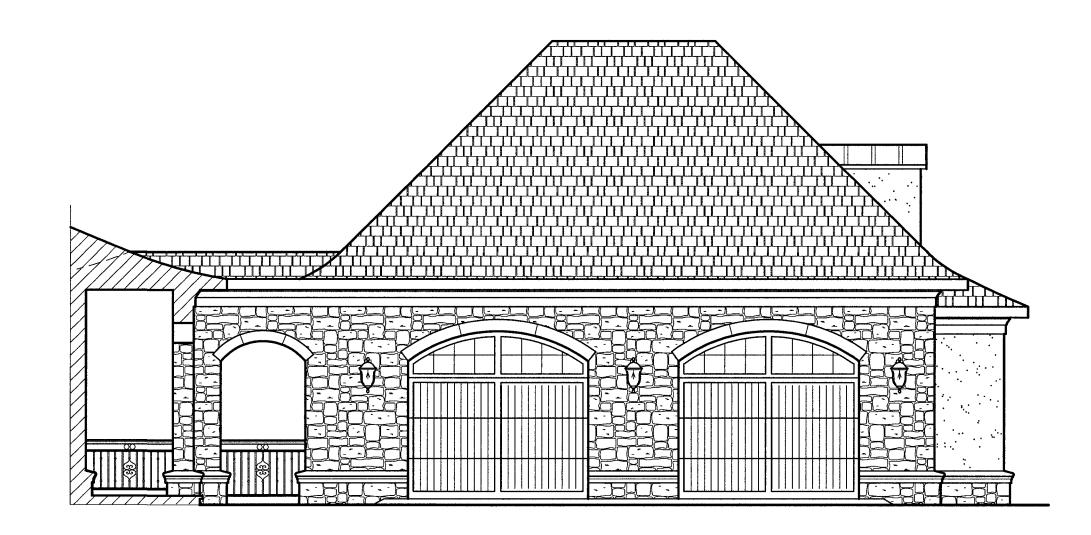

right side courtyard elevation
scale: 3/16"=1'-0"

COPYRIGHT NOTICE:
THIS MATERIAL, INCLUDING ALL PLANS, DESIGNS
AND PRESENTATIONS, IS THE EXCLUSIVE PROPERTY
OF MALVERN VIEWS LLC AND IS PROTECTED UNDER
UNITED STATES AND INTERNATIONAL COPYRIGHT
LAW.UNAUTHORIZED REPRODUCTION, DISTRIBUTION
EXHIBITION, OR PUBLIC DISPLAY-WHETHER IN PRINT,
DIGITAL, OR ANY OTHER FORM- IS STRICTLY
PROHIBITED AND MAY RESULT IN CIVIL AND
CRIMINAL PENALTIES. THIS WORK IS PROVIDED
FOR PRIVATE VIEWING ONLY.

FOR LICENSING OR PERMISSION REQUEST,
PLEASE CONTACT: MANAGEMENT@MELROC.COM

Copyright © 2025 MALVERN VIEWS LLC.
All rights reserved.

NO.	DATE	BY	DESCRIPTION
1			
		ļ	
T			
十			
l			
$\dashv$			
-+			 
		<u> </u>	
$\neg +$			
	<del> </del>	<u> </u>	<u> </u>
$\neg \vdash$			
<del></del> -{-		<u> </u>	
		<u> </u>	
	,		
-+		<del> </del>	<u> </u>
		<u> </u>	
		<b></b>	
			•
	· ¬		
$\dashv$			
$\dashv$			
-+			
$-\!\!\!\!+$			
-			
$\neg$			
-+			
$\dashv$			
+			

PROJECT: 526 MENDON RD. PITTSFORD, NY

MALVERN VIEWS LLC

DRAWING TITLE:
FRONT ELEVATION
\$ COURTYARD ELEVATIONS

PHASE: PRELIMINARY DESIGN

JOB NO. A24-063	PROJECT NO. 20-12231-3
DRAWN BY: CNS	DRAWING NO:
CHECKED BY: JRF	
DATE: 9-15-2025	







lest side elevation
scale: 3/16"=1'-0"

COPYRIGHT NOTICE:
THIS MATERIAL, INCLUDING ALL PLANS, DESIGNS
AND PRESENTATIONS, IS THE EXCLUSIVE PROPERTY
OF MALVERN VIEWS LLC AND IS PROTECTED UNDER
UNITED STATES AND INTERNATIONAL COPYRIGHT
LAW.UNAUTHORIZED REPRODUCTION, DISTRIBUTION
EXHIBITION, OR PUBLIC DISPLAY-WHETHER IN PRINT,
DIGITAL, OR ANY OTHER FORM- IS STRICTLY
PROHIBITED AND MAY RESULT IN CIVIL AND
CRIMINAL PENALTIES. THIS WORK IS PROVIDED
FOR PRIVATE VIEWING ONLY.

FOR LICENSING OR PERMISSION REQUEST, PLEASE CONTACT: MANAGEMENT@MELROC.COM

All ri	right © 20 ghts reser	)25 ved.	MALVERN VIEWS
REVIS	IONS:		
NO.	DATE	BY	DESCRIPTION
_			
$\dashv$			
		-	
		ļ	
		<u> </u>	
			<del></del>
-+			

PROJECT:	
526 MENDON RD. PITTSFORD, NY	

CLIENT:
MALVERN VIEWS LLC

DRAWING TITLE:

RIGHT & LEFT SIDE ELEVATIONS

PHASE: PRELIMINARY DESIGN


JOB NO. A24-063	PROJECT NO. 20-12231-3
DRAWN BY: CNS	DRAWING NO:
CHECKED BY: JRF	
DATE: 9-15-2025	] / \   ,





# rear elevation

scale: 3/16"=1'-0"

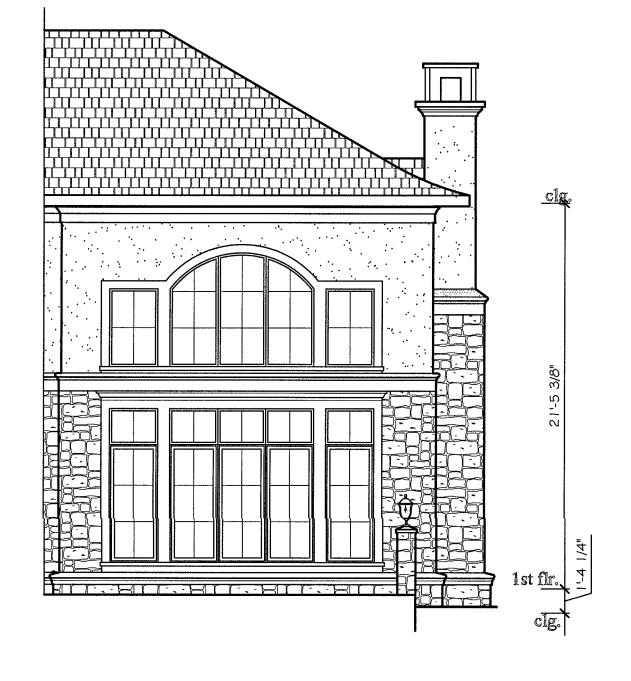



family room elevations
scale: 3/16"=1'-0"

COPYRIGHT NOTICE:
THIS MATERIAL, INCLUDING ALL PLANS, DESIGNS
AND PRESENTATIONS, IS THE EXCLUSIVE PROPERTY
OF MALVERN VIEWS LLC AND IS PROTECTED UNDER
UNITED STATES AND INTERNATIONAL COPYRIGHT
LAW.UNAUTHORIZED REPRODUCTION, DISTRIBUTION
EXHIBITION, OR PUBLIC DISPLAY-WHETHER IN PRINT,
DIGITAL, OR ANY OTHER FORM- IS STRICTLY
PROHIBITED AND MAY RESULT IN CIVIL AND
CRIMINAL PENALTIES. THIS WORK IS PROVIDED
FOR PRIVATE VIEWING ONLY.

FOR LICENSING OR PERMISSION REQUEST,
PLEASE CONTACT: MANAGEMENT@MELROC.COM

Copyright © 2025
All rights reserved.

REVISIONS:
NO. DATE BY DESCRIPTION

			7
			**************************************
			•
			<u></u>
	<del>,</del>		
-			
	· ·		
	<u>.</u>		
l		- 1	


PROJECT: 526 MENDON RD. PITTSFORD, NY

CLIENT:
MALVERN VIEWS LLC

DRAWING TITLE:
REAR \$ FAMILY ROOM ELEVATIONS

PHASE: PRELIMINARY DESIGN

JOB NO. A24-063	PROJECT NO. 20-12231-3
DRAWN BY: CNS	DRAWING NO:
CHECKED BY: JRF	] 412
DATE: 9-15-2025	] ////-

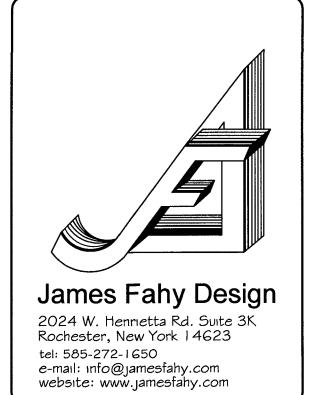












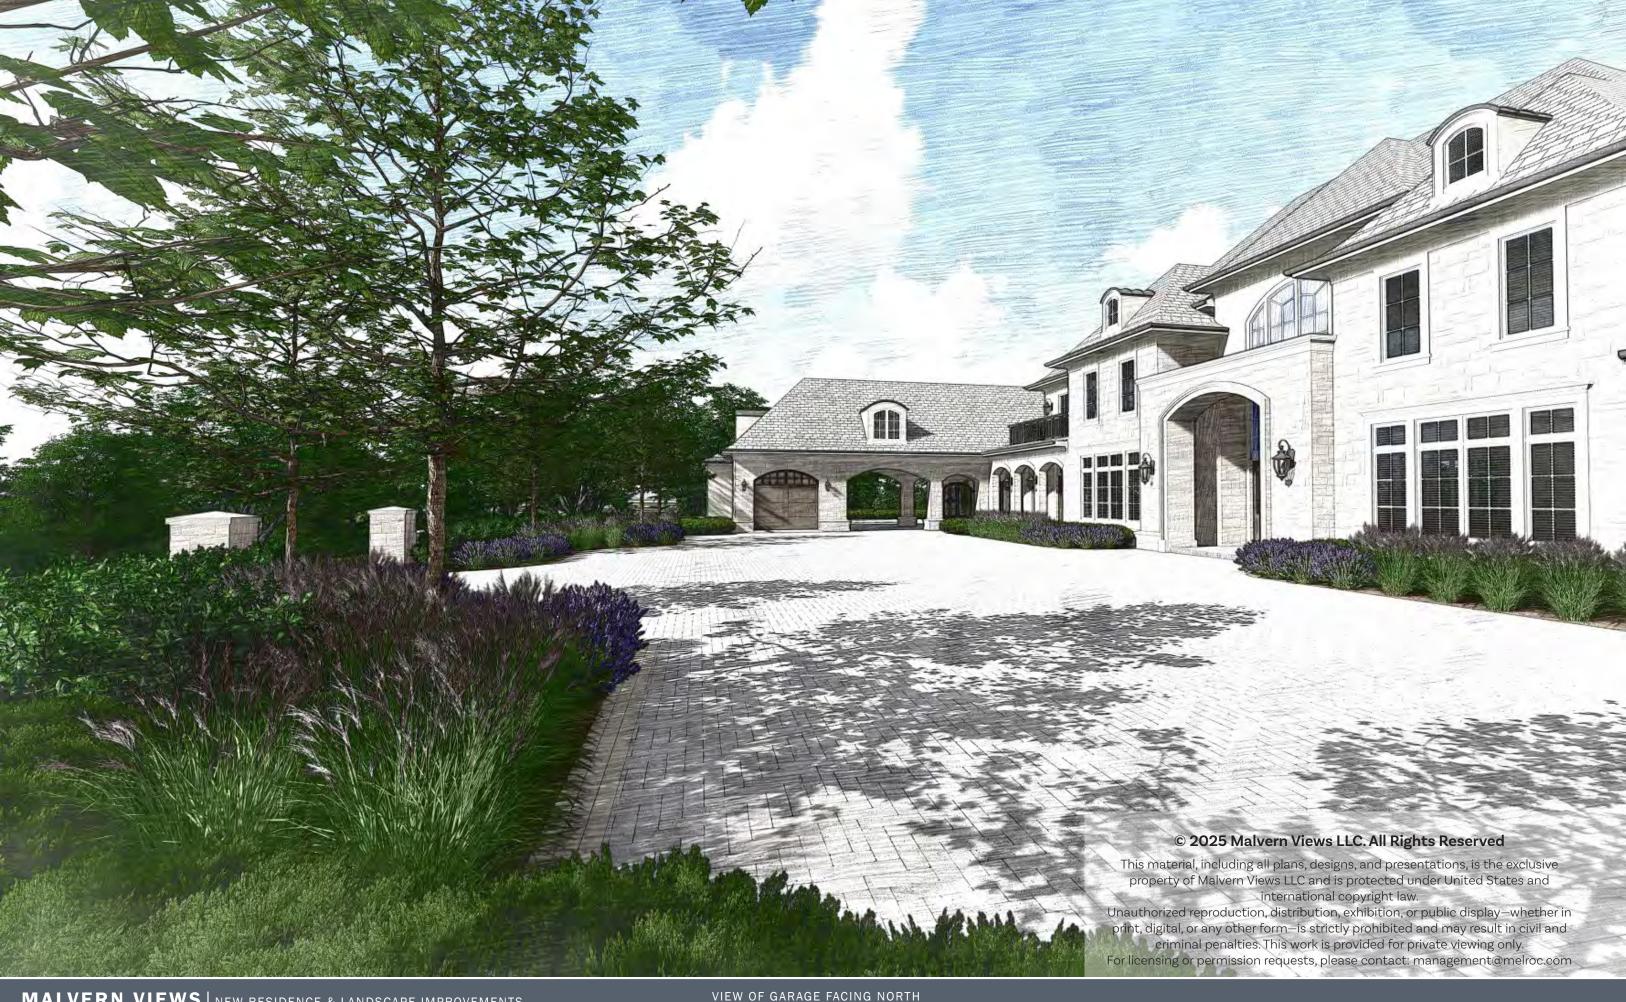














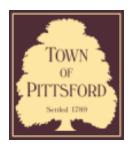

#### **Town of Pittsford**

Department of Public Works 11 South Main Street Pittsford. New York 14534

Permit # B25-000119

Phone: 585-248-6250 FAX: 585-248-6262

#### DESIGN REVIEW AND HISTORIC PRESERVATION BOARD REFERRAL OF APPLICATION

Property Address: 33 Sutton PITTSFORD, NY 14534

**Tax ID Number:** 163.02-3-15

Zoning District: RN Residential Neighborhood

Owner: Narang, Bal K Applicant: Narang, Bal K


Λn	nl	ica	tia	n T	T. , ,	30
Λþ	וקי	ıca	uv		ı yı	JE.

• •		
<b>✓</b>	Residential Design Review §185-205 (B)	Build to Line Adjustment §185-17 (B) (2)
	Commercial Design Review §185-205 (B)	Building Height Above 30 Feet §185-17 (M)
	Signage §185-205 (C)	Corner Lot Orientation §185-17 (K) (3)
	Certificate of Appropriateness §185-197	Flag Lot Building Line Location §185-17 (L) (1) (c)
	Landmark Designation §185-195 (2)	Undeveloped Flag Lot Requirements §185-17 (L) (2)
	Informal Review	

**Project Description:** Applicant is requesting design review for the construction of a one story single family home approximately 3700 square feet.

Meeting Date: October 23, 2025

#### Residential Neighborhood Zoning

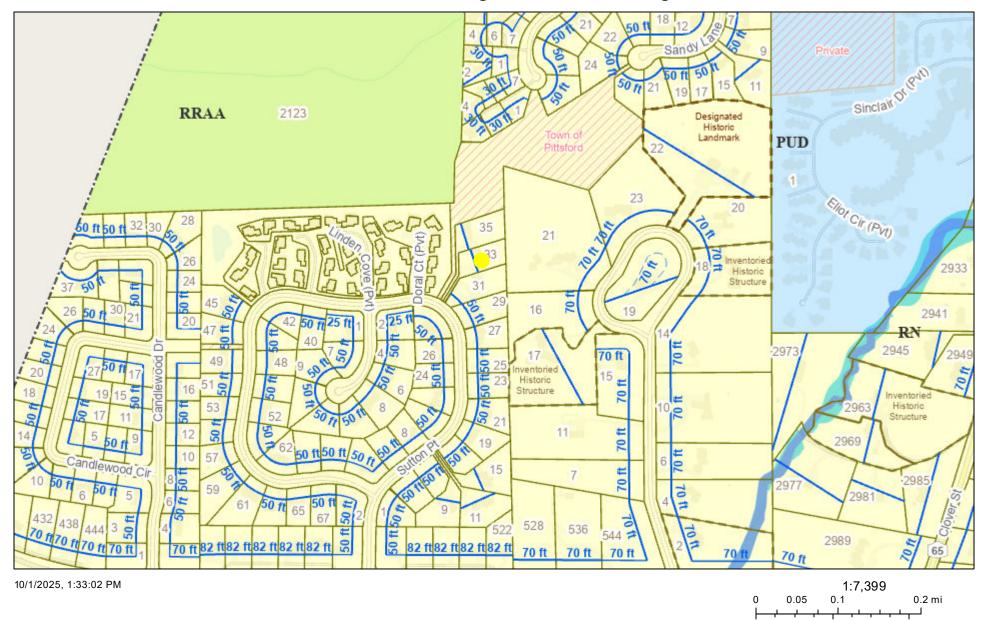


Town of Pittsford GIS

0.075 0.15


0.3 km



# RN Residential Zoning

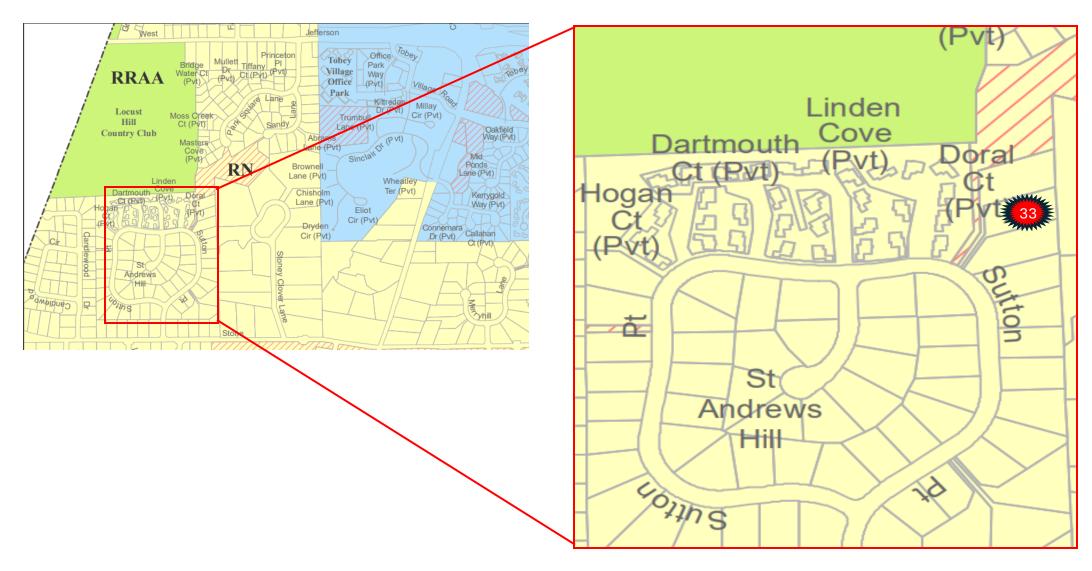

# Google Map of 33 Sutton Point

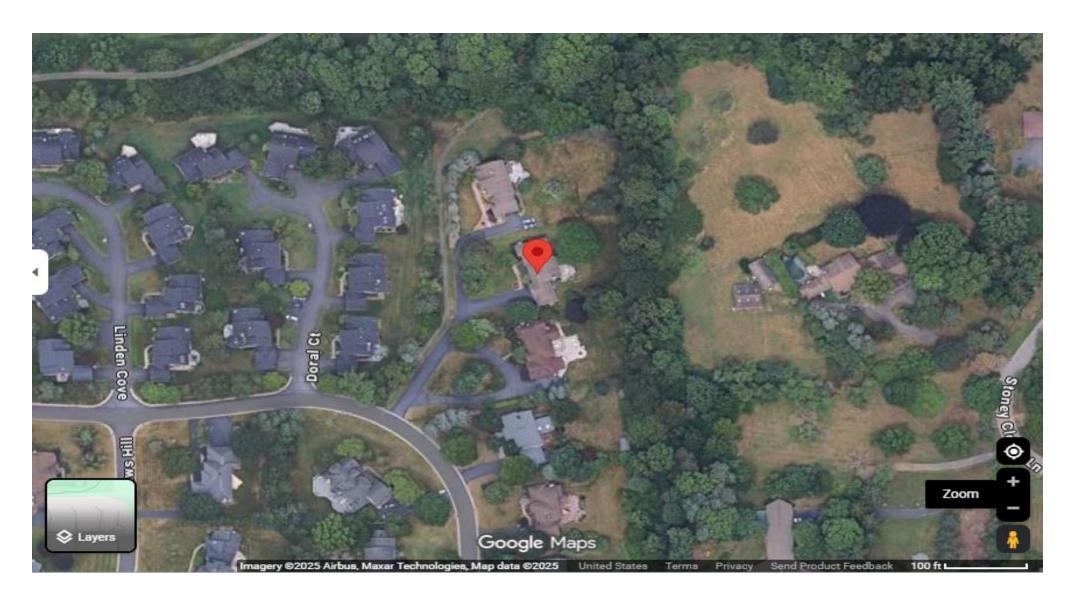

### Original home damaged in fire July 2023



Original residence 4 bedrooms 3.5 bathrooms 3,363 Square feet

Fire damaged in July 2023

Home has been demolished and foundation and garage remain

## Existing condition of 33 Sutton Point



Lot has been vacant and overgrown for 2 years. Shawna and Mike Hayes purchased the lot and are proposing an updated ranch home with similar elevations

# Remaining Garage will be re-used





Existing garage was not damaged in house fire and will be re-used.

Batton board siding will be removed and match the new stucco faced home being built

Shingles will also be replaced to match new home. Black 30 year shingle planned for entire house and garage

# Survey Map with planned alterations to existing foundation shown

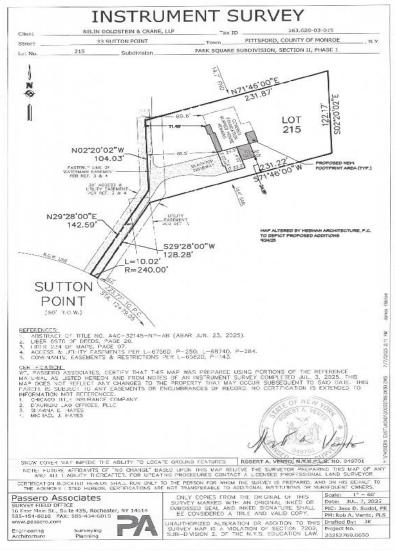

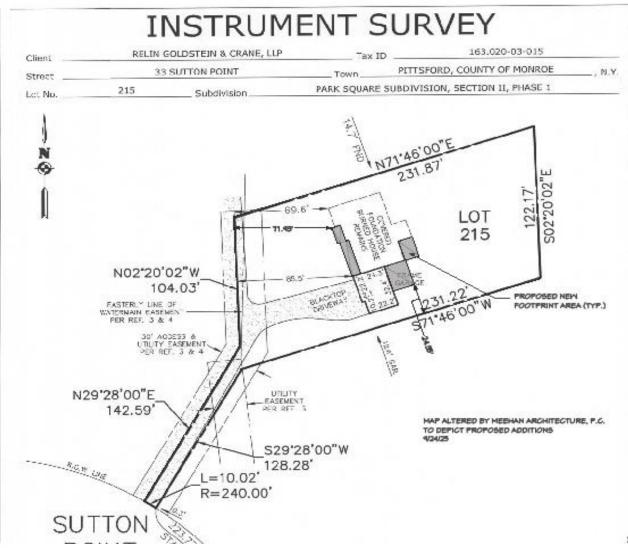

Gray areas
indicate new
mud slab/crawl
space
additions to
existing
foundation

### New Front Elevation proposed




New home proposed will be 3700 Square Feet, 3 Bedroom, 2.5 baths, Vaulted ceilings throughout and similar roof height to previous home

New home overlayed on fire damaged home later in the proposal

Home will have black 30 year shingles, white stucco face with black window trim and black pillars on the front porch


Wooden pergola above double garage door

### New Rear Elevation

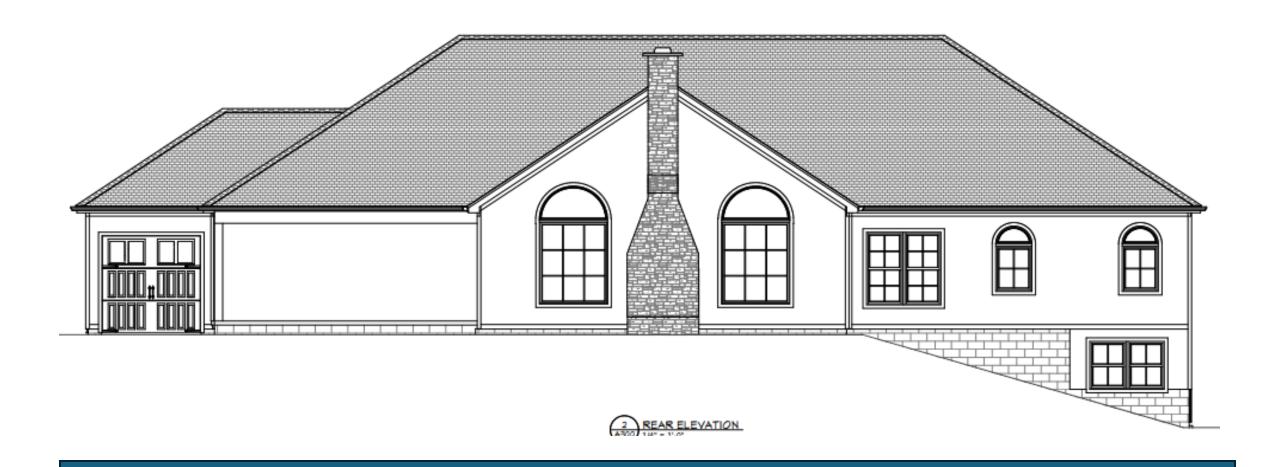

Wood burning fireplace with brick exterior chimney shown on rear of home

## Right Elevation

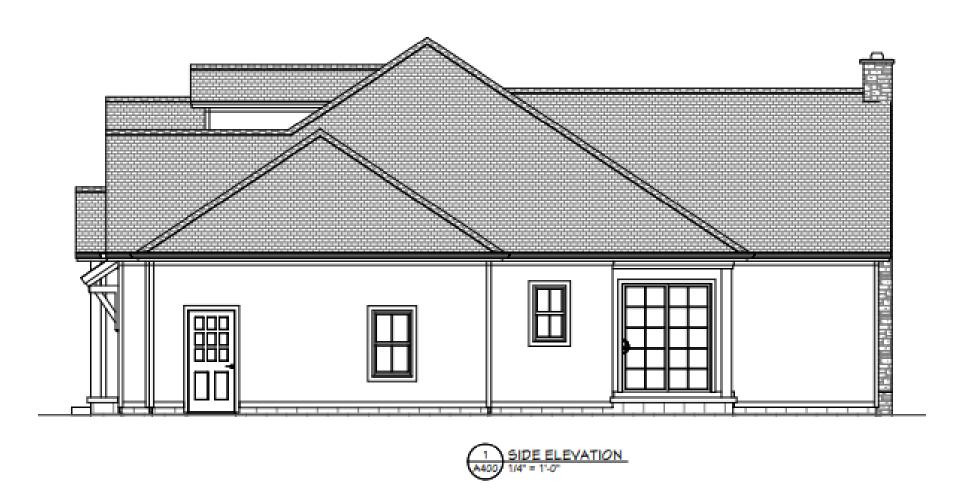

Sliding glass door from living room walking out to back yard

Man door on right side of the garage

### Left Elevation




Walkout basement and egress windows shown for lower level Bedrooms

# Front of proposed home overlayed on previous fire damaged home




Shawna and Mike Hayes purchased the lot and are proposing an updated ranch home with similar elevations

Shown here at scale is the overlay of the new proposed home on top of the previous home to show relative size comparison

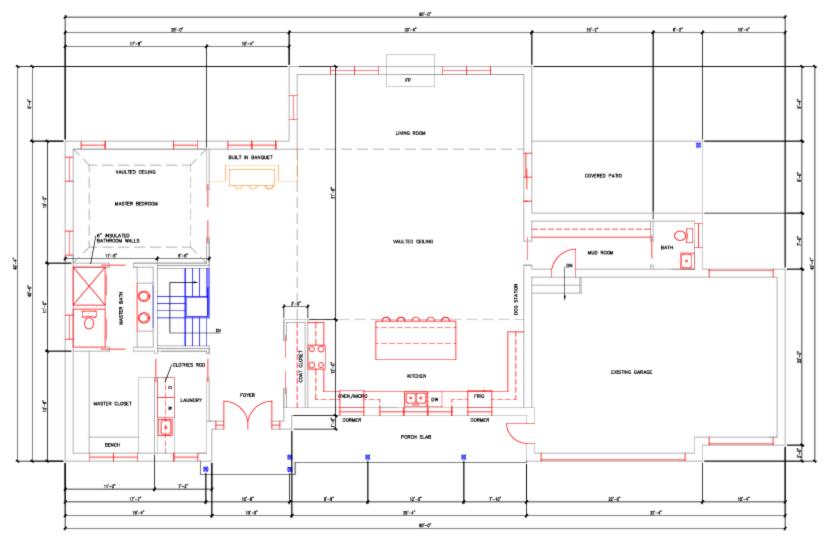


FIRST FLOOR

Draft first floor plans

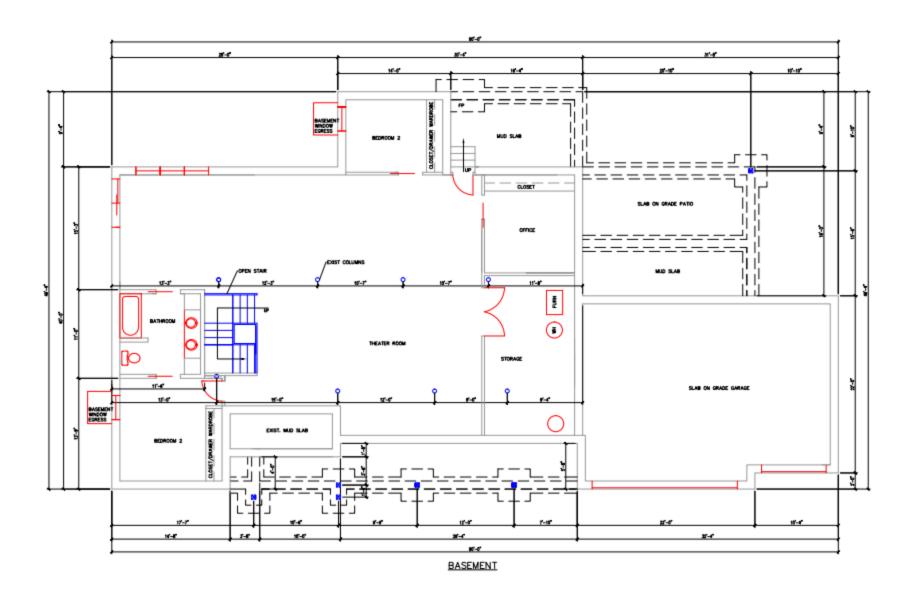

Draft Lower Level Walk out basement plan

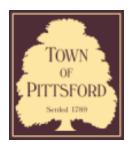

#### **Town of Pittsford**

Department of Public Works 11 South Main Street Pittsford, New York 14534

Permit # D25-000011

Phone: 585-248-6250 FAX: 585-248-6262

#### DESIGN REVIEW AND HISTORIC PRESERVATION BOARD REFERRAL OF APPLICATION

Property Address: 71 Knollwood Drive ROCHESTER, NY 14618

**Tax ID Number:** 138.13-1-21

Zoning District: RN Residential Neighborhood

Owner: Schwert, George W III

**Applicant:** DiMarco Constructors LLC


Α	p	pΙ	ic	ati	or	ı T	vr	Эе	

<b>/</b>	Residential Design Review	Build to Line Adjustment
	§185-205 (B)	§185-17 (B) (2)
	Commercial Design Review	Building Height Above 30 Feet
	§185-205 (B)	§185-17 (M)
	Signage	Corner Lot Orientation
	§185-205 (C)	§185-17 (K) (3)
	Certificate of Appropriateness	Flag Lot Building Line Location
	§185-197	§185-17 (L) (1) (c)
	Landmark Designation	Undeveloped Flag Lot Requirements
	§185-195 (2)	§185-17 (L) (2)
	Informal Review	


**Project Description:** Applicant is requesting Board approval to demolish the existing 3,420-square-foot, two-story, single-family home, with the intent to build a 6,510-square-foot, two-story, single-family home (with finished basement) on the property. This property is zoned residential Neighborhood (RN).

Meeting Date: October 23, 2025

#### Residential Neighborhood Zoning

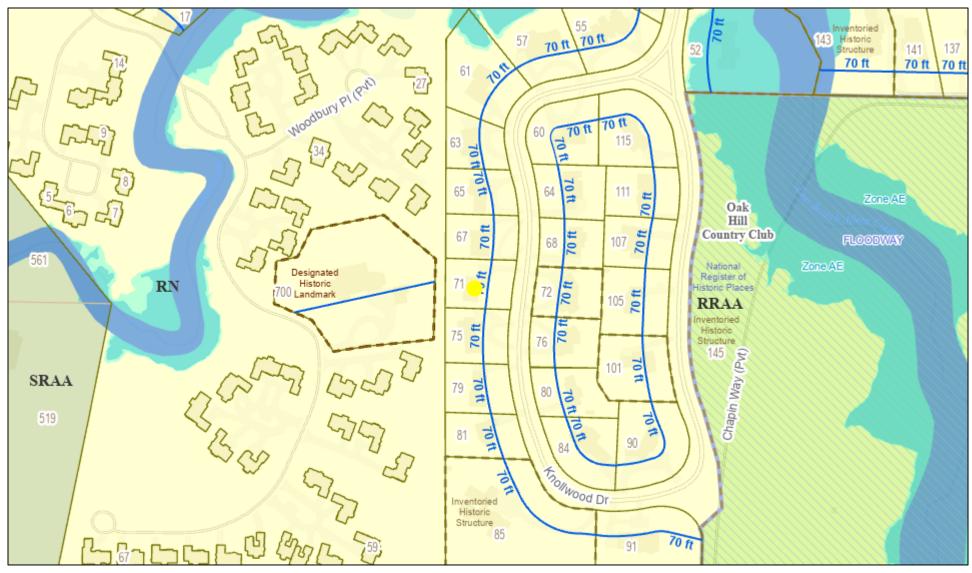

10/16/2025, 8:45:41 AM

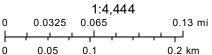

Town of Pittsford GIS

The information depicted on this map is representational and should be used for general reference purposes only. No warranties, expressed or implied, are provided for the data or its use or interpretation.





Licensed in Colorado • Connecticut • Florida • Maine • Massachusetts • Nevada • New York • Pennsylvania • Rhode Island • South Carolina • Texas

October 15, 2025

The Town of Pittsford, NY
Design Review and Historic Board
11 South Main Street
Pittsford, NY 14534

Re: 71 Knollwood Dr. Pittsford, NY

Members of the board,

I am pleased to introduce you to a New Build project at the above noted address. This project will require the demolition of the existing residence located on the site. Included in this submittal are photos of the existing house along with the concept plans for the proposed structure that will replace the existing house. Additionally included is the asbestos survey and demolition proposal that indicates the procedure that will be followed during the removal process. This project will require a variance for the building height, building footprint, and lot coverage. Application will be made to the ZBA for the November meeting.

The existing house was constructed around 1983. It was designed by Yours Truly for the Schwert Family according to the plans. It is a 2-story house approximately 25 feet high to the ridge. The existing footprint is 3463 s.f.

Thank you for the opportunity to present the project for your consideration.

Respectfully,

Patrick J. Morabito, AIA

Architect, PC

Hatrick J Morabito, AL

President

TOWN	OF.	PITTSFORD,	N.	Y.
	-	,		

I. Y. PERMIT NO. .
ISSUED ./././7...........

#### APPLICATION FOR BUILDING PERMIT

#### INSTRUCTIONS

A. This application must be filled in by typewriter or in ink and submitted to the Building Inspector.

B. One plot plan showing location of lot and of proposed and existing buildings on premises, relationship to adjoining premises, public streets or areas, and giving a detailed description of layout of property, with ALL measurements shown, must be submitted with this application.

C. This application must be accompanied by ONE complete set of plans showing proposed construction. Plans shall describe the nature of the work to be performed, the materials and equipment to be used and installed and details of structure, mechanical, electrical and plumbing installations, sewage disposal and water drainage system.

D. The work covered by this application cannot be commenced before the issuance of a Building Permit.

E. Upon approval of this application, the Building Inspector will issue a Building Permit to the applicant.

APPLICATION IS HEREBY MADE for the issuance of a BUILDING PERMIT pursuant to the rules and regulations, that have been adopted by the Town of Pittsford, for the construction of buildings, additions or alterations, or removal, or demolition, as herein described. The OWNER will be held responsible for com-

pliance with all applicable laws, ordinances and regulations.
Subject to the provisions of the Town Building Code. All lot and setback stakes must be set and protected be- fore construction is started.
LOCATION OF PREMISES:
Tract Knollwood Sub. Lot No. R33. Street Knollwood, Drive. House No. 71. Zoned AA
LOT SIZE: Front 134.24. ft. Rear 133.34. ft. Depth 179.99 ft. Depth/988ft. Sq. Ft. Area 25,250
BUILDING: New Addition Alteration Repair Demolition  OWNER AND PRESENT ADDRESS Woodstone Custom Homes In  52 Butternut Drive
NAME AND ADDRESS OF APPLICAN'1 Pittsford, New York 14534
DWELLING X MULTIPLE DWELLING GARA 86-0953 CARS, COMMERCIAL
NAME AND ADDRESS OF APPLICAN'I Pittsford, New York 14534.  DWELLING X MULTIPLE DWELLING CARRASE-0953 CARS, COMMERCIAL INDUSTRIAL FEE \$ 254.75  COMPLETED COST \$ 270,000
DIMENSIONS OF NEW CONSTRUCTION: (As Per Plans Submitted)
Ground Floor Area 1932 st. ft. Type of Building Wood Frame
2nd Floor Area
FOR ALTERATIONS AND ADDITIONS:
Dimensions of existing structures:
Front Rear Depth Height Number of Stories
Dimension of proposed additions:
Front Rear Depth Height Number of Stories
ACCEPTANCE:
DATE: Jan 13, 1984 BLDG. INSP. SIGNATURE: William From
THIS ACCEPTANCE DOES NOT RELIEVE THE AGENT, APPLICANT, ARCHITECT, BUILDER, ENGINEER OR OWNER FROM COMPLYING WITH ANY OF THE PROVISIONS OF THE N.Y.S BUILDING CODE, ENERGY CODE, SEQR ACT, LOCAL ZONING ORD. ETC., WHETHER STATED, IMPLIED OR OMITTED IN THE PLANS AND SPECIFICATIONS SUBMITTED FOR THE BUILDING PERMIT.
STATE OF NEW YORK


COUNTY OF MONROE TOWN OF PITTSFORD

..... being duly sworn and says that he is the applicant above named. He is the owner, contractor, agent, and is duly authorized to perform the said work and to make and file this application; that all statements contained in this application are true to the best of his knowledge and belief, and that the work will be performed in the manner set forth in the application and in the plans filed herewith.

Sworn to before me

this ..... day of ....., 19 ...

(Signature of Applicant)

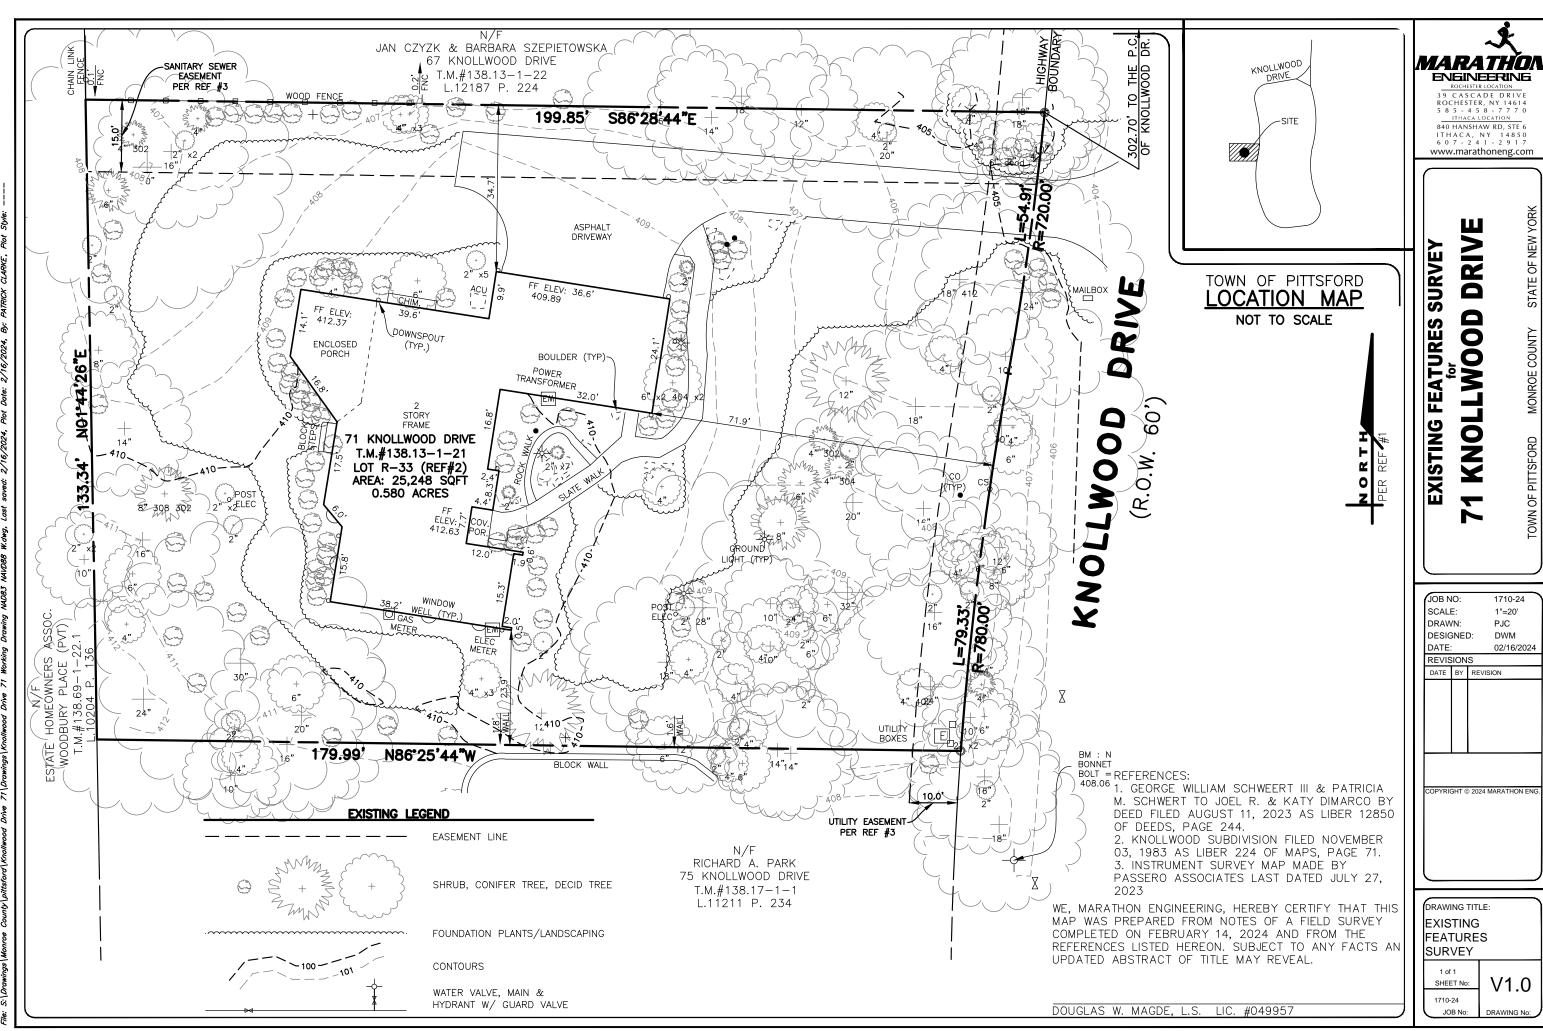

*MARATHON* **ENGINEERING** 

840 HANSHAW RD, STE 6 ITHACA, NY 14850 6 0 7 - 2 4 1 - 2 9 1 7

1710-24 02/16/2024


OPYRIGHT © 2024 MARATHON EN









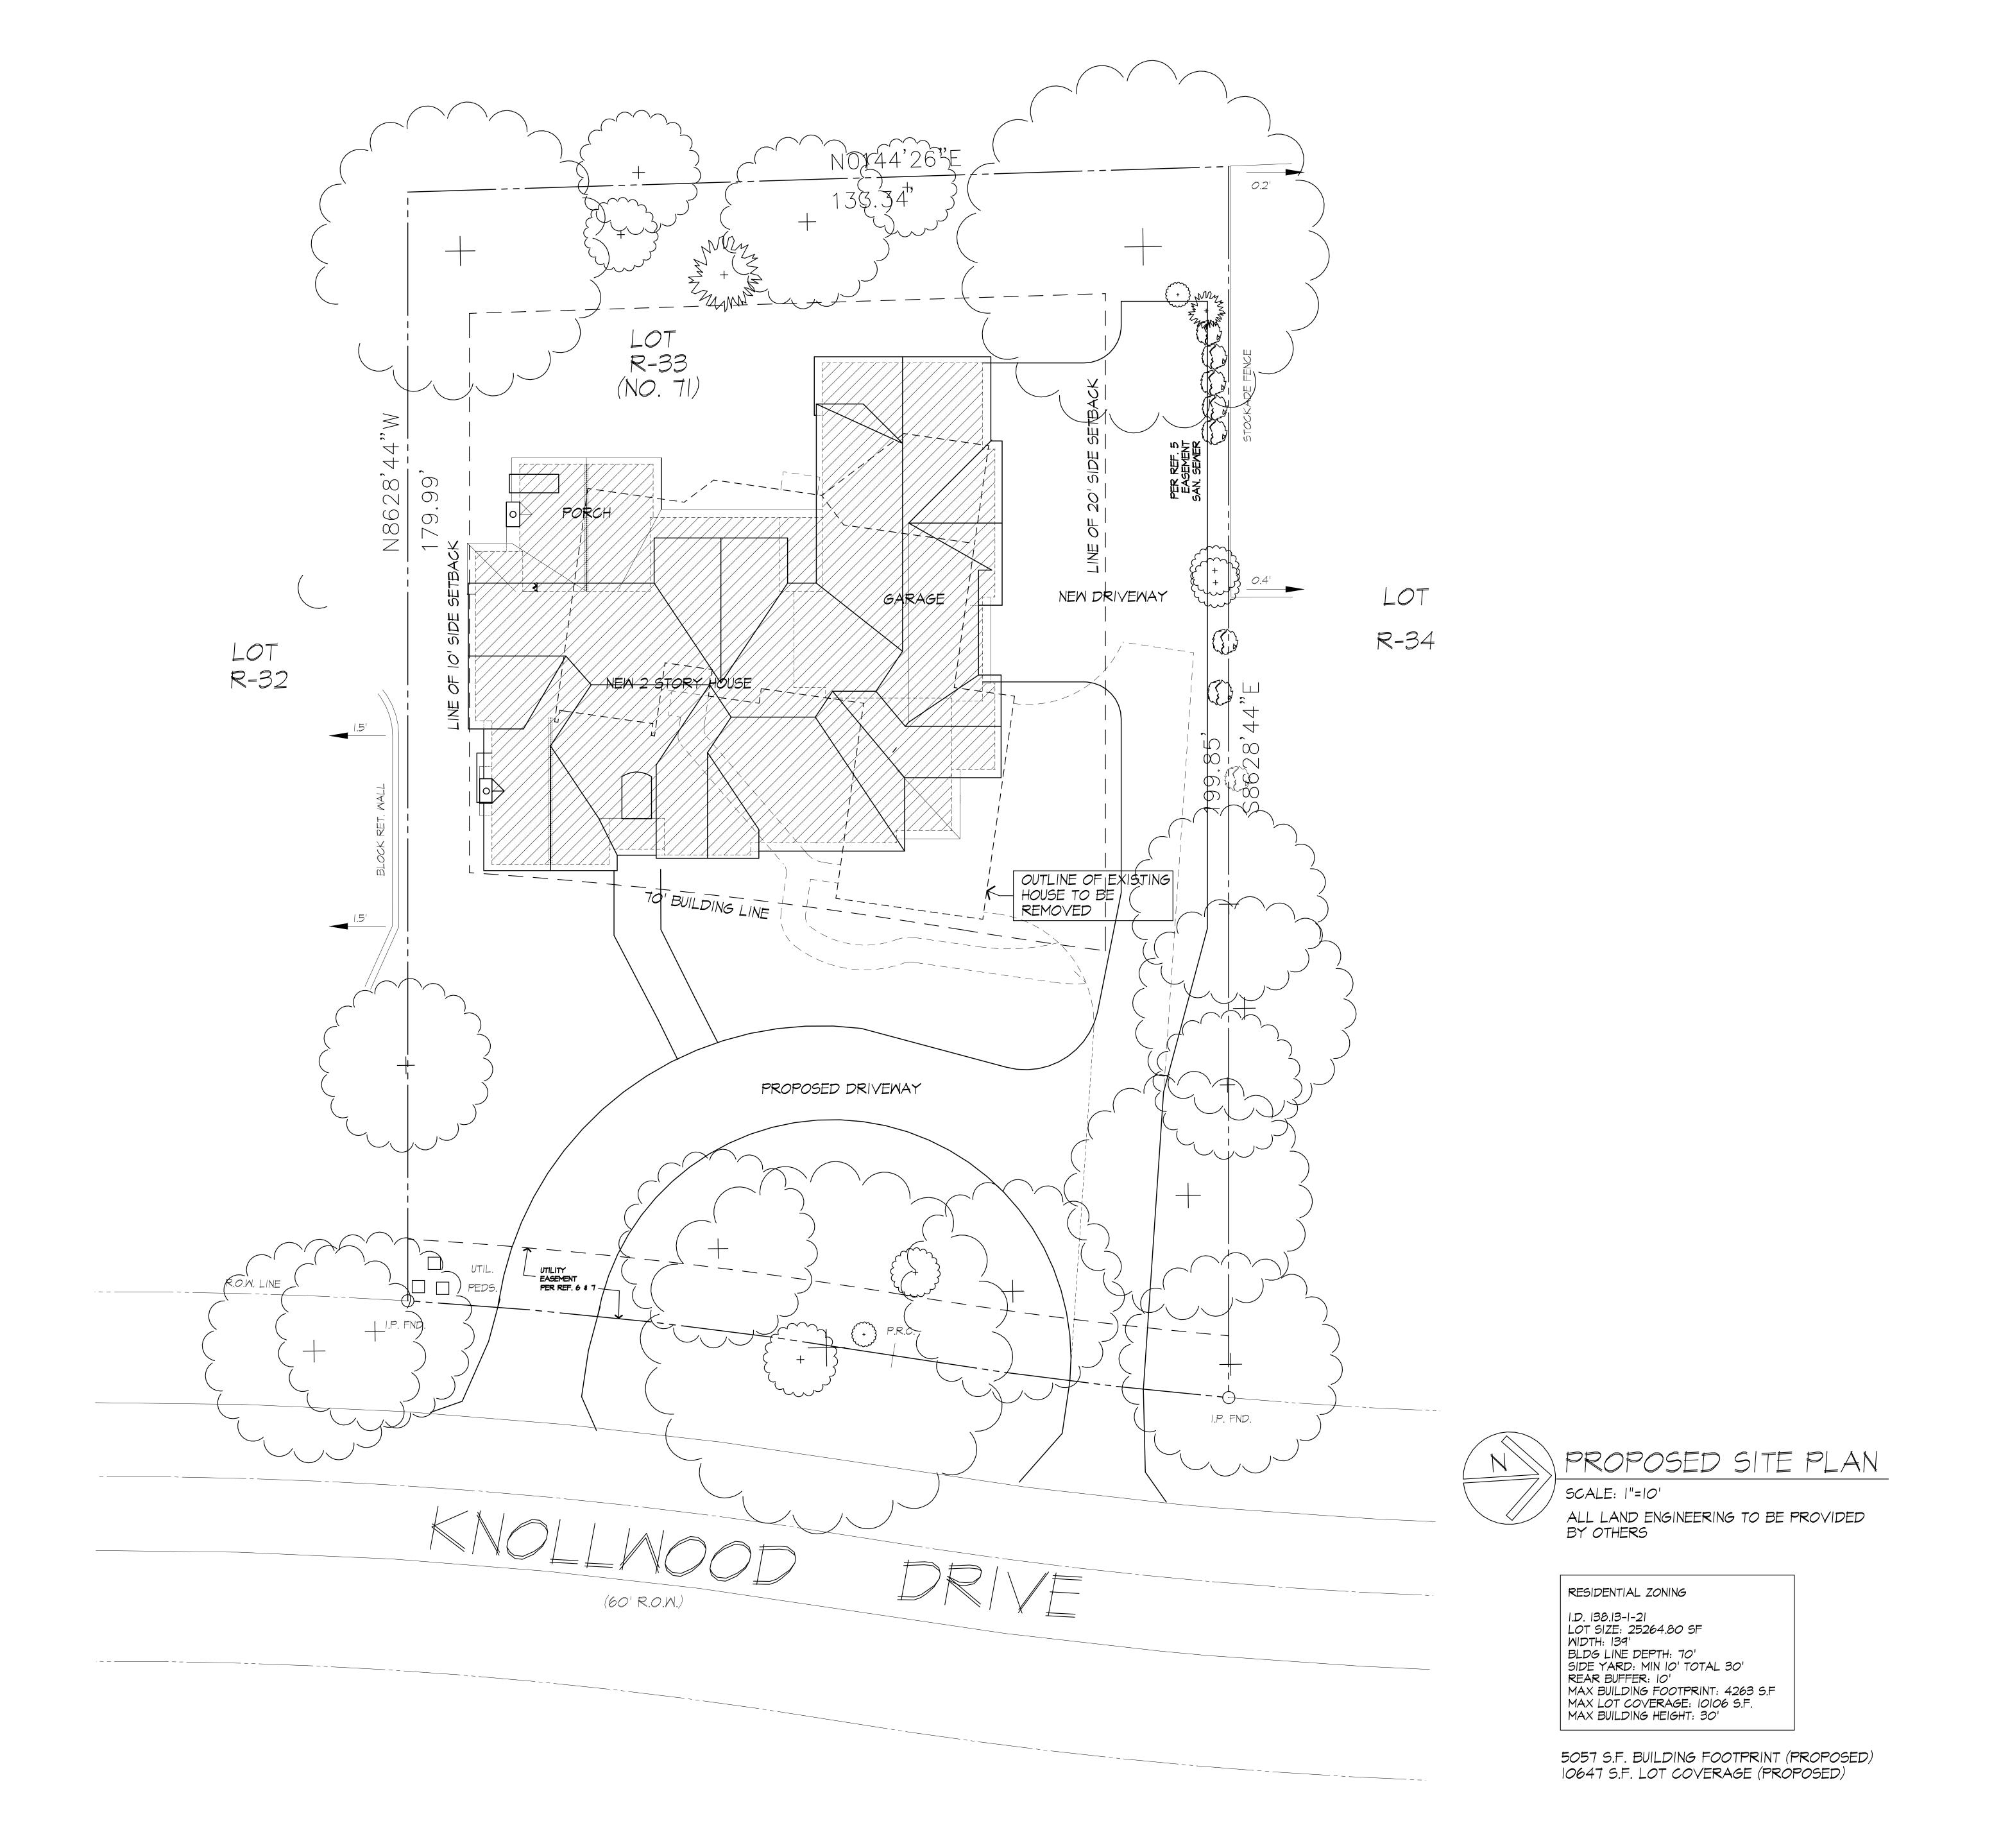



121 Sully's Trail Pittsford, NY 14534

(585) 264-1330 (585) 264-1333 Fax

www.MorabitoArchitects.com

NOTICE:

IT IS A VIOLATION OF LAW FOR ANY PERSON, UNLESS ACTING UNDER THE SUPERVISION OF A LICENSED ARCHITECT TO ALTER ANY ITEM ON THIS DOCUMENT IN ANY WAY.

ANY LICENSEE WHO ALTERS THIS DOCUMENT IS REQUIRED BY LAW TO FIX HIS OR HER SEAL AND THE NOTATION "ALTERED BY" FOLLOWED BY HIS OR HER SIGNATURE AND A SPECIFIC DESCRIPTION OF THE ALTERATIONS.

THESE DRAWINGS ARE COPYRIGHTED AND ARE SUBJECT TO COPYRIGHT PROTECTION AS AN "ARCHITECTURAL WORK" UNDER SEC. 102 OF THE COPYRIGHT ACT, 17 U.S.O. AS AMENDED DECEMBER 1990 AND KNOWN AS ARCHITECTURAL WORKS COPYRIGHT PROTECTION ACT OF 1990. THE PROTECTION INCLUDES BUT IS NOT LIMITED TO THE OVERALL FORM AS WELL AS THE ARRANGEMENT AND COMPOSITION OF SPACES AND ELEMENTS OF THE DESIGN.

UNDER SUCH PROTECTION, UNAUTHORIZED USE
OF THESE DRAWINGS OR WORK REPRESENTED
HEREIN, CAN LEGALLY RESULT IN THE CESSATION
OF CONSTRUCTION OR BUILDINGS BEING SEIZED
AND/OR MONETARY COMPENSATION TO
PATRICK J. MORABITO, A.I.A. ARCHITECT P.C.
NO FURTHER USE OR DISTRIBUTION IS ALLOWED
WITHOUT THE WRITTEN PERMISSION AND CONSENT OF
PATRICK J. MORABITO, A.I.A. ARCHITECT P.C.

COPYRIGHT 2025 PATRICK J. MORABITO, A.I.A. ARCHITECT P.C.

preliminary

PROJECT:
PROPOSED RESIDENCE
TI KNOLLWOOD DRIVE
TOWN OF PITTSFORD, NY

CLIENT:

JOEL AND KATY DIMARCO
TI KNOLLWOOD DRIVE
TOWN OF PITTSFORD, NY

SITE PLAN

DRAWING:

DRAWN: CHECKED
PJMAIA/MGM PJMAIA

DATE: 2/II/25

SCALE: 1/4"=1'-0", OR AS NOTED

JOB NO.: 23M438I

ī:

SHEETS





### FRONT ELEVATION/ PROPOSED

TOTAL PROPOSED AREA: 6510 S.F. (HOUSE)
1459 S.F. (GARAGE)
84 S.F. (GRILLING PORCH)
403 S.F. (COVERED PORCH)
100 S.F. (OTHER PORCHES)
5057 S.F. (BUILDING FOOTPRINT)



LEFT SIDE ELEVATION/ PROPOSED



121 Sully's Trail Pittsford, NY 14534

(585) 264-1330 (585) 264-1333 Fax

www.MorabitoArchitects.com

NOTICE:

UNLESS ACTING UNDER THE SUPERVISION
OF A LICENSED ARCHITECT TO ALTER ANY
ITEM ON THIS DOCUMENT IN ANY WAY.

ANY LICENSEE WHO ALTERS THIS DOCUMENT IS
REQUIRED BY LAW TO FIX HIS OR HER SEAL
AND THE NOTATION "ALTERED BY" FOLLOWED BY
HIS OR HER SIGNATURE AND A SPECIFIC

DESCRIPTION OF THE ALTERATIONS.

THESE DRAWINGS ARE COPYRIGHTED AND ARE SUBJECT TO COPYRIGHT PROTECTION AS AN "ARCHITECTURAL WORK" UNDER SEC. 102 OF THE COPYRIGHT ACT, 17 U.S.O. AS AMENDED DECEMBER 1990 AND KNOWN AS

DECEMBER 1990 AND KNOWN AS
ARCHITECTURAL WORKS COPYRIGHT PROTECTION
ACT OF 1990. THE PROTECTION INCLUDES
BUT IS NOT LIMITED TO THE OVERALL FORM
AS WELL AS THE ARRANGEMENT AND COMPOSITION
OF SPACES AND ELEMENTS OF THE DESIGN.

UNDER SUCH PROTECTION, UNAUTHORIZED USE

UNDER SUCH PROTECTION, UNAUTHORIZED USE OF THESE DRAWINGS OR WORK REPRESENTED HEREIN, CAN LEGALLY RESULT IN THE CESSATION OF CONSTRUCTION OR BUILDINGS BEING SEIZED AND/OR MONETARY COMPENSATION TO PATRICK J. MORABITO, A.I.A. ARCHITECT P.C. NO FURTHER USE OR DISTRIBUTION IS ALLOWED WITHOUT THE WRITTEN PERMISSION AND CONSENT OF PATRICK J. MORABITO, A.I.A. ARCHITECT P.C.

COPYRIGHT 2025
PATRICK J. MORABITO, A.I.A. ARCHITECT P.C.

preliminary

PROJECT:
PROPOSED RESIDENCE
TI KNOLLWOOD DRIVE
TOWN OF PITTSFORD, NY

CLIENT:

JOEL AND KATY DIMAR
TI KNOLLWOOD DRIVE
TOWN OF PITTSFORD, N

ELEVATIONS - PROPOSED

DRAWN: CHECK
PJMAIA/MGM PJMAIA

DATE: 2/II/25

SCALE: 1/4"=1'-0", OR AS NOTED

JOB NO.: 23M438I

SHEET:

SHEE





### REAR ELEVATION/ PROPOSED



MORABITO ARCHITECT, P.C. LICENSED IN CO, MA, ME, NV, NY, PA, SC

121 Sully's Trail Pittsford, NY 14534

(585) 264-1330 (585) 264-1333 Fax

www.MorabitoArchitects.com

NOTICE:

IT IS A VIOLATION OF LAW FOR ANY PERSON,

UNLESS ACTING UNDER THE SUPERVISION
OF A LICENSED ARCHITECT TO ALTER ANY
ITEM ON THIS DOCUMENT IN ANY WAY.

ANY LICENSEE WHO ALTERS THIS DOCUMENT IS
REQUIRED BY LAW TO FIX HIS OR HER SEAL
AND THE NOTATION "ALTERED BY" FOLLOWED BY
HIS OR HER SIGNATURE AND A SPECIFIC

DESCRIPTION OF THE ALTERATIONS.

THESE DRAWINGS ARE COPYRIGHTED AND ARE SUBJECT TO COPYRIGHT PROTECTION AS AN "ARCHITECTURAL WORK" UNDER SEC. 102 OF THE COPYRIGHT ACT, 17 U.S.O. AS AMENDED DECEMBER 1990 AND KNOWN AS ARCHITECTURAL WORKS COPYRIGHT PROTECTION ACT OF 1990. THE PROTECTION INCLUDES BILL IS NOT LIMITED TO THE OVERALL FORM

BUT IS NOT LIMITED TO THE OVERALL FORM
AS WELL AS THE ARRANGEMENT AND COMPOSITION
OF SPACES AND ELEMENTS OF THE DESIGN.

UNDER SUCH PROTECTION, UNAUTHORIZED USE
OF THESE DRAWINGS OR WORK REPRESENTED
HEREIN, CAN LEGALLY RESULT IN THE CESSATION
OF CONSTRUCTION OR BUILDINGS BEING SEIZED
AND/OR MONETARY COMPENSATION TO
PATRICK J. MORABITO, A.I.A. ARCHITECT P.C.
NO FURTHER USE OR DISTRIBUTION IS ALLOWED
WITHOUT THE WRITTEN PERMISSION AND CONSENT OF
PATRICK J. MORABITO, A.I.A. ARCHITECT P.C.

COPYRIGHT 2025
PATRICK J. MORABITO, A.I.A. ARCHITECT P.C.

preliminary

PROJECT:
PROPOSED RESIDENCE
TI KNOLLWOOD DRIVE
TOWN OF PITTSFORD, NY

JOEL AND KATY DIMAI TI KNOLLWOOD DRIVE TOWN OF PITTSFORD, N

DRAWING: ELEVATIONS - PROPOSED

DRAWN: CHEC

SCALE: 1/4"=1'-0", OR AS NOTED

JOB NO.: 23M-

SHEET:

F SHE

















