Agenda 02-29-2024

Town of Pittsford Design Review & Historic Preservation Board AGENDA February 29, 2024

This agenda is subject to change.

Please take notice that the Town of Pittsford Design Review & Historic Preservation Board will hold the following meeting on Thursday, February 29, 2024, in the Lower-Level Meeting Room of Pittsford Town Hall, 11 S. Main Street, and beginning at 6:00PM local time.

HISTORIC PRESERVATION DISCUSSION

RESIDENTIAL APPLICATIONS: RENOVATIONS & ADDITIONS

38 Jordan Road

Applicant is requesting design review for a 432-square-foot addition off the rear of the home.

25 Barrington Hills

Applicant is requesting design review for a 252-square-foot addition to the front of the home, as well as new windows and siding to the existing structure.

11 Smead Road

Applicant is requesting design review for a 126-square-foot addition to the rear of the home, as well as new windows, doors, and siding to the existing structure.

COMMERCIAL APPLICATIONS: SIGNAGE

3349 Monroe Avenue

Applicant is requesting design review for a 22.4-square-foot sign for Body Fuel at Pittsford Plaza.

TOWN OF PITTSFORD DESIGN REVIEW & HISTORIC PRESERVATION BOARD MINUTES FEBRUARY 8. 2024

Minutes of the Town of Pittsford Design Review and Historic Preservation Board meeting held on Thursday, February 8, 2024, at 6:00PM local time. The meeting took place in the Lower-Level Meeting Room of Pittsford Town Hall, 11 S. Main Street.

PRESENT: Dirk Schneider, Chairman; Dave Wigg, Vice Chairman; Jim Vekasy;

Bonnie Salem; John Mitchell; Kathleen Cristman

ABSENT: Paul Whitbeck

ALSO PRESENT: Bill Zink, Building Inspector; Meghan Brooks, Building Department

Assistant; Robert Koegel, Town Attorney; Cathy Koshykar, Town Board

Liaison

ATTENDANCE: There were 14 members of the public present.

The Design Review and Historic Preservation Board (DRHPB) Chairman Dirk Schneider called the meeting to order at 6:00PM.

HISTORIC PRESERVATION DISCUSSION

DRHPB Member Bonnie Salem stated the Board's intention to reach back out to some of the attendees of the Reception for Owners of Inventoried Homes held back in November of 2023. She suggested sending emails instead of letters, as it would make the contact more personal. Several Board members volunteered to contact specific homes.

DRHPB Chairman Dirk Schneider and DRHPB Member Kathleen Cristman suggested having a first paragraph that has been formalized through the Town. Board Member Salem agreed to write it.

RESIDENTIAL APPLICATIONS: RETURNING

800 Allens Creek Road

Applicant is requesting design review for a 240 square foot storage addition off the side of the home.

Brandon DiCesare of 800 Allens Creek Road introduced the application. Mr. DiCesare restated his family's need for storage and noted the changes made to the design since the application had previously come to the Board. He stated that they added a window and tried to match the gable without losing the necessary egress from the window above. They have chosen to use a metal roof because of the amount of debris that comes off nearby trees.

Chairman Schneider confirmed with Mr. DiCesare that the roof color will match existing shingle roof. DRHPB Vice Chairman Dave Wigg asked what material will be used for the siding. Mr. DiCesare responded that he is not entirely sure, but likely some sort of shake vinyl. Vice Chairman Wigg strongly suggested adding a corner board.

DRHPB Chairman Dirk Schneider motioned to approve the 240-square-foot storage addition off the side of the home as submitted, with the condition that the trim and siding color and style match the existing home. This motion was seconded by DRHPB Member John Mitchell. Following a unanimous voice vote, the application was approved, none opposed.

18 Amber Hill Drive

Applicant is requesting design review for a 1,560-square-foot, three-story addition to the rear of the home.

Jenna Evans of Pardi Partnership Architects introduced the application. Ms. Evans stated that the application has returned with revised elevations which include additional windows to the west and south elevations.

The Board expressed its appreciation that the west elevation had been improved.

DRHPB Member Bonnie Salem motioned to approve the 1,560-square-foot, three-story addition to the rear of the home as submitted, with the condition that the siding line will follow grade over the CMU. This motion was seconded by DRHPB Vice Chairman Dave Wigg. Following a unanimous voice vote, the application was approved, none opposed.

COMMERCIAL APPLICATIONS: RETURNING

3330 Monroe Avenue – Community Bank N.A.

Applicant is requesting design review for the exterior renovation of a commercial buildout. This property is zoned Commercial (C).

Doug Templeton of Hanlon Architects introduced the application with Albert Giannino of Community Bank N.A. Mr. Templeton restated the project and noted that, per the Board's request, the façade is now carried further onto the northwest elevation. They also provided roof plans in the updated submittal.

Board Member Salem stated that she had driven by the existing building and now, seeing the new elevations, she feels that the design is a marked improvement to the current structure. DRHPB Member Jim Vekasy added that the façade looks more complete and overall has a nice depth and thickness to it. Chairman Schneider confirmed with Mr. Giannino that he is happy with the changes the Board had requested.

DRHPB Member John Mitchell motioned to approve the exterior renovation of the commercial buildout of Community Bank N.A as submitted. This motion was seconded by DRHPB Member Jim Vekasy. Following a unanimous voice vote, the application was approved, none opposed.

RESIDENTIAL APPLICATIONS: RENOVATIONS & ADDITIONS

16 Ravenna Crescent

Applicant is requesting design review for a 308-square-foot garage addition to the south side of the home.

Jim Beswick, contractor, introduced the application.

Chairman Schneider asked if the driveway will be expanding to three lanes. Mr. Beswick stated that it will be flared out to meet the new door, but that the paving would be the homeowner's responsibility. Chairman Schneider confirmed with Mr. Beswick that the expanded pavement would not go all the way to the road and require a curb cut.

Board Member Salem stated that she liked that the garage addition is set back and that the exposed wall has a window and door.

DRHPB Member Kathleen Cristman motioned to approve the 308-square-foot garage addition to the south side of the home as submitted. This motion was seconded by DRHPB Member Bonnie Salem. Following a unanimous voice vote, the application was approved, none opposed.

RESIDENTIAL APPLICATIONS: NEW HOMES

3 Old Homestead Road

Applicant is requesting design review for a 2,981-square-foot, two-story home in the Country Pointe Subdivision.

Lou Masi of Mascot Inc. introduced the application. Mr. Masi stated that the stone is wrapped around the corners of this design.

Vice Chairman Wigg asked if the lumber will be kept natural or if it will be painted. Mr. Masi stated that it will be painted but the homeowners have not yet chosen a color.

There was some discussion about the location and angle of the home in relation to others in the area. Mr. Masi confirmed that this home will face West Bloomfield.

DRHPB Vice Chairman Dave Wigg motioned to approve the 2,981-square-foot, two-story home in the Country Pointe Subdivision as submitted. This motion was seconded by DRHPB Member John Mitchell. Following a unanimous voice vote, the application was approved, none opposed.

COMMERCIAL APPLICATIONS: ADDITIONS & RENOVATIONS

3349 Monroe Avenue - Shell Space

Applicant is requesting design review for a new storefront entry to the exterior of a commercial shell space whose use is changing from one tenant to two.

Eric Wright of Wilmorite Construction introduced the application. Mr. Wright stated that the current Citizens Bank is looking to downsize and, as such, they are proposing to divide the

building into two spaces. They will fill in some areas of the exterior and add another storefront facing Pittsford Plaza to create a shell space for a future tenant.

Chairman Schneider confirmed that Citizens Bank's signage application will be coming in separately. He also inquired about the ATM canopy. Mr. Wright stated that it would remain as a functioning ATM.

Board Member Cristman and Chairman Schneider both expressed their appreciation that the Plaza and Citizens Bank are rethinking building uses rather than leaving Town and creating empty storefronts.

DRHPB Chairman Dirk Schneider motioned to approve the new storefront entry to the exterior of a commercial shell space as submitted. This motion was seconded by DRHPB Member Bonnie Salem. Following a unanimous voice vote, the application was approved, none opposed.

01/11/2024 MEETING MINUTES REVIEW

The minutes of January 25, 2024, were approved following a motion by DRHPB Chairman Dirk Schneider. This motion was seconded by DRHPB Member Jim Vekasy. Following a unanimous voice vote, the minutes were approved, none opposed.

OTHER DISCUSSION


Design Review and Historic Preservation Board Chairman Dirk Schneider closed the meeting at 6:46PM.

Respectfully submitted,

Meghan Brooks

Building Department Assistant

OFFICIAL MINUTES ARE ON FILE IN THE OFFICE OF THE BUILDING DEPARTMENT

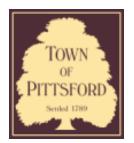

Town of Pittsford

Department of Public Works 11 South Main Street Pittsford, New York 14534

Permit # B24-000020

Phone: 585-248-6250 FAX: 585-248-6262

DESIGN REVIEW AND HISTORIC PRESERVATION BOARD REFERRAL OF APPLICATION

Property Address: 38 Jordan Road PITTSFORD, NY 14534

Tax ID Number: 164.18-1-52

Zoning District: RN Residential Neighborhood

Owner: Schirmer, June E Applicant: Brian Hartman

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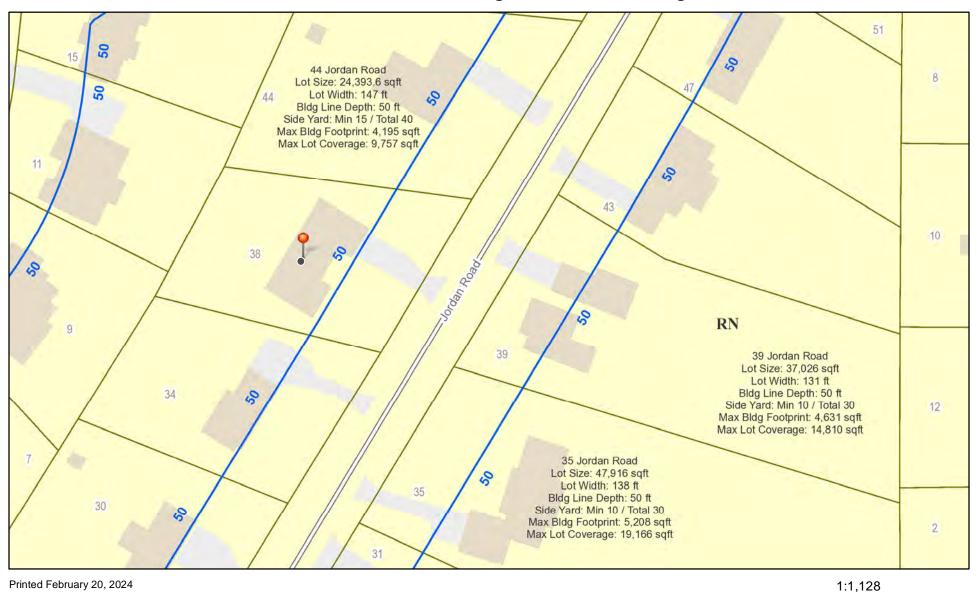
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Residential Design Review §185-205 (B)	Build to Line Adjustment §185-17 (B) (2)
Commercial Design Review §185-205 (B)	Building Height Above 30 Feet §185-17 (M)
Signage §185-205 (C)	Corner Lot Orientation §185-17 (K) (3)
Certificate of Appropriateness §185-197	Flag Lot Building Line Location §185-17 (L) (1) (c)
Landmark Designation §185-195 (2)	Undeveloped Flag Lot Requirements §185-17 (L) (2)
Informal Review	

Project Description: Applicant is requesting design review for a 432-square-foot addition off the rear of the home.

Meeting Date: February 29, 2024



RN Residential Neighborhood Zoning



Town of Pittsford GIS

12.5

25

180 ft

50 m



GENERAL NOTES:

- THESE PLANS HAVE BEEN PREPARED TO THE BEST OF THE ARCHITECT'S KNOWLEDGE, BELIEF, AND PROFESSIONAL JUDGMENT IN ACCORDANCE WITH THE 2020 RESIDENTIAL CODE OF NEW YORK STATE AND ENERGY CONSERVATION CODE REQUIREMENTS. THE CONTRACTOR SHALL BE RESPONSIBLE FOR ADAPTING THESE PLANS, IF REQUIRED, TO SUIT THE NEEDS OF THE BUILDING ON THE SITE. PROVIDED THAT THE ALTERATIONS DO NOT VIOLATE THE CODE OR ALTER THE STRUCTURAL INTEGRITY OF THE BUILDING.
- 2. THE CONTRACTOR SHALL BE RESPONSIBLE FOR COMPLIANCE WITH ALL APPLICABLE BUILDING/ELECTRICAL/MECHANICAL/SANITARY AND ENERGY CODES; STATE OR LOCAL. THE CONTRACTOR SHALL BE RESPONSIBLE FOR COMPLIANCE WITH THE ENERGY CONSERVATION CODE FOR ALL HVAC EQUIPMENT, HVAC CONTROLS, WATER HEATING EQUIPMENT, PIPE AND DUCT INSULATION, AND FLUORESCENT LAMPS AND BALLASTS.
- 3. THE CONTRACTOR SHALL BE RESPONSIBLE SO THAT BRANDS OF WINDOWS AND DOORS INSTALLED MEET THE NEW YORK STATE ENERGY CONSERVATION CODE REQUIREMENTS, WINDOWS AND / OR DOORS SHOWN ARE INDICATED FOR SIZING ONLY.
- 4. ALL FOOTINGS SHALL REST ON UNDISTURBED VIRGIN SOIL. THE FOOTING/FOUNDATION DESIGN ASSUMES MINIMUM SOIL BEARING PRESSURE TO BE 2000 PSF. CONTRACTOR SHALL BE RESPONSIBLE FOR ALL SUBGRADE CONDITIONS. IF REQUIRED, THE OWNER AND / OR CONTRACTOR SHALL BE RESPONSIBLE FOR HIRING A SOILS ENGINEER TO VERIFY SUBGRADE CONDITIONS AND SUBSTANTIATE ACTUAL BEARING CAPACITY.
- 5. BACKFILL MATERIALS SHALL BE NATIVE SOIL.
 FOR FILL UNDER THE GARAGE FLOOR OR BASEMENT FLOOR,
 PROVIDE SAND/ GRAVEL FILL FOR COMPACTION AS NEEDED
- MINIMUM CONCRETE COMPRESSIVE STRENGTH:

2500 PSI FOOTINGS

- 7. CONCRETE BLOCK SHALL CONFORM TO ASTM C90 N-I, WALL REINFORCING ASTM A82. ALL MORTAR SHALL CONFORM TO ASTM C270, TYPE S I PART PORTLAND CEMENT, I/4 PART LIME, 3 PARTS SAND.
- 8. _{N/A}
- 9. MINIMUM FIBER STRESS IN BENDING (FB) FOR ALL FRAMING LUMBER TO BE 1150 PSI #2
 HEM-FIR OR BETTER. PROVIDE DOUBLE FRAMING MEMBERS UNDER PARTITIONS RUNNING IN
- O. CONTRACTOR SHALL PAY STRICT ADHERENCE TO MICROLAM MANUFACTURER'S WRITTEN DIRECTIONS FOR CUTTING, DRILLING, NOTCHING, JOINING AND GENERAL INSTALLATION OF
- WOOD TRUSSES SHALL BE DESIGNED BY MANUFACTURER.
 SUPPLIER SHALL BE RESPONSIBLE FOR INSTALLATION DETAILS
- 12. PLYWOOD SHALL CONFORM TO U.S. PRODUCT STANDARD PS I, THICKNESS AS SHOWN,
 APA RATED SHEATHING EXP-I. NAILING AND SPACING PER APA RECOMMENDATIONS FOR
- 13. ALL WOOD IN CONTACT WITH CONCRETE OR MASONRY SHALL BE FULLY WOOD PRESERVATIVE-TREATED WITH OSMOSALTS OR WOLMAN SALTS.
- |4. ALL OPENINGS IN THE BUILDING ENVELOPE (DOORS, WINDOWS, UTILITIES) SHALL BE CAULKED, WEATHER-STRIPPED, OR OTHERWISE SEALED.

 CORROSION RESISTIVE FLASHING SHALL BE PROVIDED AT THE LOCATIONS ON THE EXTERIOR WALL ENVELOPE PER RESIDENTIAL CODE OF NEW YORK (2020)
- 15. CONTRACTOR SHALL VERIFY ALL NOTES AND DIMENSIONS PRIOR TO CONSTRUCTION.
 THESE DRAWINGS ARE NOT TO BE SCALED USE DIMENSIONS GIVEN.
- 16. CONTRACTOR SHALL BE RESPONSIBLE FOR ALL CONSTRUCTION MEANS, METHODS, TECHNIQUES, SEQUENCES AND SAFETY PRECAUTIONS IN CONNECTION WITH THE WORK
- 17. THESE DRAWINGS HAVE BEEN PREPARED FOR STRUCTURAL INTENT ONLY. ELECTRICAL, MECHANICAL AND OTHER BUILDING SYSTEMS, AS REQUIRED ARE TO BE DESIGNED BY OTHERS.
- THE FOLLOWING DESIGN LOADS HAVE BEEN USED IN THE STRUCTURES DESIGN IN ACCORDANCE WITH THE PRINTED SPAN TABLES IN THE RESIDENTIAL CODE OF NEW YORK STATE (2020).


 FLOOR LOADS (LIVING AREAS-IST FLOOR)

 EXTERIOR DECKS

 40 PSF
- 19. ALL WORK, MATERIALS, METHODS, EQUIPMENT, ETC. SHALL BE IN STRICT ACCORDANCE WITH THE CONTRACT DOCUMENTS. ALL MATERIALS SHALL BE NEW, UNLESS NOTED OTHERWISE.
- 20. WORK SEQUENCE AND SCHEDULE SHALL BE MUTUALLY AGREED UPON BY BOTH THE OWNER AND THE CONTRACTOR.
- 21. IT IS ASSUMED THAT THE SUBSURFACE CONDITIONS WILL BE EARTH OR SOIL. IF BEDROCK IS ENCOUNTERED, IT WILL BE REMOVED AS REQUIRED.
- 22. ANY DEMOLITION WORK SHALL BE DONE CAREFULLY. ALL DISTURBED SURFACES TO BE REPAIRED APPROPRIATELY. ALL SALVAGEABLE ITEMS SHALL BE TURNED OVER TO THE OWNER.
- EXAMINATION OF THE SITE SHOULD BE MADE BY ALL CONTRACTORS CONCERNED TO FULLY CONSIDER ALL SITE CONDITIONS WHICH MAY HAVE A BEARING ON THE WORK OF THE ENTIRE PROJECT. SUBMISSION OF A BID IS PRESUMPTIVE EVIDENCE THAT THE BIDDER IS CONVERSANT WITH LOCAL JURISDICTIONS AND HAS MADE DUE ALLOWANCES IN HIS BID FOR ALL CONTINGENCIES. THE OWNER RESERVES THE RIGHT TO REJECT ANY OR ALL BIDS.
- 24. IT IS THE RESPONSIBILITY OF THE CONTRACTOR TO NOTIFY THE ARCHITECT IN CASE OF ANY OR ALL DEVIATIONS FROM THESE DRAWINGS. THE ARCHITECT SHALL BE HELD HARMLESS AS A RESULT OF ANY UNAUTHORIZED CHANGES TO THESE PLANS. ADDITIONAL FEES MAY OCCUR FOR "AS BUILT" DOCUMENTATION DUE TO CIRCUMSTANCES BEYOND THE ARCHITECT'S CONTROL, OR OWNER / CONTRACTOR CHANGES TO THESE DRAWINGS
- 25. THE CONTRACTOR SHALL OBTAIN AND PAY FOR ALL PERMITS AND APPROVALS REQUIRED BY THE LOCAL ZONING AND BUILDING DEPARTMENTS AND ANY OTHER GOVERNMENTAL AGENCY HAVING JURISDICTION OVER THE WORK. ALL APPLICABLE REGULATIONS SHALL BE ADHERED TO AND CARRIED OUT BY ALL INDIVIDUALS UNDER THIS CONTRACT.
- 26. THE CONTRACTOR SHALL FURNISH A CERTIFICATE OF INSURANCE INDICATING THE TYPE AND AMOUNTS OF COVERAGE AS REQUIRED BY NEW YORK STATE AND THE LOCAL MUNICIPALITY.
- SATISFACTORY TO THE OWNER.
- 28. THE CONTRACTOR SHALL GUARANTEE HIS WORK AND HIS SUBCONTRACTOR'S WORK AGAINST FAULTY MATERIALS AND WORKMANSHIP IN ACCORDANCE WITH NEW YORK STATE GENERAL BUSINESS LAW.
- 29. ONLY COPIES FROM THE ORIGINALS OF THESE DRAWINGS MARKED WITH AN ORIGINAL OF THE ARCHITECT'S WET SEAL SHALL BE CONSIDERED TO BE VALID TRUE COPIES.

THE CONTRACTOR SHALL REMOVE ALL RUBBISH AND LEAVE THE COMPLETED PROJECT IN A CLEAN STATE,

- 30. BUILDING IS CLASSIFIED AS A ONE FAMILY DWELLING
- SMOKE-DETECTING ALARM DEVICES SHALL BE INSTALLED IN COMPLIANCE WITH SECTION R314.3
 OF THE RESIDENTIAL CODE OF NEW YORK STATE (2020)
 CARBON MONOXIDE ALARM DEVICES SHALL BE INSTALLED IN COMPLIANCE WITH SECTION 915 FCNYS
- 32. ALL MATERIALS USED IN THIS PROJECT SHALL BE NON-ASBESTOS AND NON-LEAD CONTAINING.

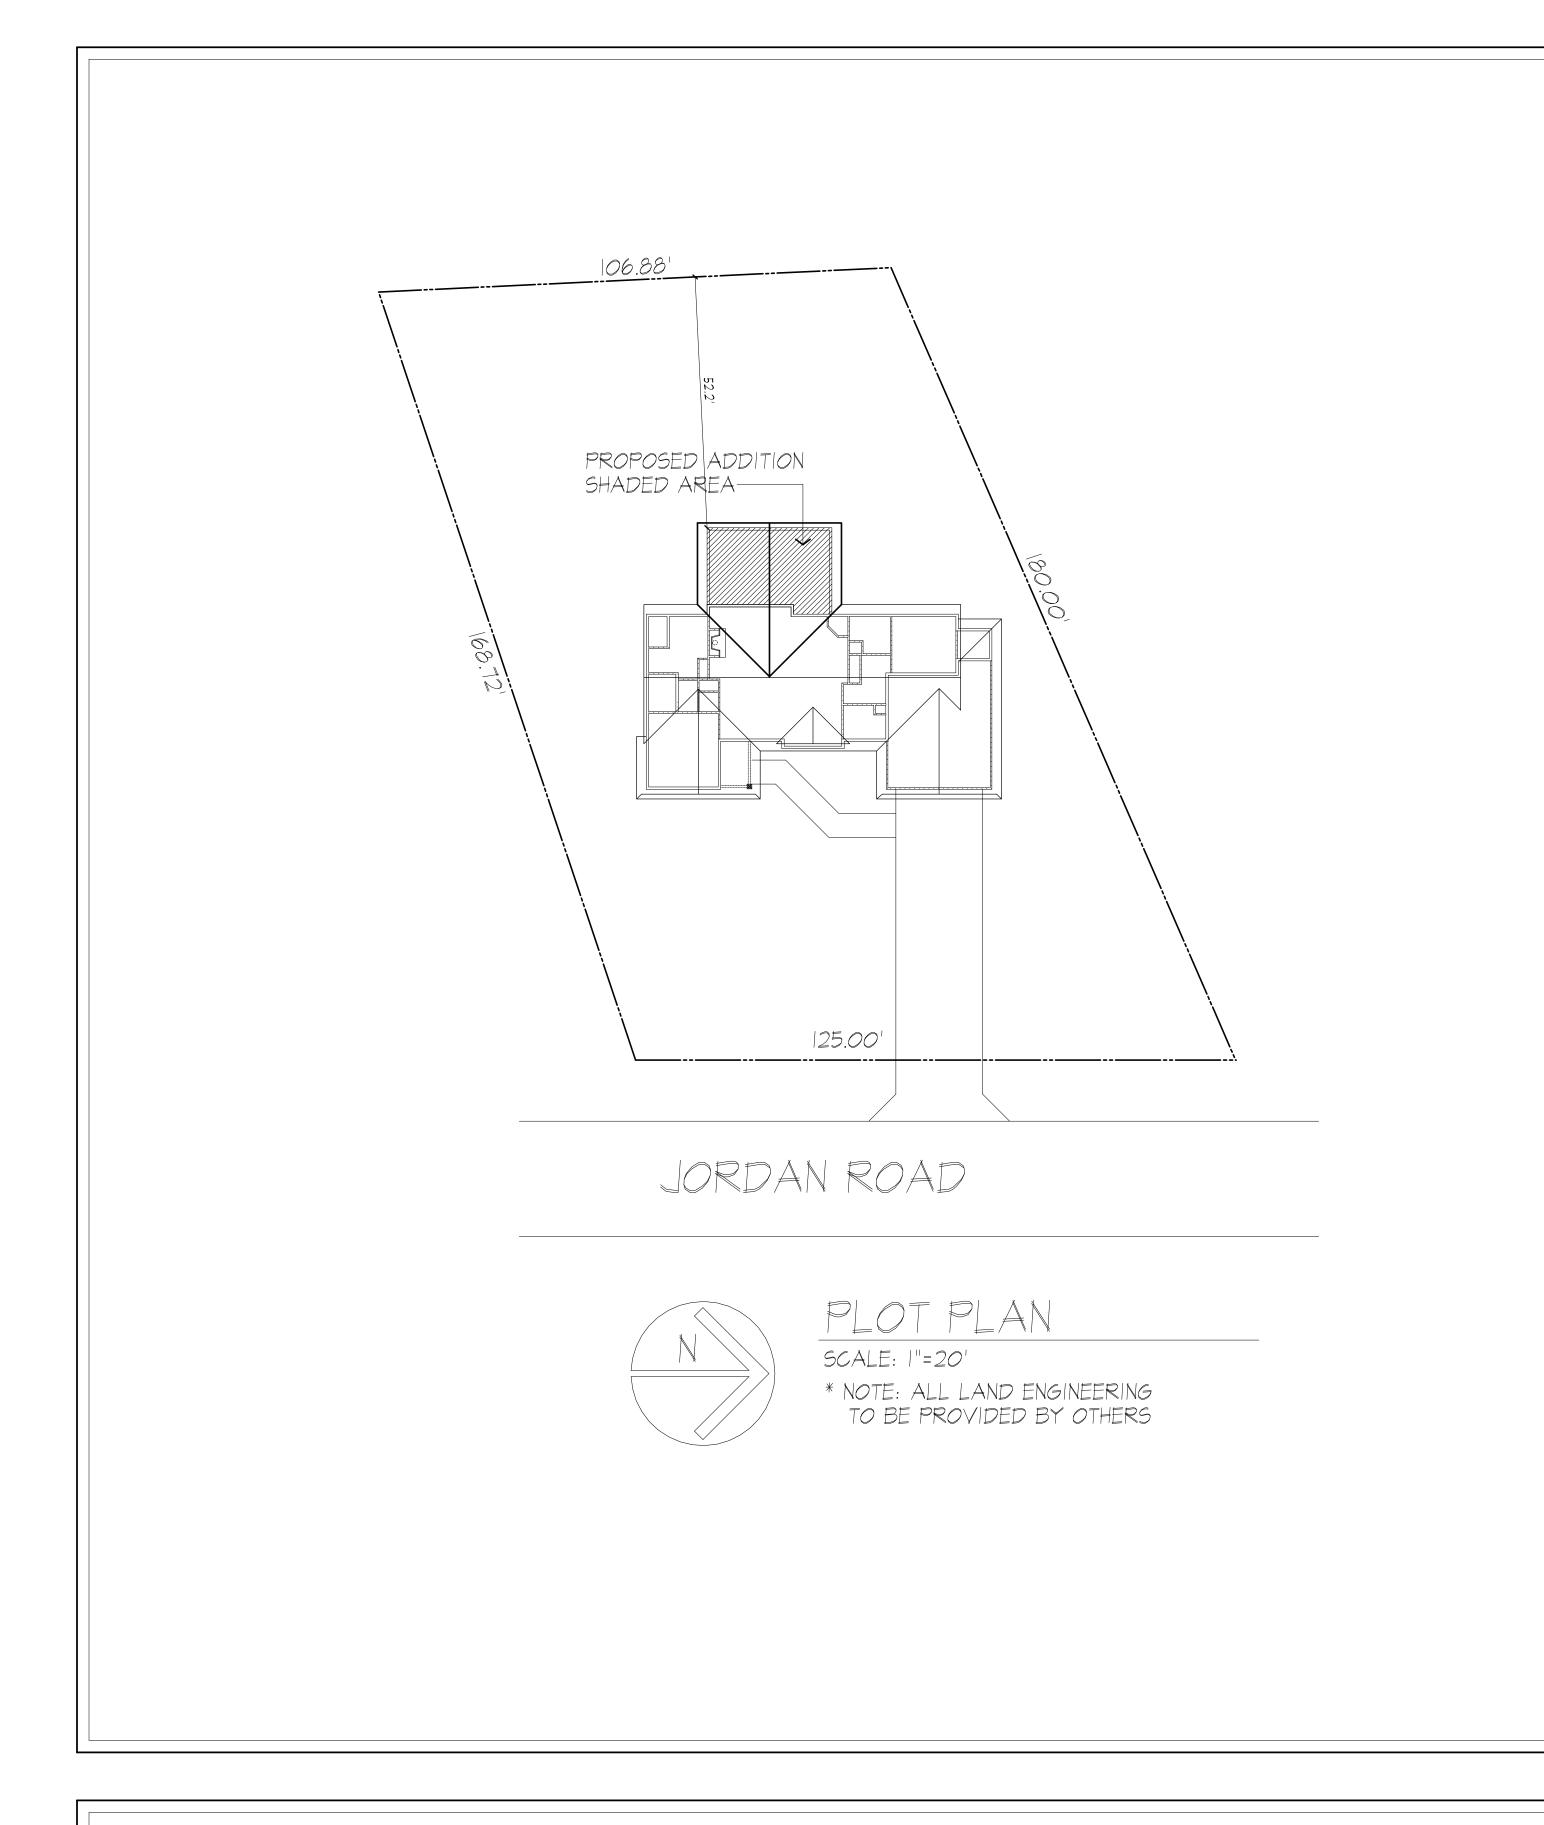

PROPOSED ADDITION

SCHIRMER RESIDENCE

38 JORDAN RD PITTSFORD NY

DRAWING INDEX

1	TITLE PAGE
2	ELEVATIONS 1
3	ELEVATIONS 2
4	FOUNDATION PLAN- proposed
5	FLOOR PLAN- proposed
6	ROOF PLAN

BUILDING SECTIONS/TYPICAL NOTES

ENERGY COMPLIANCE DETAILS & PATH

MEETS OR EXCEEDS PRESCRIPTIVE REQUIREMENTS R402.1.2 (2020 RESIDENTIAL CODE OF NEW YORK STATE) CLIMATE ZONE - 5

(
COMPONENT	REQUIRED	PROVIDED
I. FENESTRATION U-FACTOR	.30	.30
2. CEILING R-FACTOR	49	R-49
3. WOOD FRAMED WALL R-VALUE	20 OR 13+5	R-2I
4. FLOOR R-VALUE	30	30

2020 INTERNATIONAL ENERGY CONSERVATION CODE (IECC) COMPLIANCE PATH

- I. A MINIMUM OF 90% OF THE LAMPS IN PERMANENTLY INSTALLED LIGHTING FIXTURES SHALL BE HIGH-EFFICIENCY LAMPS PER SECTION IIO4.I
- 2. RECESSED LUMINARIES INSTALLED IN THE BUILDING THERMAL ENVELOPE SHALL BE SEALED WITH A GASKET OR CAULK BETWEEN THE HOUSING AND THE INTERIOR WALL OR CEILING COVERING TO LIMIT AIR LEAKAGE BETWEEN CONDITIONED AND UNCONDITIONED SPACES. PER SECTION 1102.4.5
- 3. CONTRACTOR TO PROVIDE A PROGRAMMABLE THERMOSTAT TO CONTROL THE HVAC SYSTEM PER SECTION 1103.1.1
- 4. ALL CIRCULATING SERVICE HOT WATER PIPING SHALL BE INSULATED TO AT LEAST R-2. CIRCULATION HOT WATER SYSTEMS SHALL INCULDE AN AUTOMATIC OR READILY ACCESSIBLE MANUAL SWITCH THAT CAN TURN OFF THE HOT WATER CIRCULATING PUMP WHEN THE SYSTEM IS NOT IN USE. PER SECTION 1103.3.4
- 5. AIR LEAKAGE TEST TO BE CONDUCTED & PERFORMED BY A THIRD PARTY IN COMPLIANCE WITH 1102.4.1.2. AIR LEAKAGE RATE MAY NOT EXCEED 3 ACH (CLIMATE ZONE 5)
- 6. ATTIC ACCESS SHALL BE INSULATED WITH THE SAME R-VALUE AS THE ATTIC, WEATHER STRIPPED AND LATCHED PER SECTION 1102.2.3
- 7. DUCTWORK ON EXTERIOR WALLS IF REQUIRED SHALL BE INSULATED TO A MINUMUM OF R-6 PER 1103.2.1
- 8. MECHANICAL VENTILATION PER SECTION NIIO3.6 TO BE MET WITH CONTINUOUS USE EXHAUST FANS AND MAKE-UP AIR CONTROLS, PER
- SECTION MI507.3.3 REQUIREMENT.

 9. MECHANICAL VENTILATION FAN EFFICACY SHALL MEET MINIMUM
- REQUIREMENTS PER SECTION NIIO3.6.1.

 10. HEATING AND COOLING EQUIPMENT SHALL BE SIZED IN ACCORDANCE WITH SECTION NIIO3.7 REQUIREMENTS.

BASIC DESIGN CRITERIA

- I. GROUND SNOW LOAD 40 PSF R301.2 (5)
- 2. WIND SPEED 115 MPH, EXPOSURE B R301.2.1
- 3. SEISMIC DESIGN CATEGORY A R301.2 (2)
- 4. WEATHERING SEVERE
- 5. FROST LINE DEPTH 48"
- 6. TERMITE DAMAGE NONE TO SLIGHT
- 7. DECAY DAMAGE NONE TO SLIGHT
- B. WINTER DESIGN TEMPERATURE 1
- 9. ICE SHIELD UNDERLAYMENT REQUIRED YES
- IO. FLOOD HAZARD FIRM 1992
- II. ROOF TIE DOWN REQUIREMENTS R802.II.I



121 Sully's Trail Pittsford, NY 14534

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PROJECT:
PROPOSED ADDITION

38 JORDAN RD PITTSFORD NY

CLIENT:
JUNE SCHIRMER

DRAWING:
TITLE PAGE

DRAWN: Paul morabito


DATE: FEBRUARY 2024 **SCALE:** 1/4"=1'-0"

SCALE: 1/4"=1'-0"

JOB NO.: 23M4380

HEET:



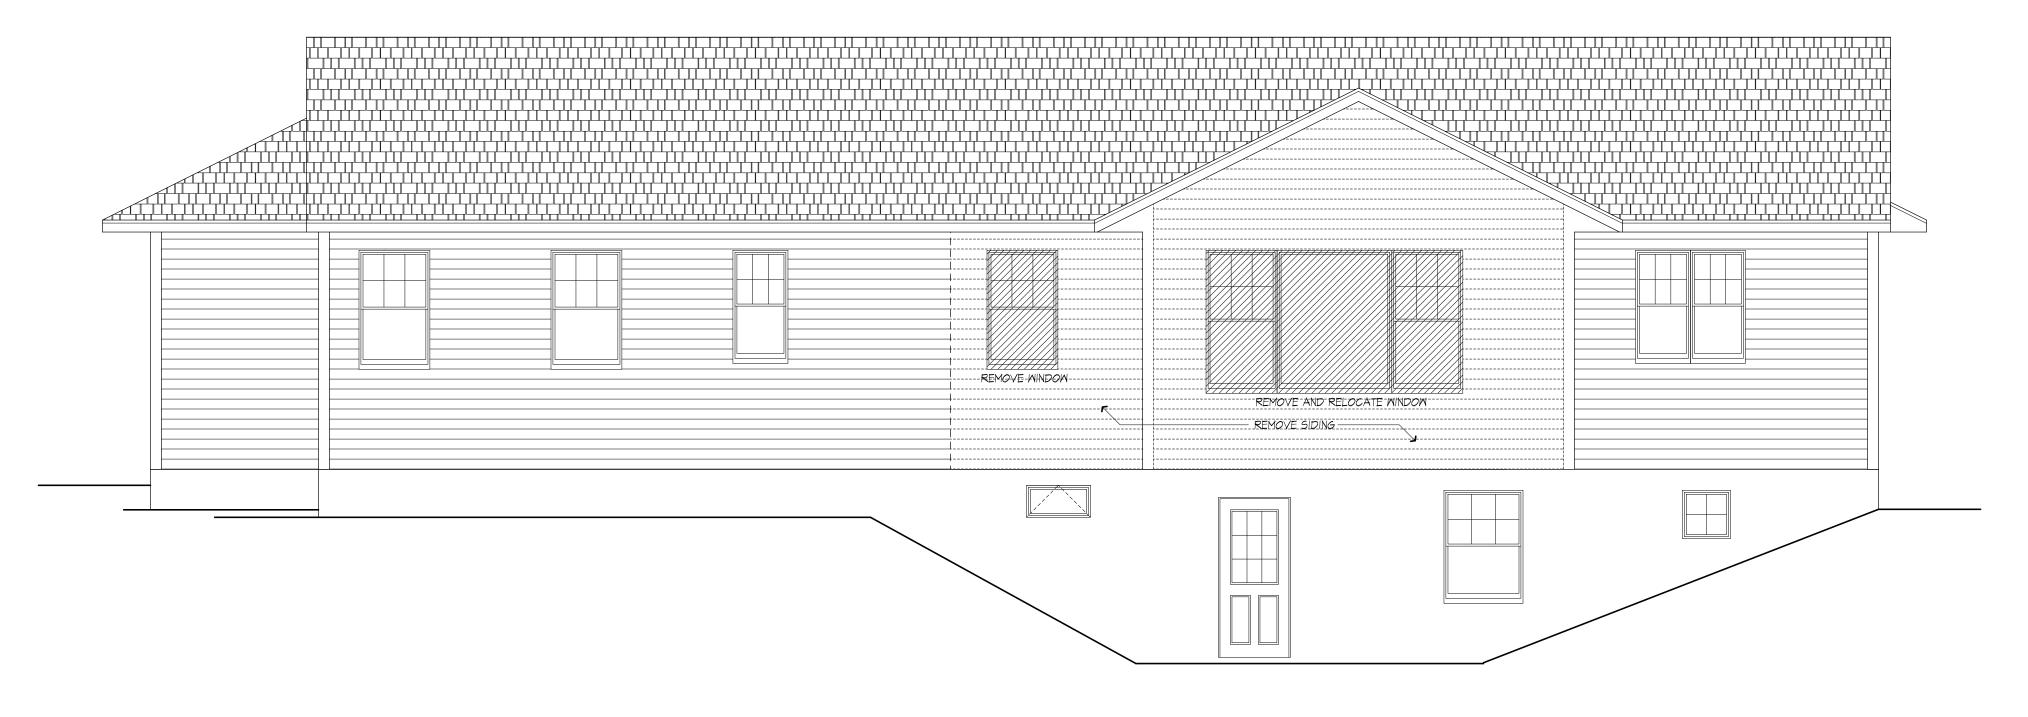

REAR ELEVATION

EXISTING WITH REMOVALS SHOWN





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OF SPACES AND ELEMENTS OF THE DESIGN.

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PROPOSED AT

PROPOSED ADDITION 36 JORDAN RD PITTSFORD NY

JUNE SCHIRMER

DIAMING.

DRAWN:

PAUL MORABI


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OF **7** SHFFT.






RIGHT SIDE ELEVATION

EXISTING

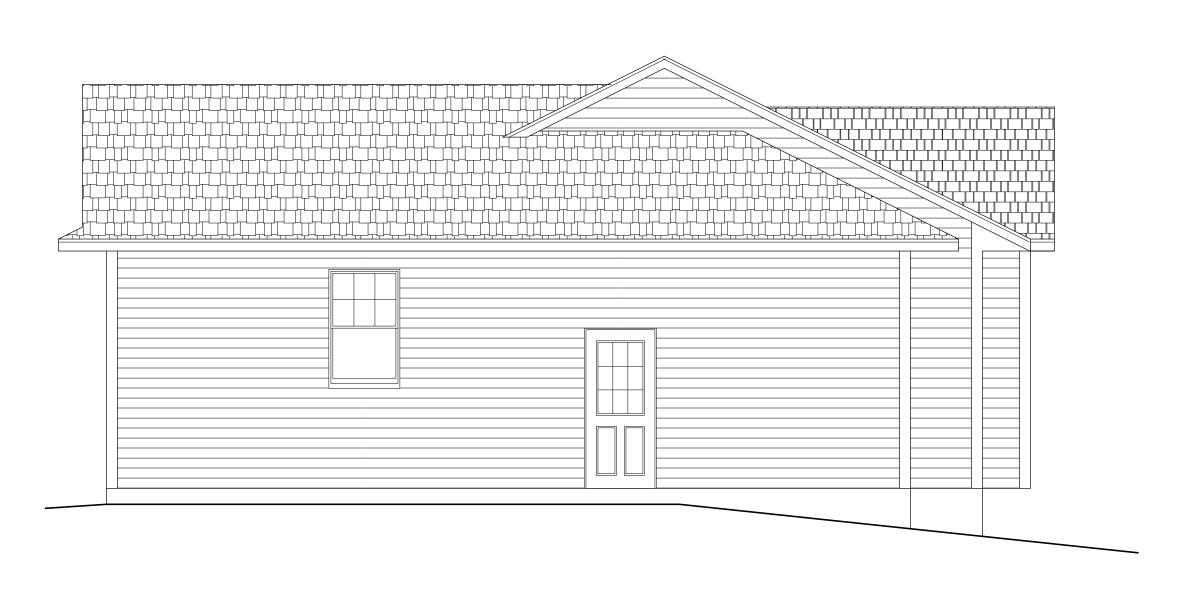

LEFT SIDE ELEVATION

EXISTING

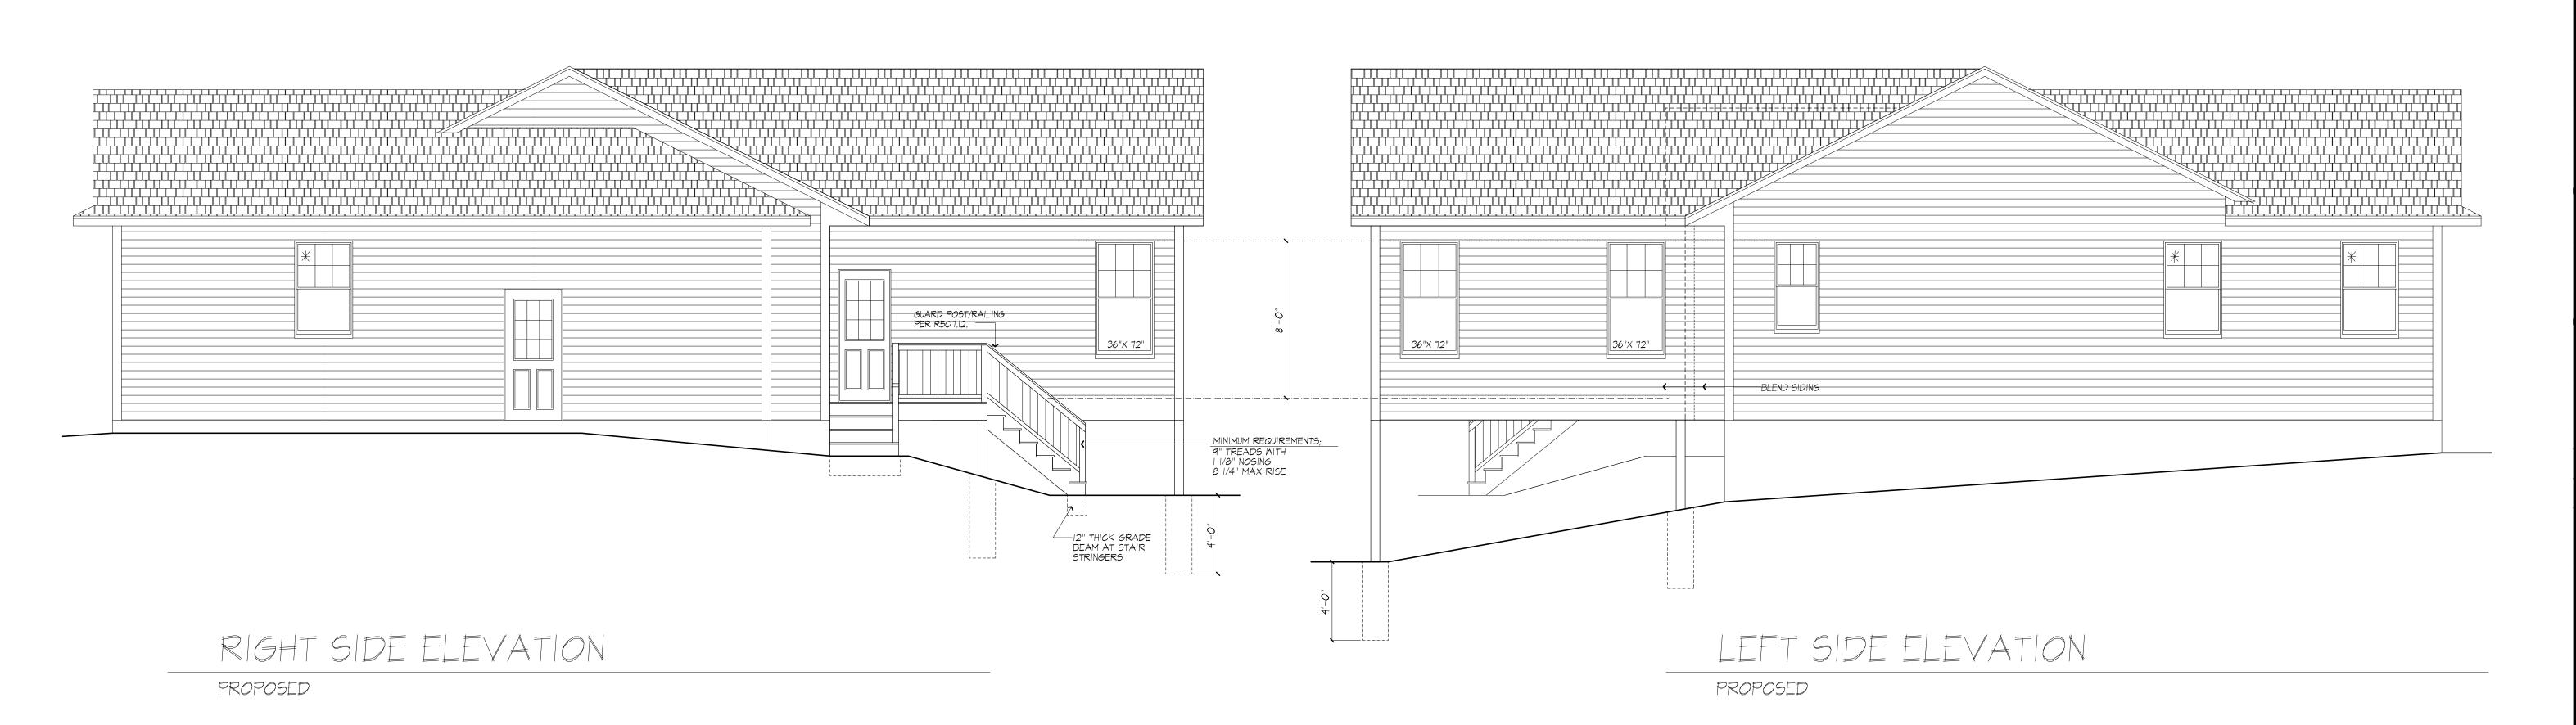

MORABITO ARCHITECTS

LICENSED IN CO, MA, ME, NV, NY, PA, SC

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PROJECT: PROPOSED AI

PROPOSED ADDITION 36 JORDAN RD PITTSFORD NY

CLIENT: JUNE SCHIRMER

DRAWING: ELEVATIONS 2

DRAWN:
PAUL MORABITO

DATE: FEBRUAF


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SHEET:

3





FOUNDATION PLAN

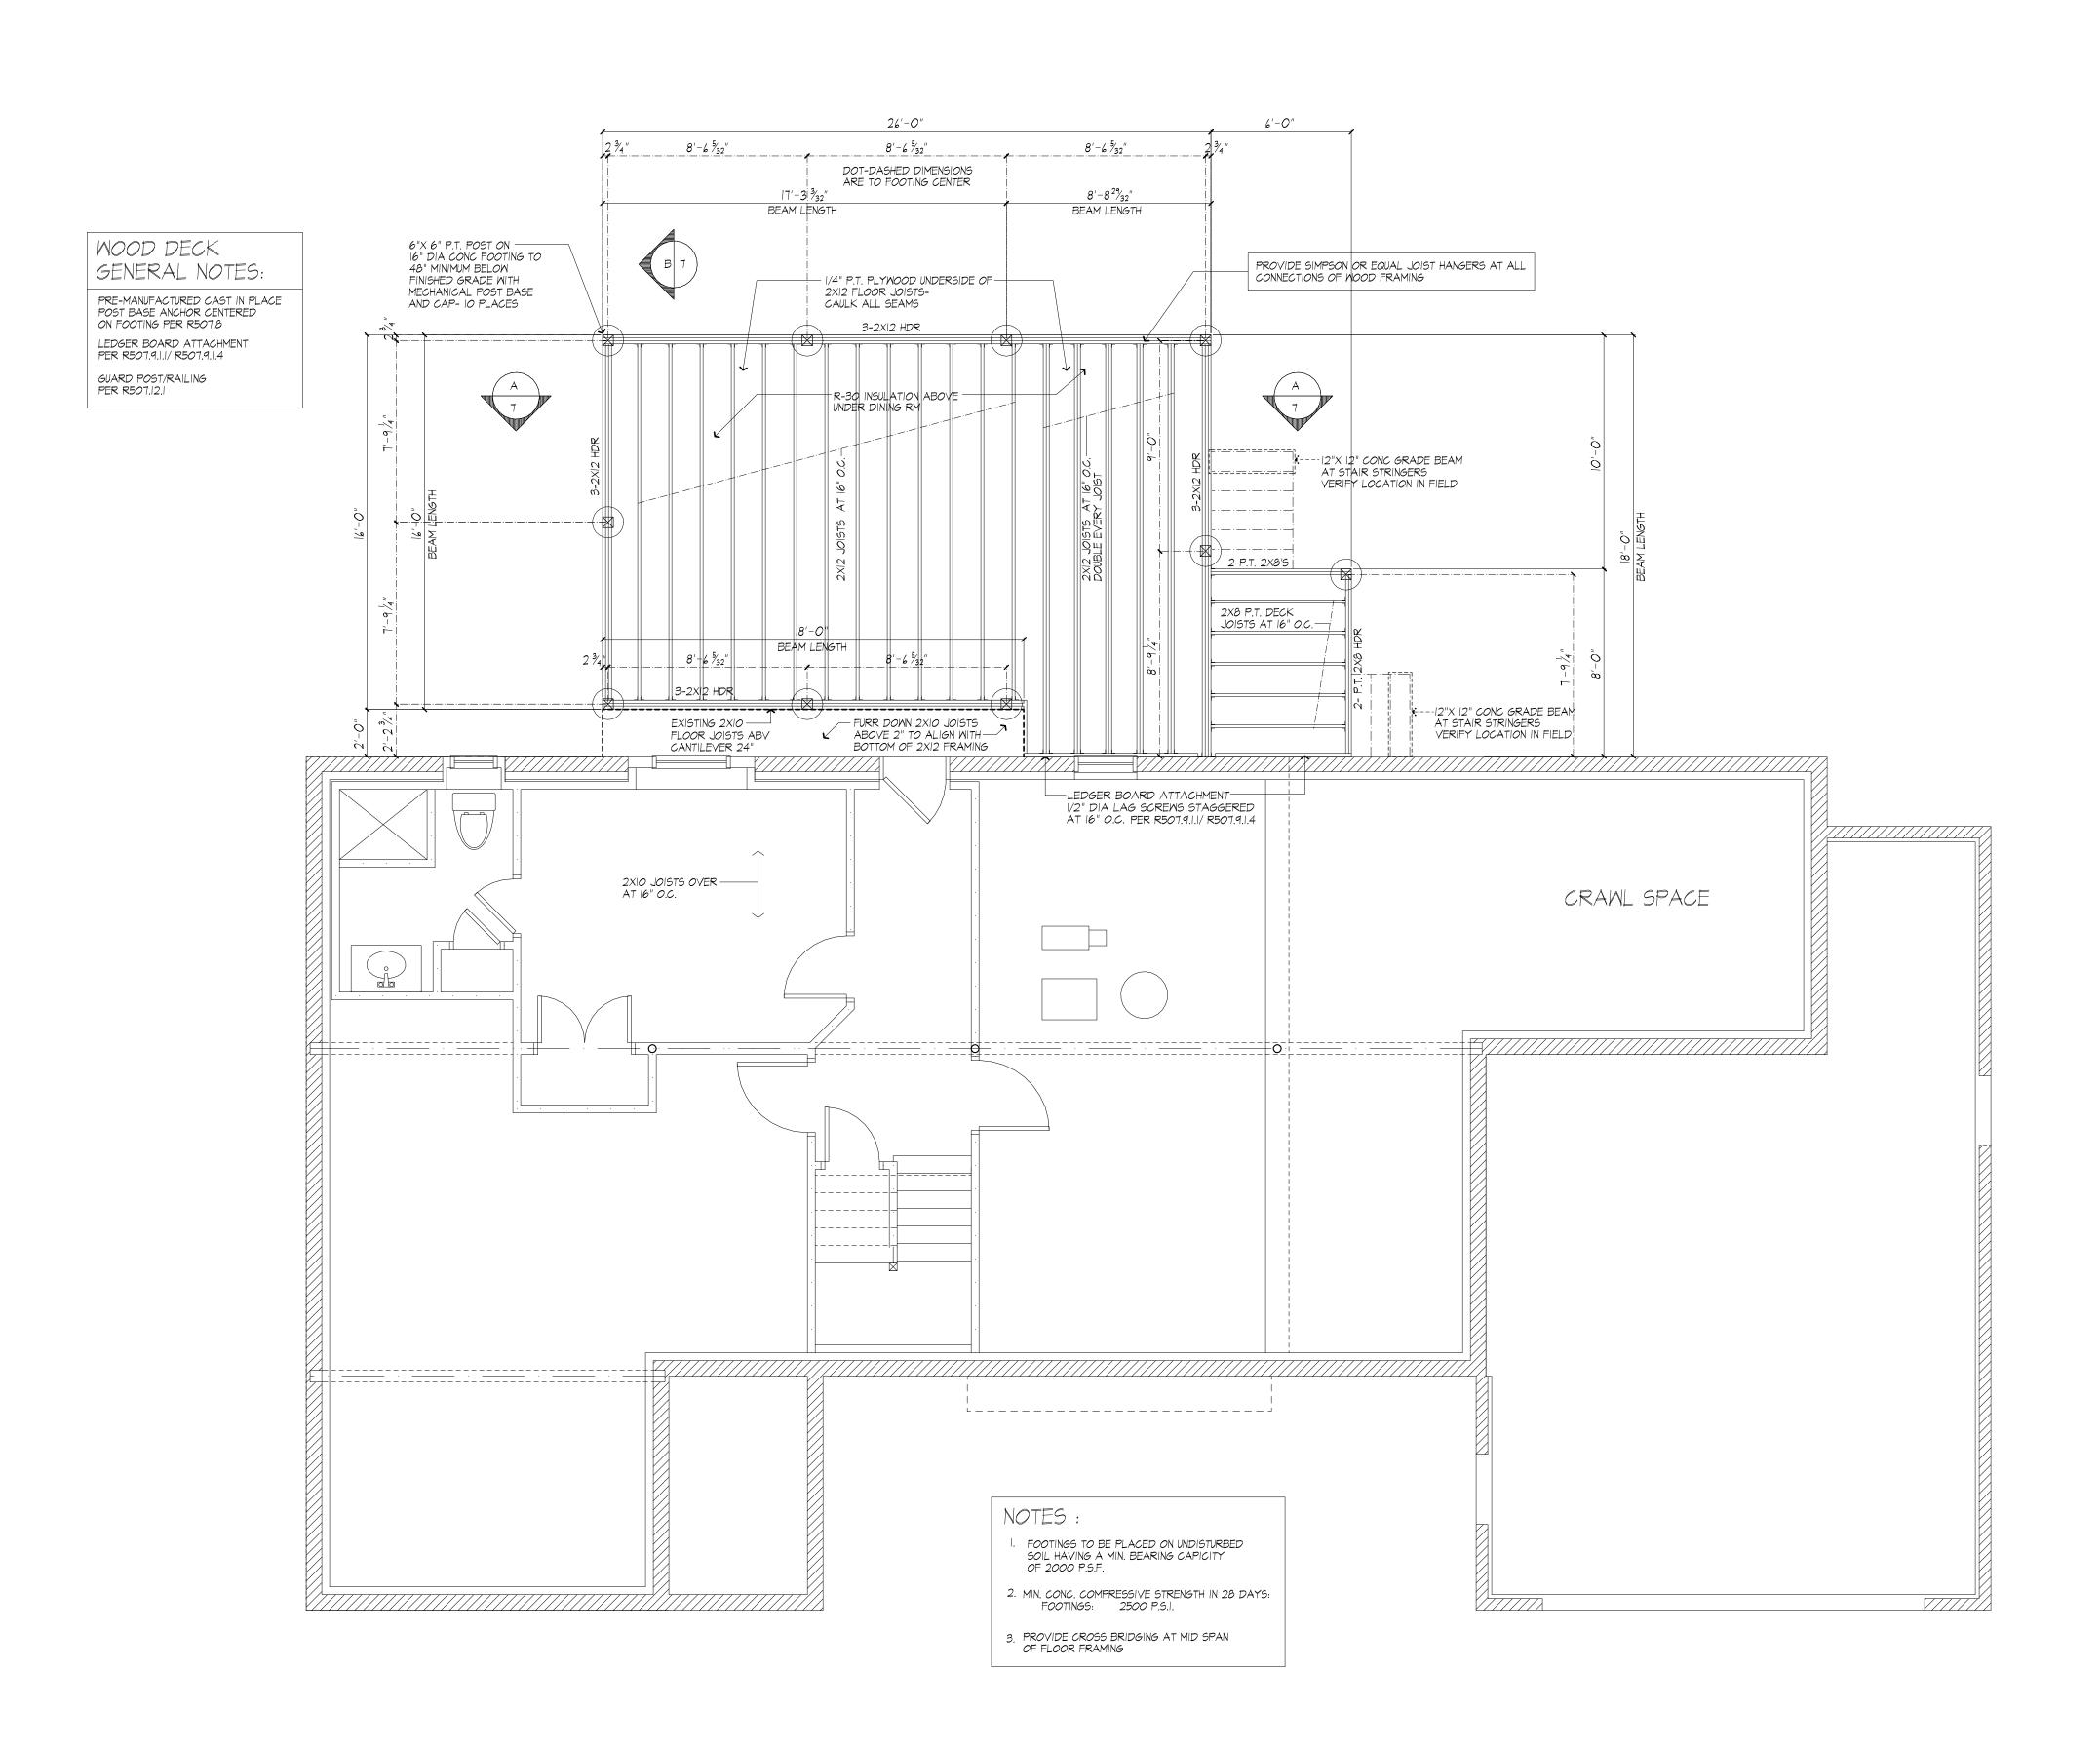PROPOSED



121 Sully's Trail Pittsford, NY 14534

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PROJECT:

PROPOSED ADDITION
38 JORDAN RD PITTSFORD NY

FOUNDATION PLAN - PROPOSED

CLIENT:

JUNE SCHIRMER

DRAWING:

DDAIWA

PAUL MORABITO

DATE: FEBRUARY 2024

SCALE: 1/4"=1'-0"

JOB NO.: 23M4380

SHEET:

4

of **7** sheets



WINDOW FALL PROTECTION

WINDOW FALL PROTECTION SHALL BE PROVIDED IN ACCORDANCE WITH SECTIONS R312.2.1 AND R312.2.2

R312.2.1 WINDOW SILLS. IN DWELLING UNITS, WHERE THE TOP OF THE SILL OF AN OPERABLE WINDOW OPENING IS LOCATED LESS THAN 24 INCHES ABOVE THE FINISHED FLOOR AND GREATER THAN 72 INCHES ABOVE THE FINISHED GRADE OR OTHER SURFACE BELOW ON THE EXTERIOR OF THE BUILDING, THE OPERABLE WINDOW SHALL COMPLY WITH ONE OF THE

. OPERABLE WINDOWS WITH OPENINGS THAT WILL NOT ALLOW A 4-INCH-DIAMETER (102 MM) SPHERE TO PASS THROUGH THE OPENING WHERE THE OPENING IS IN ITS LARGEST OPENED POSITION. 2.0PERABLE WINDOWS THAT ARE PROVIDED WITH WINDOW FALL PREVENTION DEVICES THAT COMPLY WITH ASTM F 2090. 3.OPERABLE WINDOWS THAT ARE PROVIDED WITH WINDOW OPENING

CONTROL DEVICES THAT COMPLY WITH SECTION R312.2.2.

R312.2.2 WINDOW OPENING CONTROL DEVICES. WINDOW OPENING CONTROL DEVICES SHALL COMPLY WITH ASTM F 2090. THE WINDOW OPENING CONTROL DEVICE, AFTER OPERATION TO RELEASE THE CONTROL DEVICE ALLOWING THE WINDOW TO FULLY OPEN, SHALL NOT REDUCE THE NET CLEAR OPENING AREA OF THE WINDOW UNIT TO LESS THAN THE AREA REQUIRED BY SECTION R310.2.1.

WINDOW GLAZING

HAZARDOUS LOCATION.

IN THE INDIVIDUAL UNIT.

WINDOW GLAZING SHALL BE PROVIDED IN ALL HAZARDOUS LOCATIONS IN ACCORDANCE WITH SECTION R308

R308.4.1 GLAZING IN DOORS

GLAZING IN FIXED AND OPERABLE PANELS OF SWINGING, SLIDING AND BIFOLD DOORS SHALL BE CONSIDERED TO BE A HAZARDOUS

I. GLAZED OPENINGS OF A SIZE THROUGH WHICH A 3" DIA SPHERE IS UNABLE TO PASS
2. DECORATIVE GLAZING

R308.4.7 GLAZING ADJACENT TO THE BOTTOM STAIR LANDING GLAZING ADJACENT TO THE LANDING AT THE BOTTOM OF A STAIRWAY WHERE THE GLAZING IS LESS THAN 36" ABOVE THE LANDING AND WITHIN A 60" HORIZONTAL ARC LESS THAN 180 DEGREES FROM THE BOTTOM TREAD NOSING SHALL BE CONSIDERED TO BE A HAZARDOUS LOCATION


I. WHERE GLAZING IS ADJACENT TO A WALKING SURFACE AND A HORIZONTAL RAIL IS INSTALLED AT 34" TO 38" ABOVE THE WALKING SURFACE 2. GLAZING 36" OR MORE MEASURED HORIZONTALLY FROM THE WALKING SURFACE

SMOKE & CARBON MONOXIDE ALARM LOCATIONS

R314.3 LOCATION. SMOKE ALARMS SHALL BE INSTALLED IN THE FOLLOWING LOCATIONS: I. IN EACH SLEEPING ROOM. 2. OUTSIDE EACH SEPARATE SLEEPING AREA IN THE IMMEDIATE VICINITY OF THE BEDROOMS. 3. ON EACH ADDITIONAL STORY OF THE DWELLING, INCLUDING BASEMENTS BUT NOT INCLUDING CRAWL SPACES AND UNINHABITABLE ATTICS. IN DWELLINGS OR DWELLING UNITS WITH SPLIT LEVELS AND WITHOUT AN INTERVENING DOOR BETWEEN THE ADJACENT LEVELS, A SMOKE ALARM INSTALLED ON THE UPPER LEVEL SHALL SUFFICE FOR THE ADJACENT LOWER LEVEL PROVIDED THAT THE LOWER LEVEL IS LESS THAN OF FULL STORY BELOW THE UPPER LEVEL. WHEN MORE THAN ONE SMOKE ALARM IS REQUIRED TO BE INSTALLED WITHIN AN INDIVIDUAL DWELLING UNIT THE ALARM DEVICES SHALL BE INTERCONNECTED IN SUCH A MANNER THAT THE ACTUATION OF ONE ALARM WILL ACTIVATE ALL OF THE ALARMS

R315 REQUIRED LOCATIONS. CARBON MONOXIDE ALARMS SHALL BE PROVIDED IN THE FOLLOWING LOCATIONS: I. WITHIN EACH DWELLING UNIT ON EACH STORY CONTAINING A SLEEPING AREA, WITHIN 10 FEET OF THE SLEEPING AREA. MORE THAN ONE CARBON MONOXIDE ALARM SHALL BE PROVIDED WHERE NECESSARY TO ASSURE THAT NO SLEEPING AREA ON A STORY IS MORE THAN 10 FEET AWAY FROM A CARBON MONOXIDE ALARM. 2. ON ANY STORY OF A DWELLING UNIT THAT CONTAINS A CARBON MONOXIDE SOURCE.

	HE)	ADER SCHEDULE UNLESS OTHERWISE NOTED	
OPENING		2X6 WALL	
UP TO	5'-0"	(3) 2×8	
UP TO	8'-0"	(3) 2XIO	
PROVIDE (2) 1/2" PLY. WD. GUSSETS -2X6 WALL PROVIDE (1) 1/2" PLY. WD. GUSSETS -2X4 WALL GLUE AND NAIL ALL HEADERS			
		WALL LEGEND	
2X6 STUDS AT 16" OC W/ R-21 INSULATION			
		2X6 STUDS AT 16" OC	
		2X4 STUDS @ 16"O.C.	

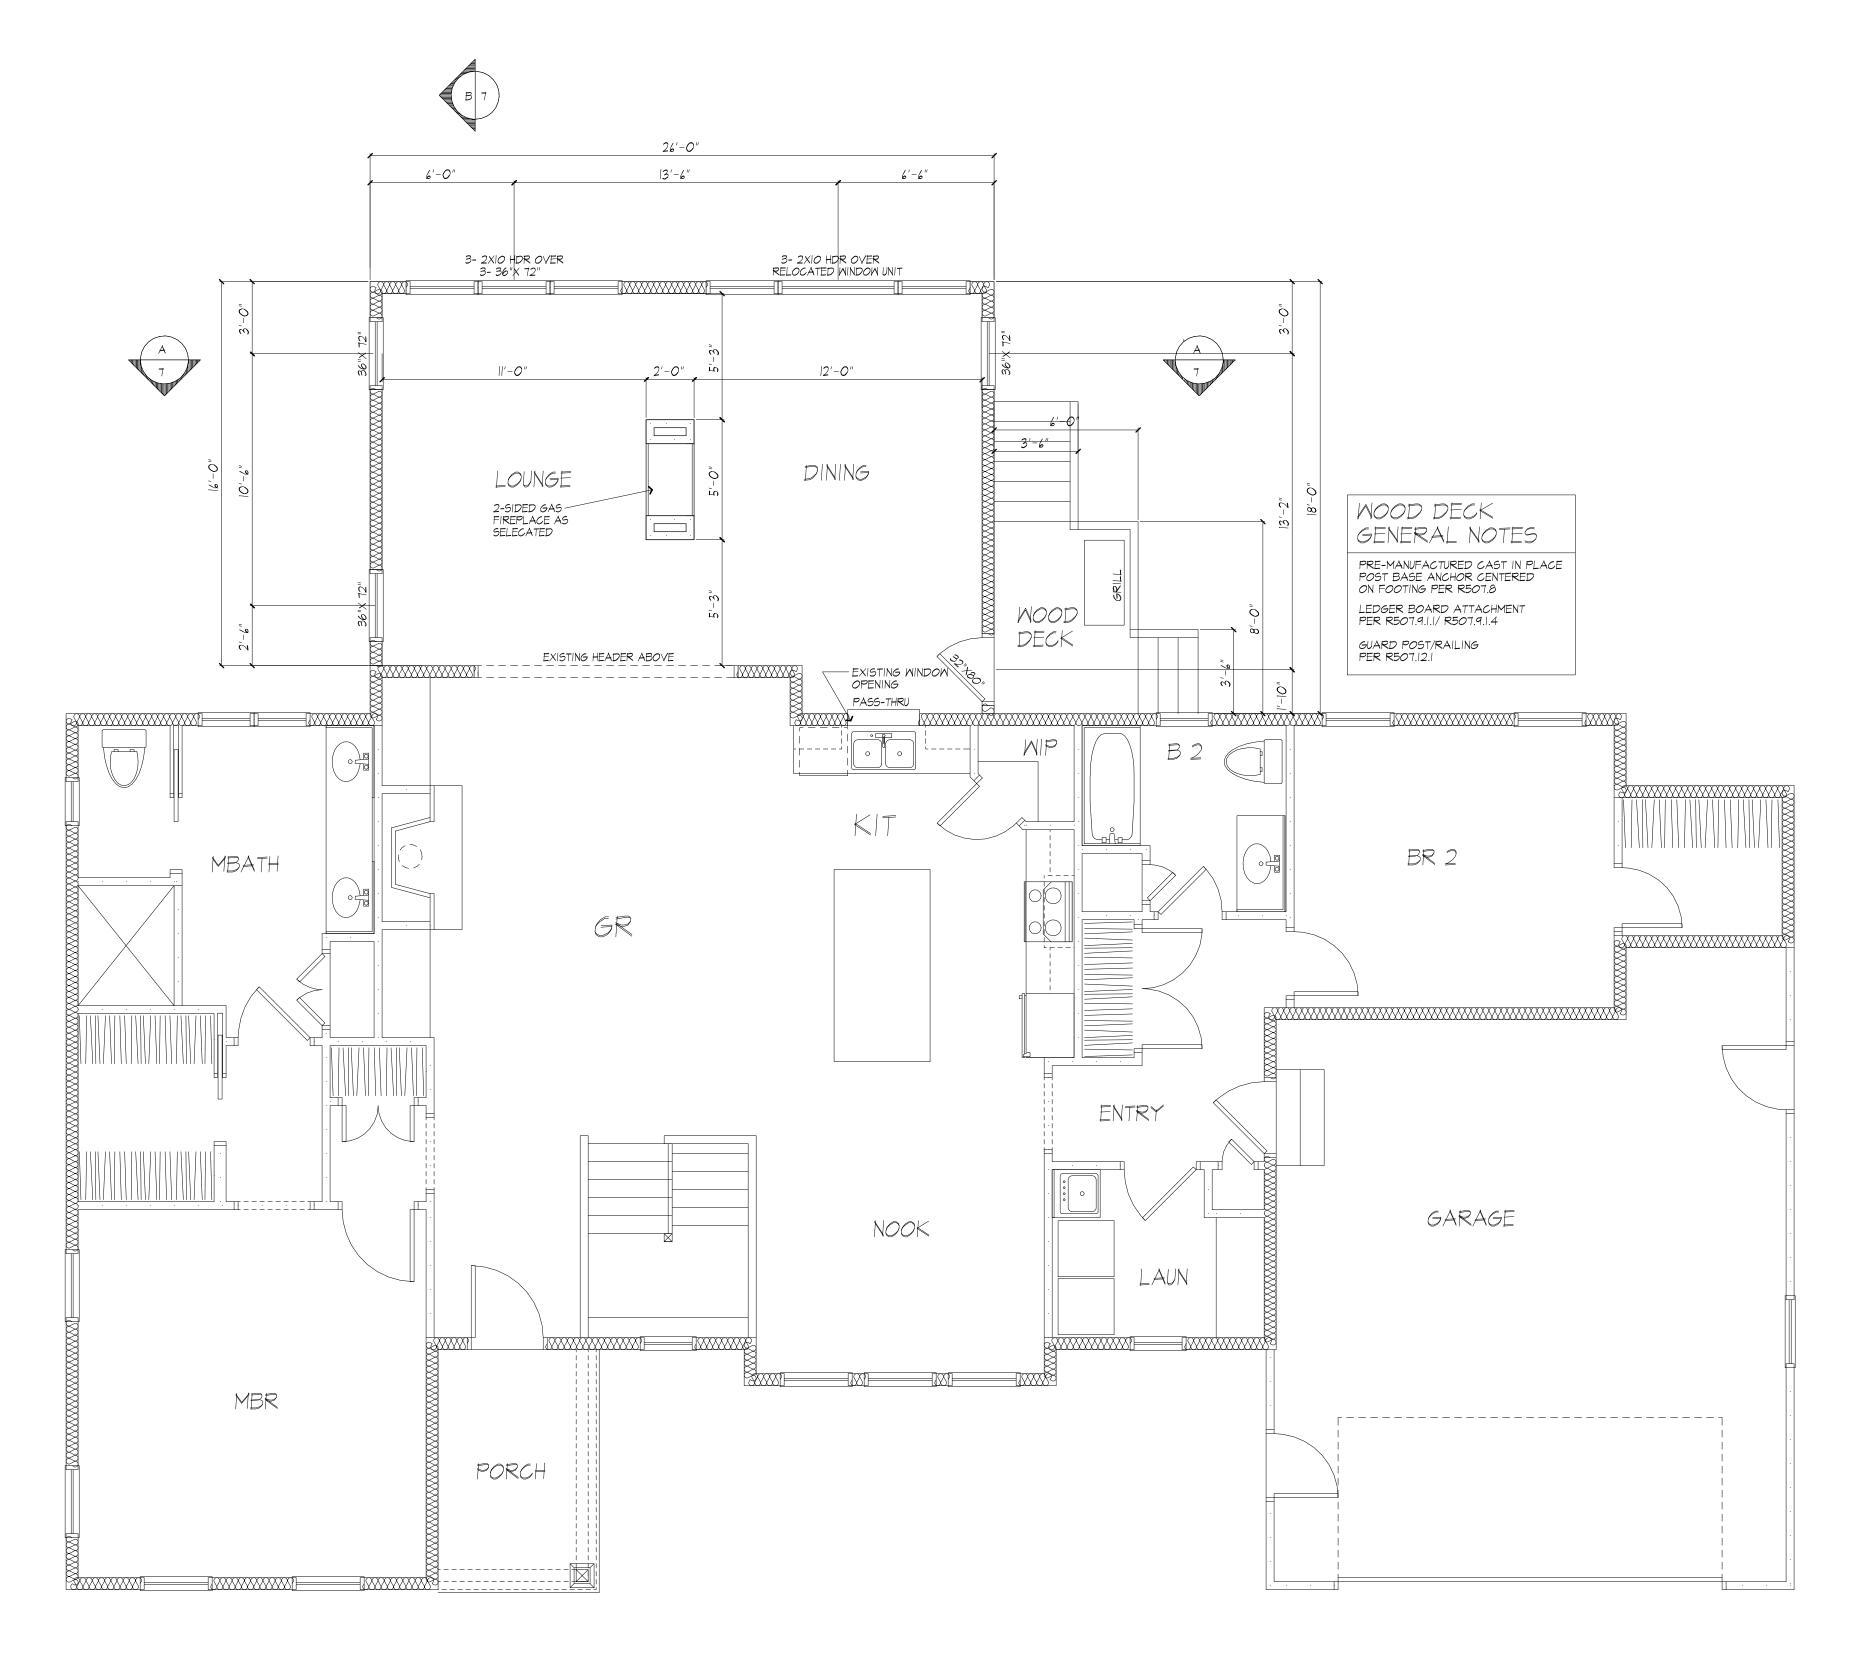

FLOOR PLAN

AREA; 1780 SQ FT EXISTING 432 SQ FT ADDITION

2212 SQ FT PROPOSED TOTAL AREA



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PROJECT: PROPOSED ADDITION 38 JORDAN RD PITTSFORD NY

CLIENT: JUNE SCHIRMER

DRAWING:

FLOOR PLAN - PROPOSED

DRAWN: PAUL MORABITO


DATE: FEBRUARY 2024

SCALE: 1/4"=1'-0"

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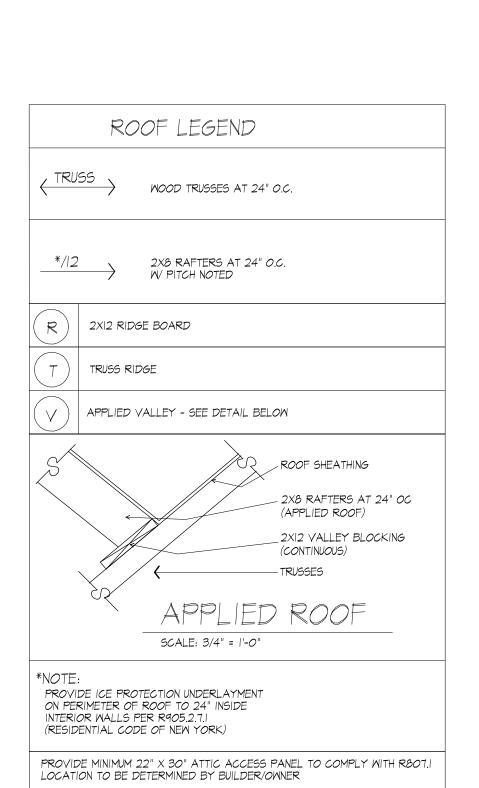
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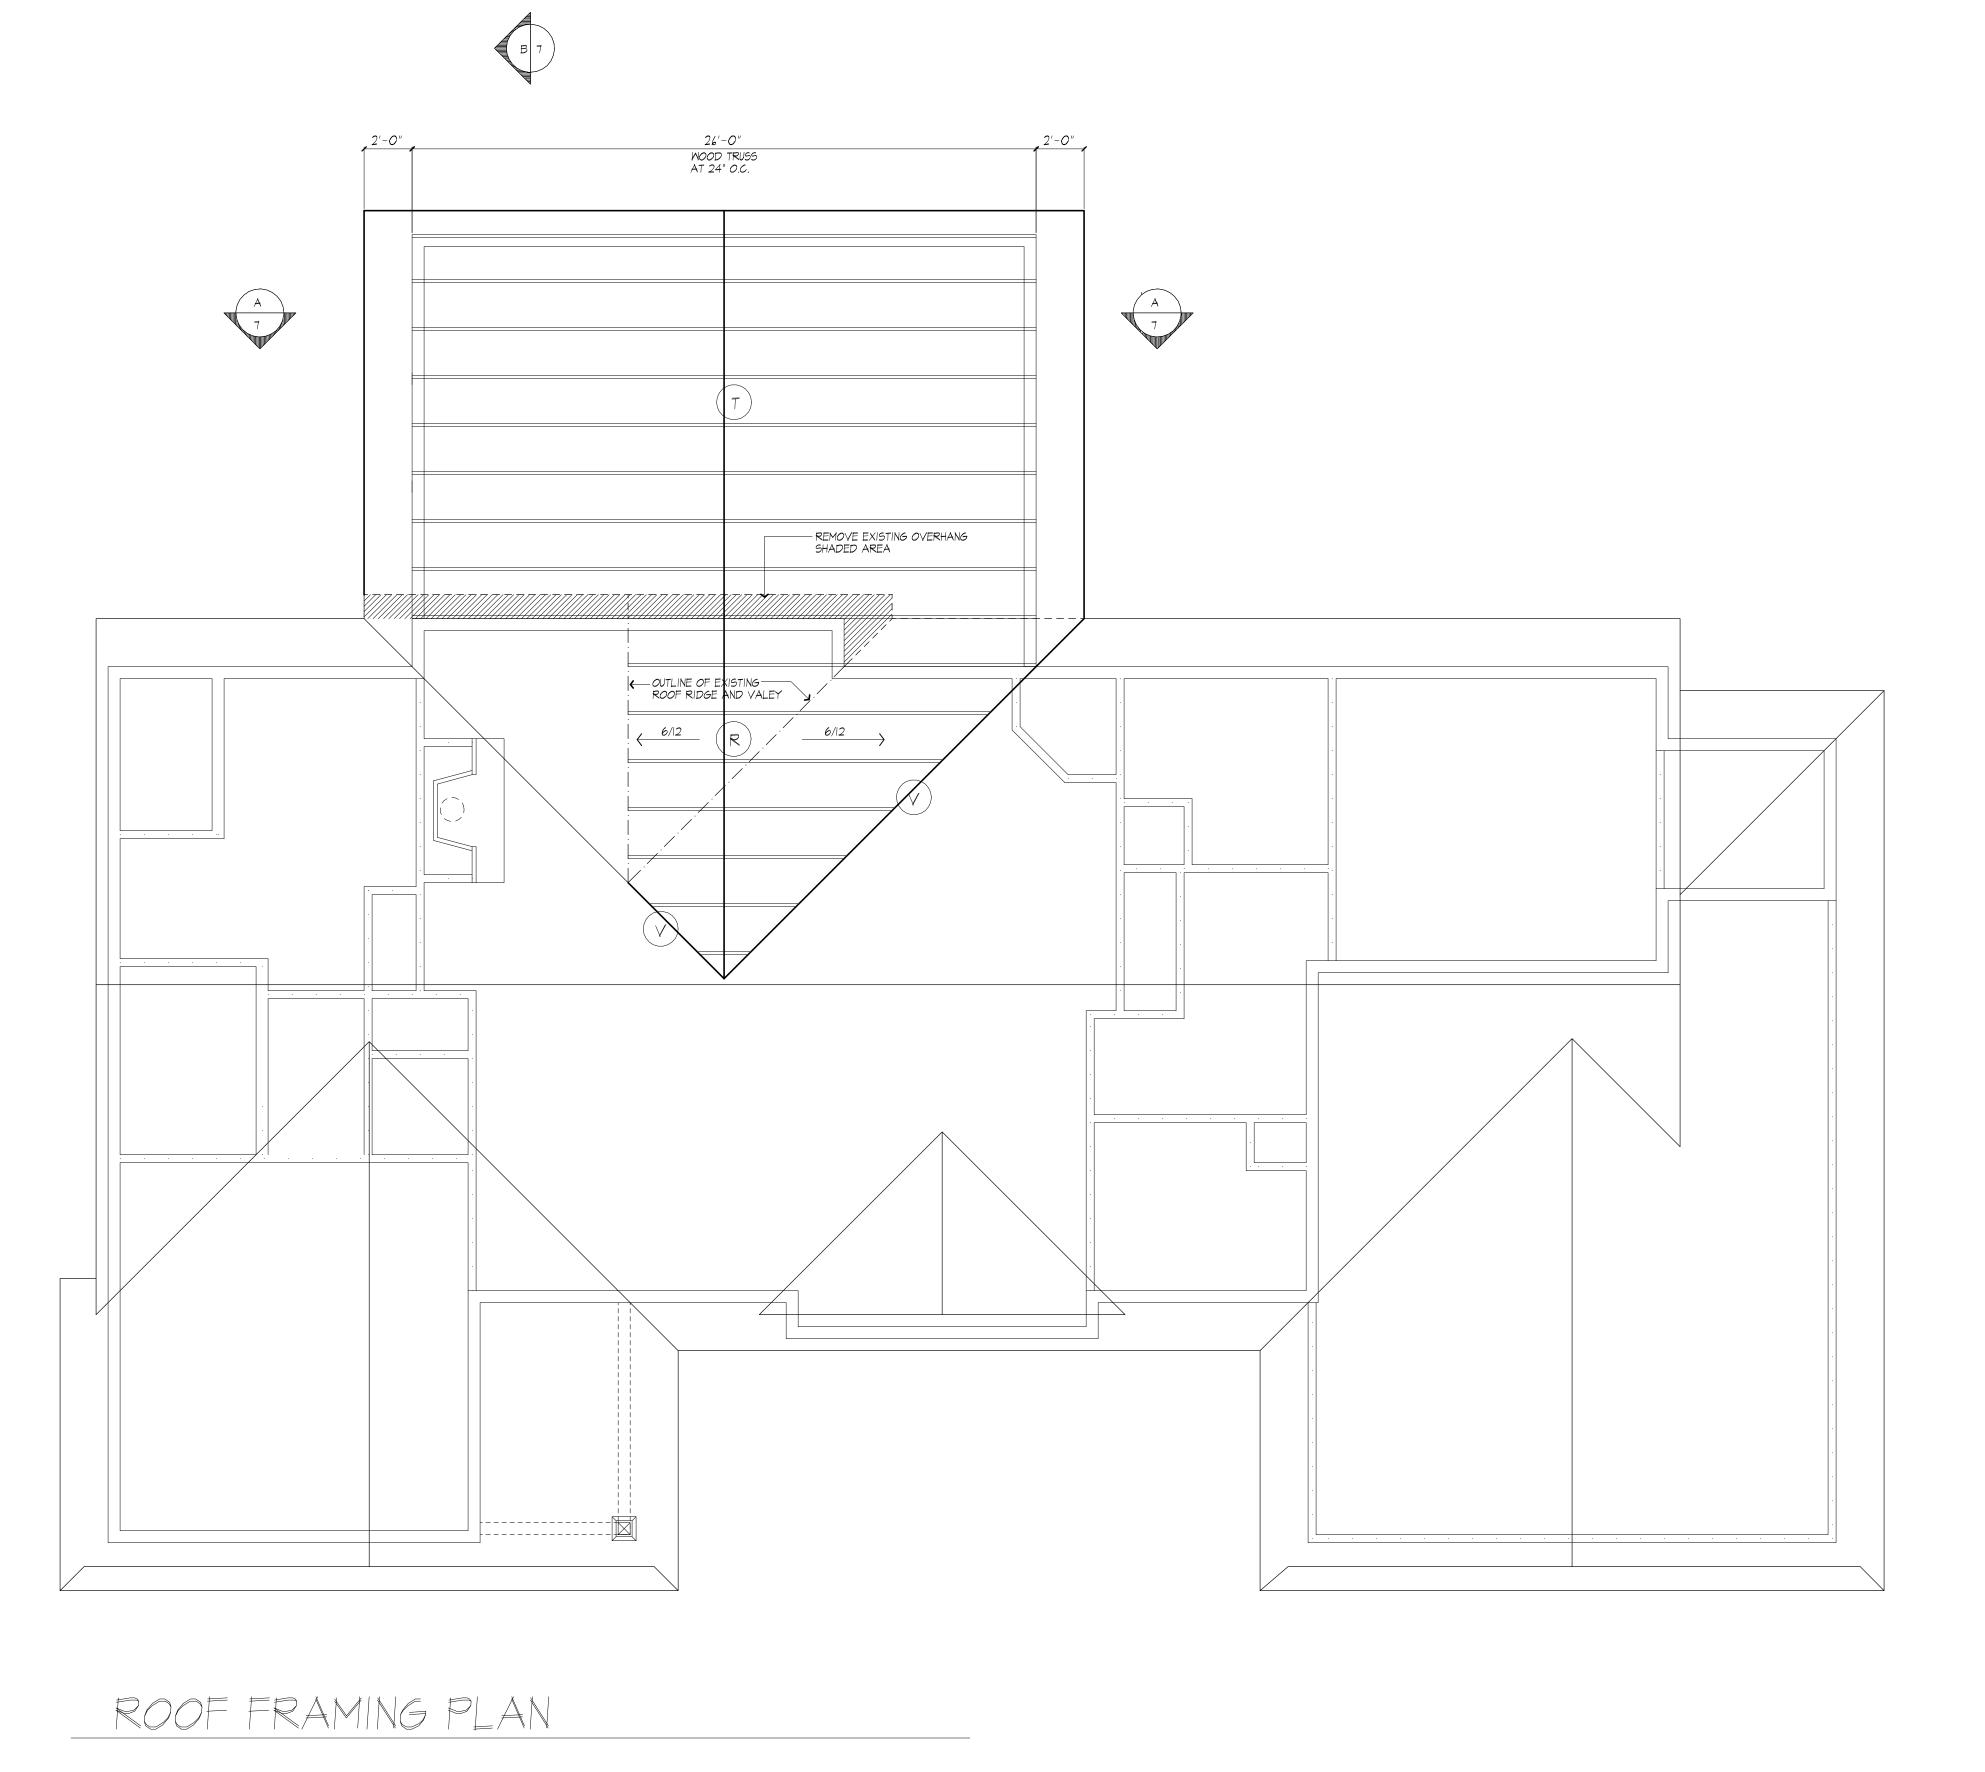




TRUSS DIAGRAM

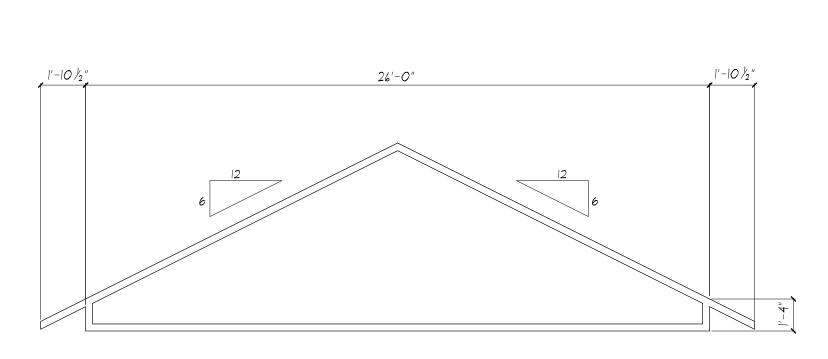FINAL DESIGN BY TRUSS MANUFACTURER, SUBMIT SHOP DRAMINGS TO ARCHITECT FOR APPROVAL PRIOR TO FABRICATION





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PROJECT:

PROPOSED ADDITION 38 JORDAN RD PITTSFORD NY

CLIENT:
JUNE SCHIRMER

DRAWING:

ROOF PLAN - PROPOSED

PAUL MORABITO

DATE: FEBRUARY 2024


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LIGHTING FIXTURE SCHEDULE DINING ROOM MINIMUM (1) 120 WATT FIXTURE ALL OTHER FIRST FLOOR ROOMS (EACH) MINIMUM (1) 120 WATT FIXTURE TYPICAL NOTES I.) DOOR MANUFACTURER: VMD SLIDING 0.10 CFM IN-SWING HINGED 0.15 CFM PELLA ENTRY DOORS: 0.30 CFM OR LESS 2.) WINDOW AIR INFILTRATION DOUBLE HUNG 0.30 CFM CASEMENT, AWNING, FIXED 0.05 CFM 3.) GAS FIREPLACE(S): TIGHT FITTING NON CUMBUSTABLE FIREPLACE DOORS
 TO CONTROL INFILTRATION LOSSES SHALL BE INSTALLED
 ON FIREPLACE OPENINGS- FIREPLACES SHALL BE PROVIDED WITH A SOURCE OF COMBUSTION AIR AS REQUIRED BY THE RESIDENTIAL CODE OF NEW YORK STATE 4.) JOINTS IN DUCT SYSTEM SEALED WITH MASTIC, TAPE OR GASKETING. 5.) CLASS I VAPOR RETARDER ON INTERIOR OF 2X4 FRAMED WALLS: RIGID POLYISOCYANURATE FOAM-FOIL BOARD CLASS II VAPOR RETARDER ON INTERIOR OF CEILINGS AND 2X6 FRAMED WALLS: KRAFT BATTS 6.) MECHANICAL SYSTEM PIPING CAPABLE OF CARRYING FLUIDS ABOVE 105F OR BELOW 55F SHALL BE INSULATED TO A MINIMUM OF R-3. 7.) BUILDING CAVITIES SHALL NOT BE USED FOR SUPPLY DUCTS. 8.) DAMPERS INSTALLED ON ALL OUTDOOR INTAKE AND EXHAUST OPENINGS. 9.) THE AIR HANDLER AND ALL DUCTS SHALL BE LOCATED WITHIN THE CONDITIONED SPACE. IF ANY DUCTWORK IS LOCATED COMPLETELY OUTSIDE OF THE CONDITIONED SPACE THE DUCT TIGHTNESS SHALL BE VERIFIED PER SECTION 403.2.2 OF THE 2018 ENERGY CONSERVATION

IO.) ANY SUPPLY DUCTS IN THE ATTICS SHALL BE INSULATED TO A MINIMUM OF R-8. ALL OTHER DUCTS LOCATED COMPLETELY OUTSIDE OF THE BUILDING THERMAL ENVELOPE SHALL BE INSULATED TO A MINIMUM OF R-6.


II.) THERE ARE NOT TO BE WATER SUPPLY LINES IN THE EXTERIOR WALLS

UTILIZATION OF TRUSS TYPE CONSTRUCTION, PRE-ENGINEERED WOOD CONSTRUCTION AND/OR TIMBER CONSTRUCTION IN RESIDENTIAL STRUCTURES


WHEN TRUSS TYPE CONSTRUCTION, PRE-ENGINEERED WOOD CONSTRUCTION, AND/OR TIMBER CONSTRUCTION IS TO BE UTILIZED IN THE CONSTRUCTION OF A NEW RESIDENTIAL STRUCTURE, OR IN AN ADDITION TO OR REHABILITATION OF AN EXISTING RESIDENTIAL STRUCTURE; THE OWNER OF SUCH STRUCTURE, OR THE OWNERS DULY AUTHORIZED REPRESENTATIVE, SHALL NOTIFY THE AUTHORITY HAVING JURISDICTION OF THAT FACT. SUCH NOTICE SHALL BE IN WRITING AND SHALL BE PROVIDED TO THE AUTHORITY HAVING JURISDICTION PRIOR TO THE ISSUANCE OF THE CERTIFICATE OF OCCUPANCY OR CERTIFICATE OF COMPLETION FOR SUCH PROJECT.

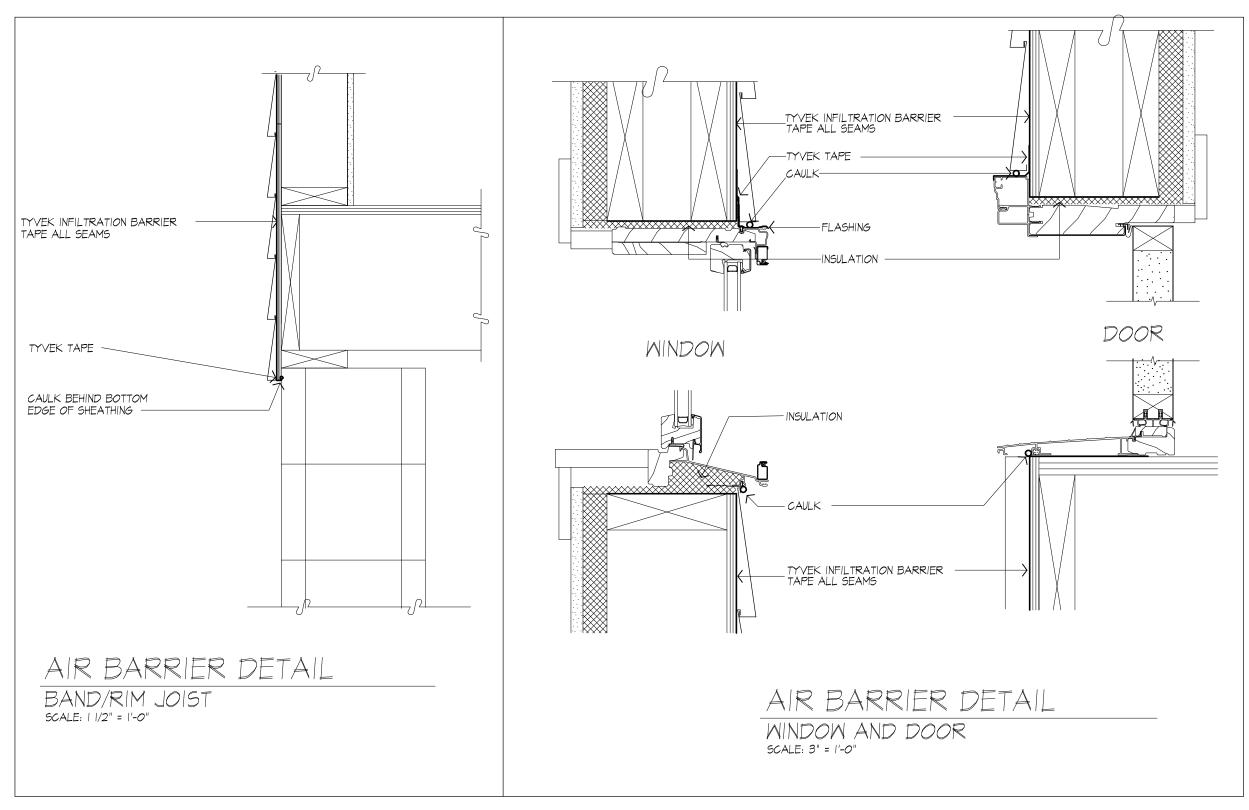
THE SIGN SHALL BE AFFIXED TO THE ELECTRICAL BOX ATTACHED TO THE EXTERIOR OF THE RESIDENTIAL STRUCTURE. IN THE INSTANCE WHERE THE ELECTRICAL SERVICE DOES NOT ALLOW FOR THE SIGN, OR IS NOT PRESENT ON THE EXTERIOR OF THE RESIDENTIAL STRUCTURE, THE SIGN SHALL BE LOCATED IN A PLACE THAT IS LIKELY TO BE SEEN BY FIREFIGHTERS OR OTHER FIRST RESPONDERS. THE LOCATION SHALL BE APPROVED BY THE BUILDING INSPECTOR OR THE FIRE MARSHAL. THE MAINTENANCE OF THIS SIGN, AND THE AREA ADJACENT TO IT, SHALL BE THE RESPONSIBILITY OF THE PROPERTY OWNER. AN EXAMPLE OF THE SIGN CAN BE SEEN BELOW.



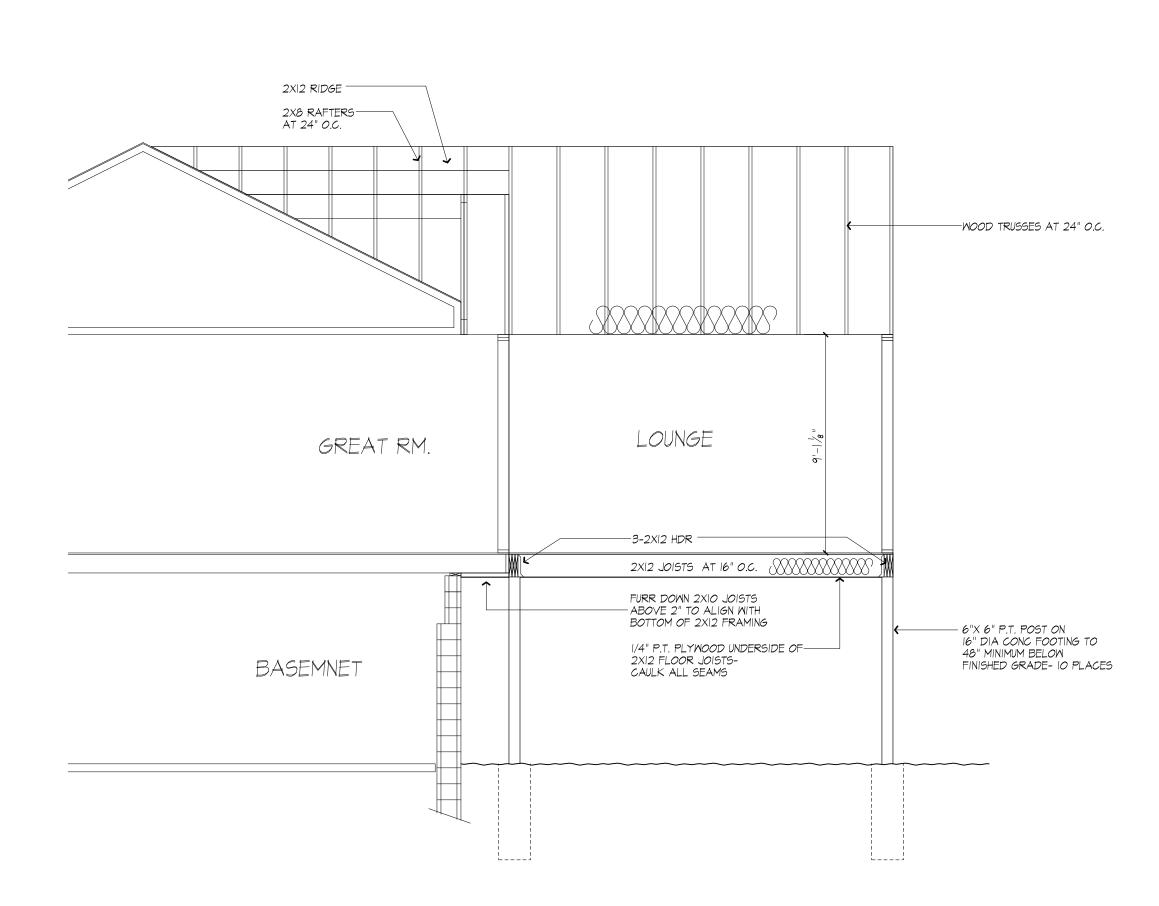



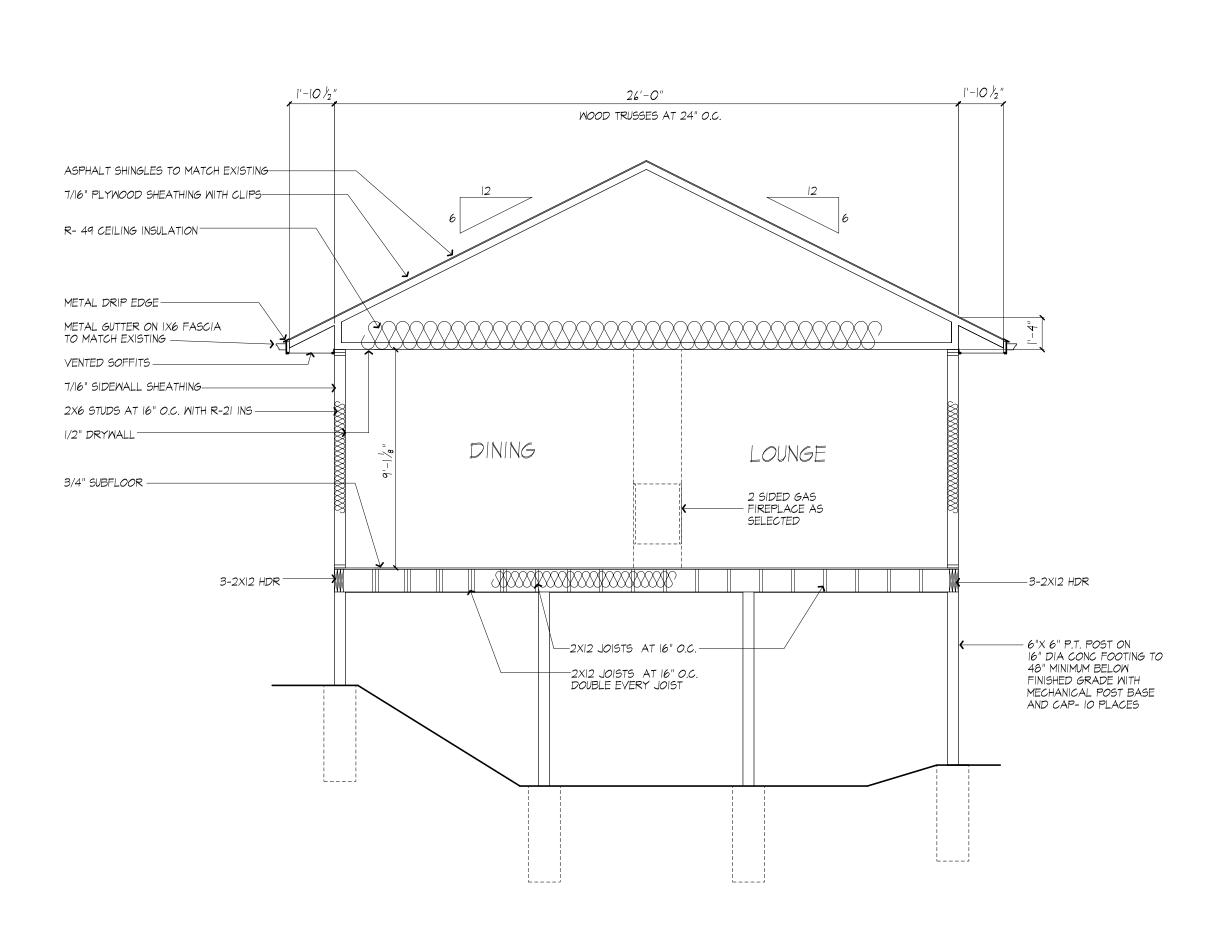

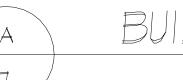

BUILDING SECTION

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PROJECT:

PROPOSED ADDITION
38 JORDAN RD PITTSFORD NY

CLIENT:

JUNE SCHIRMER

DRAWING:
BUILDING SECTIONS

DRAWN:
PAUL MORABITO

DATE: FEBRUARY 2024


SCALE: 1/4"=1'-0"

JOB NO.: 23M4380

SHEET:

7



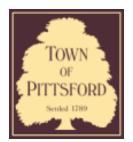

Town of Pittsford

Department of Public Works 11 South Main Street Pittsford, New York 14534

Permit # B24-000023

Phone: 585-248-6250 FAX: 585-248-6262

DESIGN REVIEW AND HISTORIC PRESERVATION BOARD REFERRAL OF APPLICATION

Property Address: 25 Barrington Hills PITTSFORD, NY 14534

Tax ID Number: 177.08-1-11

Zoning District: RN Residential Neighborhood

Owner: Rowden, Reginald Applicant: Rowden, Reginald

An	plic	atio	n Ty	ne:
	\sim	$\alpha \cup \circ$		\sim


.ppca	
Residential Design Review §185-205 (B)	Build to Line Adjustment §185-17 (B) (2)
Commercial Design Review §185-205 (B)	Building Height Above 30 Feet §185-17 (M)
Signage §185-205 (C)	Corner Lot Orientation §185-17 (K) (3)
Certificate of Appropriateness §185-197	Flag Lot Building Line Location §185-17 (L) (1) (c)
Landmark Designation §185-195 (2)	Undeveloped Flag Lot Requirements §185-17 (L) (2)
Informal Review	


Project Description: Applicant is requesting design review for a 252-square-foot addition to the front of the home, as well as new windows and siding to the existing structure.

Meeting Date: February 29, 2024




RN Residential Neighborhood Zoning

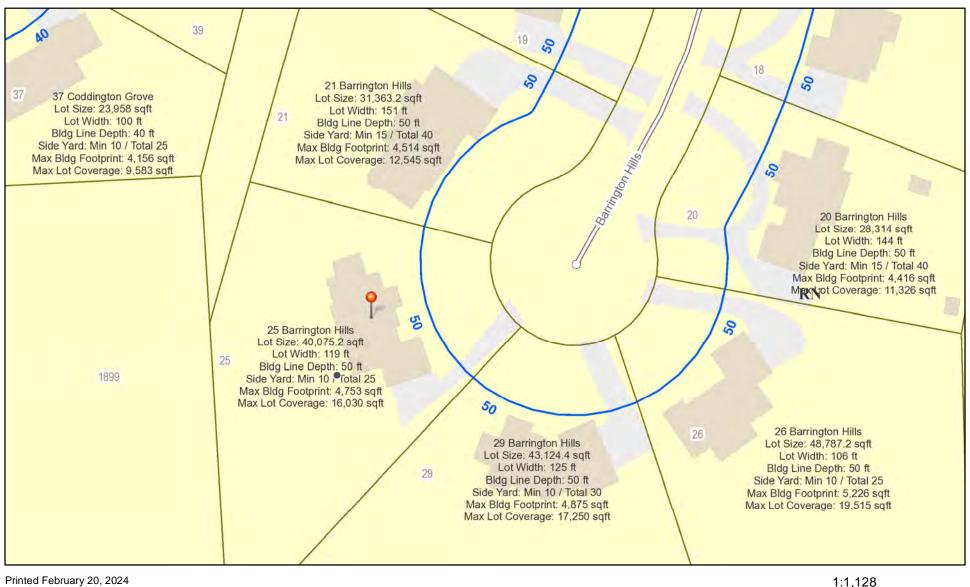

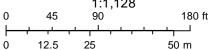


Town of Pittsford GIS



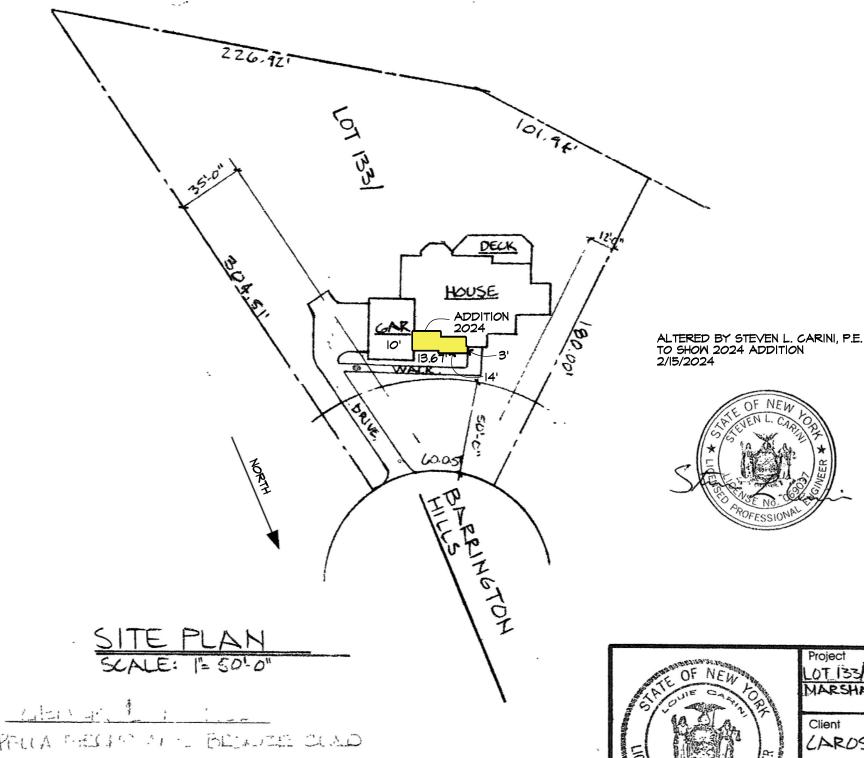

- MAL BUTTLE PELLA FREATS AT L BELLAZE CLAD
- · ALLENGTH SWING CONSTRUCTION 1
- · RESOUT LAWN INC
- · CAPPET NUCLEARY & AS MAK CONTRACT
- · HOOK CLEN THIM
- · ONE PINE WE'VE ACHER DINITY
- · LITHEN SING AUDITANCE AS ME LIAT IT
- · 3 CATY/E MILLIAM OUTLETS ALLOWED
- · PREW 25 CANNY TOR WESTER SIGNAT

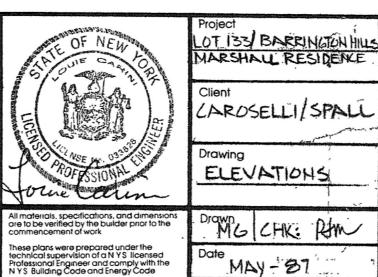

Scale 14 1-0"

Sheet

Unauthorized alterations to these plans is a violation of the New York State Education Law, Section 7209

Patrick J. Morabito, Designer 945 East Henrietta Road Rochester, New York 14623



FRONT ELEVATION

SCALE: 1/4" = 1'-0"



LEFT SIDE ELEVATION

SCALE: 1/4" = 1'-0"



RIGHT SIDE ELEVATION

SCALE: 1/4" = 1'-0"

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These plans comply with the 2020 code.

Revisions: REVISED 6/23/23 - TJM

Ject:

RESIDENTIAL ADDITION / REMODEL

REG & TINA ROMDEN

Job Location:

25 BARRINGTON HILLS PITTSFORD, NEW YORK

Drawing Title:

ELEVATIONS

Drawn Checked

JUNE, 2023

Job No. 38752

of 3

NOTES (GENERAL NOTES TO BE APPLIED AS NEEDED TO THIS REMODELING PROJECT)

- (I.) BUILDING IS CLASSIFIED AS A ONE FAMILY DWELLING. THE 2020 CODE SHALL PREVAIL AND BUILDING CONTRACTOR IS RESPONSIBLE FOR COMPLIANCE REGARDLESS OF ANY MISSING OR
- INCOMPLETE DETAILS OR NOTES ON THE DRAWINGS. THE 2020 ENERGY CONSERVATION CODE SHALL PREVAIL AND BUILDING CONTRACTOR IS RESPONSIBLE FOR COMPLIANCE REGARDLESS OF ANY MISSING OR INCOMPLETE DETAILS OR NOTES
- (4.) BUILDING CONTRACTOR AND HIS SUBCONTRACTORS SHALL CONFORM TO LOCAL CONSTRUCTION ORDINANCES AND SHALL VERIFY ALL DIMENSIONS AND CONDITIONS BEFORE PROCEEDING
- ROOF TRUSS ENGINEERING AND SIZES DETERMINED BY AND ARE THE SOLE RESPONSIBILITY OF THE MANUFACTURER. (MFR)
- (6.) NOTED DIMENSIONS TAKE PRECEDENCE OVER SCALED DIMENSIONS.
- THESE DRAWINGS HAVE BEEN PREPARED FOR DESIGN AND STRUCTURAL REFERENCE ONLY. ELECTRICAL, MECHANICAL, PLUMBING, AND OTHER BUILDING SYSTEMS IF ANY, ARE TO BE PREPARED BY AND ARE THE RESPONSIBILITY OF OTHERS.
- BEARING CAPACITY OF SOIL IS ASSUMED AT 2000 P.S.F. AND CONTRACTOR SHALL VERIFY PRIOR TO PLACEMENT OF FOOTINGS.
- (9.) ALLOWABLE STRESSES OF MATERIALS: (A.S.D. THEORY AND METHODS HAVE BEEN USED IN THE STRUCTURAL DESIGN
- OF THE MASONRY, STEEL AND WOOD FRAMING OF THIS BUILDING.) THE WEATHERING POTENTIAL FOR CONCRETE IS ASSUMED TO BE SEVERE. SEE FIGURE R301.2(4)) A.) CONCRETE (R402.2) - MIN. COMPRESSIVE STRENGTH @ 28 DAYS PSI =
- FOOTINGS: 2500 PSI
 BASEMENT SLAB: 2500 PSI (W/ FIBER REINF. ADDITIVE, OPTIONAL)
 GARAGE & PORCH SLABS: 3500 PSI (AIR-ENTRAINED)
 BASEMENT WALLS: 3000 PSI (AIR-ENTRAINED WHERE EXPOSED TO WEATHER)
- POURED CONC. SHALL BE PROTECTED FROM FREEZE/THAW DURING CONST-RUCTION, OR AIR ENTRAINED CONC. MUST BE USED. (TABLE R402.2, NOTE 2.) B.) STRUCTURAL STEEL TO BE ASTM - A36
- WOOD JOISTS, BEAMS, HEADERS, AND RAFTERS SHALL HAVE AN EXTREME FIBER STRESS IN BENDING (FB) WITH REPETITIVE MEMBER USE OF 1150 P.S.I. (HEM FIR #2 OR BETTER.)
- IO.) FIREPLACES SHALL HAVE AN OUTSIDE AIR SOURCE FOR COMBUSTION WITH A DUCT, DAMPER ETC. \$ SHALL COMPLY WITH CODE SECTION RIOOI-RIO66 AS APPLICABLE.
- SETTING THE BUILDING ELEVATION IS THE RESPONSIBILITY OF THE GENERAL CONTRACTOR AND SHALL COMPLY WITH R403.1.7.3 OF THE CODE.
- (12.) THE CONTRACTOR SHALL INSTALL 4" HIGH NUMBERS ON THE FRONT OF THIS BUILDING TO IDENTIFY THE SITE ADDRESS. (SEE SECTION R319.)

- (13.) GLAZING IN DOORS, STORM DOORS, SIDELIGHTS, SHOWER SPACES, AND TUB ENCLOSURES IS DEEMED TO BE HAZARDOUS PER SECTION R308.4 OF THE 2020 CODE AND SHALL BE IDENTIFIED AS SUCH IN COMPLIANCE WITH SECTION R 308.1. DECORATIVE GLASS IS EXEMPT IN SWINGING DOORS AND SIDELIGHTS (SEE SECTION R308.4 FOR ADDITIONAL HAZARDOUS LOCATIONS).
- (14.) DESIGN CRITERIA:
 - A.) ROOMS OTHER THAN SLEEPING = 40 PSF LIVE LOAD B.) SLEEPING ROOMS = 30 PSF LIVE LOAD C.) GROUND SNOW LOAD = 40 PSF (FIG R301.2(6)) D.) WIND SPEED - 115 MPH ULTIMATE, 89 MPH ASD, EXP. B WIND SPEED CONVERSION PER TABLE R301.2.1.3
 - SEISMIC DESIGN CATEGORY A OR B R301.2(2) WEATHERING - SEVERE FROST LINE DEPTH - 42"
 - TERMITE DAMAGE CONTACT LOCAL JURISDICTION
 - DECAY DAMAGE NONE TO SLIGHT WINTER DESIGN TEMPERATURE (I) DEGREE K.) ICE BARRIER IS REQUIRED
 - ROOF TIE-DOWN REQUIREMENTS R802.II (BASED UPON SPECIFIC ROOF DESIGN)
 M.) ENERGY COMPLIANCE DETAILS AND PATH - NIIOI.IS

NATURAL SOIL, FREE FROM FROST OR LOOSE MATERIAL

- (15.) FOOTINGS TO BEAR ON FIRM, LEVEL, UNDISTURBED
- (16.) DRAWING ALTERATION: THE FOLLOWING IS AN EXCERPT FROM THE N.Y.S. EDUCATION LAW ARTICLE 145. SECTION 7209 AND APPLIES TO THESE "IT IS A VIOLATION OF THIS LAW FOR ANY PERSON, UNLESS HE/SHE IS ACTING UNDER THE DIRECT SUPERVISION OF A LICENSED PROFESSIONAL ENGINEER OR ARCHITECT TO ALTER AN ITEM IN ANY WAY. IF AN ITEM BEARING THE SEAL OF AN ENGINEER OR ARCHITECT IS ALTERED, THE ALTERING ENGINEER OR ARCHITECT SHALL AFFIX TO THE ITEM HIS/HER SEAL AND THE NOTATION "ALTERED BY" FOLLOWED BY HIS/HER SIGNATURE AND THE DATE OF SUCH ALTERATION AND A SPECIFIC DESCRIPTION
- (17.) WHERE LOCAL EXHAUST OR WHOLE-HOUSE MECHANICAL VENTILATION IS PROVIDED, THE EQUIPMENT SHALL BE DESIGNED IN ACCORDANCE WITH SECTION MISOT OF THE

CODE" SHALL MEAN CHAPTER II OF THE CODE.

- (18.) "CODE" SHALL MEAN THE 2020 RESIDENTIAL CODE OF NEW YORK STATE. "ENERGY CONSERVATION CODE" OR "ENERGY
- (19.) TO THE BEST OF MY KNOWLEDGE, BELIEF AND PROFESSIONAL JUDGEMENT, THESE PLANS ARE IN COMPLIANCE WITH THE ENERGY CONSERVATION CODE.

ENERGY CONSERVATION, CHAPTER II, ENERGY EFFICIENCY

- A MINIMUM OF 90 PERCENT OF THE LAMPS IN PERMANENTLY INSTALLED LIGHTING FIXTURES SHALL BE HIGH-EFFICACY LAMPS PER
- RECESSED LUMINARIES INSTALLED IN THE BUILDING THERMAL ENVELOPE SHALL BE SEALED WITH A GASKET OR CAULK BETWEEN THE HOUSING AND THE INTERIOR WALL OR CEILING COVERING TO LIMIT AIR LEAKAGE BETWEEN CONDITIONED AND UNCONDITIONED SPACES PER
- CONTRACTOR TO PROVIDE A PROGRAMMABLE THERMOSTAT TO CONTROL THE HVAC SYSTEM PER SECTION NIIO3.1.1
- 4. ALL DUCTS, AIR HANDLERS, FILTER BOXES SHALL BE SEALED PER
- 5. ALL CIRCULATING SERVICE HOT WATER PIPING SHALL BE INSULATED TO AT LEAST R-3. CIRCULATING HOT WATER SYSTEMS SHALL INCLUDE AN AUTOMATIC OR READILY ACCESSIBLE MANUAL SMITCH THAT CAN TURN OFF THE HOT WATER CIRCULATING PUMP WHEN THE SYSTEM IS NOT IN USE. PER SECTION NIIO3.5
- ATTIC ACCESS SHALL BE INSULATED WITH THE SAME R-VALUE AS THE ATTIC, WEATHER-STRIPPED AND LATCHED PER SECTION NIIO2.2.4
- AIR TIGHTNESS AND INSULATION INSTALLATION SHALL BE PER MANUFACTURERS INSTRUCTIONS AND CRITERIA LISTED IN SECTIONS NIIO2.4.1 THROUGH NIIO2.4.6.
- THE STRUCTURE SHALL BE TESTED AND VERIFIED AS HAVING AN AIR LEAKAGE RATE NOT EXCEEDING 3 AIR CHANGES PER HOUR. CONDUCT FEST ACCORDING TO ASTM E779 OR ASTM E1827 OR NET/ICC 380 AND REPORTED AT A PRESSURE OF 0.2 INCH W.G. COMPLY WITH NIIO2.4.1.2.
- THE CONTRACTORS AND SUB-CONTRACTORS SHALL BE FAMILIAR WITH THE ENERGY CODE AND EXPERIENCED IN PERFORMING WORK THAT COMPLIES WITH ALL ASPECTS OF THE ENERGY CODE. THESE NOTES ARE NOT INTENDED TO BE ALL INCLUSIVE.

a. In addition, inspection of log walls shall be in accordance with the provisions of ICC 400.

ADDITION

25 BARRINGTON HILLS, PITTSFORD, NEW YORK

REG & TINA ROWDEN, HOMEOWNERS


ENERGY CODE COMPLIANCE PATH: SEE ATTACHED RES CHECK COMPLIANCE CERTIFICATE

GENERAL NOTES

- CONTRACTOR SHALL COMPLY WITH ALL STATE AND LOCAL CODES WHICH PERTAIN TO THE CONSTRUCTION OF THIS STRUCTURE
- CONTRACTOR SHALL VERIFY EXISTING STRUCTURAL O CONDITIONS AND DIMENSIONS PRIOR TO DEMOLITION
- AND / OR CONSTRUCTION CONTRACTOR SHALL PROVIDE ANY NECESSARY BRACING, TEMPORARY FRAMING SUPPORTS (SHORING), AND UNDER-
- PINNING OF EXISTING STRUCTURE AS REQUIRED
- OF NEW AND / OR USE OF RELOCATED DOORS, AND WINDOWS WITH HOMEOWNER
- CONTRACTOR SHALL (WHERE POSSIBLE) MATCH PLATE

 HEIGHTS, SUBFLOORS, AND WINDOW ROUGH OPENING
- HEIGHTS TO MAINTAIN CONTINUITY WHERE POSSIBLE - MATCH CONCRETE BLOCK COURSES
- AT NEW AND EXISTING FOUNDATION WALLS
- MINIMUM GRADE COVER AT ALL CONCRETE FOOTINGS SHALL BE 3'-6"
- INFILL EXISTING EXPOSED EXTERIOR FRAMING CAVITIES FULL WITH INSULATION
- CONTRACTOR NOTE: IF EXISTING CONDITIONS DIFFER FROM PLANS CONTRACTOR IS TO CONTACT CARINI ENGINEERING DESIGNS, P.C.
- PLAN REFRENCE:
- PATRICK J MORABITO DESIGNER PLAN # R-462, DATE: MAY-87

SYMBOLS

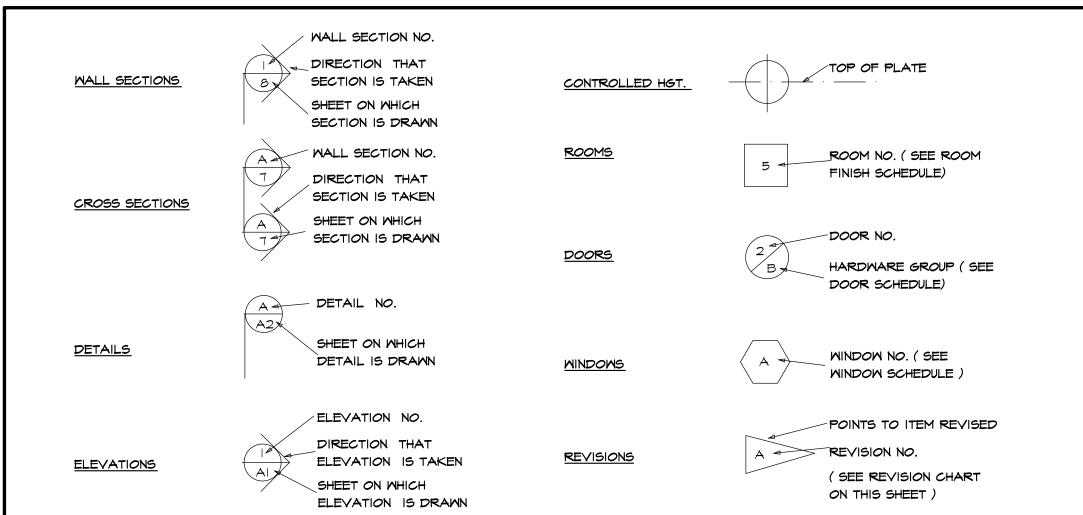

ABBREVIATIONS

APPROX	-APPROXIMATE	F ⊤ (')	-F <i>OO</i> T	OPNG	-OPENING
&	-AND	FTG	-FOOTING	O/A	-OVERALL
@	-AT	FDN	-FOUNDATION	O.H.D	-OVERHEAD DOOR
BM	-BEAM	GYP	-GYPSUM	O/ HANG	-OVERHANG
BLK	-BLOCK	HND'CP	-HANDICAP	0/	-OVER
BD	-BOARD	HGT	-HEIGHT	OPT	-OPTIONAL
BLDG	-BUILDING	HM	-HOT WATER	P.D.R	-PONDER ROOM
BTR	-BETTER	HDR	-HEADER	PSF	-POUNDS PER SQ. FT
CLG	-CEILING	IN (")	-INCH	PSI	-POUNDS PER SQ. IN.
CL	-CENTERLINE	INCL	-INCLUDE	P.T.	-PRESSURE TREATED
COL	-COLUMN	INFO	-INFORMATION	PLY'WD	-PLYWOOD
CONC	-CONCRETE	ID	-INSIDE DIAMETER	REQ'D	-REQUIRED
CONT	-CONTINUOUS	INSUL	-INSULATION	RM	-R00M
COMM	-COMMERCIAL	INT	-INTERIOR	RES	-RESIDENTIAL
CRS	-COURSES	IECC	-INTERNATIONAL ENERGY	R'S	-RISERS
DL	-DEAD LOAD		CONSERVATION CODE	RD & SH	-ROD & SHELF
DIA	-DIAMETER	JT	-JOINT	S	-SOUTH
DBL	-DOUBLE	JSTS	-JOISTS	SKY'LT	-SKYLIGHT
DN	-DOWN	LT	-LIGHT	SH	-SHELF
DMG	-DRAWING	LL	-LIVE LOAD	SH'S	-SHELVES
DIM	-DIMENSION	MFR	-MANUFACTURER	STOR	-STORAGE
ELEC	-ELECTRIC	MAX	-MAXIMUM	STL	-STEEL
EXP	-EXPANSION	MECH	-MECHANICAL	SUSP	-SUSPENDED
EXT	-EXTERIOR	MTL	-METAL	SYN	-SYNTHETIC
FT (')	-FEET	MIN	-MINIMUM	T'S	-TREADS
FIN	-FINISH	MISC	-MISCELLANEOUS	(TYP)	-TYPICAL
FLR	-FLOOR	N	-NORTH	T\$6	-TONGUE & GROOVE
IST	-FIRST	NTS	-NOT TO SCALE	W/	-WITH
FLUOR	-FLUORESCENT	NO	-NUMBER	W/O	
1 2001	LOCKLOCENT			700	-MITHOUT

TABLE N1102.4.1.1 (402.4.1.1) AIR BARRIER AND INSULATION INSTALLATION INSULATION INSTALLATION CRITERIA AIR BARRIER CRITERIA COMPONENT continuous air barrier shall be installed in the building r-permeable insulation shall not be used as a sealing Seneral requirements The exterior thermal envelope contains a continuous air Breaks or joints in the air barrier shall be sealed. The air barrier in any dropped ceiling/soffit shall be aligned with the insulation and any gaps in the air barrier he insulation in any dropped ceiling/soffit shall be Ceiling/attic ligned with the air barrier. Access openings, drop down stairs or knee wall doors to conditioned attic spaces shall be sealed. avities within corners and headers of frame walls hall be insulated by completely filling the cavity with The junction of the foundation and sill plate shall be sealed. a material having a thermal resistance of R-3 per inch The junction of the top plate and the top of exterior walls shall be sealed. Exterior thermal envelope insulation for framed walls Knee walls shall be seale ignment with the air barrier. The space between window/door jambs and framing, and Vindows, skylights and doors kylights and framing shall be sealed. Rim joists shall include the air barrier. Rim joists shall be insulated. Floor framing cavity insulation shall be installed to naintain permanent contact with the underside of ubfloor decking, or floor framing cavity insulation Floors (including above garage The air barrier shall be installed at any exposed edge shall be permitted to be in contact with the top side o heathing, or continuous insulation installed on the underside of floor framing; and extends from the bottom to the top of all perimeter floor framing rposed earth in unvented crawl spaces shall be covered Where provided instead of floor insulation, insulation rawl space walls ith a Class I vapor retarder with overlapping joints taped. shall be permanently attached to the crawl space wall Duct shafts, utility penetrations, and flue shafts opening to Shafts, penetrations exterior or unconditioned space shall be sealed. Batts in narrow cavities shall be cut to fit, or narrow Narrow cavities cavities shall be filled by insulation that on installation eadily conforms to the available cavity space. Air sealing shall be provided between the garage and Garage separation Recessed light fixtures installed in the building thermal Recessed light fixtures installed in the building Recessed lighting velope shall be sealed to the drywall. ermal envelope shall be air tight and IC rated. Batt insulation shall be cut neatly to fit around wiring and plumbing in exterior walls, or insulation that on Plumbing and wiring installation readily conforms to available space shall extend behind piping and wiring. The air barrier installed at exterior walls adjacent to Exterior walls adjacent to showers and tubs shall be nower/tub on exterior wall showers and tubs shall separate them from the showers and lectrical/phone box on exterior The air barrier shall be installed behind electrical or communication boxes or air-sealed boxes shall be installed HVAC register boots that penetrate building thermal HVAC register boots welope shall be sealed to the subfloor or drywall When required to be sealed, concealed fire sprinklers shall only be sealed in a manner that is recommended by Concealed sprinklers the manufacturer, Caulking or other adhesive sealants shall not be used to fill voids between fire sprinkler cover plates and

1387 FAIRPORT ROAD FAIRPORT, NY 14450-2002 PH. (585) 223-6420



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DESIGNS, P.C.

STEVEN L. CARINI, P.E.

Also doing business as

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ISSUED FOR TOWN REVIEW 02/15/24

Project:

RESIDENTIAL ADDITION / REMODEL

REG & TINA ROWDEN

Job Location 25 BARRINGTON HILLS

COVER SHEET & NOTES


FEBRUARY, 2024

38752

PITTSFORD, NEW YORK






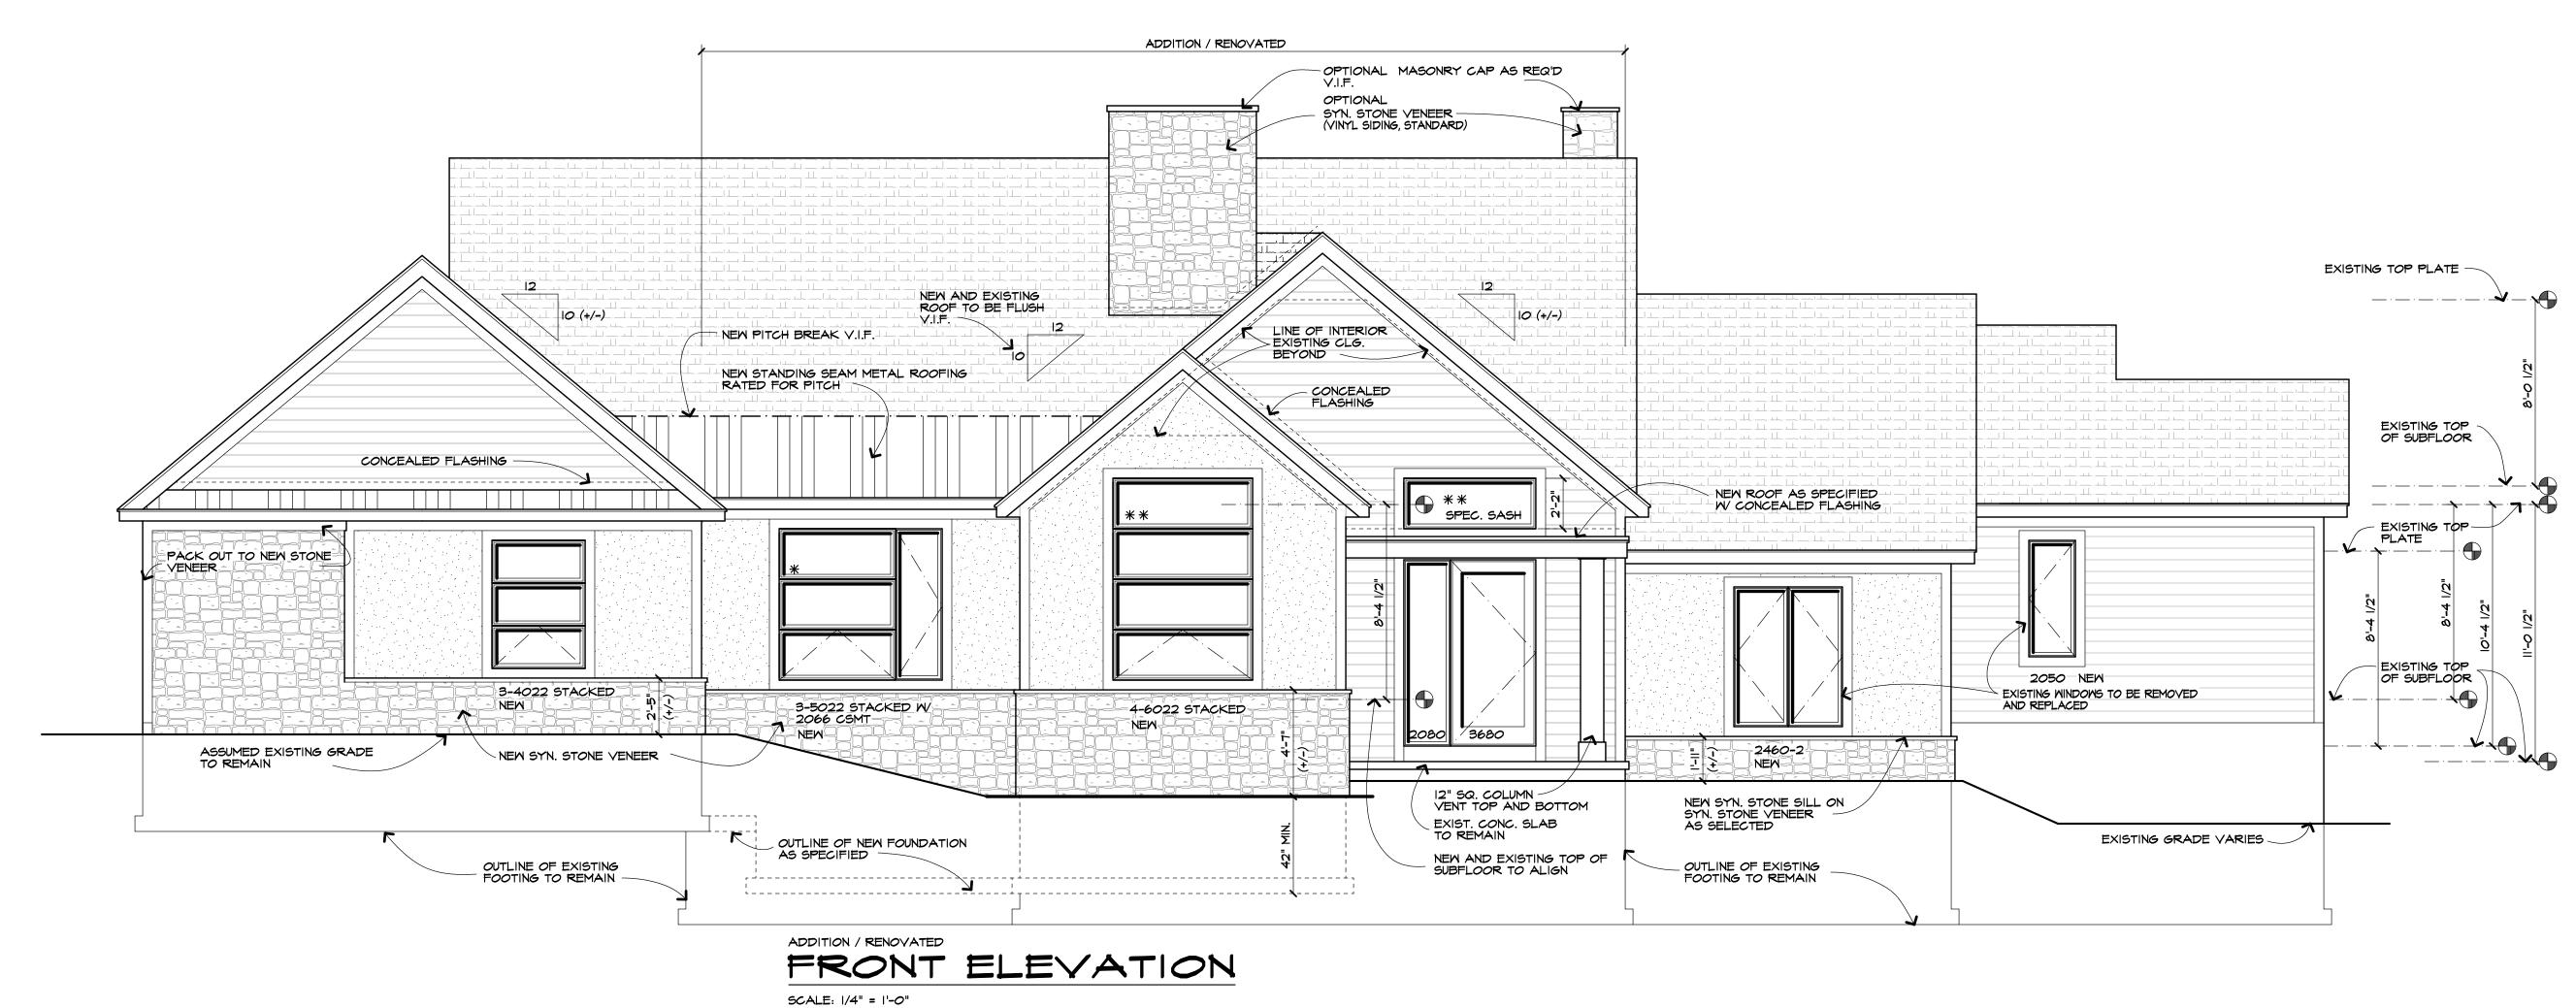

/*) DENOTES WINDOW ROUGH OPENING HEIGHT AT 7'-4 I/4" ABOVE SUBFLOOR (**) DENOTES WINDOW ROUGH OPENING HEIGHT AT 9'-6 1/4" ABOVE SUBFLOOR

UNLESS OTHERWISE NOTED ROOFING: ASPHALT / FIBERGLASS SHINGLES AS SEL'TD ROOF VENTING: ONE SQ.FT NET PER 300 SQ. FT. ATTIC SPACE (PER EXCEPTION IN R806.2 OF THE CODE.) FACIA: ALUM WRAP 2X6 FRIEZEBOARDS: CORNERBOARDS: CASINGS: SIDING: VINYL AS SEL'TD & "STUCCO / DRYVIT" AS SELECTED INSTALL PER MFR SPEC'S MATCH COLOR AND TEXTURE OF EXISTING STUCCO EAVE O/HANGS: RAKE O/HANGS: 1'**-**0" FOOTING DEPTH: 3'-6" BELOW GRADE PLATE HEIGHT: FIRST FLOOR: 8'-4 I/2" (+/-) VARIES SECOND FLOOR: 8'-0 1/2" (+/-) VARIES WINDOW R.O. HEIGHT: FIRST FLOOR: 6'-10 1/2" SECOND FLOOR: 6'-10 1/2" "MARVIN" MODERN **WINDOW MFR:** LOWE INSTALL SYNTHETIC STONE VENEER IN ACCORDANCE WITH MANUFACTURER'S SPECIFICATIONS AND PRODUCT LITERATURE.

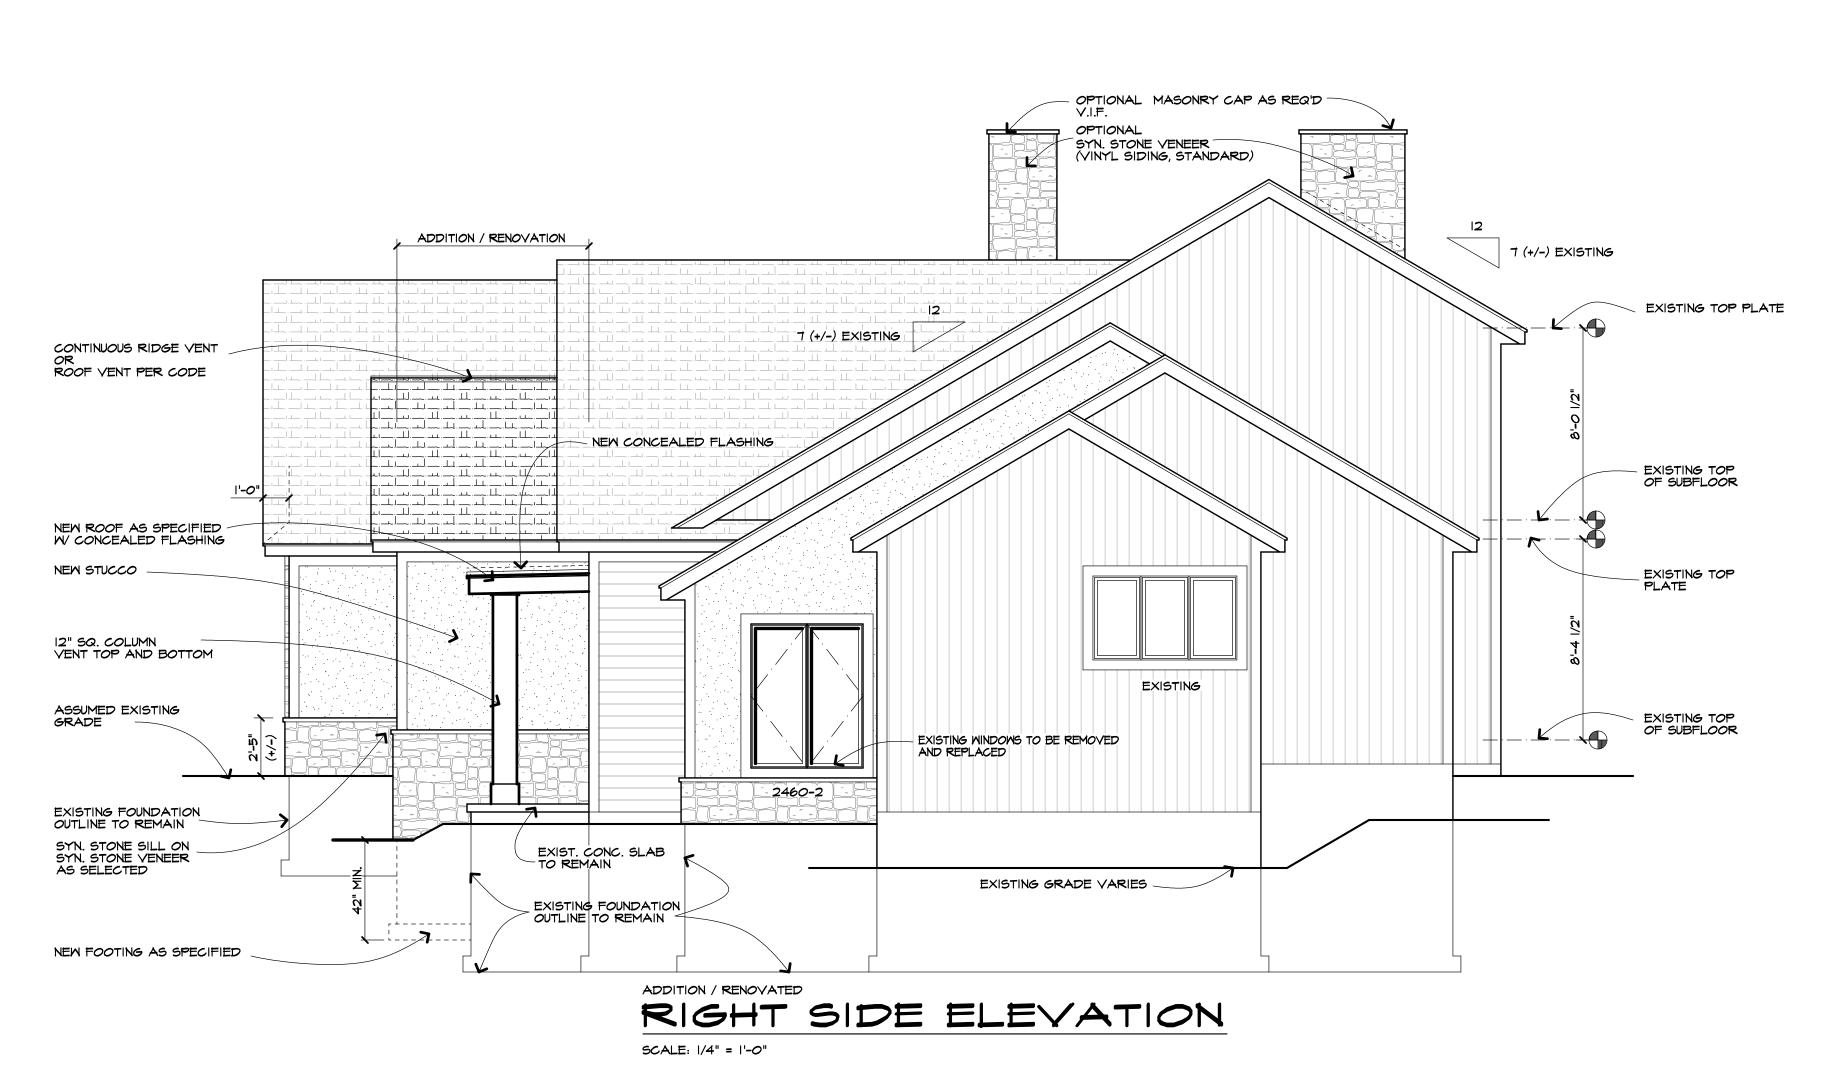

DESIGNS, P.C.

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ISSUED FOR TOWN REVIEW 02/15/24

Project:

RESIDENTIAL ADDITION / REMODEL

REG & TINA ROWDEN

Job Location: 25 BARRINGTON HILLS

PITTSFORD, NEW YORK

Drawing Title:


ELEVATIONS

Checked By

FEBRUARY, 2024

Of

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Revisions:
ISSUED FOR TOWN REVIEW
02/15/24

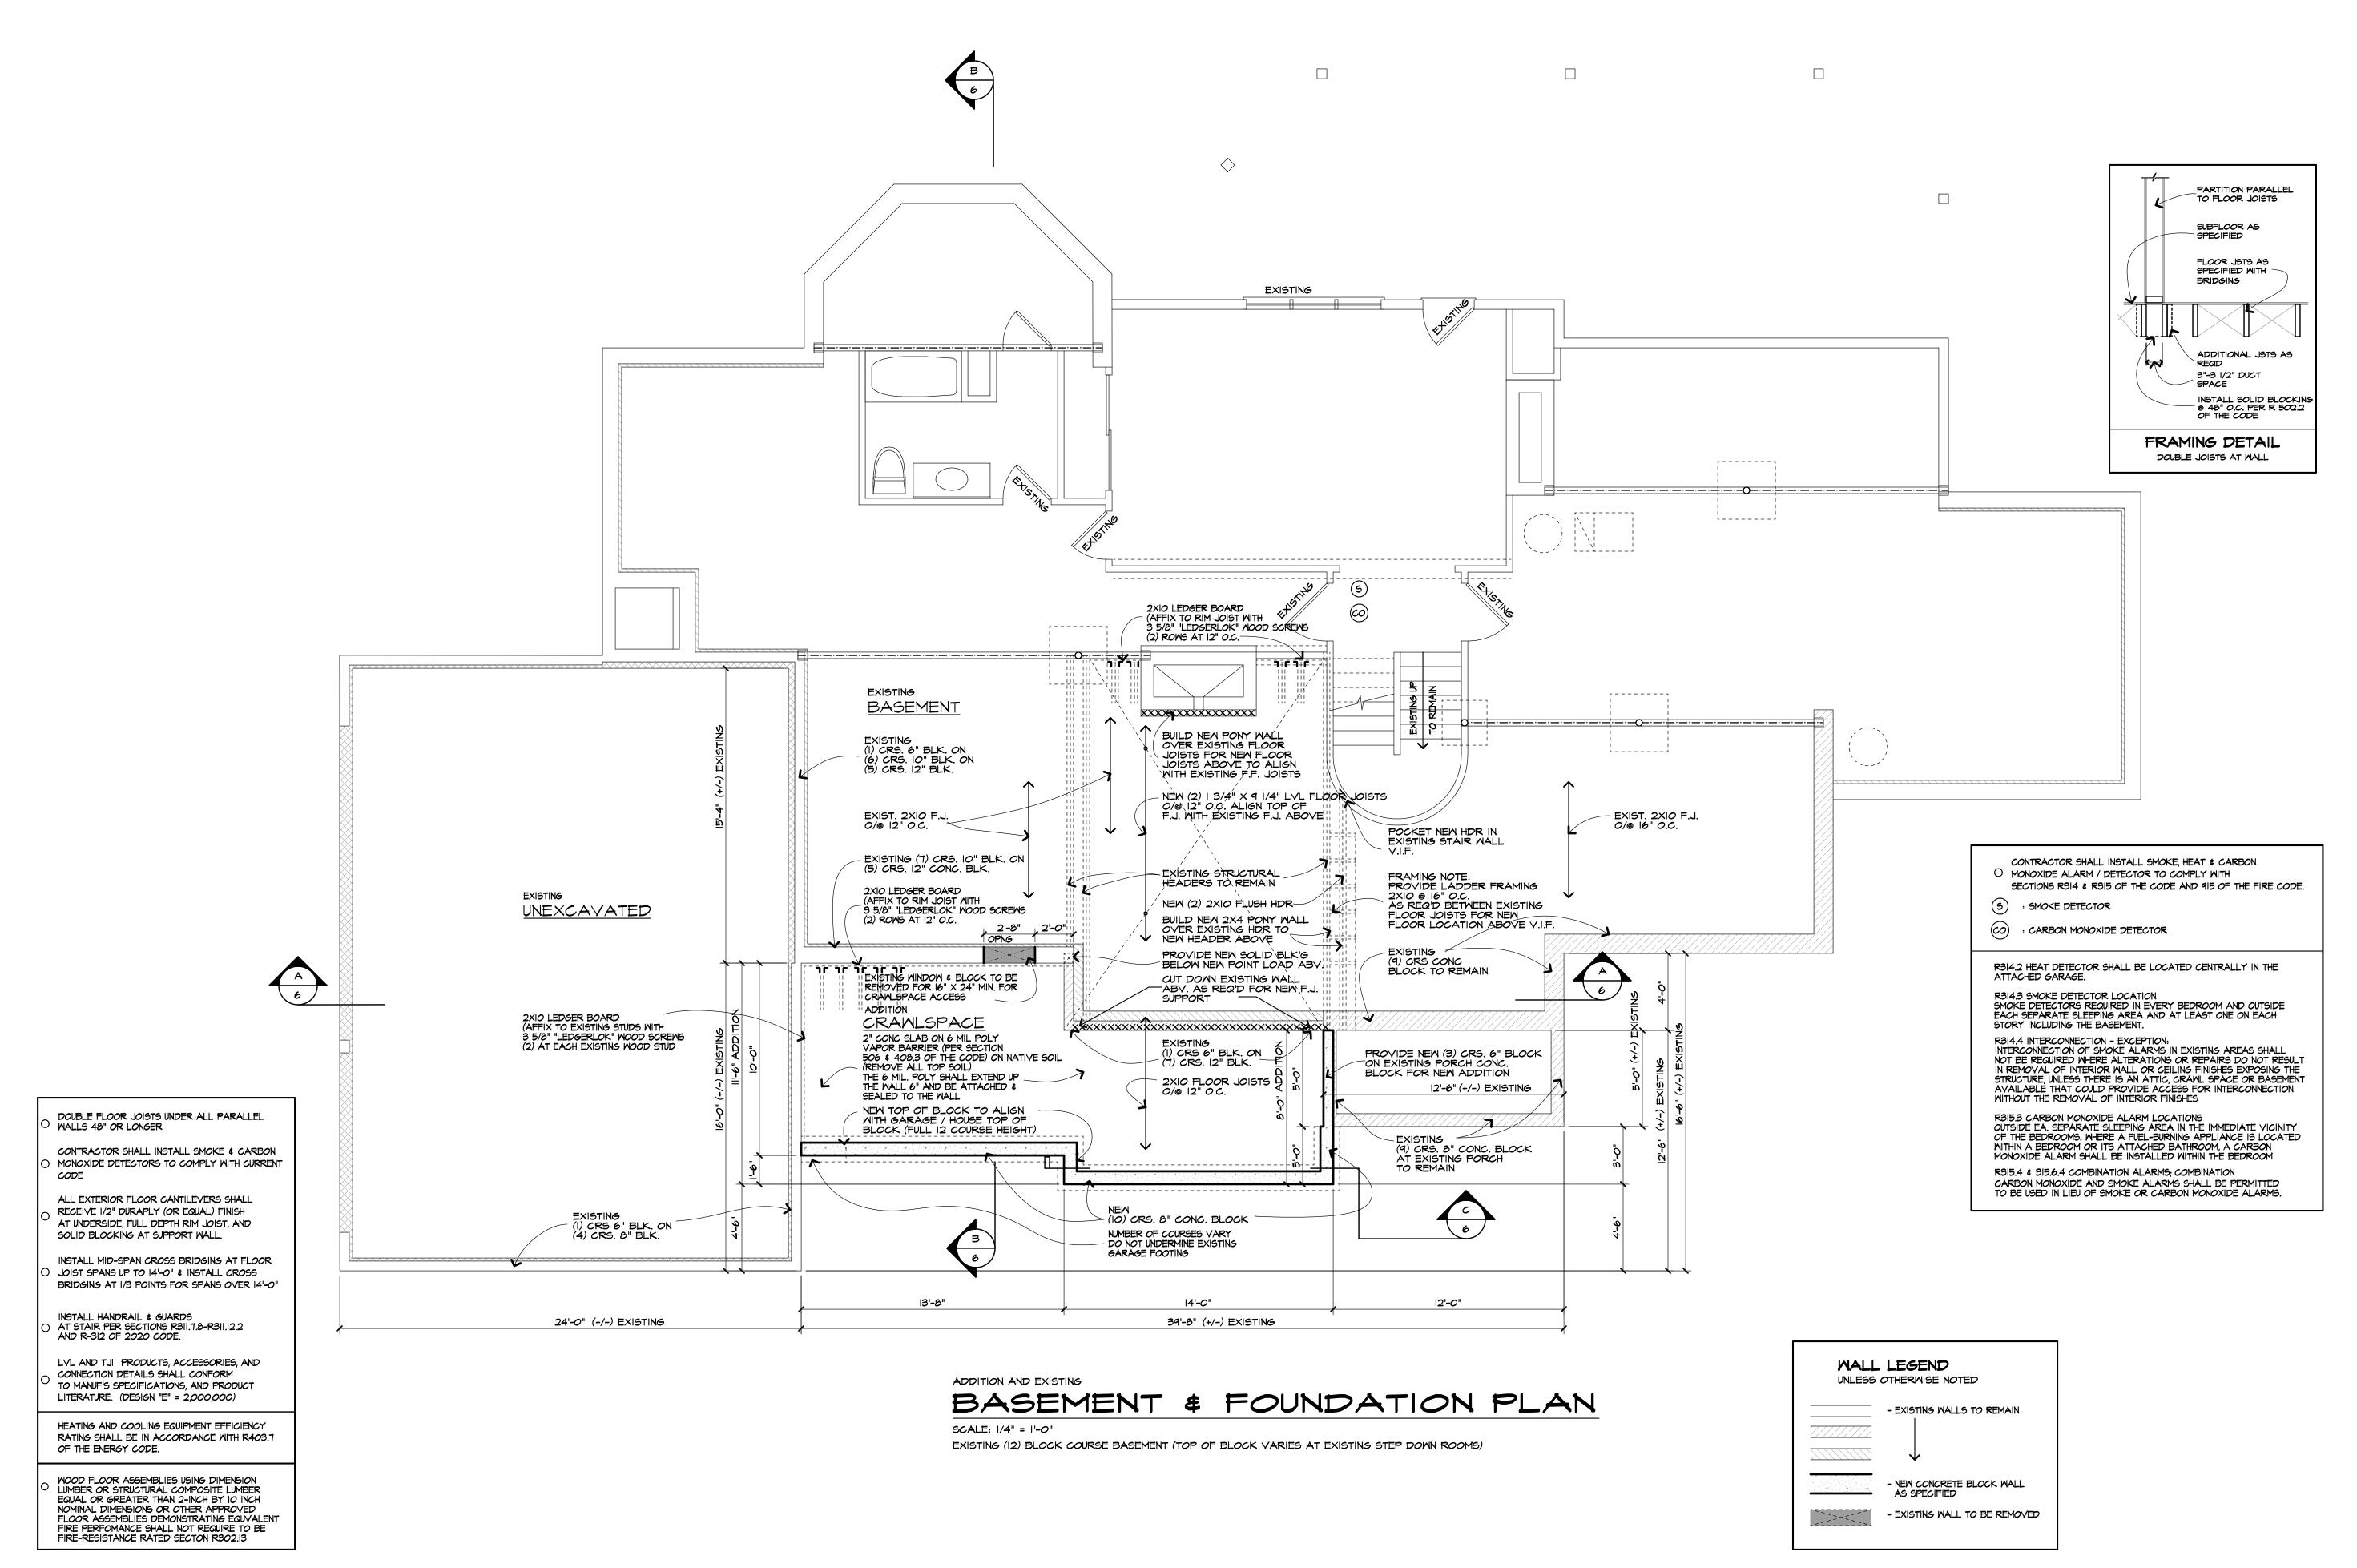Project:

RESIDENTIAL ADDITION / REMODEL

REG & TINA ROWDEN

Job Location

25 BARRINGTON HILLS PITTSFORD, NEW YORK

Drawing Title:


BASEMENT PLAN

SMK Checked By

FEBRUARY, 2024

38752

3 of

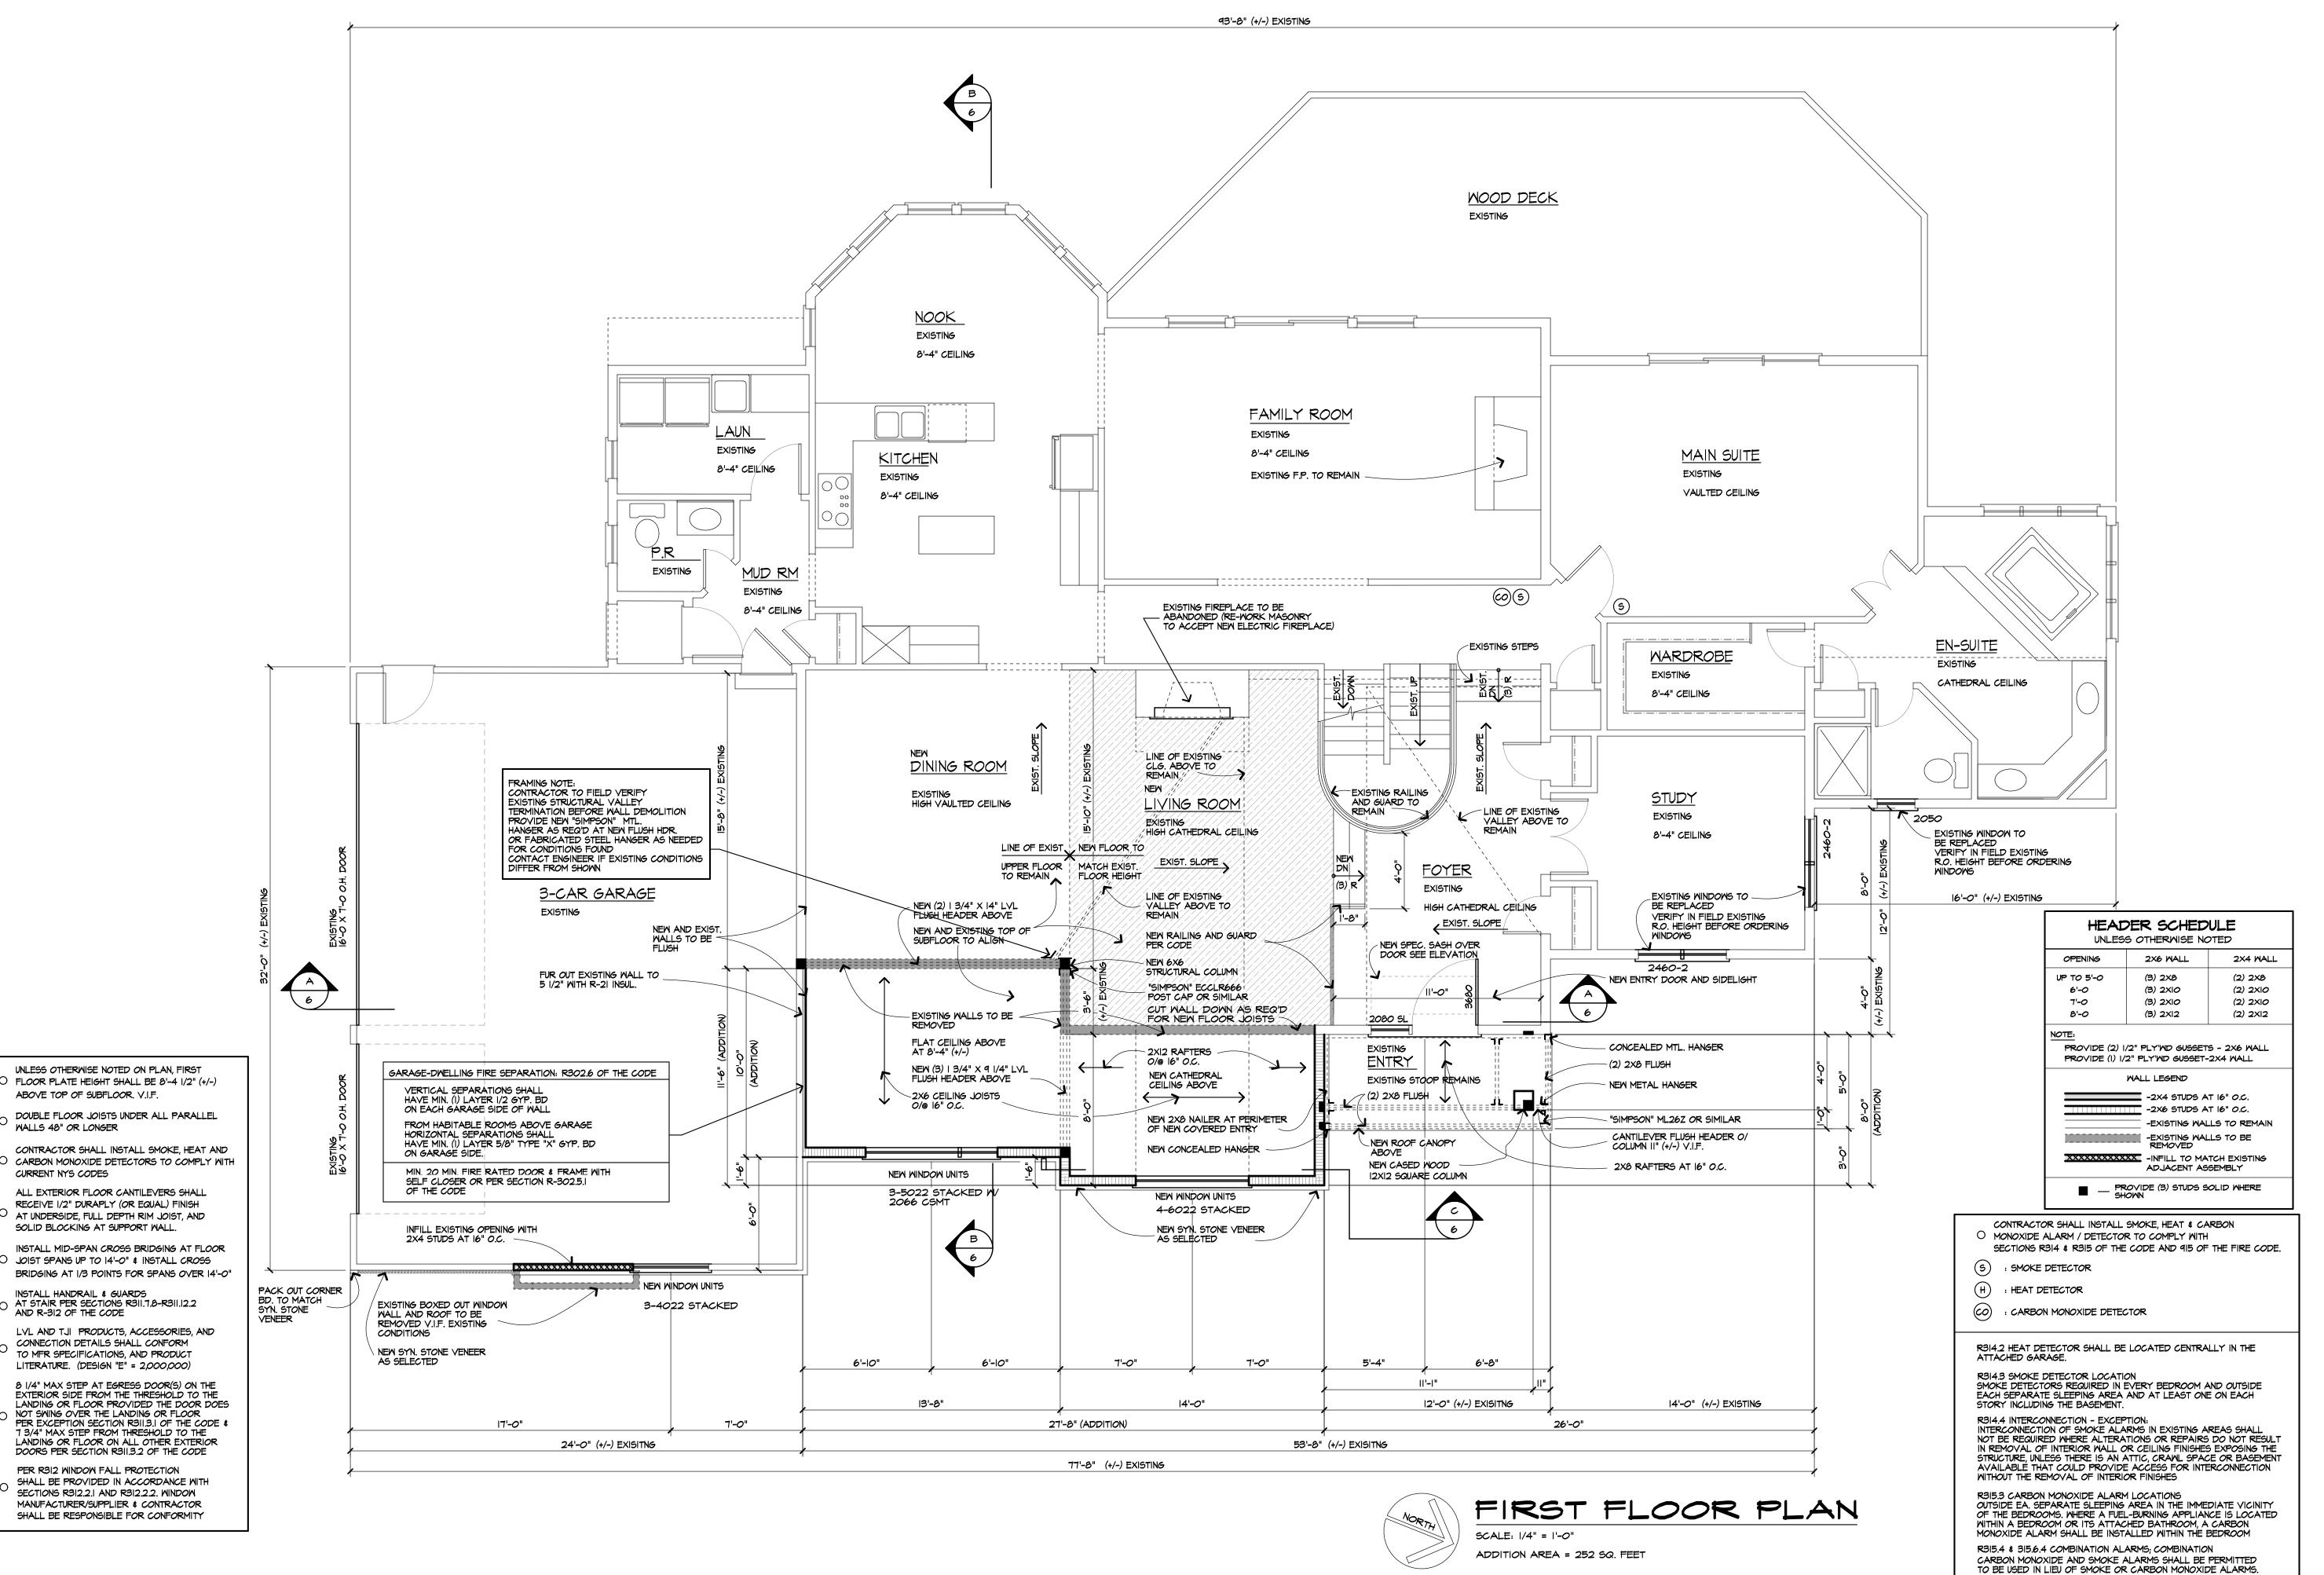



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Project:

RESIDENTIAL ADDITION / REMODEL

REG & TINA ROWDEN

25 BARRINGTON HILLS PITTSFORD, NEW YORK


FIRST FLOOR PLAN

Checked By

FEBRUARY, 2024

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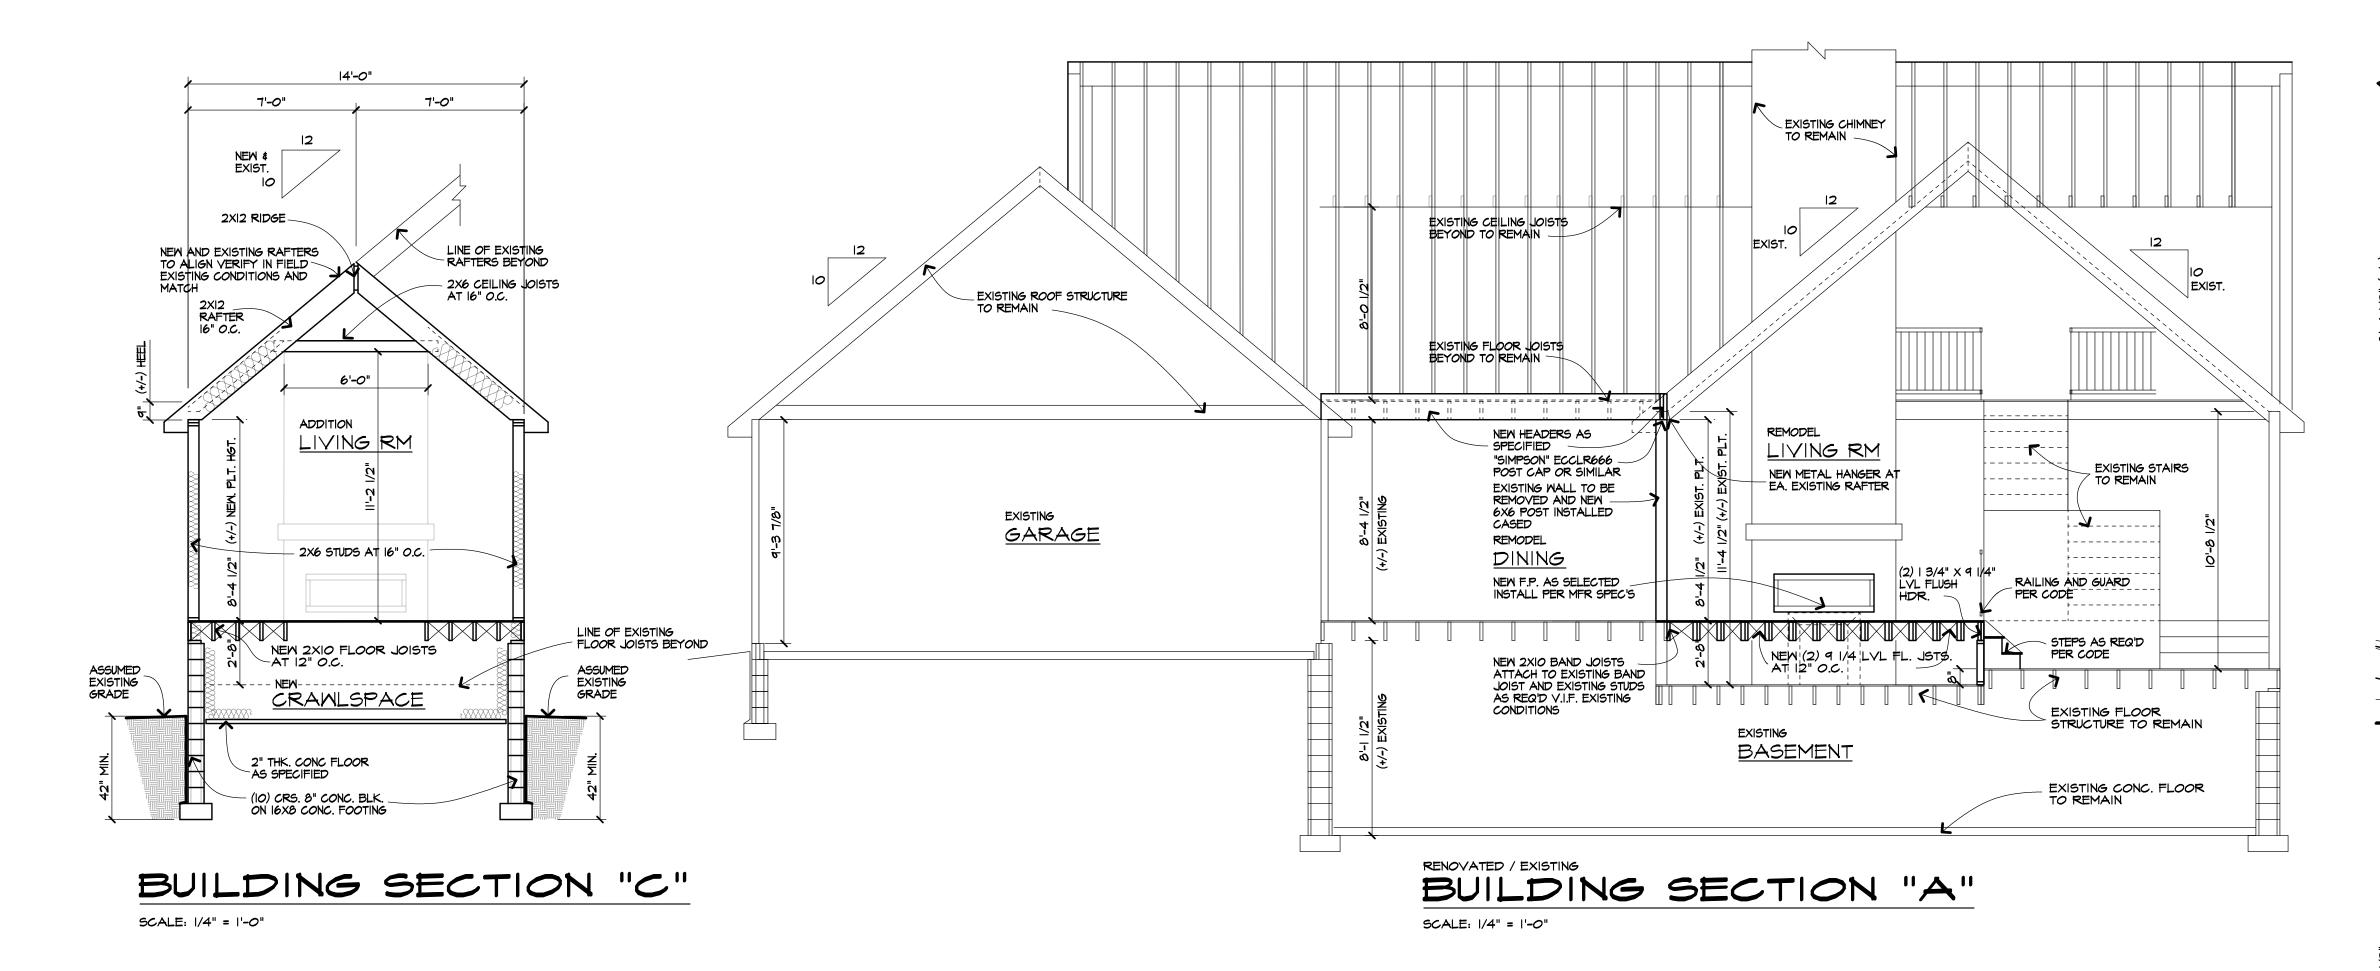



25 BARRINGTON HILLS

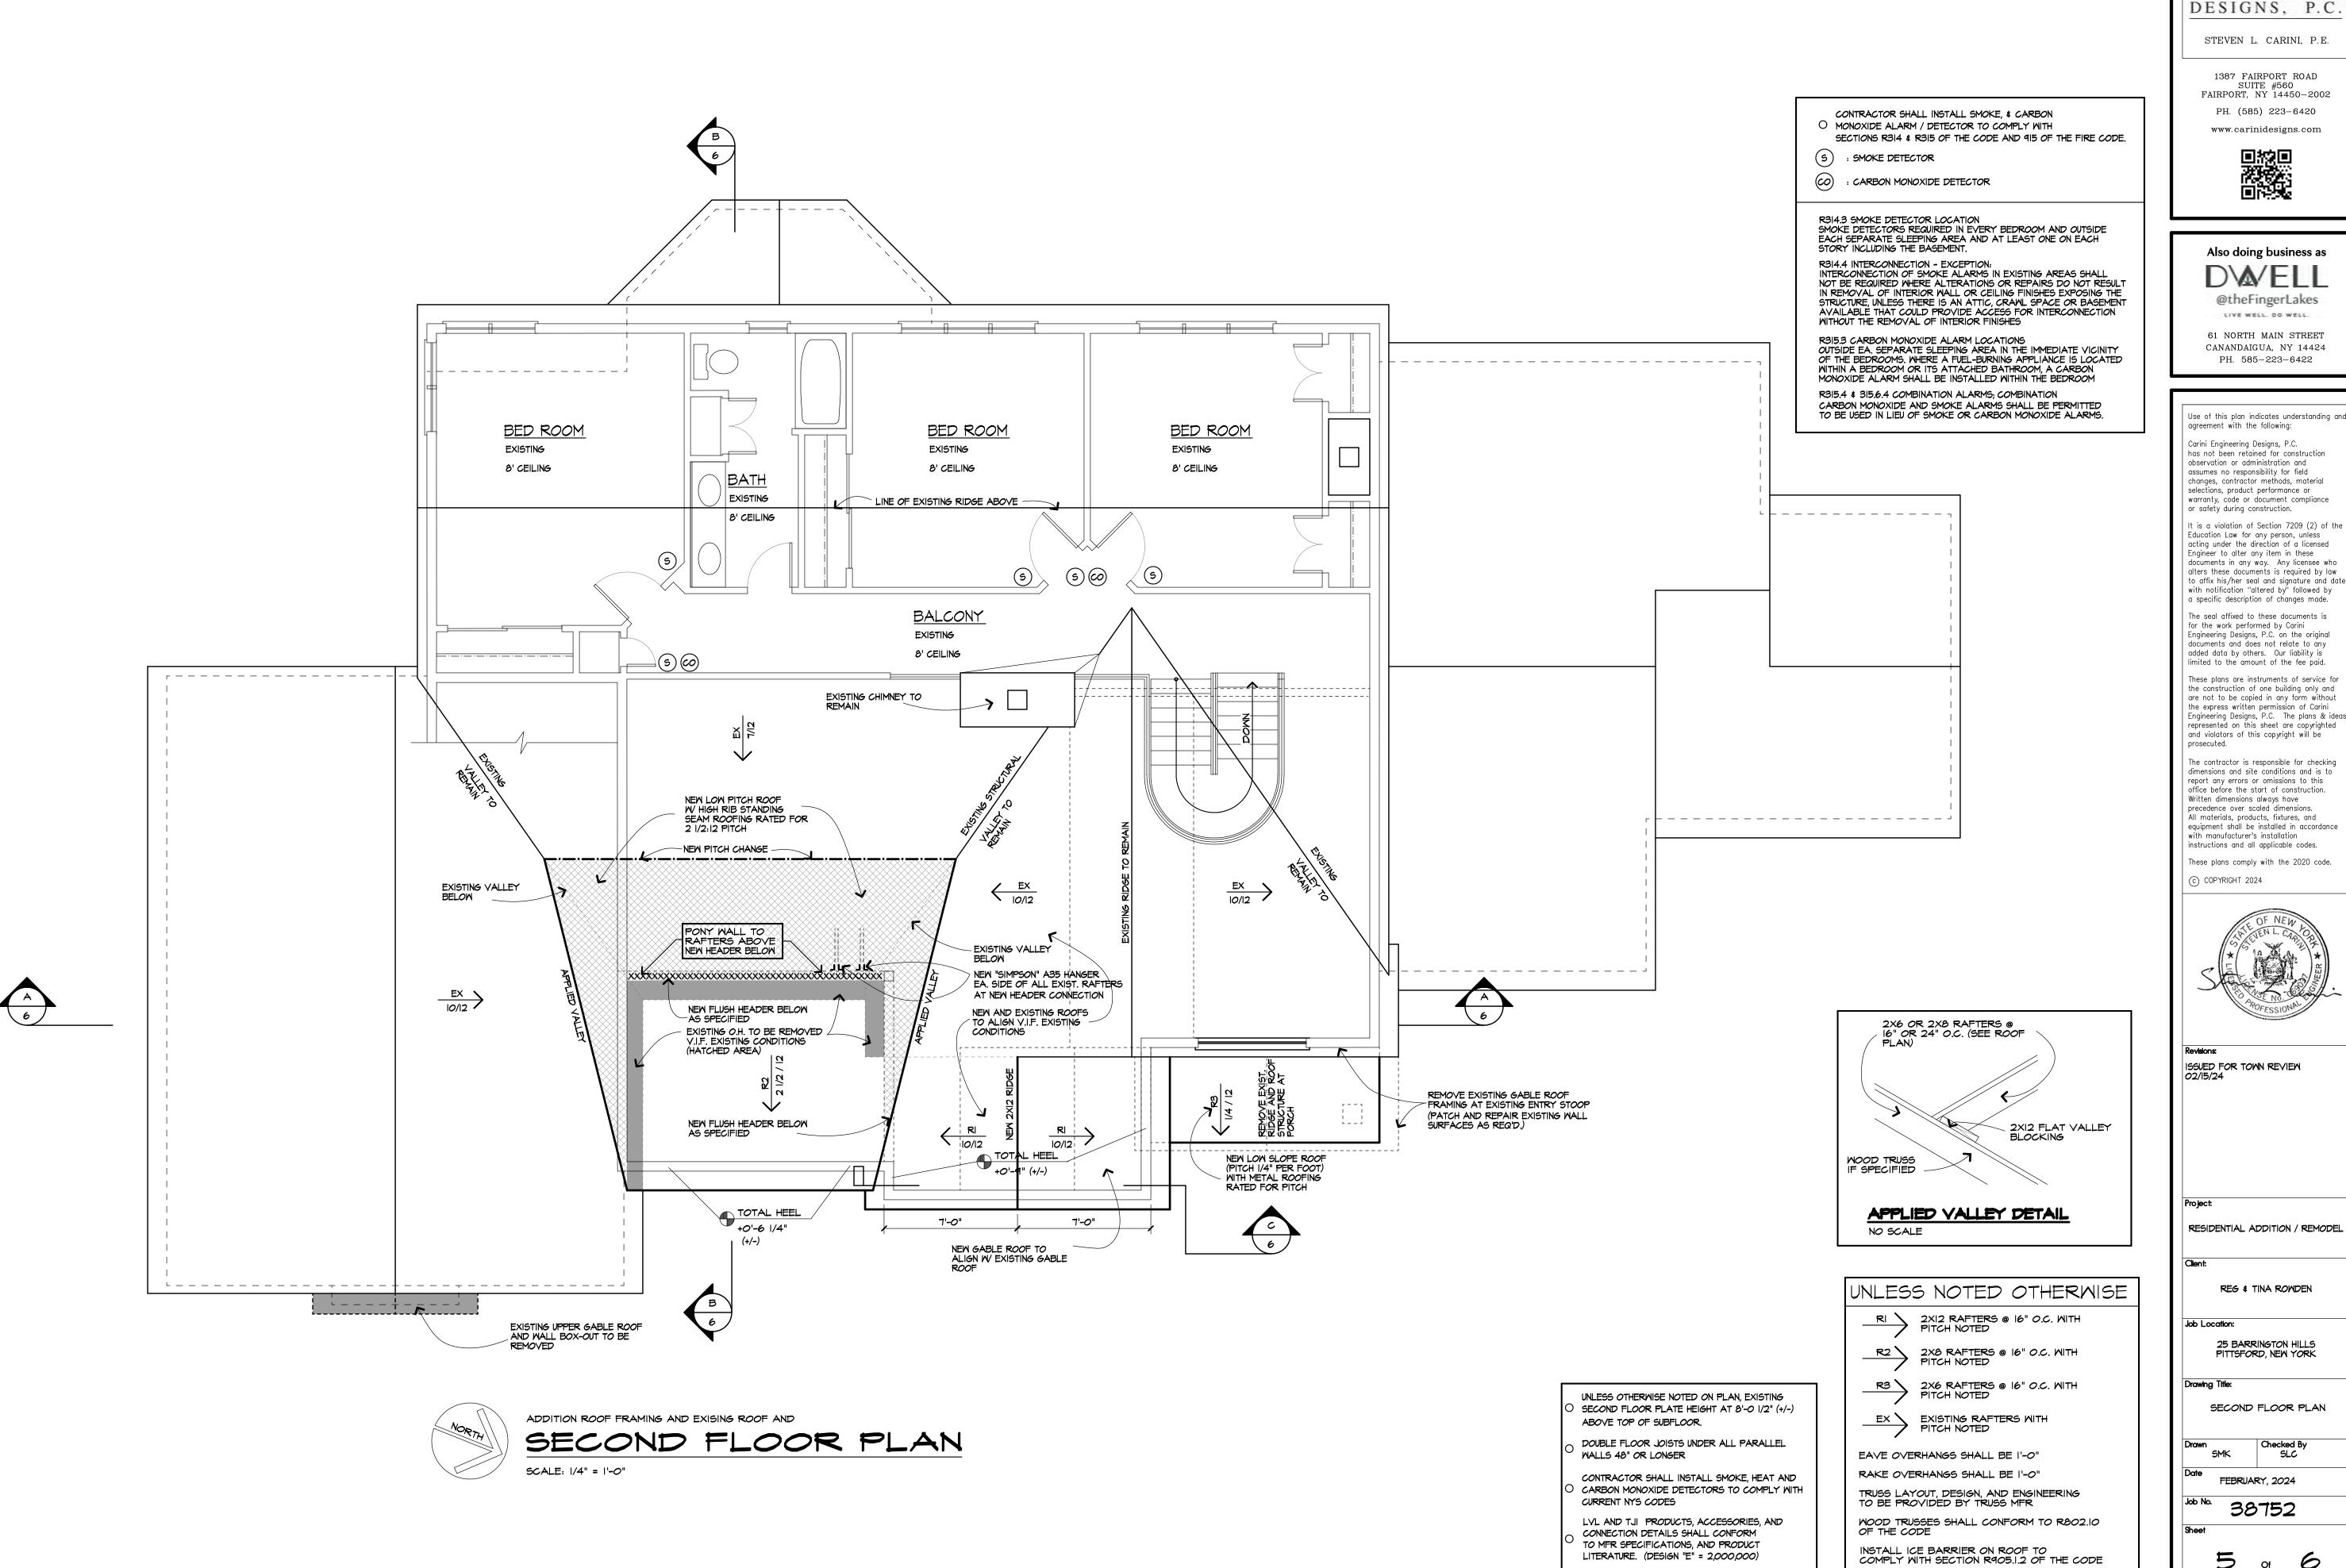
Checked By SLC

LITERATURE. (DESIGN "E" = 2,000,000)





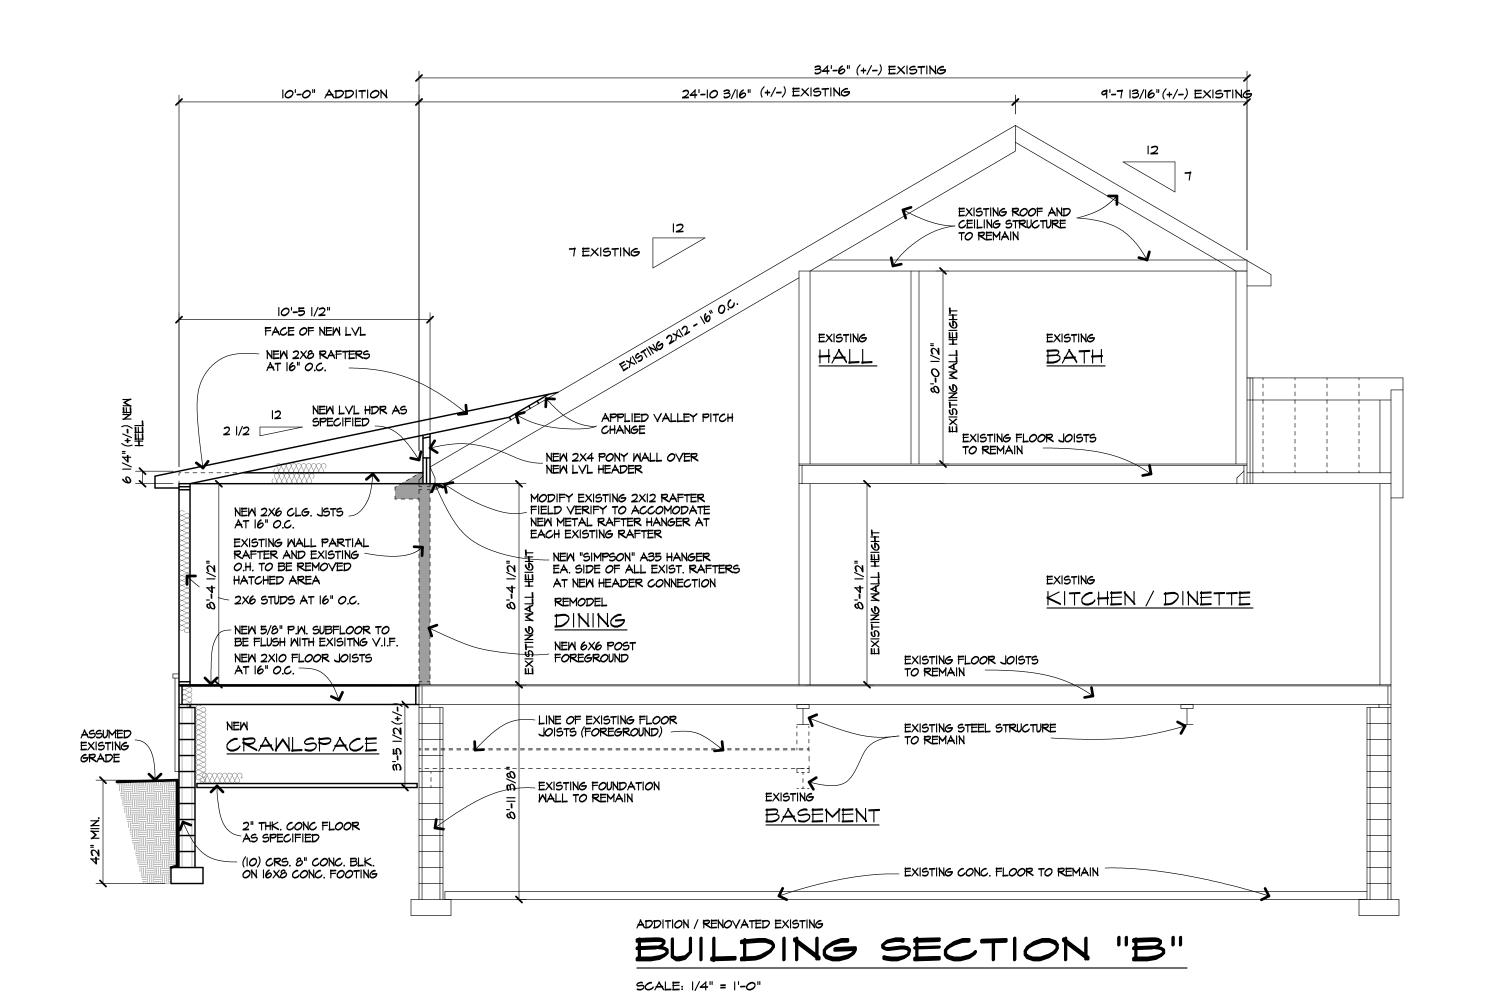

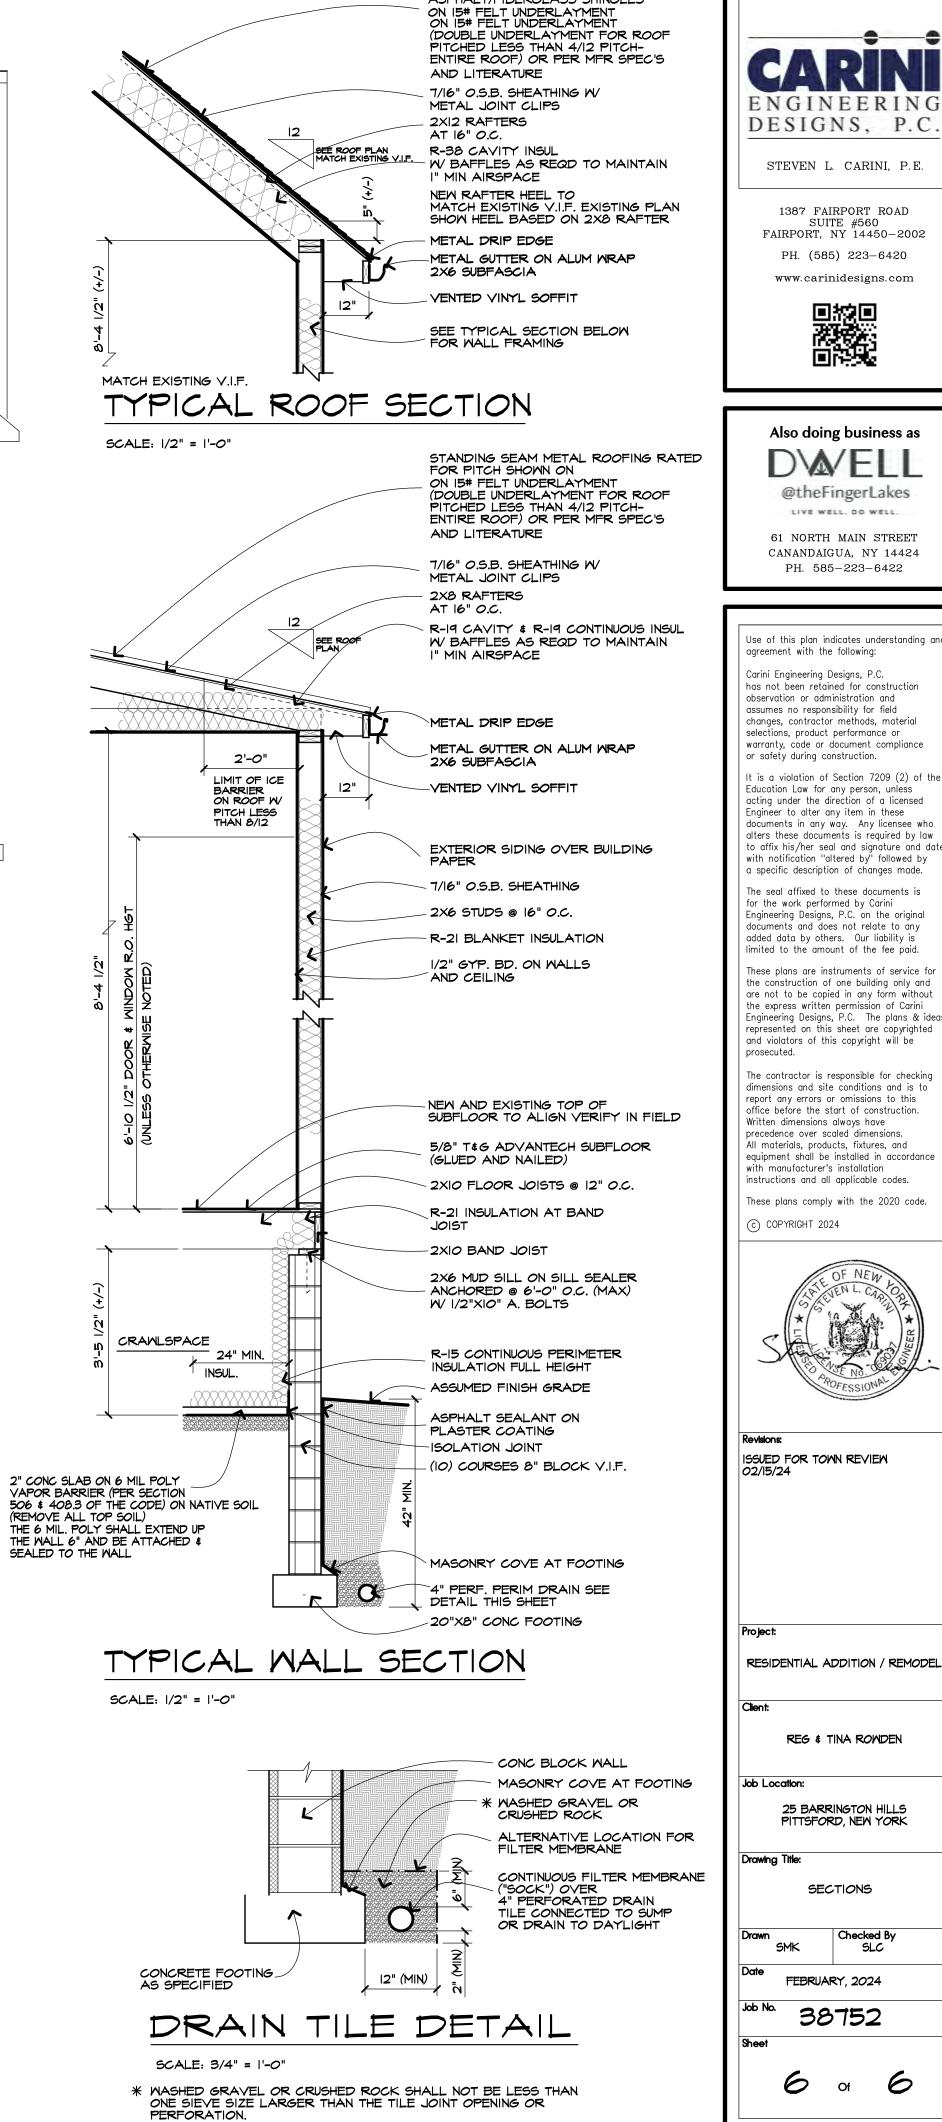

ASPHALT/FIBERGLASS SHINGLES

DESIGNS, P.C. STEVEN L. CARINI, P.E. 1387 FAIRPORT ROAD SUITE #560 FAIRPORT, NY 14450-2002

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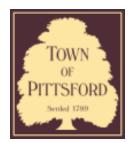
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The contractor is responsible for checking dimensions and site conditions and is to report any errors or omissions to this office before the start of construction.

All materials, products, fixtures, and equipment shall be installed in accordance instructions and all applicable codes.





Town of Pittsford

Department of Public Works 11 South Main Street Pittsford, New York 14534

Permit # B24-000024

Phone: 585-248-6250 FAX: 585-248-6262

DESIGN REVIEW AND HISTORIC PRESERVATION BOARD REFERRAL OF APPLICATION

Property Address: 11 Smead Road PITTSFORD, NY 14534

Tax ID Number: 150.20-2-59

Zoning District: RN Residential Neighborhood

Owner: Goforth, Gregory L Applicant: Goforth, Gregory L

Δı	ոո	lic	atio	n T	ype:
_	\sim		uuv		Y NO.

ippiioatioii iypoi		
Residential Design Residential D	view	Build to Line Adjustment §185-17 (B) (2)
Commercial Design Re §185-205 (B)	eview	Building Height Above 30 Feet §185-17 (M)
Signage §185-205 (C)		Corner Lot Orientation §185-17 (K) (3)
Certificate of Appropria §185-197	ateness	Flag Lot Building Line Location §185-17 (L) (1) (c)
Landmark Designation §185-195 (2)		Undeveloped Flag Lot Requirements §185-17 (L) (2)
■ Informal Review		

Project Description: Applicant is requesting design review for a 126-square-foot addition to the rear of the home, as well as new windows, doors, and siding to the existing structure.


Meeting Date: February 29, 2024



RN Residential Neighborhood Zoning



Printed February 21, 2024

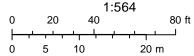

Town of Pittsford GIS





SITE PLAN - NEW (DR)

design plan live

11KGS

11 Smead Rd Pittsford, NY 14534 DRAWN BY: BuildHappy

CHECKED BY: Checker

PROJECT STATUS: PLAN02

1/31/2024 2:10:40 PM

Digital Design + Construction

50 STATE ST BUILDING R PITTSFORD, NY 14534



PLAN SHEETS

DR01-S

Site Plan New - DRB - Back



lesign plan Tive

11KGS

11 Smead Rd Pittsford, NY 14534

DRAWN BY: BuildHappy

CHECKED BY: Checker

PROJECT STATUS: PLAN02



Digital Design + Construction


50 STATE ST BUILDING R PITTSFORD, NY 14534

PLAN SHEETS

DR01-100

Front Elevation - DRB - Back Addition



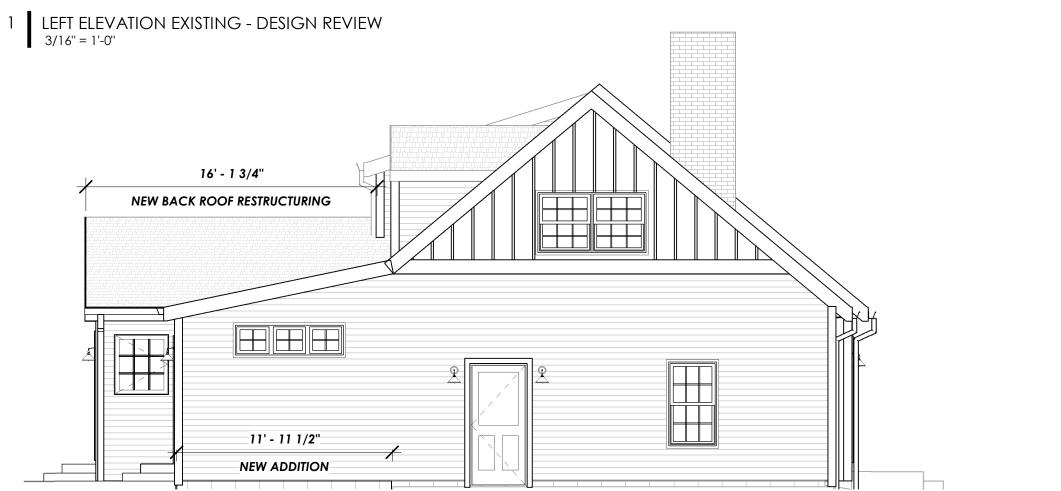

design plan live

11KGS

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DRAWN BY: BuildHappy

CHECKED BY: Checker

PROJECT STATUS: PLAN02



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50 STATE ST BUILDING R PITTSFORD, NY 14534

PLAN SHEETS

DR01-101

Left Elevation - DRB - Back Addition





design plan live

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CHECKED BY: Checker

PROJECT STATUS: PLAN02



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50 STATE ST BUILDING R PITTSFORD, NY 14534

PLAN SHEETS

DR01-102

Back Elevation - DRB - Back Addition



1 RIGHT ELEVATION EXISTING - DESIGN REVIEW 3/16" = 1'-0"



design plan live

11KGS

11 Smead Rd Pittsford, NY 14534

DRAWN BY: BuildHappy

CHECKED BY: Checker

PROJECT STATUS: PLAN02




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50 STATE ST BUILDING R PITTSFORD, NY 14534

PLAN SHEETS

DR01-103

Right Elevation - DRB - Back Addition

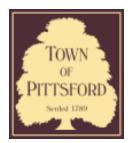

Town of Pittsford

Department of Public Works 11 South Main Street Pittsford, New York 14534

Permit # S24-000002

Phone: 585-248-6250 FAX: 585-248-6262

DESIGN REVIEW AND HISTORIC PRESERVATION BOARD REFERRAL OF APPLICATION

Property Address: 3349 Monroe Avenue ROCHESTER, NY 14618

Tax ID Number: 150.12-1-18

Zoning District: C Commercial / MATZ Monroe Avenue Transitional Zone

Owner: Pittsford Plaza SPE, LLC

Applicant: Skylight Signs


An	plic	atio	n Ty	ne:
	\sim	$\alpha \cup \circ$		\sim

application Type:	
Residential Design Review §185-205 (B)	Build to Line Adjustment §185-17 (B) (2)
Commercial Design Review §185-205 (B)	Building Height Above 30 Feet §185-17 (M)
Signage §185-205 (C)	Corner Lot Orientation §185-17 (K) (3)
Certificate of Appropriateness §185-197	Flag Lot Building Line Location §185-17 (L) (1) (c)
Landmark Designation §185-195 (2)	Undeveloped Flag Lot Requirements §185-17 (L) (2)
☐ Informal Review	


Project Description: Applicant is requesting design review for a 22.4-square-foot sign for Body Fuel at Pittsford Plaza.

Meeting Date: February 29, 2024

RN Residential Neighborhood Zoning

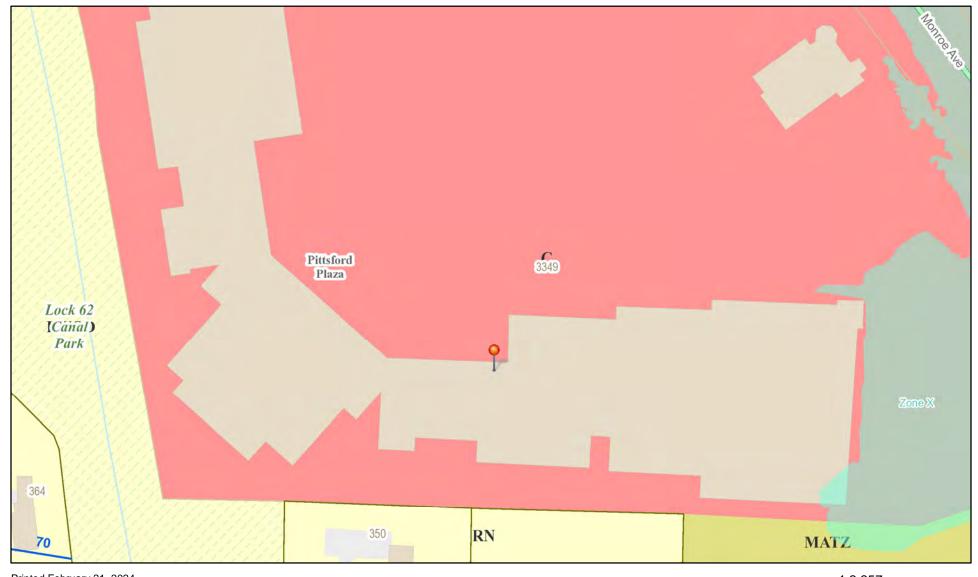



Printed February 21, 2024

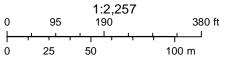

Town of Pittsford GIS

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Sign is 22.4 Sq ft

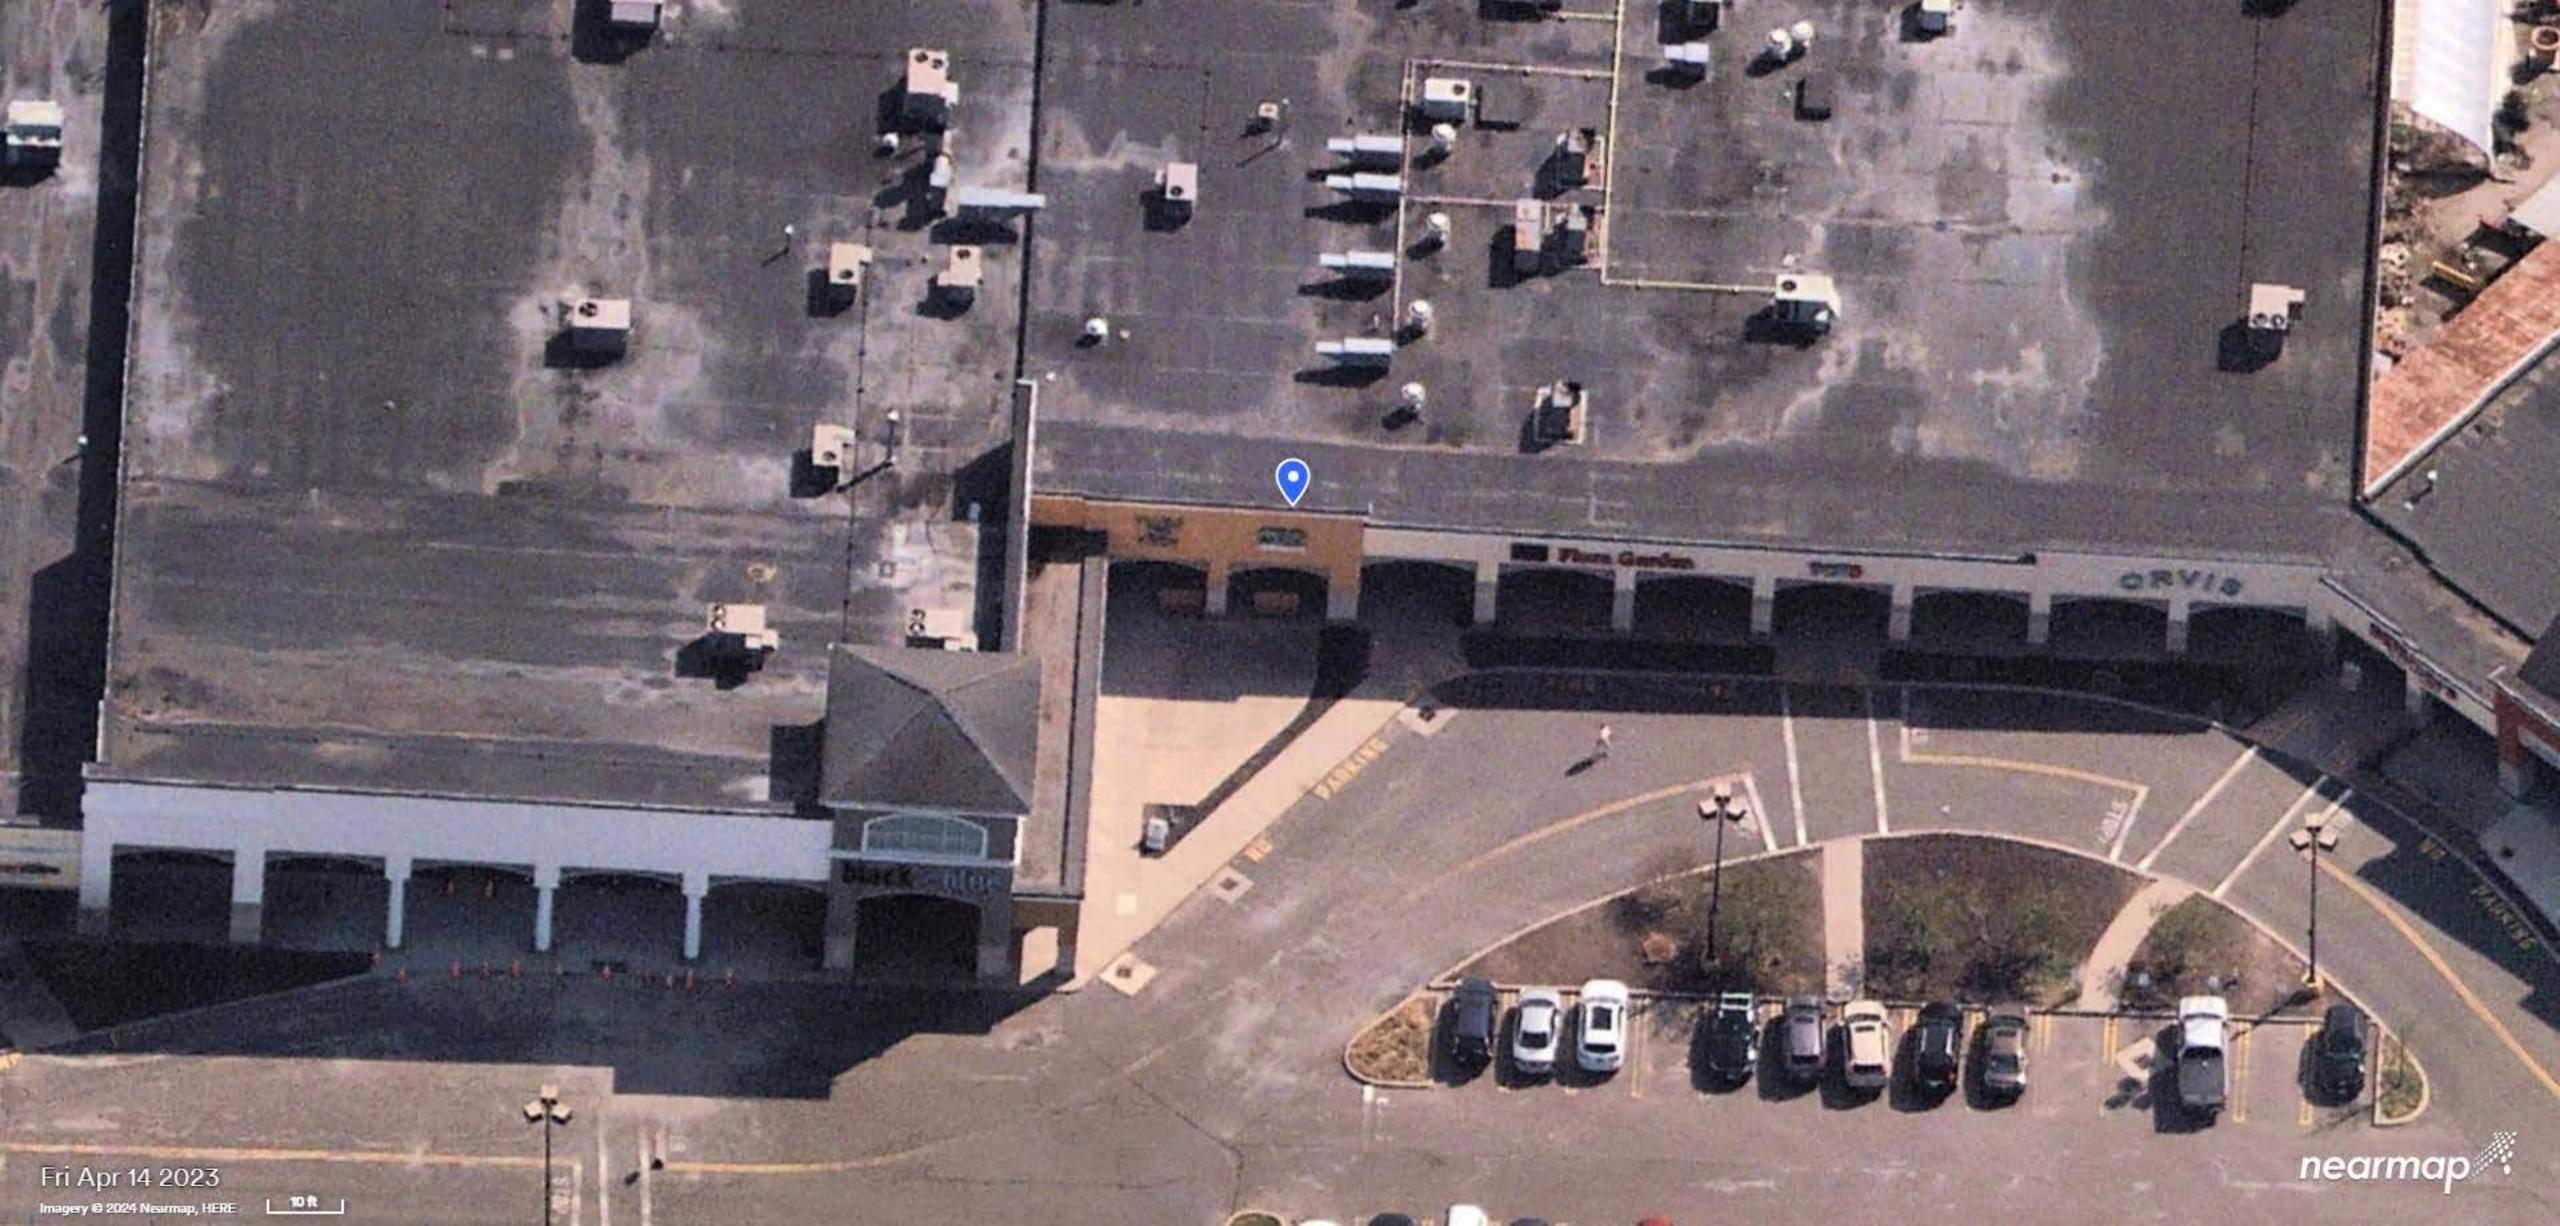Description:

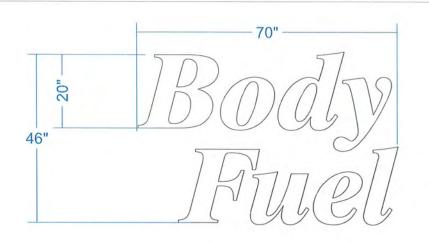(1) set of Internally illuminated channel LED flush mounted letters.

Letters to have aluminum returns with 1" trim cap and 3/16" acrylic faces.


Letters mounted directly to fascia.

Letters to be centered on building fascia area


Colors:

Face Acrylic: 7328 White

Returns: Black Trim cap: White LED: White

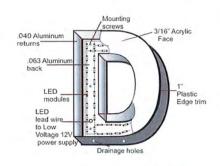

LED Flush Mount

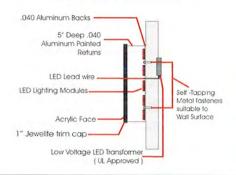



Ranne PIS GAN PIZA 2/1/24 Body Fuel Suga icus 111136