Design Review & Historic Preservation Board Agenda March 23, 2023

HISTORIC PRESERVATION DISCUSSION

BUILDING INSPECTOR REMARKS

COMMERCIAL APPLICATION FOR REVIEW - SIGNAGE

• 789 Linden Avenue

The Applicant has requested design review for the addition of a business identification sign. The building sign will be approximately 16 square feet. The sign will identify the business "McLaud Law P.C.".

RESIDENTIAL APPLICATION FOR REVIEW

82 Reitz Parkway

The Applicant is requesting design review for the construction of a covered entryway off the front of the house.

180 Alpine Drive

The Applicant is requesting design review for the removal of two windows as part of their kitchen and bath remodel project.

RESIDENTIAL APPLICATION FOR REVIEW - NEW

6 Black Wood Circle

The Applicant is requesting design review for the construction of an approximately 2036 SF new single story family home in the Wilshire Hill subdivision.

10 Aden Hill

The Applicant is requesting design review for the construction of an approximately 2040 SF new single story family home in the Wilshire Hill subdivision.

RESIDENTIAL APPLICATION FOR REVIEW - RETURNING

• 2490 Lehigh Station Road

The Applicant is requesting design review for an addition of a 2650 SF garage addition off the side of the existing house.

DEMOLITION OF STRUCTURE AND CONSTRUCTION OF NEW RESIDENCE

• 114 Sunset Boulevard

In accordance with Chapter 64 Article VIII, §64-43 of the Pittsford Town Code, the owner of 114 Sunset Boulevard is requesting approval from the Design Review and Historic Preservation Board to demolish the existing 1,872 square foot home at 114 Sunset Boulevard and rebuild a new 3,180 +/- square foot single family home on the property. Tax Parcel No. 164.10-4-23. This property is Zoned Residential Neighborhood (RN).

Design Review and Historic Preservation Board Minutes March 9, 2023

PRESENT

David Wigg, Vice Chairman; Paul Whitbeck, Jim Vekasy, Kathleen Cristman

ALSO PRESENT

Cathy Koshykar, Town Board liaison; Bill Zink, Building Inspector; Susan Donnelly, Secretary to the Board

ABSENT

Dirk Schneider, Chairman; Bonnie Salem, John Mitchell

HISTORIC PRESERVATION DISCUSSION

There was no historic preservation discussion.

RESIDENTIAL APPLICATION FOR REVIEW

2490 Lehigh Station Road

The Applicant is requesting design review for the addition of a 100 SF front entry porch.

The homeowner, Kody Young, was present.

The applicant is requesting design approval for a porch that is already under construction. The porch is proposed to have metal roofing. The siding will be white board and batten. Brick has been removed and replaced with stone. The building inspectors will check to see if the height of the porch will require a railing by code. The Board approved of the design of the porch.

David Wigg move to approve the design for a front porch entry as submitted.

Paul Whitbeck seconded.

All Ayes.

2490 Lehigh Station Road

The Applicant is requesting design review for an addition of a 2650 sf garage addition off the side of the existing house.

The homeowner, Kody Young, was present.

Mr. Young is proposing to demolish a current one car garage and replace with a 4-bay garage addition. The garage addition will be stepped back from the main structure and turned perpendicular to it facing Pittsford Henrietta Town Line Road. Living space is proposed above the garage bays. One of the bays is proposed to have a larger door to accommodate potential future boat storage. Mr. Young indicated that the windows and roofing materials will match the existing on the home. The style of garage doors has not been determined.

The Board raised concerns that the proposed garage addition is too large in relation to the existing home. They asked if the current trees would remain, and Mr. Young indicated that one will need to be removed to achieve the construction of the garage and one is currently blocking the view of the road.

David Wigg suggested a breezeway between the garage and home, but the homeowner preferred not to pursue that option.

Kathleen Cristman suggested making a smaller garage or having a detached garage design to break up the massing of the garage.

The elimination of one of the ridges was also suggested.

After discussion, Jim Vekasy moved to accept the application for a 4-bay garage addition as submitted.

David Wigg seconded.

Ayes – Wigg, Cristman, Vekasy Nay – Whitbeck

The motion failed to carry.

The applicant asked for further direction. The Board suggested that the applicant consider the comments and return to the Board at a future meeting.

32 Rosewood Drive

The Applicant is requesting design review for the construction of a covered porch off the front of the house.

The homeowner, Mike Madden, was present.

The porch will feature a hip roof design and the shingles will match the existing asphalt shingles currently on the home. The columns will be wrapped white 6" x 6" Azek to match the white trim on the home.

David Wigg move to approve the application as submitted.

Kathleen Cristman seconded.

All Ayes.

91 Caversham Woods

The Applicant is requesting design review for the construction of approximately a 520 SF addition off the rear of the house.

Tom Taglitanto of Tri-State Construction was present to represent the homeowner.

He indicated that the siding from the original house will be reused on the new addition. All other materials will match the existing.

Kathleen Cristman moved to accept the application as submitted.

David Wigg seconded.

All Ayes.

56 and 58 Skylight Trail

The Applicant is requesting design review for the proposed construction of a new town home dwelling. The proposed building will consist of 2 attached single family dwellings sharing a common wall. 56 Skylight Trail will be approximately 1884 sq. ft. and 58 Skylight Trail will be 2023 sq. ft. The town homes will be located in the new Alpine Ridge development.

Bill Arieno of Morrell Builders was present,

This new model in section 2 of Alpine Ridge will feature one side load and one front load garage. There will be no stone materials on this model.

David Wigg moved to accept the application as submitted.

Paul Whitbeck seconded.

All Ayes.

DEMOLITION OF STRUCTURE AND CONSTRUCTION OF NEW RESIDENCE

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Vice Chairman David Wigg opened the public hearing.

The homeowner, Verdana Saralijic, was present.

Ms. Saralijic is requesting approval to demolish the current structure and build a new home on the footprint of the former. She cited foundational and insulation issues with the current home. She stated the home is poorly constructed, not energy efficient and does not meet their family needs. She indicated the new home plan will feature a basement and second floor. She also stated she is working with the Town Engineer to resolve drainage issues on the property.

Vice Chairman David Wigg called for public comment and there was none. No correspondence to date has been received by the Town regarding this application.

David Wigg moved to close the public hearing.

Kathleen Cristman seconded.

All Ayes.

The Board discussed that it has been determined that the home has no historical or architectural significance and noted that the proposed design is a vast improvement over the existing structure.

No vote of decision was taken at this meeting.

REVIEW OF MINUTES OF FEBRUARY 23, 2023 MEETING

David Wigg moved to accept the minutes of the February 23, 2023, meeting as written.

Kathleen Cristman seconded.

All Ayes.


ADJOURNMENT

David Wigg moved to close the meeting at 7:35 pm.

All Ayes.

Respectfully submitted,

Susan Donnelly Secretary to the Design Review and Historic Preservation Board

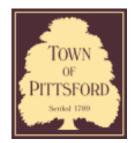

Town of Pittsford

Department of Public Works 11 South Main Street Pittsford, New York 14534

Permit # S23-000004

Phone: 585-248-6250 FAX: 585-248-6262

DESIGN REVIEW AND HISTORIC PRESERVATION BOARD REFERRAL OF APPLICATION

Property Address: 789 Linden Avenue ROCHESTER, NY 14625

Tax ID Number: 138.15-1-43

Zoning District: LI Light Industrial
Owner: Gino D'Agostino Family, LLC
Applicant: 789 Linden Avenue LLC

App	lication	Type:

'P P	noution Typo:	
	Residential Design Review §185-205 (B)	Build to Line Adjustment §185-17 (B) (2)
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	Informal Review	

Project Description: Applicant has requested design review for the addition of a business identification sign. The building sign will be approximately 16 square feet. The sign will identify the business "McLaud Law P.C.".


Meeting Date: March 23, 2023

Proposed 2' x 8' sign illuminated sign for 789 Linden Ave

24" x 96" x 3" deep fabricated aluminum pill box sign with routed aluminum face and push through acrylic box and letters. Vinyl copy on box by Gupp

Face and returns painted black, white acrylic, LED internal illumination



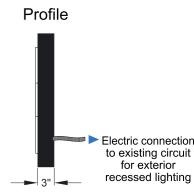

2' x 8' sign centered in 44" x 160" recessed sign area



Existing tenant sign on East elevation at 789 Linden Ave 42" x 96"= 28 sf internally illuminated pill box sign similar to proposed one for McLaud Law



Proposed second tenant sign on North elevation 789 Linden Ave.



Tenant occupied frontage of building 52 lineal feet proposed sign 2' x 8' = 16 sf

Design Review & Historic Preservation Board Agenda March 23, 2023

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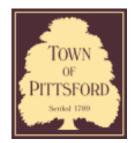
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Respectfully submitted,

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Town of Pittsford

Department of Public Works 11 South Main Street Pittsford, New York 14534

Permit # S23-000004

Phone: 585-248-6250 FAX: 585-248-6262

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Tax ID Number: 138.15-1-43

Zoning District: LI Light Industrial
Owner: Gino D'Agostino Family, LLC
Applicant: 789 Linden Avenue LLC

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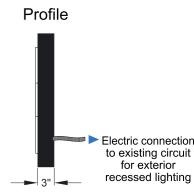
Meeting Date: March 23, 2023

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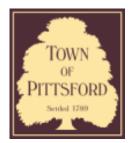
Existing tenant sign on East elevation at 789 Linden Ave 42" x 96"= 28 sf internally illuminated pill box sign similar to proposed one for McLaud Law



Proposed second tenant sign on North elevation 789 Linden Ave.



Tenant occupied frontage of building 52 lineal feet proposed sign 2' x 8' = 16 sf



Town of Pittsford

Department of Public Works 11 South Main Street Pittsford, New York 14534

Permit # B23-000029

Phone: 585-248-6250 FAX: 585-248-6262

DESIGN REVIEW AND HISTORIC PRESERVATION BOARD REFERRAL OF APPLICATION

Property Address: 82 Reitz PITTSFORD, NY 14534

Tax ID Number: 164.11-2-5

Zoning District: RN Residential Neighborhood

Owner: Boyce, Martha Cushman Applicant: Stagliano Builders

Application	Ty	oe:
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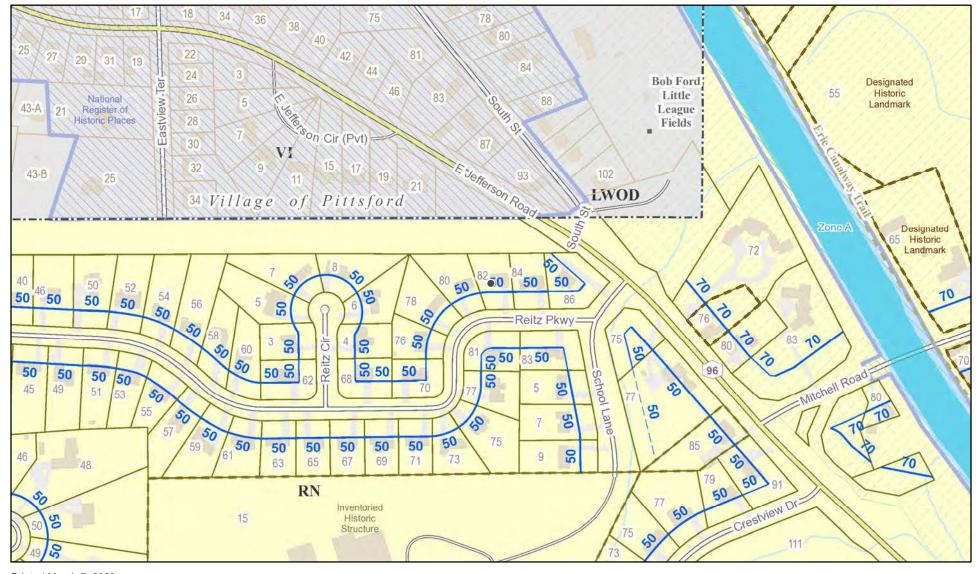
אאי	noution typo:	
✓	Residential Design Review §185-205 (B)	Build to Line Adjustment §185-17 (B) (2)
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	Informal Review	

Project Description: Applicant is requesting design review for the construction of a covered entryway off the front of the house.


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RN Residential Neighborhood Zoning




Printed March 7, 2023



Town of Pittsford GIS

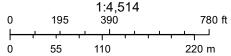The information depicted on this map is representational and should be used for general reference purposes only. No warranties, expressed or implied, are provided for the data or its use or interpretation.



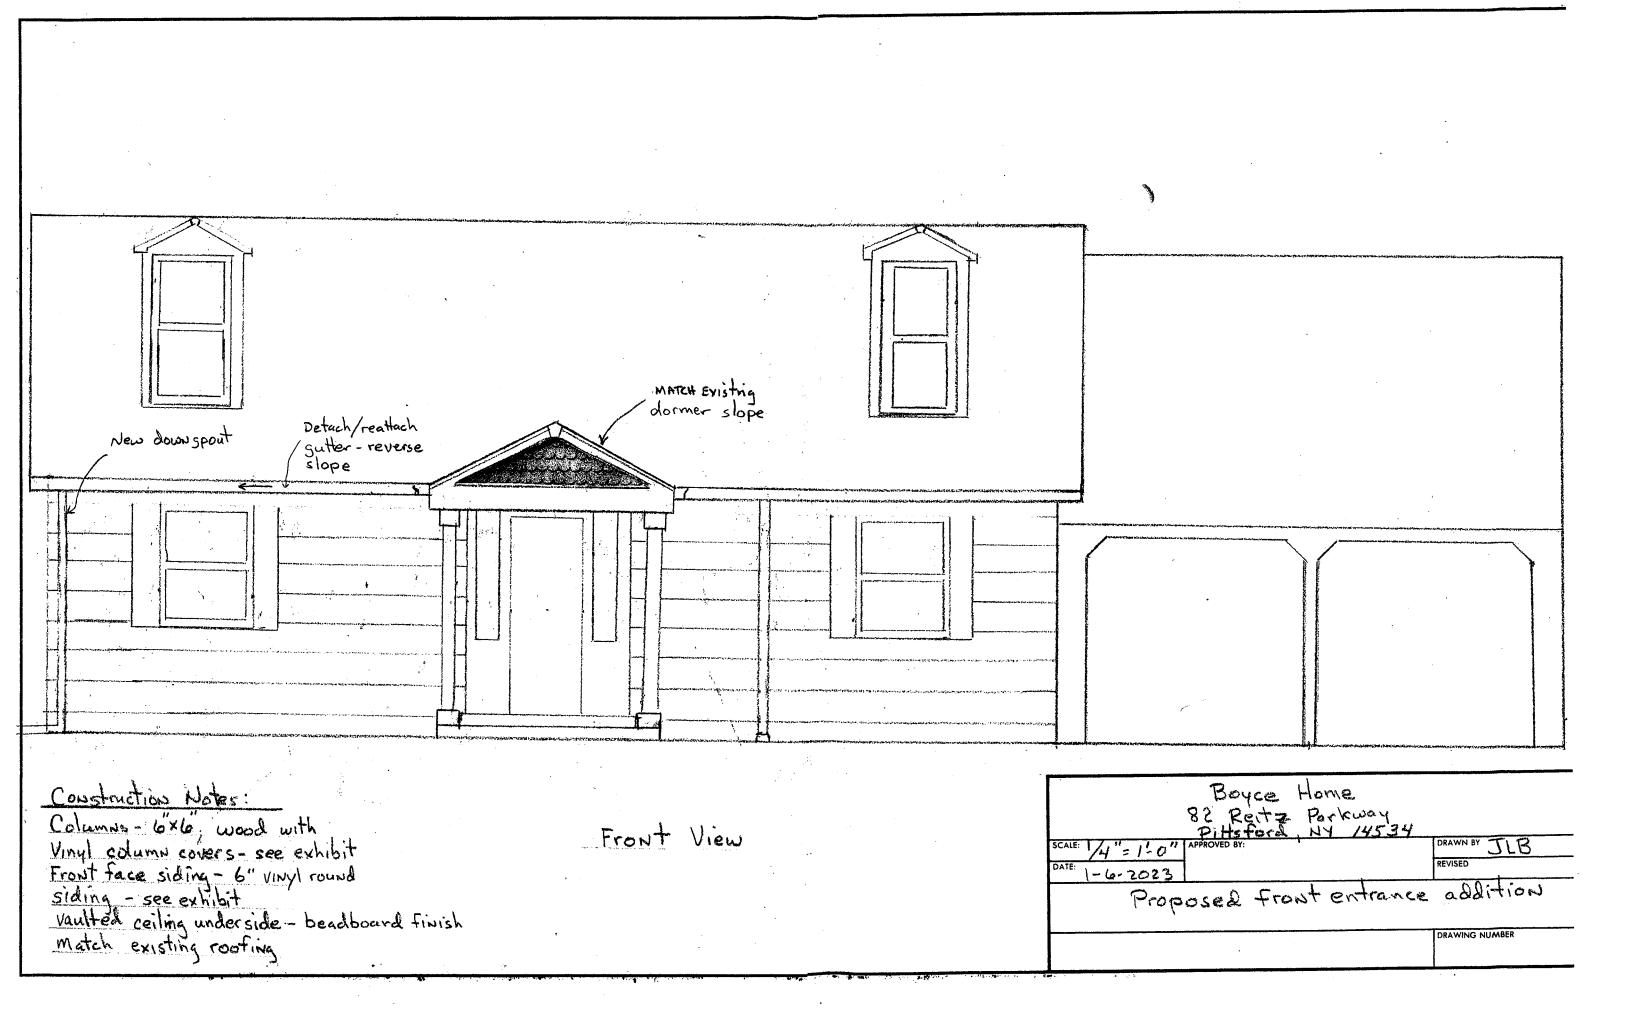

Existing House Existing Front entrance steps Boyce Home

APPROVED BY:

14" = 1'-0"

1-6-5023

END VIEW

DRAWN BY

DRAWING NUMBER

REVISED

118









Town of Pittsford

Department of Public Works 11 South Main Street Pittsford, New York 14534

Permit # B23-000031

Phone: 585-248-6250 FAX: 585-248-6262

DESIGN REVIEW AND HISTORIC PRESERVATION BOARD REFERRAL OF APPLICATION

Property Address: 180 Alpine Drive ROCHESTER, NY 14618

Tax ID Number: 151.06-2-28

Zoning District: RN Residential Neighborhood

Owner: Cottrell, Brandon

Applicant: Rochester Bath and Kitchen

Application Type:

, PP	iication Type.	
✓	Residential Design Review §185-205 (B)	Build to Line Adjustment §185-17 (B) (2)
	Commercial Design Review §185-205 (B)	Building Height Above 30 Feet §185-17 (M)
	Signage §185-205 (C)	Corner Lot Orientation §185-17 (K) (3)
	Certificate of Appropriateness §185-197	Flag Lot Building Line Location §185-17 (L) (1) (c)
	Landmark Designation §185-195 (2)	Undeveloped Flag Lot Requirements §185-17 (L) (2)
	Informal Review	

Project Description: Applicant is requesting design review for the removal of two windows as part of their kitchen and bath remodel project.


Meeting Date: March 23, 2023



RN Residential Neighborhood Zoning




Printed March 16, 2023

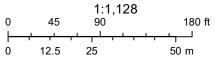


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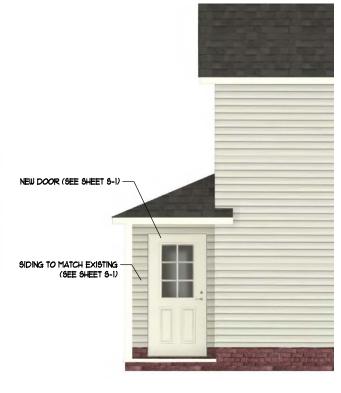


PROJECT LOCATION: 180 ALPINE DRIVE ROCHESTER, NY 14618 (IMAGE SOURCE: GOOGLE MAPS)



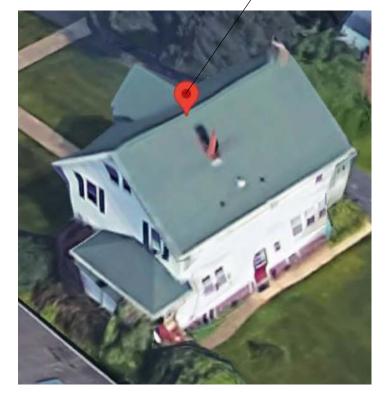

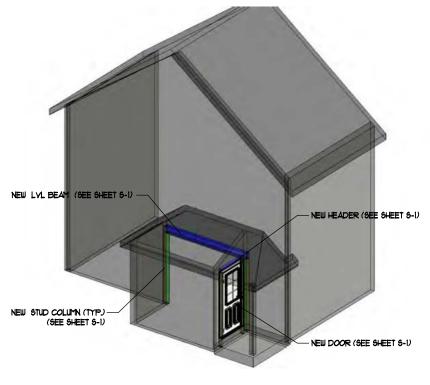



SCALE: N.T.S.

STRUCTURAL PERSPECTIVE
SCALE: N.T.S.

RENDERED PERSPECTIVE

SCALE: N.T.S.





Torchia Structural Engineering & Design P.C.

625 Panorama Trail Suite #2210 Rochester, NY 14625 www.TSE123.com

Phone: 585-385-7630 Fax: 585-385-6386

Interior Alterations to: The Cottrell Residence

S-2

GENERAL/STRUCTURAL NOTES:

I. GENERAL NOTES

- 1. THE BUILDING CODE USED IS THE 2020 RESIDENTIAL CODE OF NEW YORK STATE AND THE 2020 NYS ECCC. ALL EDITIONS OF APPLICABLE CODES AND STANDARDS SHALL BE THOSE WITHIN THE 2020 RCNYS.
- CONTRACTOR TO VERIFY ALL NOTES AND DIMENSIONS BEFORE STARTING CONSTRUCTION CONTACT ENGINEER IF ERRORS OR OMISSIONS ARE FOUND.
- 3. CONTRACTOR TO BE RESPONSIBLE FOR CONSTRUCTION MEANS, METHODS, TECHNIQUES, SEQUENCES, PROCEDURES, AND SAFETY PRECAUTIONS IN CONNECTION WITH THE WORK.
- 4. PRIOR TO THE REMOVAL WORK, CONTRACTOR SHALL PROVIDE SHORING AS REQ'D. TO PERFORM THE WORK AS OUTLINED IN THIS DRAWING. SHORING IS CONSIDERED MEANS & METHODS AND THEREFORE, IS THE RESPONSIBILITY OF THE CONTRACTOR.
- 5. CONTRACTOR TO BE RESPONSIBLE FOR CONSTRUCTION MEANS, METHODS, TECHNIQUES, SEQUENCES, PROCEDURES, AND SAFETY PRECAUTIONS IN CONNECTION WITH THE WORK.
- 6. FINISHES AS SELECTED BY OWNER.
- 1. DESIGN OF HYAC, PLUMBING AND ELECTRICAL WORK ARE BY OTHERS.
- 8. REPLACE ANY SMOKE ALARMS AND CARBON MONOXIDE DETECTORS THAT ARE REMOVED DURING ALTERATIONS, INSTALL AS PER THE RESIDENTIAL CODE OF NYS.

 Wood dimensional lumber to be Hem-Fir *2 (or equal), with minimum NDS reference design values equal to:

Bending $(F_b) = 850 \text{ psi}$ Compression Parallel to Grain $(F_c) = 1,300 \text{ psi}$ Modulus of Elasticity (E) = 1,300,000 psiMin. Modulus of Elasticity $(E_{MIN}) = 470,000 \text{ psi}$ Shear Parallel to Grain $(F_v) = 150 \text{ psi}$


2. Microllam / LVL beams to meet minimum reference design values equal to:

Bending $(F_b) = 2,600$ psi $(F_c) = 2,500$ psi $(F_c) = 2,500$ psi $(F_c) = 2,500$ psi $(F_c) = 2,000,000$ psi $(F_c) = 2,000,000$ psi $(F_c) = 2,000,000$ psi $(F_c) = 2,000,000$ psi $(F_c) = 1,016,535$ psi $(F_c) = 2,85$ psi $(F_c) = 2,85$ psi

- ALL INTERIOR, COVERED FRAMING LUMBER TO BE KILN DRIED, WITH A MAXIMUM MOISTURE CONTENT (MC) OF 19%.
- 4. THE GENERAL CONTRACTOR SHALL REJECT ALL POOR QUALITY LUMBER THAT IS NOT SUITABLE FOR ITS INTENDED PURPOSE. REGARDLESS OF GRADE.
- 5. PROVIDE SOLID BLOCKING UNDER ALL BEAMS AND HEADER SUPPORTS DOWN TO MASONRY WALL OR BEAMS.
- 6. WOOD IN CONTACT WITH MASONRY, CONC. OR EARTH OR WITHIN 1'-0" OF GRADE & EXPOSED SHALL BE PRESSURE TREATED.
- FRAMING ANCHORS, JOIST HANGER, ETC. SHALL BE GALVANIZED STEEL (16 GA. MIN.) INSTALL IN STRICT ACCORDANCE WITH MFR'S INSTRUCTIONS, INCLUDING MFR'S SPECIFIED FASTENERS. PROVIDE PRODUCTS BY "SIMPSOM CO." OR APPROVED PROPOSED SUBSTITUTE.
- 8. WALL SHEATHING AT EXTERIOR WALLS: 1/2" EXTERIOR GRADE APA RATED CDX PLYWOOD.

REMOVALS GENERAL NOTES:

- I. IT IS THE CONTRACTOR'S RESPONSIBILITY TO FAMILIARIZE THEMSELVES WITH ALL DETAILS INVOLVED IN SELECTIVE DEMOLITION. SPECIFIC INSTRUCTIONS ON EACH ITEM WILL NOT BE GIVEN.
- 2. THE CONTRACTOR SHALL BE RESPONSIBLE FOR THE SALVAGE OF EXISTING MATERIALS AS REQUIRED FOR PATCHING EXISTING AREAS TO REMAIN. WHEREVER REMOVALS OCCUR, DISTURBED SURFACES SHOULD BE PATCHED TO MATCH ADJACENT EXISTING.
- THE CONTRACTOR SHALL MAINTAIN SAFE ACCESS TO ALL DESIGNATED EXITS FOR THE BUILDING OCCUPANTS DURING CONSTRUCTION.
- 4. REMOVALS SHOWN ARE NOT NECESSARILY
 ALL-INCLUSIVE. REMOVE ALL ITEMS AS REQUIRED
 TO PROVIDE THE COMPLETE FINISHED
 CONSTRUCTION AS SHOWN ON THE FULL SET OF
 DRAWINGS..
- 5. STORAGE FOR CONTRACTOR'S EQUIPMENT AND DEBRIS MUST BE KEPT INSIDE THE CONTRACT AREA.
- 6. DUMPSTERS FOR CONSTRUCTION DEBRIS ARE TO BE PROVIDED BY CONTRACTOR. ALL DEBRIS TO BE HAULED OFF SITE BY CONTRACTOR.
- 1. REMOVAL OF ELECTRICAL, PLUMBING, AND HVAC ITEMS WITHIN ARCHITECTURAL ELEMENTS SHOWN TO BE REMOVED SHALL BE BY THOSE TRADES. G.C. TO COORDINATE.
- 8. ALL DISCREPANCIES AND/OR UNFORESEEN CONDITIONS EXPOSED BY DEMOLITION WORK SHALL BE REPORTED TO THE ENGINEER IMMEDIATELY.
- 9. BEFORE BEGINNING REMOVALS, V.I.F. THAT ELEMENTS TO BE REMOVED ARE NOT LOADBEARING. PROVIDE SHORING AS REQ'D. DETERMINATION AS TO ANY NEED FOR SHORING. SHORING IS CONSIDERED MEANS AND METHODS THEREFORE, DESIGN OF ANY SHORING IS THE SOLE RESPONSIBILITY OF THE G.C.

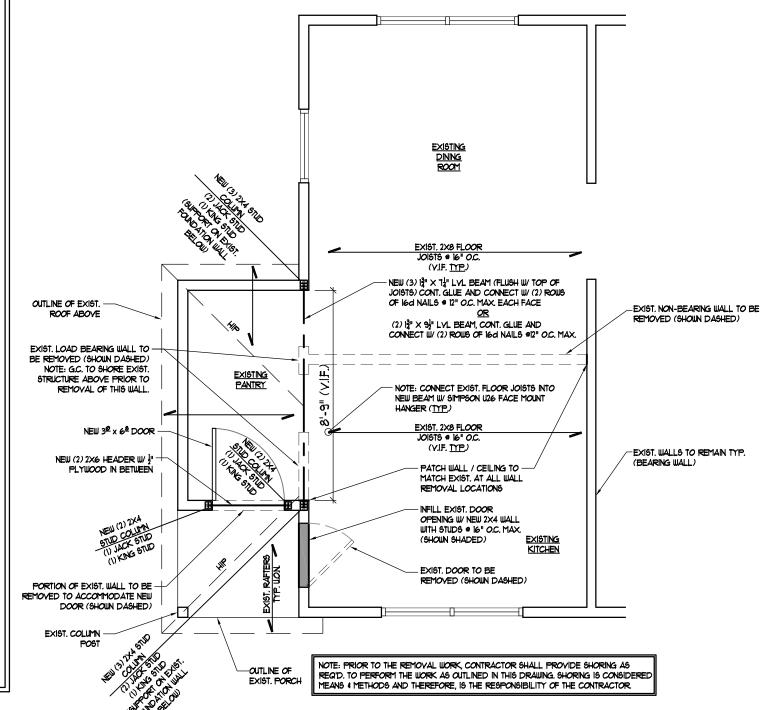

FIRST FLOOR / SECOND FLOOR & LOWER

ROOF FRAMING & REMOVALS PLAN

SCALE: 1/4"=1'-0"





Torchia Structural Engineering & Design P.C.

625 Panorama Trail Suite #2210 Rochester, NY 14625


Phone: 585-385-7630 Fax: 585-385-6386 www.TSE123.com Interior Alterations to: The Cottrell Residence







180 ALPINE DRIVE ROCHESTER, NY 14618

09/16/2022 TSE Project # 22-08-13

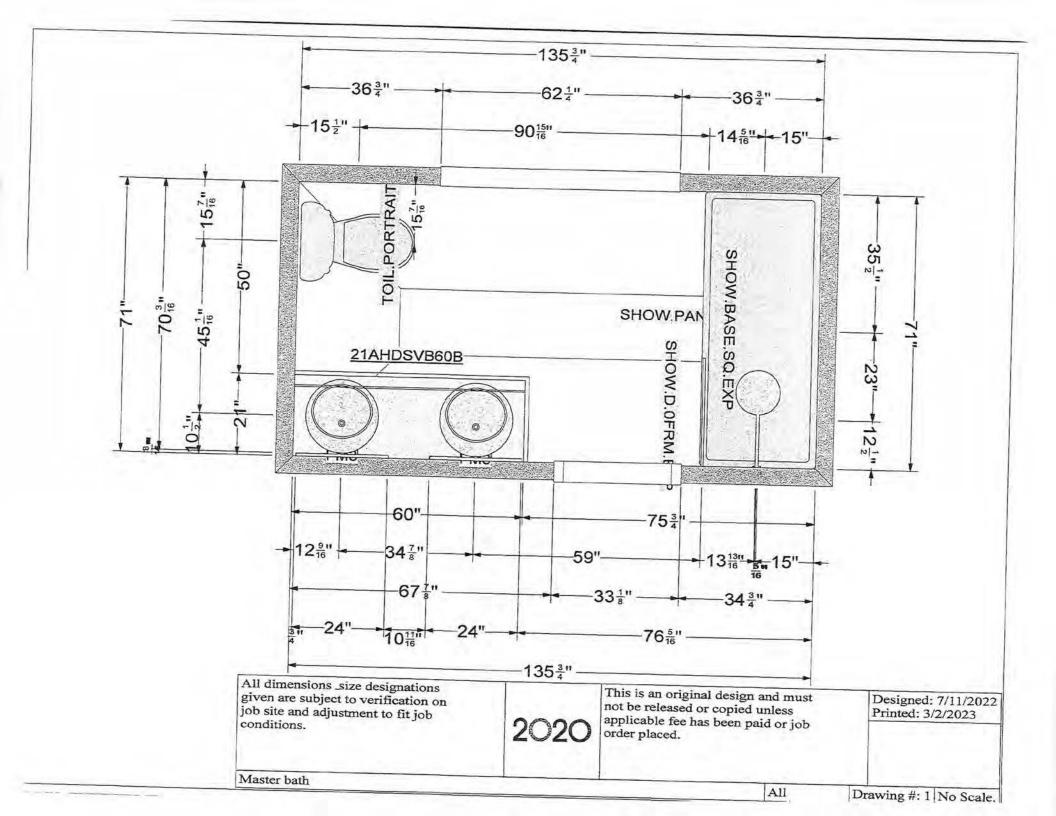

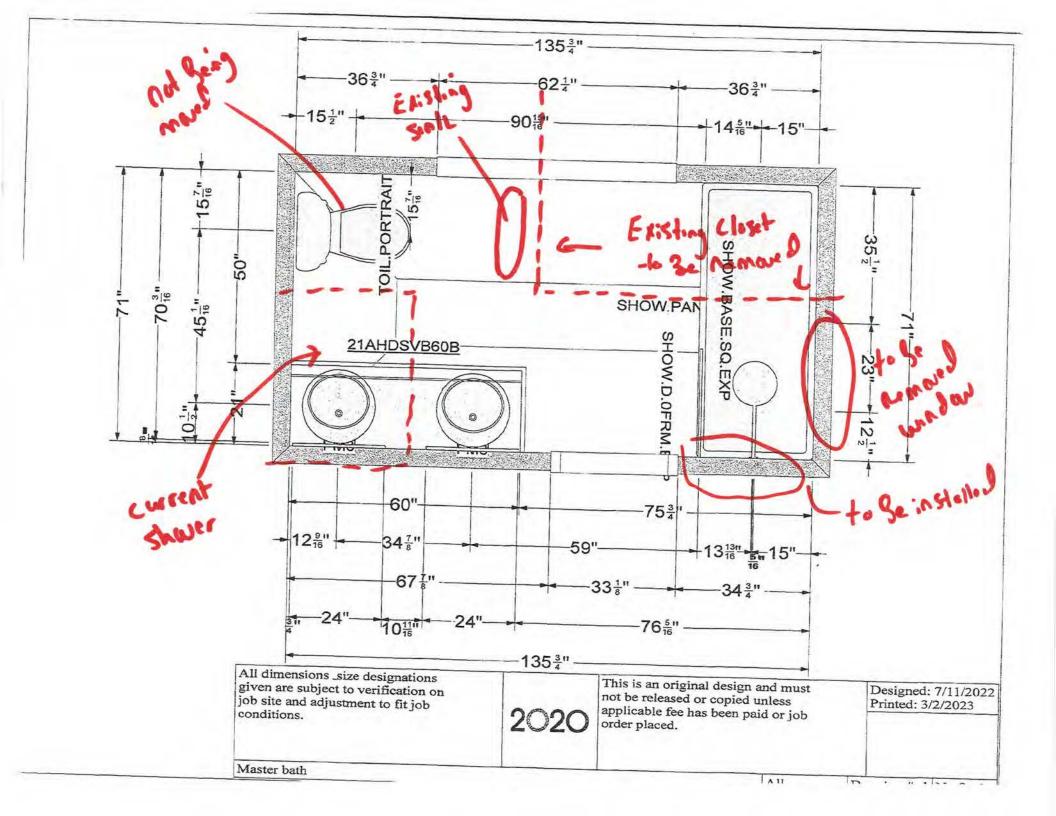

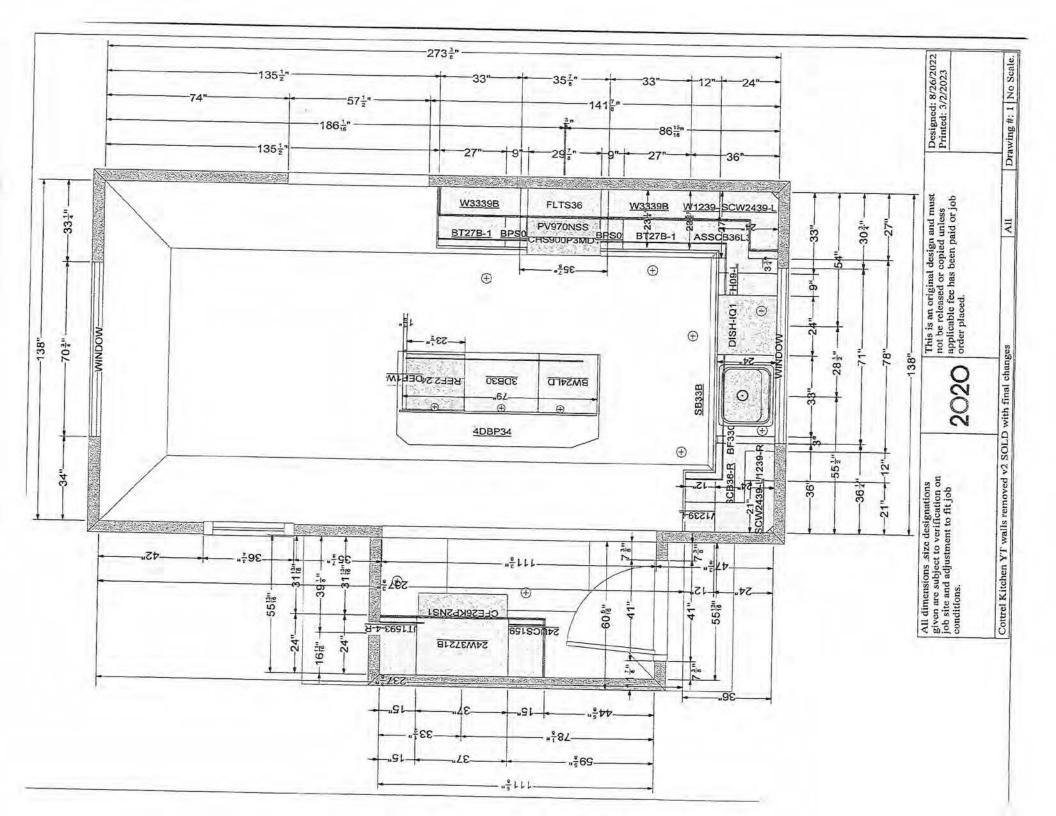

this window to & nemoved and filled, extrain to march enisting codor-shoke

Se installed here



to Se aploud with one wisher of Same size as every Side By side window

to & Replaced with "Bump-out" window; will & Stightly wider and Stightly Shorter

this Joan to Se Removed and filled in, exterior to match existing color-shoke



to be Limoved

to Se Lemon D

new door location to be lumoured





to Se Uploced will bumpout window to hit is slightly who and slightly shorter

existing side by side to

So replaced where window


that is some total size

as crising

facolin y usm

entror of enough under Sung replaced w/ Sumport dexisted above to be remared



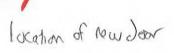



Se bemand: Filled in w/ Celar shake siding to match


to be Lemond wordow,
-k be filed in, with

Codar whole siding
-k meech

to be homored window,
to be filled in, with
codor-shake siding to
motch existing


Note: with new fince and when tree is in Stoom, neither of these handows are visible from the Street



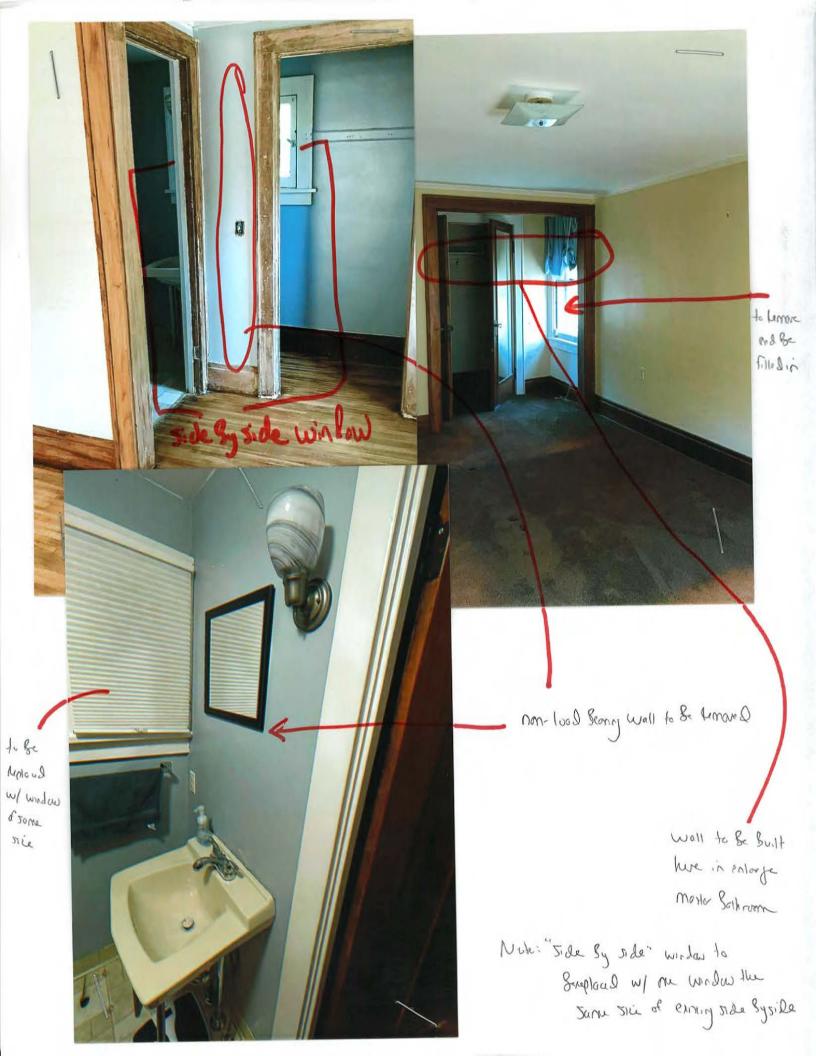

Examples of New Door Style:



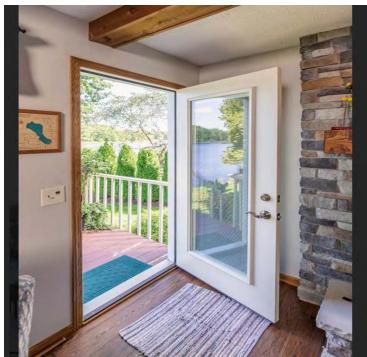






This is the style window that we are installing in the kitchen, except that the "lattice" or "grids" shown on this photo will not be on our window.



This is the style window that we are installing in the master/upstairs bathroom.

Casement and Awning

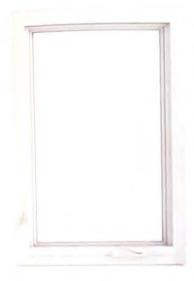

A better view for optimal performance

The Infinity Casement and Infinity Awning offer unlimited views with a slim profile and a sash that smoothly cranks open to invite the outdoors in. Our engineers optimized the design to tightly seal out wind and water for energy-efficient performance. Choose the Infinity Awning when you want to maximize light in a space that requires you to reach to open a window - especially over a kitchen sink.

Designed with Ultrex® fiberglass, the Infinity Casement and Awning feature multipoint locking systems and folding handles that tuck conveniently out of the way of most window treatments for a clean, finished look.





CASEMENT

AWNING





CLEAR VIEW HINGE




Casement hinges

The standard Easy Wash® hinge is just that - a design that lets you easily clean the window both inside and out. The optional Clear View® hinge provides for an expanded viewing area.

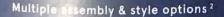

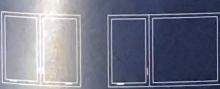

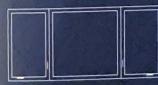

PICTURE UNIT MULL



PICTURE UNIT MULL




ROUND TOP MULL



SIMULATED CHECKRAIL

- Clear Vine, rings availability is based on window width.
 Available with matching picture window. Ask about additional assembly options for your home.

Colors and Finishes

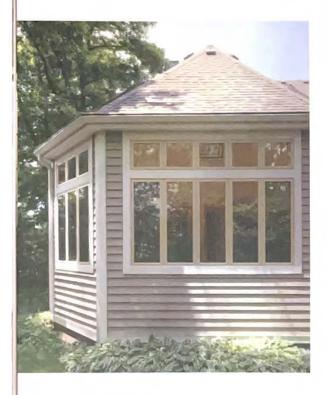

Exterior

We use a proprietary acrylic finish on our Ultrex® fiberglass that's virtually impermeable to help protect your investment from wind, weather and color fading,





Interior

We use the same acrylic finish on our interior as on our exterior for superior performance. Or choose our EverWood® option for the classic appeal of wood.



- 1. Sierra interior is not available with Ebony exterior
- 2 Bronze interior is only available with Bronze exterior.
- 5. Ebony interior is only available with Ebony exterior

Grilles and Divided Lites





Simulated Divided Lites 1

Our Simulated-Divided-Lite (SDL) bars are built with Ultrex® fiberglass. Permanently adhered in our factory to the outside surfaces of the glass, SDLs have a spacer bar between the panes of glass to offer the traditional look of divided lites.

Grilles Between the Glass 2

Located between the panes of insulating glass, Grilles-Between-the-Glass (GBG) combine easy cleaning with the timeless detail of a grille pattern.

Patterns

We offer various divided lite patterns so you can replicate the look of your original windows and doors or add new architectural interest to your home.3



STANDARD RECTANGULAR



RECTANGULAR




PRAIRIE SIX-LITE



PRAIRIE NINE-LITE




COTTAGE ONE-HIGH

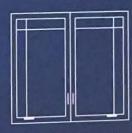

PRAIRIE FOUR-LITE ONE-HIGH



PRAIRIE SIX-LITE

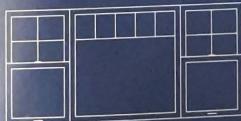

STANDARD RECTANGULAR



STANDARD COTTAGE RECTANGULAR ONE-HIGH



OPEN HUB SUNBURST



CLOSED HUB SUNBURST

^{2.} Infinity GBGs a

o your window or door's interior and exterior. I style options.



Town of Pittsford

Department of Public Works 11 South Main Street Pittsford, New York 14534

Permit # B23-000026

Phone: 585-248-6250 FAX: 585-248-6262

DESIGN REVIEW AND HISTORIC PRESERVATION BOARD REFERRAL OF APPLICATION

Property Address: 6 Black Wood Circle PITTSFORD, NY 14534

Tax ID Number: 178.03-5-28

Zoning District: IZ Incentive Zoning

Owner: Wilshire Hill LLC **Applicant:** Pride Mark Homes


Application Type	IVDE	II IY	UH	ľ	u	a	C	111	ν	b	м
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ppiication	rype:	
~//	ntial Design Review 205 (B)	Build to Line Adjustment §185-17 (B) (2)
Comme	ercial Design Review 205 (B)	Building Height Above 30 Feet §185-17 (M)
Signage	· ,	Corner Lot Orientation §185-17 (K) (3)
Certifica §185-	ate of Áppropriateness 197	Flag Lot Building Line Location §185-17 (L) (1) (c)
	ark Designation 195 (2)	Undeveloped Flag Lot Requirements §185-17 (L) (2)
•	al Review	


Project Description: Applicant is requesting design review for the construction of an approximately 2036 SF new single story family home in the Wilshire Hill subdivision

Meeting Date: March 23, 2023

RN Residential Neighborhood Zoning

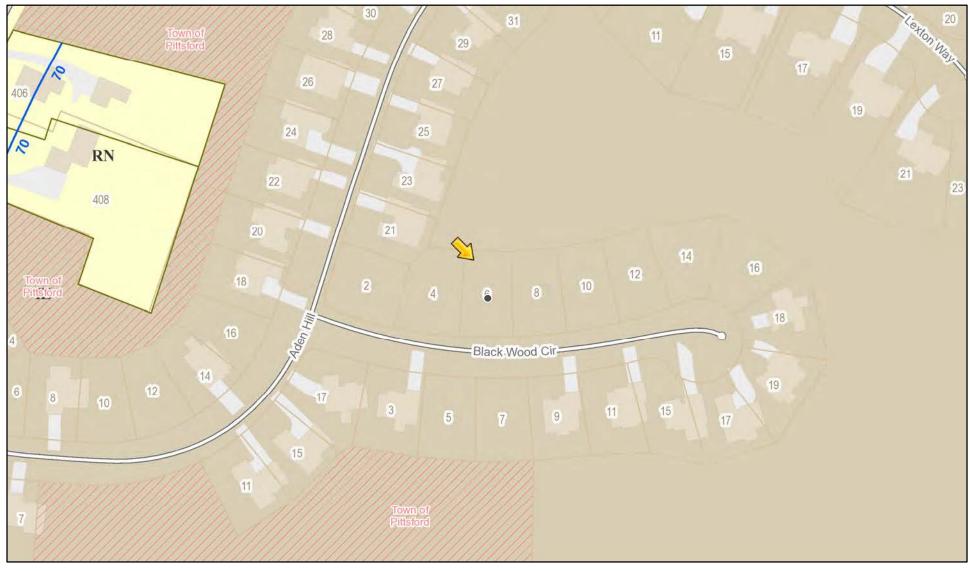


Printed March 7, 2023

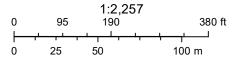

Town of Pittsford GIS

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ROCHESTER LOCATION
3 9 CASCADE DRIVE
ROCHESTER, NY 14614
5 8 5 - 4 5 8 - 7 7 0
11HACALOCATION
840 HANSHAW RD, STE 12
1THACA, NY 14850
6 0 7 - 2 4 1 - 2 9 1 7

JOB NO: 0423-17 1" = 20' SCALE: DRAWN: RJT DESIGNED: RJT DATE:

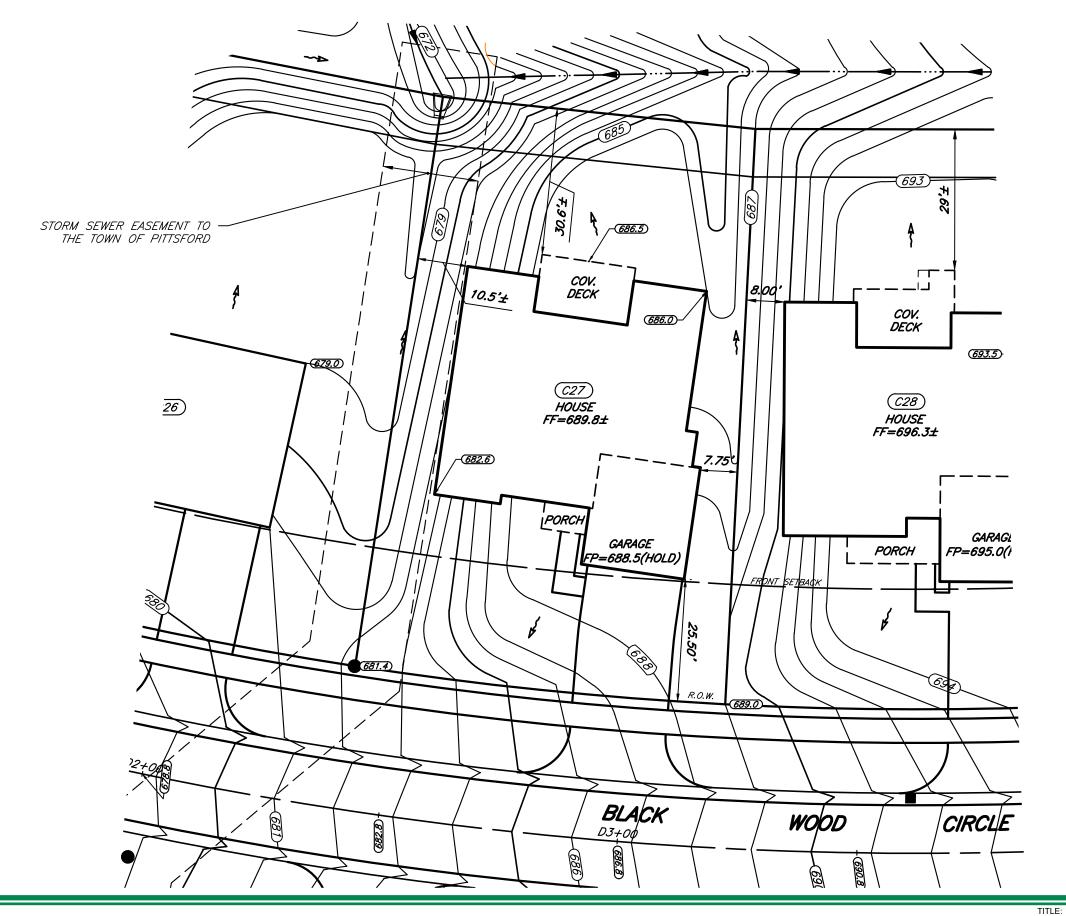SETBACK	REQUIRED	PROVIDED
FRONT	25'	25.50'
SIDE	7.5'	7.75'
REAR	10'	30.6+' ±

PLOT PLAN - LOT C27

WILSHIRE HILL - SECTION 3

DESIGN CRITERIA:

-For Greater Rochester Area and surrounding counties.

IST & 2ND FLOOR LIVING AREA LIVE LOAD 40 PSF SLEEPING AND ATTIC AREA LIVE LOAD 30 PSF FLOOR DEAD LOAD 15 PSF 40 PSF GROUND SNOW LOAD ROOF DEAD LOAD 10 PSF

ALLOWABLE SOIL BEARING 2500 PSF AT MINIMUM 42" BELOW FINISHED GRADE

WIND SPEED 115 MPH, EXPOSURE B CATEGORY B SEISMIC DESIGN WEATHERING SEVERE

FROST DEPTH LINE 42 INCHES


TERMITE DAMAGE SLIGHT TO MODERATE NONE TO SLIGHT DECAY DAMAGE WINTER DESIGN TEMPERATURE I DEGREE

ICE SHIELD UNDERLAYMENT REQUIRED 24" INSIDE OF EXTERIOR WALL LINE

FLOOD HAZARD FIRM - 1992

ROOF TIE DOWN REQUIREMENTS R802.11, BASED UPON


SPECIFIC ROOF DESIGN

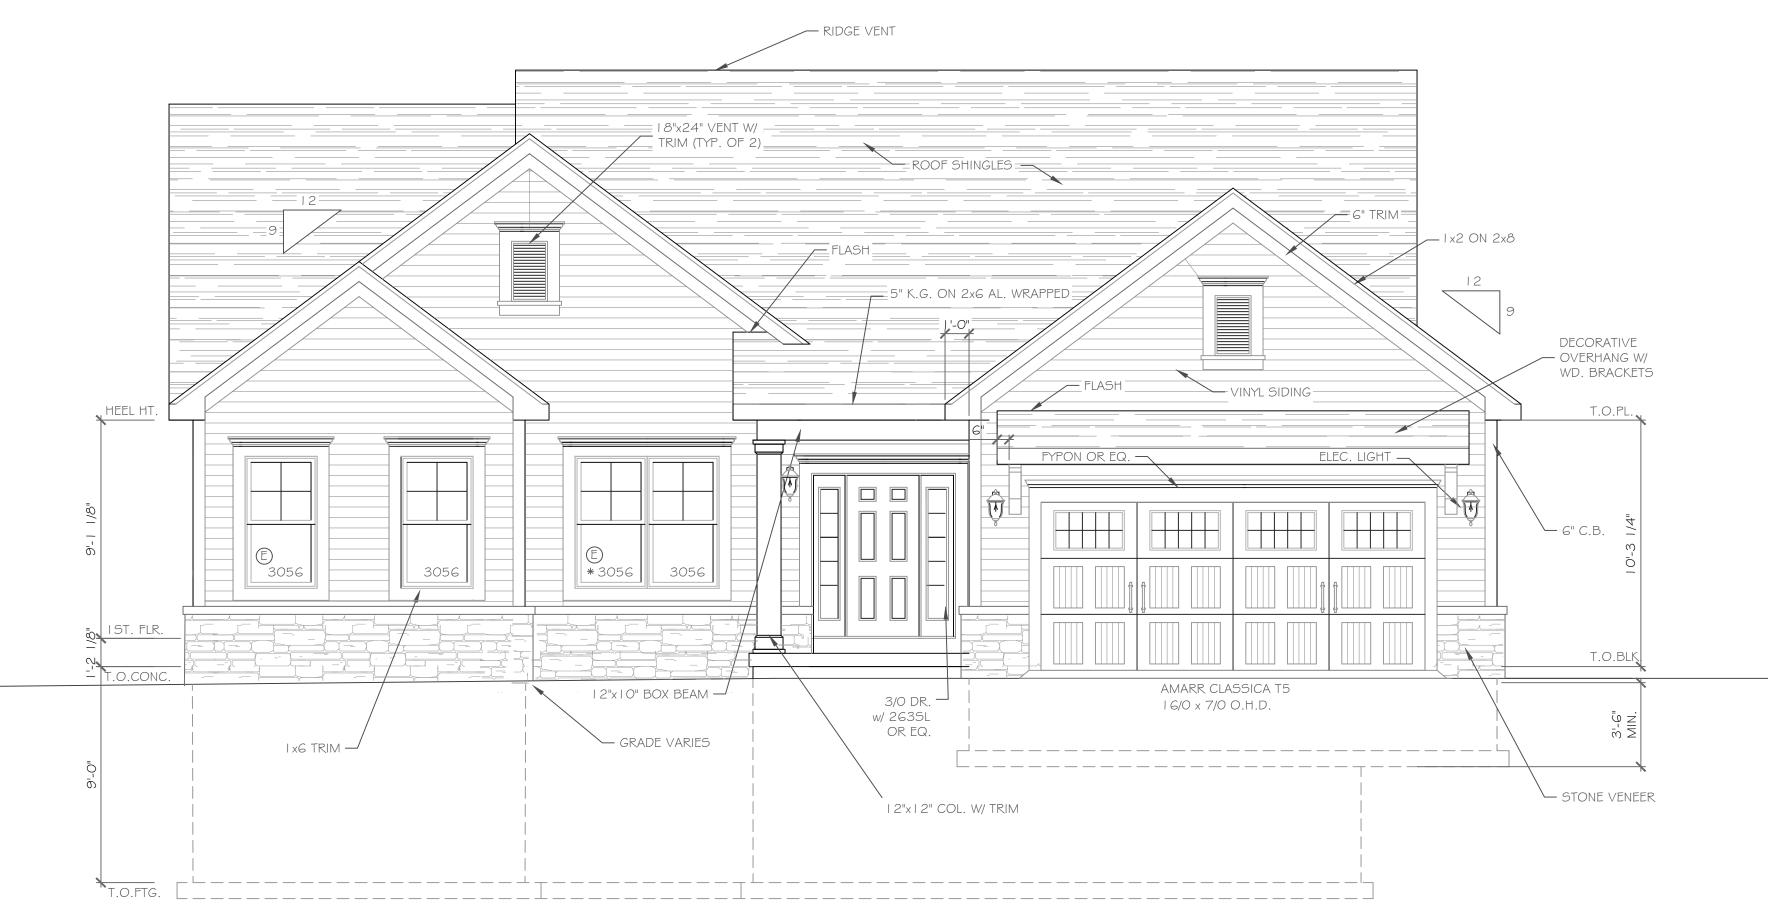

FRONT ELEVATION

2036 S.F.


NOTE: - WINDOWS TO BE "GREAT LAKES" DOUBLE-HUNG OR EQUAL - DOORS TO BE "THERMA-TRU" OR EQ. - DOWN SPOUTS TO BE LOCATED BY CONTRACTOR IN FIELD -(E): WINDOW MEETS OR EXCEEDS THE EGRESS REQUIREMENTS PER SECTION R3 I O OF THE RES. CODE OF NYS - * : SAFETY GLASS REQ. PER SECTION R308.4 OF THE RES. CODE OF NYS

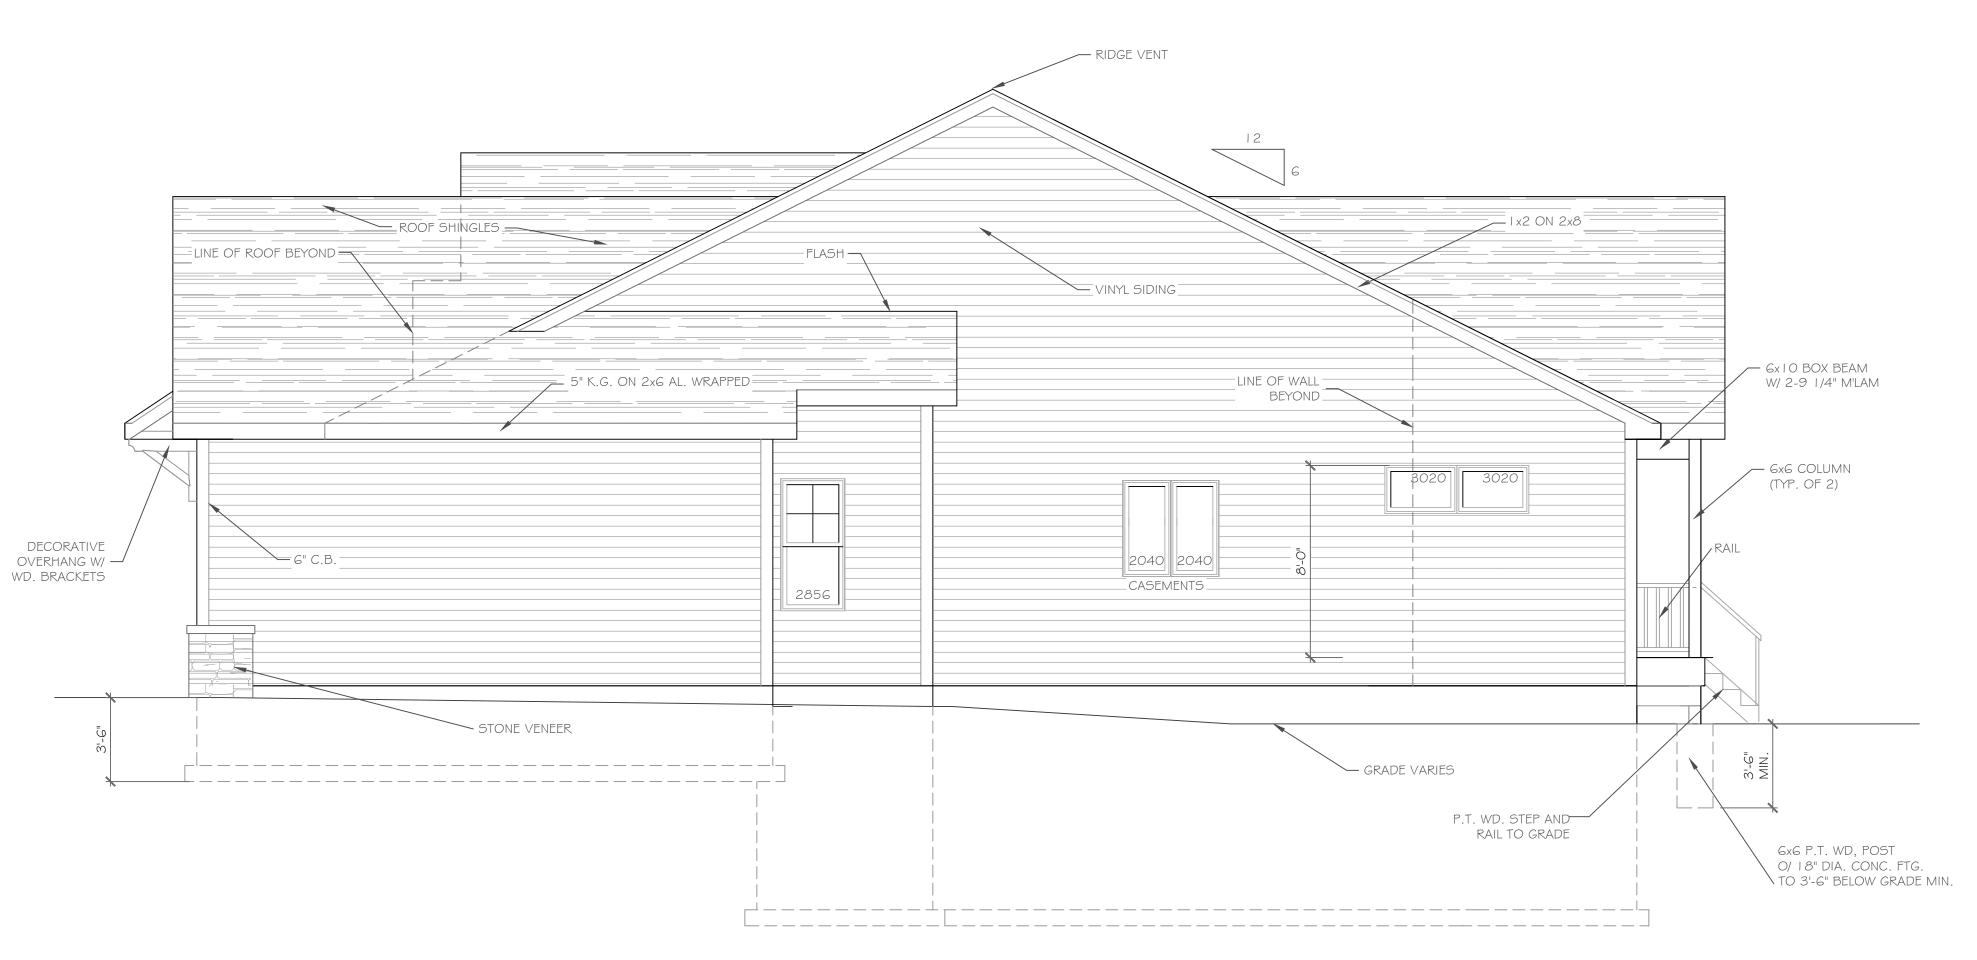



SCALE: 1/4"=1'-0"

Wilshire Hill New York

DRAWING NO.-

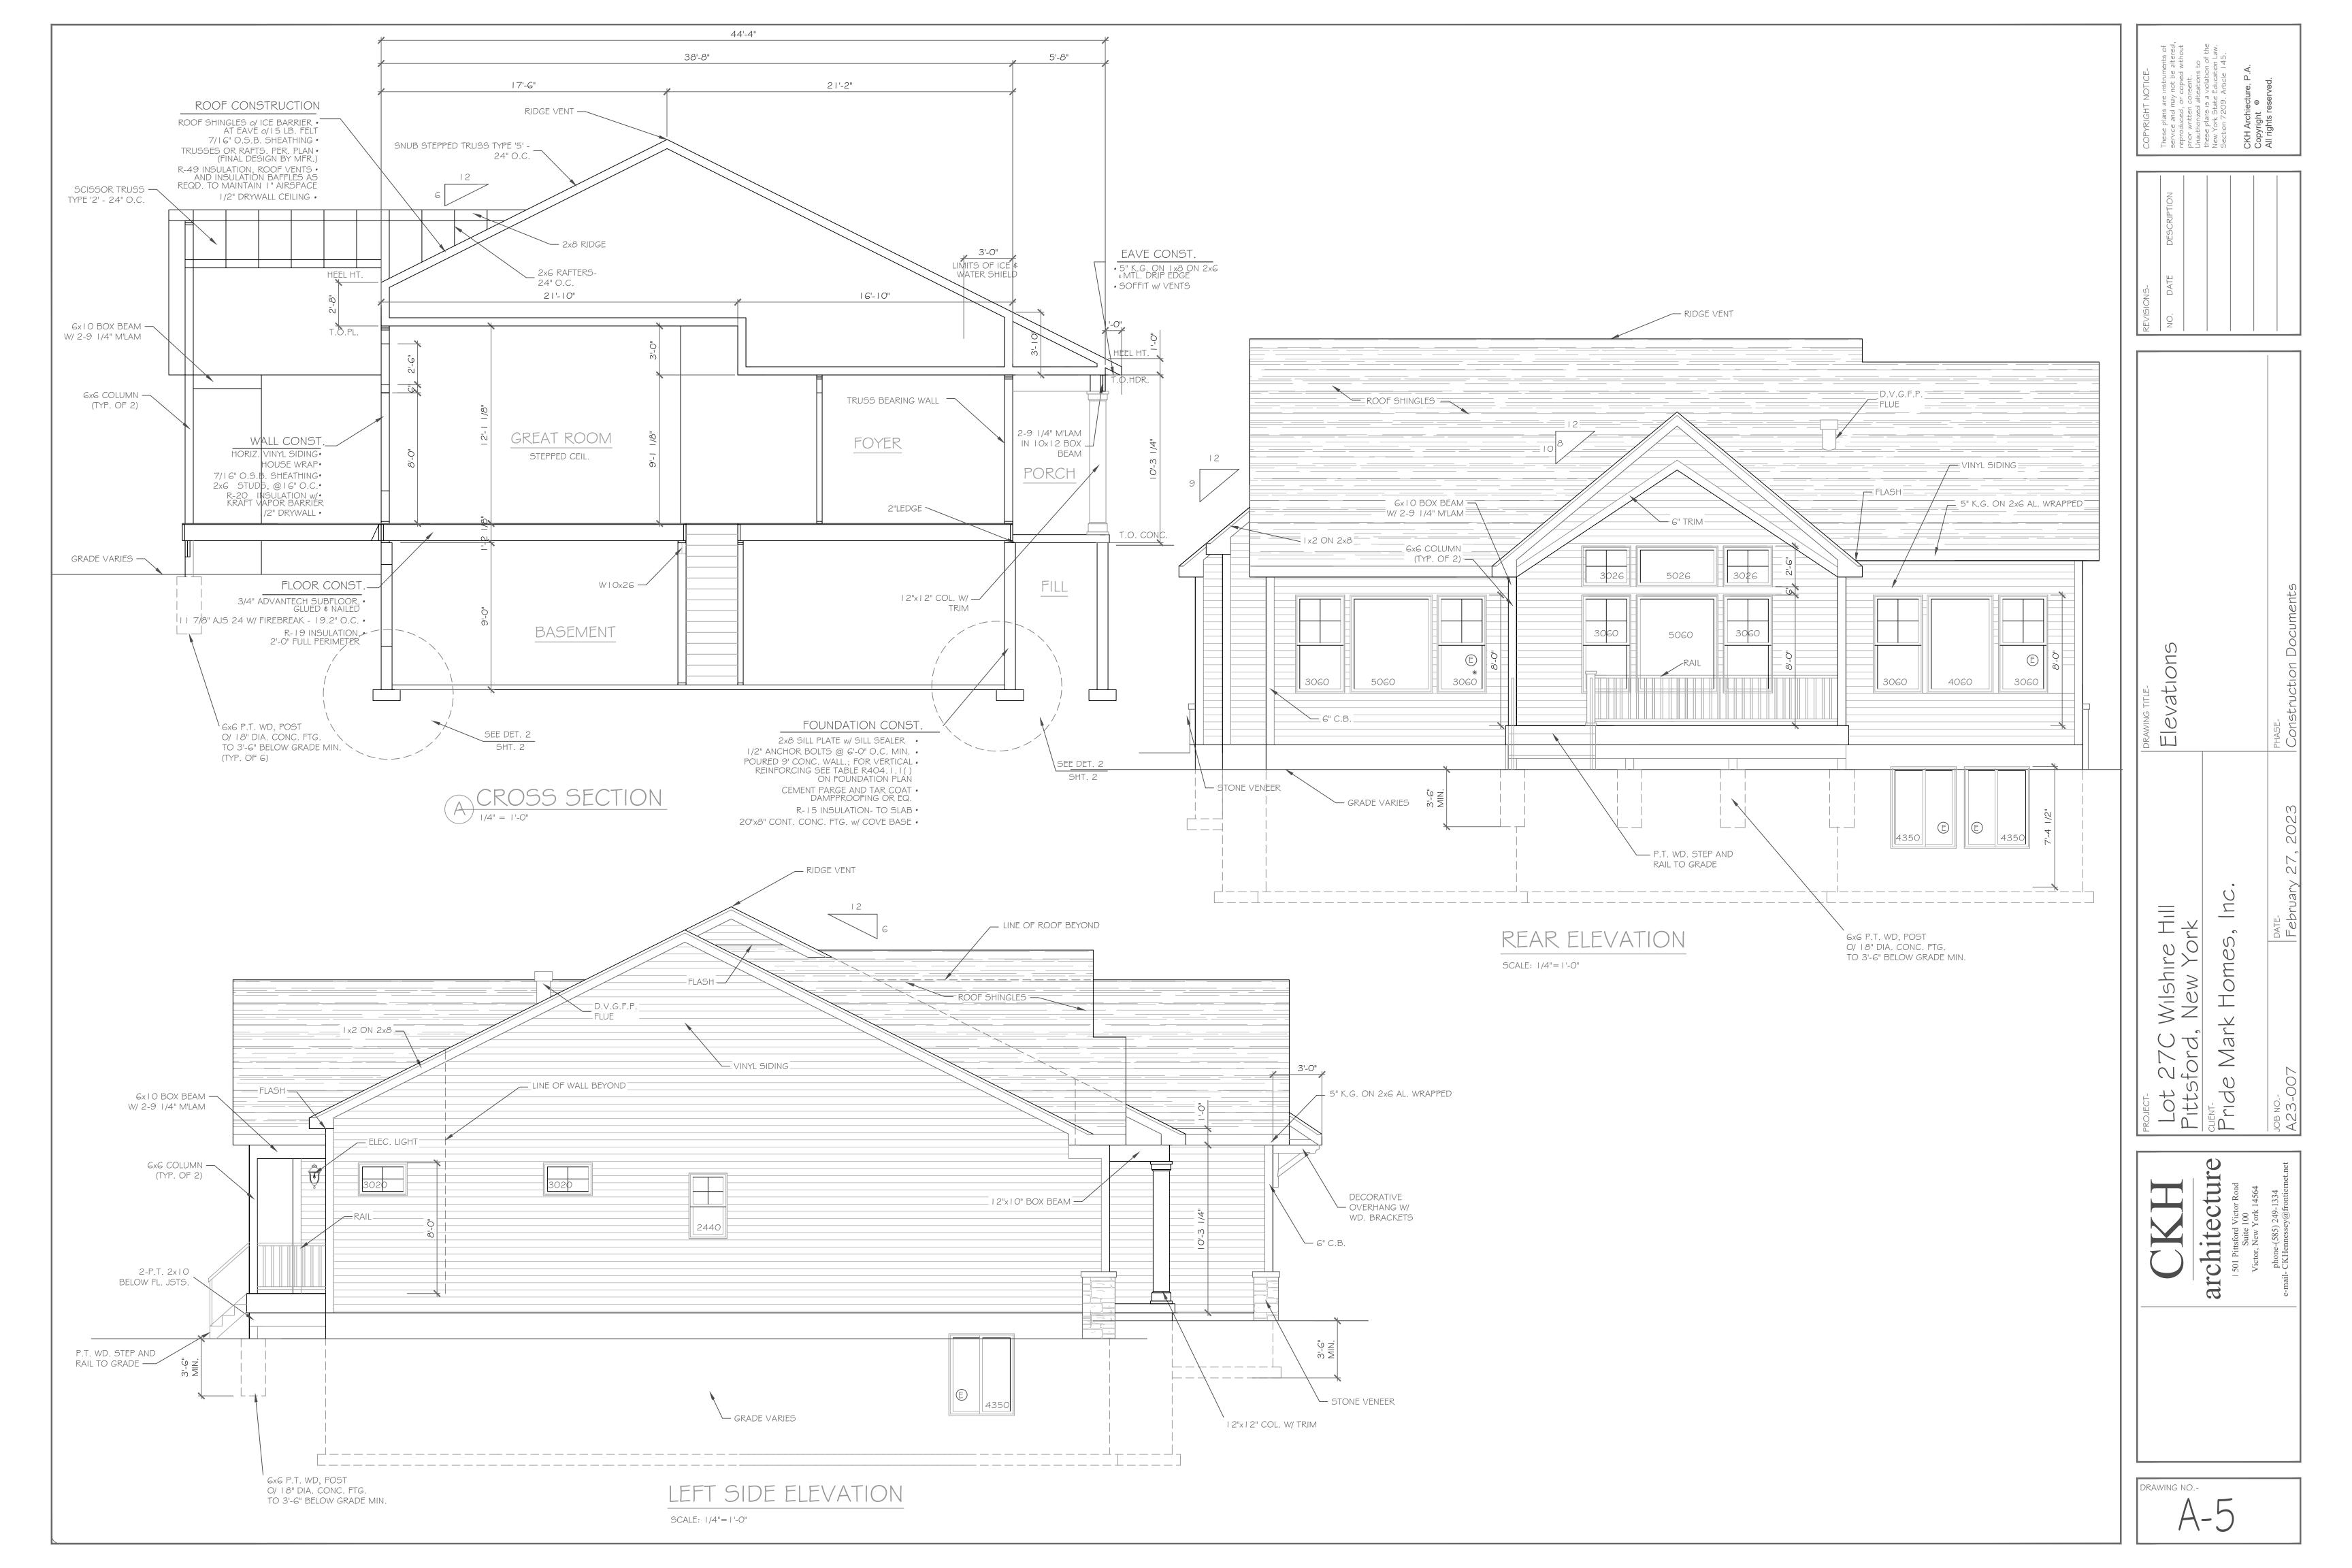

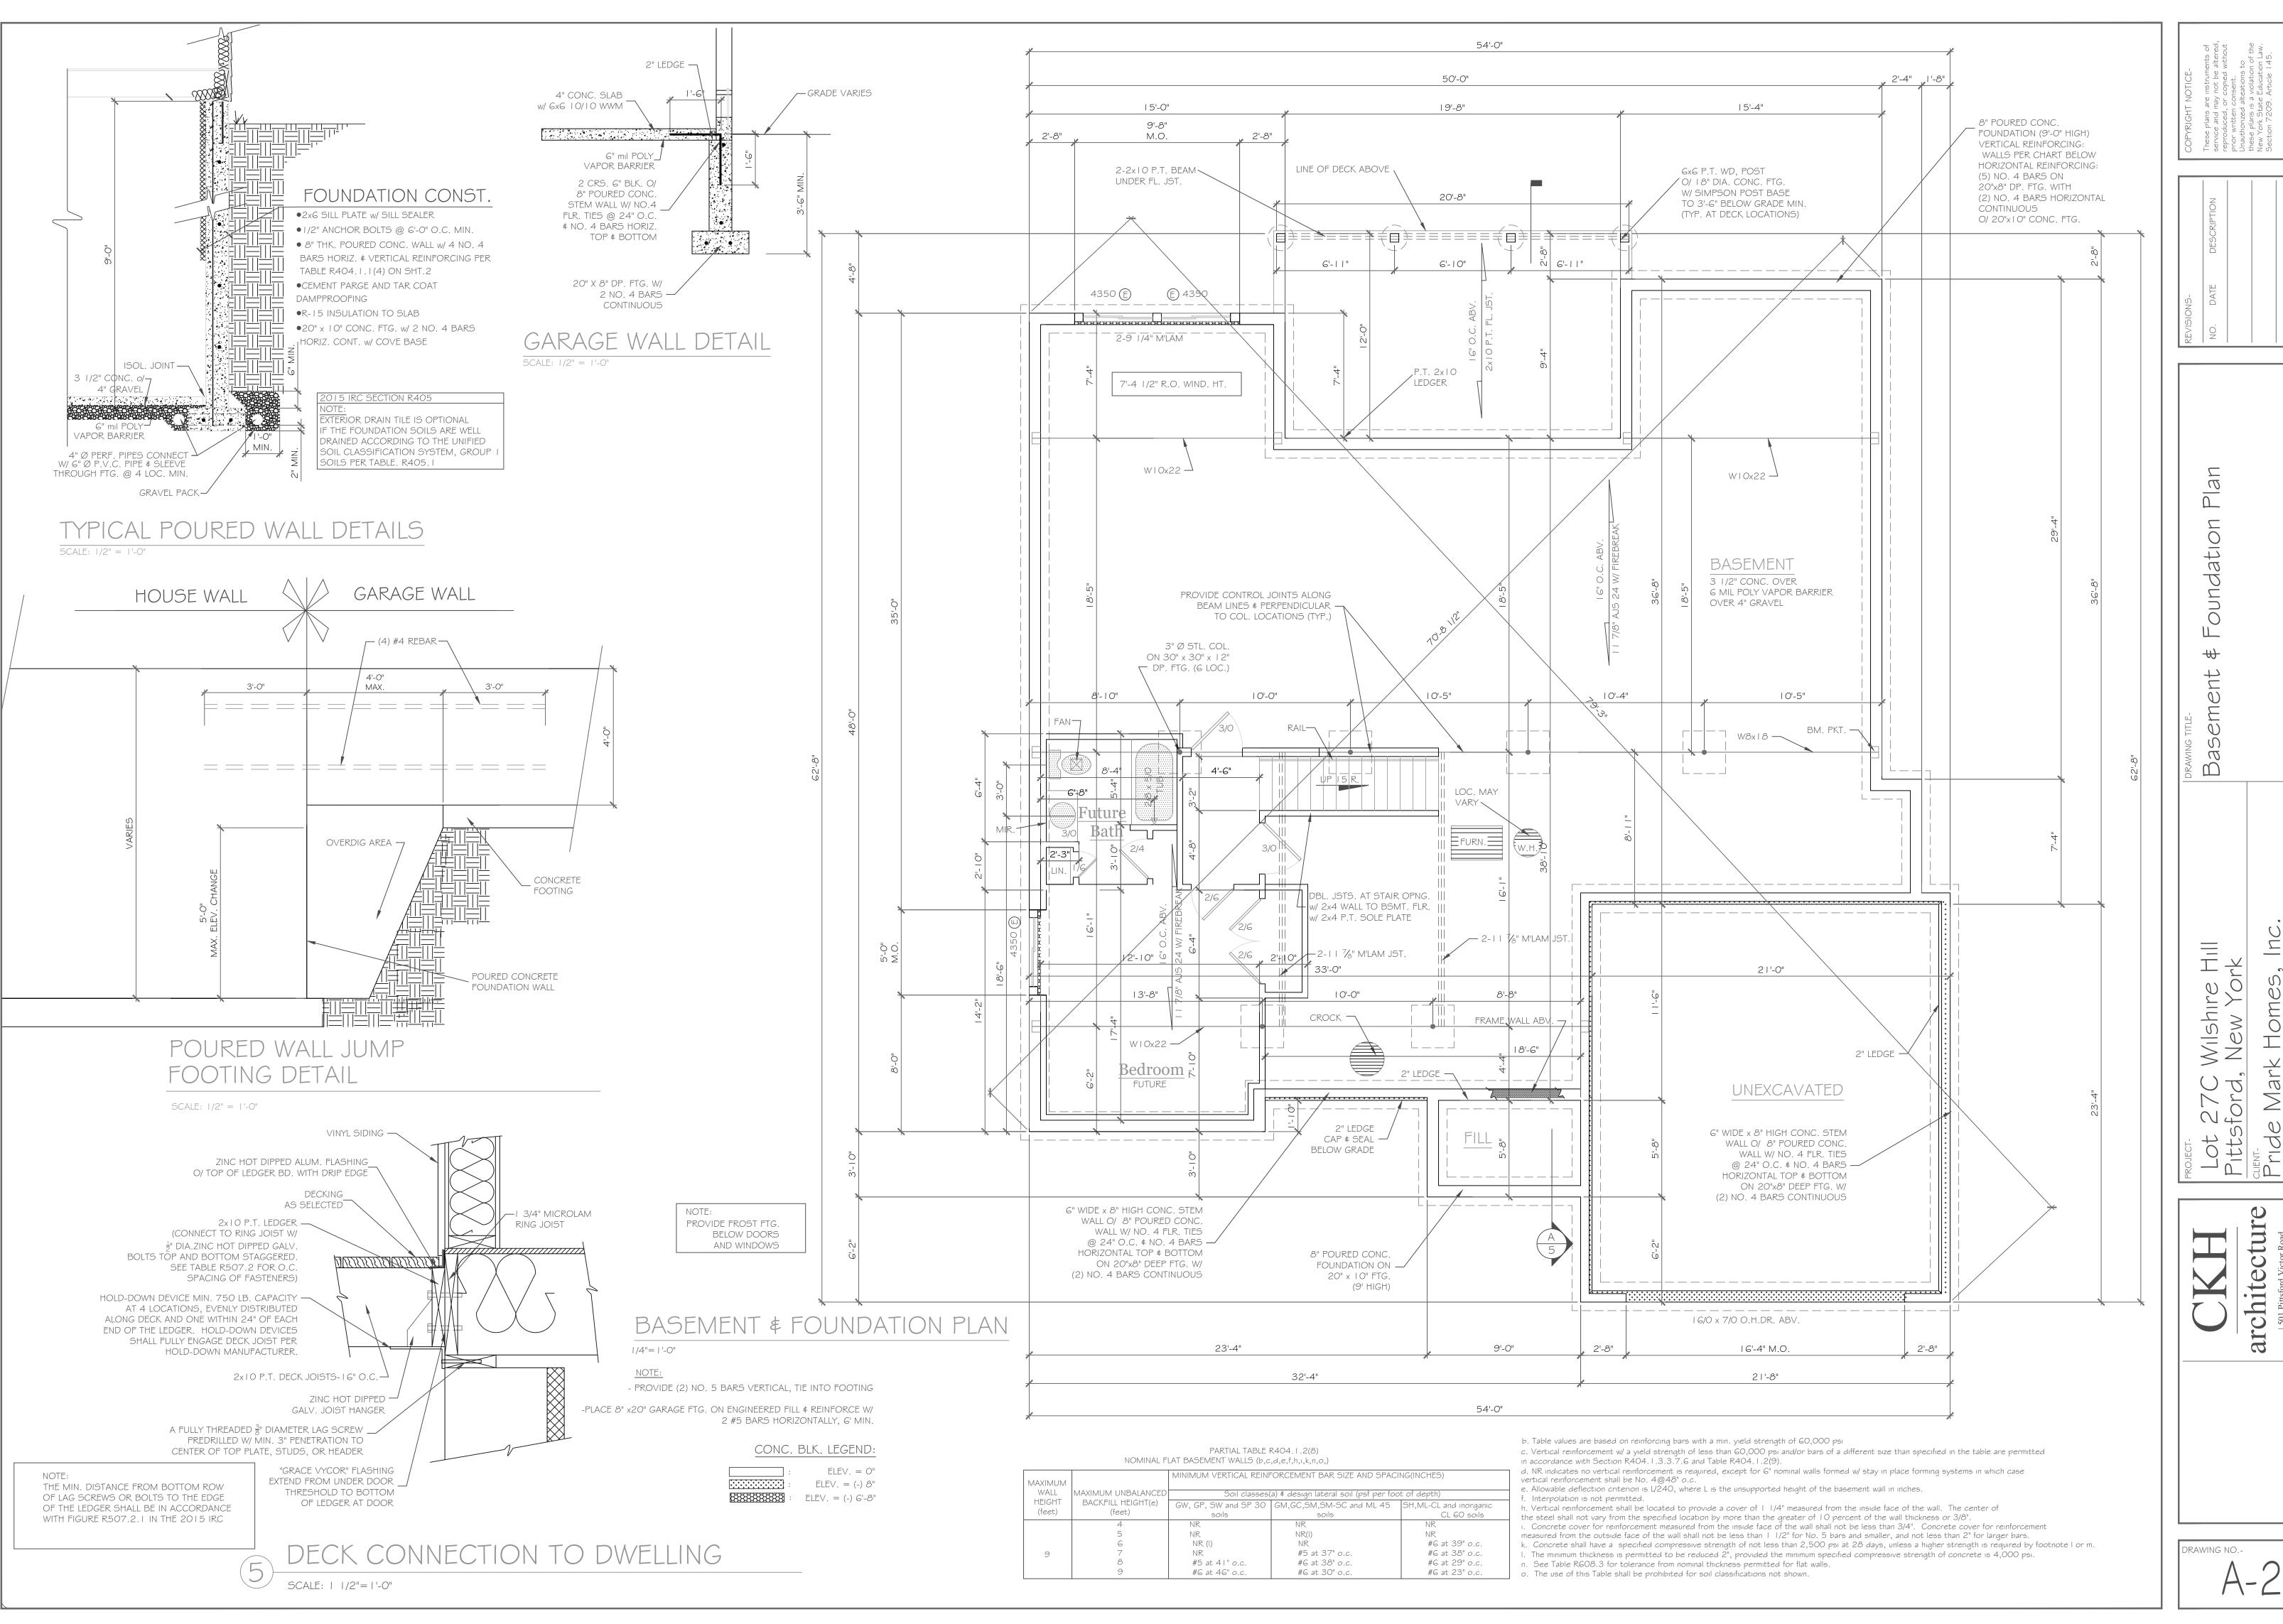

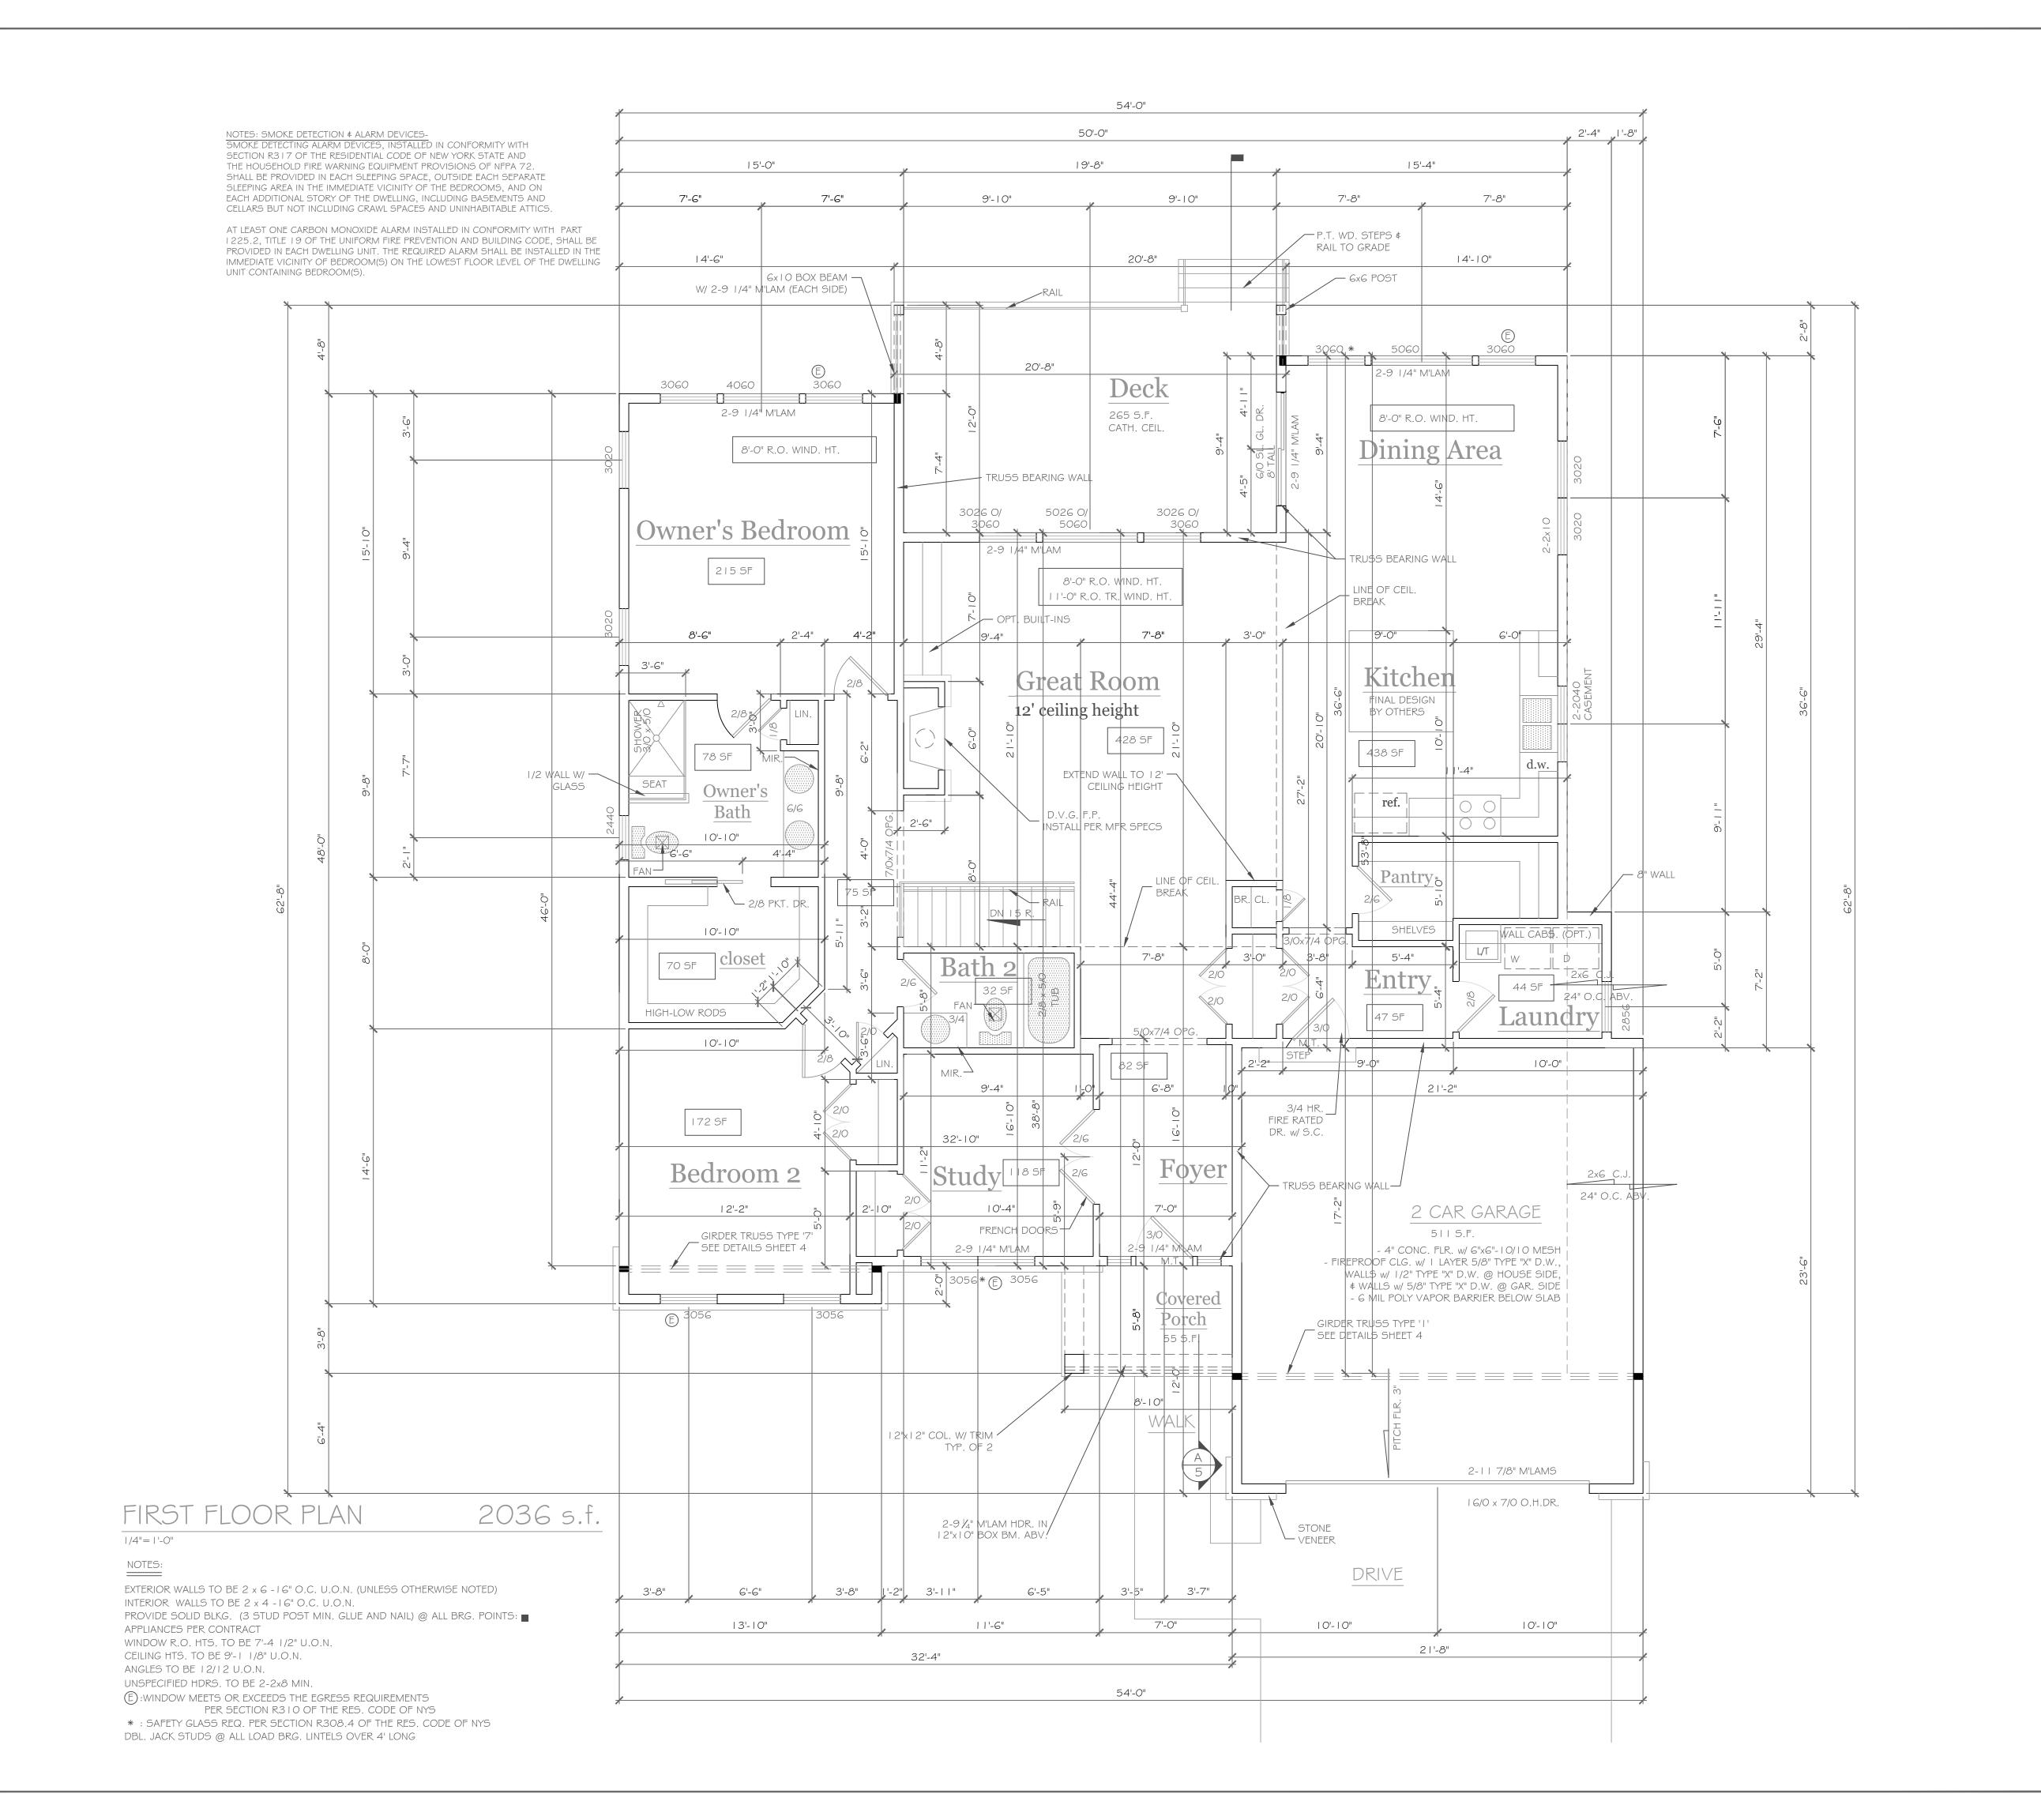

 $\frac{\overline{\Box}}{\underline{\Box}}$

Wilshire Hill 4, New York

t 27C sford,


Pitts Pride

DRAWING NO.-







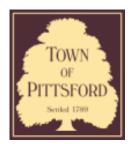

Town of Pittsford

Department of Public Works 11 South Main Street Pittsford, New York 14534

Permit # B23-000037

Phone: 585-248-6250 FAX: 585-248-6262

DESIGN REVIEW AND HISTORIC PRESERVATION BOARD REFERRAL OF APPLICATION

Property Address: 10 Aden Hill PITTSFORD, NY 14534

Tax ID Number: 178.03-4-56

Zoning District: IZ Incentive Zoning

Owner: Wilshire Hill LLC Applicant: Pride Mark Homes


Application Type	Э	е
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'nμ	neation type.	
~	Residential Design Review §185-205 (B)	Build to Line Adjustment §185-17 (B) (2)
	Commercial Design Review §185-205 (B)	Building Height Above 30 Feet §185-17 (M)
	Signage §185-205 (C)	Corner Lot Orientation §185-17 (K) (3)
	Certificate of Appropriateness §185-197	Flag Lot Building Line Location §185-17 (L) (1) (c)
	Landmark Designation §185-195 (2)	Undeveloped Flag Lot Requirements §185-17 (L) (2)
	Informal Review	


Project Description: Applicant is requesting design review for the construction of an approximately 2040 SF new single story family home in the Wilshire Hill subdivision

Meeting Date: March 23, 2023

RN Residential Neighborhood Zoning

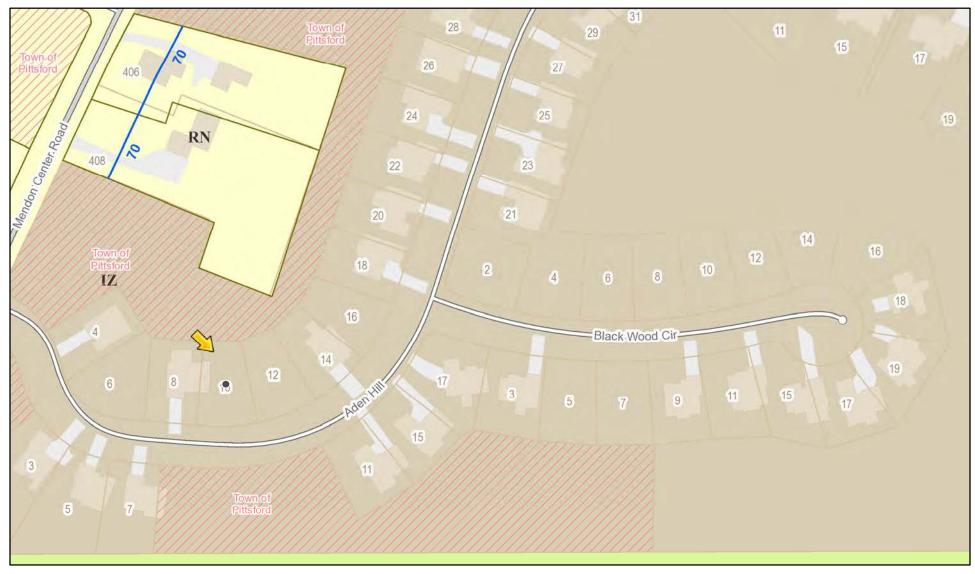


Printed March 16, 2023

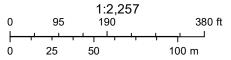

Town of Pittsford GIS

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ROCHESTER LOCATION

3 9 C A S C A D E D R I V E
ROCHESTER, NY 14614
5 8 5 - 4 5 8 - 7 7 7 0
ITHACA LOCATION
840 HANSHAW RD, STE 12
ITHA C A, NY 14850
6 0 7 - 2 4 1 - 2 9 1 7 www.marathoneng.com JOB NO: 0423-13 SCALE: 1" = 20' DRAWN: RJT DESIGNED: DATE: 4/26/22 REVISED:

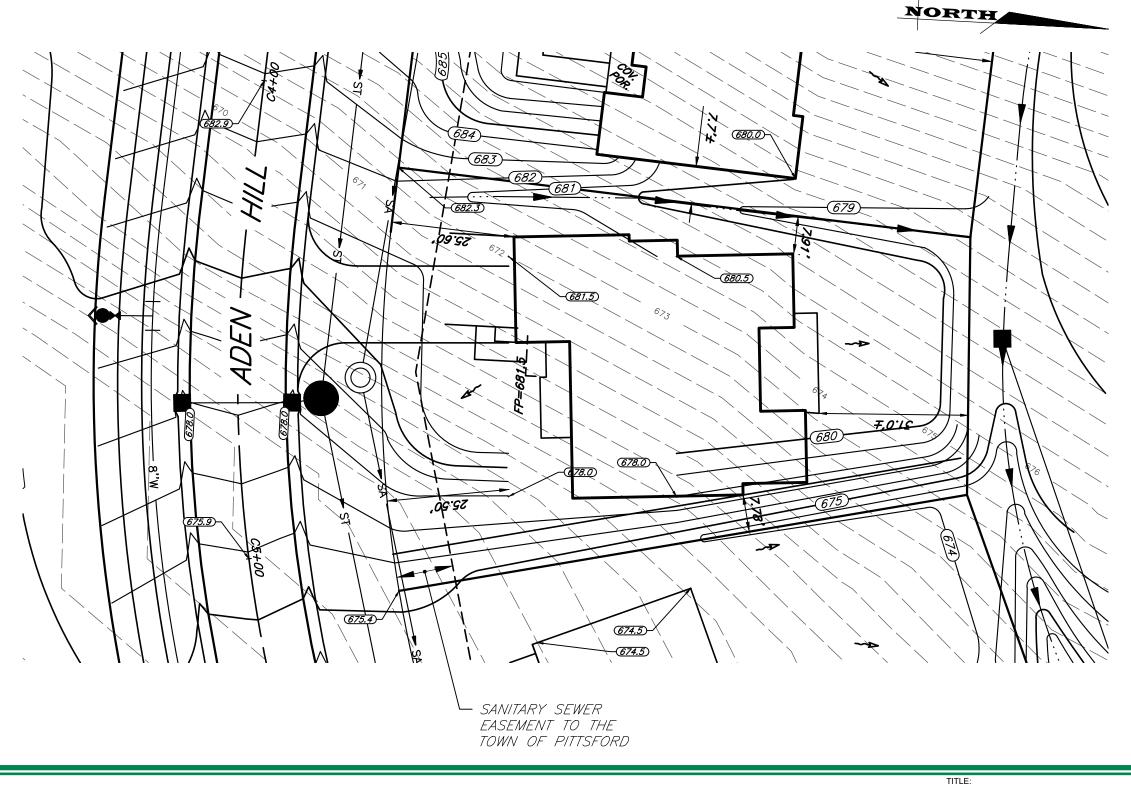SETBACK REQUIRED PROVIDED FRONT 25' TBD SIDE 7.5' TBD REAR 20' TBD

PLOT PLAN - LOT C4 WILSHIRE HILL - SECTION 2

DESIGN CRITERIA:

-For Greater Rochester Area and surrounding counties.

SEISMIC DESIGN

WINTER DESIGN TEMPERATURE

IST \$ 2ND FLOOR LIVING AREA LIVE LOAD

40 PSF

SLEEPING AND ATTIC AREA LIVE LOAD

70 PSF

FLOOR DEAD LOAD

15 PSF

GROUND SNOW LOAD

40 PSF

10 PSF

ALLOWABLE SOIL BEARING
2500 PSF AT MINIMUM
42" BELOW FINISHED GRADE

WIND SPEED 115 MPH, EXPOSURE B

WEATHERING SEVERE
FROST DEPTH LINE 42 INCHES

TERMITE DAMAGE SLIGHT TO MODERATE

DECAY DAMAGE NONE TO SLIGHT

ICE SHIELD UNDERLAYMENT REQUIRED 24" INSIDE OF

EXTERIOR WALL LINE


FLOOD HAZARD FIRM - 1992

ROOF TIE DOWN REQUIREMENTS

R802.1 I, BASED UPON
SPECIFIC ROOF DESIGN

CATEGORY B

I DEGREE

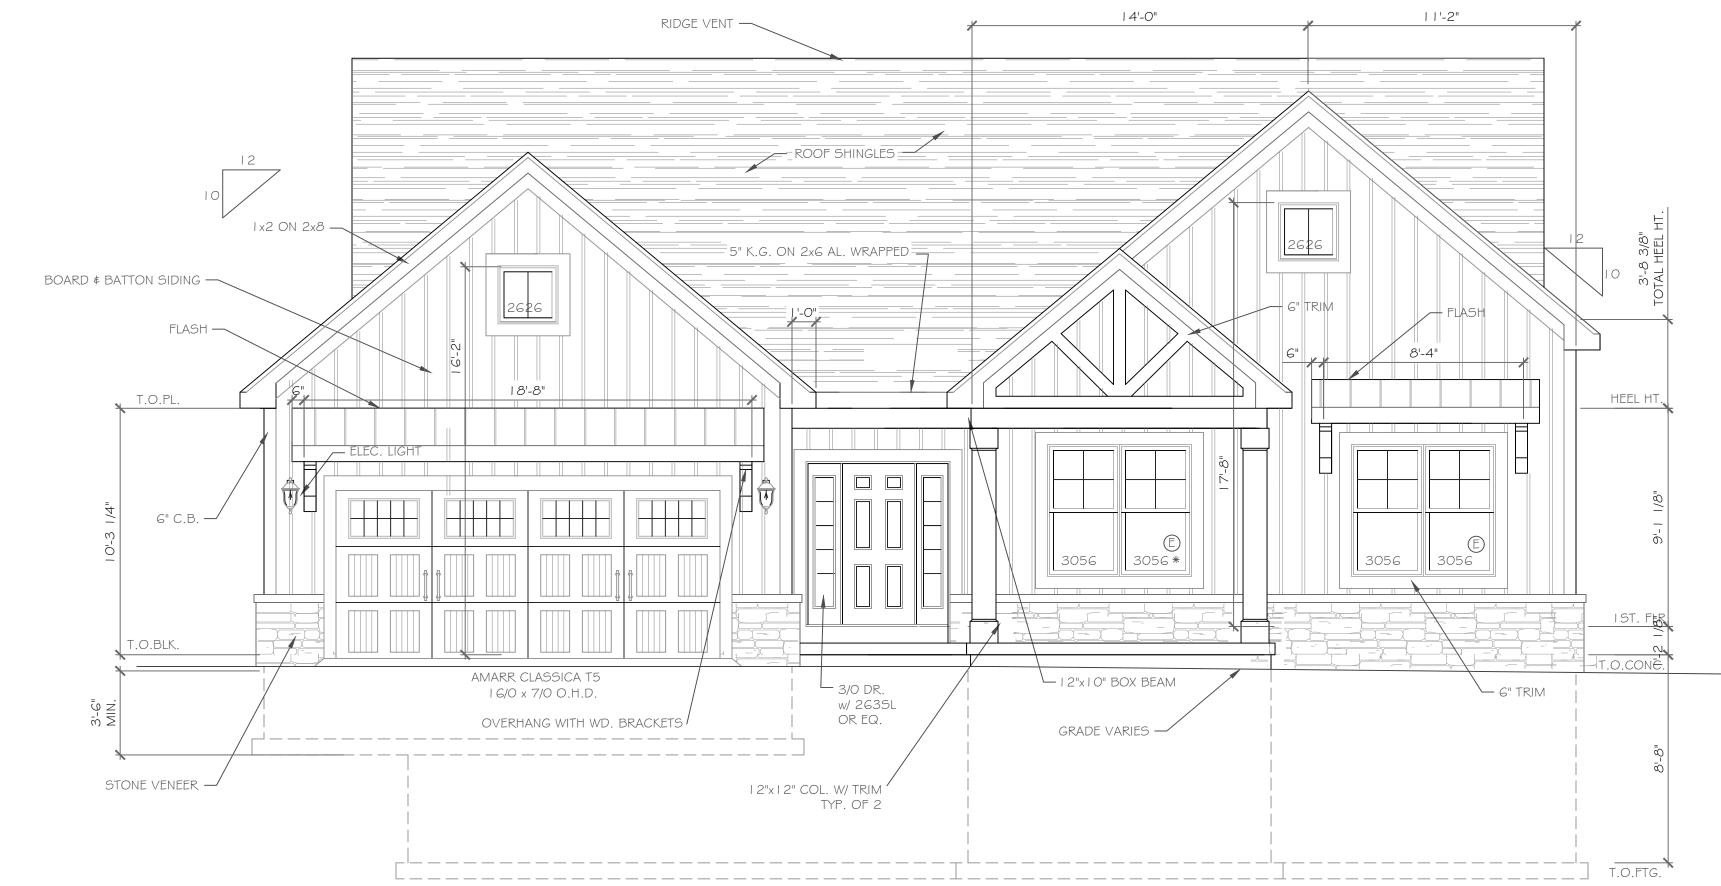


FRONT ELEVATION


2040 S.F.

NOTE: - WINDOWS TO BE "GREAT LAKES" DOUBLE-HUNG OR EQUAL - DOORS TO BE "THERMA-TRU" OR EQ.

- DOWN SPOUTS TO BE LOCATED BY CONTRACTOR IN FIELD
-E: WINDOW MEETS OR EXCEEDS THE EGRESS REQUIREMENTS

PER SECTION R3 I O OF THE RES. CODE OF NYS
- *: SAFETY GLASS REQ. PER SECTION R308.4 OF THE RES. CODE OF NYS

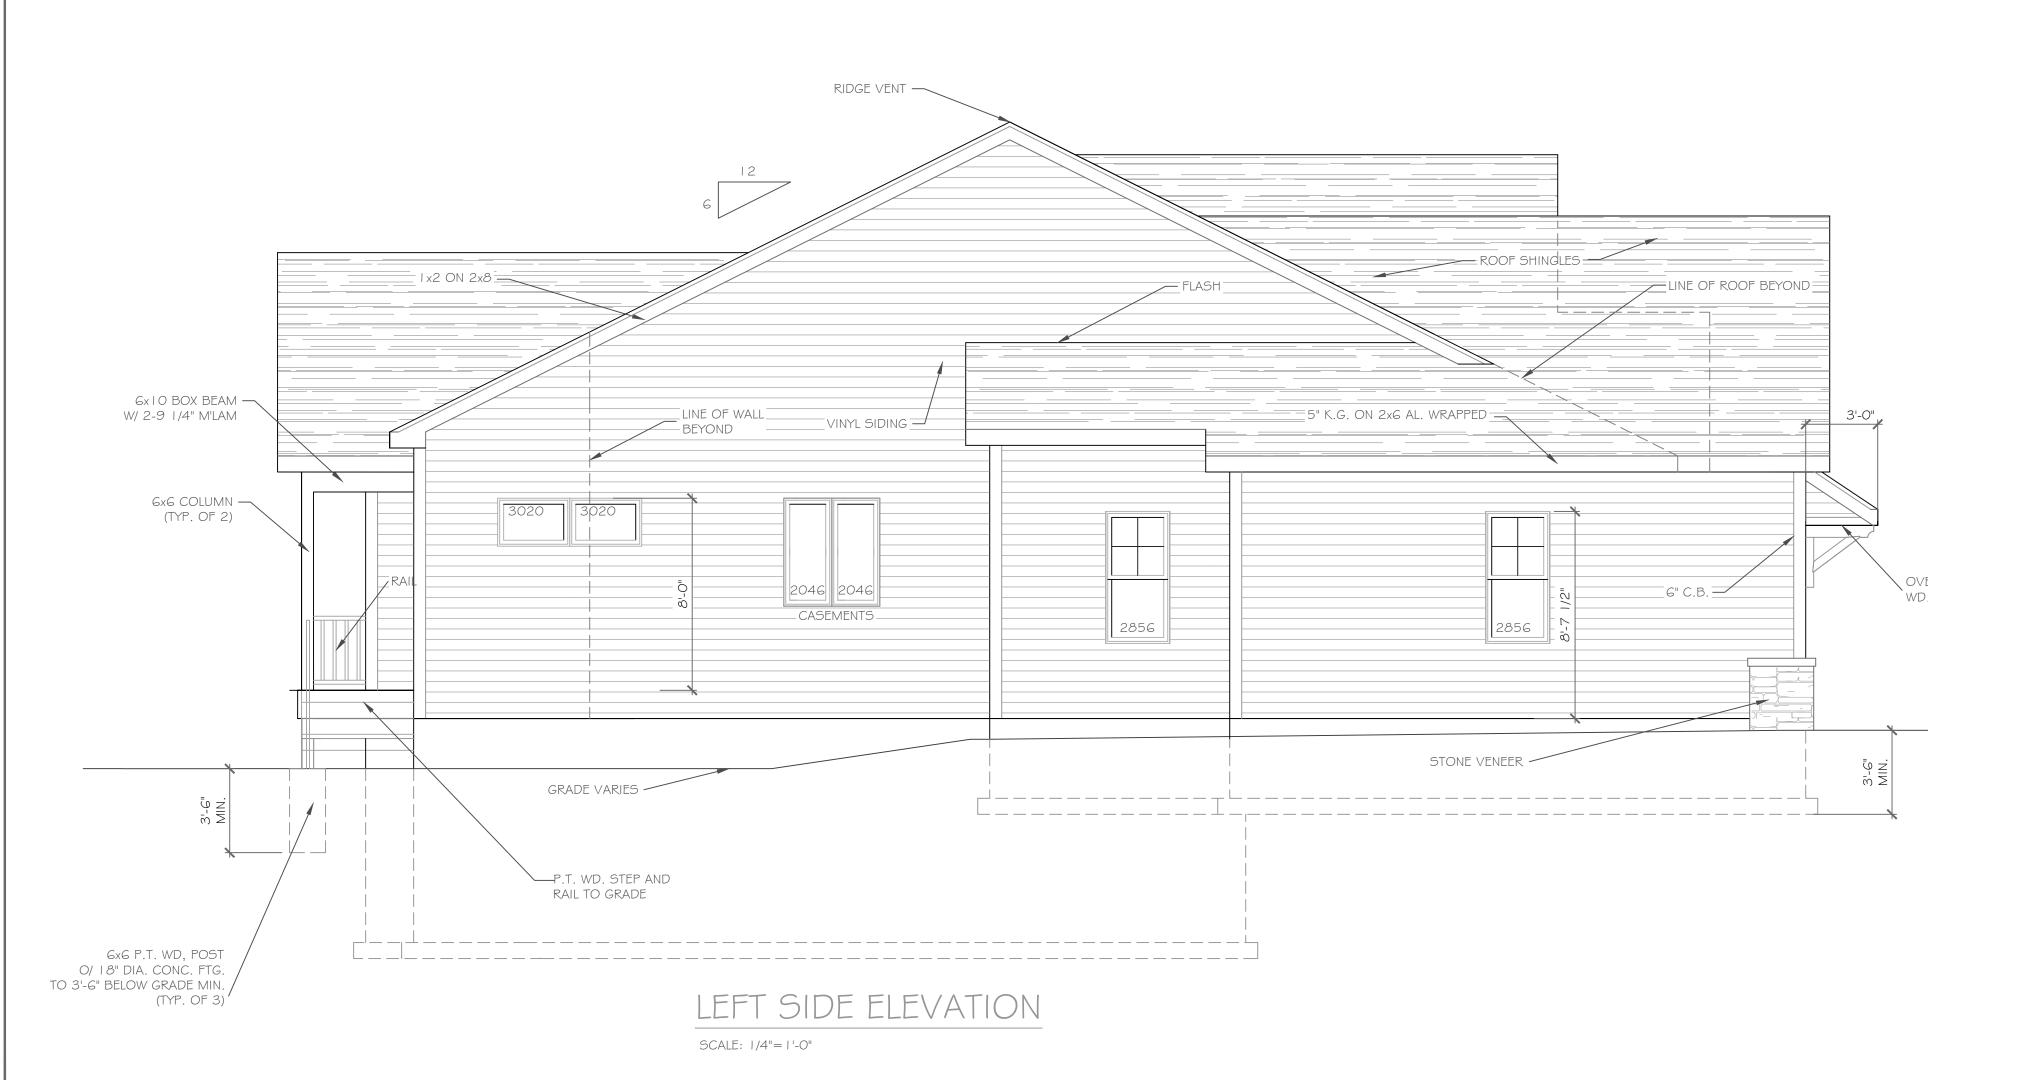


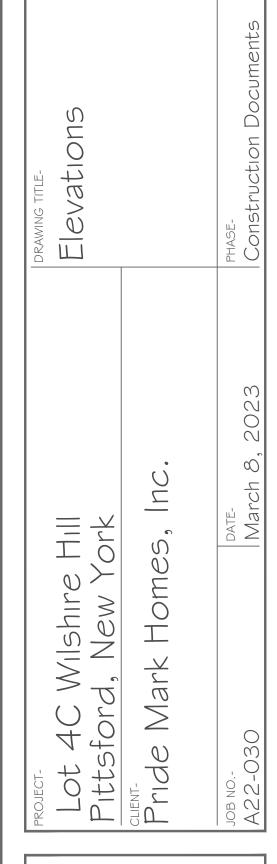



architecture

| 501 Pittsford Victor Road Suite 100 Victor, New York 14564 |
| phone-(585) 249-1334 |
| phone-(585) 249-134 |
| phone-(585)



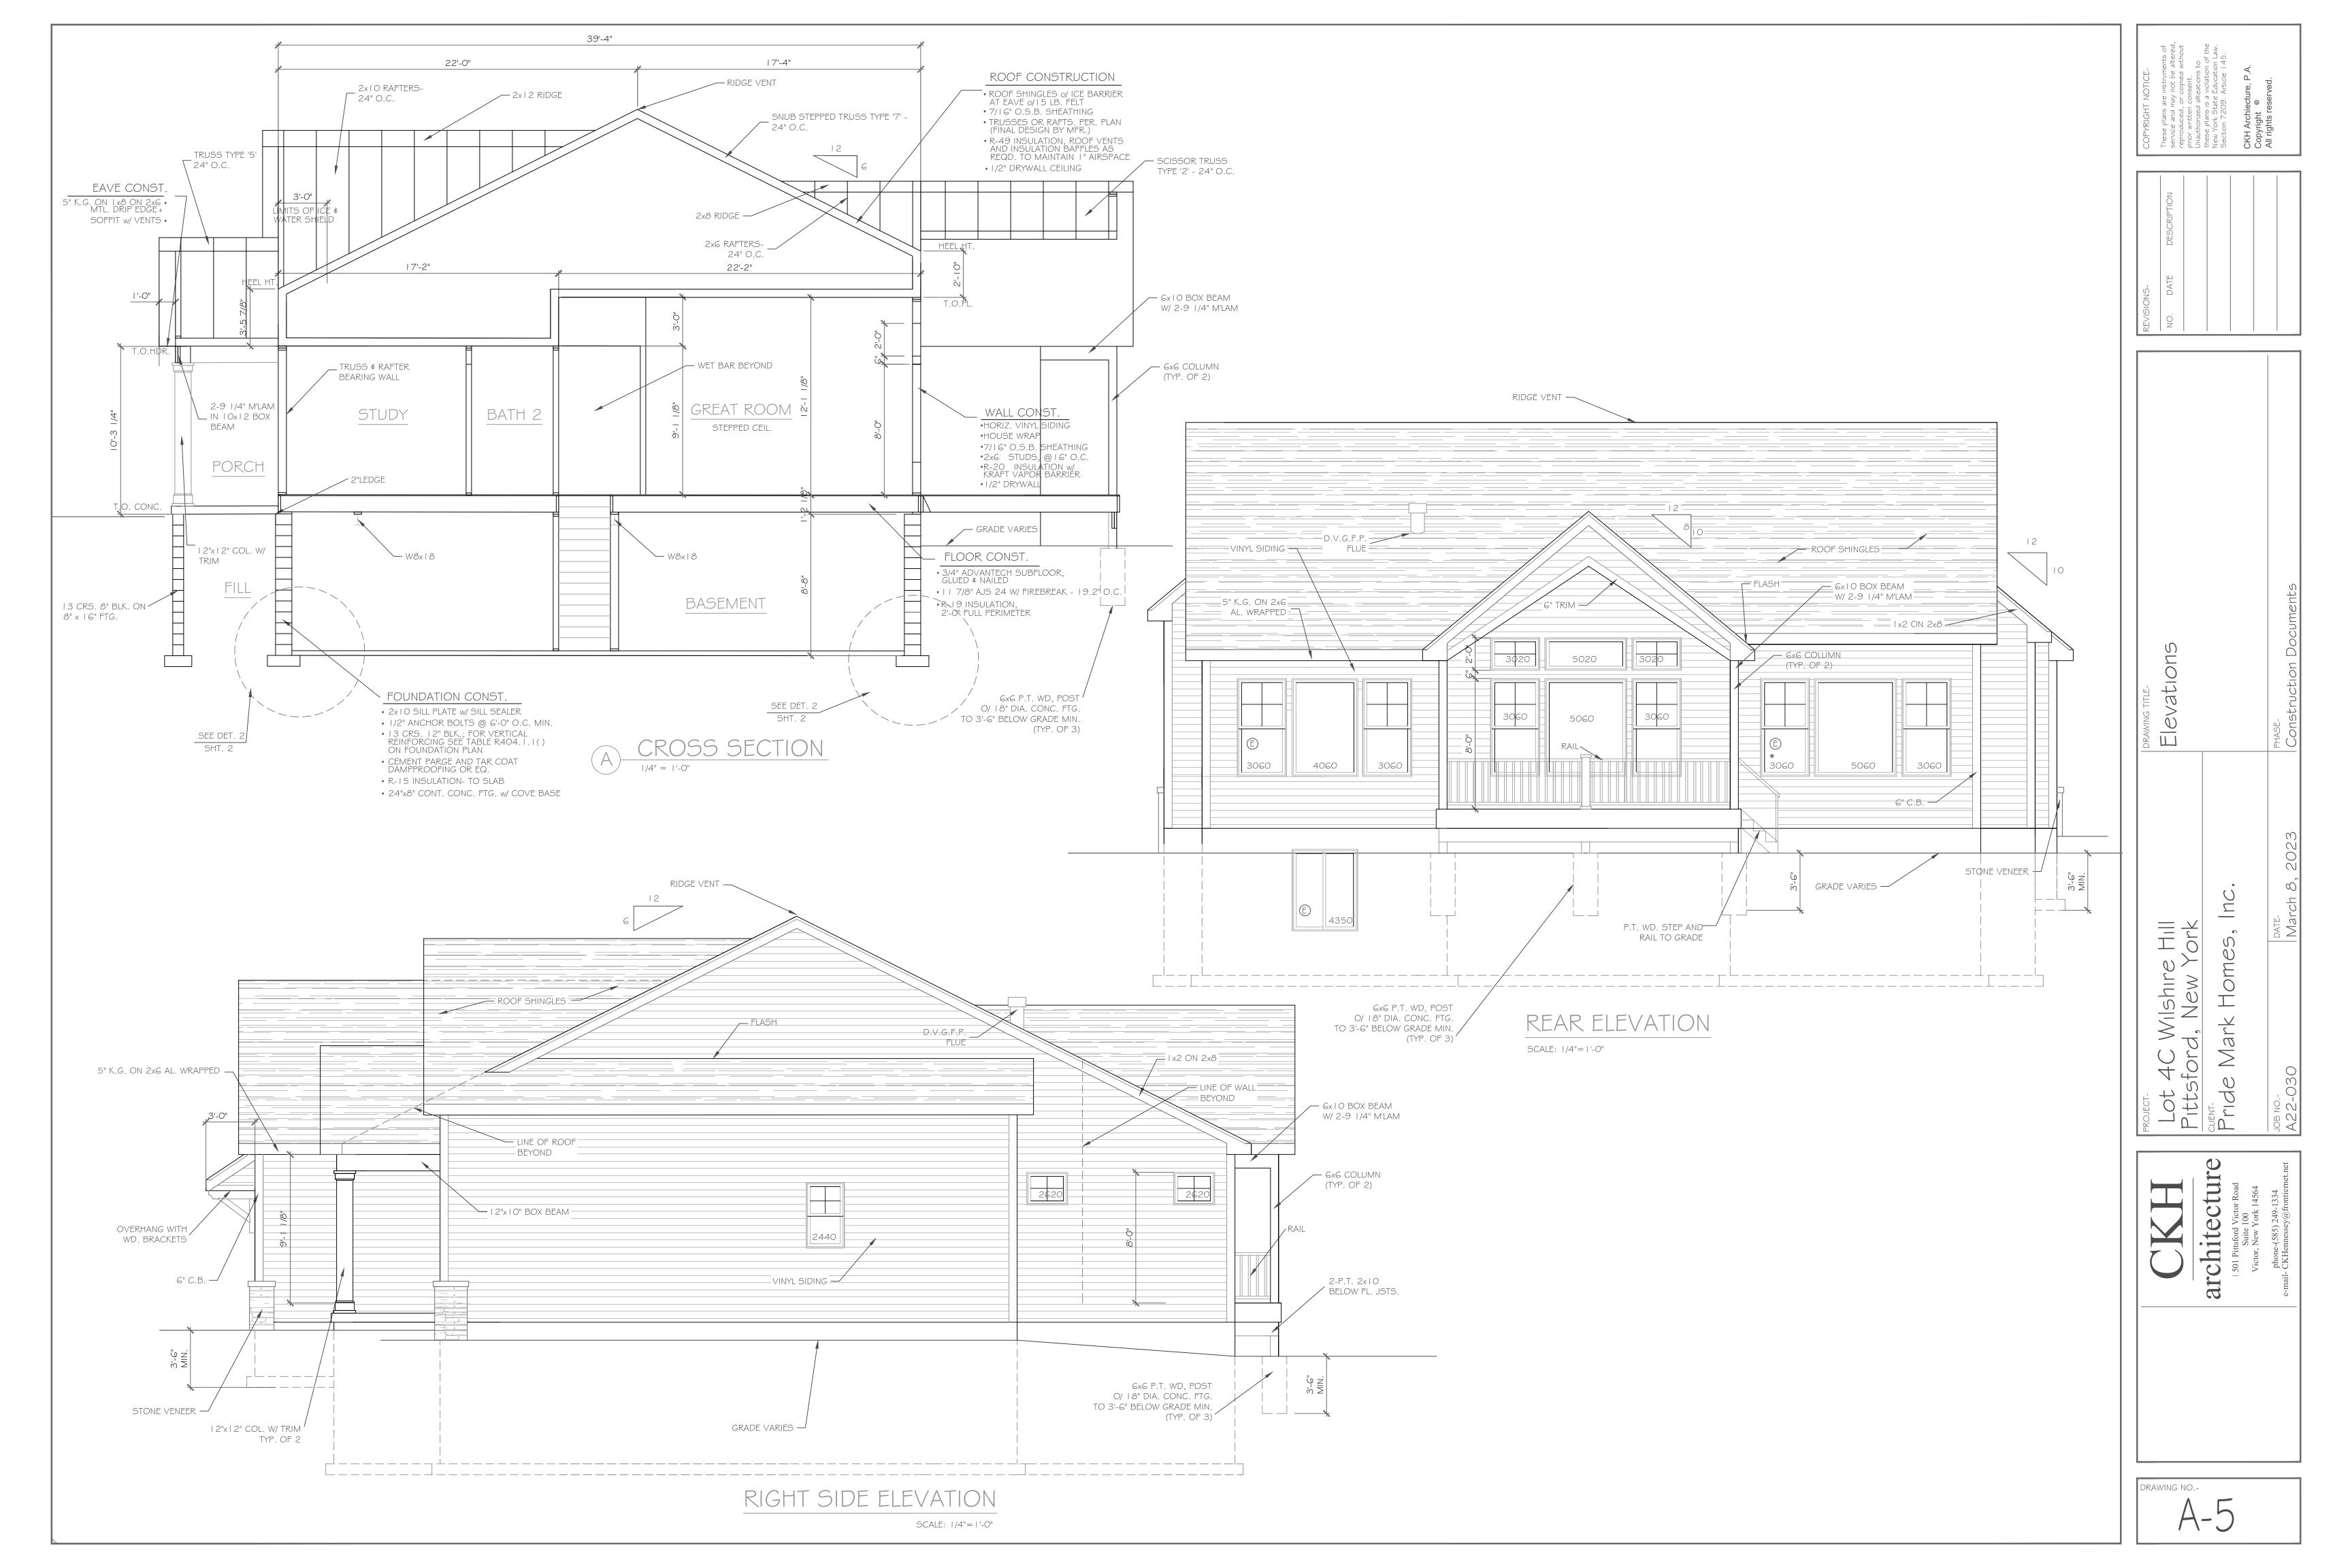

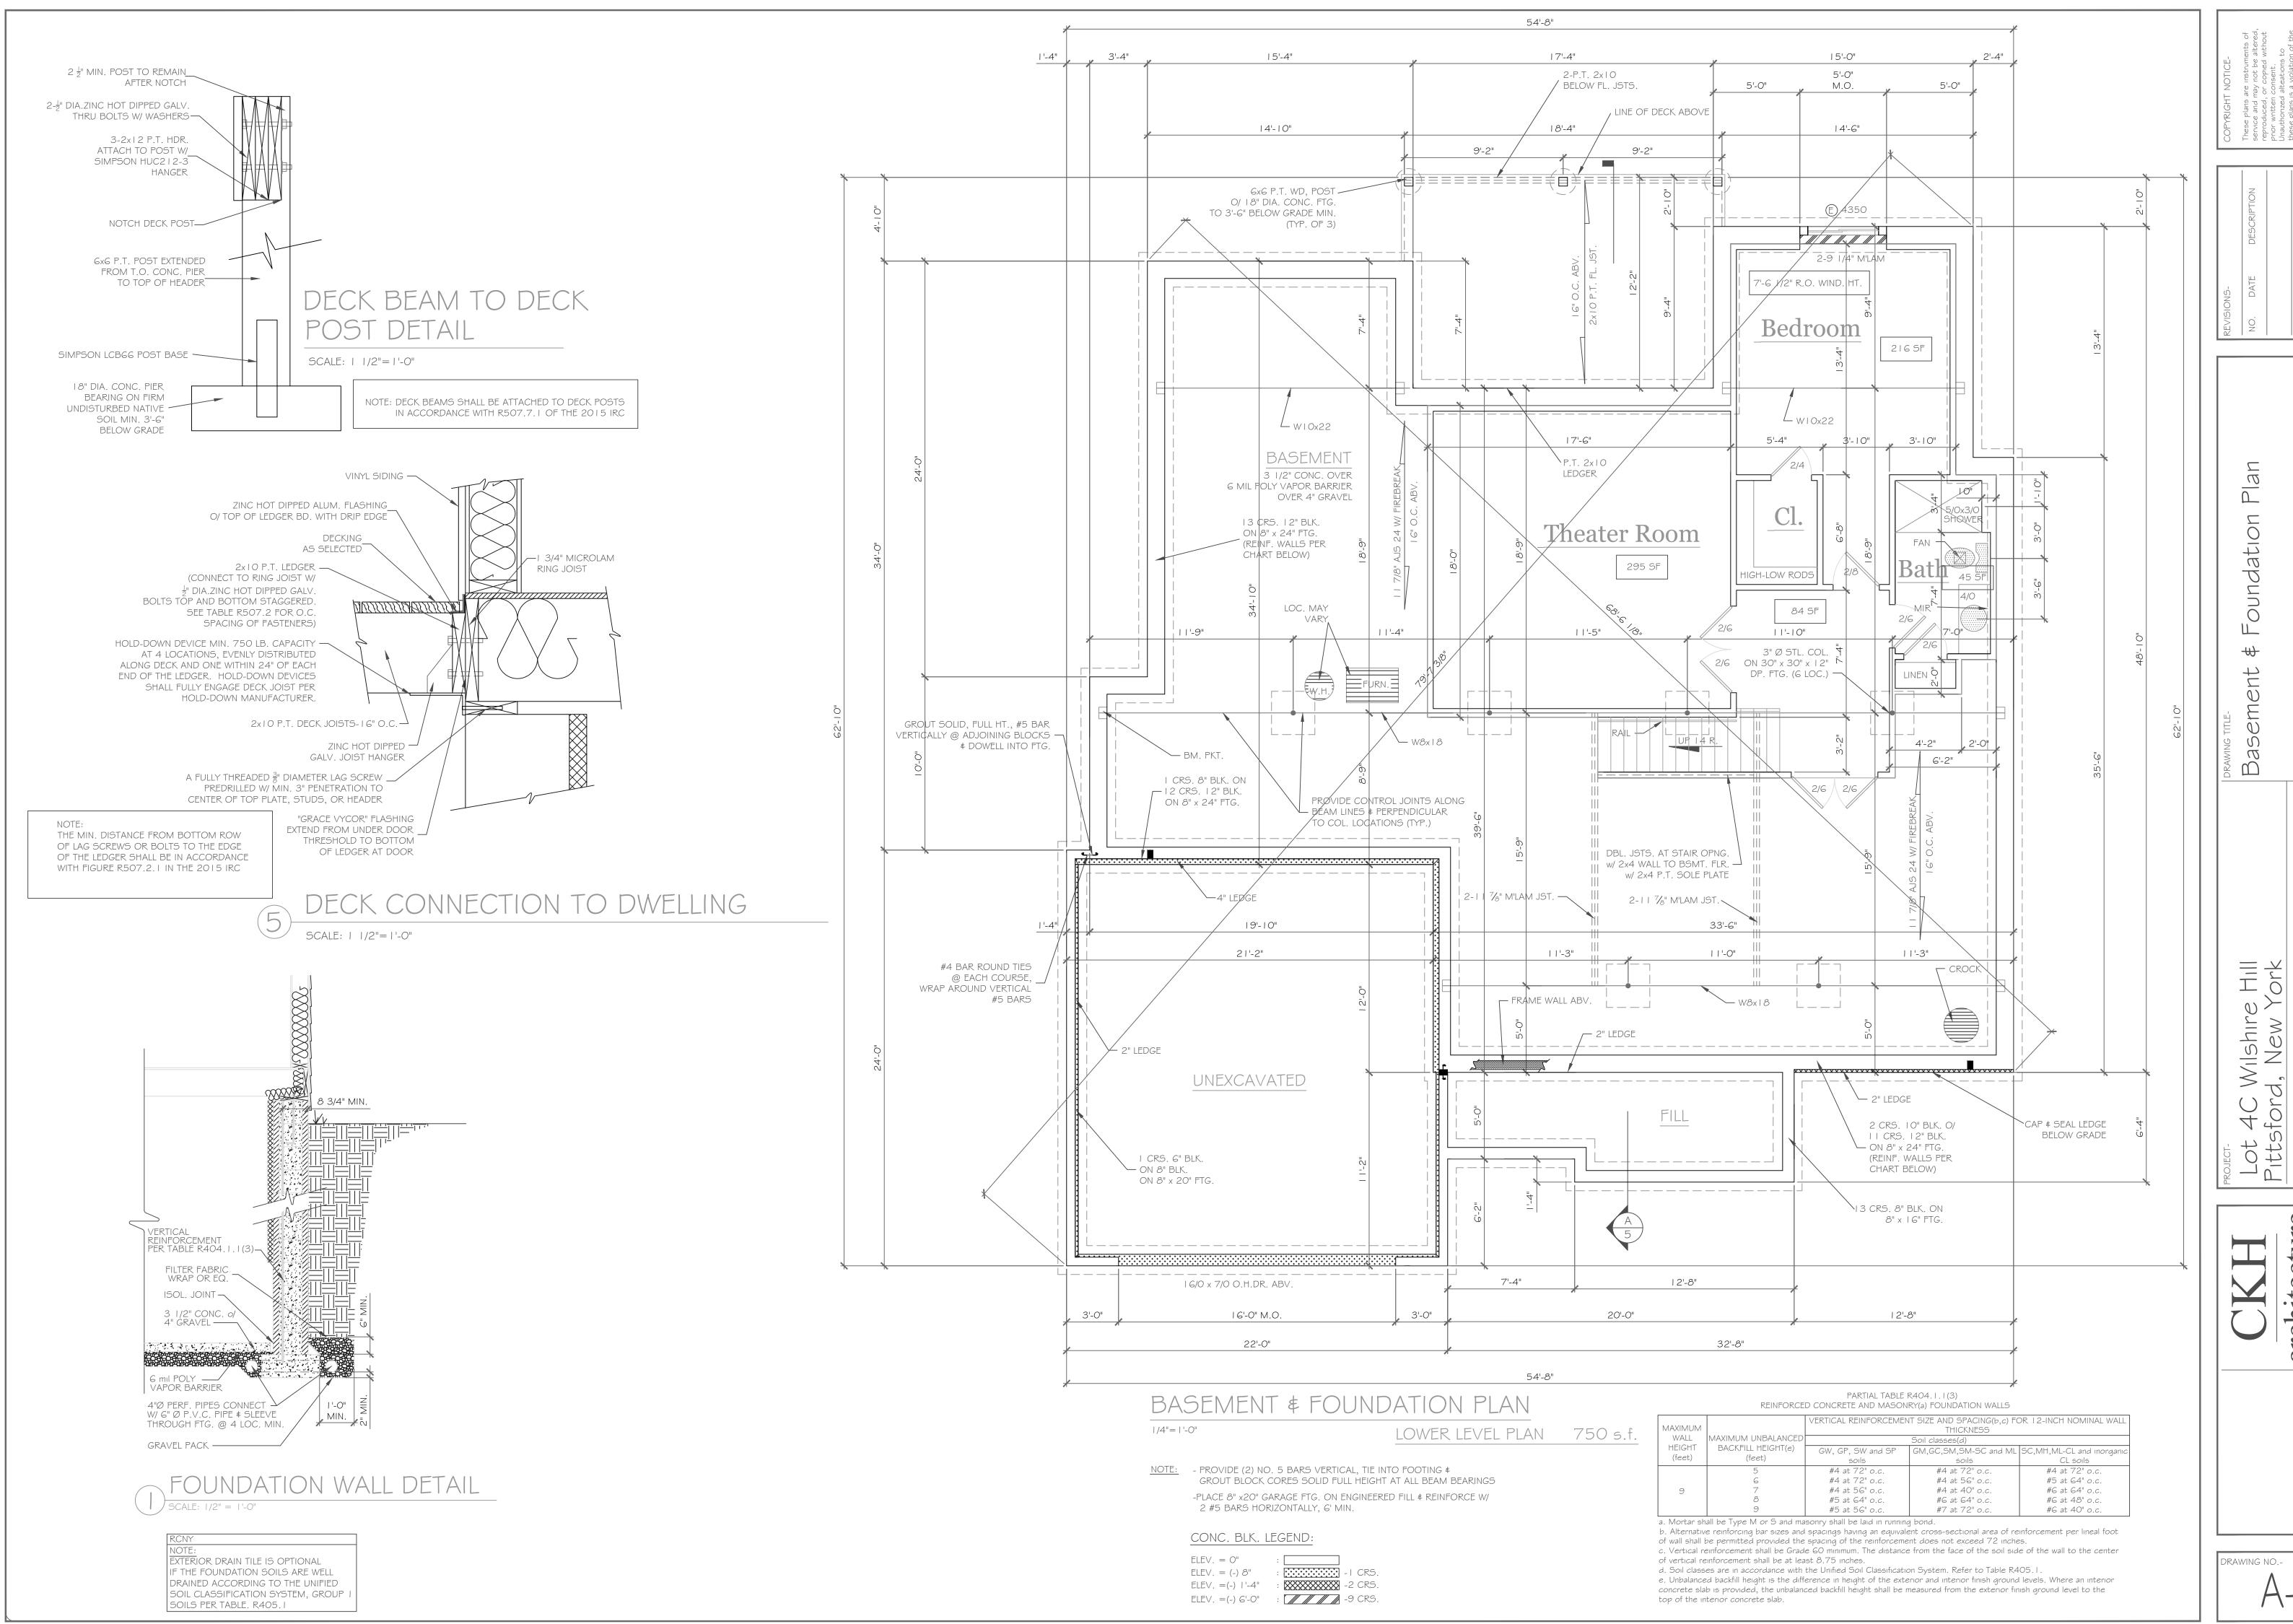

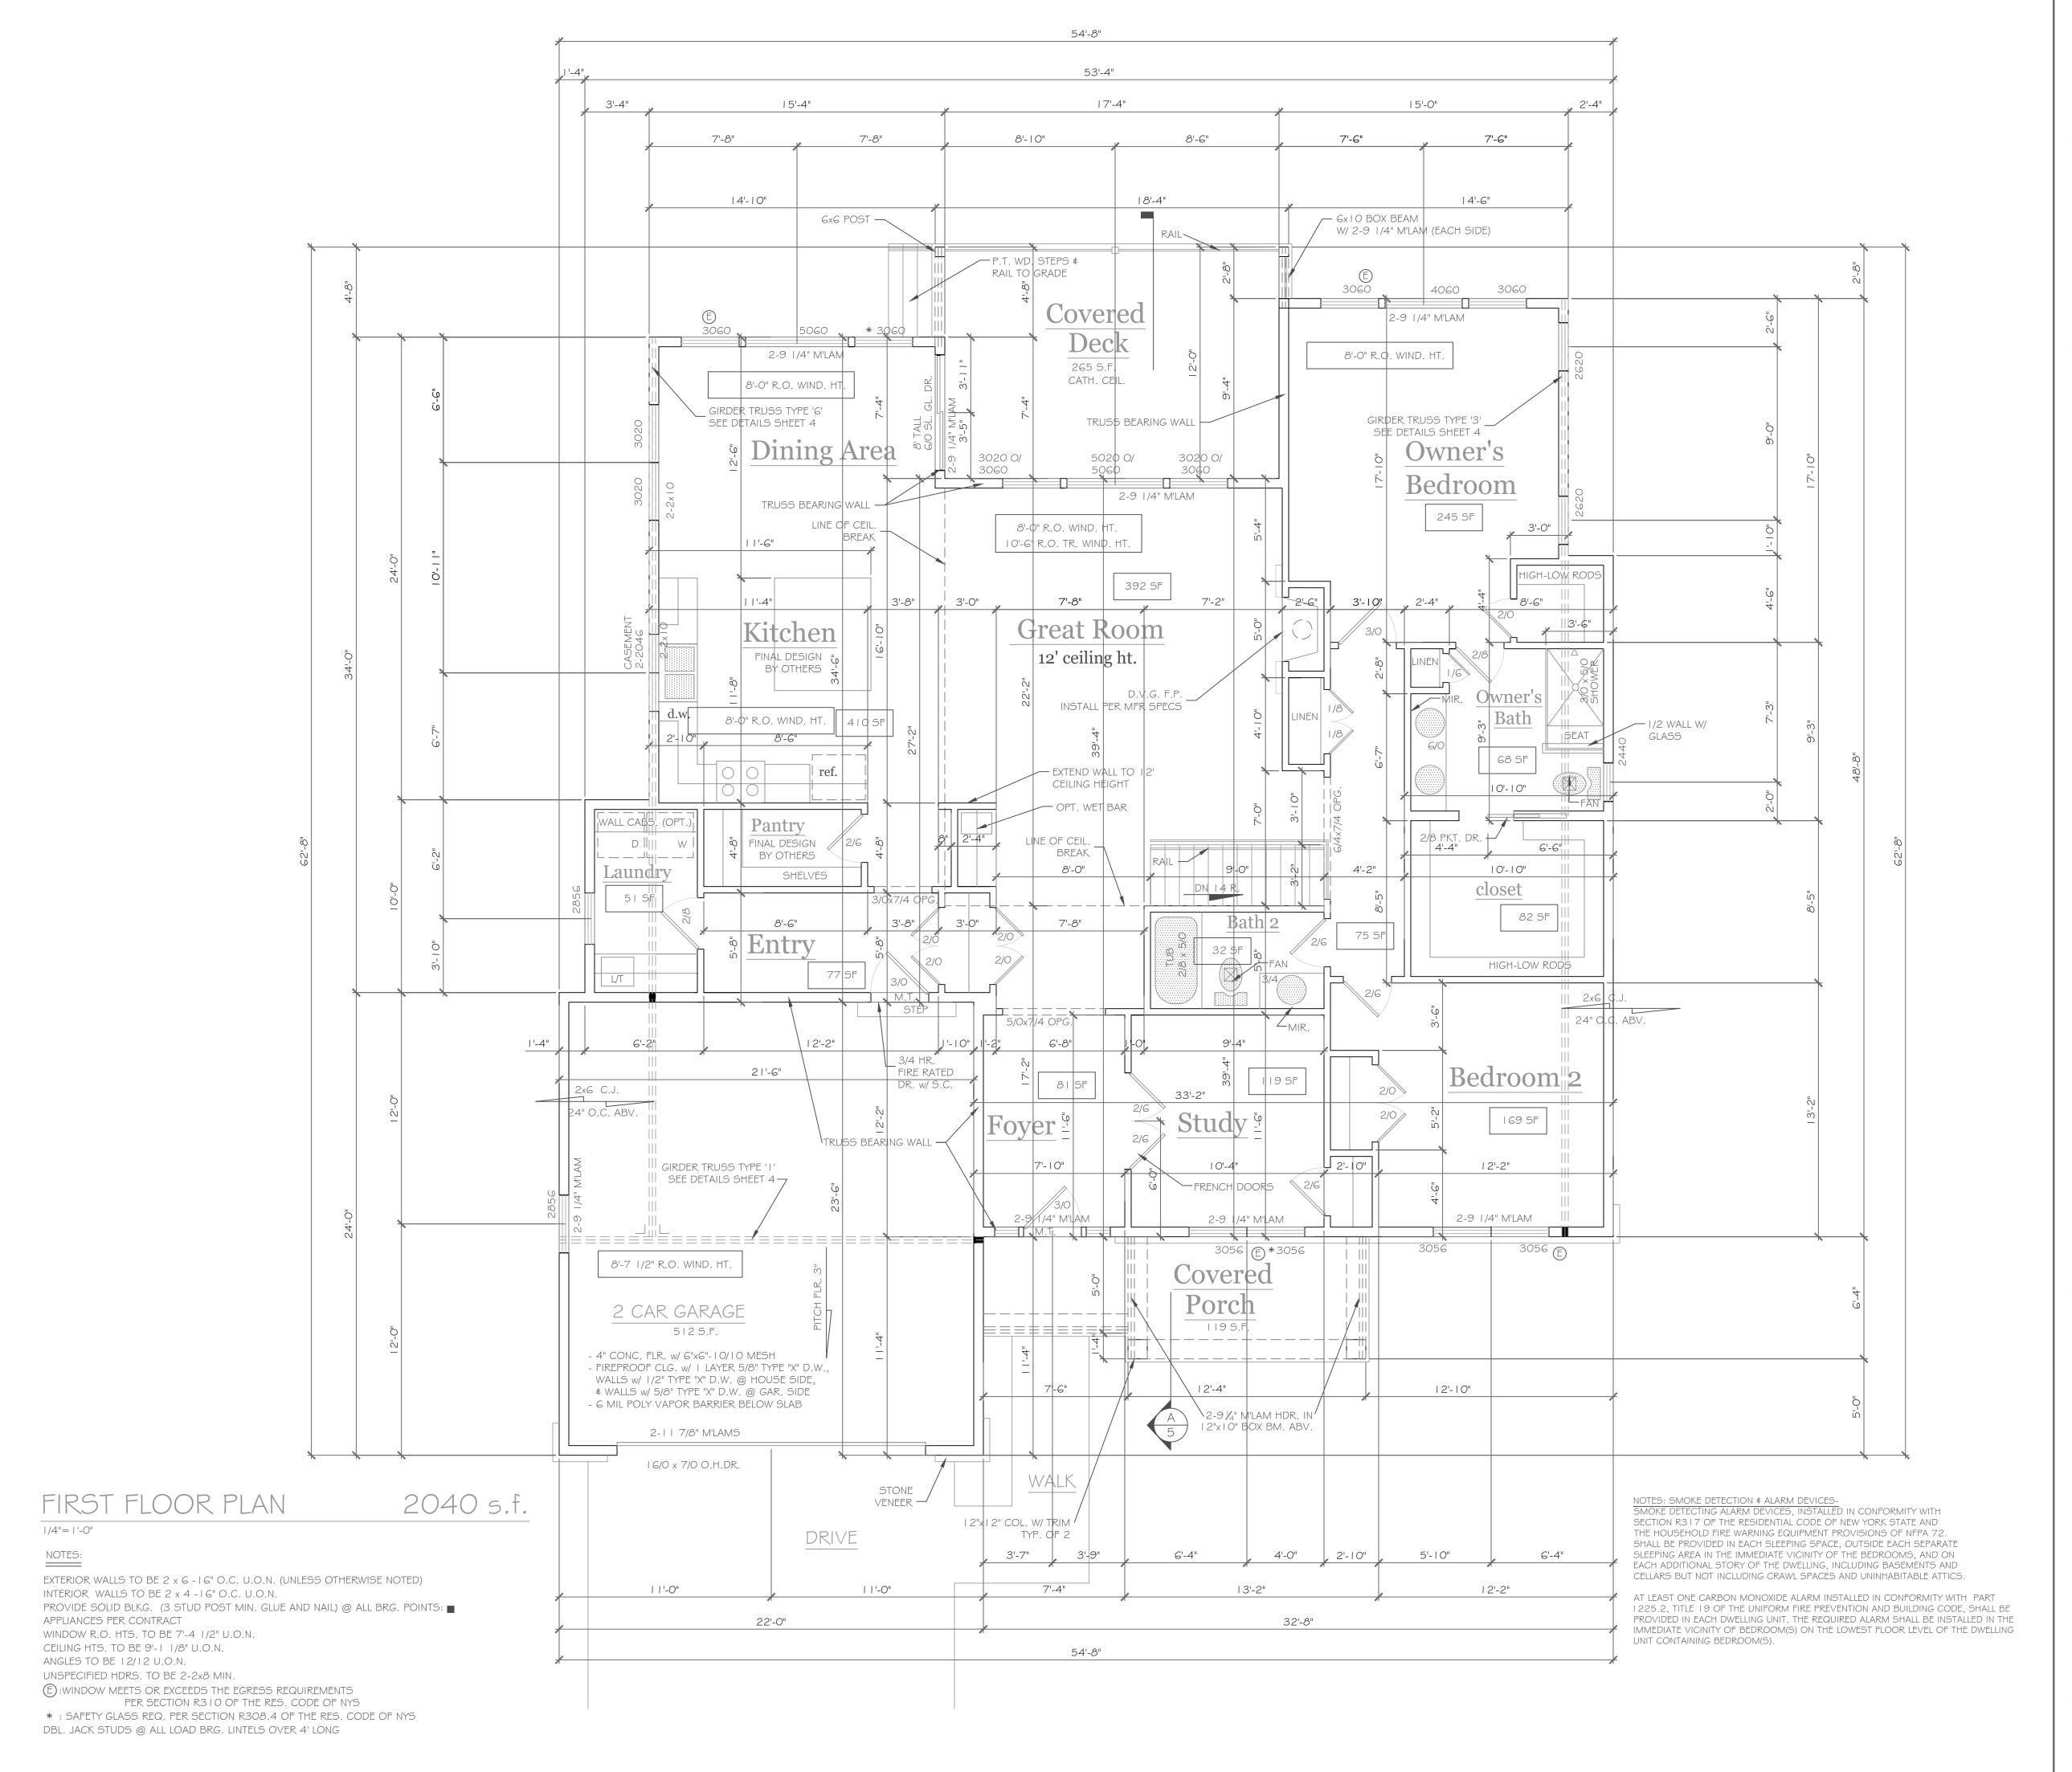


COPYRIGHT NOTICEThese plans are instruments of service and may not be altered, reproduced, or copied without prior written consent.
Unauthorized alteations to these plans is a violation of the New York State Education Law. Section 7209. Article 145.

PROJECTLot 4C Wilshire Hill
Pittsford, New York
CLENTPride Mark Homes, Inc.

DATEJOB NO.PROJECTPRAMIC TITLEPRAMIC FLOOR Plan
FIRST FLOOR Plan

DRAWING NO.-

architectur

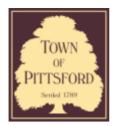

Town of Pittsford

Department of Public Works 11 South Main Street Pittsford, New York 14534

Permit # B23-000008

Phone: 585-248-6250 FAX: 585-248-6262

DESIGN REVIEW AND HISTORIC PRESERVATION BOARD REFERRAL OF APPLICATION

Property Address: 2490 Lehigh Station Road	PITTSFORD, NY 14534
Tax ID Number: 177.01-2-8.1	

Zoning District: RN Residential Neighborhood

Owner: Kody Young **Applicant:** Kody Young

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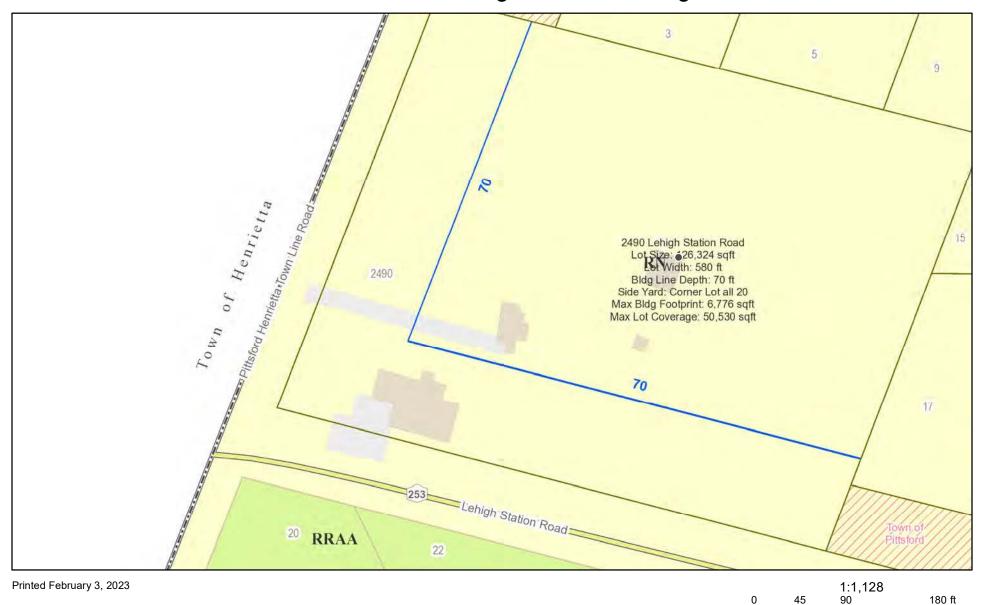
~	Residential Design Review §185-205 (B)	Build to Line Adjustment §185-17 (B) (2)
	Commercial Design Review §185-205 (B)	Building Height Above 30 Feet §185-17 (M)
	Signage §185-205 (C)	Corner Lot Orientation §185-17 (K) (3)
	Certificate of Appropriateness §185-197	Flag Lot Building Line Location §185-17 (L) (1) (c)
	Landmark Designation §185-195 (2)	Undeveloped Flag Lot Requirements §185-17 (L) (2)
	Informal Review	

Project Description: The applicant is requesting design review for an addition of a 2650 sf garage addition off the side of the existing house.

Meeting Date: March 23, 2023



RN Residential Neighborhood Zoning



Town of Pittsford GIS


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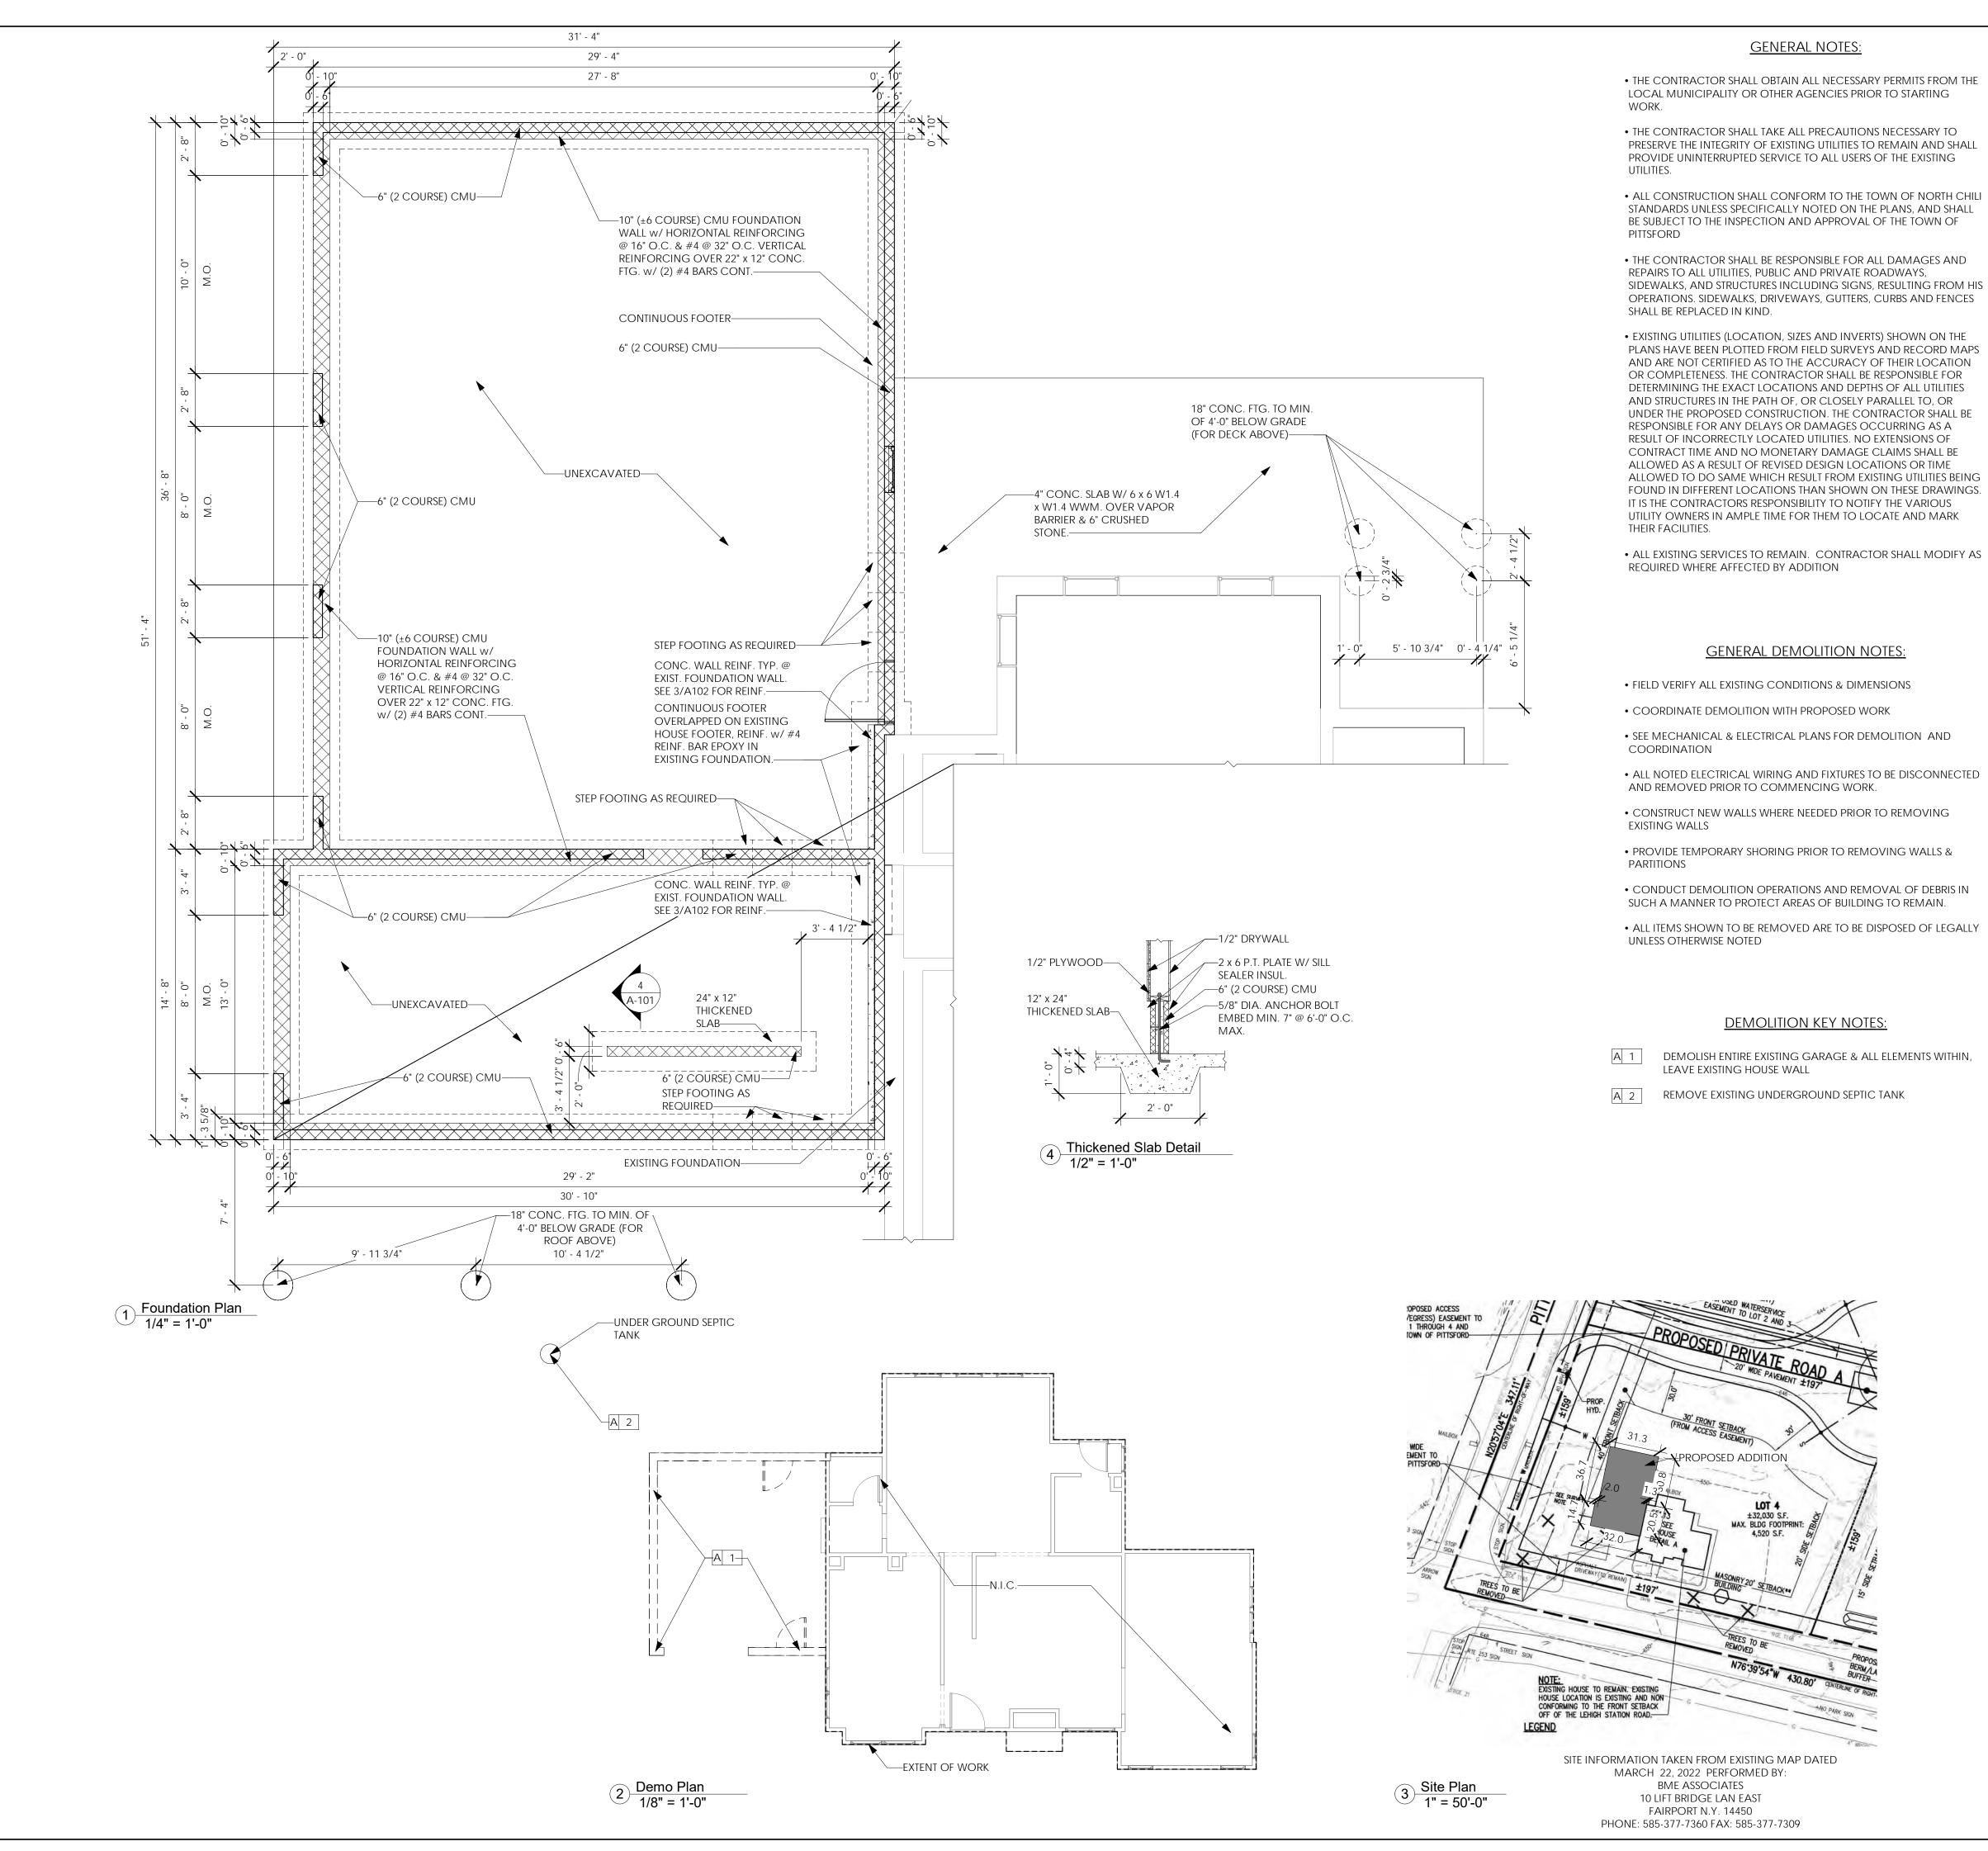
50 m









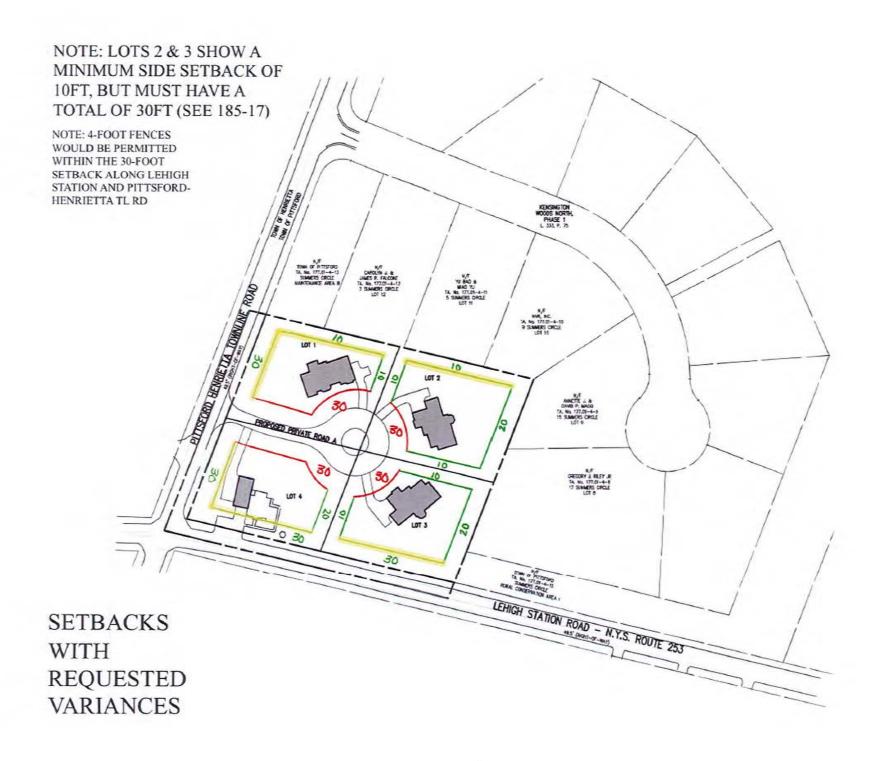

- THE CONTRACTOR SHALL OBTAIN ALL NECESSARY PERMITS FROM THE LOCAL MUNICIPALITY OR OTHER AGENCIES PRIOR TO STARTING
- THE CONTRACTOR SHALL TAKE ALL PRECAUTIONS NECESSARY TO PRESERVE THE INTEGRITY OF EXISTING UTILITIES TO REMAIN AND SHALL PROVIDE UNINTERRUPTED SERVICE TO ALL USERS OF THE EXISTING
- ALL CONSTRUCTION SHALL CONFORM TO THE TOWN OF NORTH CHILI STANDARDS UNLESS SPECIFICALLY NOTED ON THE PLANS, AND SHALL BE SUBJECT TO THE INSPECTION AND APPROVAL OF THE TOWN OF
- THE CONTRACTOR SHALL BE RESPONSIBLE FOR ALL DAMAGES AND REPAIRS TO ALL UTILITIES, PUBLIC AND PRIVATE ROADWAYS, SIDEWALKS, AND STRUCTURES INCLUDING SIGNS, RESULTING FROM HIS OPERATIONS. SIDEWALKS, DRIVEWAYS, GUTTERS, CURBS AND FENCES
- PLANS HAVE BEEN PLOTTED FROM FIELD SURVEYS AND RECORD MAPS AND ARE NOT CERTIFIED AS TO THE ACCURACY OF THEIR LOCATION OR COMPLETENESS. THE CONTRACTOR SHALL BE RESPONSIBLE FOR DETERMINING THE EXACT LOCATIONS AND DEPTHS OF ALL UTILITIES AND STRUCTURES IN THE PATH OF, OR CLOSELY PARALLEL TO, OR UNDER THE PROPOSED CONSTRUCTION. THE CONTRACTOR SHALL BE RESPONSIBLE FOR ANY DELAYS OR DAMAGES OCCURRING AS A RESULT OF INCORRECTLY LOCATED UTILITIES. NO EXTENSIONS OF CONTRACT TIME AND NO MONETARY DAMAGE CLAIMS SHALL BE ALLOWED AS A RESULT OF REVISED DESIGN LOCATIONS OR TIME ALLOWED TO DO SAME WHICH RESULT FROM EXISTING UTILITIES BEING FOUND IN DIFFERENT LOCATIONS THAN SHOWN ON THESE DRAWINGS. IT IS THE CONTRACTORS RESPONSIBILITY TO NOTIFY THE VARIOUS UTILITY OWNERS IN AMPLE TIME FOR THEM TO LOCATE AND MARK

- ALL NOTED ELECTRICAL WIRING AND FIXTURES TO BE DISCONNECTED

- ALL ITEMS SHOWN TO BE REMOVED ARE TO BE DISPOSED OF LEGALLY
- DEMOLISH ENTIRE EXISTING GARAGE & ALL ELEMENTS WITHIN,

GENERAL NOTES:

- CONSTRUCTION SHALL CONFORM TO THE RESIDENTIAL CODE OF NEW YORK STATE, AND REGULATIONS OF THE TOWN OF PITTSFORD
- CONTRACTOR IS TO OBTAIN BUILDING PERMITS, PAY FEES, COORDINATE THE SCHEDULE OF INSPECTIONS AS REQUIRED BY THE TOWN OF PITTSFORD

WITHIN 1'-0' OF GRADE OR EXPOSED TO THE EXTERIOR SHALL BE

PRESSURE PRESERVATIVE TREATED.

- LUMBER DESIGN BASED ON MINIMUM DESIGN PROPERTIES FOR NO. 2 GRADE LUMBER OF DOUGLAS FIR
- WOOD IN CONTACT WITH MASONRY, CONCRETE OR EARTH, OR
- FRAMING ANCHORS, JOIST HANGERS, AND MISCELLANEOUS METAL, CONNECTING DEVICES FOR WOOD FRAMING SHALL BE GALVANIZED STEEL OF AT LEAST 16 GAGE THICKNESS. INSTALL IN STRICT ACCORDANCE WITH MANUFACTURER'S RECOMMENDATIONS. USE NAILS SUPPLIED BY OR RECOMMENDED BY THE MANUF.
- DOUBLE ALL JOIST UNDER PARALLEL WALLS, AND AT FLOOR
- THE GENERAL CONTRACTOR IS RESPONSIBLE FOR COMPLIANCE WITH ALL INFORMATION ON THE DRAWINGS.
- CONSTRUCTION METHODS AND CRAFTSMANSHIP ARE THE RESPONSIBILITY OF THE GENERAL CONTRACTOR.
- FIELD VERIFY ALL EXISTING CONDITIONS & DIMENSIONS
- ALL NEW WALL INFILLS & EXTENSIONS SHALL BE FLUSH WITH BOTH SIDES OF EXIST. WALL
- PROVIDE SHELVING IN CLOSETS. COORDINATE SHELVING DESIGN WITH OWNER
- PATCH & REPAIR DAMAGED EXISTING DRYWALL
- ALL NEW INTERIOR DOOR HEADERS TO BE (2) 2 x 8 UNLESS OTHERWISE NOTED.
- ALL NEW WINDOW HEADERS TO BE (3) 2 x 8 UNLESS OTHERWISE
- ALL DOORS OPENING AND WINDOWS FRAMING SHALL BE 1 KING
- STUD & 2 JACK STUDS. (TYP)
- PROVIDE 3 1/2" SOUND ATTENUATION BATTS AT ALL PARTITIONS BETWEEN BATHROOMS AND OTHER ROOMS
- PROVIDE 1/2" MOISTURE RESISTANT DRYWALL AT ALL BATHROOMS
- NEW FIXTURES TO BE SELECTED BY OWNER, INSTALLED BY CONTRACTOR
- NEW APPLIANCES (AS REQ'D) TO BE FURNISHED BY OWNER, INSTALLED BY CONTRACTOR
- CONTRACTOR TO COORDINATE ELECTRICAL, HVAC AND PLUMBING NEEDS & CONNECTIONS WITH OWNER AND INCLUDE REQUIRED
- WORK IN BID PRICING
- CONTRACTOR TO INSTALL AT LEAST (1) SMOKE DETECTOR IN EACH BEDROOM & (1) OUTSIDE EACH SLEEPING AREA IN THE VICINITY OF THE BEDROOM, & (1) IN EACH SEPARATE STORY INCLUDING THE BASEMENT. ALL SMOKE DETECTORS SHALL BE WIRED INTO 120V WITHOUT DISCONNECTING SWITCH OTHER THAN CIRCUIT BREAKER & SHALL BE INTERCONNECTED SUCH THAT WHEN ONE ALARMS, ALL SHALL ALARM. (1) CARBON MONOXIDE DETECTOR IN DINING ROOM, NEAR KITCHEN. INSTALLATION OF SMOKE & CARBON MONOXIDE DETECTORS SHALL BE IN ACCORDANCE WITH ALL STATE & LOCAL CODES & THE HOUSEHOLD FIRE WARNING EQUIPMENT PROVISIONS OF NFPA 72. ALL DETECTORS SHALL BE EQUIPPED WITH BATTERY

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Project Architect/Engineer

Architect/Engineer Name

Project Lead

Project Designer

Lead Name

Designer Name

Date:

Date:

Date:

Date:

Date:

11/04/22

11/07/22

11/07/22


Issued:

| Issued for Client Review

Issued for Client Review

Issued for Bid Permit

Revisions:

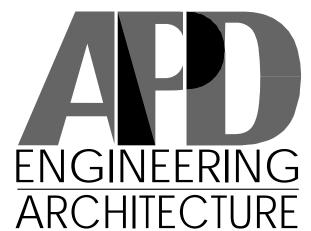

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GENERAL CONCRETE & **FOUNDATION NOTES:**

ALLOWABLE SOIL BEARING ASSUMED AS 2500 P.S.F.

2'-0" HORIZONTAL.

POROUS FILL. (CRUSHED STONE)

- ALL CONCRETE TO HAVE A MINIMUM COMPRESSIVE STRENGTH OF 3500 P.S.I. AT 28 DAYS, UNLESS NOTED OTHERWISE.
- BOTTOM OF ALL FOOTINGS TO REST ON UNDISTURBED SOIL.
- STEPS IN ALL FOOTINGS NOT TO EXCEED 1'-0" VERTICAL FOR EACH
- ALL CONCRETE SLABS ON GRADE TO REST ON 6" COMPACTED
- ALL SLABS ON GRADE TO BE REINFORCED WITH 6 x 6 -W1.4 x W1.4
- WWM. UNLESS NOTED OTHERWISE. SPLICES FER CRSI LATEST EDITION.
- FILL COLUMN AND BEAM POCKETS WIITH CONCRETE AFTER ALL COLUMNS AND BEAMS ARE IN PLACE, UNLESS NOTED OTHERWISE • BACKFILL BOTH SIDES OF FOUNDATION WALLS SIMULTANEOUSLY:
- DECK AT TOP AND SLAB BOTTOM OF WALL ARE IN PLACE.
- SLEEVE FOUNDATION WALLS WHERE REQUIRED TO ACCOMMODATE DUCTS AND UTILITIES.

WALLS WITH FILL ON ONE SIDE ONLY, MUST NOT BE BACKFILLED UNTIL

- REINFORCING BARS TO CONFORM TO ASTM A-615 GRADE 60.
- EXCEPT REINFORCING FOR DOWELS TO SLABS TO BE GRADE 40. • STEEL MESH REINFORCING TO CONFORM TO ASTM A-185
- REINFORCING BAR SPLICES & EMBEDMENT LENGTHS TO CONFORM TO LATEST CRSI HANDBOOK COMPLYING WITH ACI 318-CODE OF LATEST ISSUE, UNLESS NOTED OTHERWISE.
- ALL SPLICES IN REINFORCING ARE TO BE CLASS "B", UNLESS NOTED OTHERWISE. CONSIDER ALL HORIZONTAL WALL BARS AS "TOP BARS"
- TERMINATE ALL BARS IN ACCORDANCE WITH ACI-318 CODE OF LATEST ISSUE, WITH A HOOK IF THE REQUIRED EMBEDMENT LENGTH CANNOT BE OBTAINED.
- PROVIDE #4 VERTICAL REINFORCING @ 32" O.C.- GROUT CORES WITH REINFORCING SOLID, PER TABLE R 404.1.1(3) OF THE RESIDENTIAL CODE OF N.Y.S.

Young Residence Addition

2490 Lehigh Station Rd Pittsford, NY 14534 Monroe County

Project Name & Location:

Site Plan, Existing/Demo Plan, Foundation Plan

Drawing Name:


Project No. Date: 11/07/22


21-0511 Type: Residentia

A-101 Drawn By: NMH


Scale: As Noted


Drawing No.

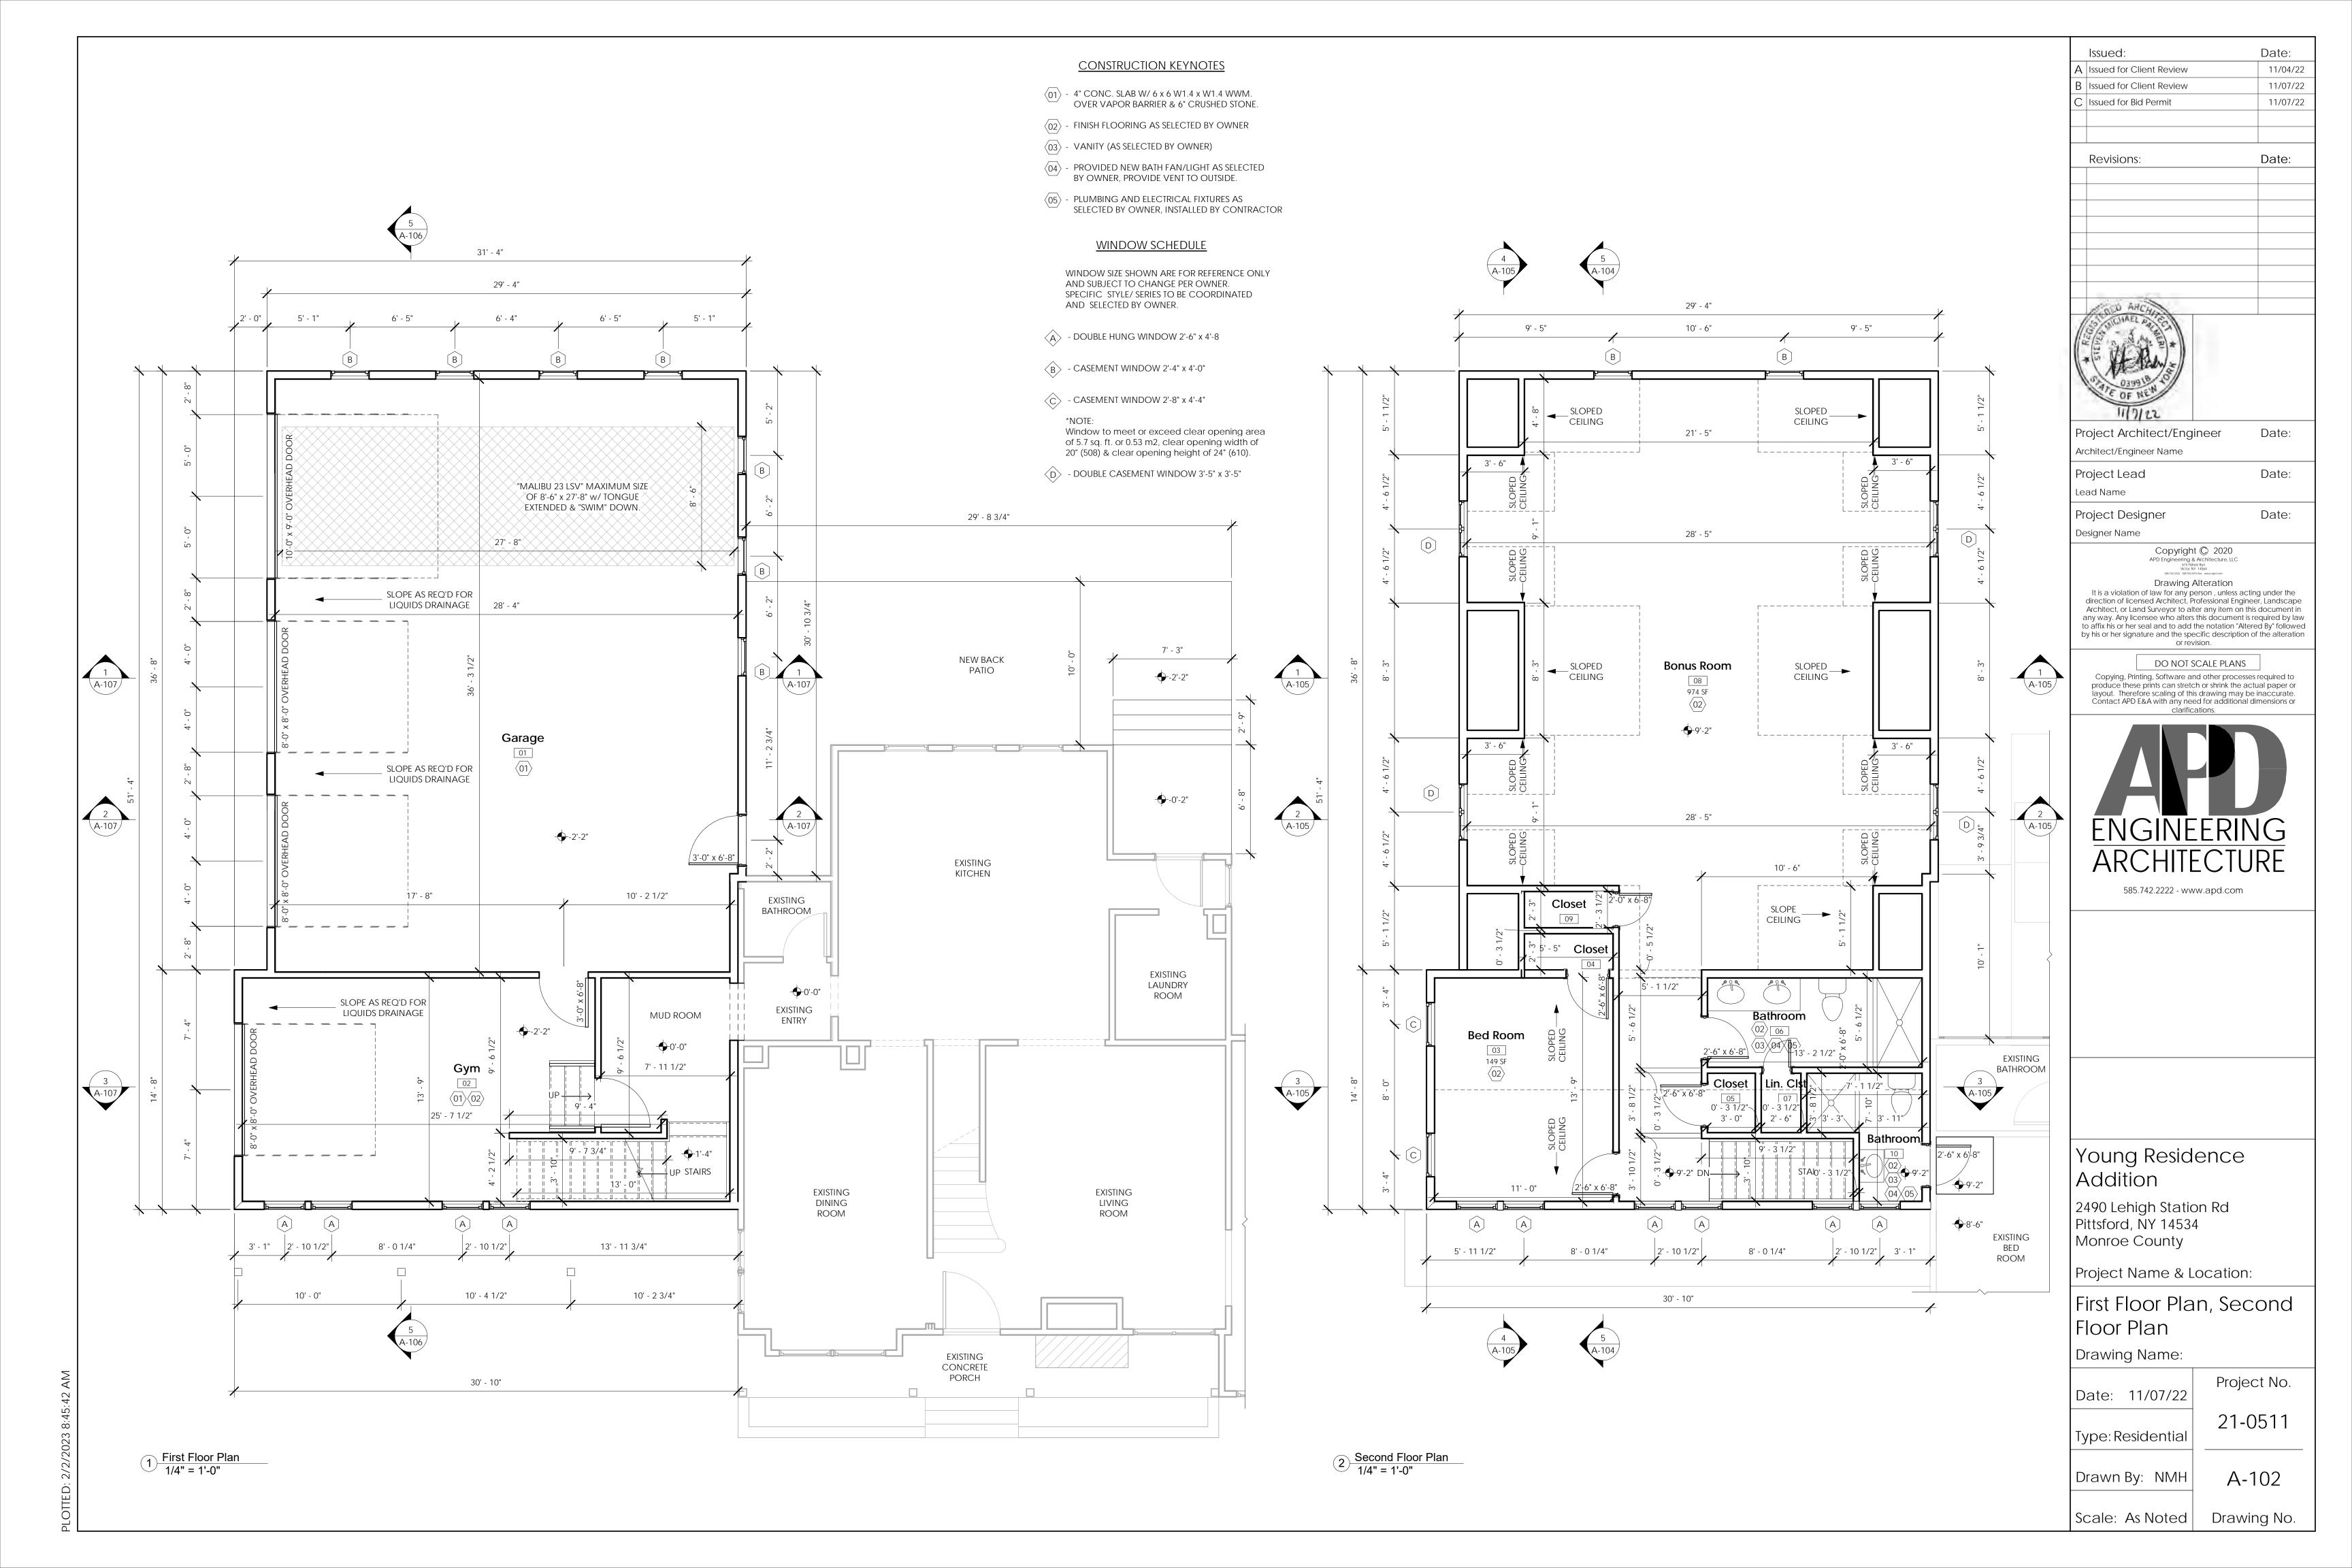

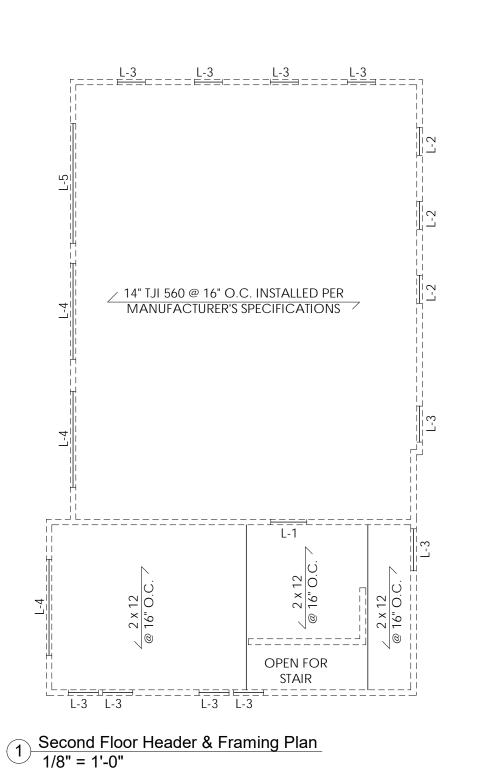


Back Deck Framing Plan
1/4" = 1'-0"

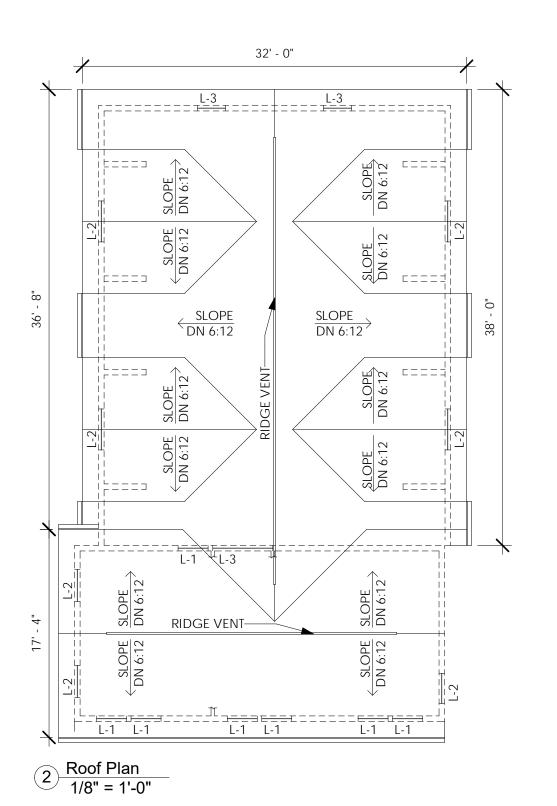

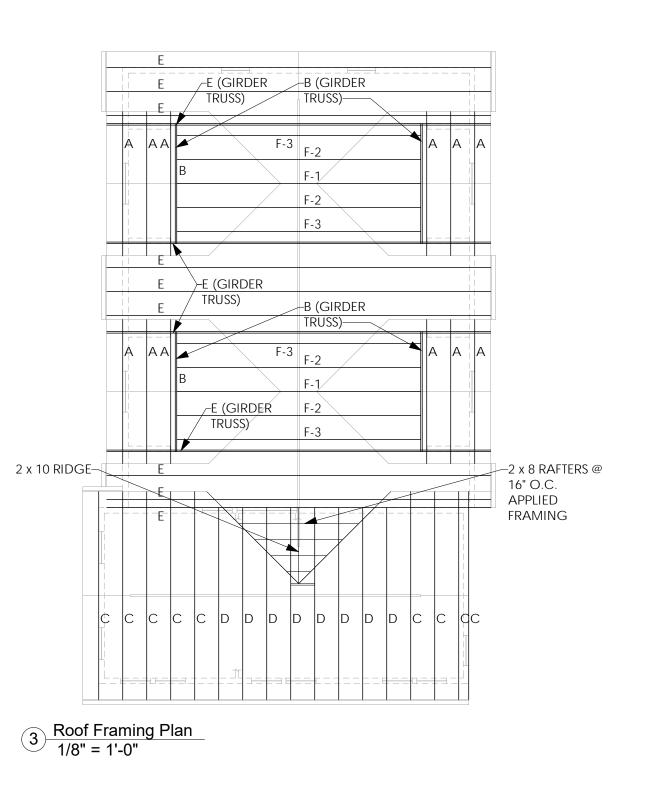

NEW BACK PATIO 5' - 10 3/4" –18" CONC. FTG. TO MIN. OF 4'-0" BELOW GRADE P.T. 4 x 4 POST. PLACED BELOW DECK BEAM FOR SUPPORT AT LEDGER.-(2) P.T. 2 x 10 FASTEN LEDGER W/ 1/2"Ø LAG BOLTS @ 24" O.C. FASTENED IN ACCORDANCE W/ IRBC 507.9. PROVIDE MIN. 750 CAPACITY HOLD DOWN DEVICE @ 4 LOCATIONS EVENLY DISTRIBUTED ALONG DECK & WITH 24' EA END OF LEDGER. HOLD DOWN SHALL FULLY ENGAGE DECK JOIST PER HOLD DOWN MANUFACTURER (1) P.T. 2 x 10 KITCHEN

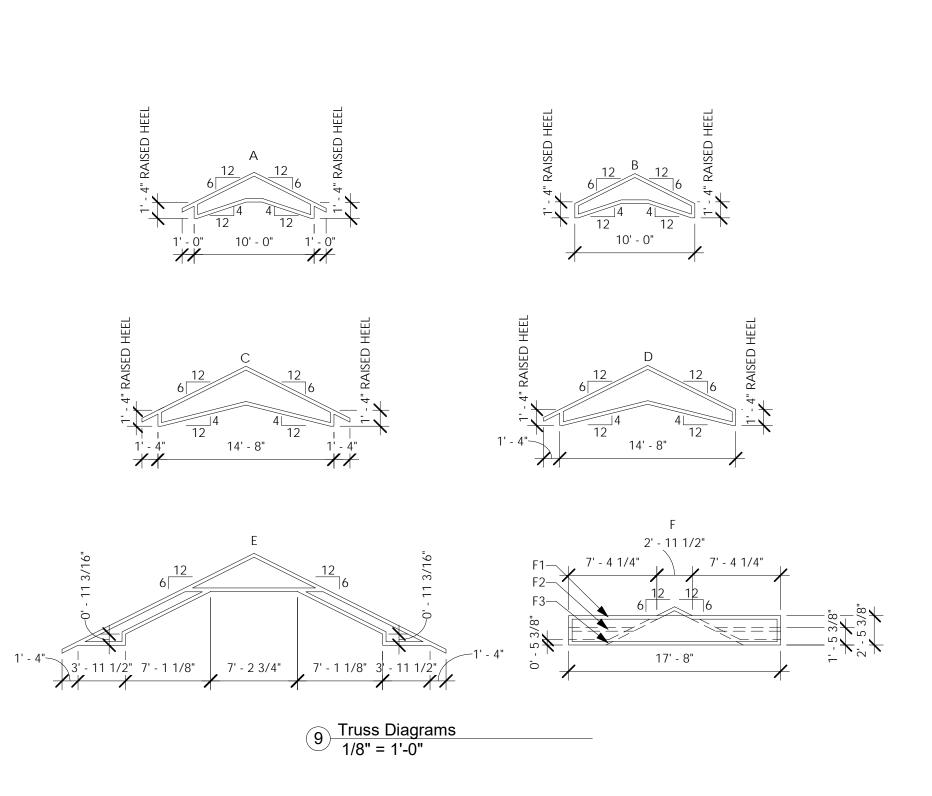

ROOF NOTES:

 PROVIDE MINIMUM 5'-0" WIDE ICE & WATER SHIELD UNDERLAYMENT ALONG EAVES AND AT VALLEYS

 PROVIDE ASPHALT SATURATED FELT UNDERLAYMENT ALL REMAINING AREAS

• PROVIDE ALUMINUM FASCIA, DRIP EDGE, VENTED SOFFITS, GUTTERS AND DOWNSPOUTS AT NEW ROOF AREAS, TO MATCH EXISTING.

• REMOVE EXISTING ROOF SHINGLES & UNDERLAYMENT. FURNISH AND INSTALL ICE & WATER UNDERLAYMENT & NEW ARCHITECTURAL SHINGLES AS REQ'D

• VERIFY IN FIELD EXISTING ROOF OVERHANGS. NEW OVERHANGS TO MATCH EXIST.

LINTEL & HEADER SCHEDULE:

L-1 - (3) 2 x 4 WITH (2)1/2" PLYWOOD GUSSET (2 x 6 EXTERIOR WALLS)
L-2 - (3) 2 x 6 WITH (2)1/2" PLYWOOD GUSSET (2 x 6 EXTERIOR WALLS)
L-3 - (3) 2 x 8 WITH (2)1/2" PLYWOOD GUSSET (2 x 6 EXTERIOR WALLS)
L-4 - 2.0E MICROLAM LVL 5 1/4" WIDE (3 PLY) x 9 1/4" (8'-0" WIDE GARAGE DOOR)
L-5 - 2.0E MICROLAM LVL 5 1/4" WIDE (3 PLY) x 11 1/4" (10'-0" WIDE GARAGE DOOR)

NOTE:

NOTE:

PRE-ENGINEERED WOOD TRUSS SYSTEM SHALL BE DESIGNED BY A N.Y.S. LICENSED ARCHITECT OR ENGINEER FOR THE FOLLOWING LOADS:

TOP CHORD DEAD LOAD: 10#
TOP CHORD SNOW LOAD: 50# GROUND
BOTTOM CHORD DEAD LOAD: 10#

NOTE:

• ALL TRUSSES TO BE 2'-0" O.C.


 ALL STICK FRAMING SHALL BE: 2x10 RIDGE & HIP MEMBERS 2x8 RAFTERS @ 16" O.C. UNLESS OTHERWISE NOTES

VERIFY PITCH OF EXISTING ROOF PRIOR TO ORDERING TRUSS


 CONTRACTOR SHALL FURNISH TRUSS SHOP DRAWINGS WITH ENGINEER OR ARCHITECT SEAL & SIGNATURE

 TRUSS MANUFACTURER TO PROIVDE RECOMMENDED ROOF TRUSS SYSTEM BRACING DIAGRAM

• ROOF TRUSS SHALL BE INSTALLED USING SIMPSON HURRICANE TIES H8 OR APPROVED EQUAL.

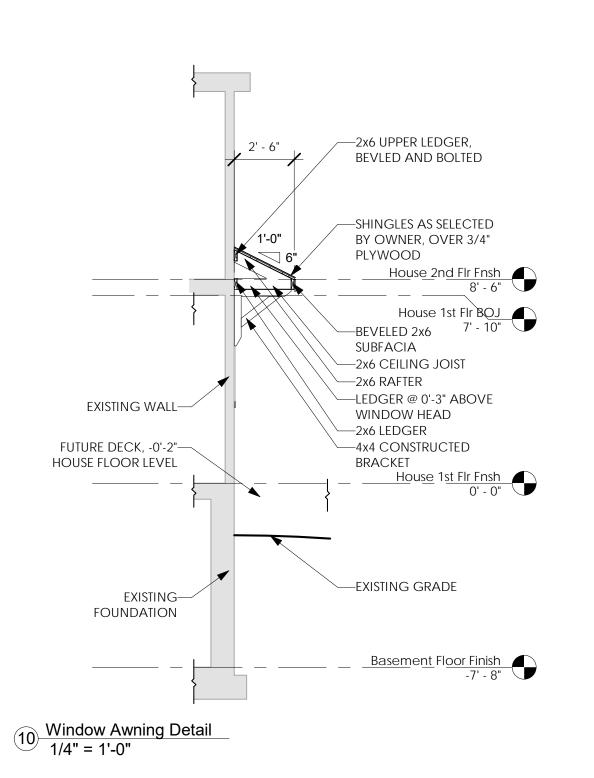

	Issued:	Date:
Α	Issued for Client Review	11/04/22
В	Issued for Client Review	11/07/22
C	Issued for Bid Permit	11/07/22
	Revisions:	Date:
1		

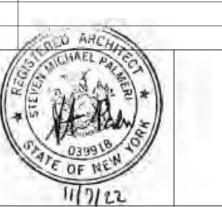

Designer Name

Project Architect/Engineer Date:

Architect/Engineer Name

Project Lead Date:

Project Designer Date:

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Young Residence Addition

2490 Lehigh Station Rd Pittsford, NY 14534 Monroe County

Project Name & Location:

Roof Framing, Plan & Truss Diagram

Drawing Name:

Date: 11/07/22


Type: Residential 21-0511


Project No.

Drawn By: NMH A-103


Scale: As Noted Drawing No.

MOTTED: 2/2/2003 B:4E:50 AN

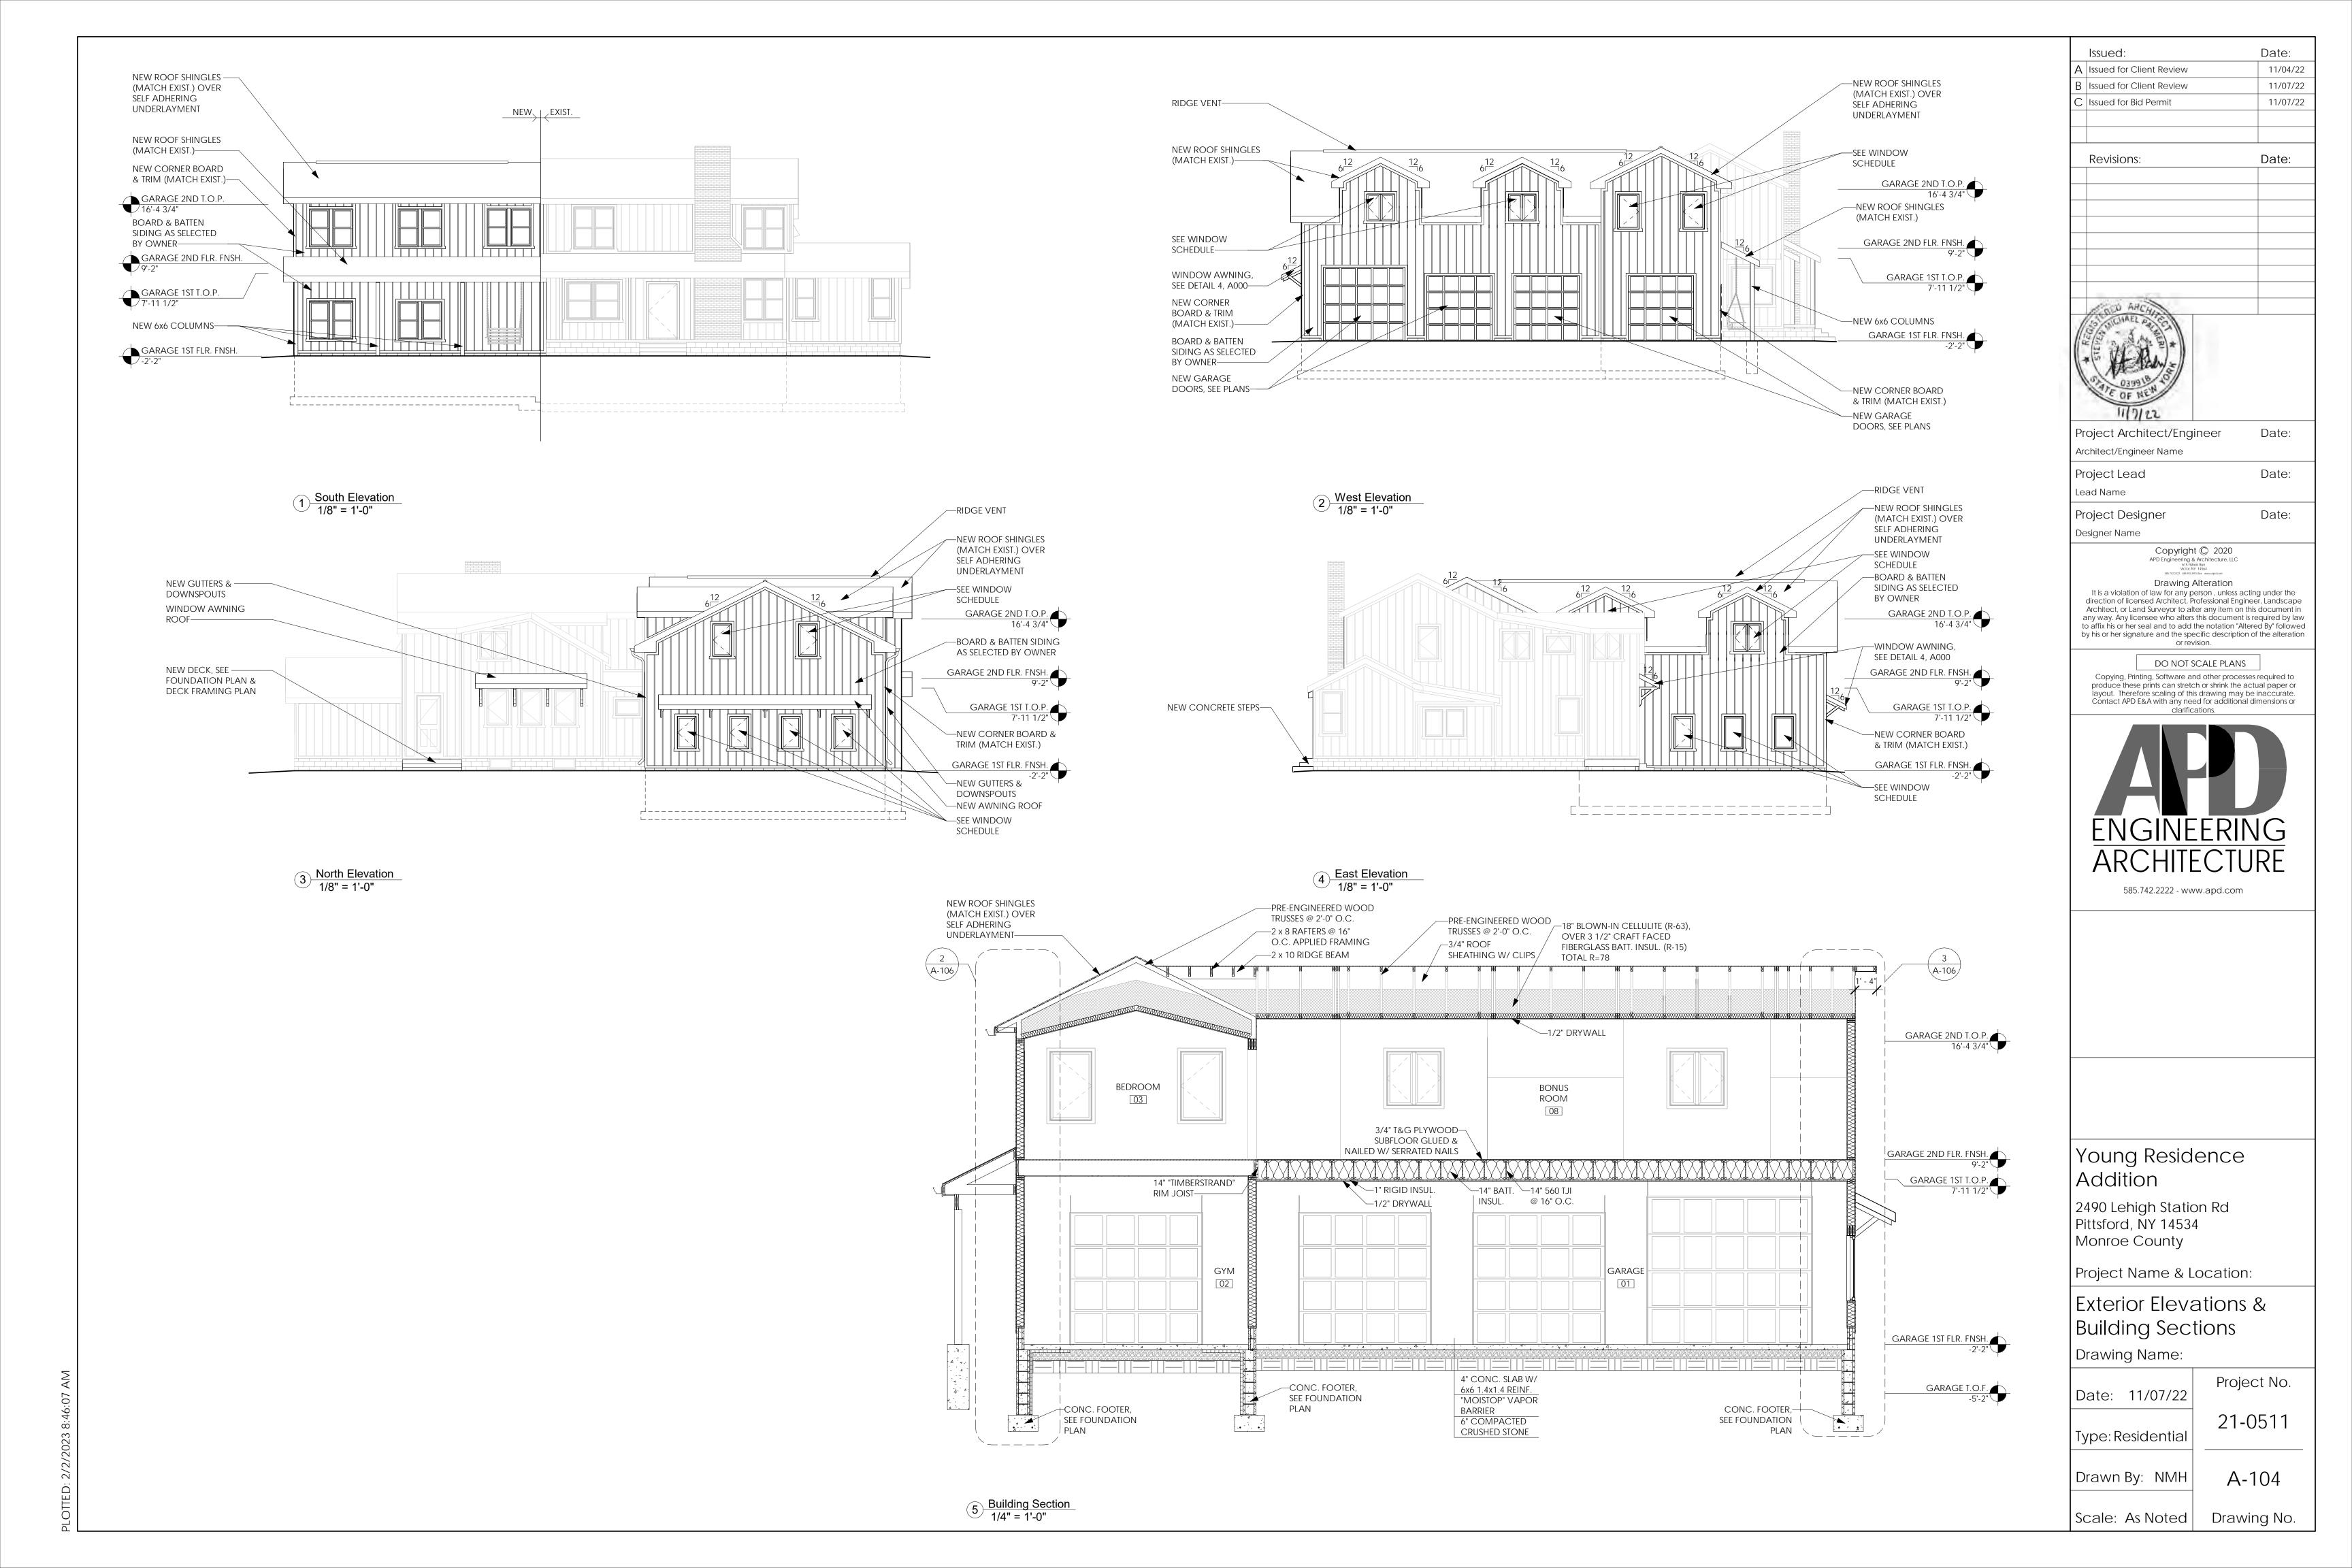

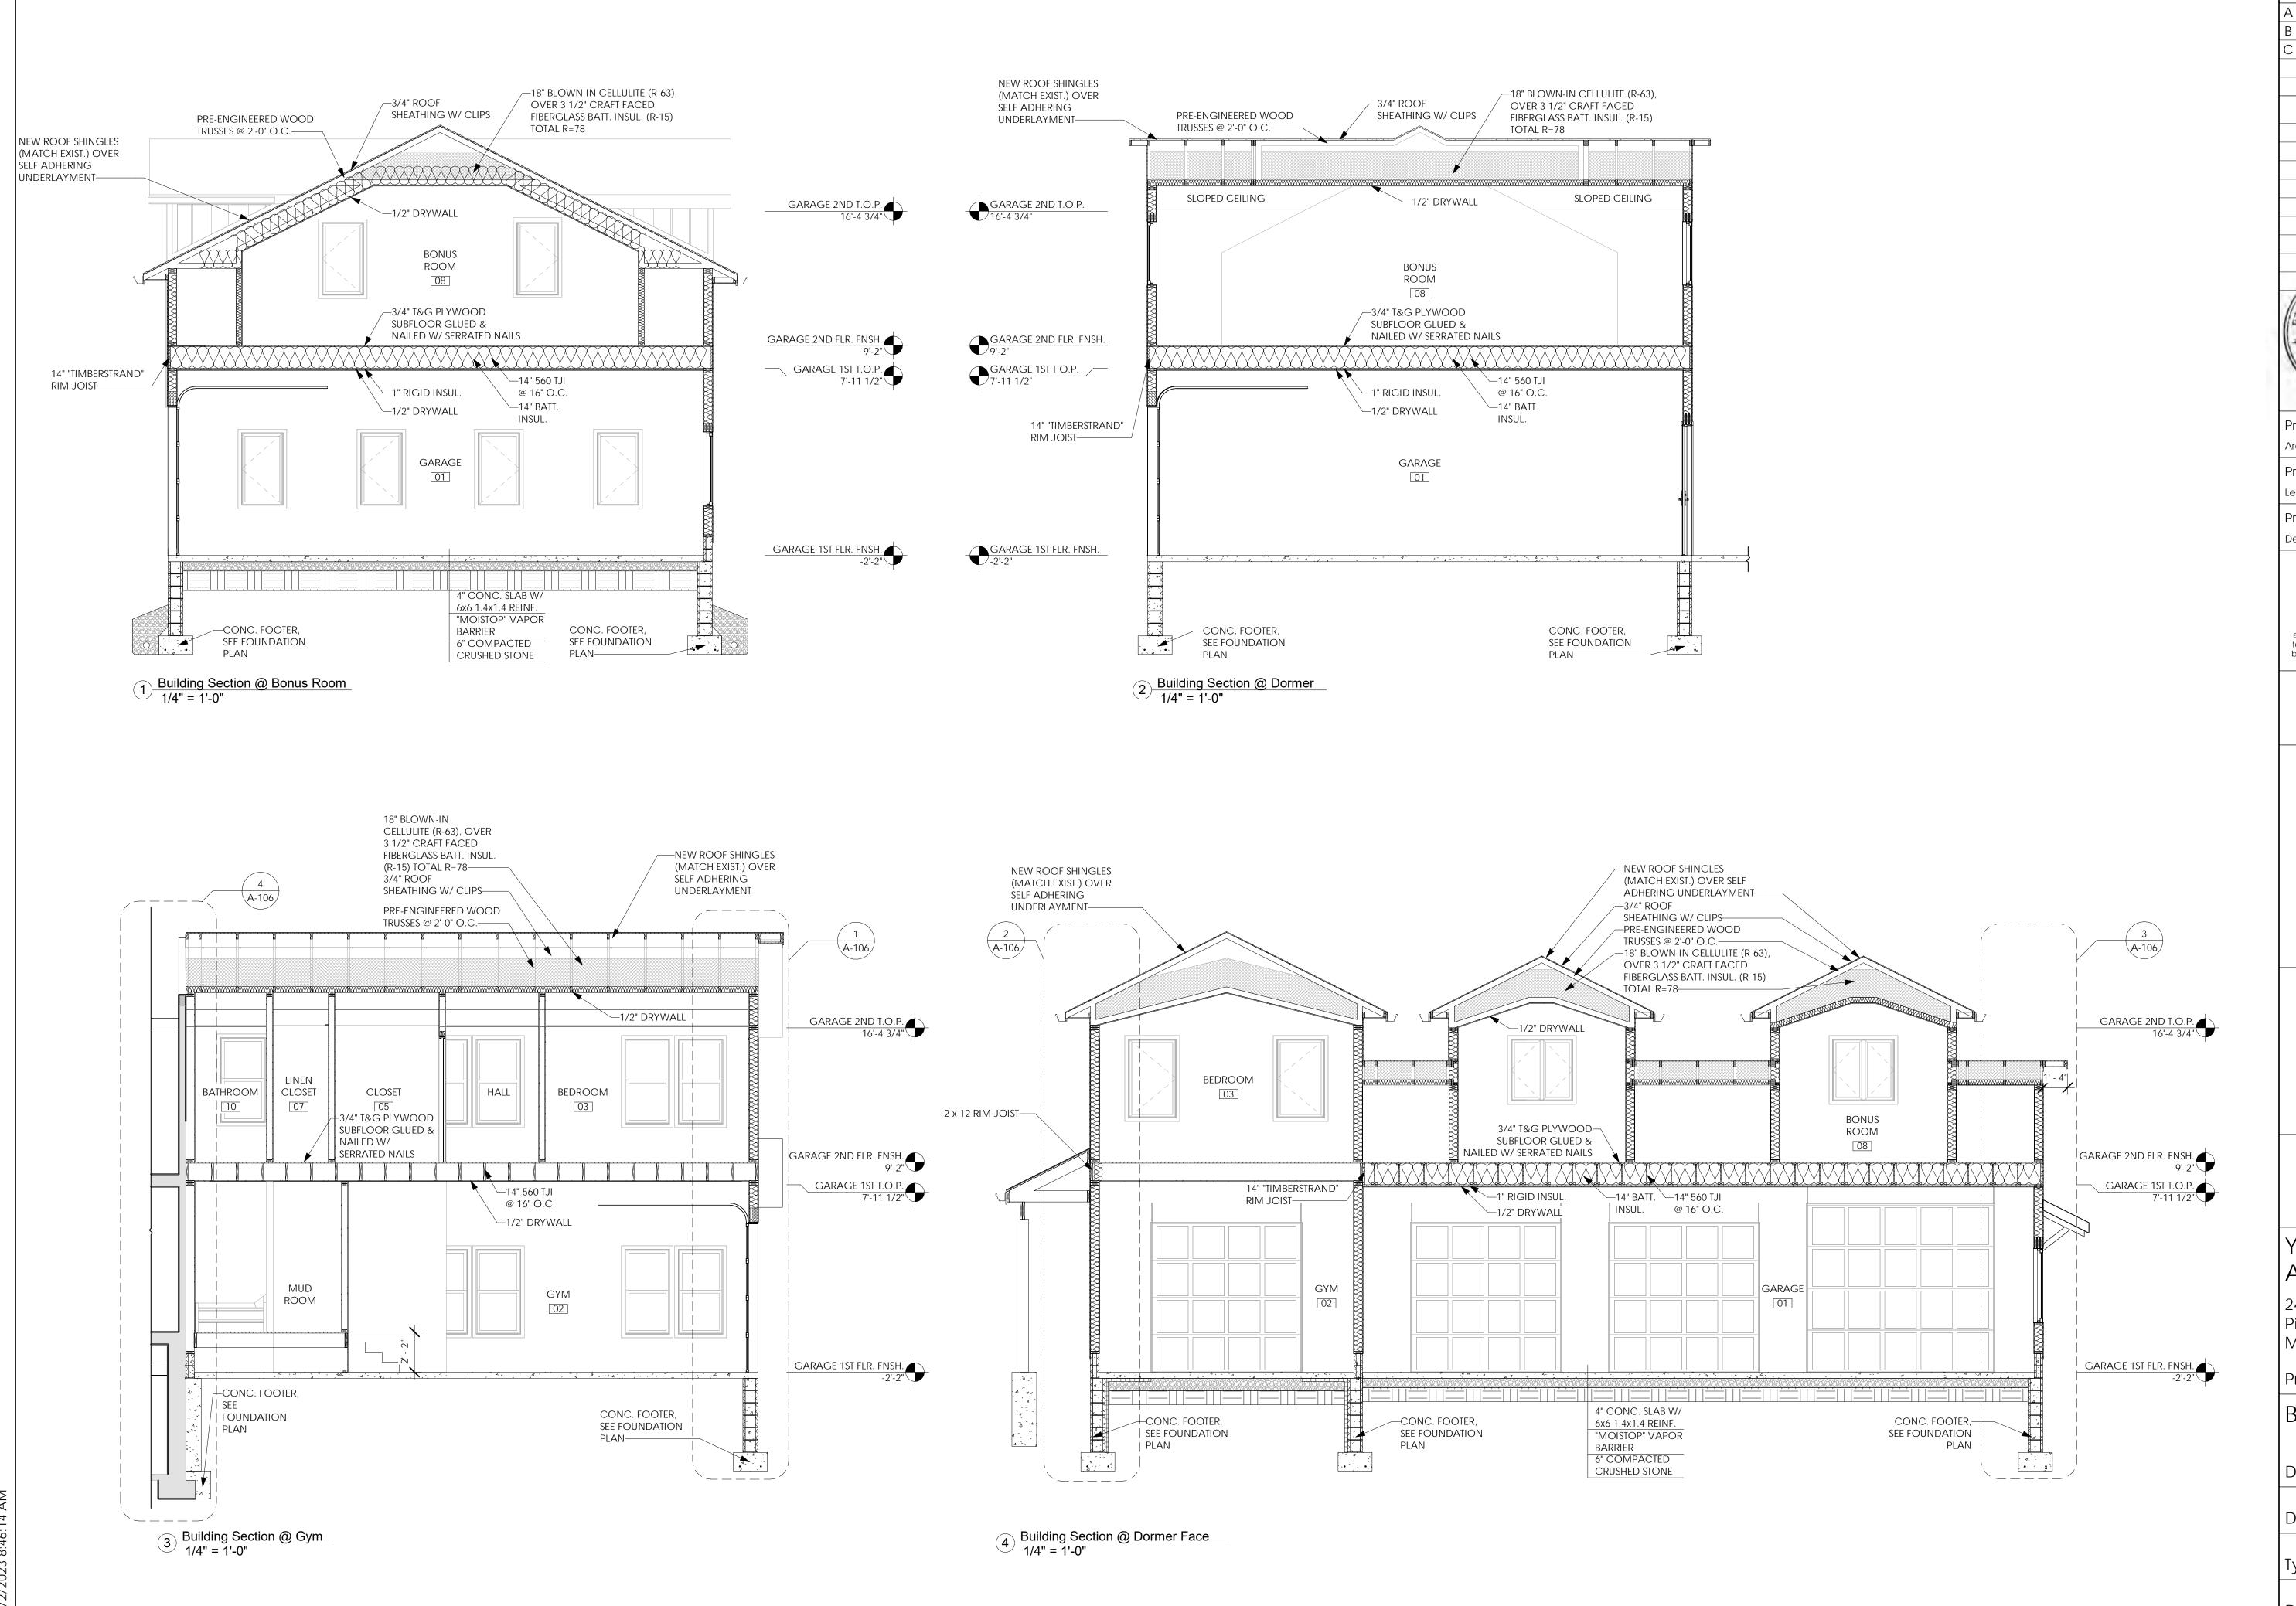

Date: Issued: 11/04/22 A Issued for Client Review 11/07/22 Issued for Client Review Issued for Bid Permit 11/07/22 Date: Revisions: Project Architect/Engineer Date: Architect/Engineer Name Date: Project Lead Lead Name Date: Project Designer Designer Name Copyright © 2020 APD Engineering & Architecture, LLC 615 Rshers Run Victor, NY 14564 5857422222 Seb-9244914 fax www.apd.com Drawing Alteration It is a violation of law for any person , unless acting under the direction of licensed Architect, Professional Engineer, Landscape Architect, or Land Surveyor to alter any item on this document in any way. Any licensee who alters this document is required by law to affix his or her seal and to add the notation "Altered By" followed by his or her signature and the specific description of the alteration or revision. DO NOT SCALE PLANS Copying, Printing, Software and other processes required to produce these prints can stretch or shrink the actual paper or layout. Therefore scaling of this drawing may be inaccurate. Contact APD E&A with any need for additional dimensions or

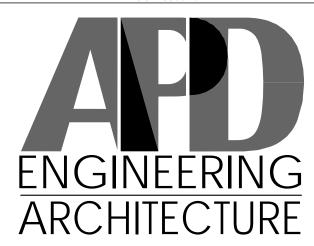

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Young Residence Addition

2490 Lehigh Station Rd Pittsford, NY 14534 Monroe County

Project Name & Location:


Building Sections

Drawing Name: Project No. Date: 11/07/22 21-0511 Type: Residential


Drawn By: NMH A-105

Scale: As Noted

Drawing No.

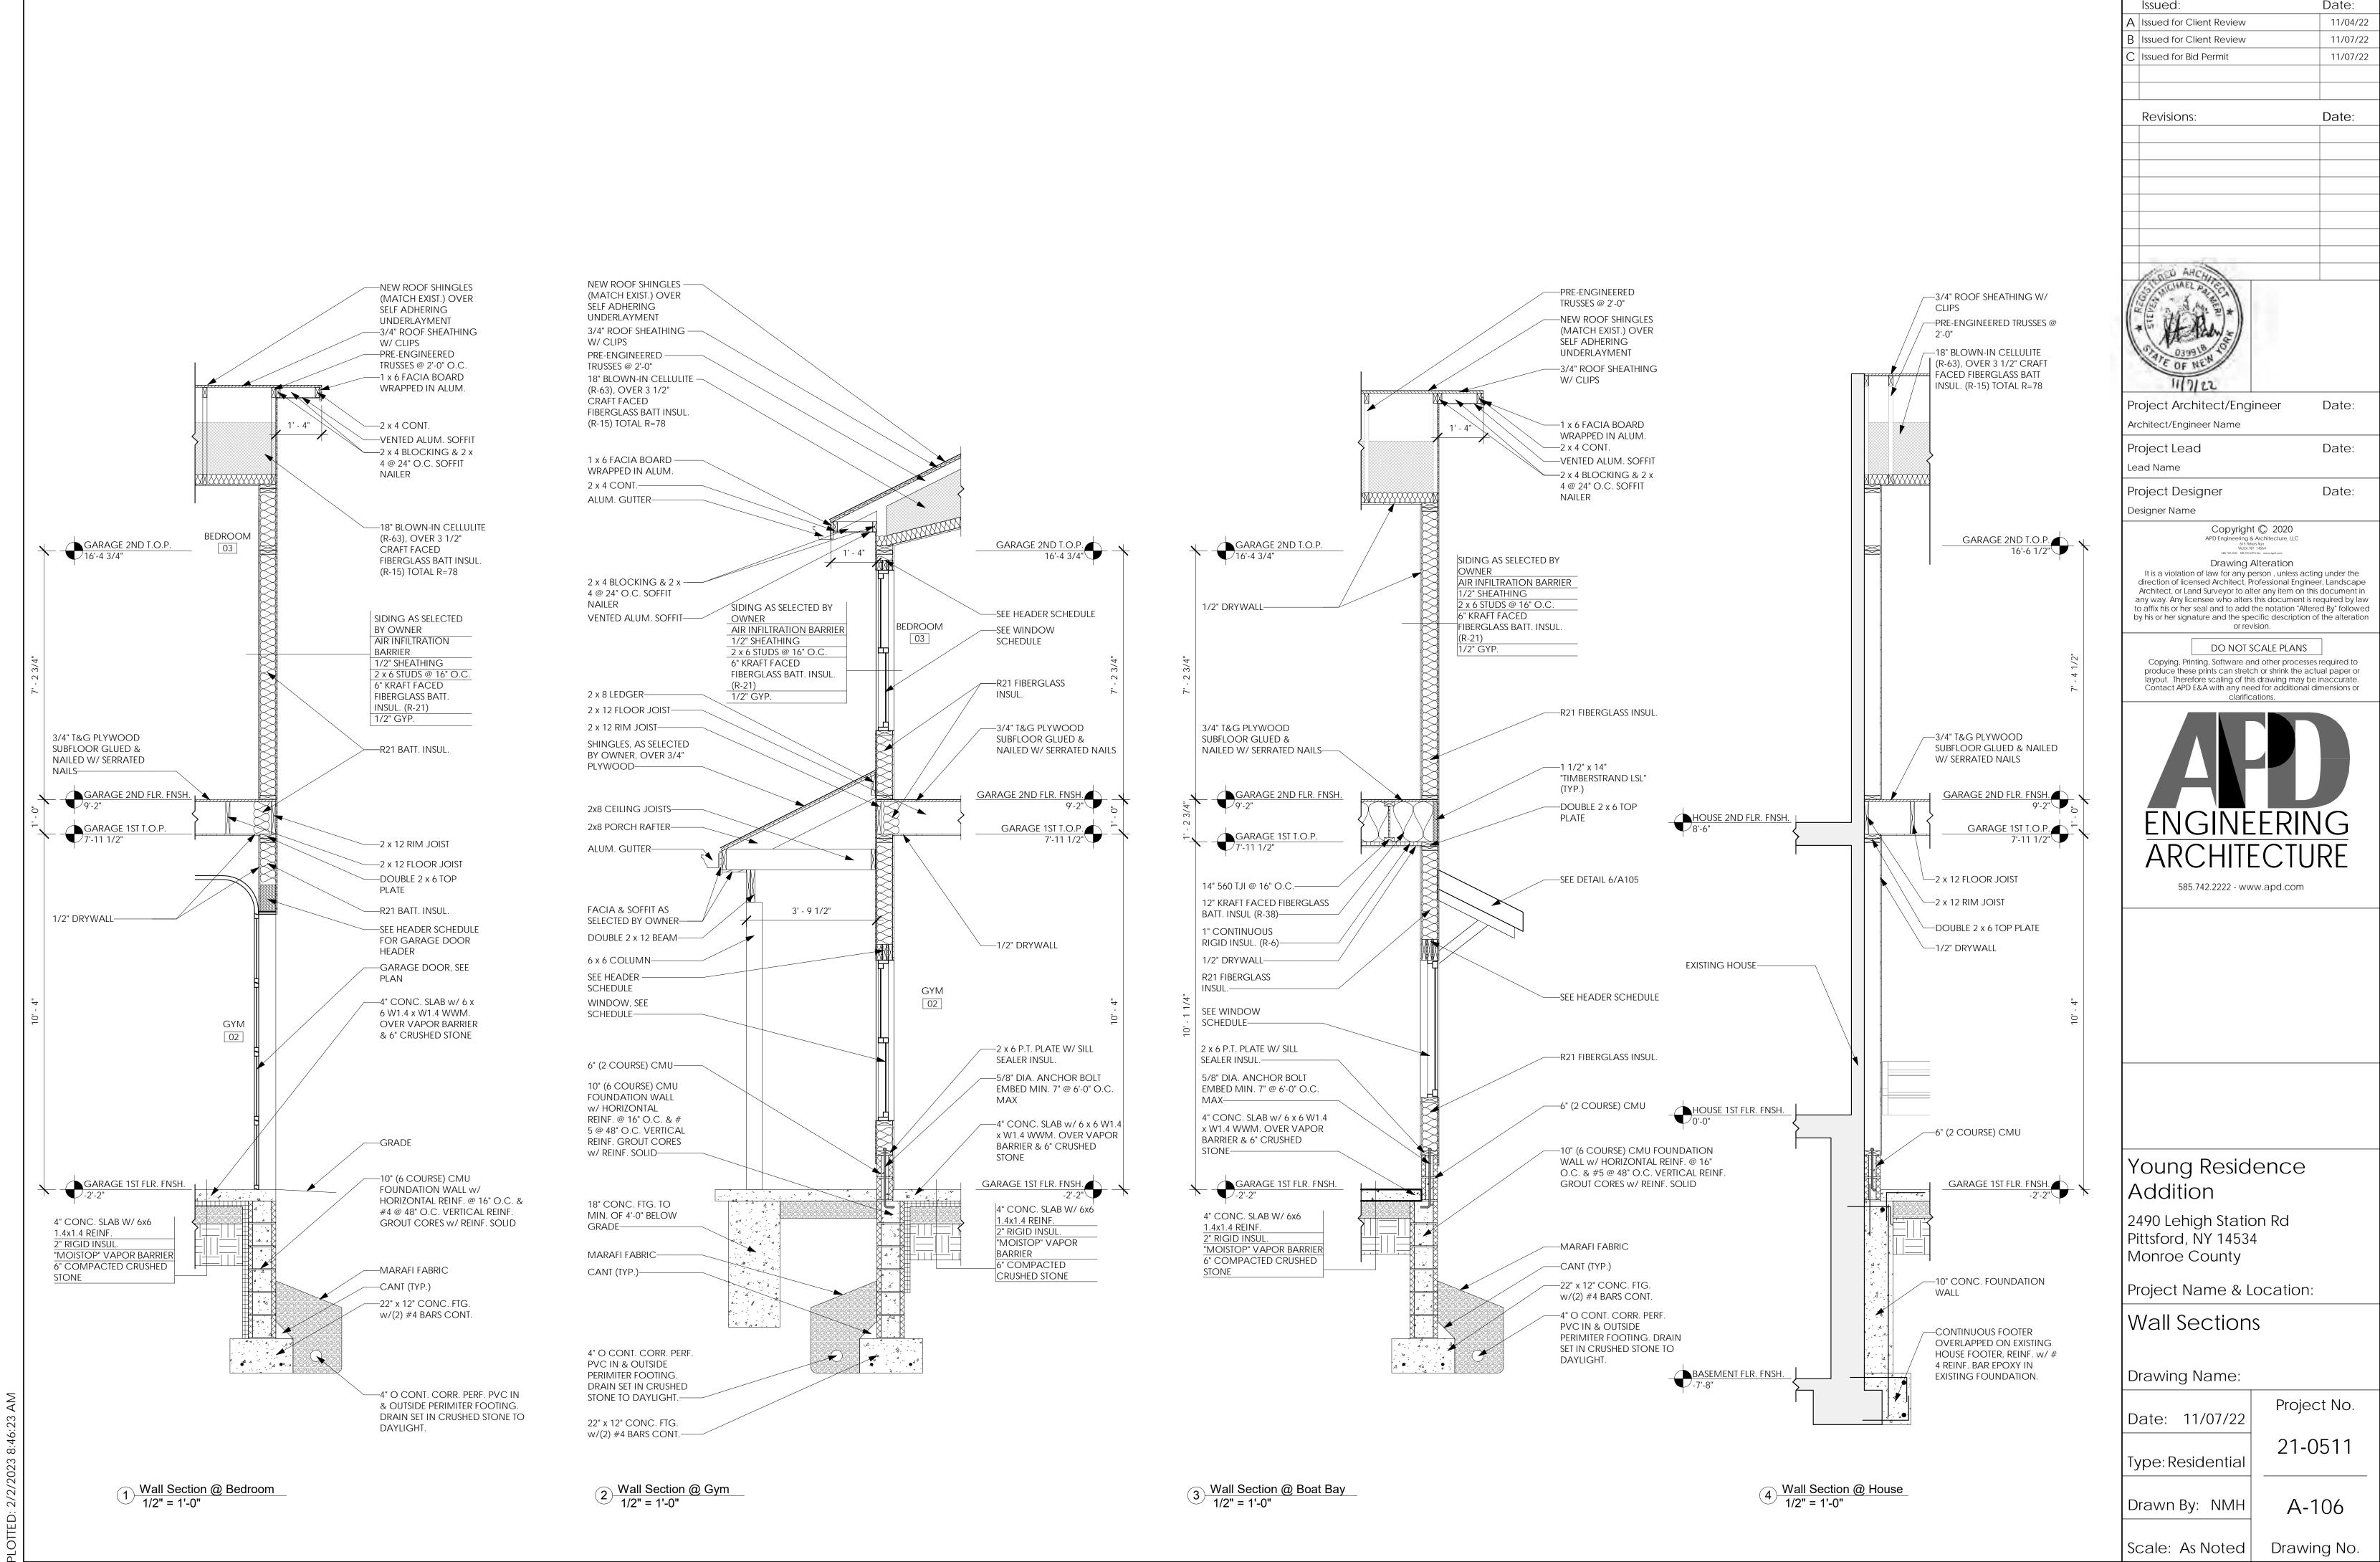

Date:

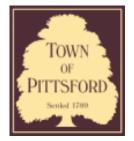

Town of Pittsford

Department of Public Works 11 South Main Street Pittsford, New York 14534

Permit # D23-00001

Phone: 585-248-6250 FAX: 585-248-6262

DESIGN REVIEW AND HISTORIC PRESERVATION BOARD REFERRAL OF APPLICATION

Property Address: 114 Sunset Boulevard PITTSFORD, NY 14534

Tax ID Number: 164.10-4-23

Zoning District: RN Residential Neighborhood

Owner: Sarajlic, Vedrana Applicant: Sarajlic, Vedrana


Application Type	Α	qq	licat	ion	Typ	e:
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hh	iication type.	
~	Residential Design Review	Build to Line Adjustment
	§185-205 (B)	§185-17 (B) (2)
	Commercial Design Review	Building Height Above 30 Feet
	§185-205 (B)	§185-17 (M)
	Signage	Corner Lot Orientation
	§185-205 (C)	§185-17 (K) (3)
	Certificate of Appropriateness	Flag Lot Building Line Location
	§185-197	§185-17 (L) (1) (c)
	Landmark Designation	Undeveloped Flag Lot Requirements
	§185-195 (2)	§185-17 (L) (2)
	Informal Review	

Project Description: In accordance with Chapter 64 Article VIII, §64-43 of the Pittsford Town Code, the owner of 114 Sunset Boulevard is requesting approval from the Design Review and Historic Preservation Board to demolish the existing 1,872 square foot home at 114 Sunset Boulevard and rebuild a new 3,180 +/- square foot single family home on the property. Tax Parcel No. 164.10-4-23. This property is Zoned Residential Neighborhood (RN).

Meeting Date: March 09, 2023

RN Residential Neighborhood Zoning

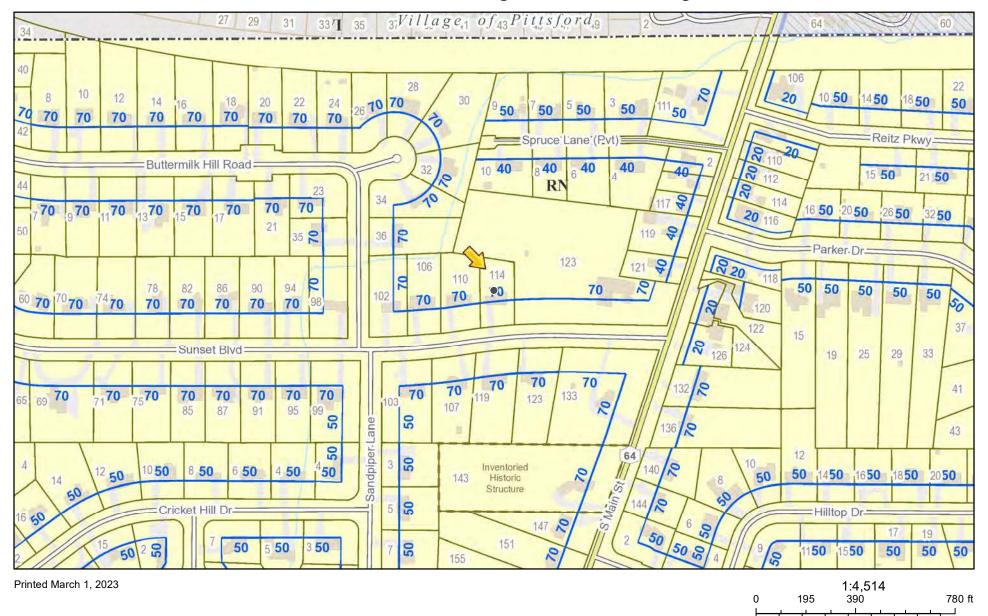


Town of Pittsford GIS

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110


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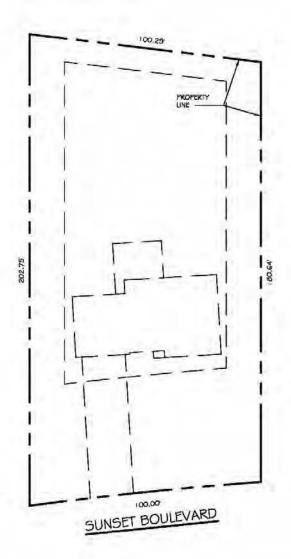





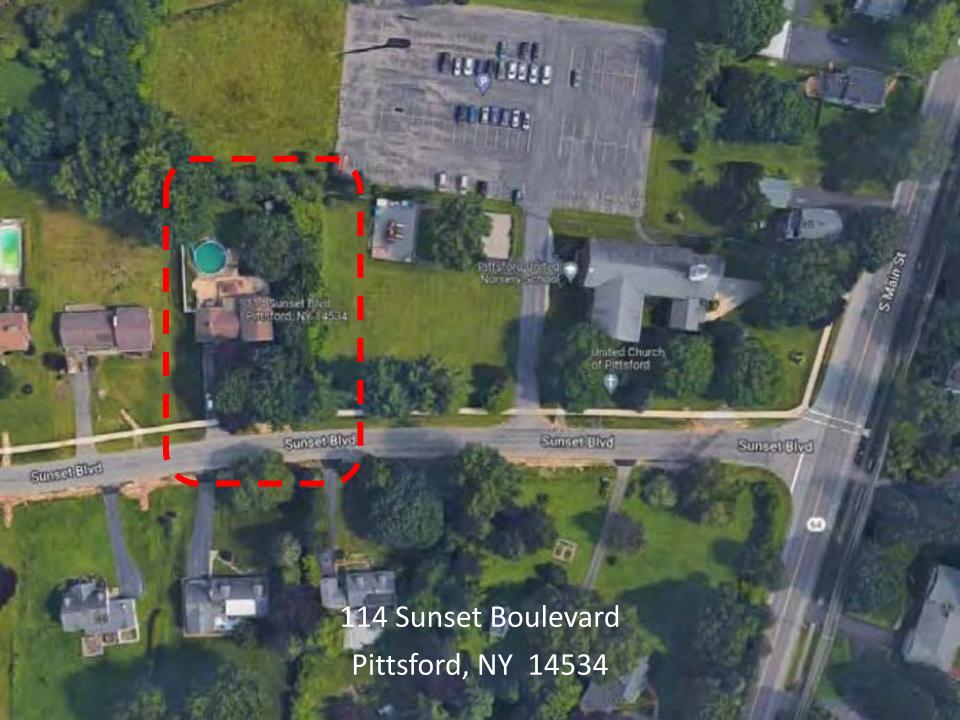







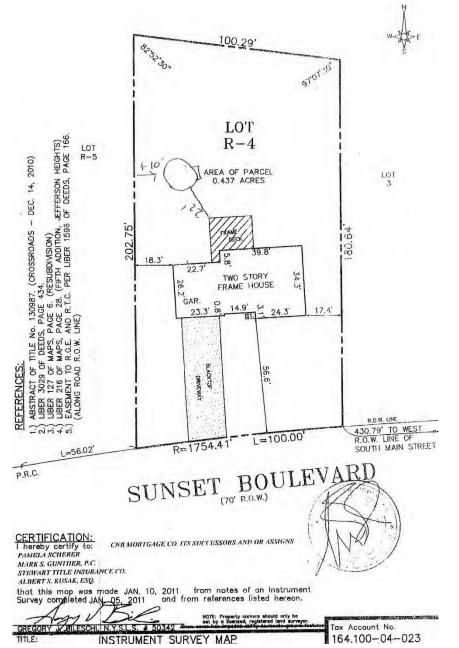

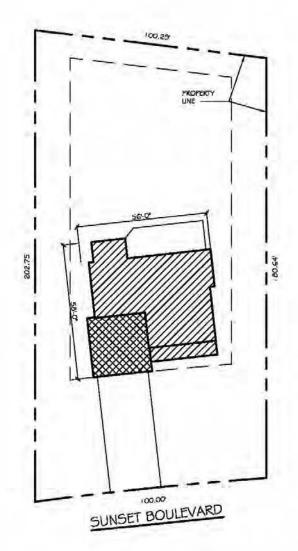


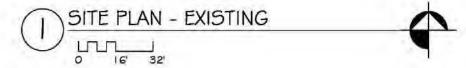

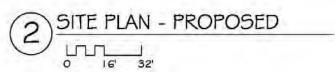






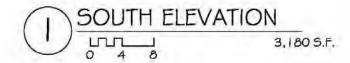






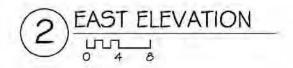






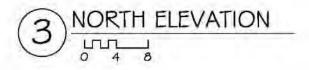






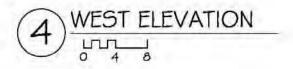




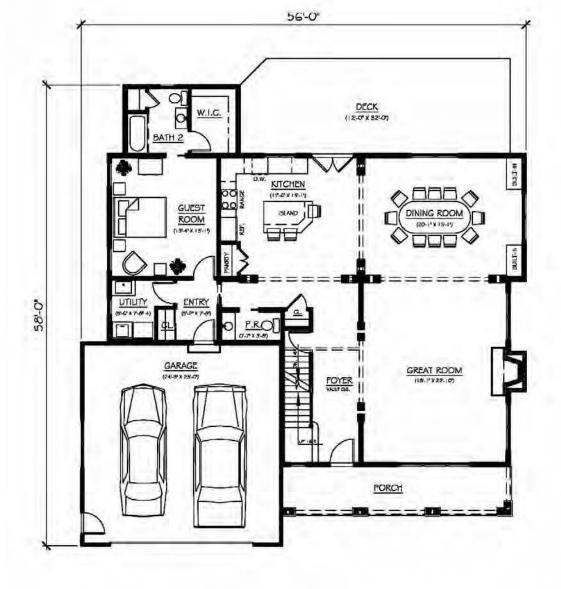







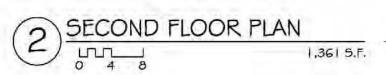










DEAN



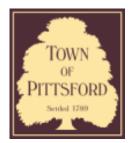

Town of Pittsford

Department of Public Works 11 South Main Street Pittsford, New York 14534

Permit # B23-000029

Phone: 585-248-6250 FAX: 585-248-6262

DESIGN REVIEW AND HISTORIC PRESERVATION BOARD REFERRAL OF APPLICATION

Property Address: 82 Reitz PITTSFORD, NY 14534

Tax ID Number: 164.11-2-5

Zoning District: RN Residential Neighborhood

Owner: Boyce, Martha Cushman Applicant: Stagliano Builders

Application	Ty	oe:
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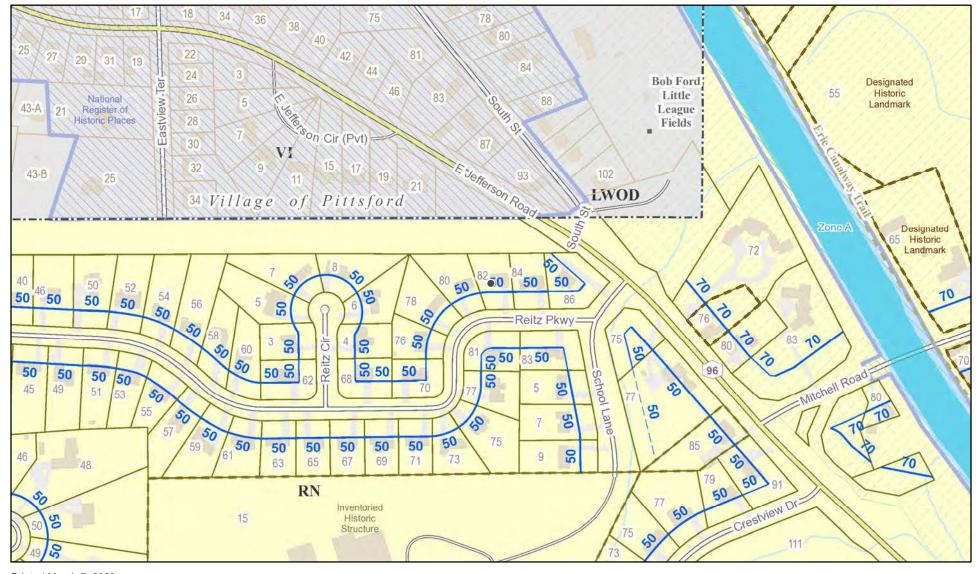
אאי	noution typo:	
✓	Residential Design Review §185-205 (B)	Build to Line Adjustment §185-17 (B) (2)
	Commercial Design Review §185-205 (B)	Building Height Above 30 Feet §185-17 (M)
	Signage §185-205 (C)	Corner Lot Orientation §185-17 (K) (3)
	Certificate of Appropriateness §185-197	Flag Lot Building Line Location §185-17 (L) (1) (c)
	Landmark Designation §185-195 (2)	Undeveloped Flag Lot Requirements §185-17 (L) (2)
	Informal Review	

Project Description: Applicant is requesting design review for the construction of a covered entryway off the front of the house.


Meeting Date: March 23, 2023



RN Residential Neighborhood Zoning




Printed March 7, 2023

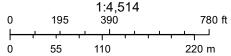

Town of Pittsford GIS

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Existing House Existing Front entrance steps Boyce Home

APPROVED BY:

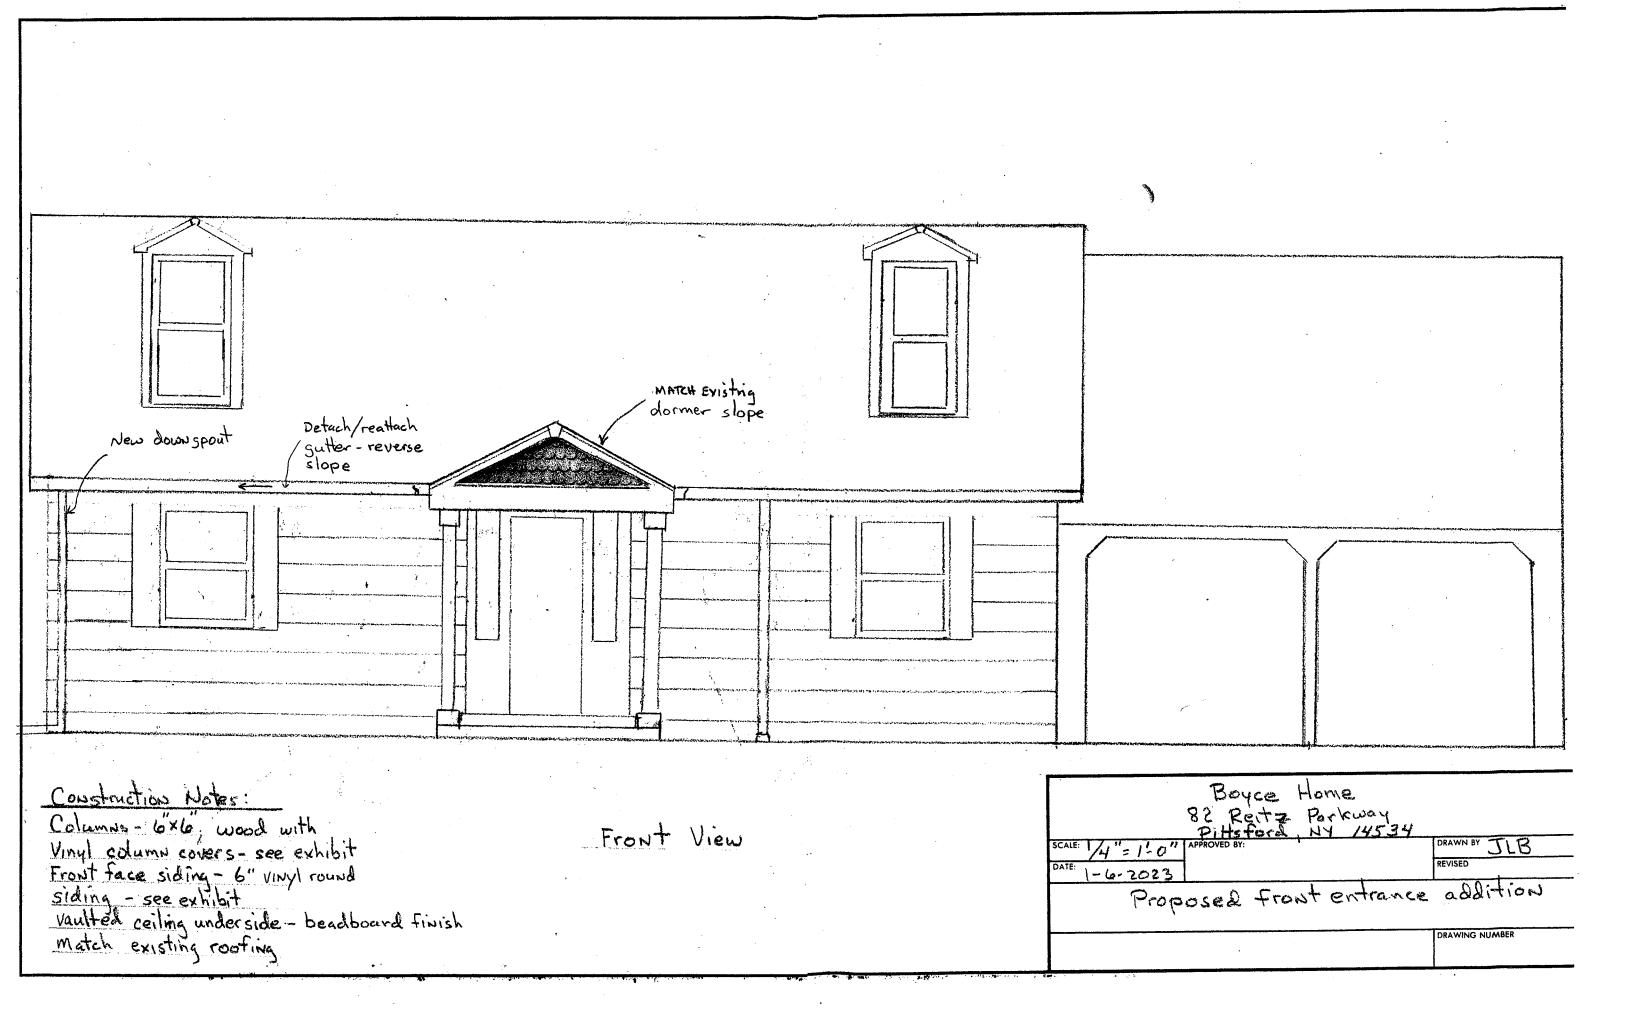14" = 1'-0"

1-6-5023

END VIEW

DRAWN BY

DRAWING NUMBER


REVISED

118







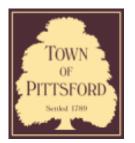

Town of Pittsford

Department of Public Works 11 South Main Street Pittsford, New York 14534

Permit # B23-000031

Phone: 585-248-6250 FAX: 585-248-6262

DESIGN REVIEW AND HISTORIC PRESERVATION BOARD REFERRAL OF APPLICATION

Property Address: 180 Alpine Drive ROCHESTER, NY 14618

Tax ID Number: 151.06-2-28

Zoning District: RN Residential Neighborhood

Owner: Cottrell, Brandon

Applicant: Rochester Bath and Kitchen

Application Type:

, PP	iication Type.	
✓	Residential Design Review §185-205 (B)	Build to Line Adjustment §185-17 (B) (2)
	Commercial Design Review §185-205 (B)	Building Height Above 30 Feet §185-17 (M)
	Signage §185-205 (C)	Corner Lot Orientation §185-17 (K) (3)
	Certificate of Appropriateness §185-197	Flag Lot Building Line Location §185-17 (L) (1) (c)
	Landmark Designation §185-195 (2)	Undeveloped Flag Lot Requirements §185-17 (L) (2)
	Informal Review	

Project Description: Applicant is requesting design review for the removal of two windows as part of their kitchen and bath remodel project.


Meeting Date: March 23, 2023



RN Residential Neighborhood Zoning




Printed March 16, 2023

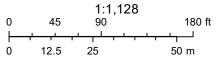


Town of Pittsford GIS




PROJECT LOCATION: 180 ALPINE DRIVE ROCHESTER, NY 14618 (IMAGE SOURCE: GOOGLE MAPS)

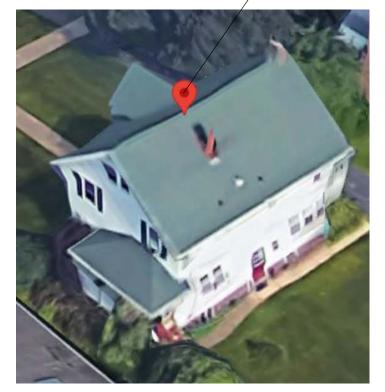

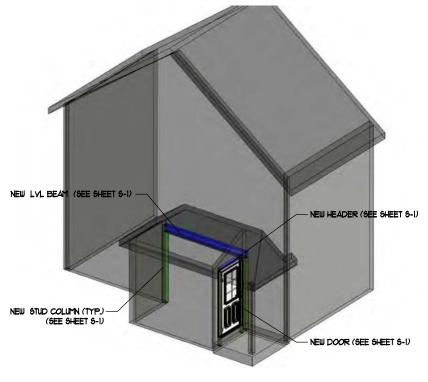



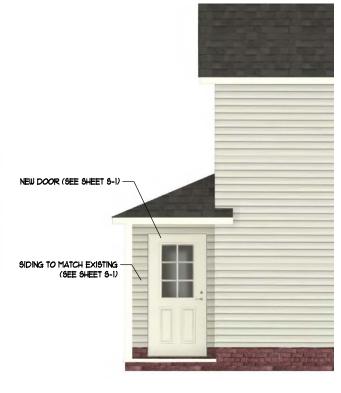

SCALE: N.T.S.

STRUCTURAL PERSPECTIVE
SCALE: N.T.S.

RENDERED PERSPECTIVE

SCALE: N.T.S.





Torchia Structural Engineering & Design P.C.

625 Panorama Trail Suite #2210 Rochester, NY 14625 www.TSE123.com

Phone: 585-385-7630 Fax: 585-385-6386

Interior Alterations to: The Cottrell Residence

S-2

GENERAL/STRUCTURAL NOTES:

I. GENERAL NOTES

- 1. THE BUILDING CODE USED IS THE 2020 RESIDENTIAL CODE OF NEW YORK STATE AND THE 2020 NYS ECCC. ALL EDITIONS OF APPLICABLE CODES AND STANDARDS SHALL BE THOSE WITHIN THE 2020 RCNYS.
- CONTRACTOR TO VERIFY ALL NOTES AND DIMENSIONS BEFORE STARTING CONSTRUCTION CONTACT ENGINEER IF ERRORS OR OMISSIONS ARE FOUND.
- 3. CONTRACTOR TO BE RESPONSIBLE FOR CONSTRUCTION MEANS, METHODS, TECHNIQUES, SEQUENCES, PROCEDURES, AND SAFETY PRECAUTIONS IN CONNECTION WITH THE WORK.
- 4. PRIOR TO THE REMOVAL WORK, CONTRACTOR SHALL PROVIDE SHORING AS REQ'D. TO PERFORM THE WORK AS OUTLINED IN THIS DRAWING. SHORING IS CONSIDERED MEANS & METHODS AND THEREFORE, IS THE RESPONSIBILITY OF THE CONTRACTOR.
- 5. CONTRACTOR TO BE RESPONSIBLE FOR CONSTRUCTION MEANS, METHODS, TECHNIQUES, SEQUENCES, PROCEDURES, AND SAFETY PRECAUTIONS IN CONNECTION WITH THE WORK
- 6. FINISHES AS SELECTED BY OWNER.
- 1. DESIGN OF HYAC, PLUMBING AND ELECTRICAL WORK ARE BY OTHERS.
- 8. REPLACE ANY SMOKE ALARMS AND CARBON MONOXIDE DETECTORS THAT ARE REMOVED DURING ALTERATIONS, INSTALL AS PER THE RESIDENTIAL CODE OF NYS.

 Wood dimensional lumber to be Hem-Fir *2 (or equal), with minimum NDS reference design values equal to:

Bending $(F_b) = 850 \text{ psi}$ Compression Parallel to Grain $(F_c) = 1,300 \text{ psi}$ Modulus of Elasticity (E) = 1,300,000 psiMin. Modulus of Elasticity $(E_{MIN}) = 470,000 \text{ psi}$ Shear Parallel to Grain $(F_v) = 150 \text{ psi}$


2. Microllam / LVL beams to meet minimum reference design values equal to:

Bending $(F_b) = 2,600$ psi $(F_c) = 2,500$ psi $(F_c) = 2,500$ psi $(F_c) = 2,500$ psi $(F_c) = 2,000,000$ psi $(F_c) = 2,000,000$ psi $(F_c) = 2,000,000$ psi $(F_c) = 2,000,000$ psi $(F_c) = 1,016,535$ psi $(F_c) = 2,85$ psi $(F_c) = 2,85$ psi

- ALL INTERIOR, COVERED FRAMING LUMBER TO BE KILN DRIED, WITH A MAXIMUM MOISTURE CONTENT (MC) OF 19%.
- 4. THE GENERAL CONTRACTOR SHALL REJECT ALL POOR QUALITY LUMBER THAT IS NOT SUITABLE FOR ITS INTENDED PURPOSE. REGARDLESS OF GRADE.
- 5. PROVIDE SOLID BLOCKING UNDER ALL BEAMS AND HEADER SUPPORTS DOWN TO MASONRY WALL OR BEAMS.
- 6. WOOD IN CONTACT WITH MASONRY, CONC. OR EARTH OR WITHIN 1'-0" OF GRADE & EXPOSED SHALL BE PRESSURE TREATED.
- FRAMING ANCHORS, JOIST HANGER, ETC. SHALL BE GALVANIZED STEEL (16 GA. MIN.) INSTALL IN STRICT ACCORDANCE WITH MFR'S INSTRUCTIONS, INCLUDING MFR'S SPECIFIED FASTENERS. PROVIDE PRODUCTS BY "SIMPSOM CO." OR APPROVED PROPOSED SUBSTITUTE.
- 8. WALL SHEATHING AT EXTERIOR WALLS: 1/2" EXTERIOR GRADE APA RATED CDX PLYWOOD.

REMOVALS GENERAL NOTES:

- I. IT IS THE CONTRACTOR'S RESPONSIBILITY TO FAMILIARIZE THEMSELVES WITH ALL DETAILS INVOLVED IN SELECTIVE DEMOLITION. SPECIFIC INSTRUCTIONS ON EACH ITEM WILL NOT BE GIVEN.
- 2. THE CONTRACTOR SHALL BE RESPONSIBLE FOR THE SALVAGE OF EXISTING MATERIALS AS REQUIRED FOR PATCHING EXISTING AREAS TO REMAIN. WHEREVER REMOVALS OCCUR, DISTURBED SURFACES SHOULD BE PATCHED TO MATCH ADJACENT EXISTING.
- THE CONTRACTOR SHALL MAINTAIN SAFE ACCESS TO ALL DESIGNATED EXITS FOR THE BUILDING OCCUPANTS DURING CONSTRUCTION.
- 4. REMOVALS SHOWN ARE NOT NECESSARILY
 ALL-INCLUSIVE. REMOVE ALL ITEMS AS REQUIRED
 TO PROVIDE THE COMPLETE FINISHED
 CONSTRUCTION AS SHOWN ON THE FULL SET OF
 DRAWINGS.
- 5. STORAGE FOR CONTRACTOR'S EQUIPMENT AND DEBRIS MUST BE KEPT INSIDE THE CONTRACT AREA.
- 6. DUMPSTERS FOR CONSTRUCTION DEBRIS ARE TO BE PROVIDED BY CONTRACTOR. ALL DEBRIS TO BE HAULED OFF SITE BY CONTRACTOR.
- 1. REMOVAL OF ELECTRICAL, PLUMBING, AND HVAC ITEMS WITHIN ARCHITECTURAL ELEMENTS SHOWN TO BE REMOVED SHALL BE BY THOSE TRADES. G.C. TO COORDINATE.
- 8. ALL DISCREPANCIES AND/OR UNFORESEEN CONDITIONS EXPOSED BY DEMOLITION WORK SHALL BE REPORTED TO THE ENGINEER IMMEDIATELY.
- 9. BEFORE BEGINNING REMOVALS, V.I.F. THAT ELEMENTS TO BE REMOVED ARE NOT LOADBEARING. PROVIDE SHORING AS REQ'D. DETERMINATION AS TO ANY NEED FOR SHORING. SHORING IS CONSIDERED MEANS AND METHODS THEREFORE, DESIGN OF ANY SHORING IS THE SOLE RESPONSIBILITY OF THE G.C.

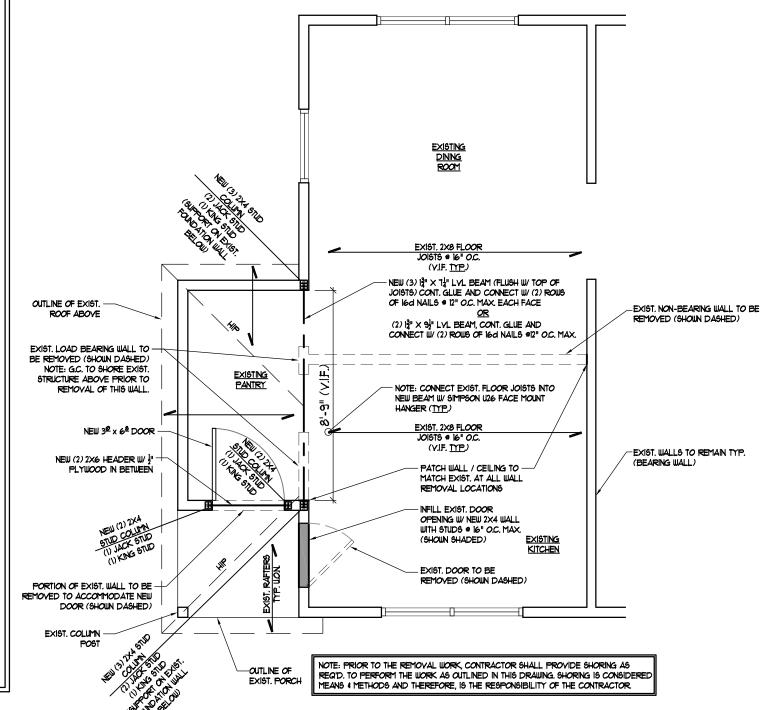

FIRST FLOOR / SECOND FLOOR & LOWER

ROOF FRAMING & REMOVALS PLAN

SCALE: 1/4"=1'-@





Torchia Structural Engineering & Design P.C.


625 Panorama Trail Suite #2210 Rochester, NY 14625


Phone: 585-385-7630 Fax: 585-385-6386 www.TSE123.com Interior Alterations to: The Cottrell Residence






180 ALPINE DRIVE ROCHESTER, NY 14618

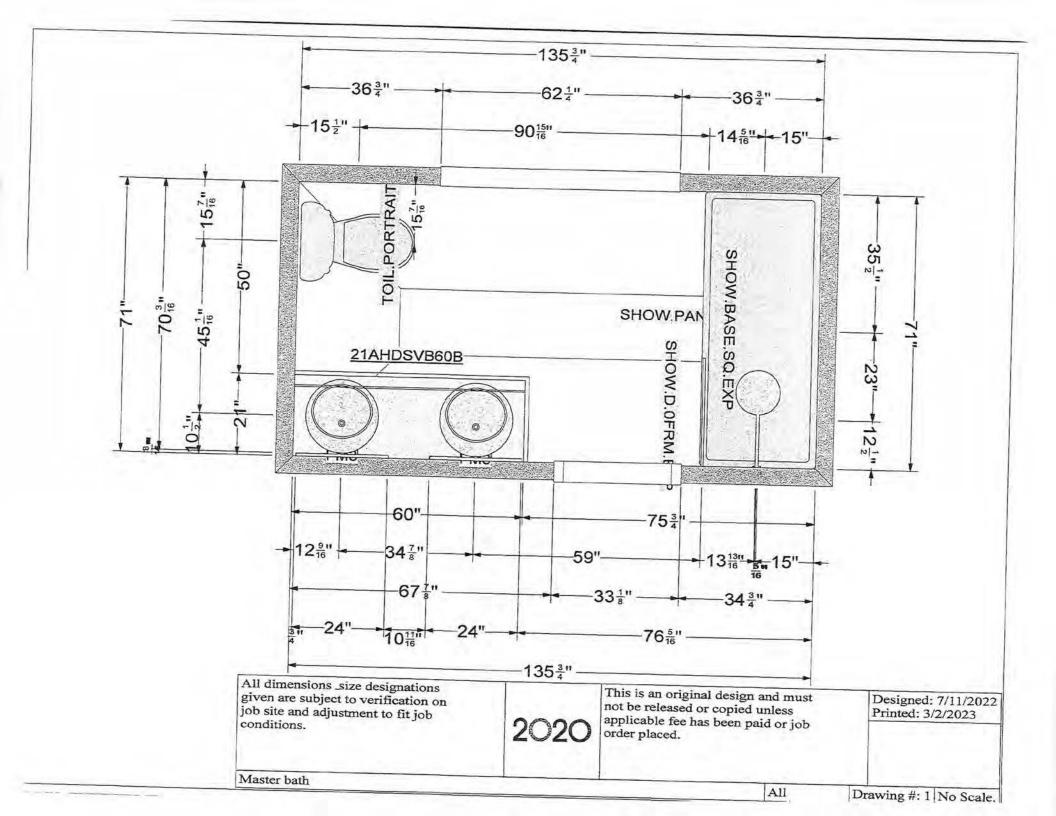

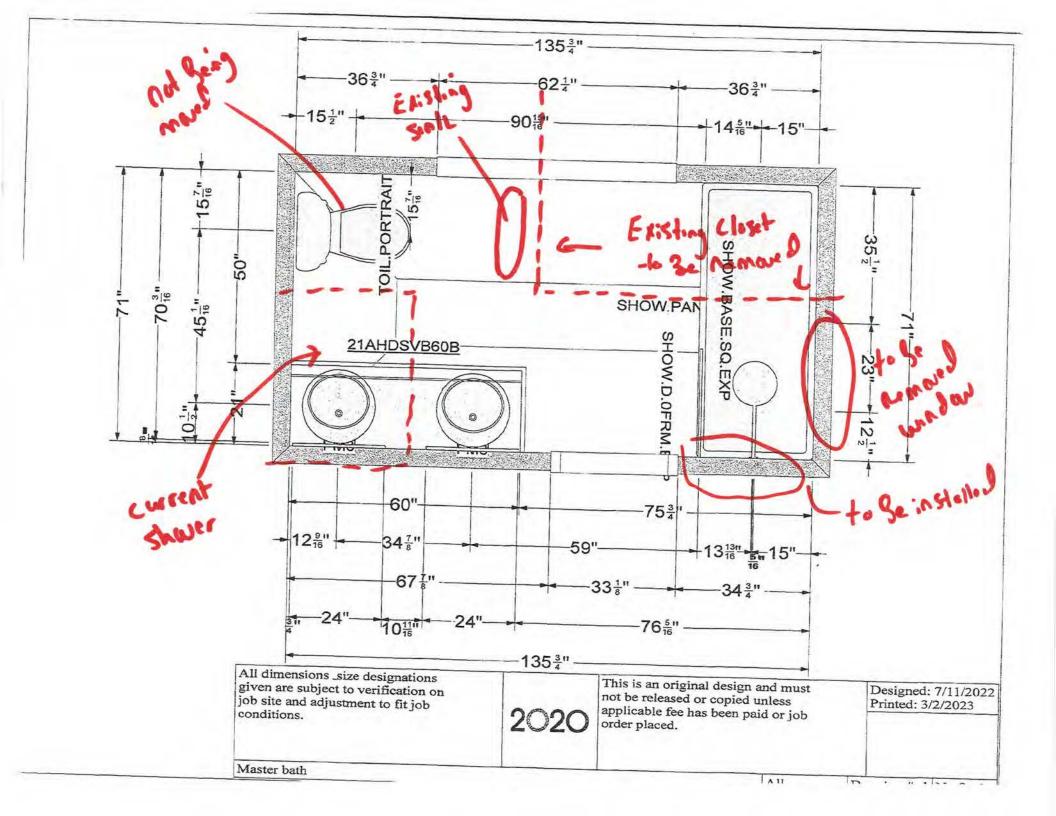

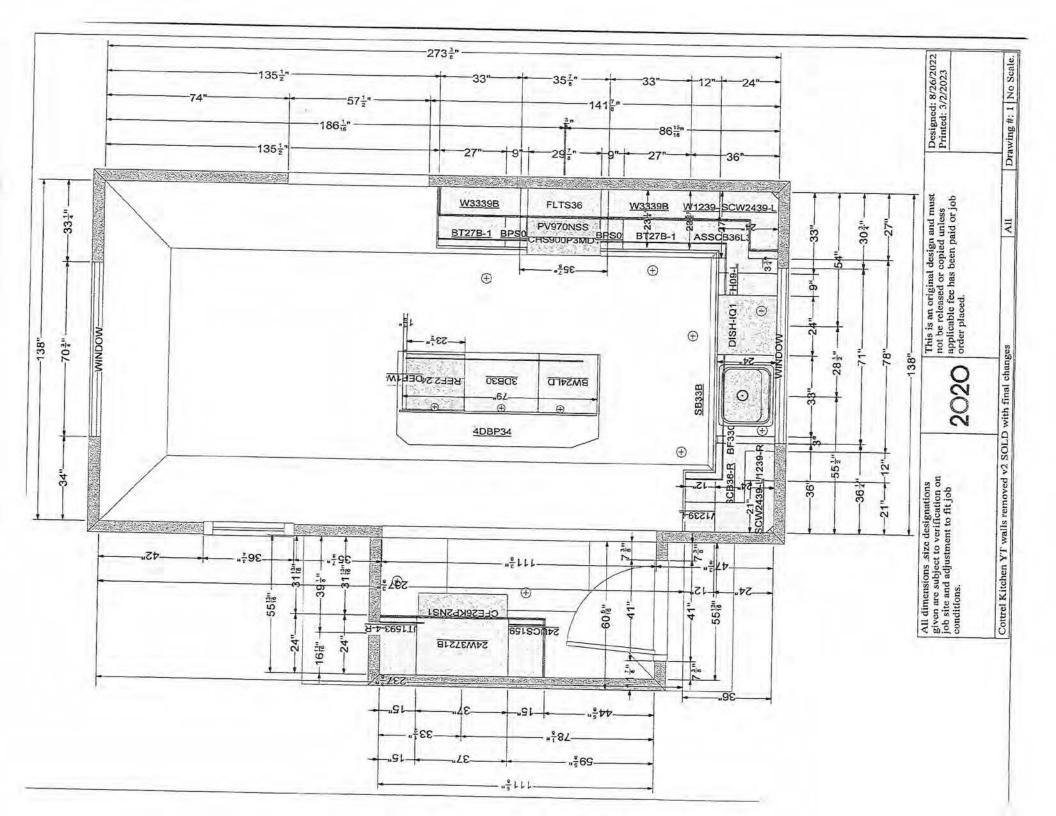

this window to & nemoved and filled, extrain to march enisting codor-shoke

Se installed here



to Se aploud with one wisher of Same size as every Side By side window

to & Replaced with "Bump-out" window; will & Stightly wider and Stightly Shorter

this Joan to Se Removed and filled in, exterior to match existing color-shoke



to be Limoved

to Se Lemon D

new door location to be lumoured





to Se Uploced will bumpout window to hit is slightly who and slightly shorter

existing side by side to

So replaced where window


that is some total size

as crising

facolin y usm

entror of enough under Sung replaced w/ Sumport dexited to be remared



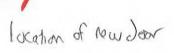



Se bemand: Filled in w/ Celar shake siding to match


to be Lemond wordow,
-k be filed in, with

Codar whole siding
-k meech

to be homored window,
to be filled in, with
codor-shake siding to
motch existing


Note: with new fince and when tree is in Stoom, neither of these handows are visible from the Street



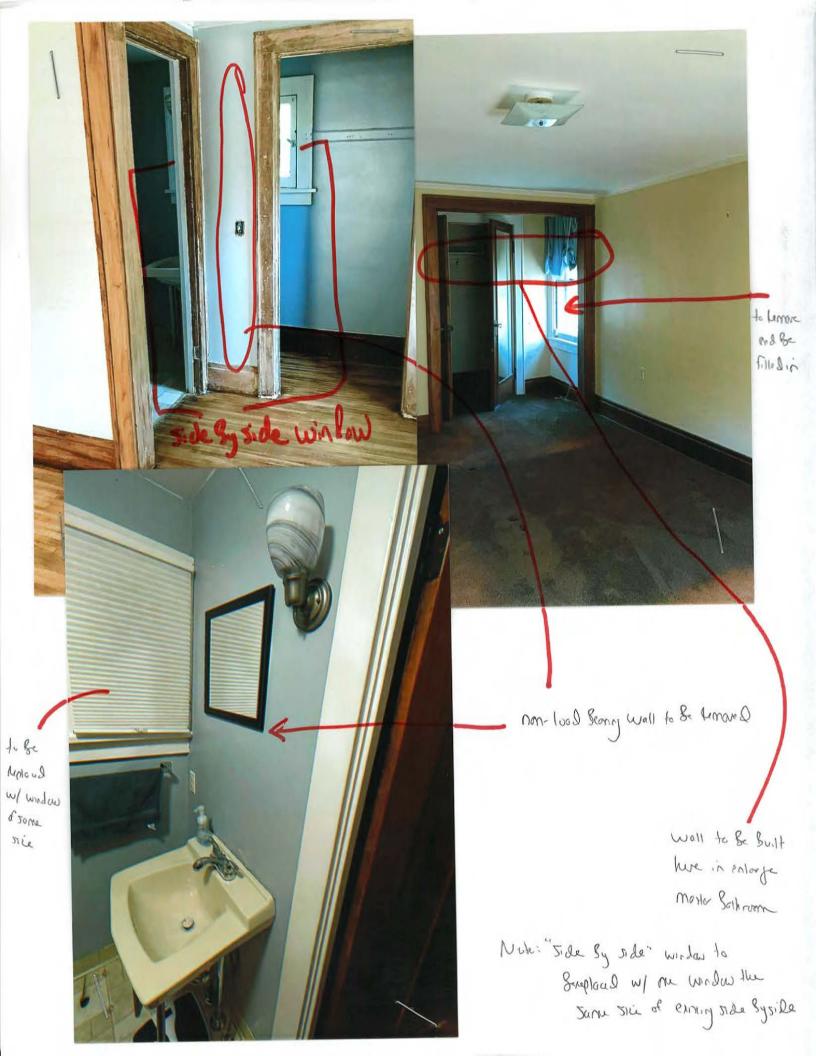

Examples of New Door Style:



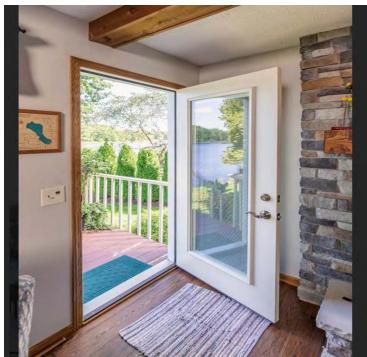






This is the style window that we are installing in the kitchen, except that the "lattice" or "grids" shown on this photo will not be on our window.



This is the style window that we are installing in the master/upstairs bathroom.

Casement and Awning

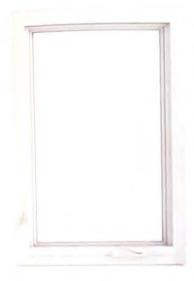

A better view for optimal performance

The Infinity Casement and Infinity Awning offer unlimited views with a slim profile and a sash that smoothly cranks open to invite the outdoors in. Our engineers optimized the design to tightly seal out wind and water for energy-efficient performance. Choose the Infinity Awning when you want to maximize light in a space that requires you to reach to open a window - especially over a kitchen sink.

Designed with Ultrex® fiberglass, the Infinity Casement and Awning feature multipoint locking systems and folding handles that tuck conveniently out of the way of most window treatments for a clean, finished look.





CASEMENT

AWNING





CLEAR VIEW HINGE




Casement hinges

The standard Easy Wash® hinge is just that - a design that lets you easily clean the window both inside and out. The optional Clear View® hinge provides for an expanded viewing area.

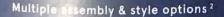

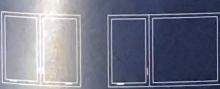

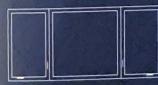

PICTURE UNIT MULL



PICTURE UNIT MULL




ROUND TOP MULL



SIMULATED CHECKRAIL

- Clear Vine, rings availability is based on window width.
 Available with matching picture window. Ask about additional assembly options for your home.

Colors and Finishes

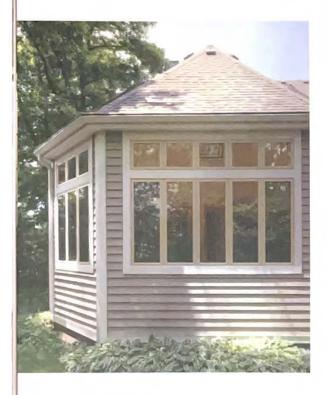

Exterior

We use a proprietary acrylic finish on our Ultrex® fiberglass that's virtually impermeable to help protect your investment from wind, weather and color fading,





Interior

We use the same acrylic finish on our interior as on our exterior for superior performance. Or choose our EverWood® option for the classic appeal of wood.



- 1. Sierra interior is not available with Ebony exterior
- 2 Bronze interior is only available with Bronze exterior.
- 5. Ebony interior is only available with Ebony exterior

Grilles and Divided Lites





Simulated Divided Lites¹

Our Simulated-Divided-Lite (SDL) bars are built with Ultrex® fiberglass. Permanently adhered in our factory to the outside surfaces of the glass, SDLs have a spacer bar between the panes of glass to offer the traditional look of divided lites.

Grilles Between the Glass 2

Located between the panes of insulating glass, Grilles-Between-the-Glass (GBG) combine easy cleaning with the timeless detail of a grille pattern.

Patterns

We offer various divided lite patterns so you can replicate the look of your original windows and doors or add new architectural interest to your home.3



STANDARD RECTANGULAR



RECTANGULAR




PRAIRIE SIX-LITE



PRAIRIE NINE-LITE




COTTAGE ONE-HIGH

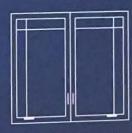

PRAIRIE FOUR-LITE ONE-HIGH



PRAIRIE SIX-LITE

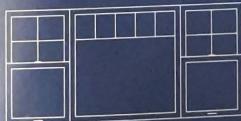

STANDARD RECTANGULAR



STANDARD COTTAGE RECTANGULAR ONE-HIGH



OPEN HUB SUNBURST



CLOSED HUB SUNBURST

^{2.} Infinity GBGs a

o your window or door's interior and exterior. I style options.



Town of Pittsford

Department of Public Works 11 South Main Street Pittsford, New York 14534

Permit # B23-000026

Phone: 585-248-6250 FAX: 585-248-6262

DESIGN REVIEW AND HISTORIC PRESERVATION BOARD REFERRAL OF APPLICATION

Property Address: 6 Black Wood Circle PITTSFORD, NY 14534

Tax ID Number: 178.03-5-28

Zoning District: IZ Incentive Zoning

Owner: Wilshire Hill LLC **Applicant:** Pride Mark Homes


Application Type	vpe	IVD	111	ΟI	ı	u	a	C	ш	Ν	u	м
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ppiication	rype:	
~//	ntial Design Review 205 (B)	Build to Line Adjustment §185-17 (B) (2)
Comme	ercial Design Review 205 (B)	Building Height Above 30 Feet §185-17 (M)
Signage	· ,	Corner Lot Orientation §185-17 (K) (3)
Certifica §185-	ate of Áppropriateness 197	Flag Lot Building Line Location §185-17 (L) (1) (c)
	ark Designation 195 (2)	Undeveloped Flag Lot Requirements §185-17 (L) (2)
•	al Review	


Project Description: Applicant is requesting design review for the construction of an approximately 2036 SF new single story family home in the Wilshire Hill subdivision

Meeting Date: March 23, 2023

RN Residential Neighborhood Zoning

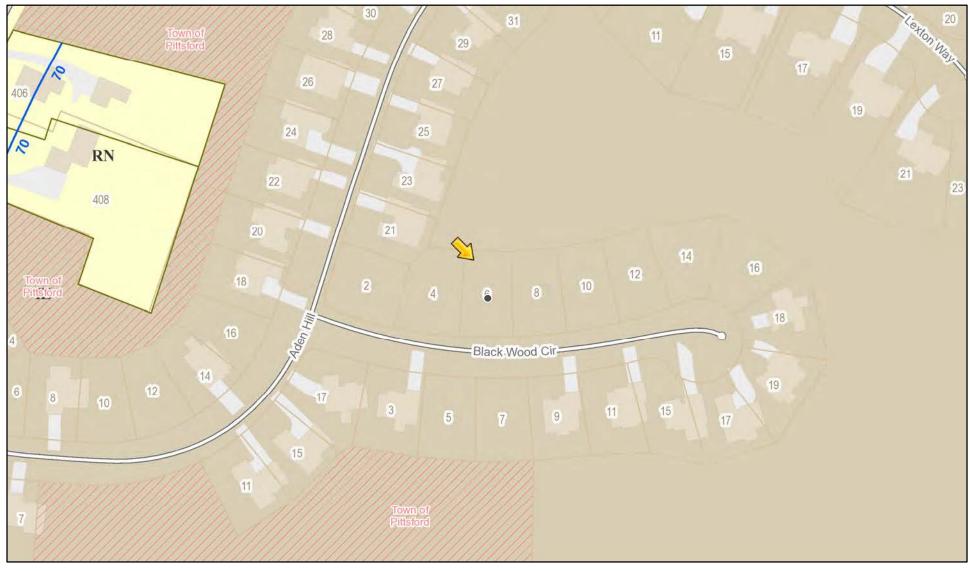


Printed March 7, 2023

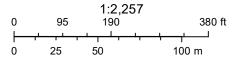

Town of Pittsford GIS

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ROCHESTER LOCATION
3 9 CASCADE DRIVE
ROCHESTER, NY 14614
5 8 5 - 4 5 8 - 7 7 0
11HACALOCATION
840 HANSHAW RD, STE 12
1THACA, NY 14850
6 0 7 - 2 4 1 - 2 9 1 7

JOB NO: 0423-17 1" = 20' SCALE: DRAWN: RJT DESIGNED: RJT DATE:

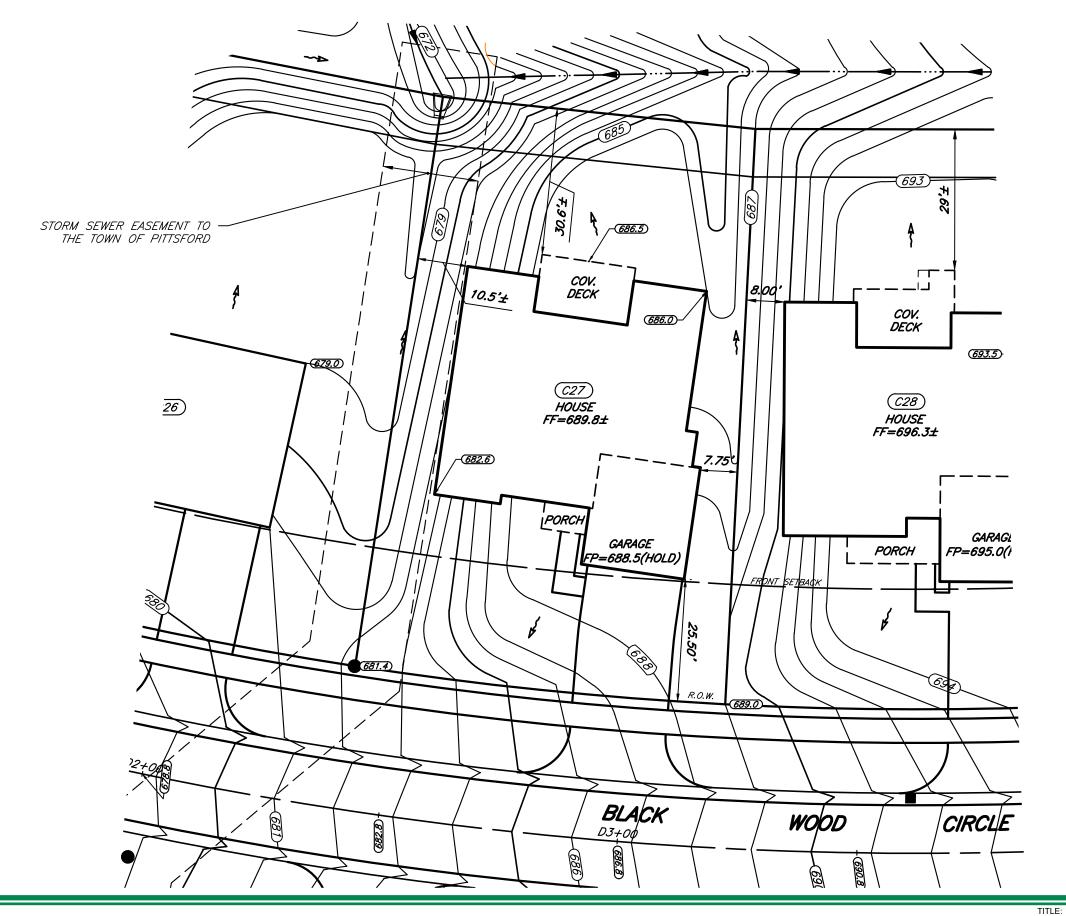SETBACK	REQUIRED	PROVIDED
FRONT	25'	25.50'
SIDE	7.5'	7.75'
REAR	10'	30.6+' ±

PLOT PLAN - LOT C27

WILSHIRE HILL - SECTION 3

DESIGN CRITERIA:

-For Greater Rochester Area and surrounding counties.

IST & 2ND FLOOR LIVING AREA LIVE LOAD 40 PSF SLEEPING AND ATTIC AREA LIVE LOAD 30 PSF FLOOR DEAD LOAD 15 PSF 40 PSF GROUND SNOW LOAD ROOF DEAD LOAD 10 PSF

ALLOWABLE SOIL BEARING 2500 PSF AT MINIMUM 42" BELOW FINISHED GRADE

WIND SPEED 115 MPH, EXPOSURE B CATEGORY B SEISMIC DESIGN WEATHERING SEVERE

FROST DEPTH LINE 42 INCHES


TERMITE DAMAGE SLIGHT TO MODERATE NONE TO SLIGHT DECAY DAMAGE WINTER DESIGN TEMPERATURE I DEGREE

ICE SHIELD UNDERLAYMENT REQUIRED 24" INSIDE OF EXTERIOR WALL LINE

FLOOD HAZARD FIRM - 1992

ROOF TIE DOWN REQUIREMENTS R802.11, BASED UPON


SPECIFIC ROOF DESIGN

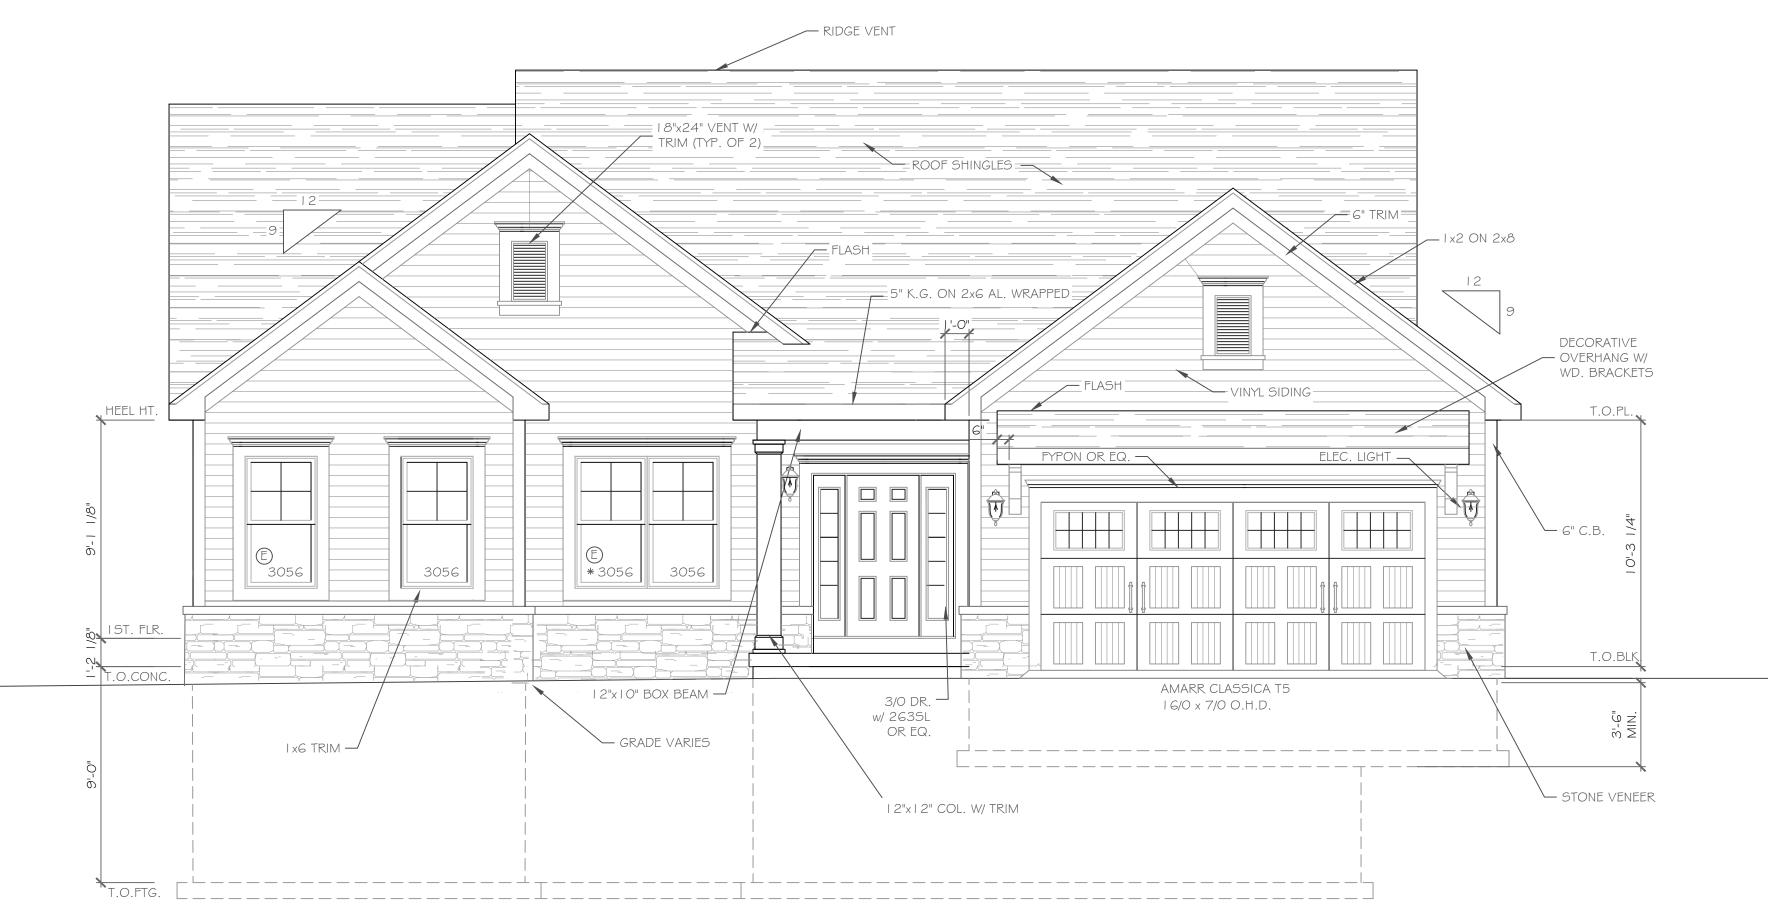

FRONT ELEVATION

2036 S.F.


NOTE: - WINDOWS TO BE "GREAT LAKES" DOUBLE-HUNG OR EQUAL - DOORS TO BE "THERMA-TRU" OR EQ. - DOWN SPOUTS TO BE LOCATED BY CONTRACTOR IN FIELD -(E): WINDOW MEETS OR EXCEEDS THE EGRESS REQUIREMENTS PER SECTION R3 | O OF THE RES. CODE OF NYS - * : SAFETY GLASS REQ. PER SECTION R308.4 OF THE RES. CODE OF NYS

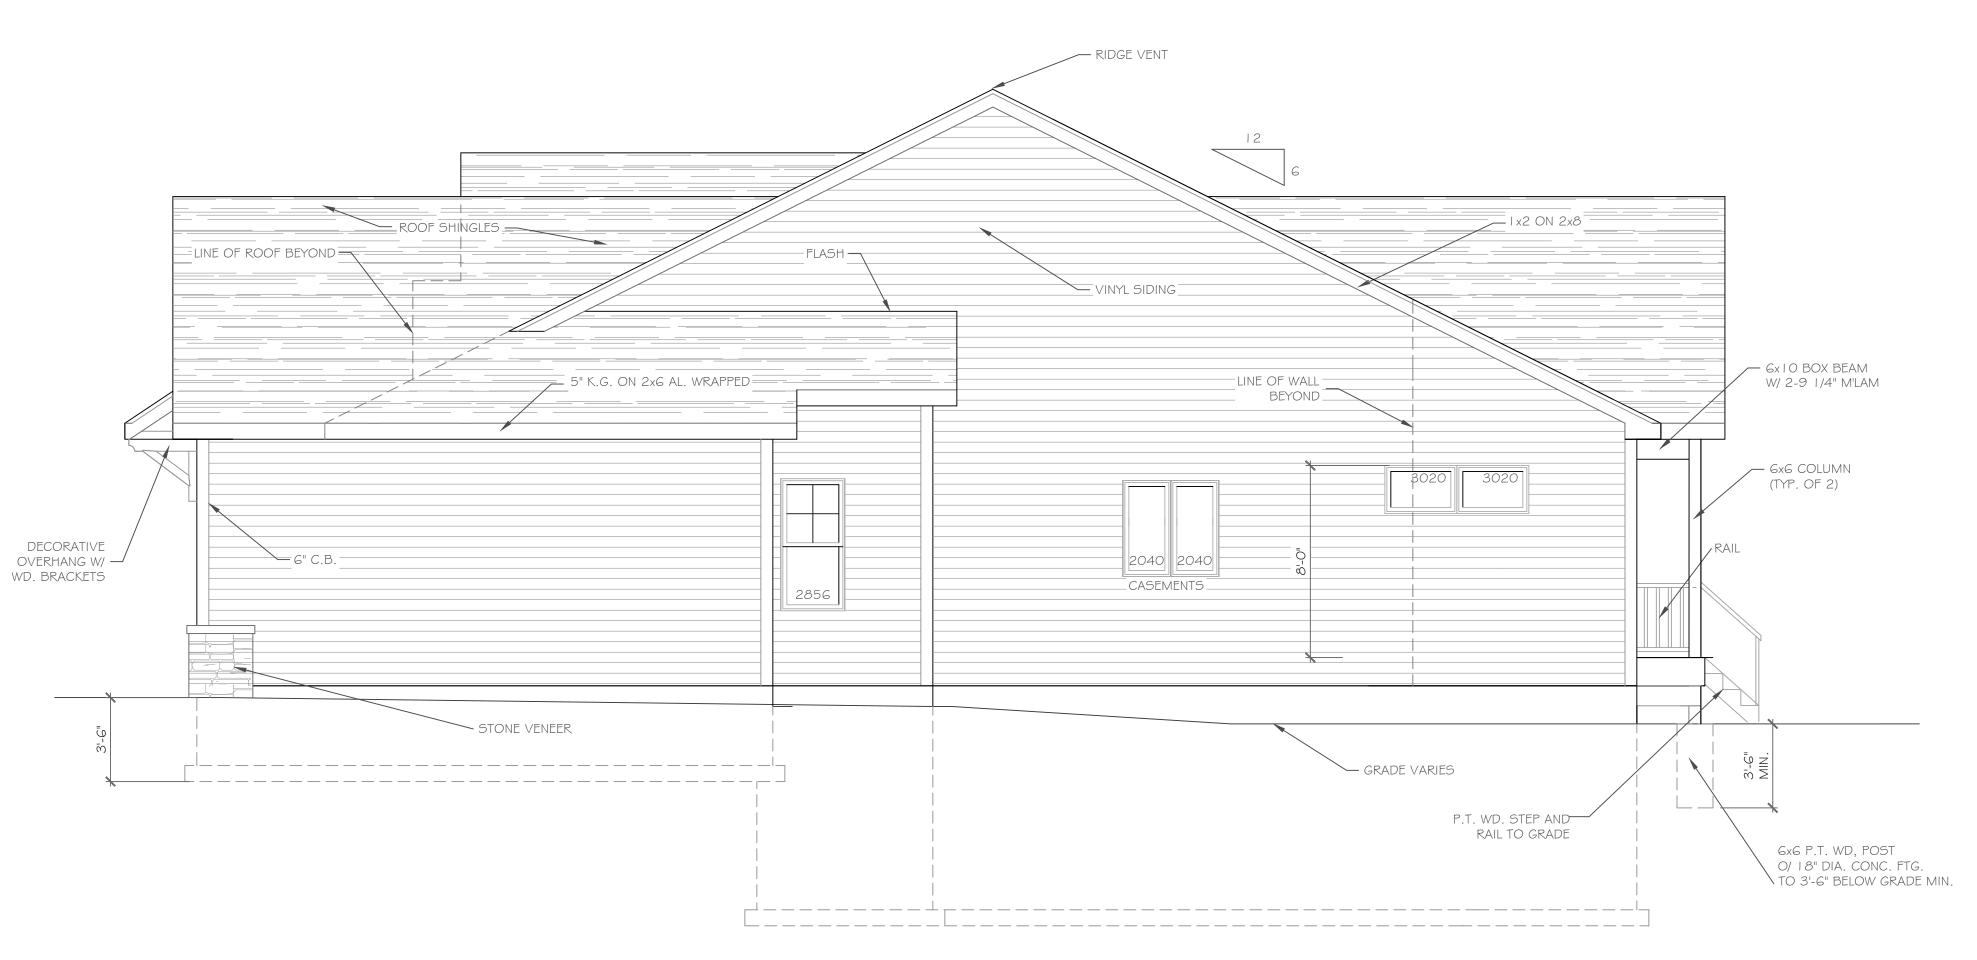



SCALE: 1/4"=1'-0"

Wilshire Hill New York

DRAWING NO.-

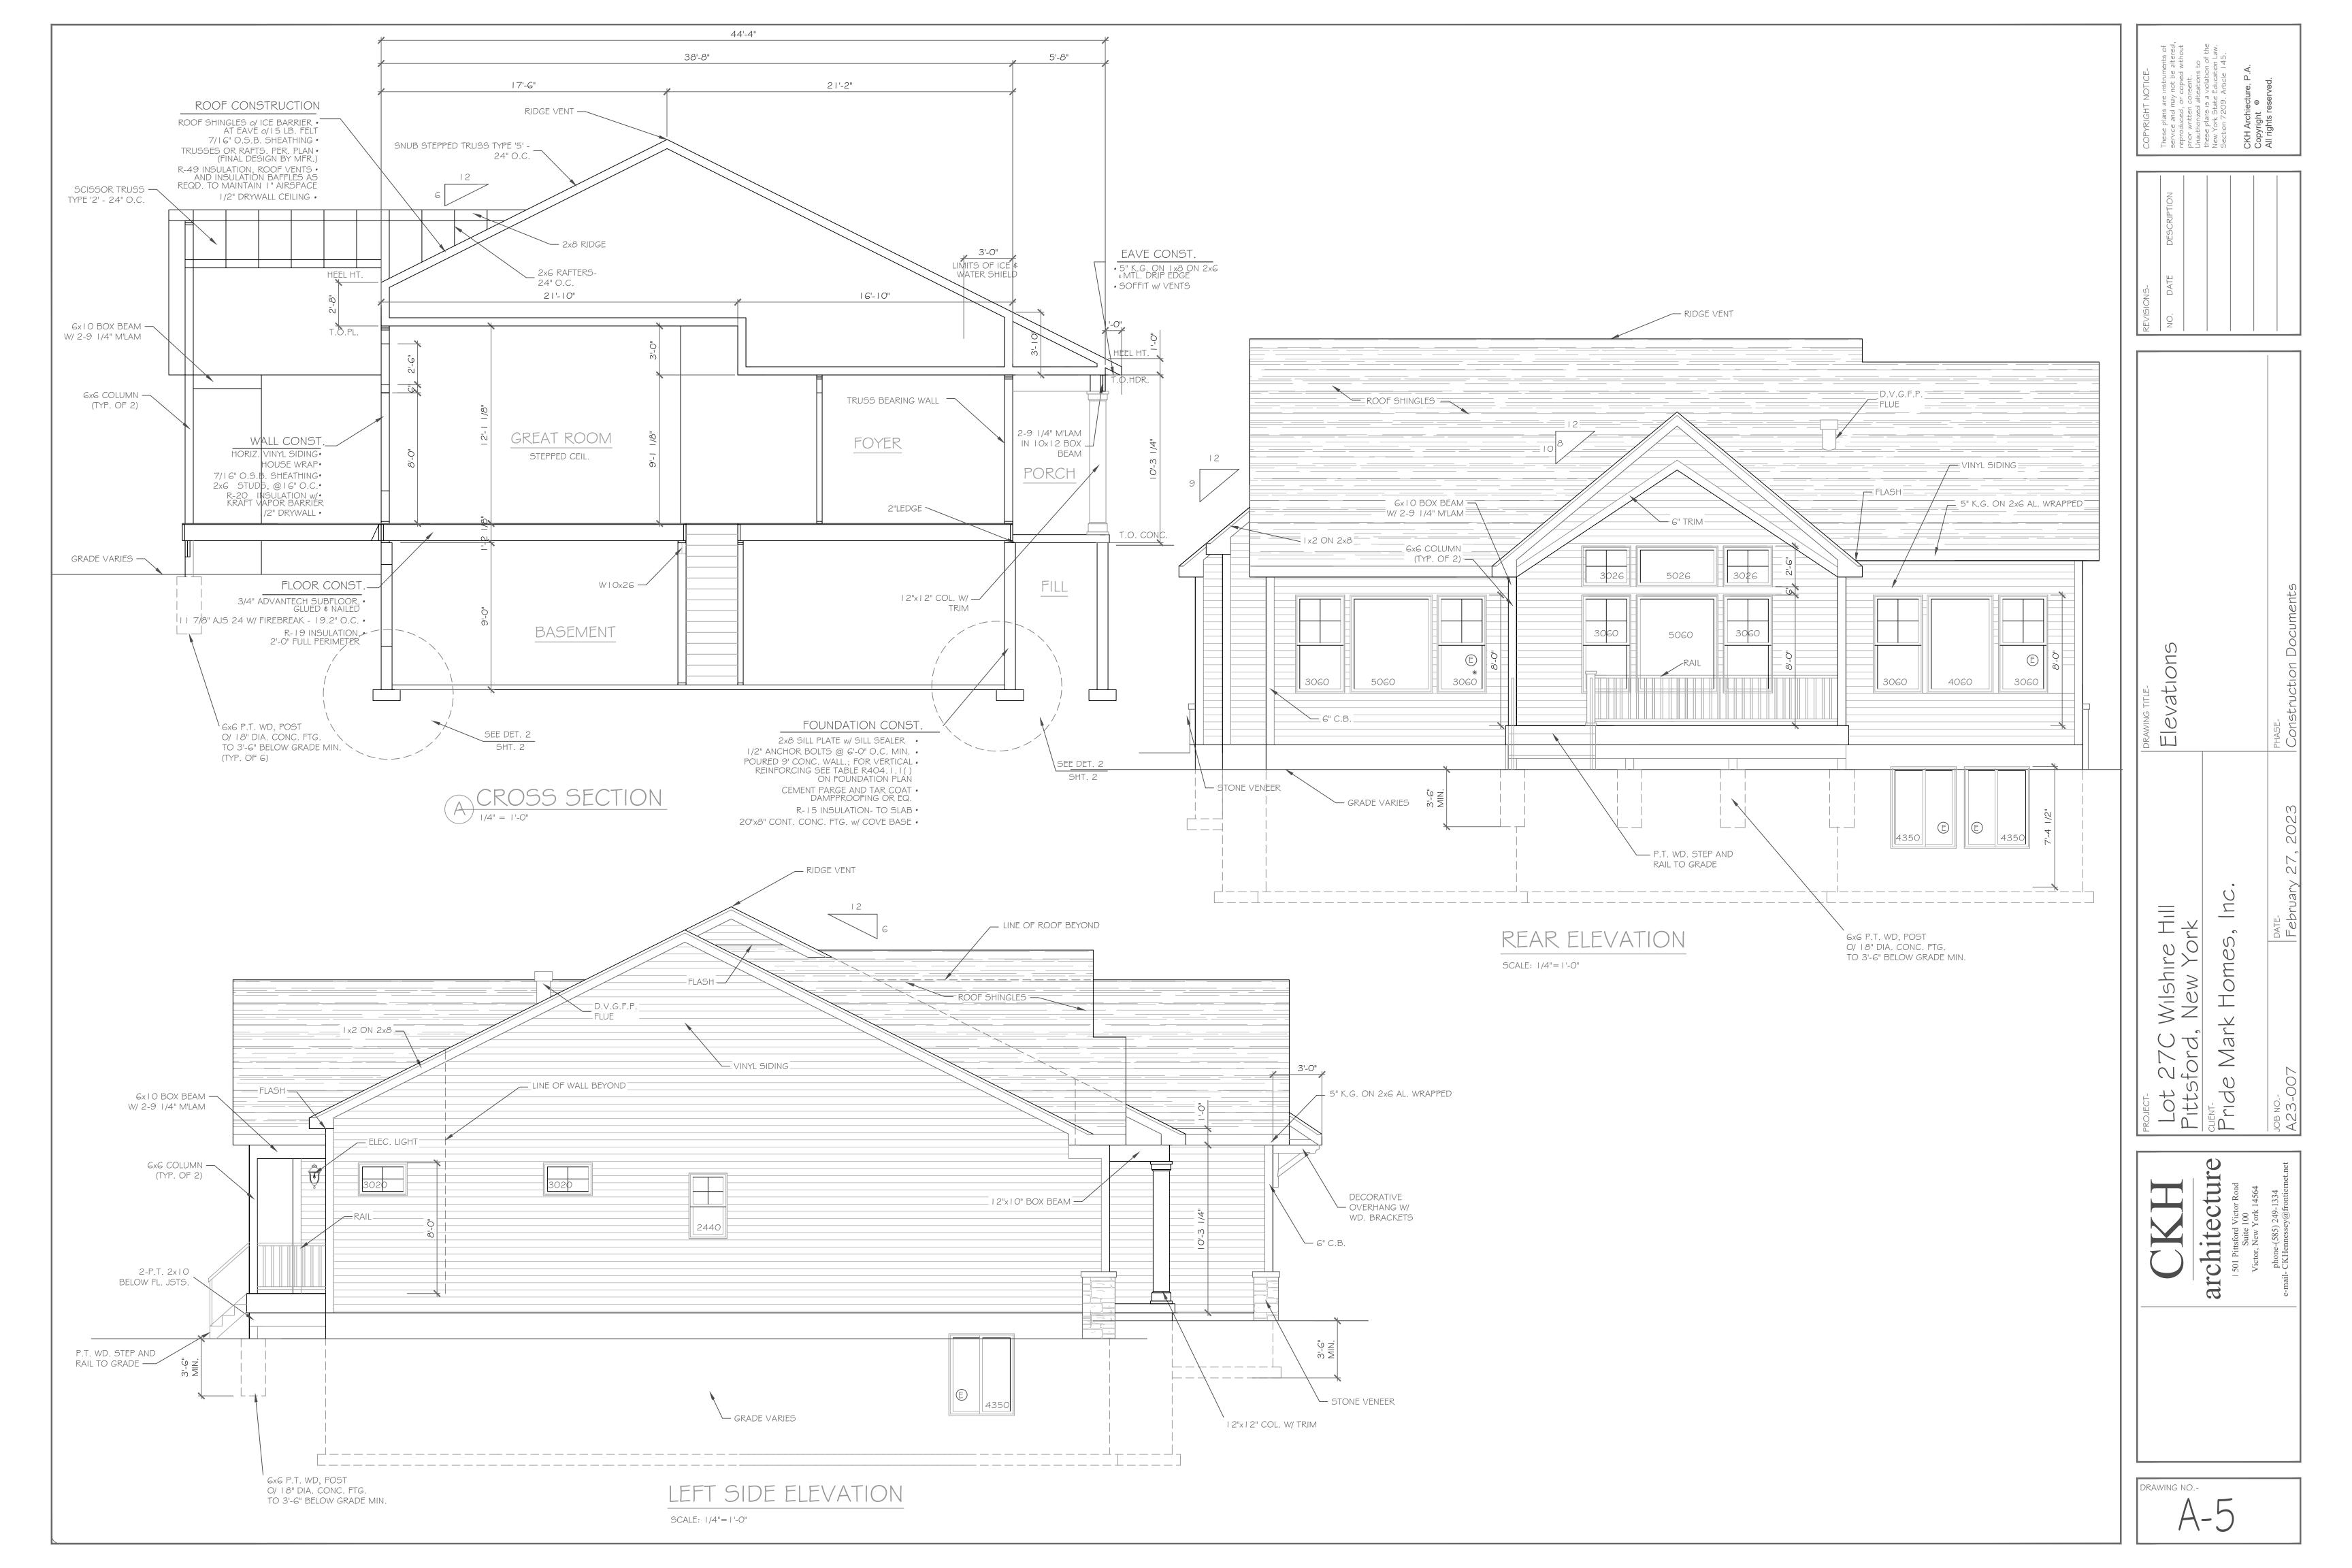

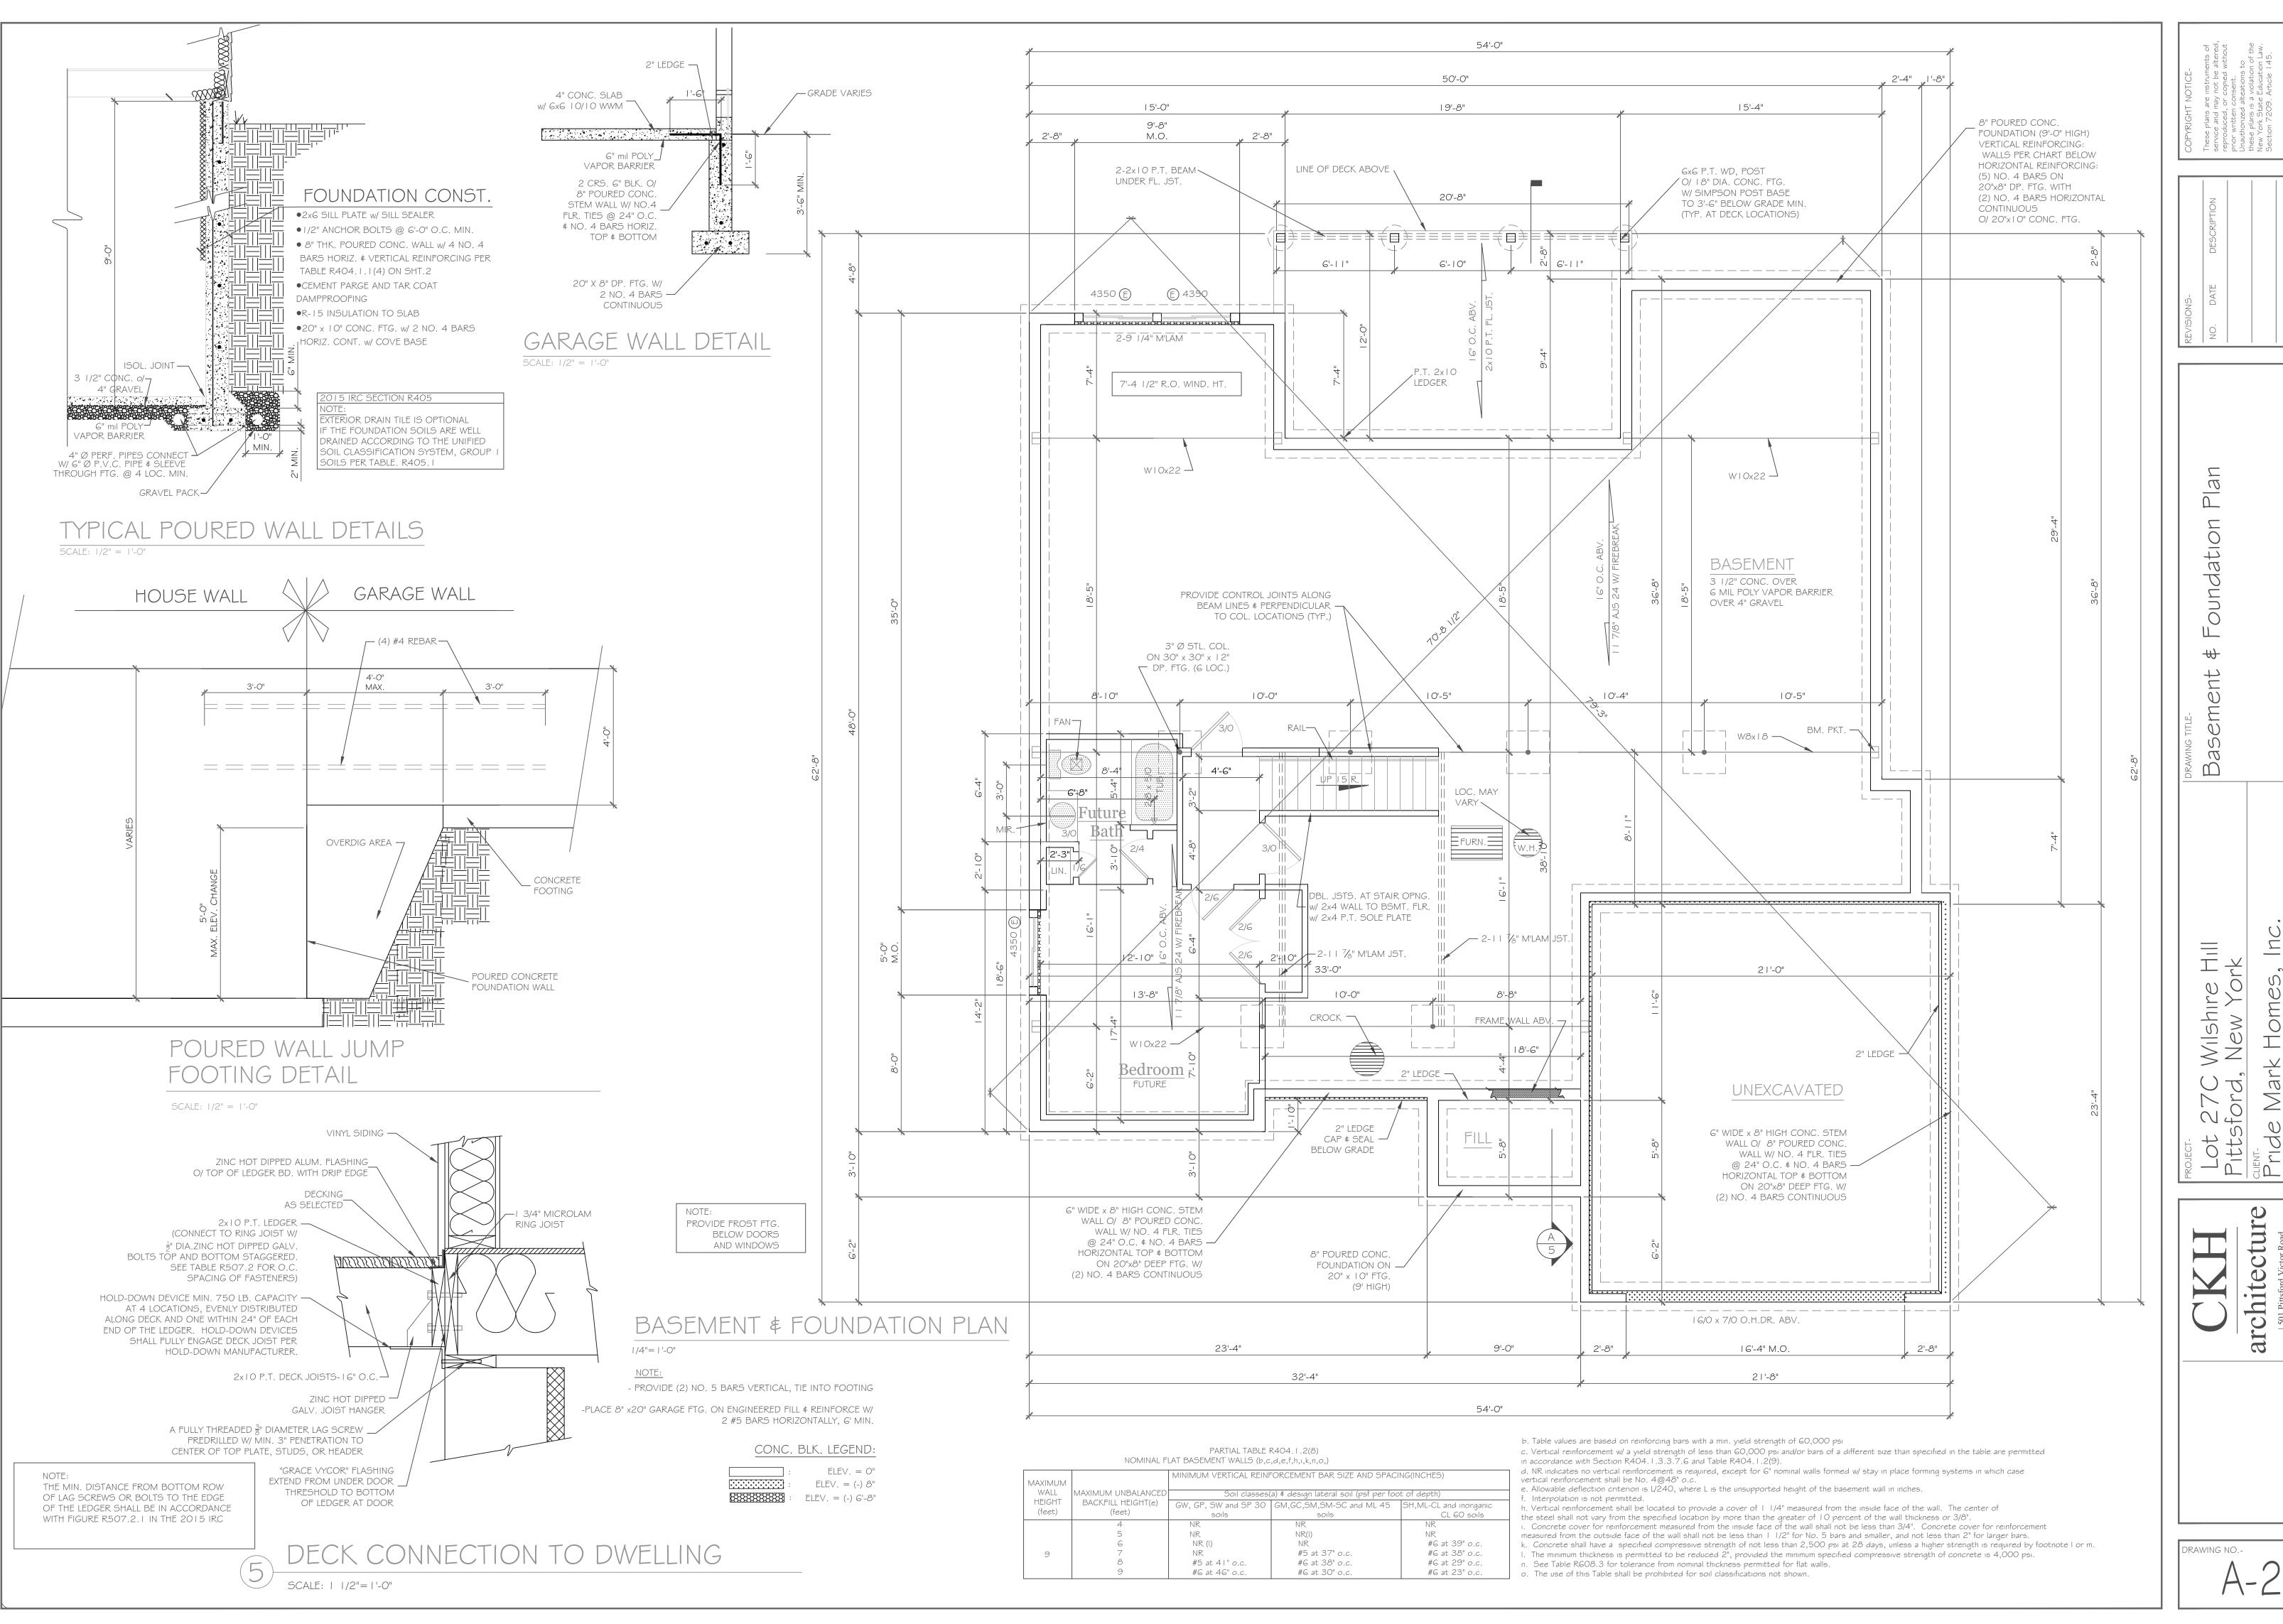

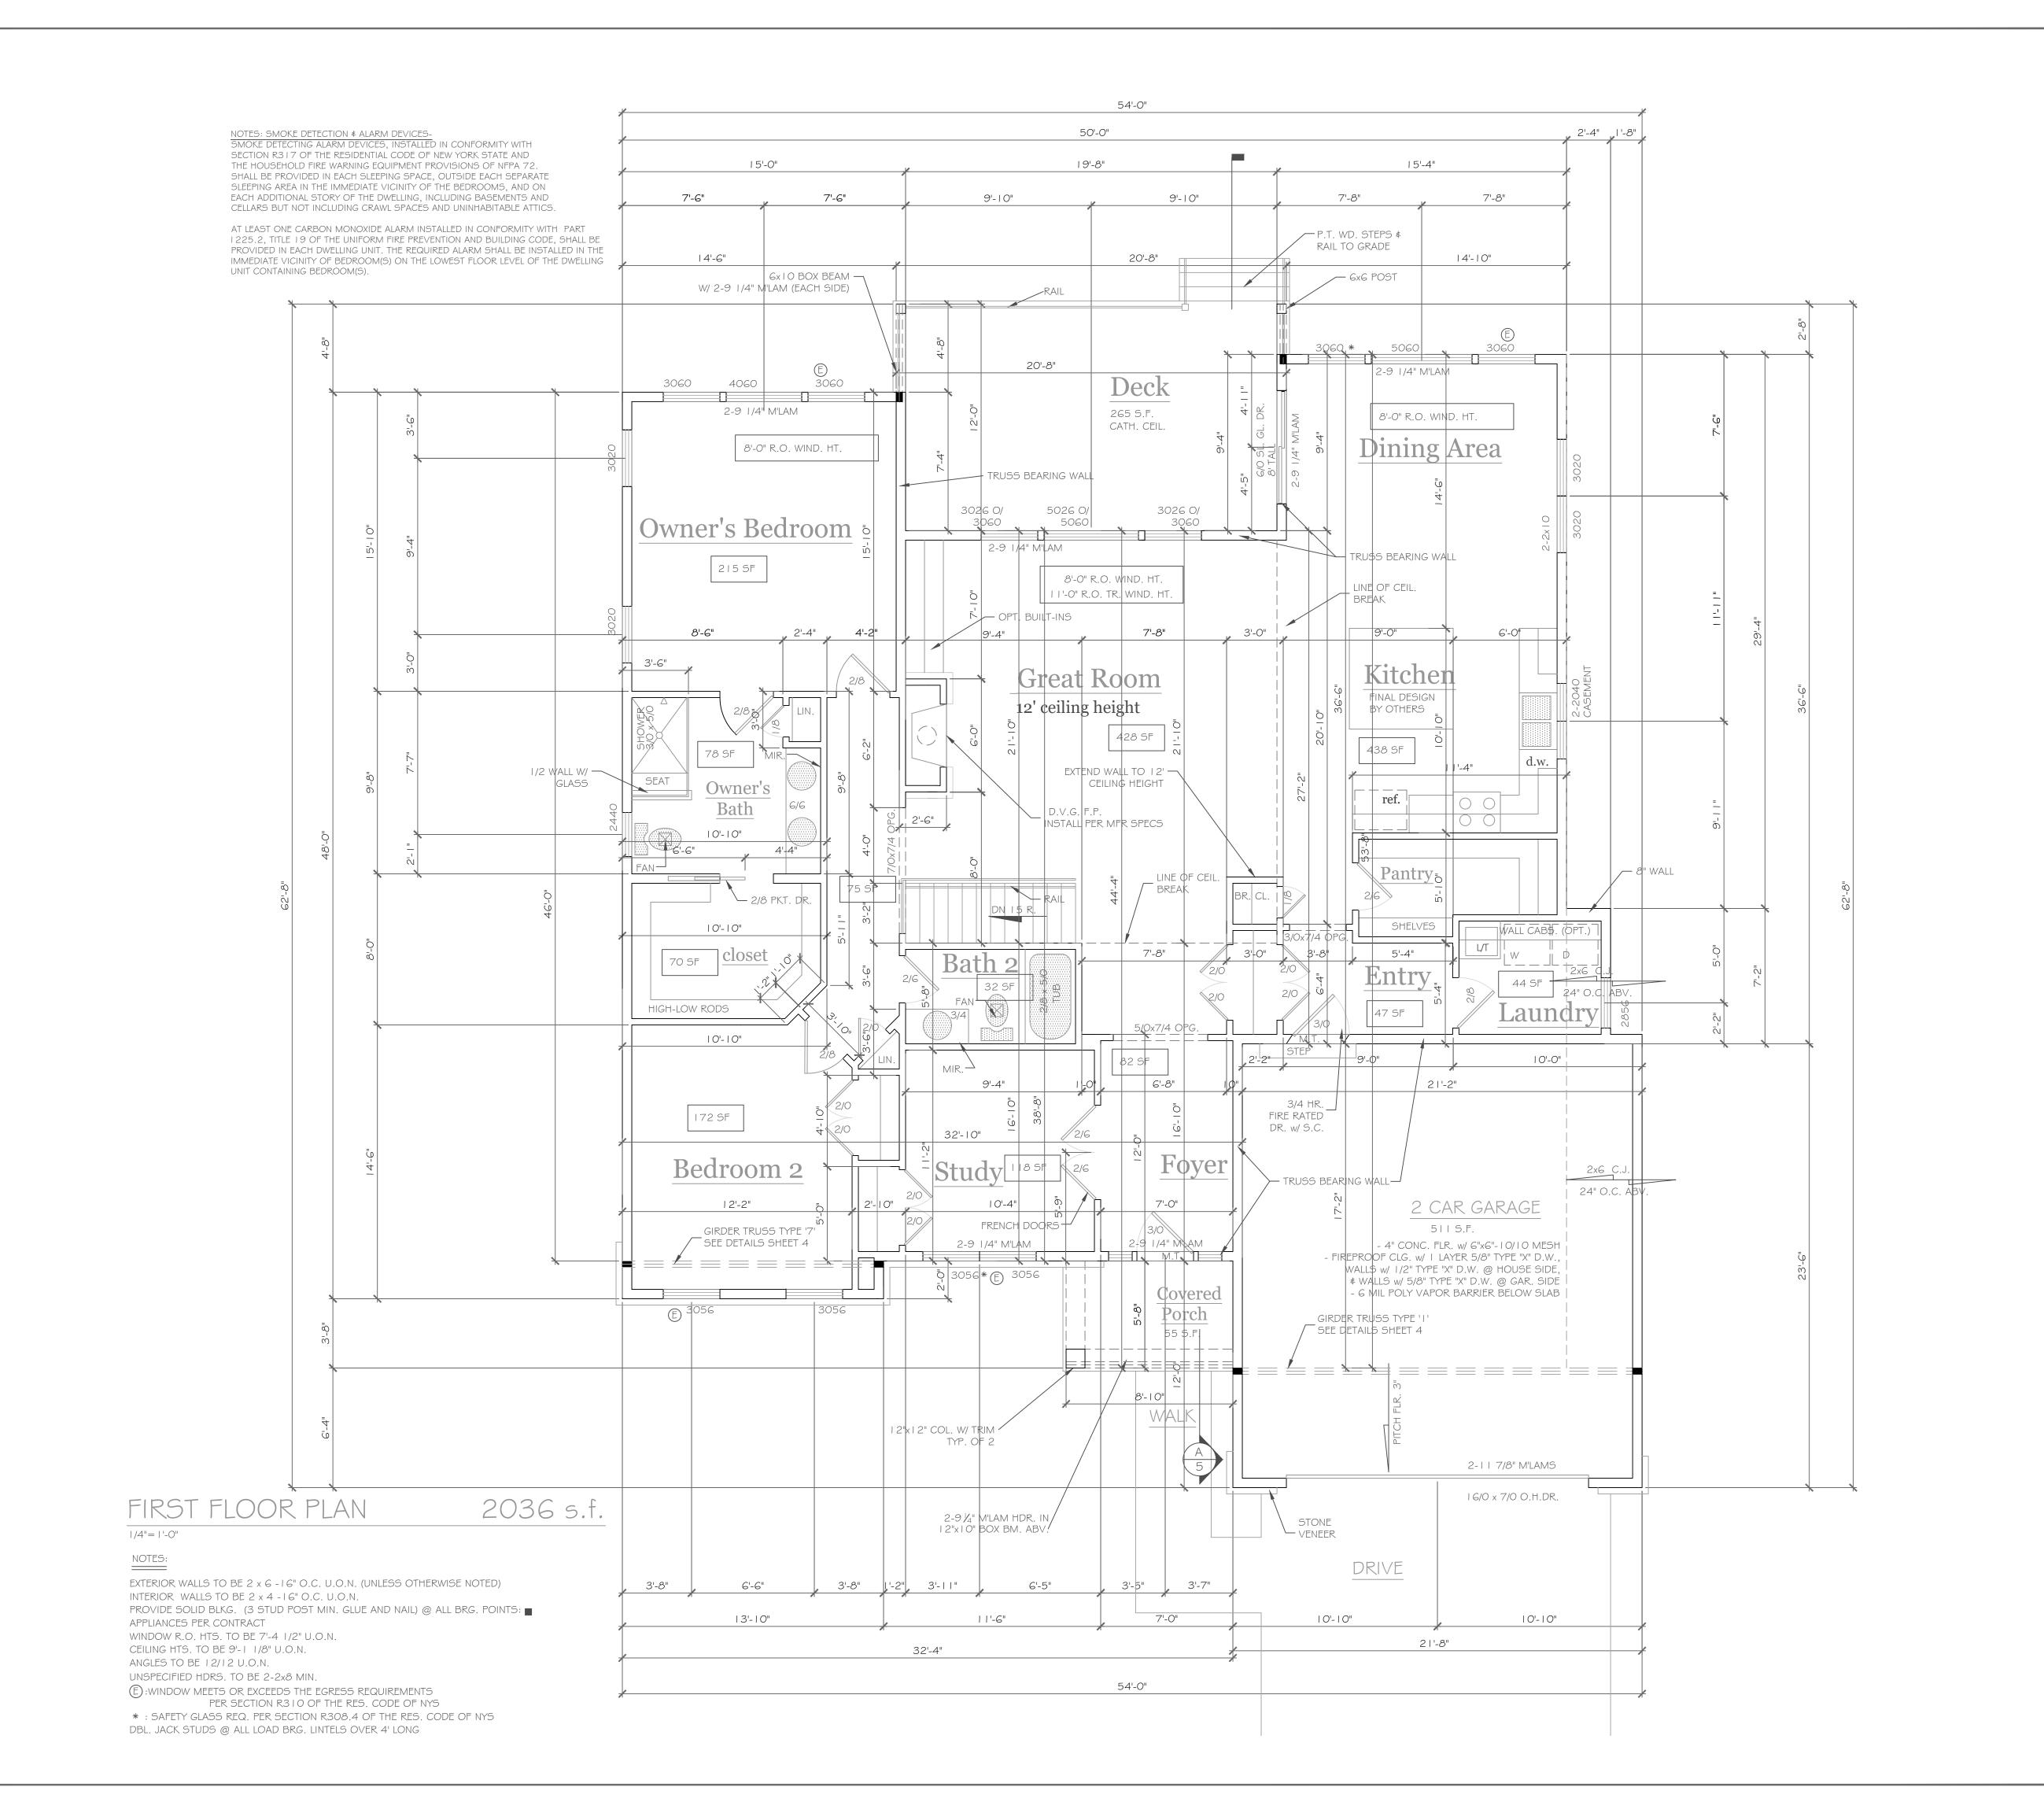

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CKH Archiecture, P.A.

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REVISIONSNO. DATE DESCRIPTION

Wilshire Hill

First Floor Plan

First Floor Plan

ark Homes, Inc.

| PASE- | Construction Documents |

architecture

| 501 Pittsford Victor Road Suite 100 Victor, New York 14564 e-mail- CKHennessey@frontiernet.net

t 27C sford,


Pitts Pride

DRAWING NO.-







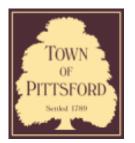

Town of Pittsford

Department of Public Works 11 South Main Street Pittsford, New York 14534

Permit # B23-000037

Phone: 585-248-6250 FAX: 585-248-6262

DESIGN REVIEW AND HISTORIC PRESERVATION BOARD REFERRAL OF APPLICATION

Property Address: 10 Aden Hill PITTSFORD, NY 14534

Tax ID Number: 178.03-4-56

Zoning District: IZ Incentive Zoning

Owner: Wilshire Hill LLC Applicant: Pride Mark Homes


Application Type:

ւրբ	incation Type.	
✓	Residential Design Review §185-205 (B)	Build to Line Adjustment §185-17 (B) (2)
	Commercial Design Review	Building Height Above 30 Feet
	§185-205 (B)	§185-17 (M)
	Signage	Corner Lot Orientation
	§185-205 (C)	§185-17 (K) (3)
	Certificate of Appropriateness	Flag Lot Building Line Location
	§185-197	§185-17 (L) (1) (c)
	Landmark Designation	Undeveloped Flag Lot Requirements
	§185-195 (2)	§185-17 (L) (2)
	Informal Review	


Project Description: Applicant is requesting design review for the construction of an approximately 2040 SF new single story family home in the Wilshire Hill subdivision

Meeting Date: March 23, 2023

RN Residential Neighborhood Zoning

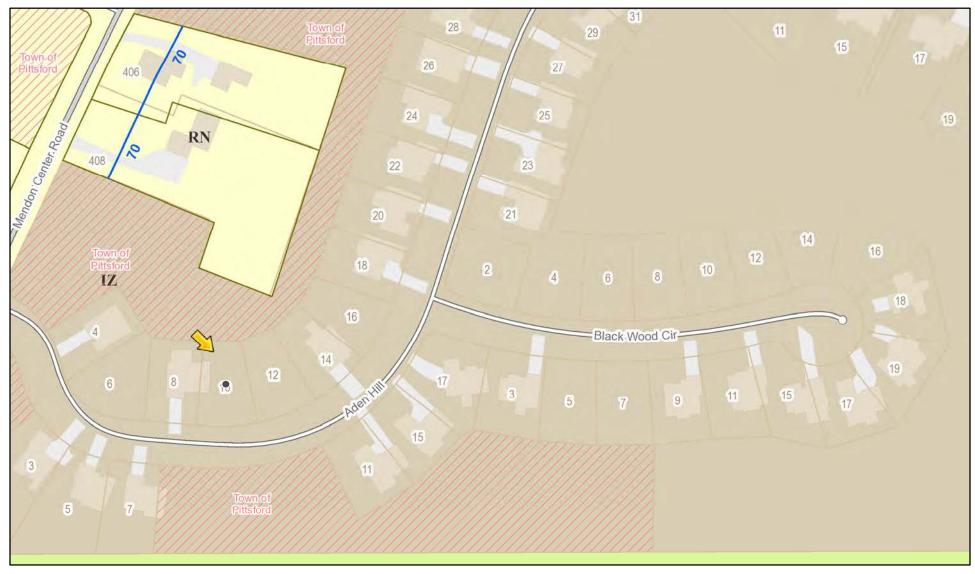


Printed March 16, 2023

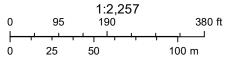

Town of Pittsford GIS

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ROCHESTER LOCATION

3 9 C A S C A D E D R I V E
ROCHESTER, NY 14614
5 8 5 - 4 5 8 - 7 7 7 0
ITHACA LOCATION
840 HANSHAW RD, STE 12
ITHA C A, NY 14850
6 0 7 - 2 4 1 - 2 9 1 7 www.marathoneng.com JOB NO: 0423-13 SCALE: 1" = 20' DRAWN: RJT DESIGNED: DATE: 4/26/22 REVISED:

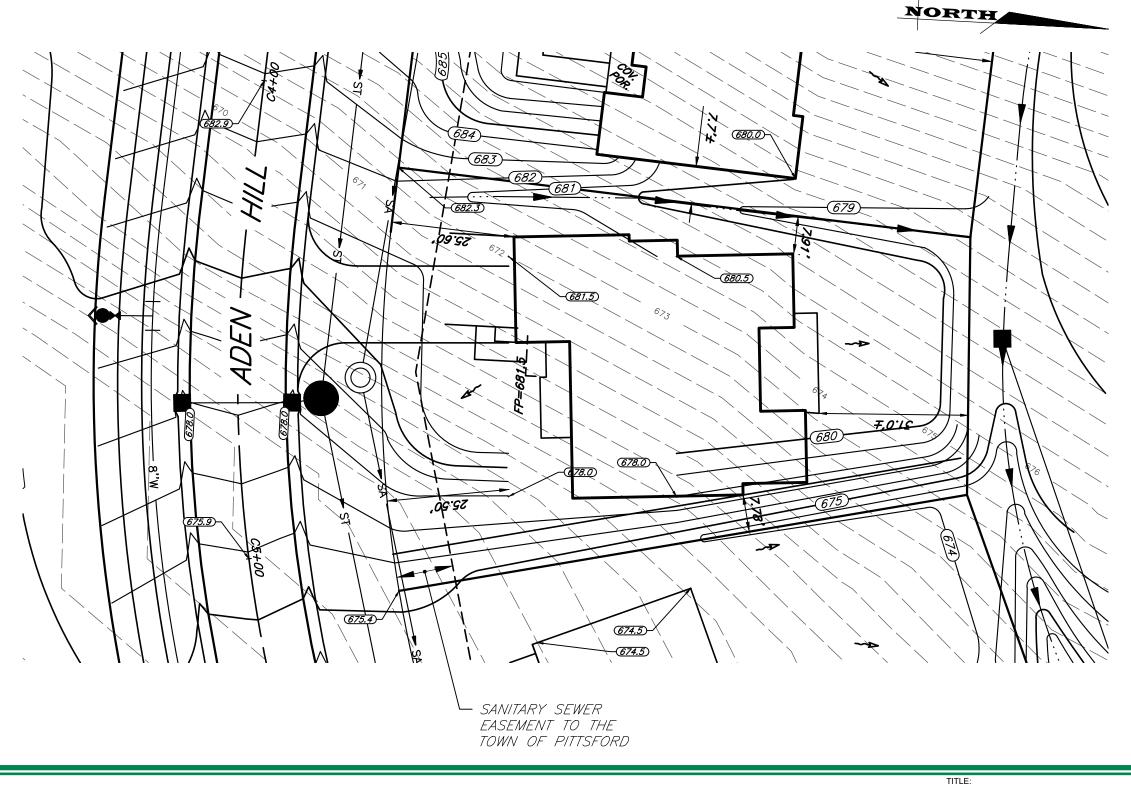SETBACK REQUIRED PROVIDED FRONT 25' TBD SIDE 7.5' TBD REAR 20' TBD

PLOT PLAN - LOT C4 WILSHIRE HILL - SECTION 2

DESIGN CRITERIA:

-For Greater Rochester Area and surrounding counties.

SEISMIC DESIGN

WINTER DESIGN TEMPERATURE

IST \$ 2ND FLOOR LIVING AREA LIVE LOAD

40 PSF

SLEEPING AND ATTIC AREA LIVE LOAD

70 PSF

FLOOR DEAD LOAD

15 PSF

GROUND SNOW LOAD

40 PSF

10 PSF

ALLOWABLE SOIL BEARING
2500 PSF AT MINIMUM
42" BELOW FINISHED GRADE

WIND SPEED 115 MPH, EXPOSURE B

WEATHERING SEVERE
FROST DEPTH LINE 42 INCHES

TERMITE DAMAGE SLIGHT TO MODERATE

DECAY DAMAGE NONE TO SLIGHT

ICE SHIELD UNDERLAYMENT REQUIRED 24" INSIDE OF

EXTERIOR WALL LINE


FLOOD HAZARD FIRM - 1992

ROOF TIE DOWN REQUIREMENTS

R802.1 I, BASED UPON
SPECIFIC ROOF DESIGN

CATEGORY B

I DEGREE

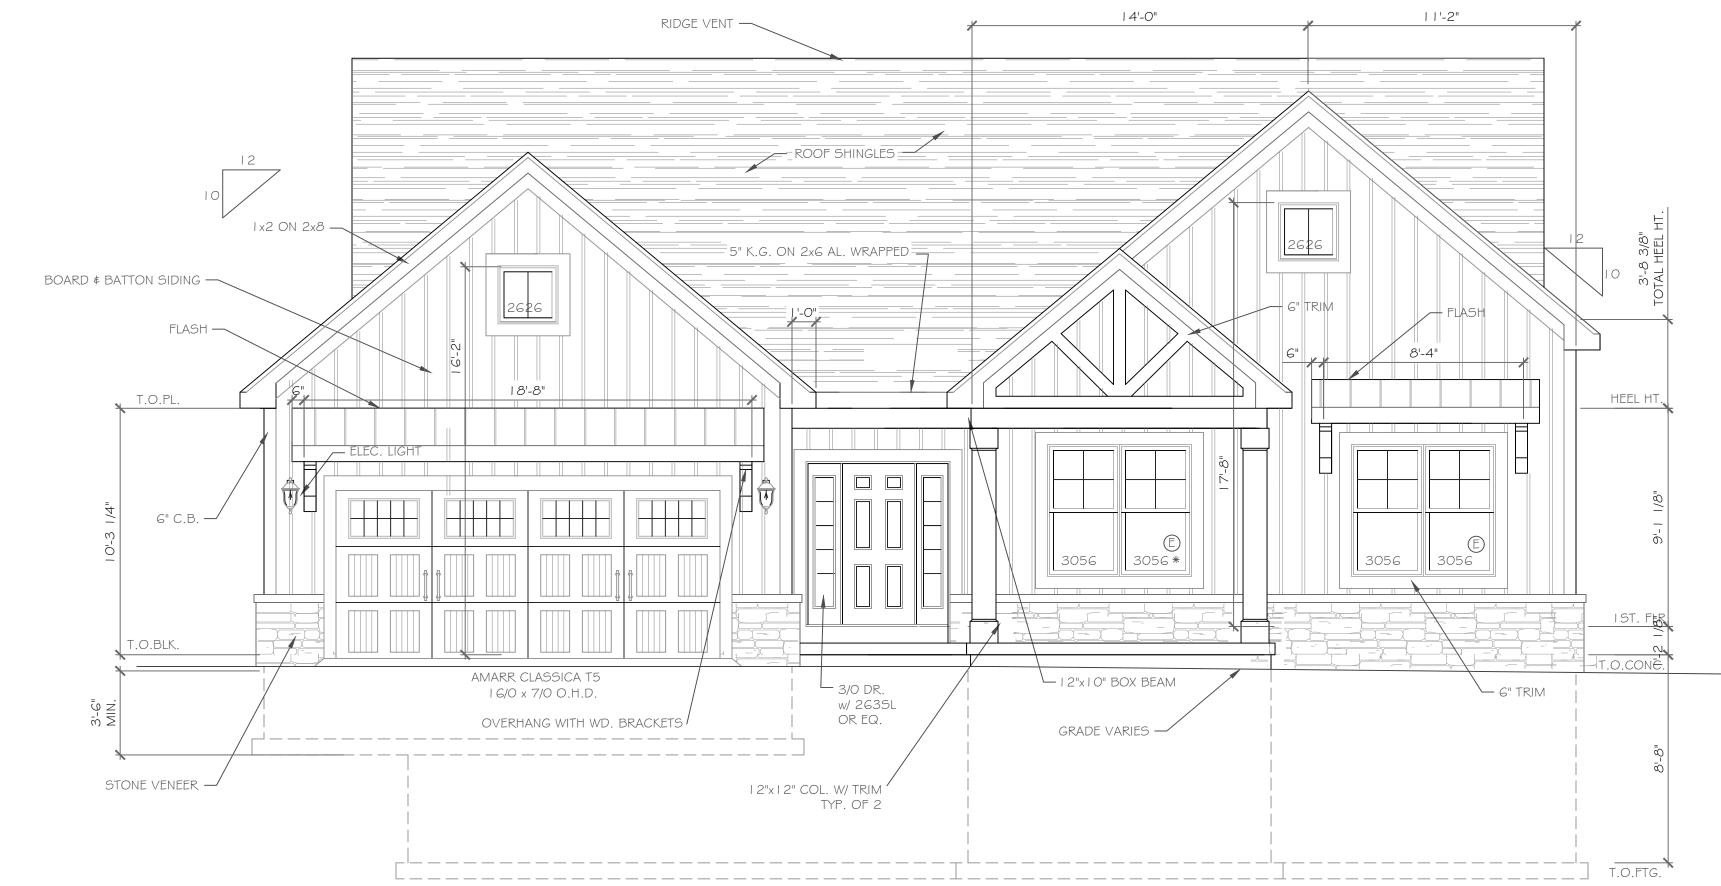


FRONT ELEVATION


2040 S.F.

NOTE: - WINDOWS TO BE "GREAT LAKES" DOUBLE-HUNG OR EQUAL - DOORS TO BE "THERMA-TRU" OR EQ.

- DOWN SPOUTS TO BE LOCATED BY CONTRACTOR IN FIELD
-E: WINDOW MEETS OR EXCEEDS THE EGRESS REQUIREMENTS

PER SECTION R3 I O OF THE RES. CODE OF NYS
- *: SAFETY GLASS REQ. PER SECTION R308.4 OF THE RES. CODE OF NYS

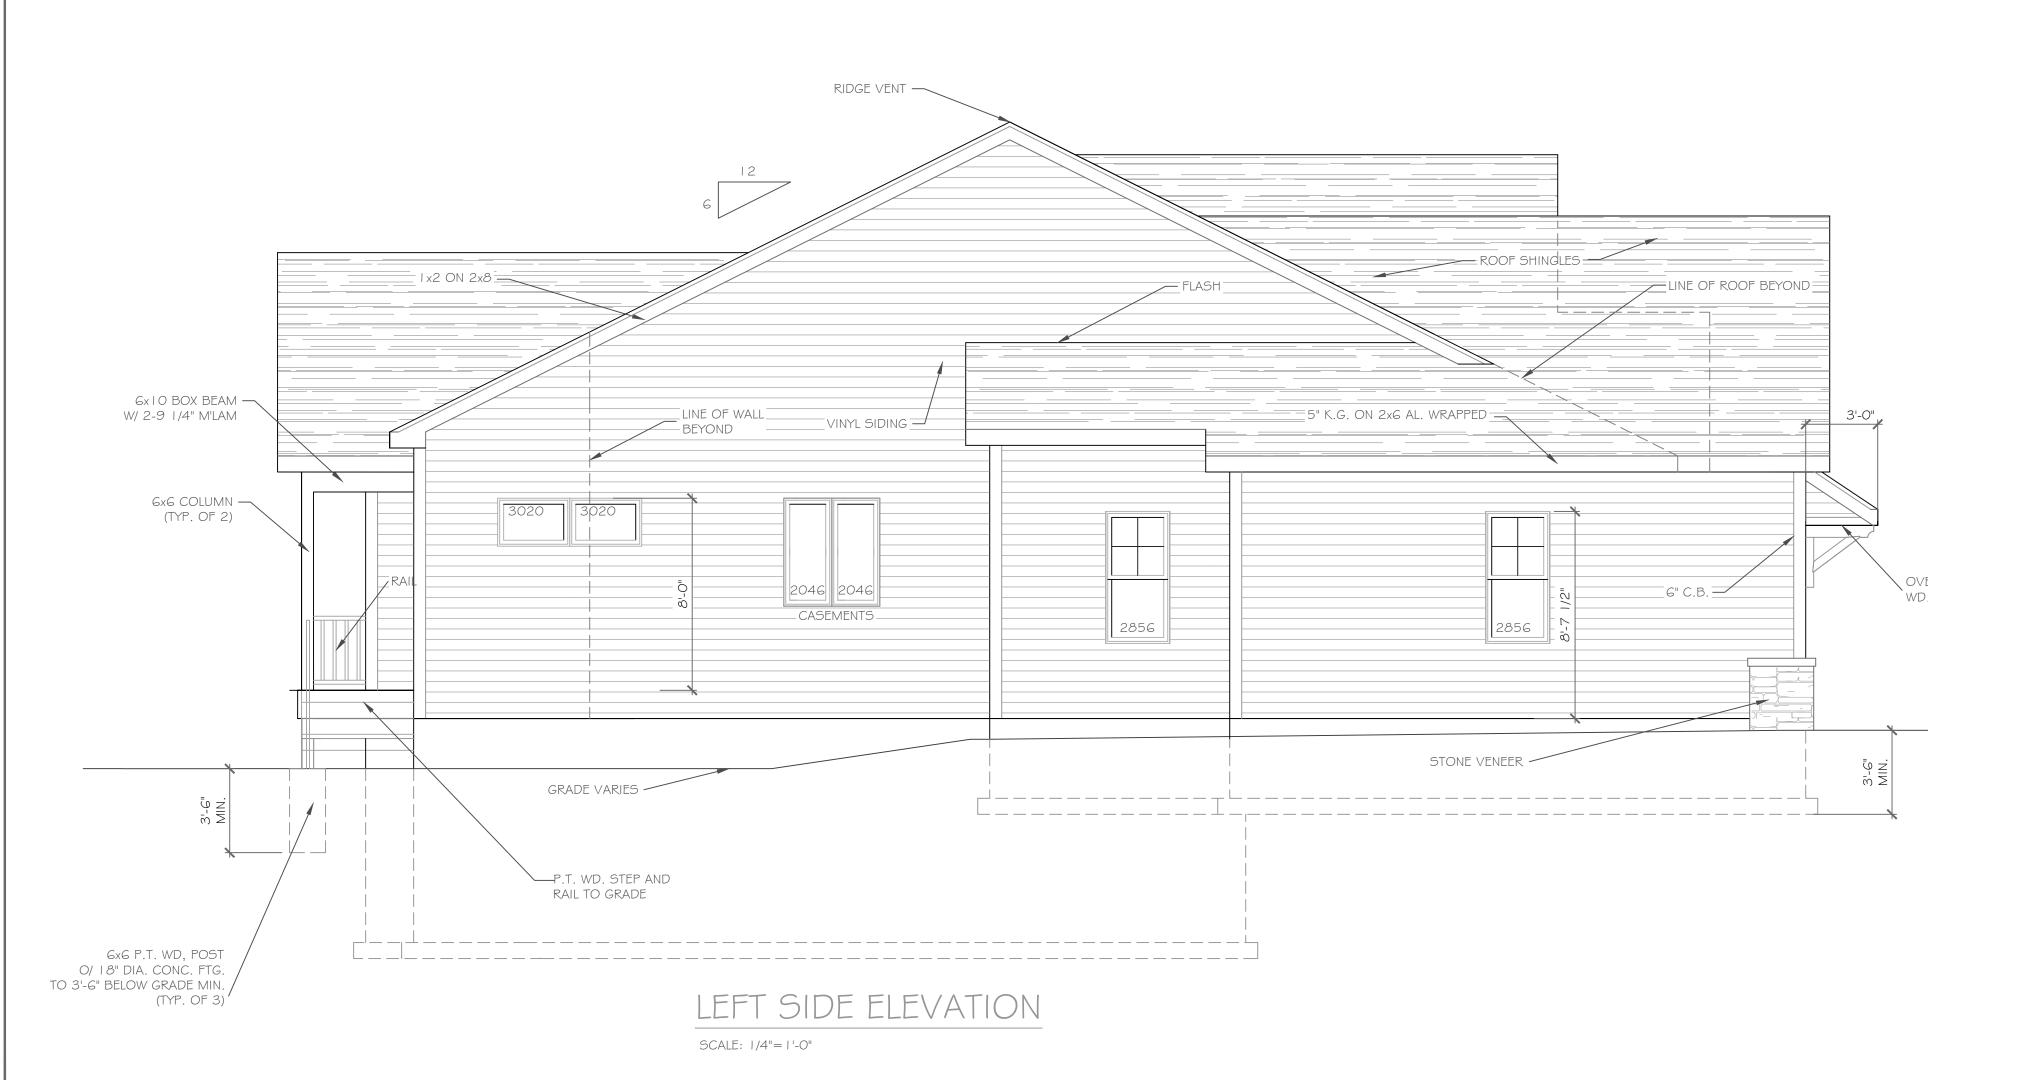


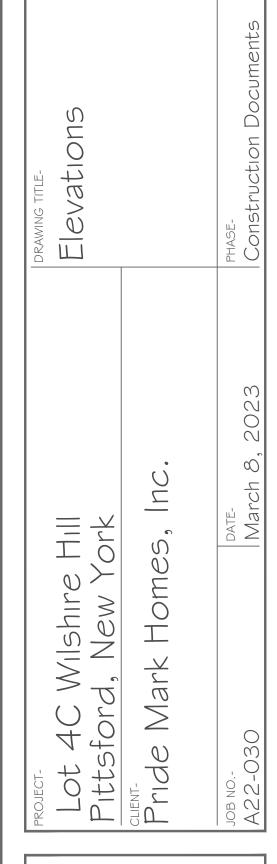



architecture

| 501 Pittsford Victor Road Suite 100 Victor, New York 14564 |
| phone-(585) 249-1334 |
| phone-(585) 249-134 |
| phone-(585)



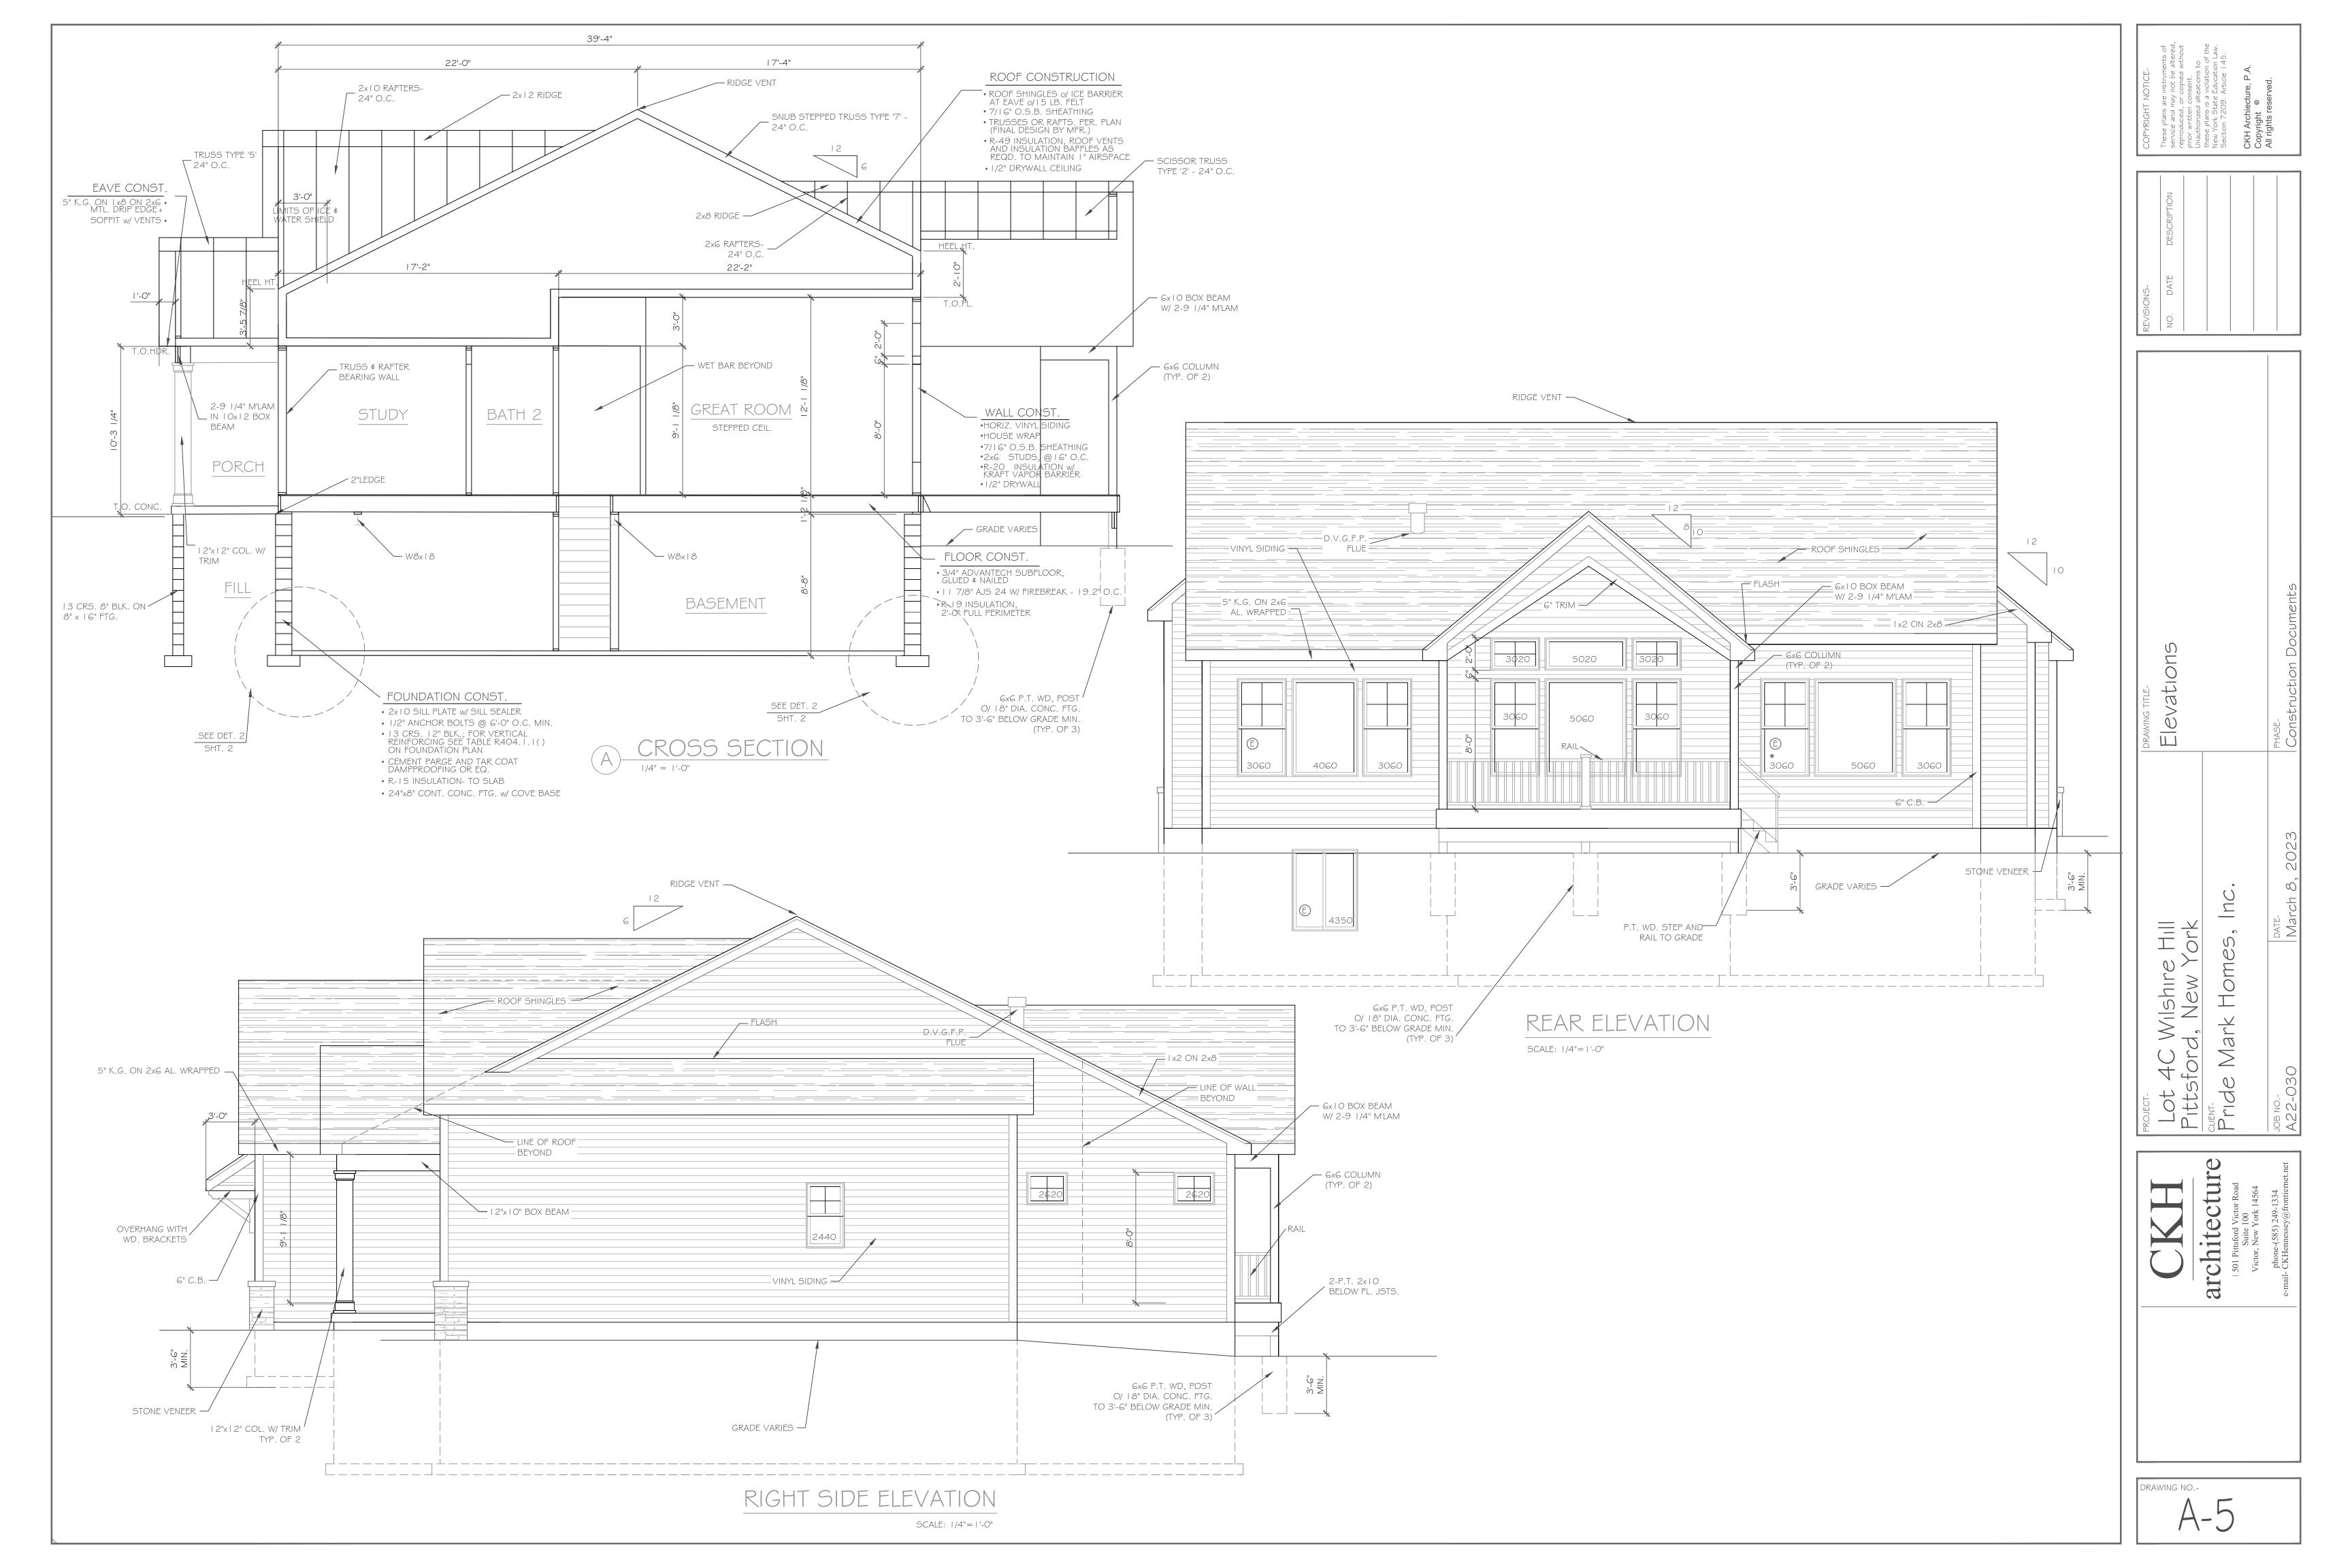

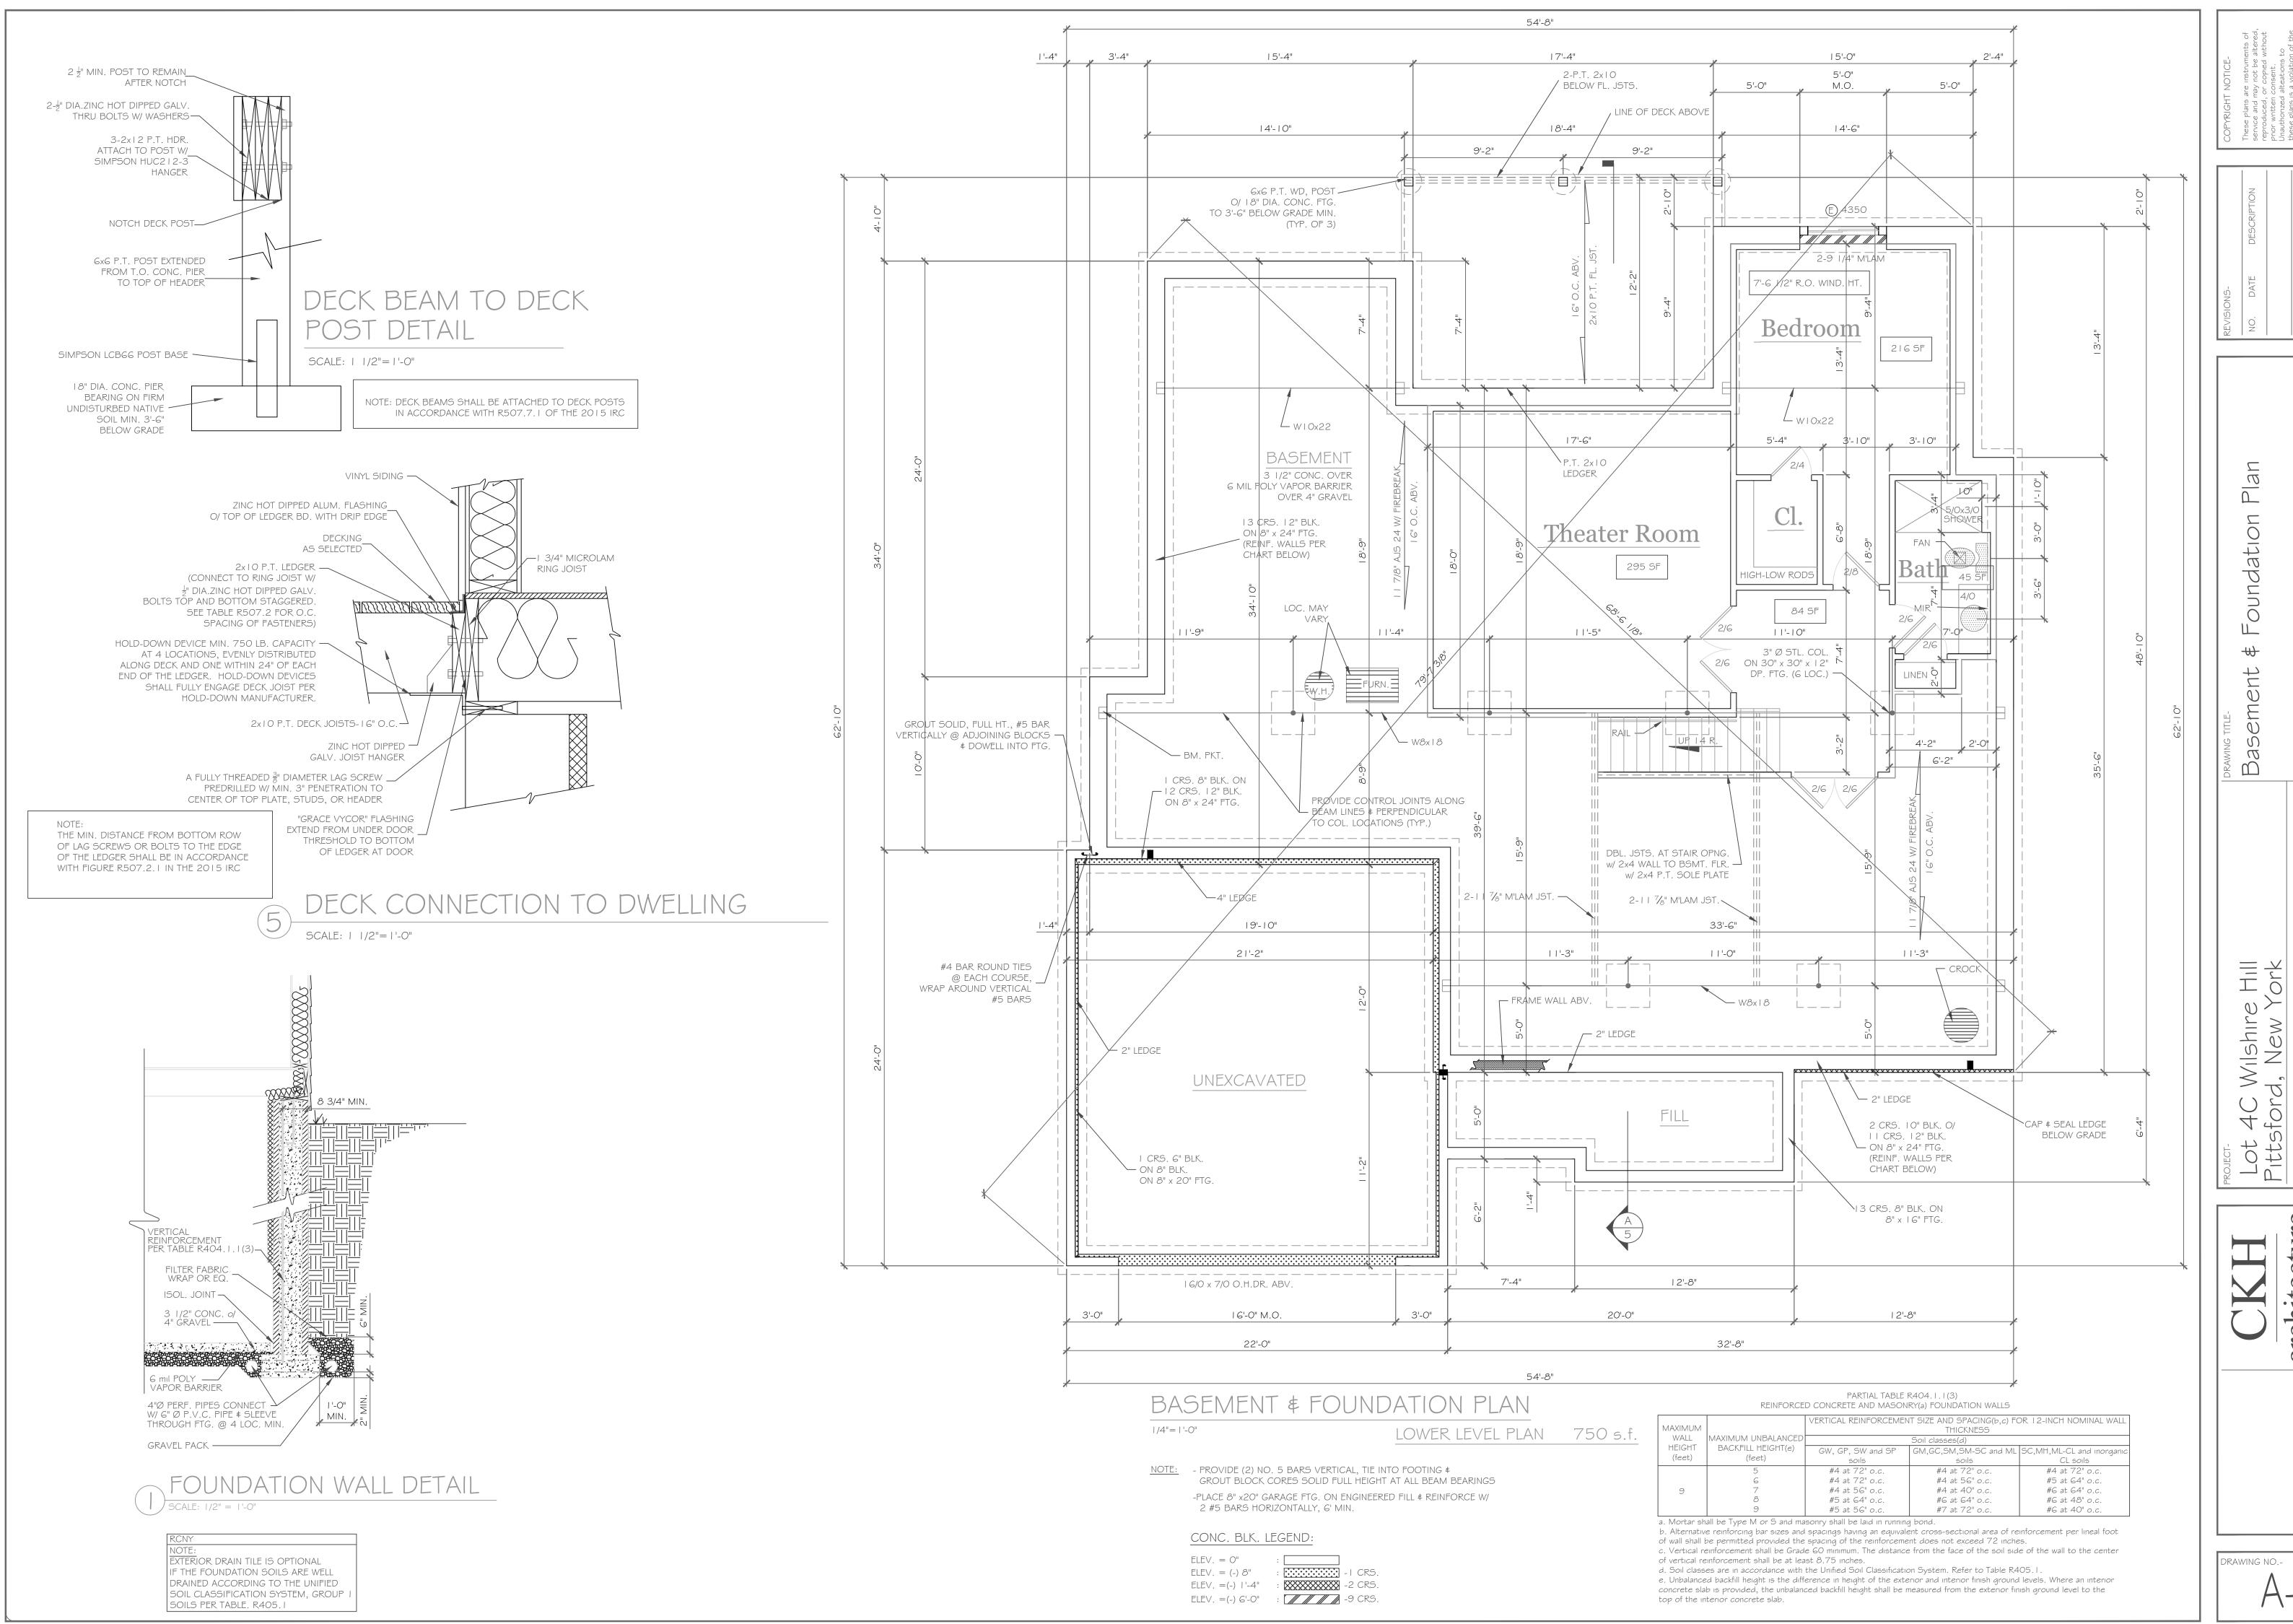

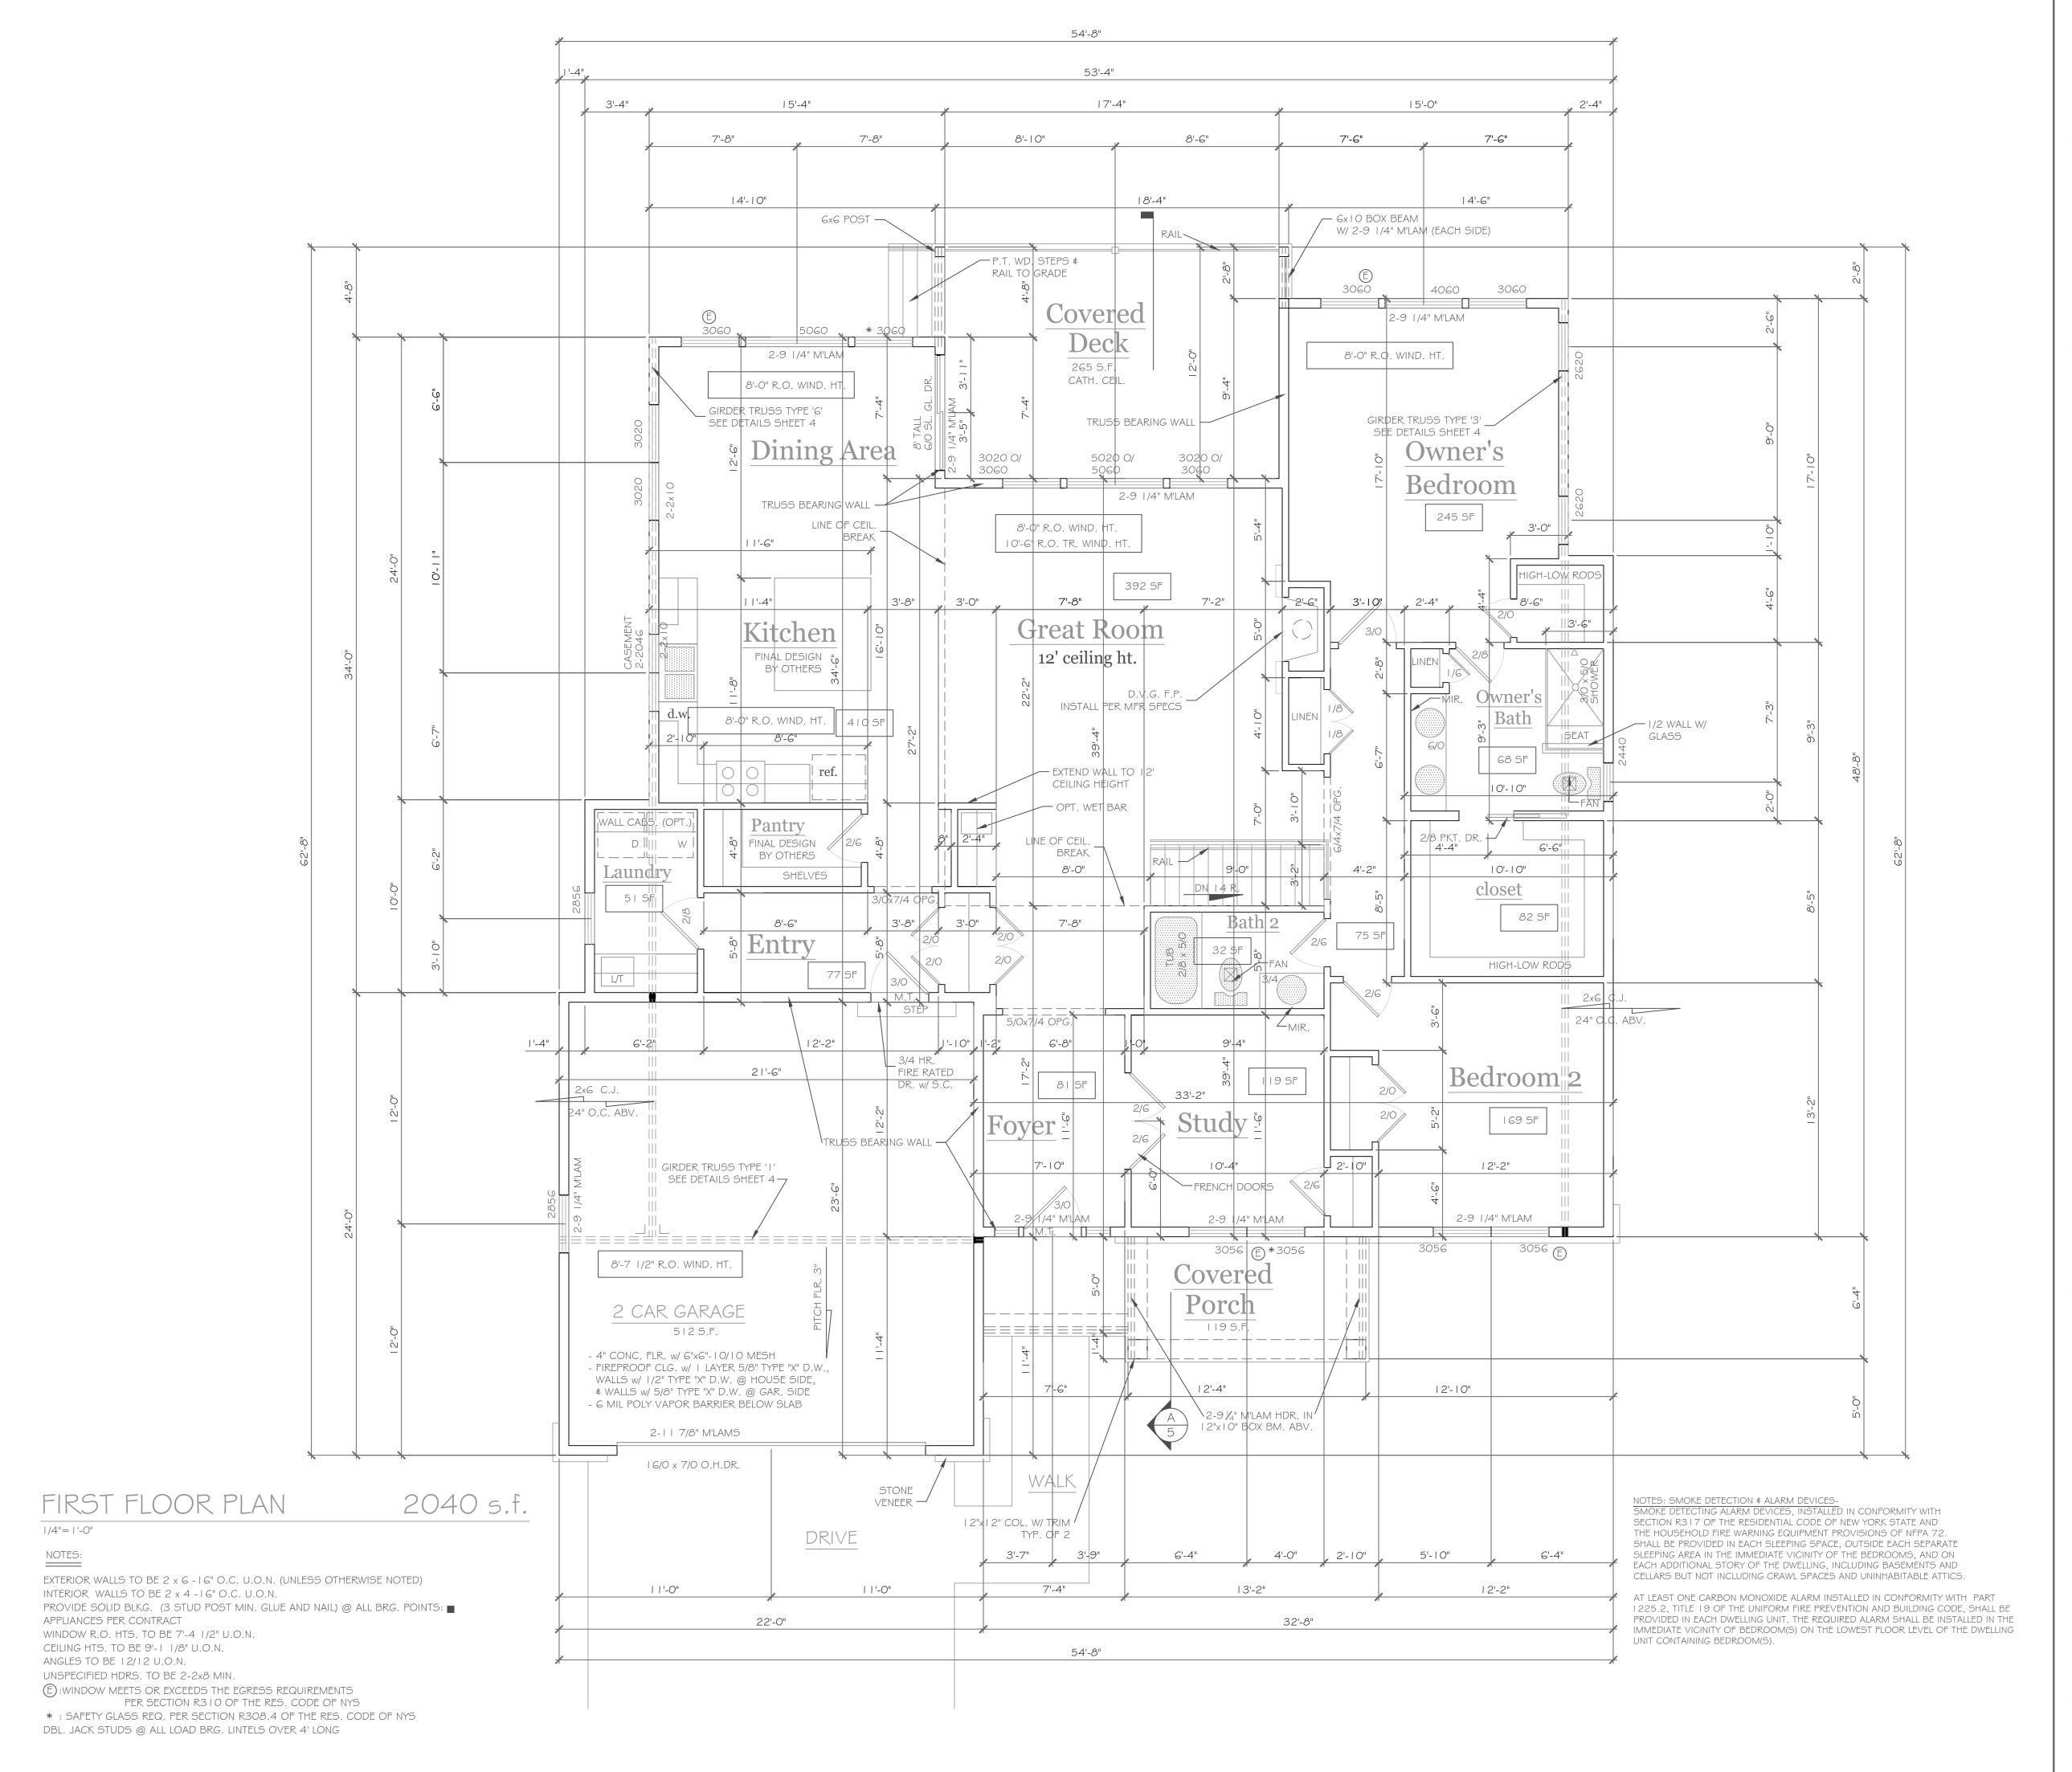

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PROJECTLot 4C Wilshire Hill
Pittsford, New York
CLENTPride Mark Homes, Inc.

DATEJOB NO.PROJECTPRAMIC TITLEPRAMIC FLOOR Plan
FIRST FLOOR Plan

DRAWING NO.-

architectur



Town of Pittsford

Department of Public Works 11 South Main Street Pittsford, New York 14534

Permit # B23-000008

Phone: 585-248-6250 FAX: 585-248-6262

DESIGN REVIEW AND HISTORIC PRESERVATION BOARD REFERRAL OF APPLICATION

Property Address: 2490 Lehigh Station Road	PITTSFORD, NY 14534
T. ID N 477 04 0 0 4	

Tax ID Number: 177.01-2-8.1

Zoning District: RN Residential Neighborhood

Owner: Kody Young Applicant: Kody Young

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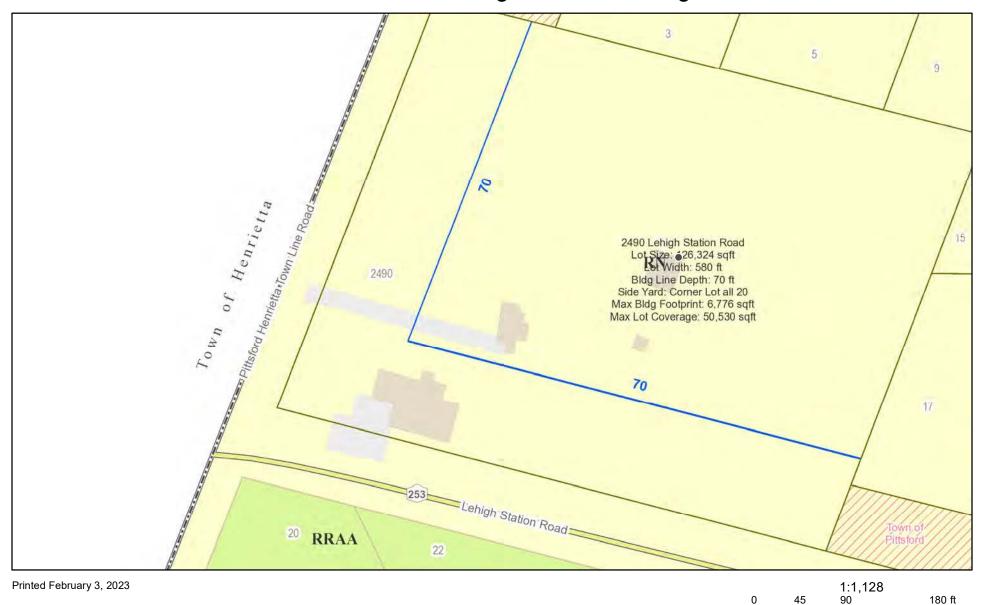
~	Residential Design Review	Build to Line Adjustment
	§185-205 (B)	§185-17 (B) (2)
	Commercial Design Review	Building Height Above 30 Feet
	§185-205 (B)	§185-17 (M)
	Signage	Corner Lot Orientation
	§185-205 (C)	§185-17 (K) (3)
	Certificate of Appropriateness	Flag Lot Building Line Location
	§185-197	§185-17 (L) (1) (c)
	Landmark Designation	Undeveloped Flag Lot Requirements
	§185-195 (2)	§185-17 (L) (2)
	Informal Review	

Project Description: The applicant is requesting design review for an addition of a 2650 sf garage addition off the side of the existing house.

Meeting Date: March 23, 2023



RN Residential Neighborhood Zoning



Town of Pittsford GIS


12.5

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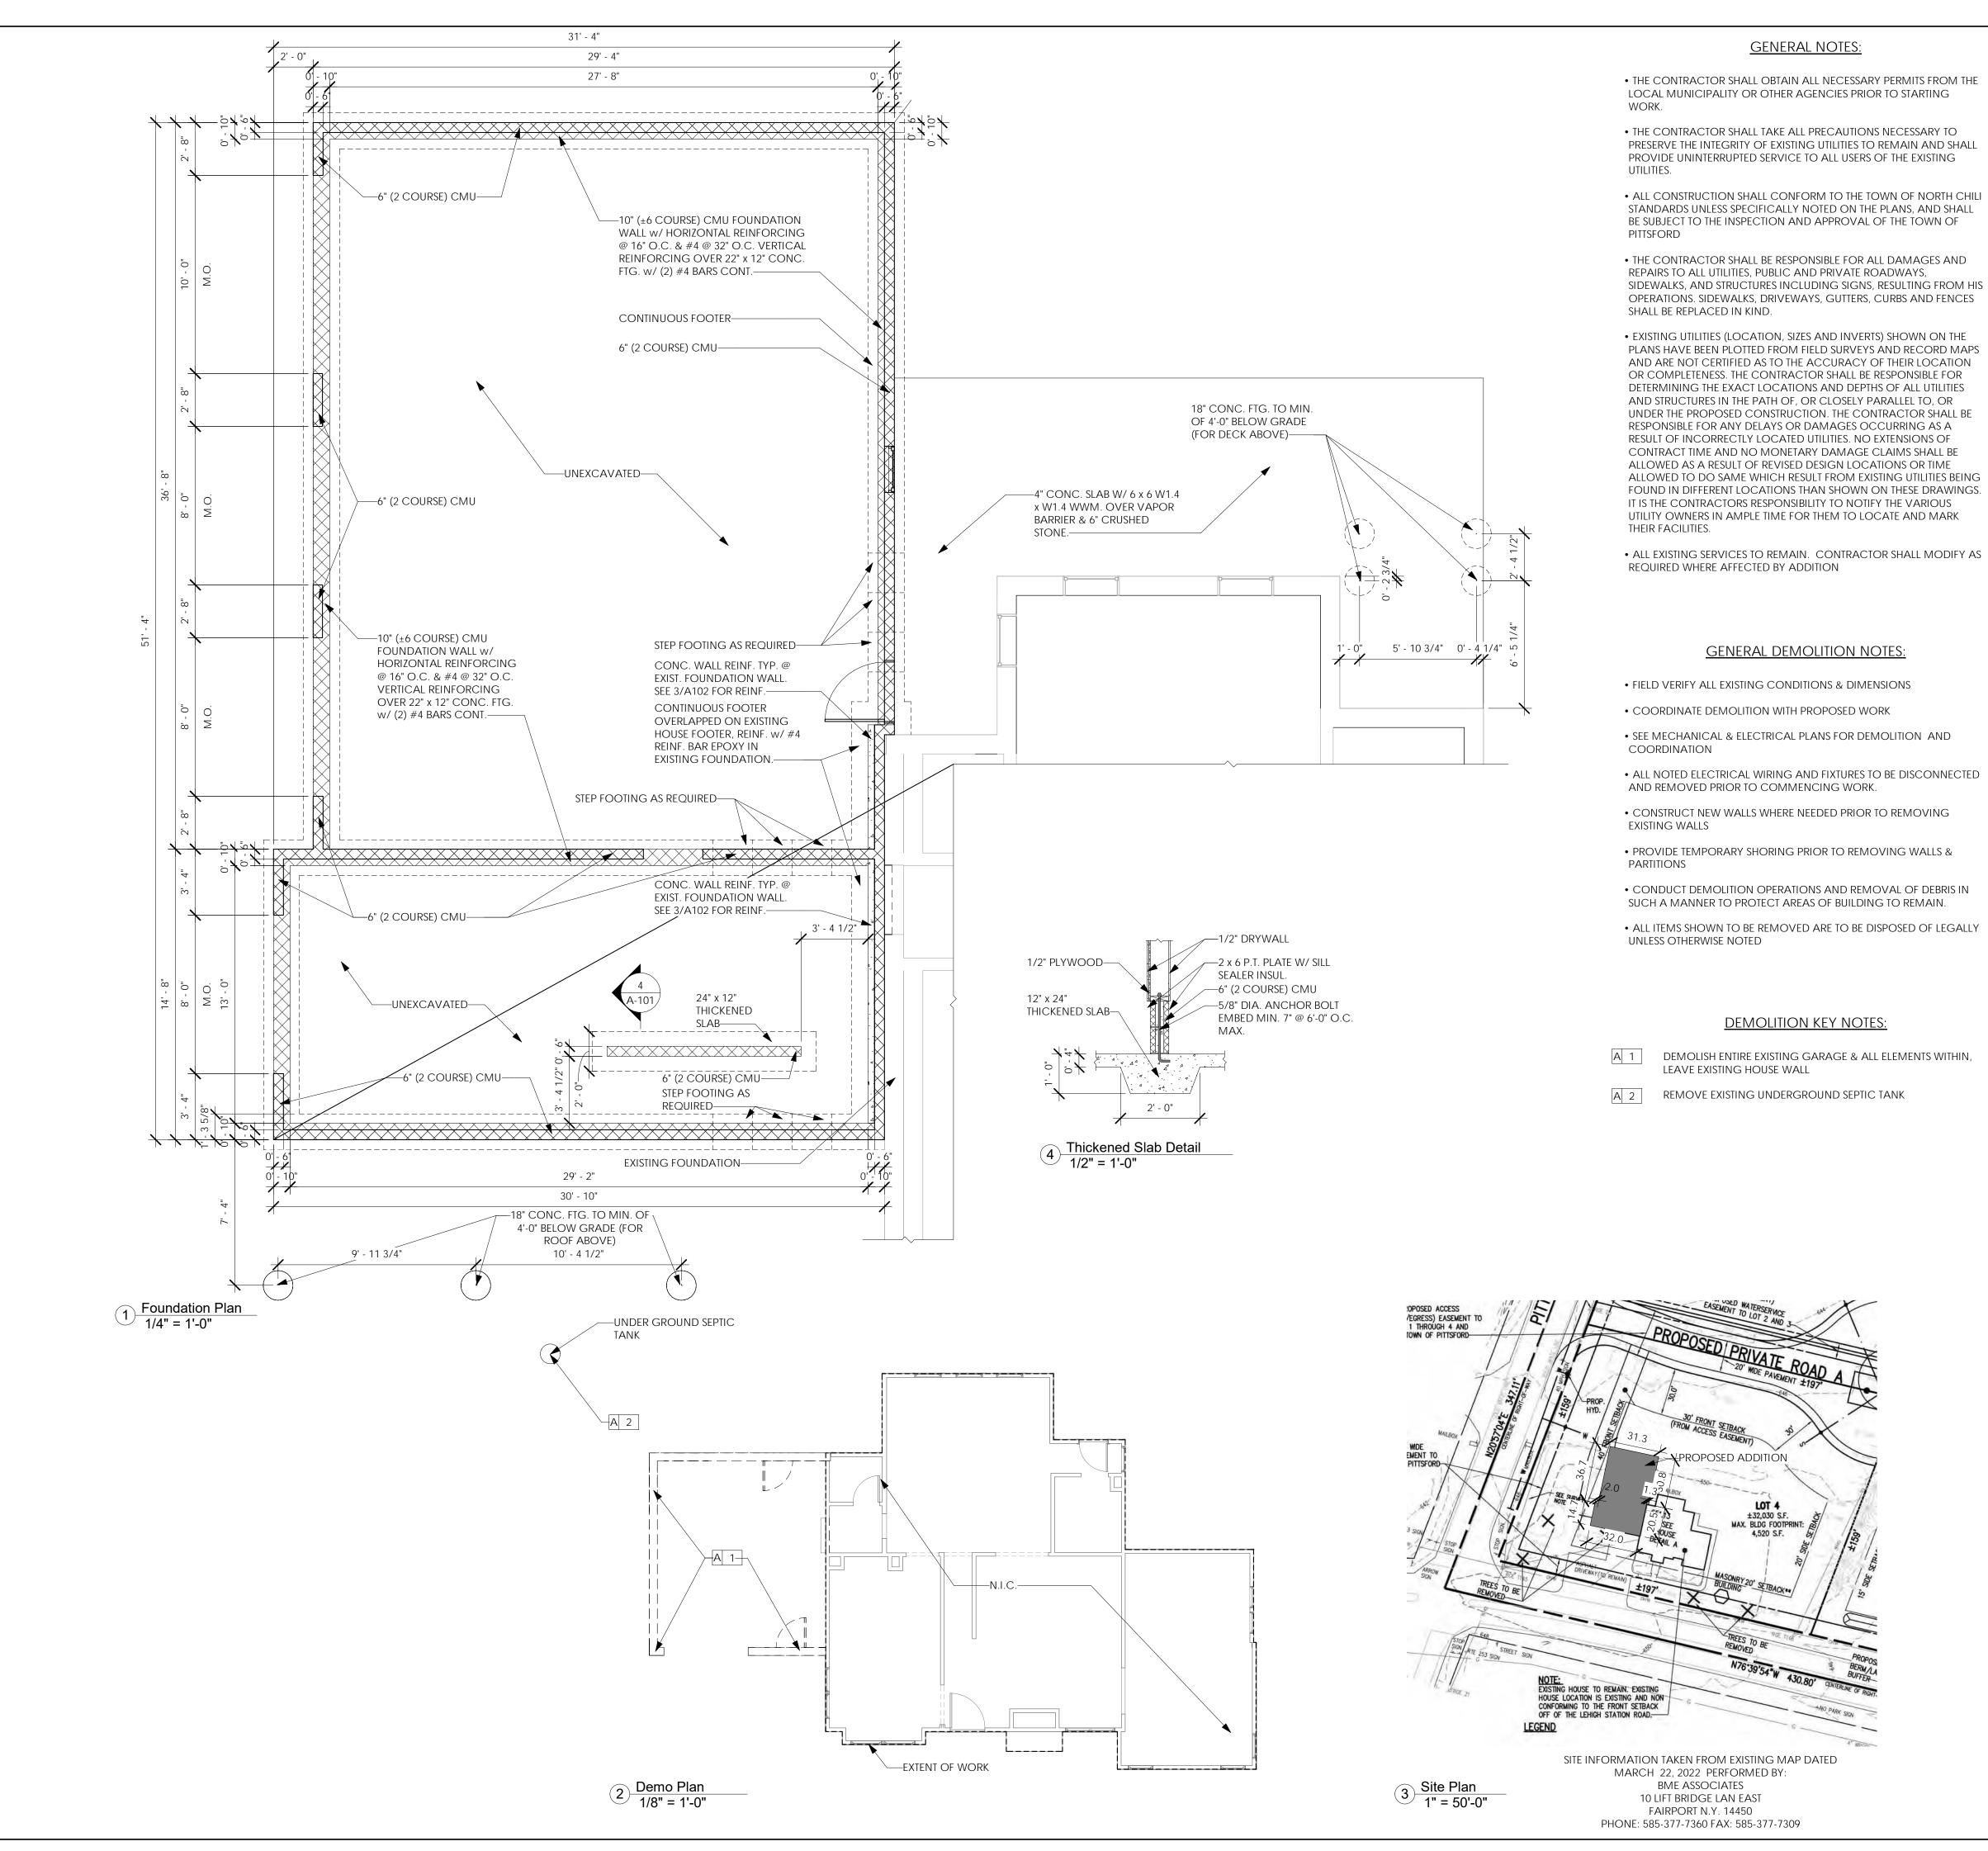
50 m







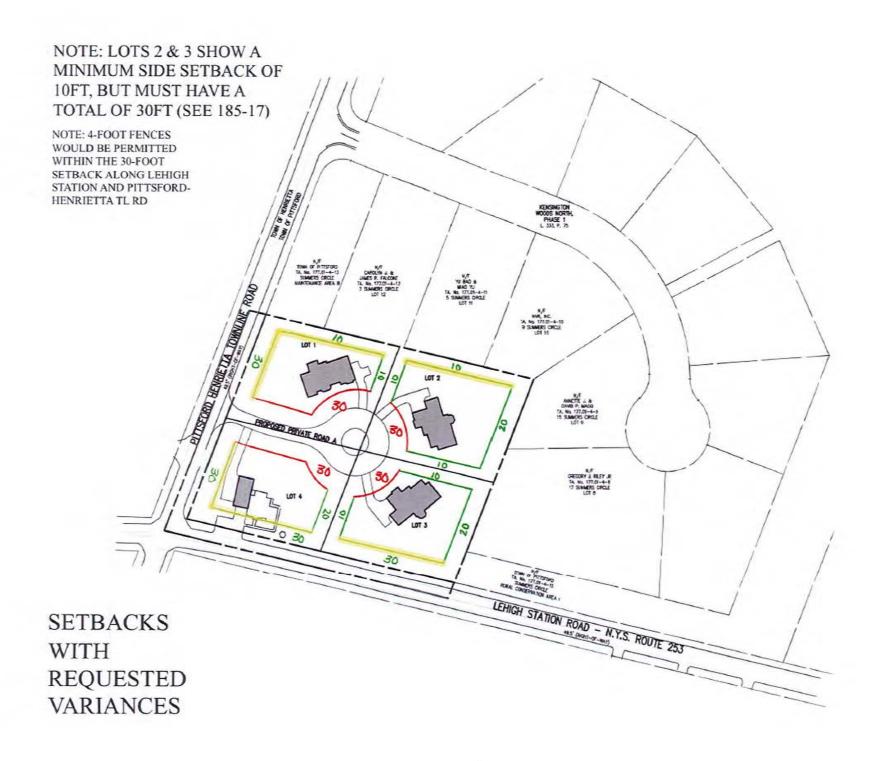



- THE CONTRACTOR SHALL OBTAIN ALL NECESSARY PERMITS FROM THE LOCAL MUNICIPALITY OR OTHER AGENCIES PRIOR TO STARTING
- THE CONTRACTOR SHALL TAKE ALL PRECAUTIONS NECESSARY TO PRESERVE THE INTEGRITY OF EXISTING UTILITIES TO REMAIN AND SHALL PROVIDE UNINTERRUPTED SERVICE TO ALL USERS OF THE EXISTING
- ALL CONSTRUCTION SHALL CONFORM TO THE TOWN OF NORTH CHILI STANDARDS UNLESS SPECIFICALLY NOTED ON THE PLANS, AND SHALL BE SUBJECT TO THE INSPECTION AND APPROVAL OF THE TOWN OF
- THE CONTRACTOR SHALL BE RESPONSIBLE FOR ALL DAMAGES AND REPAIRS TO ALL UTILITIES, PUBLIC AND PRIVATE ROADWAYS, SIDEWALKS, AND STRUCTURES INCLUDING SIGNS, RESULTING FROM HIS OPERATIONS. SIDEWALKS, DRIVEWAYS, GUTTERS, CURBS AND FENCES
- PLANS HAVE BEEN PLOTTED FROM FIELD SURVEYS AND RECORD MAPS AND ARE NOT CERTIFIED AS TO THE ACCURACY OF THEIR LOCATION OR COMPLETENESS. THE CONTRACTOR SHALL BE RESPONSIBLE FOR DETERMINING THE EXACT LOCATIONS AND DEPTHS OF ALL UTILITIES AND STRUCTURES IN THE PATH OF, OR CLOSELY PARALLEL TO, OR UNDER THE PROPOSED CONSTRUCTION. THE CONTRACTOR SHALL BE RESPONSIBLE FOR ANY DELAYS OR DAMAGES OCCURRING AS A RESULT OF INCORRECTLY LOCATED UTILITIES. NO EXTENSIONS OF CONTRACT TIME AND NO MONETARY DAMAGE CLAIMS SHALL BE ALLOWED AS A RESULT OF REVISED DESIGN LOCATIONS OR TIME ALLOWED TO DO SAME WHICH RESULT FROM EXISTING UTILITIES BEING FOUND IN DIFFERENT LOCATIONS THAN SHOWN ON THESE DRAWINGS. IT IS THE CONTRACTORS RESPONSIBILITY TO NOTIFY THE VARIOUS UTILITY OWNERS IN AMPLE TIME FOR THEM TO LOCATE AND MARK

- ALL NOTED ELECTRICAL WIRING AND FIXTURES TO BE DISCONNECTED

- ALL ITEMS SHOWN TO BE REMOVED ARE TO BE DISPOSED OF LEGALLY
- DEMOLISH ENTIRE EXISTING GARAGE & ALL ELEMENTS WITHIN,

GENERAL NOTES:

- CONSTRUCTION SHALL CONFORM TO THE RESIDENTIAL CODE OF NEW YORK STATE, AND REGULATIONS OF THE TOWN OF PITTSFORD
- CONTRACTOR IS TO OBTAIN BUILDING PERMITS, PAY FEES, COORDINATE THE SCHEDULE OF INSPECTIONS AS REQUIRED BY THE TOWN OF PITTSFORD

WITHIN 1'-0' OF GRADE OR EXPOSED TO THE EXTERIOR SHALL BE

PRESSURE PRESERVATIVE TREATED.

- LUMBER DESIGN BASED ON MINIMUM DESIGN PROPERTIES FOR NO. 2 GRADE LUMBER OF DOUGLAS FIR
- WOOD IN CONTACT WITH MASONRY, CONCRETE OR EARTH, OR
- FRAMING ANCHORS, JOIST HANGERS, AND MISCELLANEOUS METAL, CONNECTING DEVICES FOR WOOD FRAMING SHALL BE GALVANIZED STEEL OF AT LEAST 16 GAGE THICKNESS. INSTALL IN STRICT ACCORDANCE WITH MANUFACTURER'S RECOMMENDATIONS. USE NAILS SUPPLIED BY OR RECOMMENDED BY THE MANUF.
- DOUBLE ALL JOIST UNDER PARALLEL WALLS, AND AT FLOOR
- THE GENERAL CONTRACTOR IS RESPONSIBLE FOR COMPLIANCE WITH ALL INFORMATION ON THE DRAWINGS.
- CONSTRUCTION METHODS AND CRAFTSMANSHIP ARE THE RESPONSIBILITY OF THE GENERAL CONTRACTOR.
- FIELD VERIFY ALL EXISTING CONDITIONS & DIMENSIONS
- ALL NEW WALL INFILLS & EXTENSIONS SHALL BE FLUSH WITH BOTH SIDES OF EXIST. WALL
- PROVIDE SHELVING IN CLOSETS. COORDINATE SHELVING DESIGN WITH OWNER
- PATCH & REPAIR DAMAGED EXISTING DRYWALL
- ALL NEW INTERIOR DOOR HEADERS TO BE (2) 2 x 8 UNLESS OTHERWISE NOTED.
- ALL NEW WINDOW HEADERS TO BE (3) 2 x 8 UNLESS OTHERWISE
- ALL DOORS OPENING AND WINDOWS FRAMING SHALL BE 1 KING
- STUD & 2 JACK STUDS. (TYP)
- PROVIDE 3 1/2" SOUND ATTENUATION BATTS AT ALL PARTITIONS BETWEEN BATHROOMS AND OTHER ROOMS
- PROVIDE 1/2" MOISTURE RESISTANT DRYWALL AT ALL BATHROOMS
- NEW FIXTURES TO BE SELECTED BY OWNER, INSTALLED BY CONTRACTOR
- NEW APPLIANCES (AS REQ'D) TO BE FURNISHED BY OWNER, INSTALLED BY CONTRACTOR
- CONTRACTOR TO COORDINATE ELECTRICAL, HVAC AND PLUMBING NEEDS & CONNECTIONS WITH OWNER AND INCLUDE REQUIRED
- WORK IN BID PRICING
- CONTRACTOR TO INSTALL AT LEAST (1) SMOKE DETECTOR IN EACH BEDROOM & (1) OUTSIDE EACH SLEEPING AREA IN THE VICINITY OF THE BEDROOM, & (1) IN EACH SEPARATE STORY INCLUDING THE BASEMENT. ALL SMOKE DETECTORS SHALL BE WIRED INTO 120V WITHOUT DISCONNECTING SWITCH OTHER THAN CIRCUIT BREAKER & SHALL BE INTERCONNECTED SUCH THAT WHEN ONE ALARMS, ALL SHALL ALARM. (1) CARBON MONOXIDE DETECTOR IN DINING ROOM, NEAR KITCHEN. INSTALLATION OF SMOKE & CARBON MONOXIDE DETECTORS SHALL BE IN ACCORDANCE WITH ALL STATE & LOCAL CODES & THE HOUSEHOLD FIRE WARNING EQUIPMENT PROVISIONS OF NFPA 72. ALL DETECTORS SHALL BE EQUIPPED WITH BATTERY

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Project Architect/Engineer

Architect/Engineer Name

Project Lead

Project Designer

Lead Name

Designer Name

Date:

Date:

Date:

Date:

Date:

11/04/22

11/07/22

11/07/22


Issued:

| Issued for Client Review

Issued for Client Review

Issued for Bid Permit

Revisions:

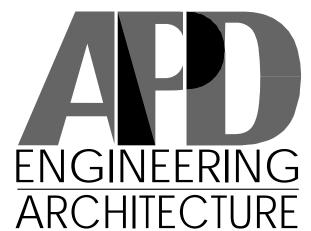

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GENERAL CONCRETE & **FOUNDATION NOTES:**

• ALLOWABLE SOIL BEARING ASSUMED AS 2500 P.S.F.

2'-0" HORIZONTAL.

POROUS FILL. (CRUSHED STONE)

- ALL CONCRETE TO HAVE A MINIMUM COMPRESSIVE STRENGTH OF 3500 P.S.I. AT 28 DAYS, UNLESS NOTED OTHERWISE.
- BOTTOM OF ALL FOOTINGS TO REST ON UNDISTURBED SOIL.
- STEPS IN ALL FOOTINGS NOT TO EXCEED 1'-0" VERTICAL FOR EACH
- ALL CONCRETE SLABS ON GRADE TO REST ON 6" COMPACTED
- ALL SLABS ON GRADE TO BE REINFORCED WITH 6 x 6 -W1.4 x W1.4
- WWM. UNLESS NOTED OTHERWISE. SPLICES FER CRSI LATEST EDITION.
- FILL COLUMN AND BEAM POCKETS WIITH CONCRETE AFTER ALL COLUMNS AND BEAMS ARE IN PLACE, UNLESS NOTED OTHERWISE • BACKFILL BOTH SIDES OF FOUNDATION WALLS SIMULTANEOUSLY:
- DECK AT TOP AND SLAB BOTTOM OF WALL ARE IN PLACE.
- SLEEVE FOUNDATION WALLS WHERE REQUIRED TO ACCOMMODATE DUCTS AND UTILITIES.

WALLS WITH FILL ON ONE SIDE ONLY, MUST NOT BE BACKFILLED UNTIL

- REINFORCING BARS TO CONFORM TO ASTM A-615 GRADE 60.
- EXCEPT REINFORCING FOR DOWELS TO SLABS TO BE GRADE 40. • STEEL MESH REINFORCING TO CONFORM TO ASTM A-185
- REINFORCING BAR SPLICES & EMBEDMENT LENGTHS TO CONFORM TO LATEST CRSI HANDBOOK COMPLYING WITH ACI 318-CODE OF LATEST ISSUE, UNLESS NOTED OTHERWISE.
- ALL SPLICES IN REINFORCING ARE TO BE CLASS "B", UNLESS NOTED OTHERWISE. CONSIDER ALL HORIZONTAL WALL BARS AS "TOP BARS"
- TERMINATE ALL BARS IN ACCORDANCE WITH ACI-318 CODE OF LATEST ISSUE, WITH A HOOK IF THE REQUIRED EMBEDMENT LENGTH CANNOT BE OBTAINED.
- PROVIDE #4 VERTICAL REINFORCING @ 32" O.C.- GROUT CORES WITH REINFORCING SOLID, PER TABLE R 404.1.1(3) OF THE RESIDENTIAL CODE OF N.Y.S.

Young Residence Addition

2490 Lehigh Station Rd Pittsford, NY 14534 Monroe County

Project Name & Location:

Site Plan, Existing/Demo Plan, Foundation Plan

Drawing Name:


Project No. Date: 11/07/22 21-0511


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Type: Residentia


A-101


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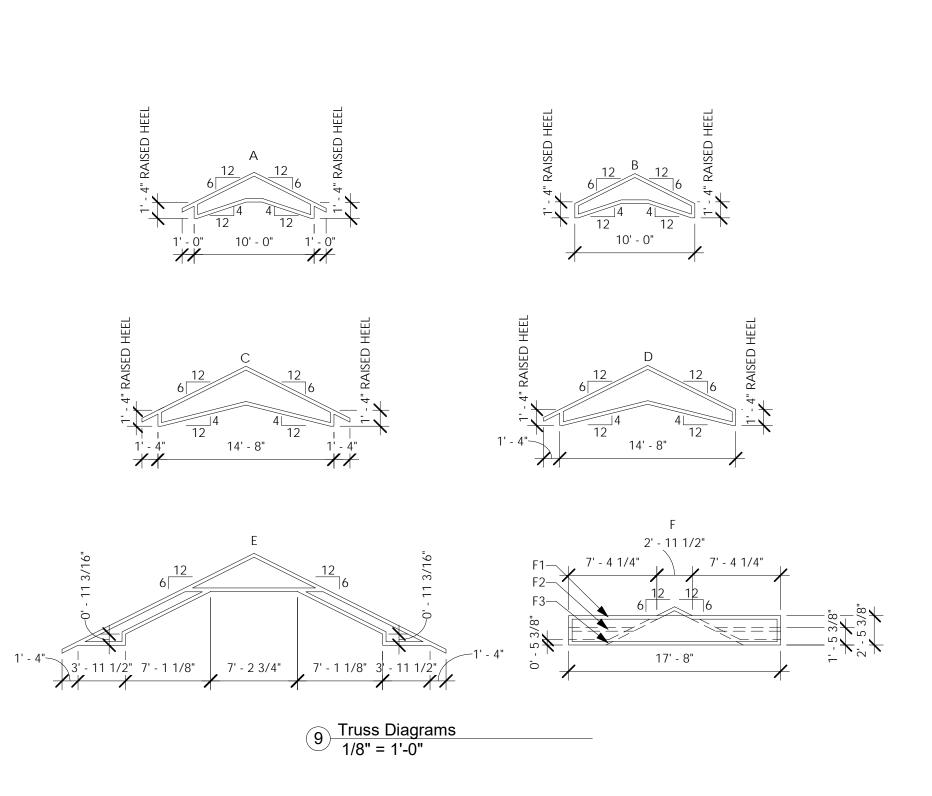


Back Deck Framing Plan
1/4" = 1'-0"

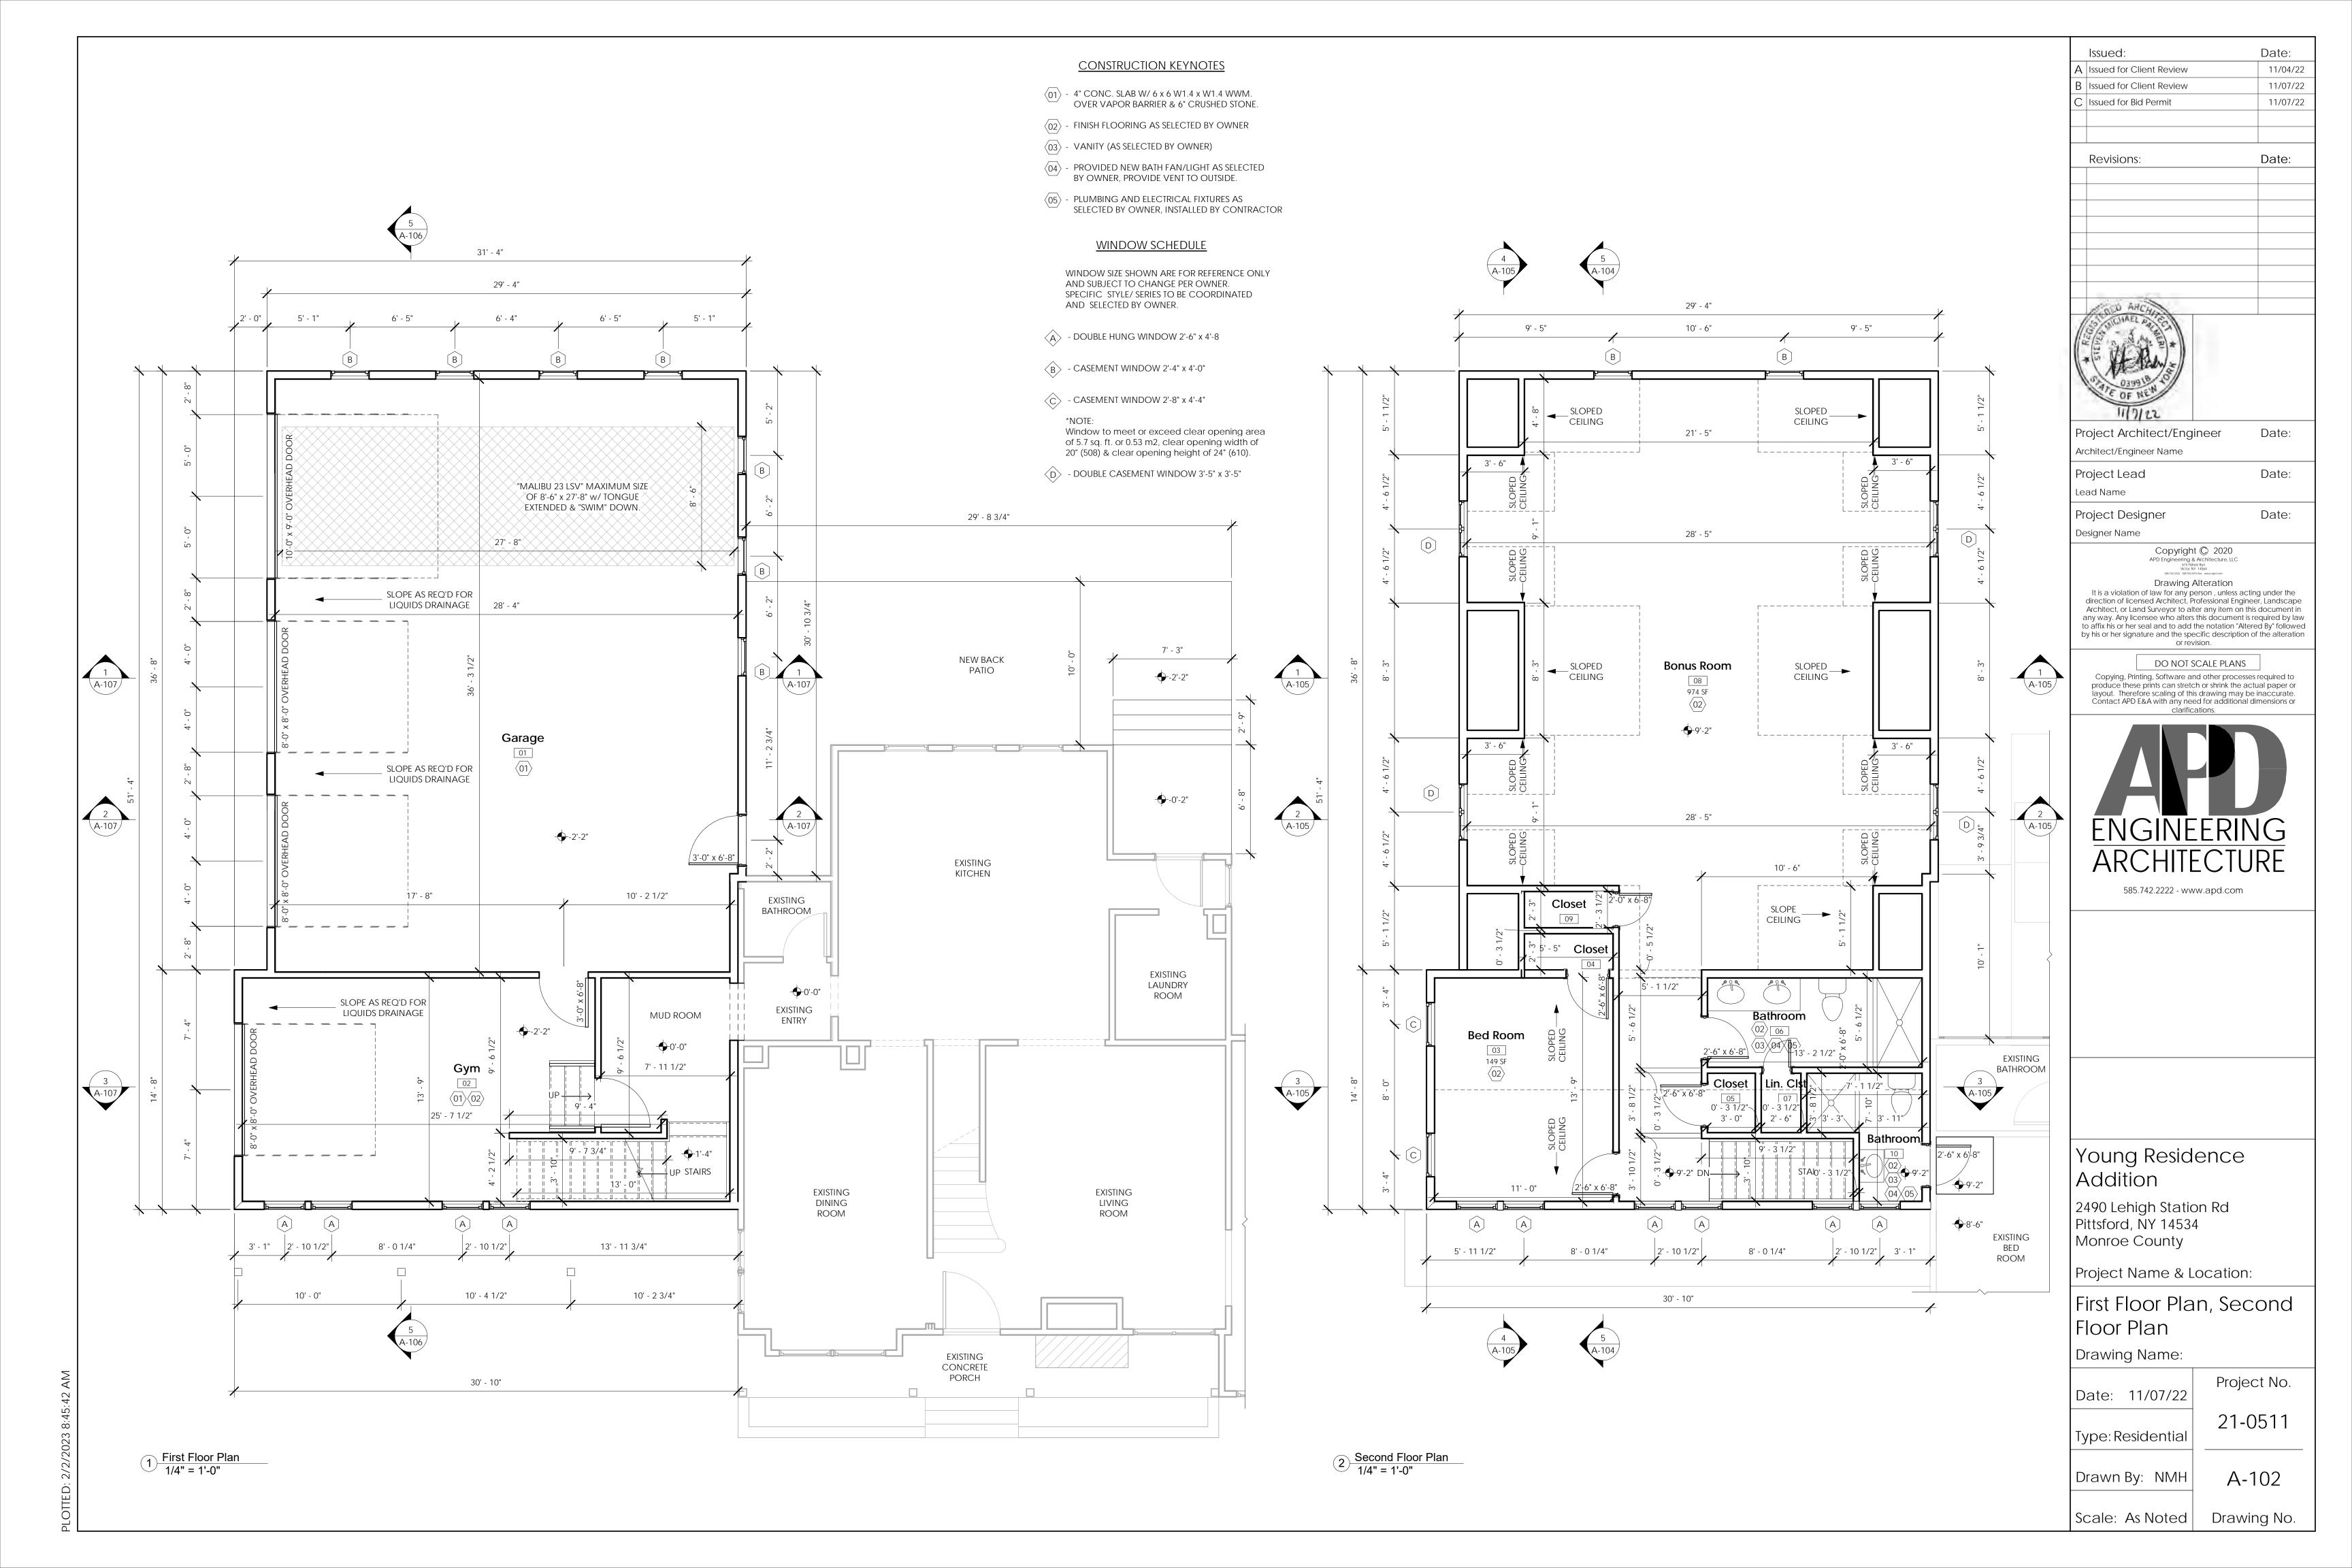

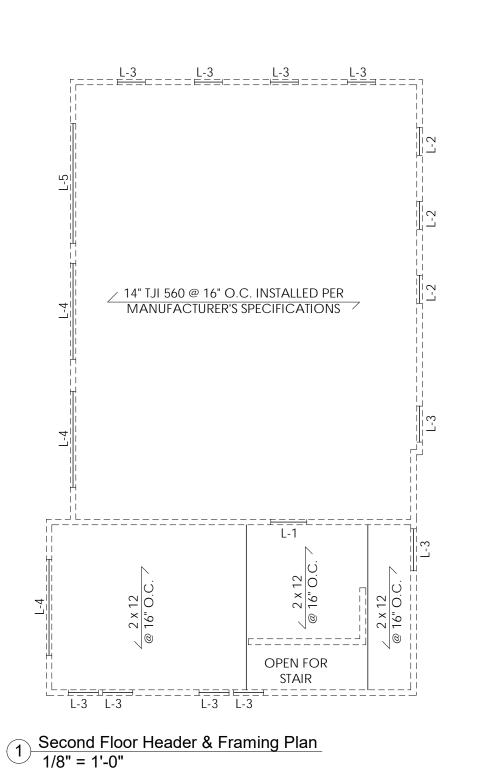

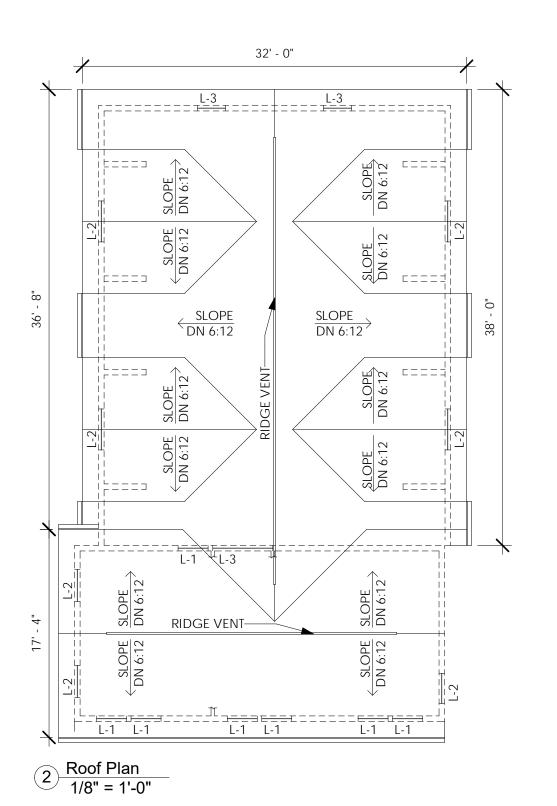NEW BACK PATIO 5' - 10 3/4" –18" CONC. FTG. TO MIN. OF 4'-0" BELOW GRADE P.T. 4 x 4 POST. PLACED BELOW DECK BEAM FOR SUPPORT AT LEDGER.-(2) P.T. 2 x 10 FASTEN LEDGER W/ 1/2"Ø LAG BOLTS @ 24" O.C. FASTENED IN ACCORDANCE W/ IRBC 507.9. PROVIDE MIN. 750 CAPACITY HOLD DOWN DEVICE @ 4 LOCATIONS EVENLY DISTRIBUTED ALONG DECK & WITH 24' EA END OF LEDGER. HOLD DOWN SHALL FULLY ENGAGE DECK JOIST PER HOLD DOWN MANUFACTURER (1) P.T. 2 x 10 KITCHEN

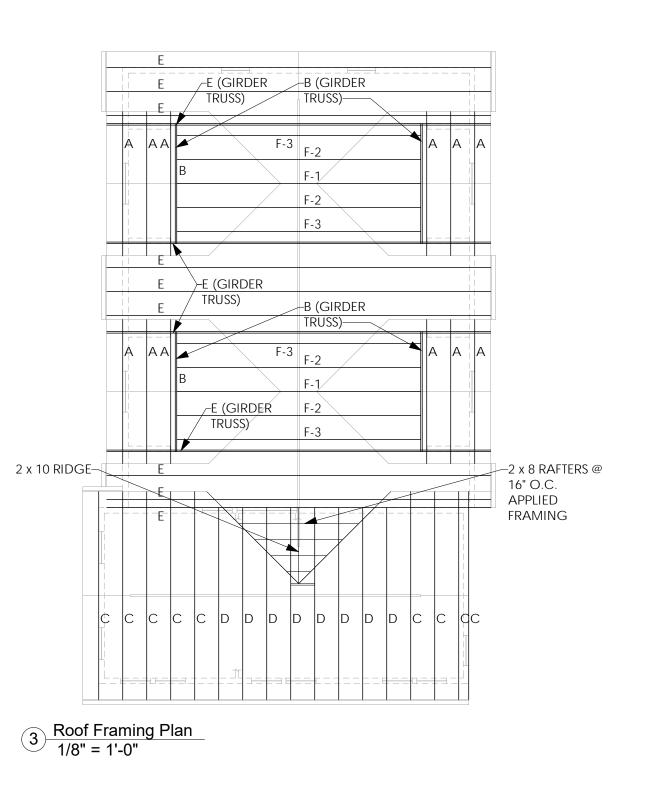

ROOF NOTES:

 PROVIDE MINIMUM 5'-0" WIDE ICE & WATER SHIELD UNDERLAYMENT ALONG EAVES AND AT VALLEYS

 PROVIDE ASPHALT SATURATED FELT UNDERLAYMENT ALL REMAINING AREAS

• PROVIDE ALUMINUM FASCIA, DRIP EDGE, VENTED SOFFITS, GUTTERS AND DOWNSPOUTS AT NEW ROOF AREAS, TO MATCH EXISTING.

• REMOVE EXISTING ROOF SHINGLES & UNDERLAYMENT. FURNISH AND INSTALL ICE & WATER UNDERLAYMENT & NEW ARCHITECTURAL SHINGLES AS REQ'D

• VERIFY IN FIELD EXISTING ROOF OVERHANGS. NEW OVERHANGS TO MATCH EXIST.

LINTEL & HEADER SCHEDULE:

L-1 - (3) 2 x 4 WITH (2)1/2" PLYWOOD GUSSET (2 x 6 EXTERIOR WALLS)
L-2 - (3) 2 x 6 WITH (2)1/2" PLYWOOD GUSSET (2 x 6 EXTERIOR WALLS)
L-3 - (3) 2 x 8 WITH (2)1/2" PLYWOOD GUSSET (2 x 6 EXTERIOR WALLS)
L-4 - 2.0E MICROLAM LVL 5 1/4" WIDE (3 PLY) x 9 1/4" (8'-0" WIDE GARAGE DOOR)
L-5 - 2.0E MICROLAM LVL 5 1/4" WIDE (3 PLY) x 11 1/4" (10'-0" WIDE GARAGE DOOR)

NOTE:

NOTE:

PRE-ENGINEERED WOOD TRUSS SYSTEM SHALL BE DESIGNED BY A N.Y.S. LICENSED ARCHITECT OR ENGINEER FOR THE FOLLOWING LOADS:

TOP CHORD DEAD LOAD: 10#
TOP CHORD SNOW LOAD: 50# GROUND
BOTTOM CHORD DEAD LOAD: 10#

NOTE:

• ALL TRUSSES TO BE 2'-0" O.C.


 ALL STICK FRAMING SHALL BE: 2x10 RIDGE & HIP MEMBERS 2x8 RAFTERS @ 16" O.C. UNLESS OTHERWISE NOTES

VERIFY PITCH OF EXISTING ROOF PRIOR TO ORDERING TRUSS


 CONTRACTOR SHALL FURNISH TRUSS SHOP DRAWINGS WITH ENGINEER OR ARCHITECT SEAL & SIGNATURE

 TRUSS MANUFACTURER TO PROIVDE RECOMMENDED ROOF TRUSS SYSTEM BRACING DIAGRAM

• ROOF TRUSS SHALL BE INSTALLED USING SIMPSON HURRICANE TIES H8 OR APPROVED EQUAL.

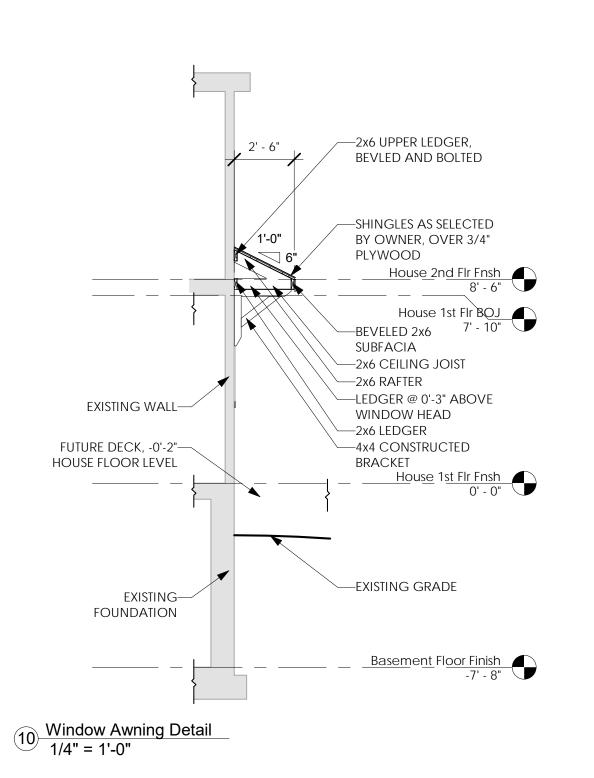

	Issued:	Date:
Α	Issued for Client Review	11/04/22
В	Issued for Client Review	11/07/22
C	Issued for Bid Permit	11/07/22
	Revisions:	Date:
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Designer Name

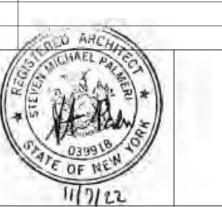Project Architect/Engineer Date:

Architect/Engineer Name

Project Lead Date:

Project Designer Date:

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Young Residence Addition

2490 Lehigh Station Rd Pittsford, NY 14534 Monroe County

Project Name & Location:

Roof Framing, Plan & Truss Diagram

Drawing Name:

Date: 11/07/22


Type: Residential 21-0511


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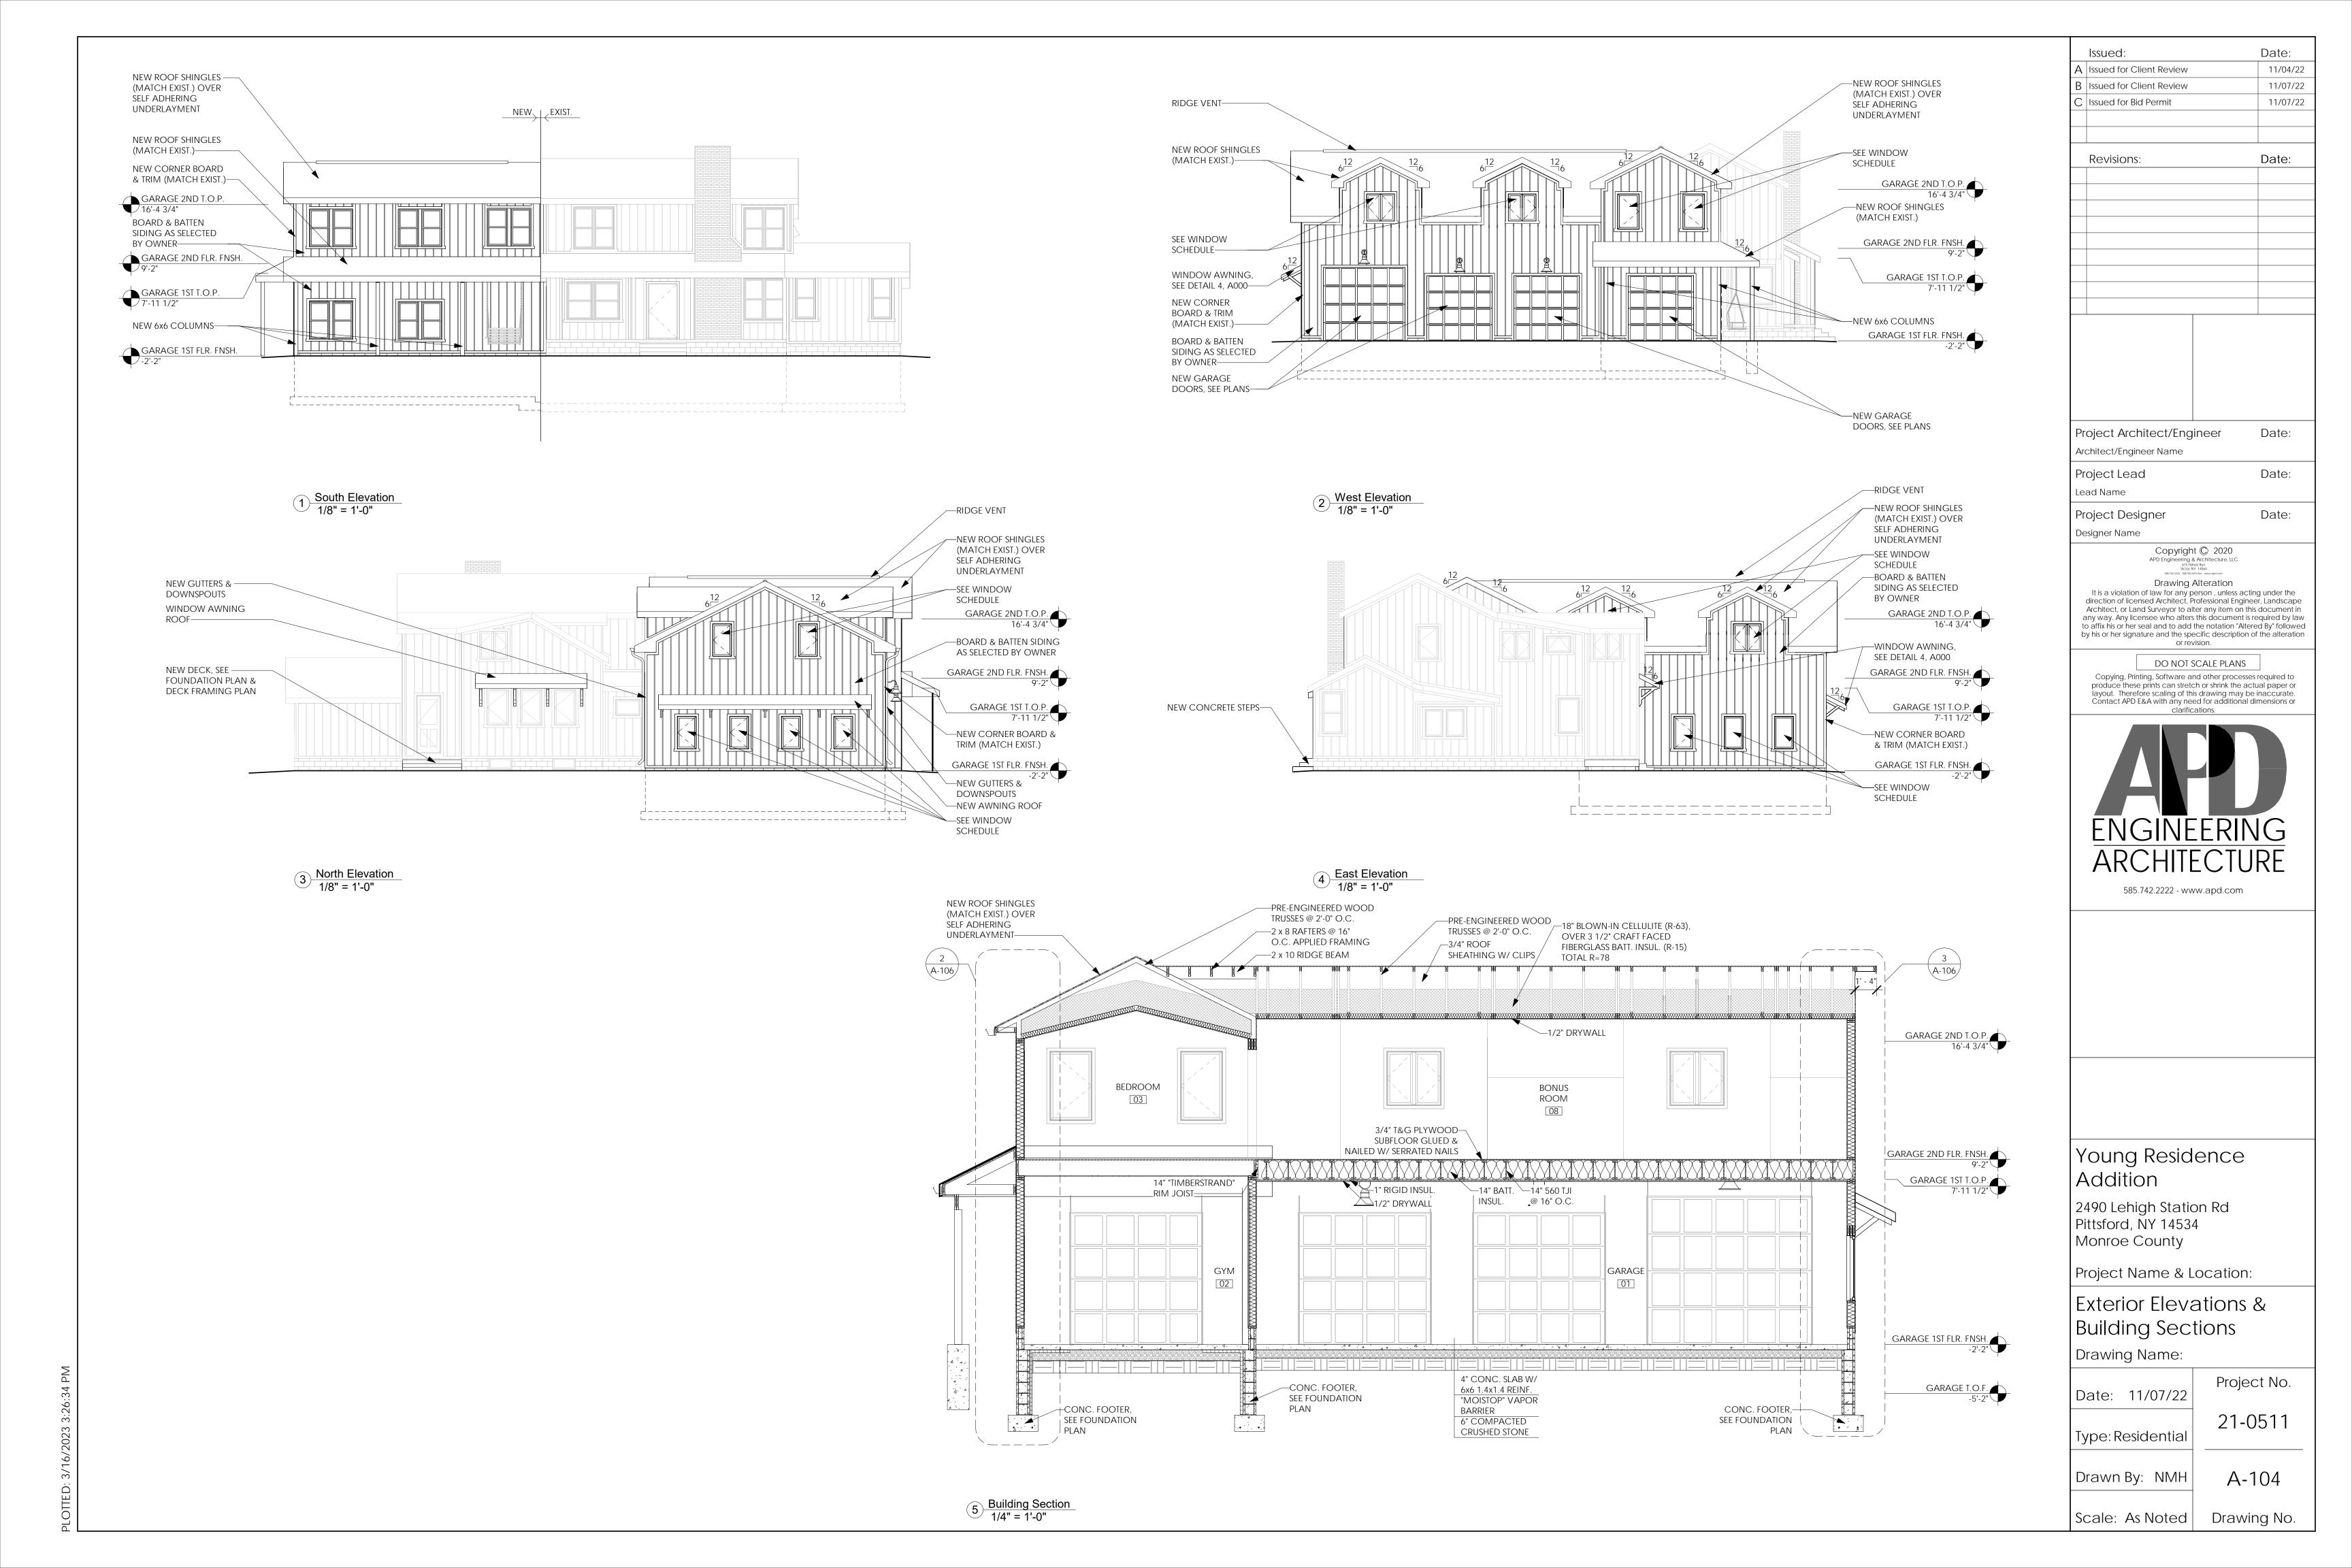
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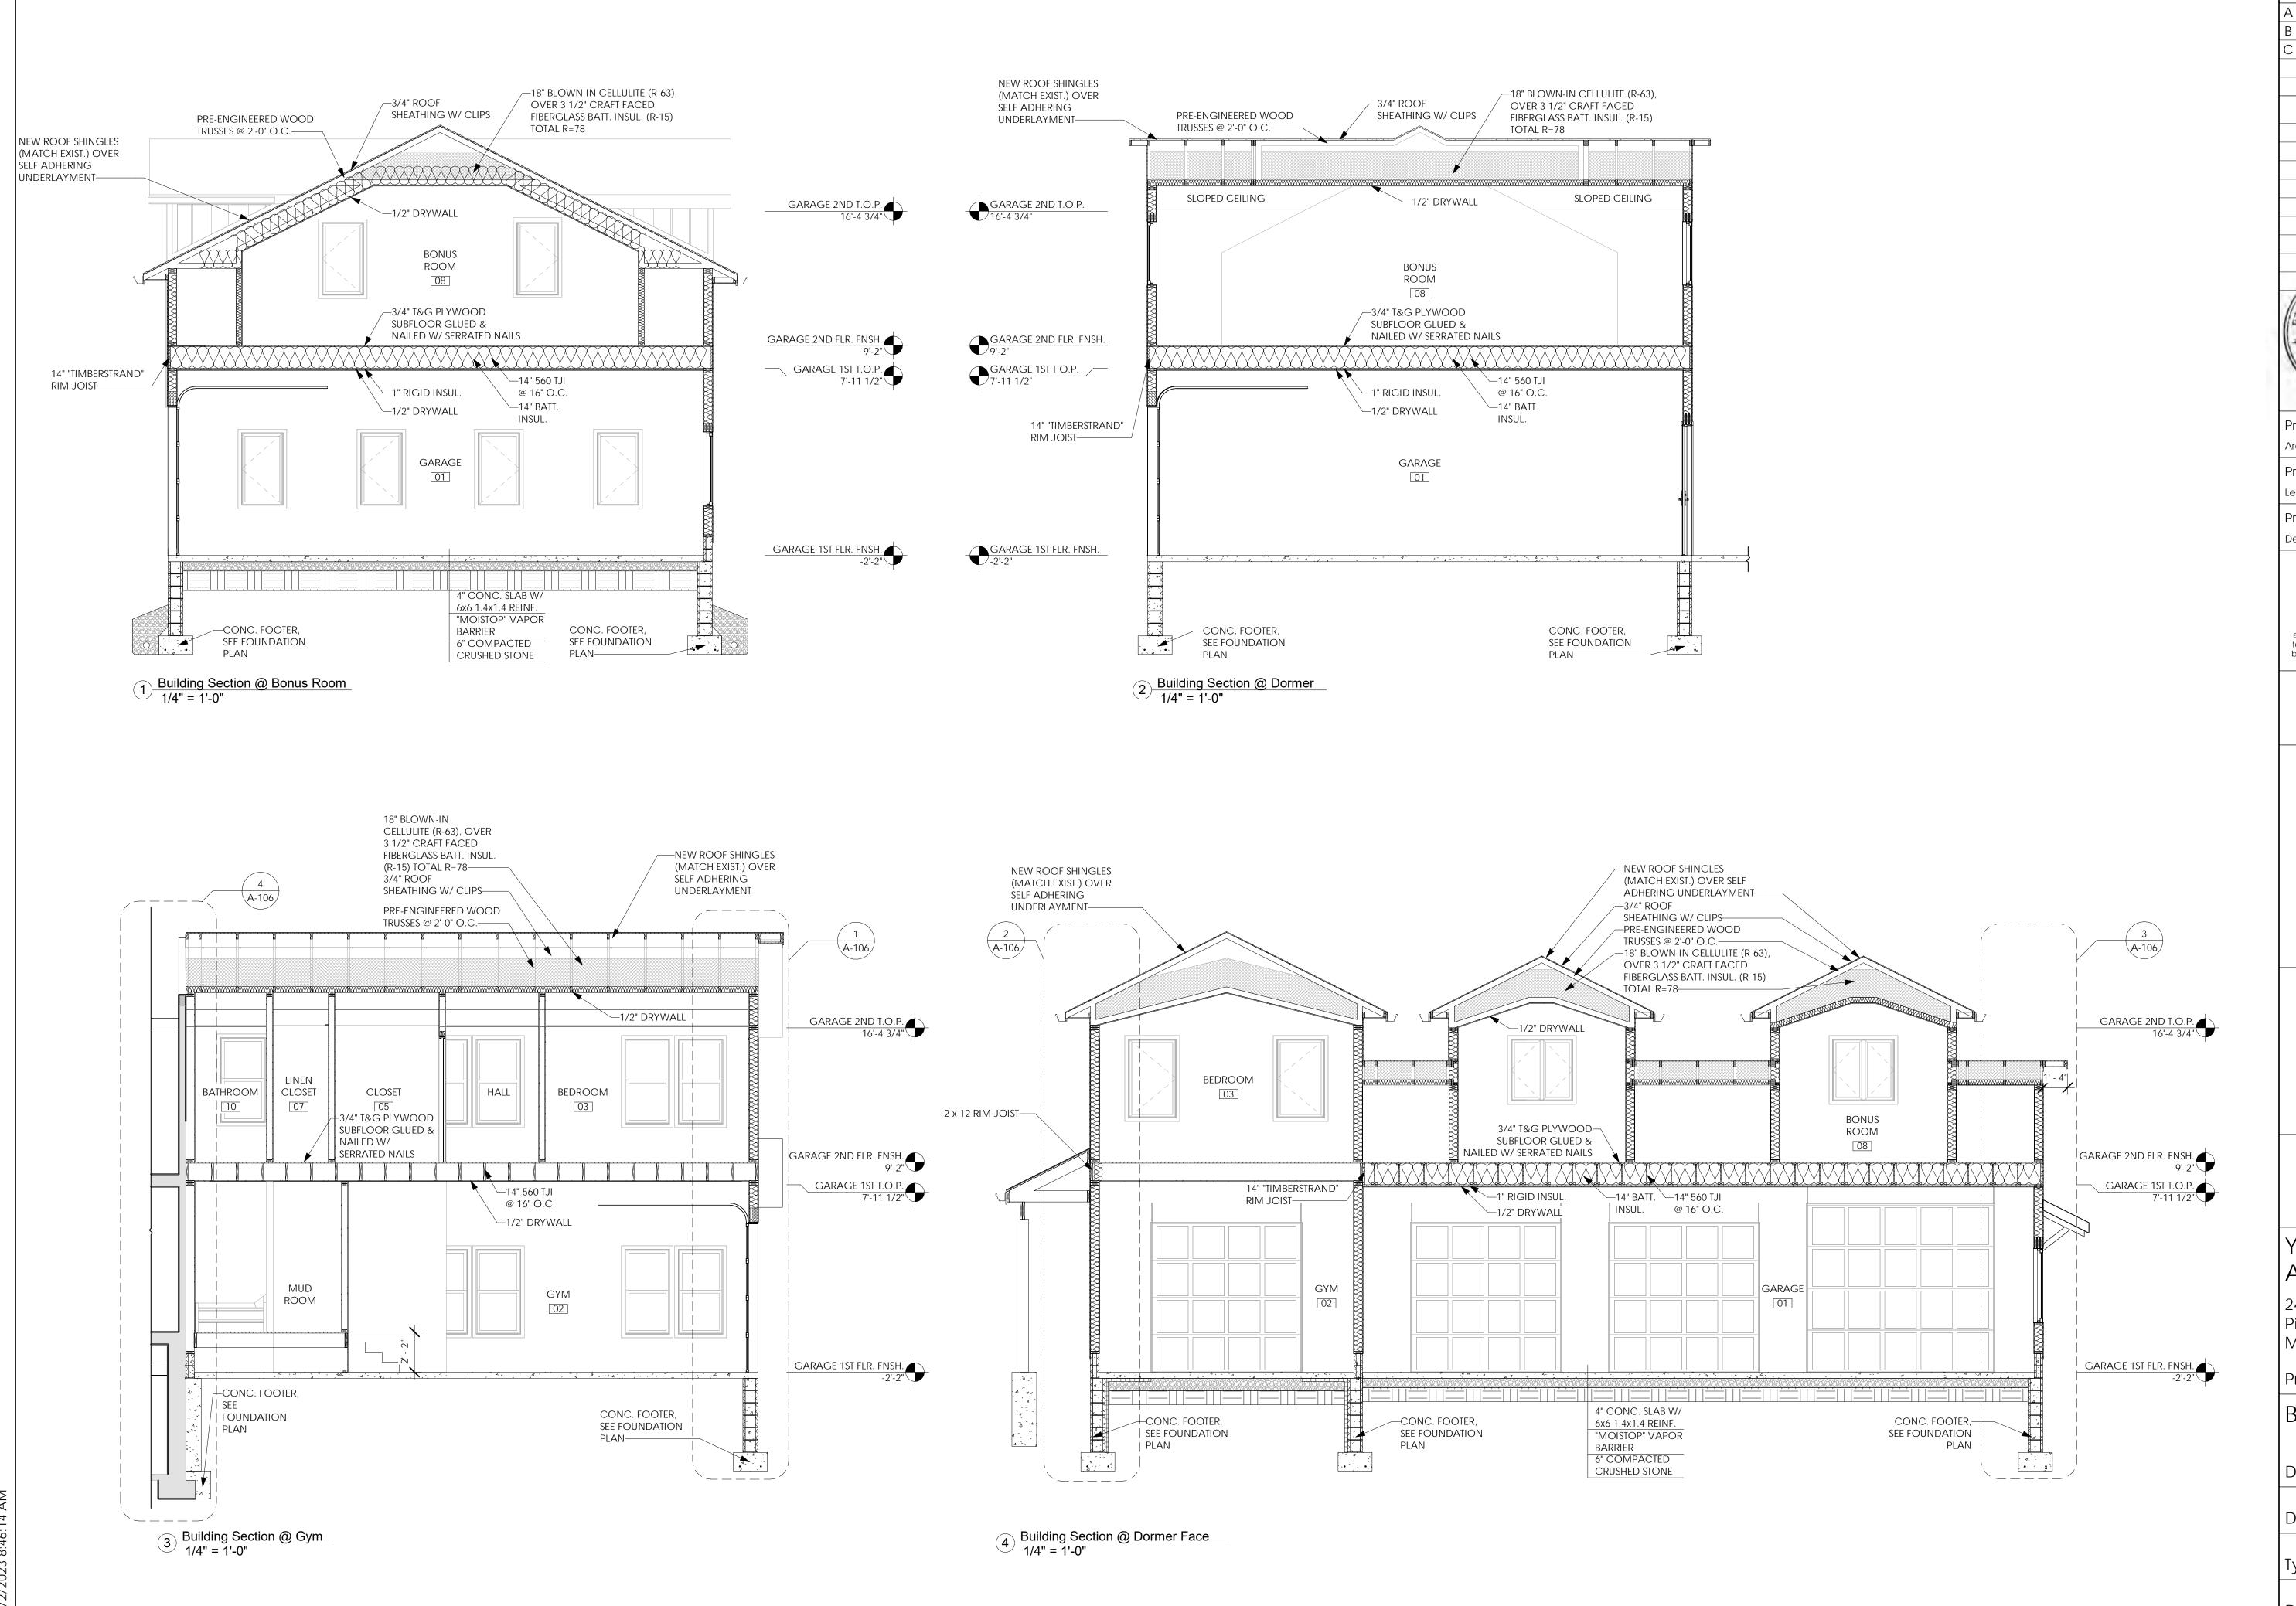
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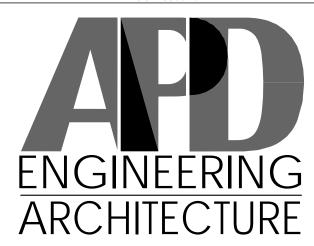






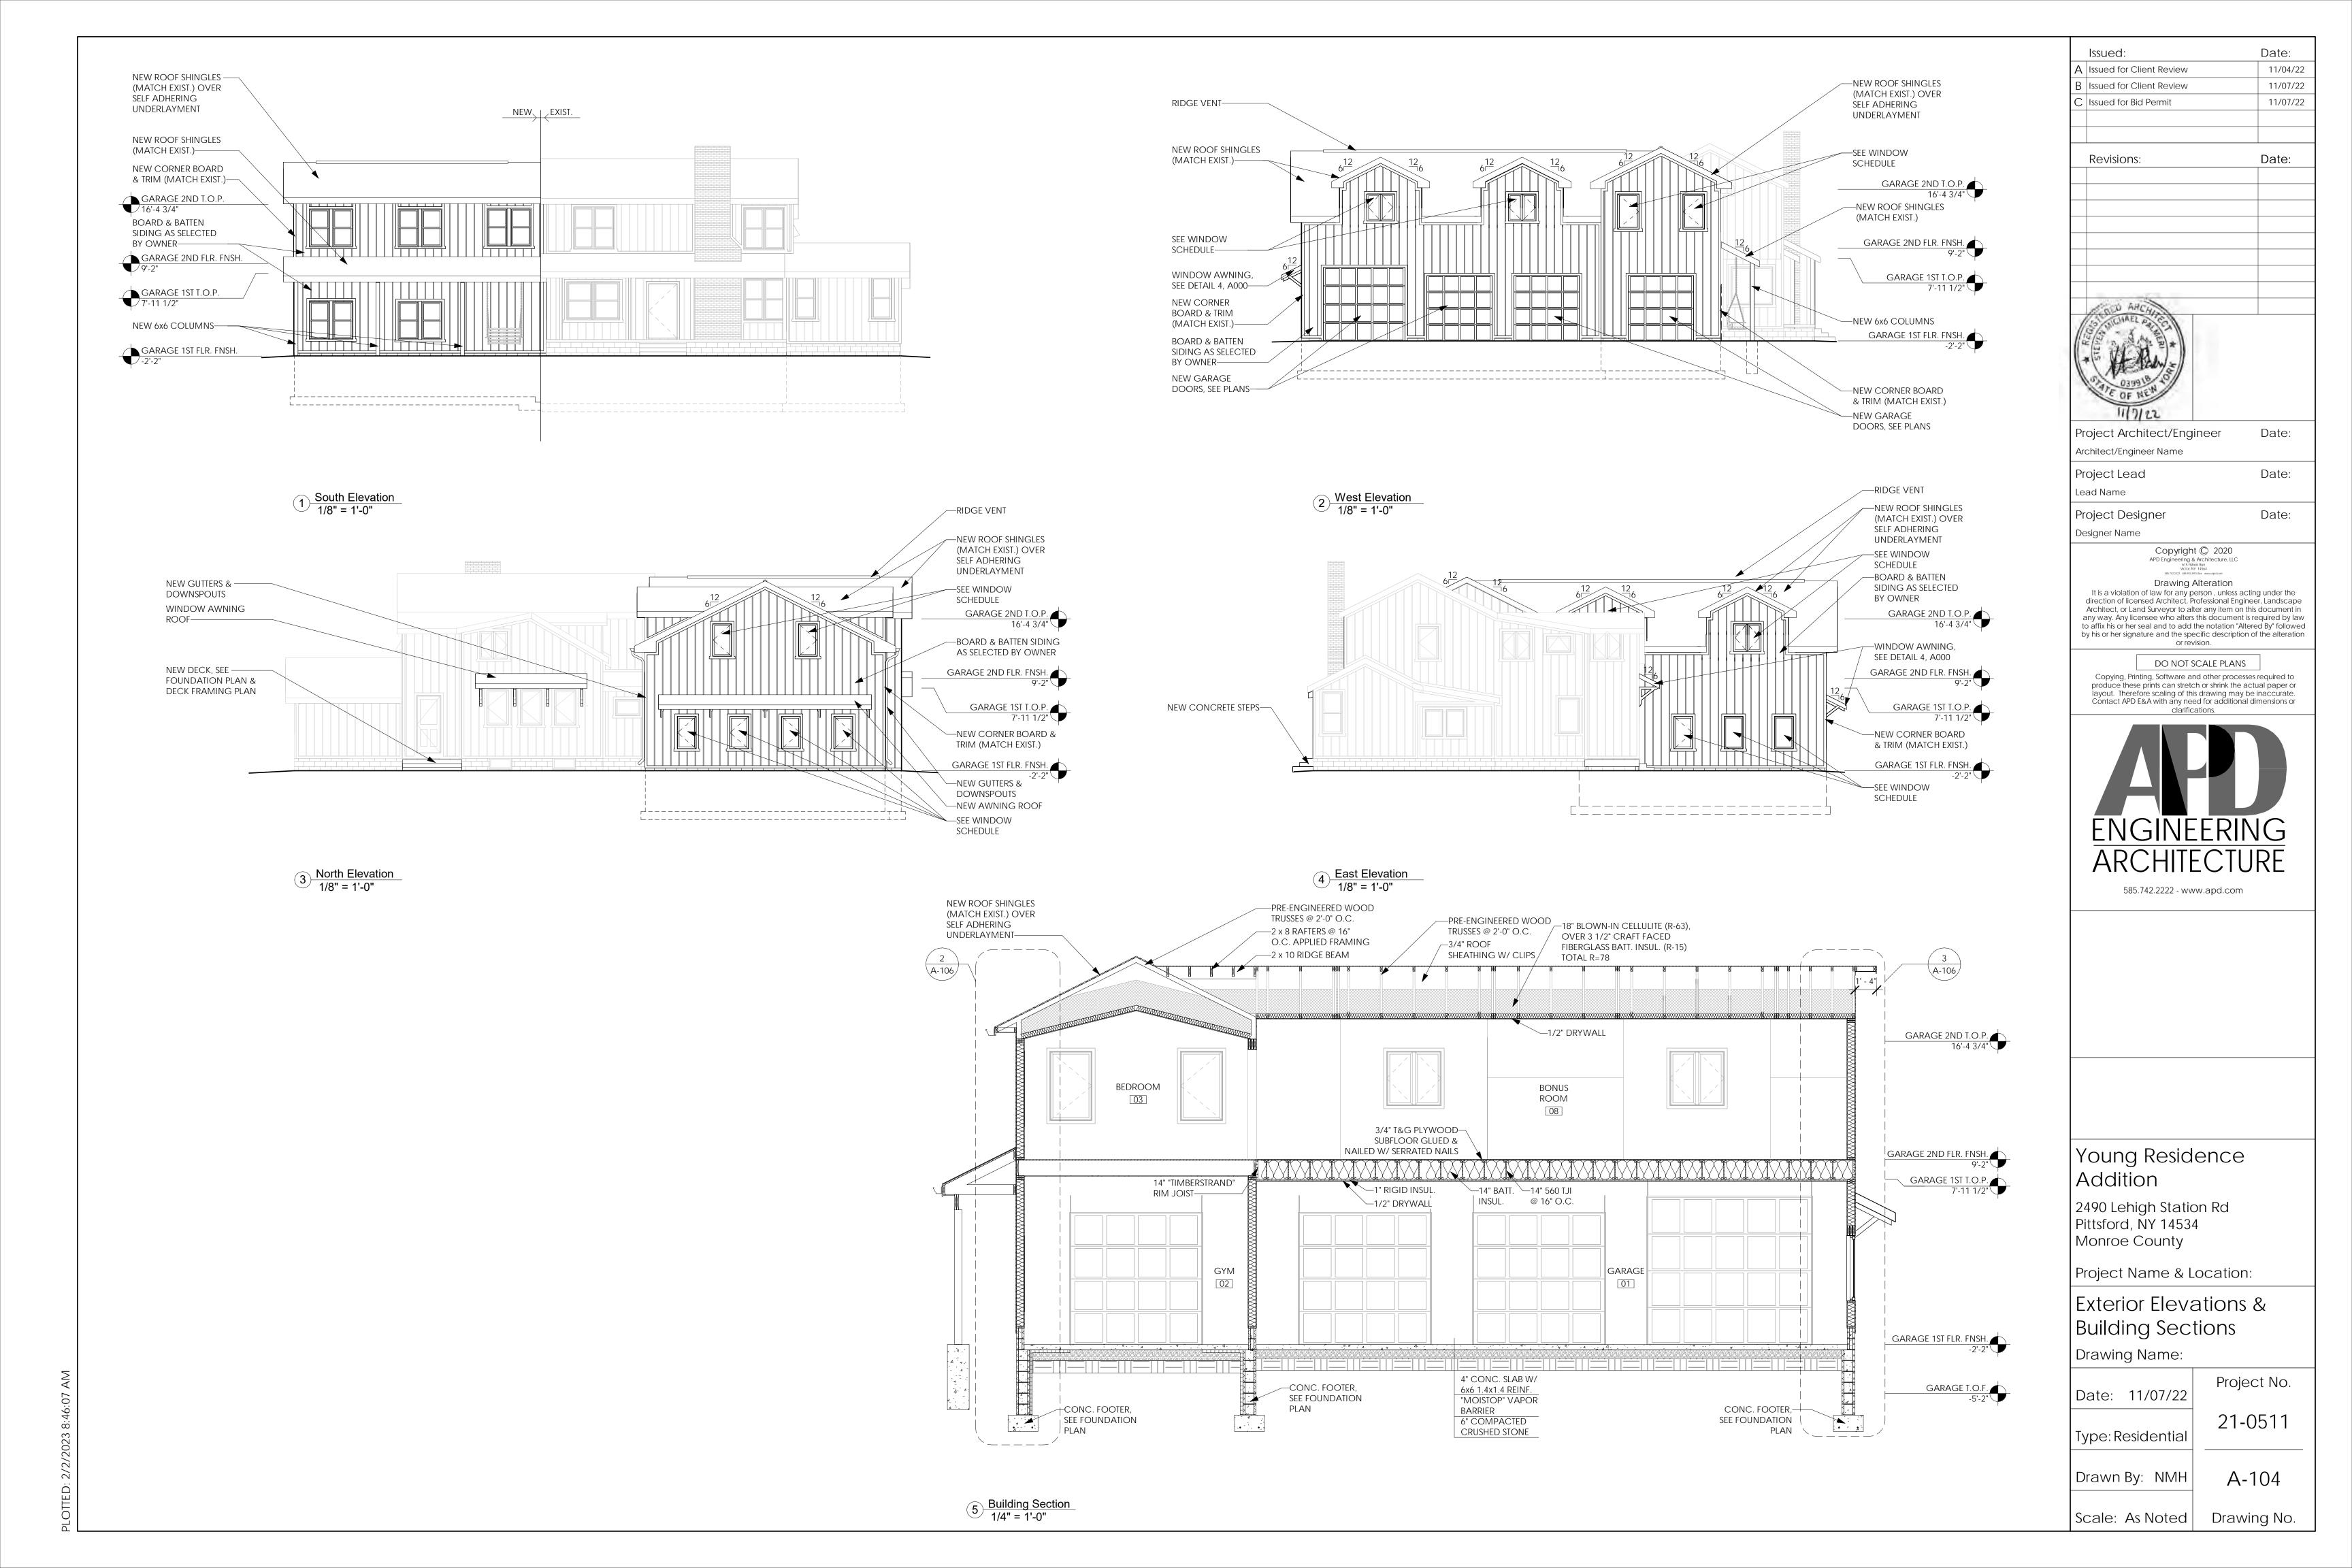

Date: Issued: 11/04/22 A Issued for Client Review 11/07/22 Issued for Client Review Issued for Bid Permit 11/07/22 Date: Revisions: Project Architect/Engineer Date: Architect/Engineer Name Date: Project Lead Lead Name Date: Project Designer Designer Name Copyright © 2020 APD Engineering & Architecture, LLC 615 Rshers Run Victor, NY 14564 5857422222 Seb-9244914 fax www.apd.com Drawing Alteration It is a violation of law for any person , unless acting under the direction of licensed Architect, Professional Engineer, Landscape Architect, or Land Surveyor to alter any item on this document in any way. Any licensee who alters this document is required by law to affix his or her seal and to add the notation "Altered By" followed by his or her signature and the specific description of the alteration or revision. DO NOT SCALE PLANS Copying, Printing, Software and other processes required to produce these prints can stretch or shrink the actual paper or layout. Therefore scaling of this drawing may be inaccurate. Contact APD E&A with any need for additional dimensions or

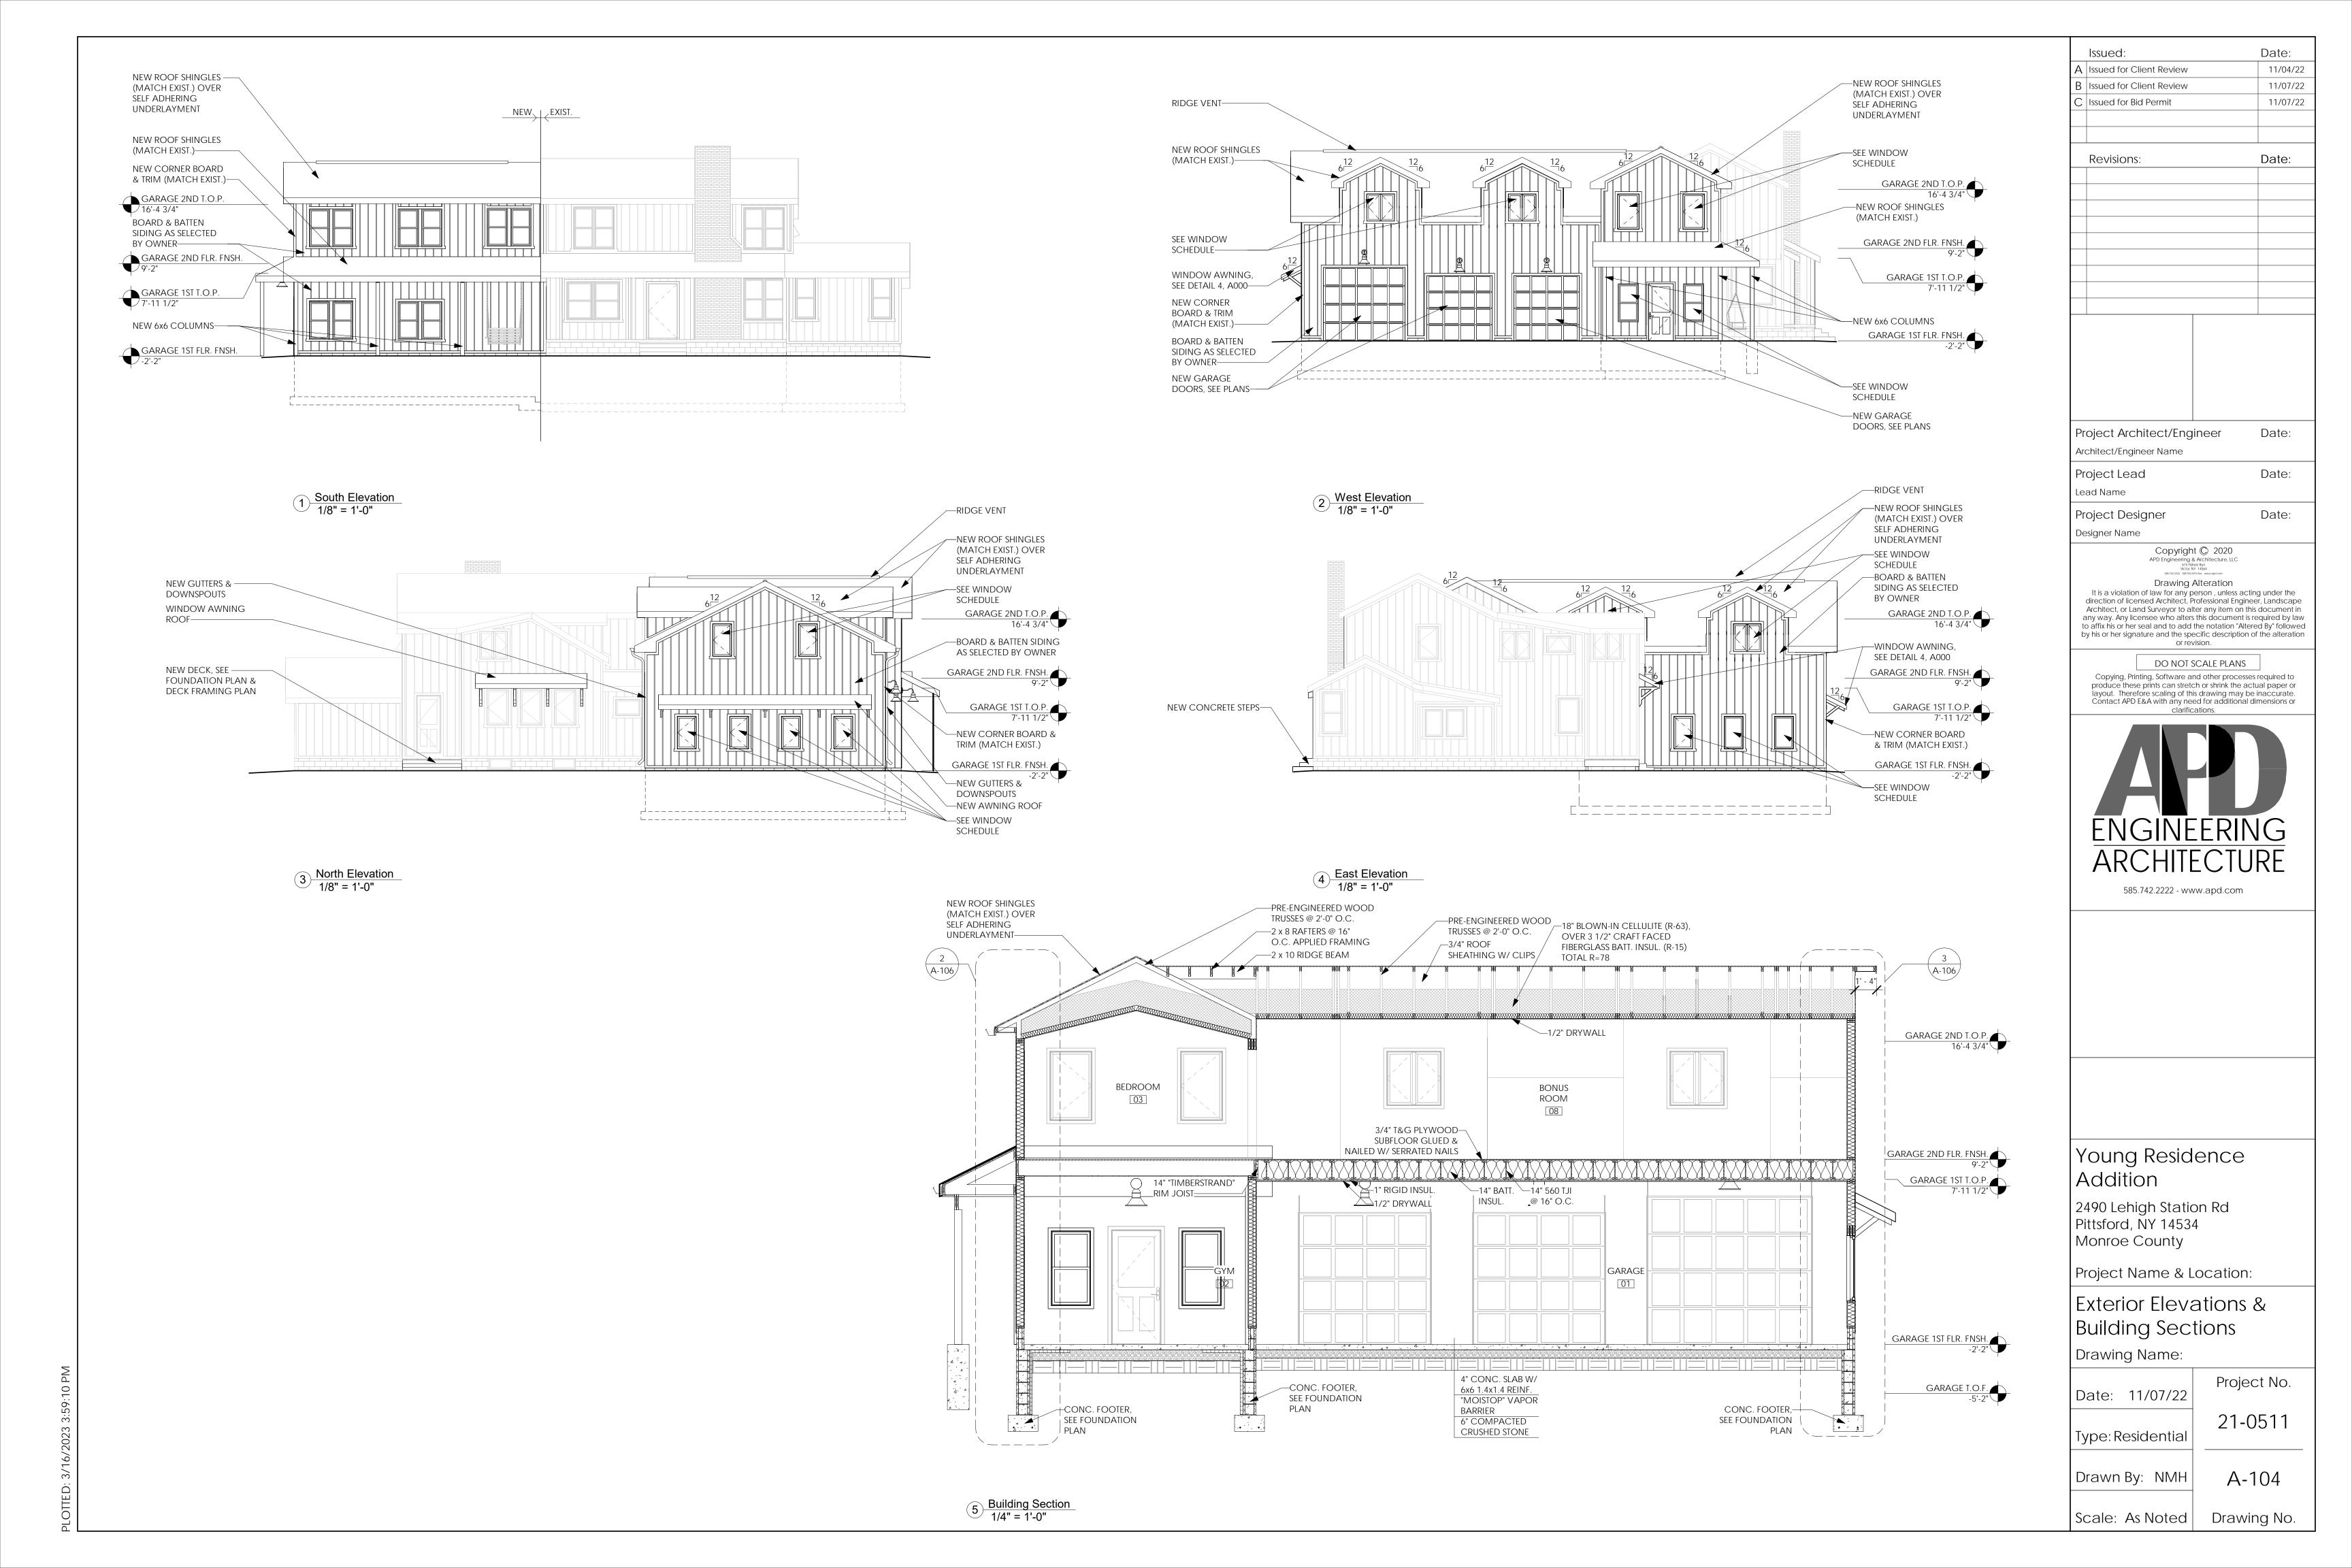

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Young Residence Addition

2490 Lehigh Station Rd Pittsford, NY 14534 Monroe County

Project Name & Location:


Building Sections

Drawing Name: Project No. Date: 11/07/22 21-0511 Type: Residential


Drawn By: NMH A-105

Scale: As Noted

Drawing No.

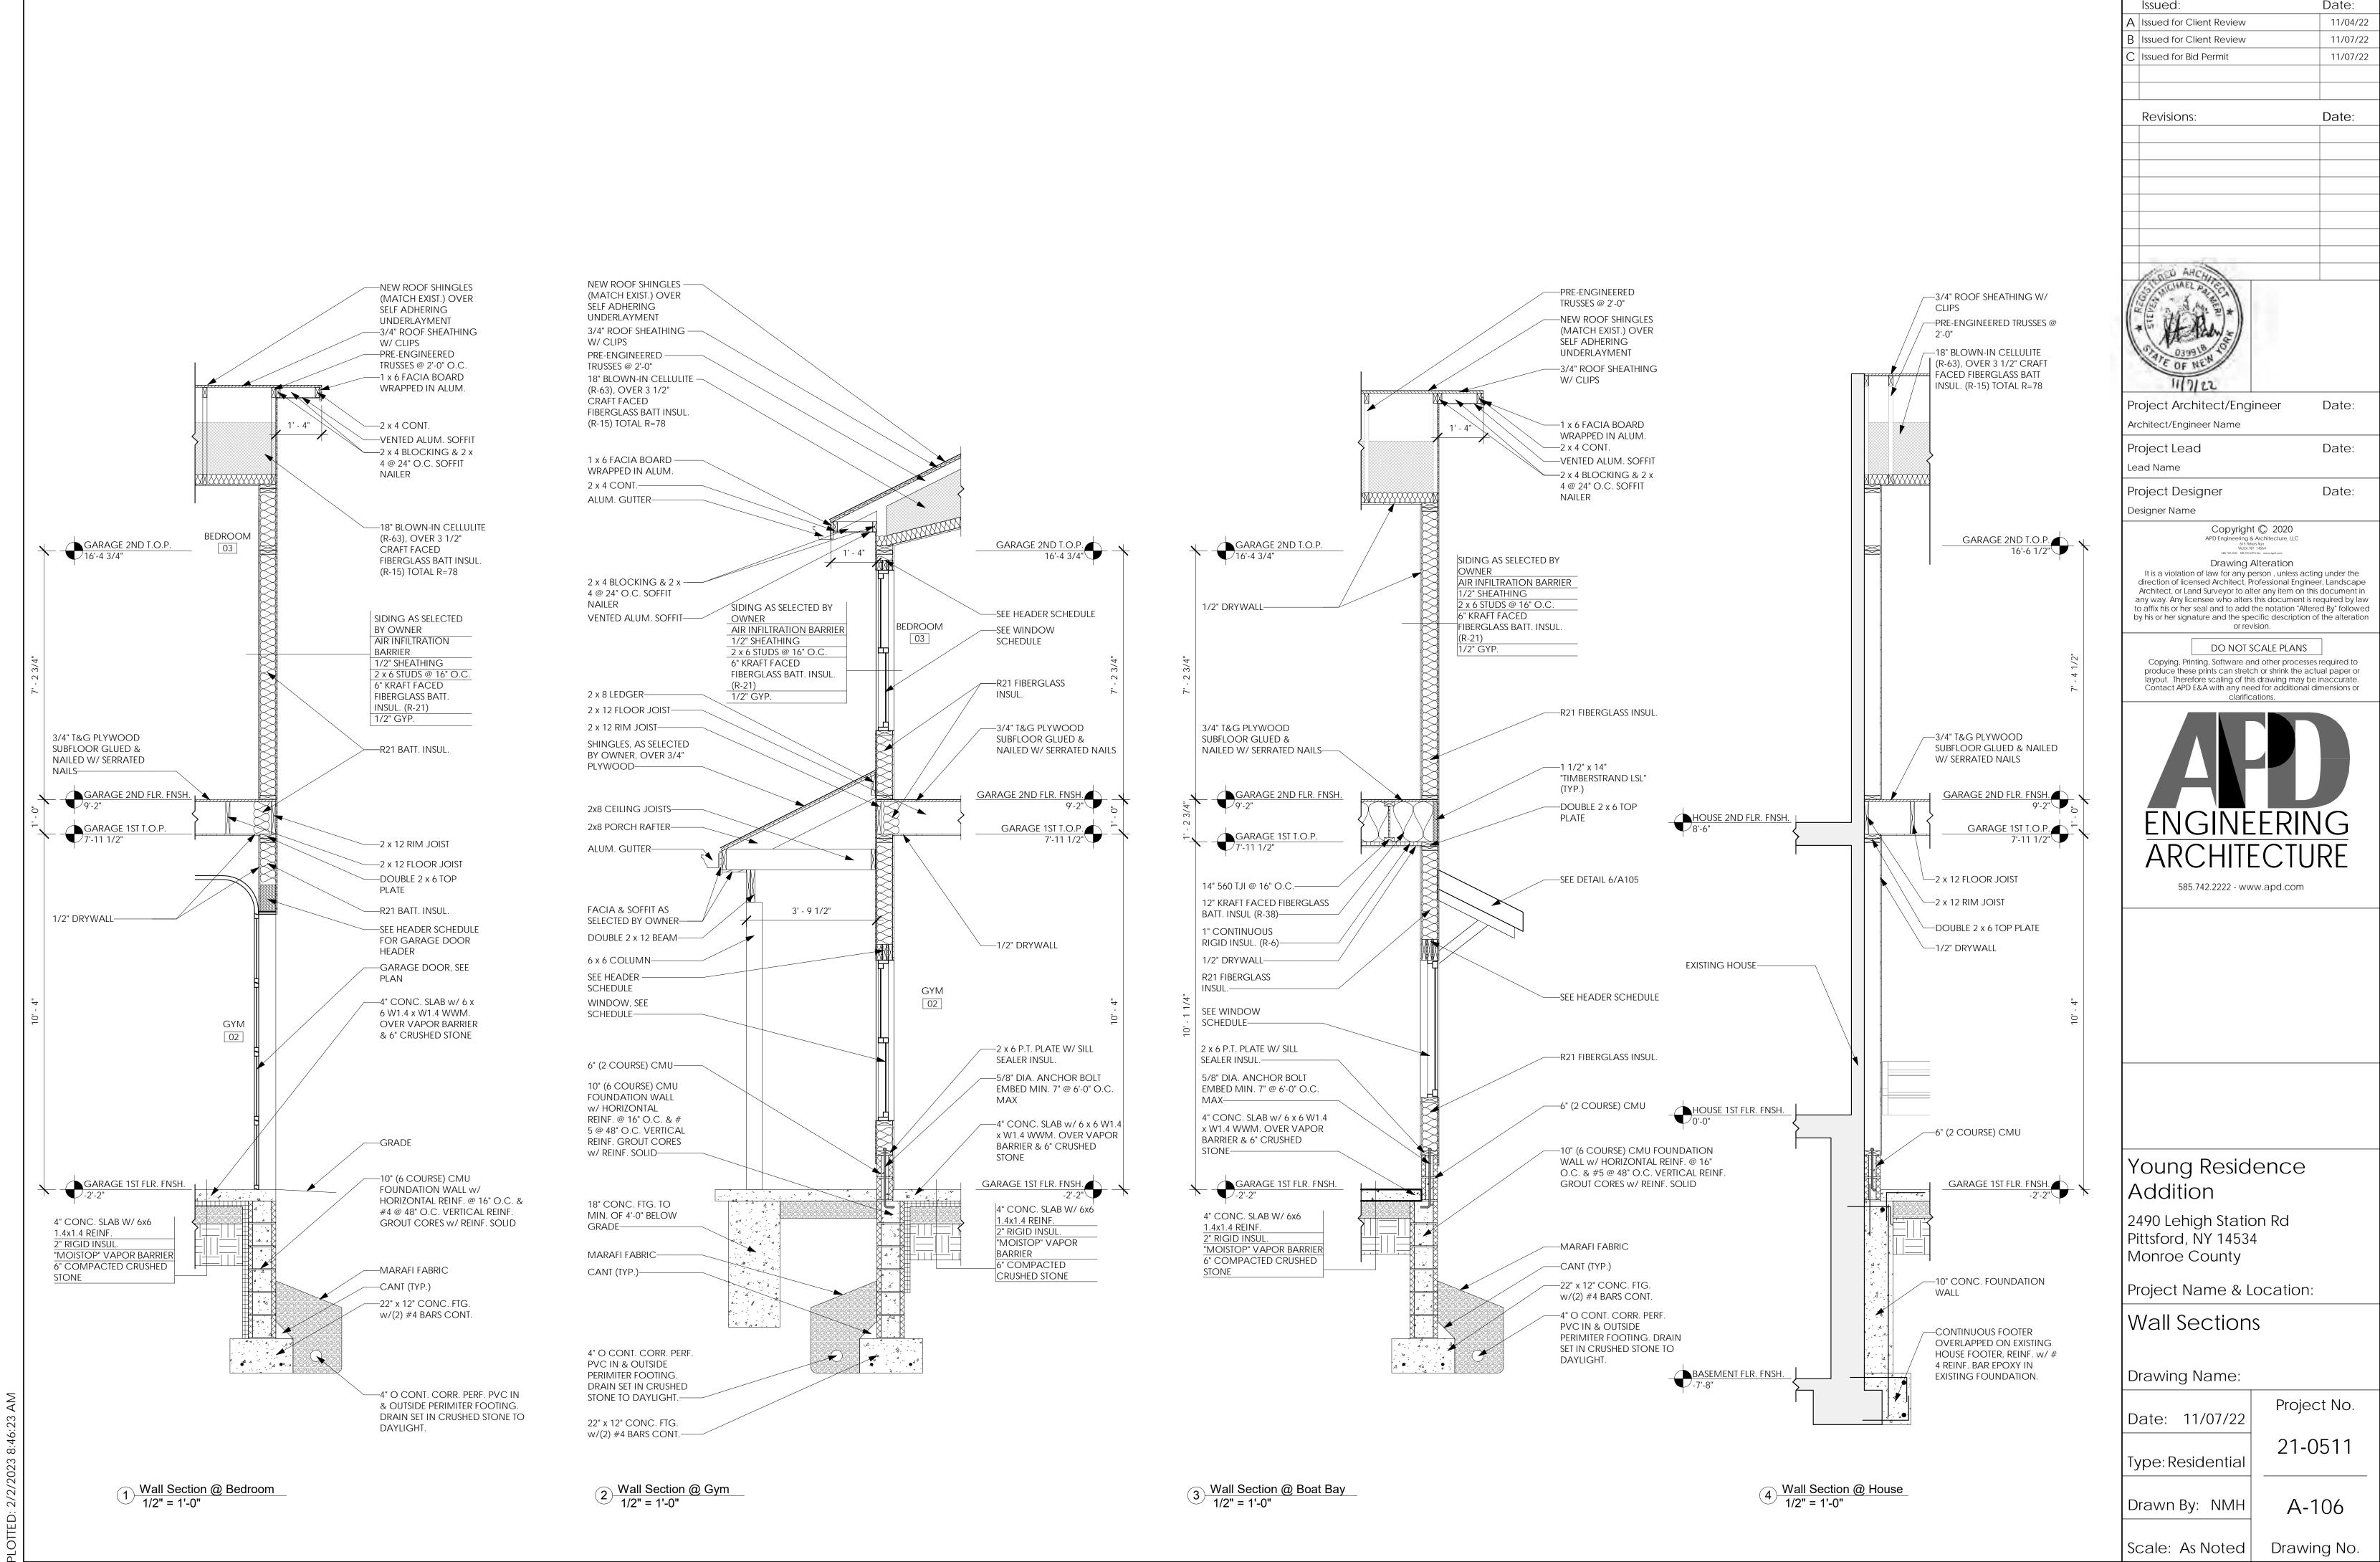

Date:

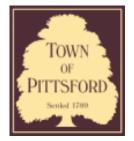

Town of Pittsford

Department of Public Works 11 South Main Street Pittsford, New York 14534

Permit # D23-00001

Phone: 585-248-6250 FAX: 585-248-6262

DESIGN REVIEW AND HISTORIC PRESERVATION BOARD REFERRAL OF APPLICATION

Property Address: 114 Sunset Boulevard PITTSFORD, NY 14534

Tax ID Number: 164.10-4-23

Zoning District: RN Residential Neighborhood

Owner: Sarajlic, Vedrana Applicant: Sarajlic, Vedrana


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~	Residential Design Review	Build to Line Adjustment
	§185-205 (B)	§185-17 (B) (2)
	Commercial Design Review	Building Height Above 30 Feet
	§185-205 (B)	§185-17 (M)
	Signage	Corner Lot Orientation
	§185-205 (C)	§185-17 (K) (3)
	Certificate of Appropriateness	Flag Lot Building Line Location
	§185-197	§185-17 (L) (1) (c)
	Landmark Designation	Undeveloped Flag Lot Requirements
	§185-195 (2)	§185-17 (L) (2)
	Informal Review	

Project Description: In accordance with Chapter 64 Article VIII, §64-43 of the Pittsford Town Code, the owner of 114 Sunset Boulevard is requesting approval from the Design Review and Historic Preservation Board to demolish the existing 1,872 square foot home at 114 Sunset Boulevard and rebuild a new 3,180 +/- square foot single family home on the property. Tax Parcel No. 164.10-4-23. This property is Zoned Residential Neighborhood (RN).

Meeting Date: March 09, 2023

RN Residential Neighborhood Zoning

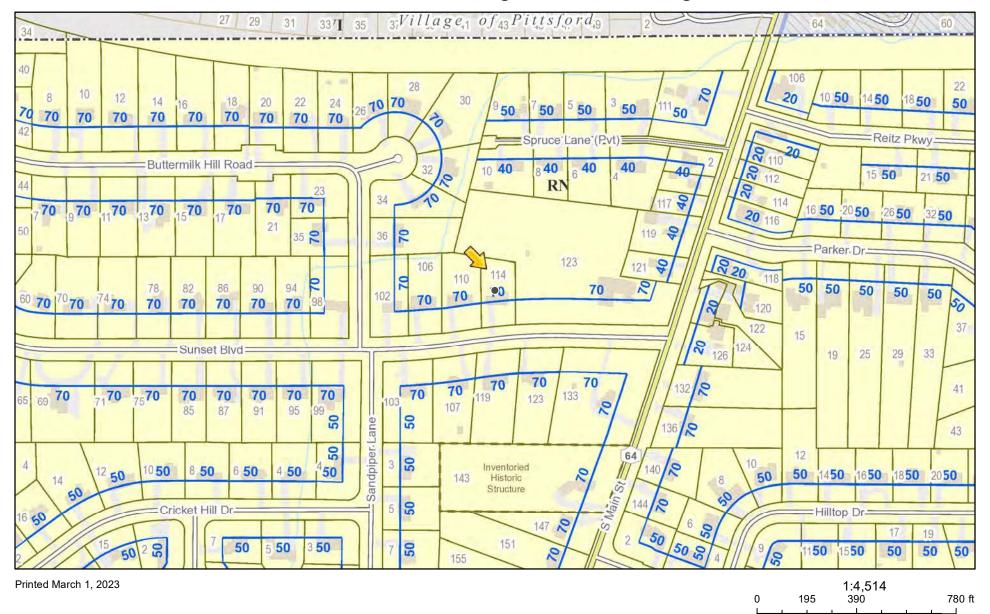


Town of Pittsford GIS

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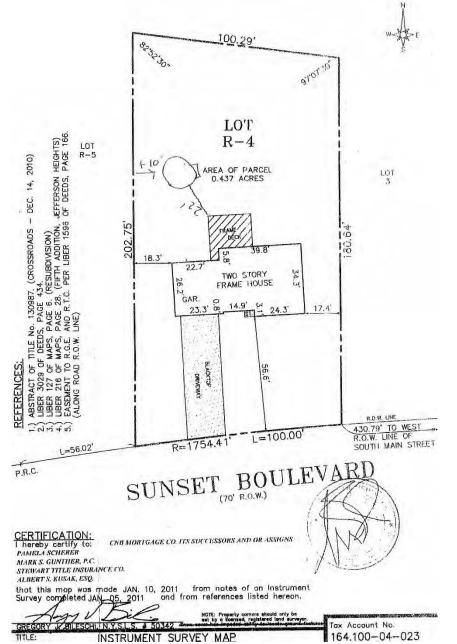
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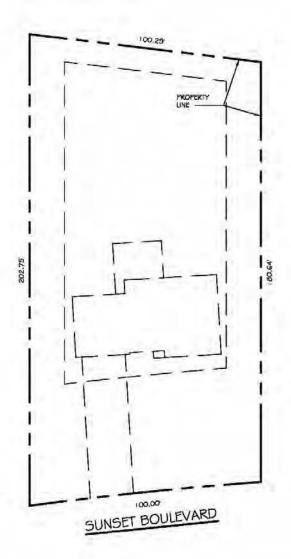







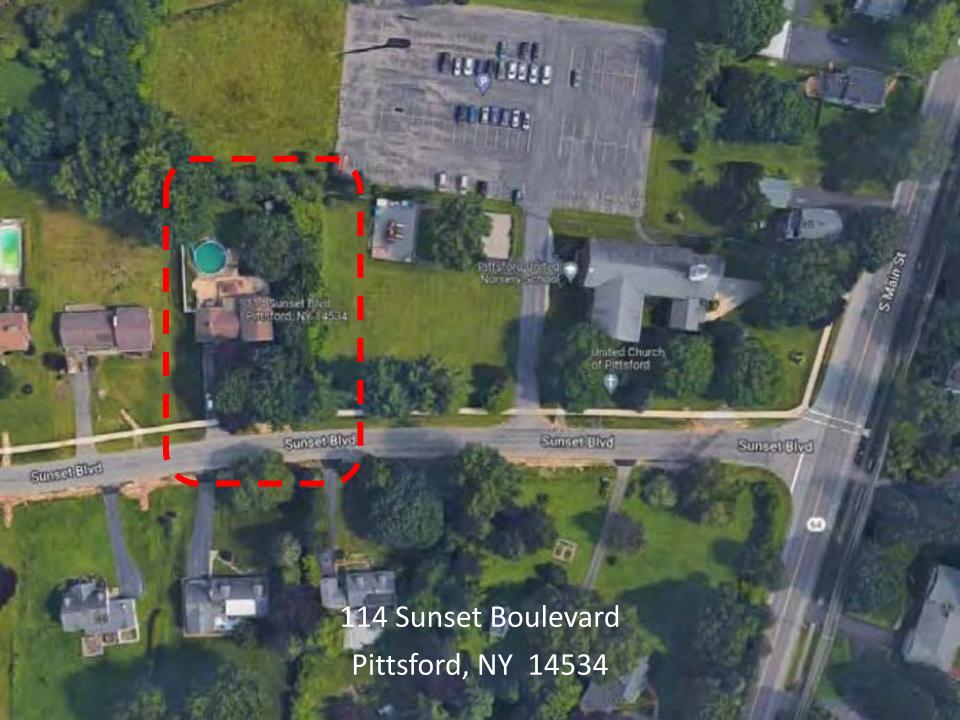






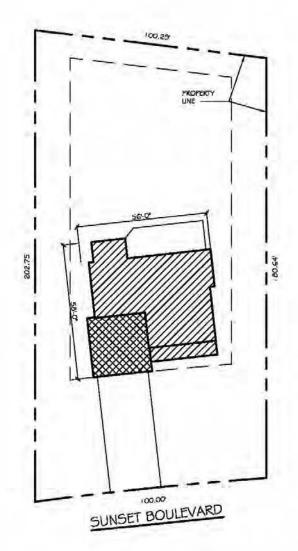




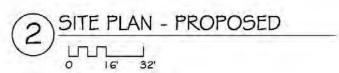






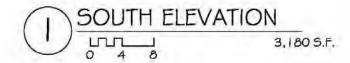






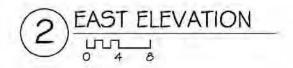






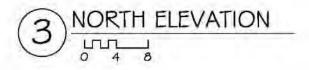






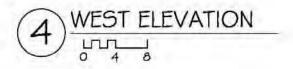




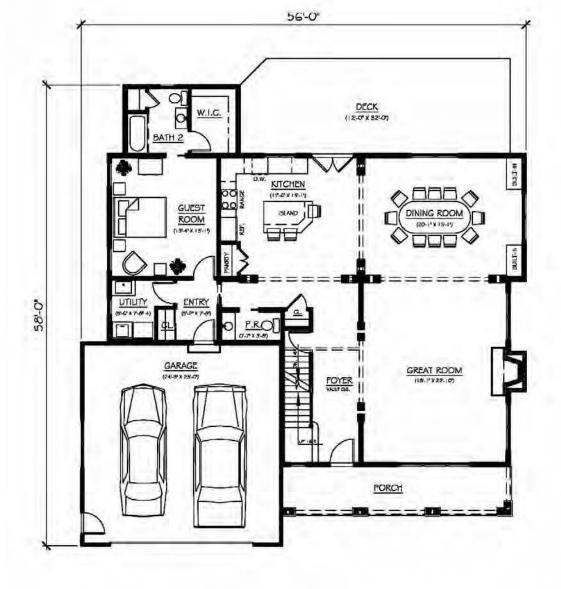







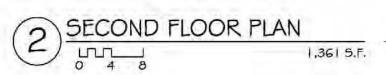










DEAN



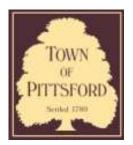

Town of Pittsford

Department of Public Works 11 South Main Street Pittsford, New York 14534

Permit # C22-000062

Phone: 585-248-6250 FAX: 585-248-6262

DESIGN REVIEW AND HISTORIC PRESERVATION BOARD REFERRAL OF APPLICATION

Property Address: 3349 Monroe Avenue ROCHESTER, NY 14618

Tax ID Number: 150.12-1-18

Zoning District: C Commercial / MATZ Monroe Avenue Transitional Zone

Owner: Pittsford Plaza SPE, LLC Applicant: Pittsford Plaza SPE, LLC

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	Residential Design Review	Build to Line Adjustment
	§185-205 (B) Commercial Design Review §185-205 (B)	§185-17 (B) (2) Building Height Above 30 Feet §185-17 (M)
✓	Signage §185-205 (C)	Corner Lot Orientation §185-17 (K) (3)
	Certificate of Áppropriateness §185-197	Flag Lot Building Line Location §185-17 (L) (1) (c)
	Landmark Designation §185-195 (2)	Undeveloped Flag Lot Requirements §185-17 (L) (2)
	Informal Review	

Project Description: Applicant has requested design review to change the color on the front of the Paper Store.

Meeting Date: March 23, 2023







