Design Review & Historic Preservation Board Agenda March 9, 2023

HISTORIC PRESERVATION DISCUSSION

BUILDING INSPECTOR REMARKS

RESIDENTIAL APPLICATION FOR REVIEW

2490 Lehigh Station Road

The Applicant is requesting design review for the addition of a 100 SF front entry porch.

2490 Lehigh Station Road

The Applicant is requesting design review for an addition of a 2650 sf garage addition off the side of the existing house.

32 Rosewood Drive

The Applicant is requesting design review for the construction of a covered porch off the front of the house.

91 Caversham Woods

The Applicant is requesting design review for the construction of approximately a 520 SF addition off the rear of the house.

• 56 and 58 Skylight Trail

The Applicant is requesting design review for the proposed construction of a new town home dwelling. The proposed building will consist of 2 attached single family dwellings sharing a common wall. 56 Skylight Trail will be approximately 1884 sq. ft. and 58 Skylight Trail will be 2023 sq. ft. The town homes will be located in the new Alpine Ridge development.

DEMOLITION OF STRUCTURE AND CONSTRUCTION OF NEW RESIDENCE

114 Sunset Boulevard

In accordance with Chapter 64 Article VIII, §64-43 of the Pittsford Town Code, the owner of 114 Sunset Boulevard is requesting approval from the Design Review and Historic Preservation Board to demolish the existing 1,872 square foot home at 114 Sunset Boulevard and rebuild a new 3,180 +/- square foot single family home on the property. Tax Parcel No. 164.10-4-23. This property is Zoned Residential Neighborhood (RN).

Design Review and Historic Preservation Board Minutes February 23, 2023

PRESENT

David Wigg, Vice Chairman; Paul Whitbeck, John Mitchell, Kathleen Cristman

ALSO PRESENT

Cathy Koshykar, Town Board liaison; Anthony Caruso, Building Inspector; Susan Donnelly, Secretary to the Board

ABSENT

Dirk Schneider, Chairman; Bonnie Salem, Jim Vekasy

HISTORIC PRESERVATION DISCUSSION

There was no historic preservation discussion.

RESIDENTIAL APPLICATION FOR REVIEW

220 Kilbourn Road

The Applicant is requesting design review for an addition of a 435 SF addition off the back of the house.

Jonathan Spoleta of Spoleta Construction and homeowner Laurence Giangreco were present.

Mr. Spoleta discussed the project of an enclosed porch on the rear of the structure. The finishes will match the existing stucco and the asphalt roofing will match the existing. A crawl space will be underneath.

David Wigg moved to accept the application with the condition that ice and water shield be installed underneath the shingles on the new addition.

Paul Whitbeck seconded.

All Ayes.

7 Grey Fawn

The Applicant is requesting design review for the construction of a 120 SF deck platform and sunroom addition of the back of existing dining room.

Dave Cerrone of Fitch Construction was present. A proposed unheated enclosed porch was discussed. This application will require an area variance for exceeding the allowed impervious coverage. The colors are described as earth tones that will blend with the original color scheme of the home.

Kathleen Cristman moved to accept the application as submitted.

David Wigg seconded.

All Ayes.

108 Stoneleigh Court

The Applicant is requesting design review for the construction of 332 SF mudroom and 691 SF garage addition off the rear of the home.

Patrick Morabito was present to discuss the application with the Board. An area variance has been approved by the Zoning Board of Appeals for a side setback to allow the construction of the garage. The materials will match the existing on the home.

The Board reviewed the project and approved of the proposed construction.

Kathleen Cristman moved to approve the application as submitted.

John Mitchell seconded.

All Ayes.

42 French Road

The Applicant is returning to design review for the demo of an existing single car garage and addition of an approximate 809 SF 2 car garage with mudroom at the rear.

Patrick Morobito discussed this application with the Board.

This application is returning from a previous submission. This addition will now be under 6 ft. forward of the residence. The ridge lines will line up and the siding and roofing will match the existing.

Paul Whitbeck moved to approve the application with the condition that the overhang of the addition will match that of the residence.

Kathleen Cristman seconded.

All Ayes.

5637 Palmyra Road

The Applicant is requesting design review for the construction of an oversized (288 SF) over height (17') accessory structure, shed.

The property owner, James Donsbach, was in attendance. Mr. Donsbach presented the board with a new drawing of the proposed structure. He indicated the exterior would be the same color as the residence on the property. One gable end elevation will feature a hinged double door and both gable ends will feature an upper double hung window which will match windows on the residence. The possibility of shutters was discussed. The foundation materials were recommended to be crushed stone.

John Mitchell moved to accept the application as discussed at the meeting on 2/23/23 with the following conditions:

- 1. The shed will be 12 ft. wide model with a building height of 15 ft.
- 2. The fenestration of one gable end will feature a double door and both gable ends will feature upper double hung windows which will match that of the residence.
- 3. The gutters and roofing will match the existing residence.

- 4. The foundation will be a minimum of 4-6" of compacted crushed stone.
- 5. Only one side elevation will feature windows that will match the residence and a man door, the other will be sided.
- 6. The vertical siding color will match the residence.

David Wigg seconded.

All Ayes.

500 Canfield Road

The Applicant is requesting design review for the construction of a two-story single-family home. The home will have approximately 4459 square feet.

The homeowner, Osiris Georgi was present.

Mr. Georgi described the proposed new home construction as a residence with a 3-car garage located on 5 acres approximately 200 ft. from Canfield Road. He described the proposed materials including varying textures, materials and colors on the front elevation. The front door will be a double door as opposed to the single door depicted on the construction plans presented.

The Board expressed their concerns regarding the following:

- 1. Different proposed colors for the main residence and attached garage.
- 2. Many colors and textures on the front elevation.
- 3. The blank massing on the back of the garage.

The suggestion was made the expanse on the rear elevation should be broken up with transom windows.

Following discussion with the applicant, David Wigg moved to accept the application as submitted with the following conditions:

- 1. The front entry will be a double door as discussed on 2/23/23.
- 2. The shakes in the garage gable and above the front entry will be the same color.
- 3. The shakes will be the same color as the siding.
- 4. White aluminum trim will surround the white garage door.
- 5. The stone will be grey with blue fleck and will return 3 ft. to the side at the water table.
- 6. Support brackets will be installed under the fireplace.
- 7. Roofing will be gray architectural shingles with plum-colored flecks.
- 8. The man door on the rear elevation will be centered underneath the upper gable window on the back wall of the garage.

Paul Whitbeck seconded.

All Ayes.

COMMERICAL APPLICATION FOR REVIEW

3690 East Avenue – Dugan Training Facility

The Applicant is requesting design review for the construction of an approximately

6900 SF practice facility next to the existing baseball field.

George Stooks of St. John Fisher University and Steve Fernaays of SWBR Architecture were Present.

This structure will be an indoor practice facility located along the first base dugout field. The structure will feature the beige/brown brick reflected in other architecture on the campus. A row of clear windows will be featured. The pitch of the building will be 25 ft. at its highest and slope to a height of 16 ft. Material samples were presented to the Board for examination.

David Wigg moved to approve the application as submitted with the materials that were submitted to the Board on 2/23/23.

John Mitchell seconded.

All Ayes.

REVIEW OF MINUTES OF JANUARY 26, 2023 MEETING

David Wigg moved to accept the minutes of the January 26, 2023, meeting as written.

Kathleen Cristman seconded.

All Ayes.


ADJOURNMENT

David Wigg moved to close the meeting at 8:00 pm.

All Ayes.

Respectfully submitted,

Susan Donnelly Secretary to the Design Review and Historic Preservation Board

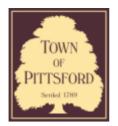

Town of Pittsford

Department of Public Works 11 South Main Street Pittsford, New York 14534

Permit # B23-000007

Phone: 585-248-6250 FAX: 585-248-6262

DESIGN REVIEW AND HISTORIC PRESERVATION BOARD REFERRAL OF APPLICATION

Property	Address: 2490 Lehigh Station Road	PITTSFORD, NY 14534	
	477 04 0 0 4		

Tax ID Number: 177.01-2-8.1

Zoning District: RN Residential Neighborhood

Owner: Morgan, Marcella Juanice

Applicant: Kody Young


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• •	Desidential Design Design	D!! -! 4 - 1 ! A -!! 4 4
✓	Residential Design Review §185-205 (B)	Build to Line Adjustment §185-17 (B) (2)
	• ,	
	Commercial Design Review	Building Height Above 30 Feet
	§185-205 (B)	§185-17 (M)
	Signage	Corner Lot Orientation
	§185-205 (C)	§185-17 (K) (3)
	Certificate of Appropriateness	Flag Lot Building Line Location
	§185-197	§185-17 (L) (1) (c)
	Landmark Designation	Undeveloped Flag Lot Requirements
	§185-195 (2)	§185-17 (L) (2)
	Informal Review	

Project Description: The applicant is requesting design review for the addition of a 100 SF front entry porch

Meeting Date: March 09, 2023



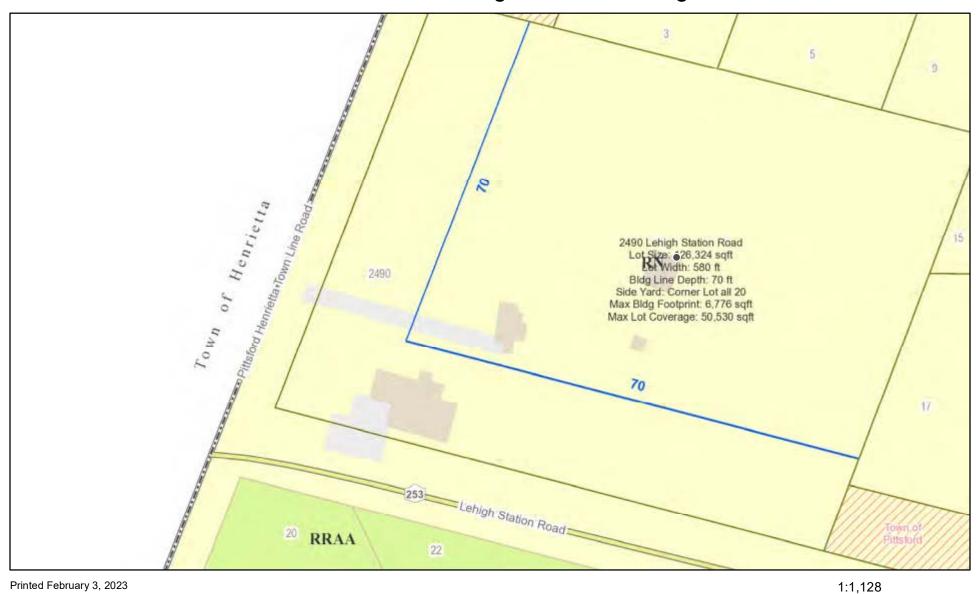

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Town of Pittsford GIS

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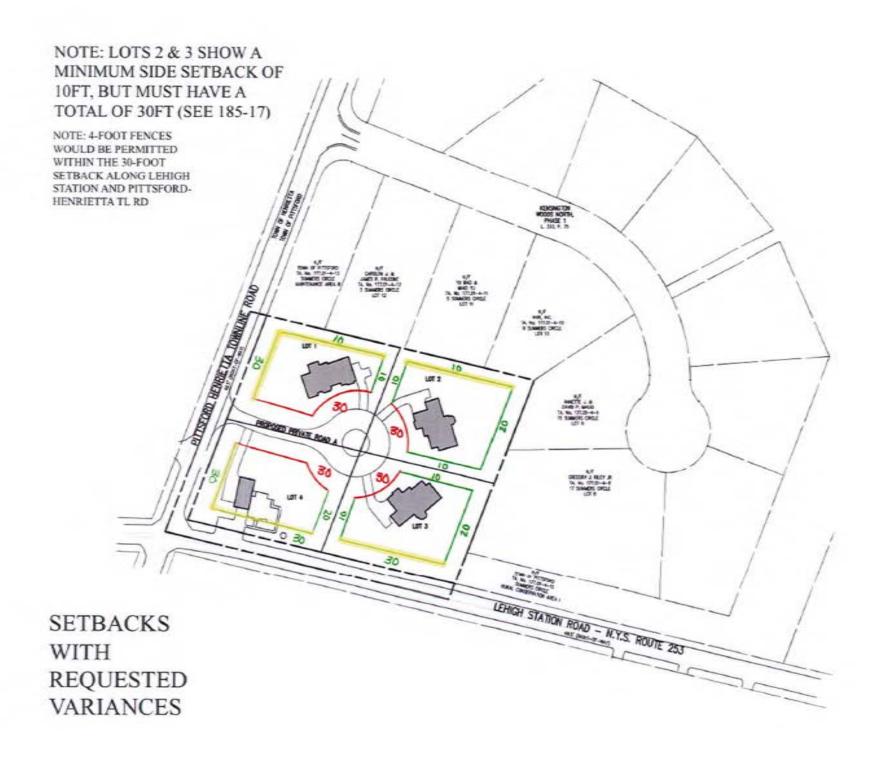
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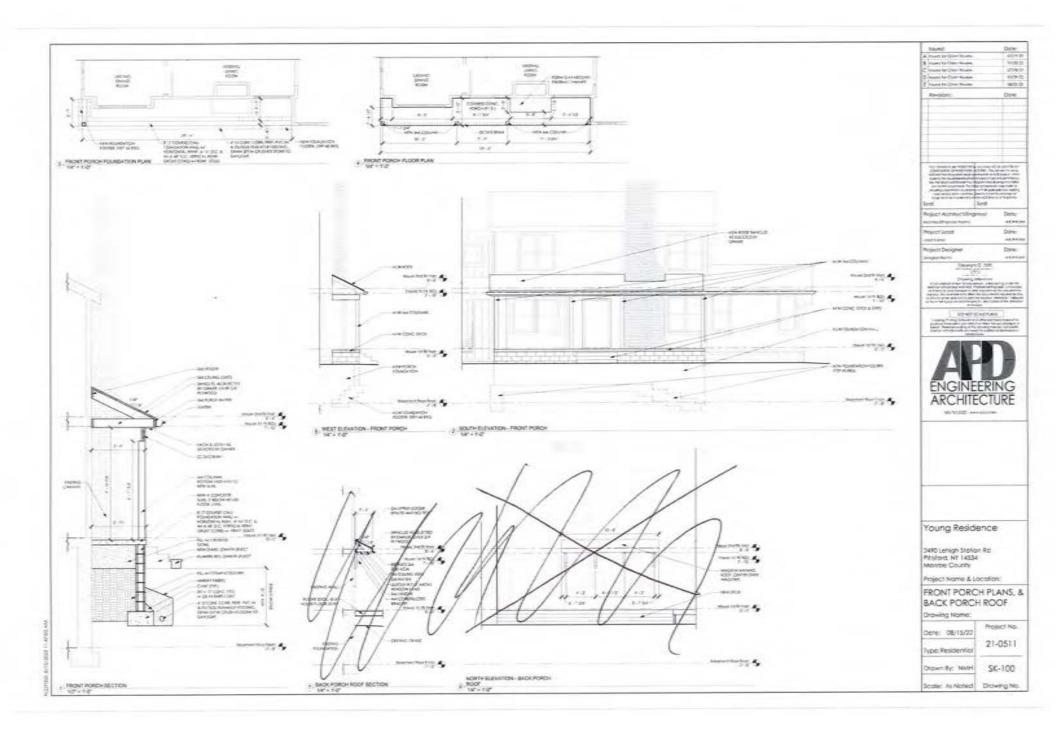
180 ft


50 m









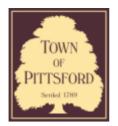

Town of Pittsford

Department of Public Works 11 South Main Street Pittsford, New York 14534

Permit # B23-000008

Phone: 585-248-6250 FAX: 585-248-6262

DESIGN REVIEW AND HISTORIC PRESERVATION BOARD REFERRAL OF APPLICATION

Property	Address: 2490 Lehigh Station Road	PITTSFORD, NY 14534
	477 04 0 0 4	

Tax ID Number: 177.01-2-8.1

Zoning District: RN Residential Neighborhood

Owner: Morgan, Marcella Juanice

Applicant: Kody Young


Application	Type:
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	Residential Design Review	Build to Line Adjustment
\checkmark	§185-205 (B)	§185-17 (B) (2)
	Commercial Design Review	Building Height Above 30 Feet
	§185-205 (B)	§185-17 (M)
	Signage	Corner Lot Orientation
	§185-205 (C)	§185-17 (K) (3)
	Certificate of Appropriateness	Flag Lot Building Line Location
	§185-197	§185-17 (L) (1) (c)
	Landmark Designation	Undeveloped Flag Lot Requirements
	§185-195 (2)	§185-17 (L) (2)
	Informal Review	

Project Description: The applicant is requesting design review for an addition of a 2650 sf garage addition off the side of the existing house.

Meeting Date: March 09, 2023



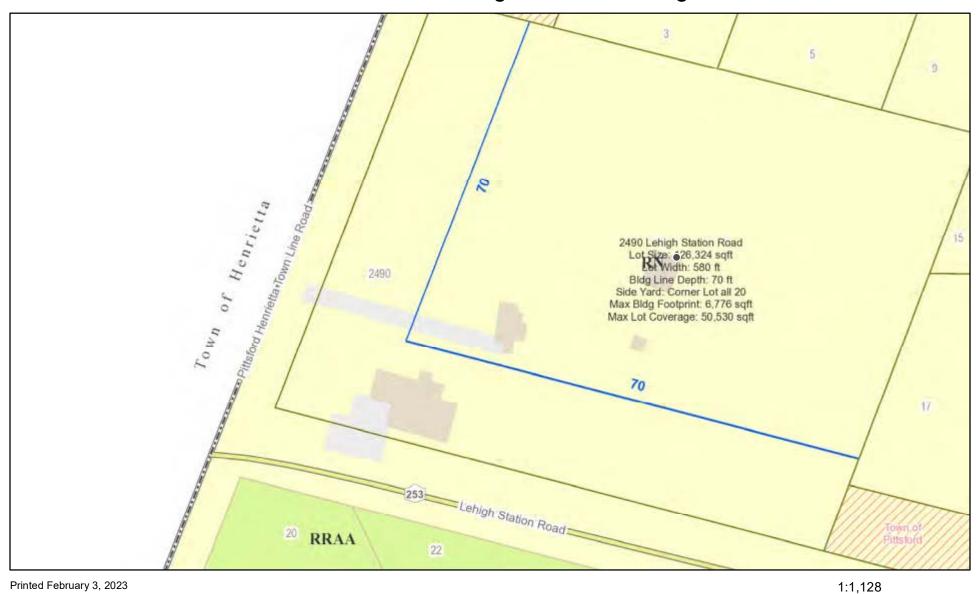

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Town of Pittsford GIS

12.5


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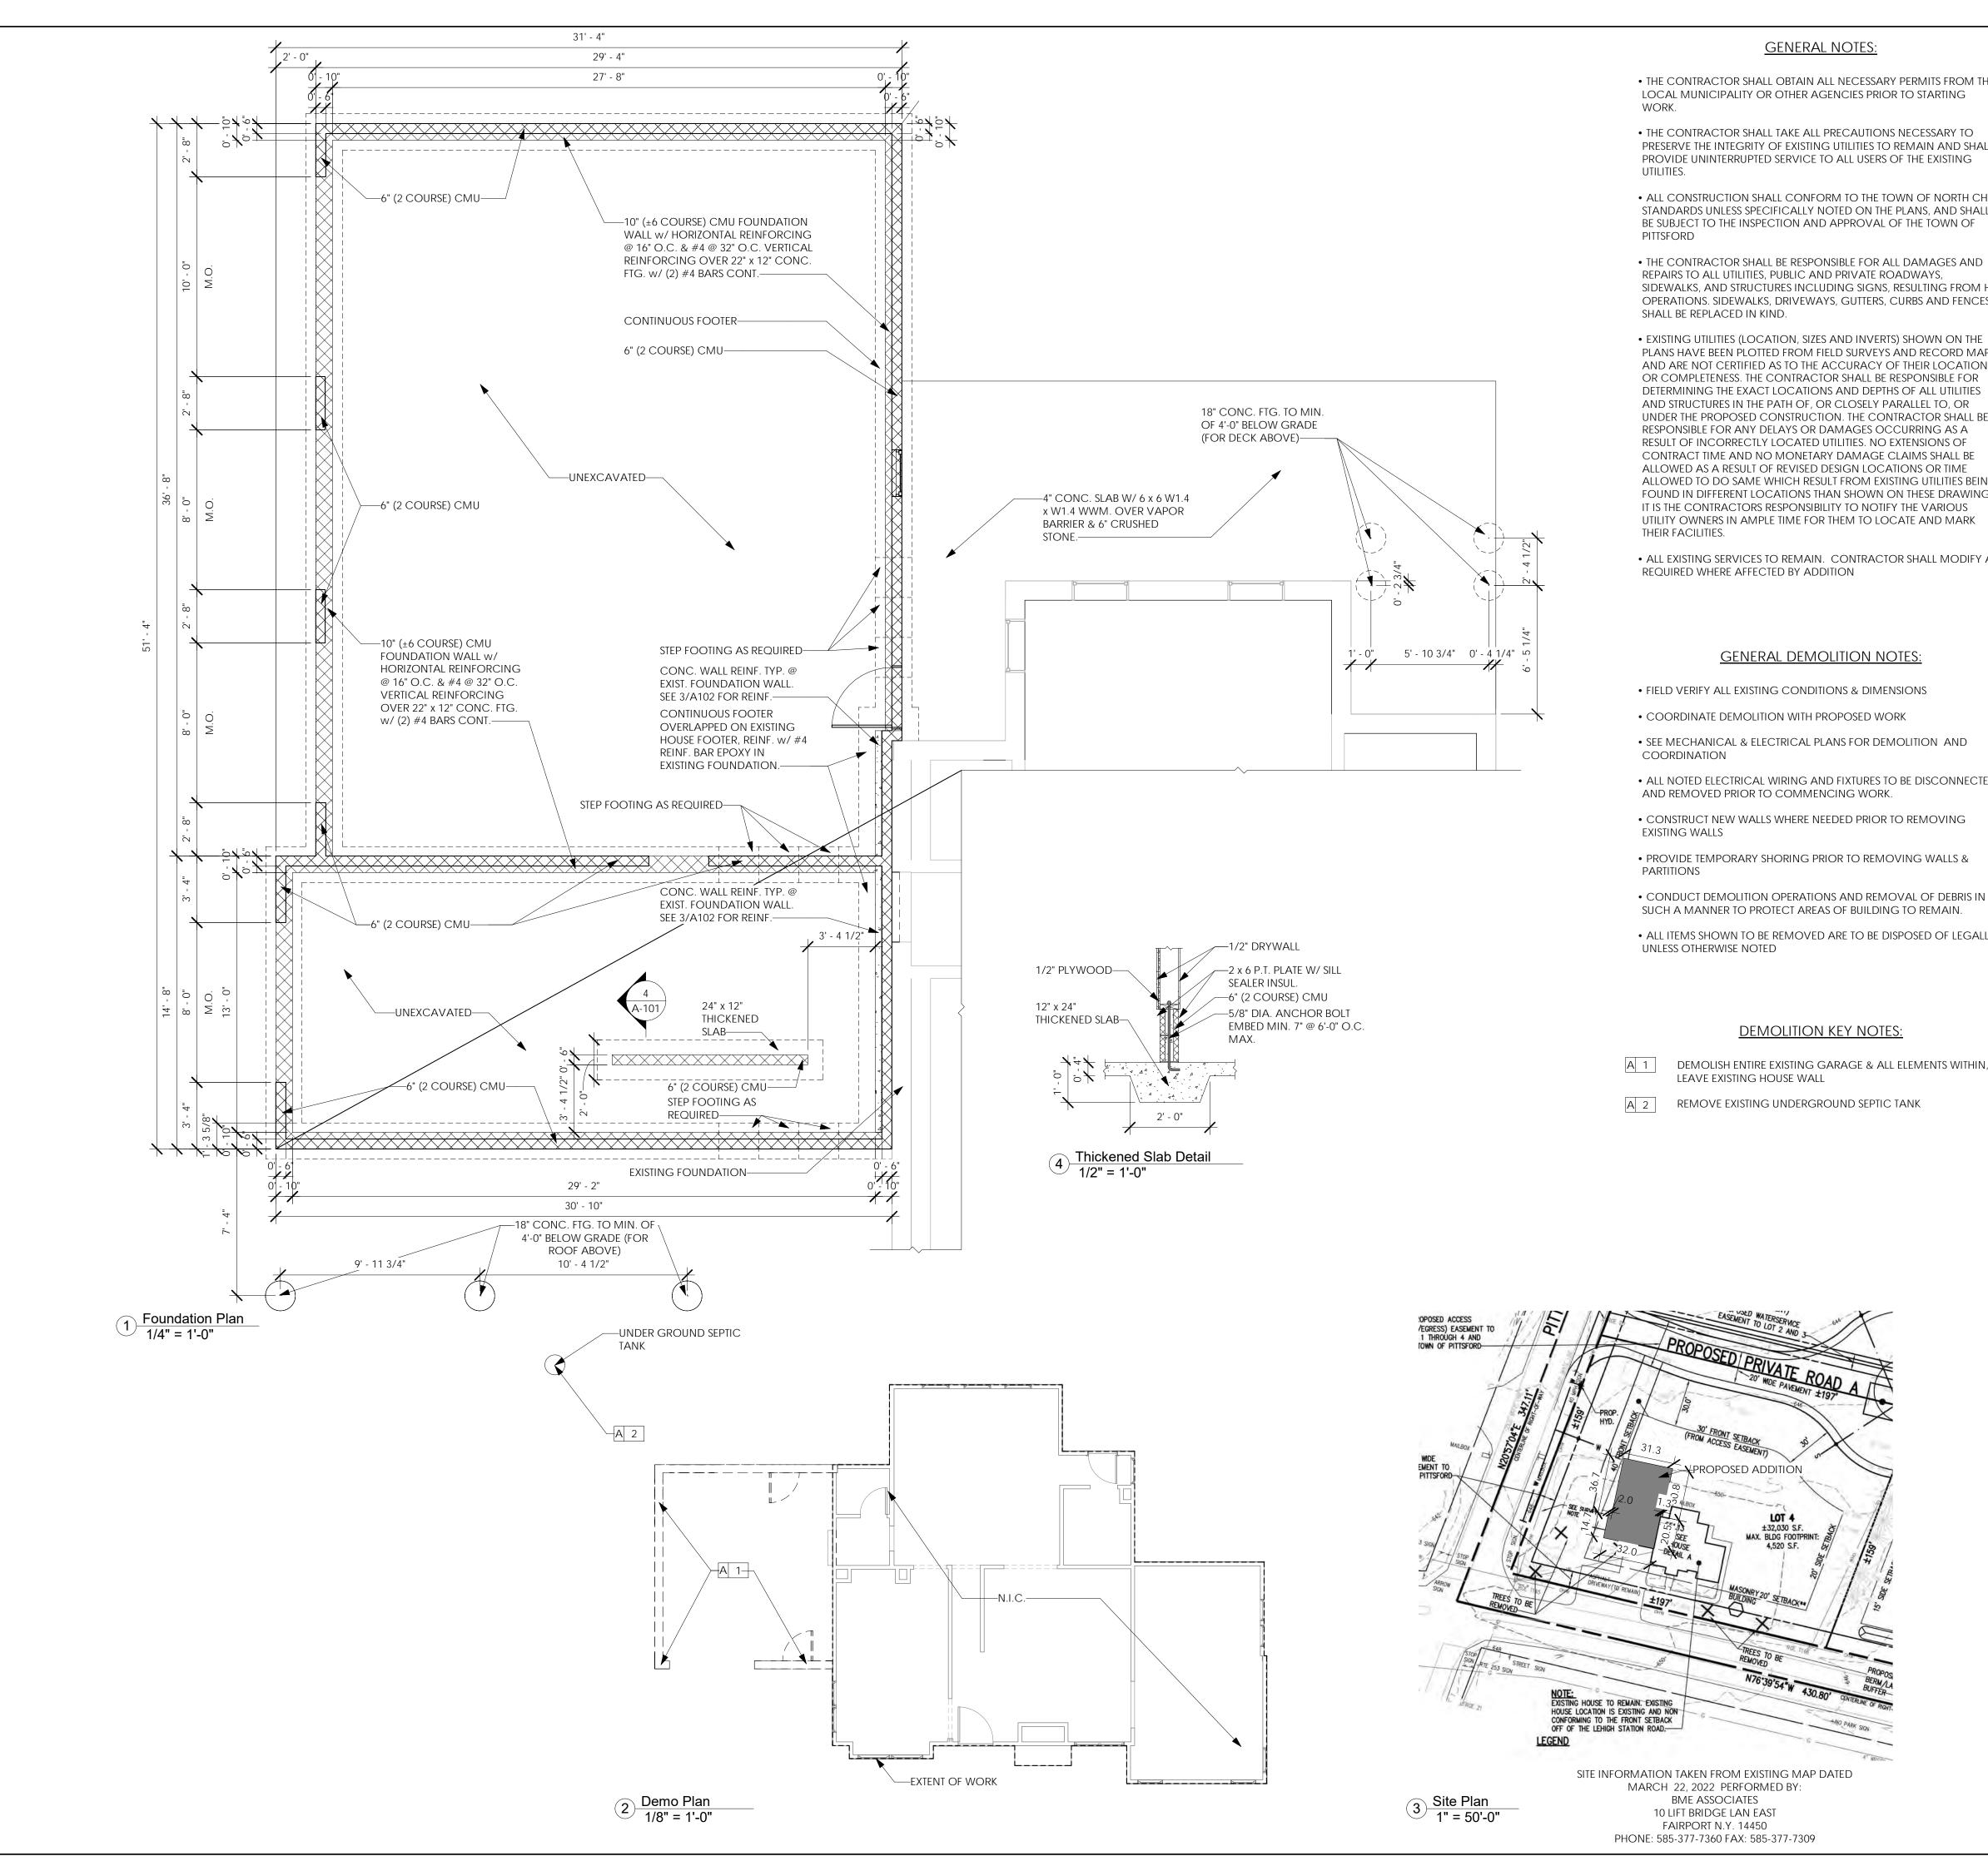
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180 ft

50 m





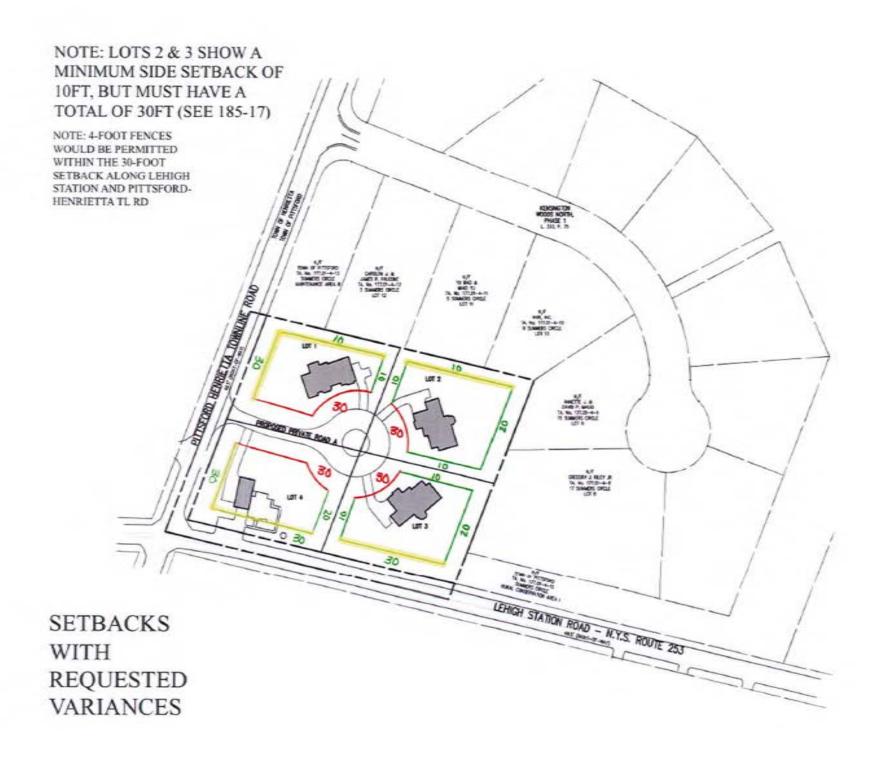

- THE CONTRACTOR SHALL OBTAIN ALL NECESSARY PERMITS FROM THE LOCAL MUNICIPALITY OR OTHER AGENCIES PRIOR TO STARTING
- THE CONTRACTOR SHALL TAKE ALL PRECAUTIONS NECESSARY TO PRESERVE THE INTEGRITY OF EXISTING UTILITIES TO REMAIN AND SHALL PROVIDE UNINTERRUPTED SERVICE TO ALL USERS OF THE EXISTING
- ALL CONSTRUCTION SHALL CONFORM TO THE TOWN OF NORTH CHILI STANDARDS UNLESS SPECIFICALLY NOTED ON THE PLANS, AND SHALL BE SUBJECT TO THE INSPECTION AND APPROVAL OF THE TOWN OF
- THE CONTRACTOR SHALL BE RESPONSIBLE FOR ALL DAMAGES AND SIDEWALKS, AND STRUCTURES INCLUDING SIGNS, RESULTING FROM HIS OPERATIONS. SIDEWALKS, DRIVEWAYS, GUTTERS, CURBS AND FENCES
- PLANS HAVE BEEN PLOTTED FROM FIELD SURVEYS AND RECORD MAPS AND ARE NOT CERTIFIED AS TO THE ACCURACY OF THEIR LOCATION OR COMPLETENESS. THE CONTRACTOR SHALL BE RESPONSIBLE FOR DETERMINING THE EXACT LOCATIONS AND DEPTHS OF ALL UTILITIES AND STRUCTURES IN THE PATH OF, OR CLOSELY PARALLEL TO, OR UNDER THE PROPOSED CONSTRUCTION. THE CONTRACTOR SHALL BE RESPONSIBLE FOR ANY DELAYS OR DAMAGES OCCURRING AS A RESULT OF INCORRECTLY LOCATED UTILITIES. NO EXTENSIONS OF CONTRACT TIME AND NO MONETARY DAMAGE CLAIMS SHALL BE ALLOWED AS A RESULT OF REVISED DESIGN LOCATIONS OR TIME ALLOWED TO DO SAME WHICH RESULT FROM EXISTING UTILITIES BEING FOUND IN DIFFERENT LOCATIONS THAN SHOWN ON THESE DRAWINGS. IT IS THE CONTRACTORS RESPONSIBILITY TO NOTIFY THE VARIOUS UTILITY OWNERS IN AMPLE TIME FOR THEM TO LOCATE AND MARK
- ALL EXISTING SERVICES TO REMAIN. CONTRACTOR SHALL MODIFY AS
- ALL NOTED ELECTRICAL WIRING AND FIXTURES TO BE DISCONNECTED
- CONSTRUCT NEW WALLS WHERE NEEDED PRIOR TO REMOVING
- PROVIDE TEMPORARY SHORING PRIOR TO REMOVING WALLS &
- CONDUCT DEMOLITION OPERATIONS AND REMOVAL OF DEBRIS IN
- ALL ITEMS SHOWN TO BE REMOVED ARE TO BE DISPOSED OF LEGALLY
- DEMOLISH ENTIRE EXISTING GARAGE & ALL ELEMENTS WITHIN,

GENERAL NOTES:

- CONSTRUCTION SHALL CONFORM TO THE RESIDENTIAL CODE OF NEW YORK STATE, AND REGULATIONS OF THE TOWN OF PITTSFORD
- CONTRACTOR IS TO OBTAIN BUILDING PERMITS, PAY FEES, COORDINATE THE SCHEDULE OF INSPECTIONS AS REQUIRED BY THE TOWN OF PITTSFORD
- LUMBER DESIGN BASED ON MINIMUM DESIGN PROPERTIES FOR NO. 2 GRADE LUMBER OF DOUGLAS FIR
- WOOD IN CONTACT WITH MASONRY, CONCRETE OR EARTH, OR WITHIN 1'-0' OF GRADE OR EXPOSED TO THE EXTERIOR SHALL BE

PRESSURE PRESERVATIVE TREATED.

- FRAMING ANCHORS, JOIST HANGERS, AND MISCELLANEOUS METAL CONNECTING DEVICES FOR WOOD FRAMING SHALL BE GALVANIZED STEEL OF AT LEAST 16 GAGE THICKNESS. INSTALL IN STRICT ACCORDANCE WITH MANUFACTURER'S RECOMMENDATIONS. USE NAILS SUPPLIED BY OR RECOMMENDED BY THE MANUF.
- DOUBLE ALL JOIST UNDER PARALLEL WALLS, AND AT FLOOR
- THE GENERAL CONTRACTOR IS RESPONSIBLE FOR COMPLIANCE WITH ALL INFORMATION ON THE DRAWINGS.
- CONSTRUCTION METHODS AND CRAFTSMANSHIP ARE THE RESPONSIBILITY OF THE GENERAL CONTRACTOR.
- FIELD VERIFY ALL EXISTING CONDITIONS & DIMENSIONS
- ALL NEW WALL INFILLS & EXTENSIONS SHALL BE FLUSH WITH BOTH SIDES OF EXIST. WALL
- PROVIDE SHELVING IN CLOSETS. COORDINATE SHELVING DESIGN WITH OWNER
- PATCH & REPAIR DAMAGED EXISTING DRYWALL
- ALL NEW INTERIOR DOOR HEADERS TO BE (2) 2 x 8 UNLESS OTHERWISE NOTED.
- ALL NEW WINDOW HEADERS TO BE (3) 2 x 8 UNLESS OTHERWISE
- ALL DOORS OPENING AND WINDOWS FRAMING SHALL BE 1 KING
- STUD & 2 JACK STUDS. (TYP) • PROVIDE 3 1/2" SOUND ATTENUATION BATTS AT ALL PARTITIONS
- BETWEEN BATHROOMS AND OTHER ROOMS
- PROVIDE 1/2" MOISTURE RESISTANT DRYWALL AT ALL BATHROOMS
- NEW FIXTURES TO BE SELECTED BY OWNER, INSTALLED BY CONTRACTOR
- NEW APPLIANCES (AS REQ'D) TO BE FURNISHED BY OWNER, INSTALLED BY CONTRACTOR
- CONTRACTOR TO COORDINATE ELECTRICAL, HVAC AND PLUMBING NEEDS & CONNECTIONS WITH OWNER AND INCLUDE REQUIRED WORK IN BID PRICING
- CONTRACTOR TO INSTALL AT LEAST (1) SMOKE DETECTOR IN EACH BEDROOM & (1) OUTSIDE EACH SLEEPING AREA IN THE VICINITY OF THE BEDROOM, & (1) IN EACH SEPARATE STORY INCLUDING THE BASEMENT. ALL SMOKE DETECTORS SHALL BE WIRED INTO 120V WITHOUT DISCONNECTING SWITCH OTHER THAN CIRCUIT BREAKER & SHALL BE INTERCONNECTED SUCH THAT WHEN ONE ALARMS, ALL SHALL ALARM. (1) CARBON MONOXIDE DETECTOR IN DINING ROOM, NEAR KITCHEN. INSTALLATION OF SMOKE & CARBON MONOXIDE DETECTORS SHALL BE IN ACCORDANCE WITH ALL STATE & LOCAL CODES & THE HOUSEHOLD FIRE WARNING EQUIPMENT PROVISIONS OF NFPA 72. ALL DETECTORS SHALL BE EQUIPPED WITH BATTERY

GENERAL CONCRETE & **FOUNDATION NOTES:**

- ALLOWABLE SOIL BEARING ASSUMED AS 2500 P.S.F.
- ALL CONCRETE TO HAVE A MINIMUM COMPRESSIVE STRENGTH OF 3500 P.S.I. AT 28 DAYS, UNLESS NOTED OTHERWISE.
- BOTTOM OF ALL FOOTINGS TO REST ON UNDISTURBED SOIL.
- STEPS IN ALL FOOTINGS NOT TO EXCEED 1'-0" VERTICAL FOR EACH 2'-0" HORIZONTAL.
- ALL CONCRETE SLABS ON GRADE TO REST ON 6" COMPACTED POROUS FILL. (CRUSHED STONE)
- ALL SLABS ON GRADE TO BE REINFORCED WITH 6 x 6 -W1.4 x W1.4 WWM. UNLESS NOTED OTHERWISE. SPLICES FER CRSI LATEST EDITION.
- FILL COLUMN AND BEAM POCKETS WIITH CONCRETE AFTER ALL COLUMNS AND BEAMS ARE IN PLACE, UNLESS NOTED OTHERWISE

WALLS WITH FILL ON ONE SIDE ONLY, MUST NOT BE BACKFILLED UNTIL

- BACKFILL BOTH SIDES OF FOUNDATION WALLS SIMULTANEOUSLY:
- DECK AT TOP AND SLAB BOTTOM OF WALL ARE IN PLACE. • SLEEVE FOUNDATION WALLS WHERE REQUIRED TO ACCOMMODATE
- DUCTS AND UTILITIES.
- REINFORCING BARS TO CONFORM TO ASTM A-615 GRADE 60. EXCEPT REINFORCING FOR DOWELS TO SLABS TO BE GRADE 40.
- STEEL MESH REINFORCING TO CONFORM TO ASTM A-185
- REINFORCING BAR SPLICES & EMBEDMENT LENGTHS TO CONFORM TO LATEST CRSI HANDBOOK COMPLYING WITH ACI 318-CODE OF LATEST ISSUE, UNLESS NOTED OTHERWISE.
- ALL SPLICES IN REINFORCING ARE TO BE CLASS "B", UNLESS NOTED OTHERWISE. CONSIDER ALL HORIZONTAL WALL BARS AS "TOP BARS"
- TERMINATE ALL BARS IN ACCORDANCE WITH ACI-318 CODE OF LATEST ISSUE, WITH A HOOK IF THE REQUIRED EMBEDMENT LENGTH CANNOT BE OBTAINED.
- PROVIDE #4 VERTICAL REINFORCING @ 32" O.C.- GROUT CORES WITH REINFORCING SOLID, PER TABLE R 404.1.1(3) OF THE RESIDENTIAL CODE OF N.Y.S.

	Issued:	Date:
Α	Issued for Client Review	11/04/22
В	Issued for Client Review	11/07/22
С	Issued for Bid Permit	11/07/22

Revisions: Date:



Project Architect/Engineer Date: Architect/Engineer Name

Date: Project Lead Lead Name

Date: Project Designer Designer Name

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Young Residence Addition

2490 Lehigh Station Rd Pittsford, NY 14534 Monroe County

Project Name & Location:

Site Plan, Existing/Demo Plan, Foundation Plan

Drawing Name:


Project No. Date: 11/07/22


21-0511 Type: Residentia

A-101 Drawn By: NMH

Scale: As Noted


Drawing No.

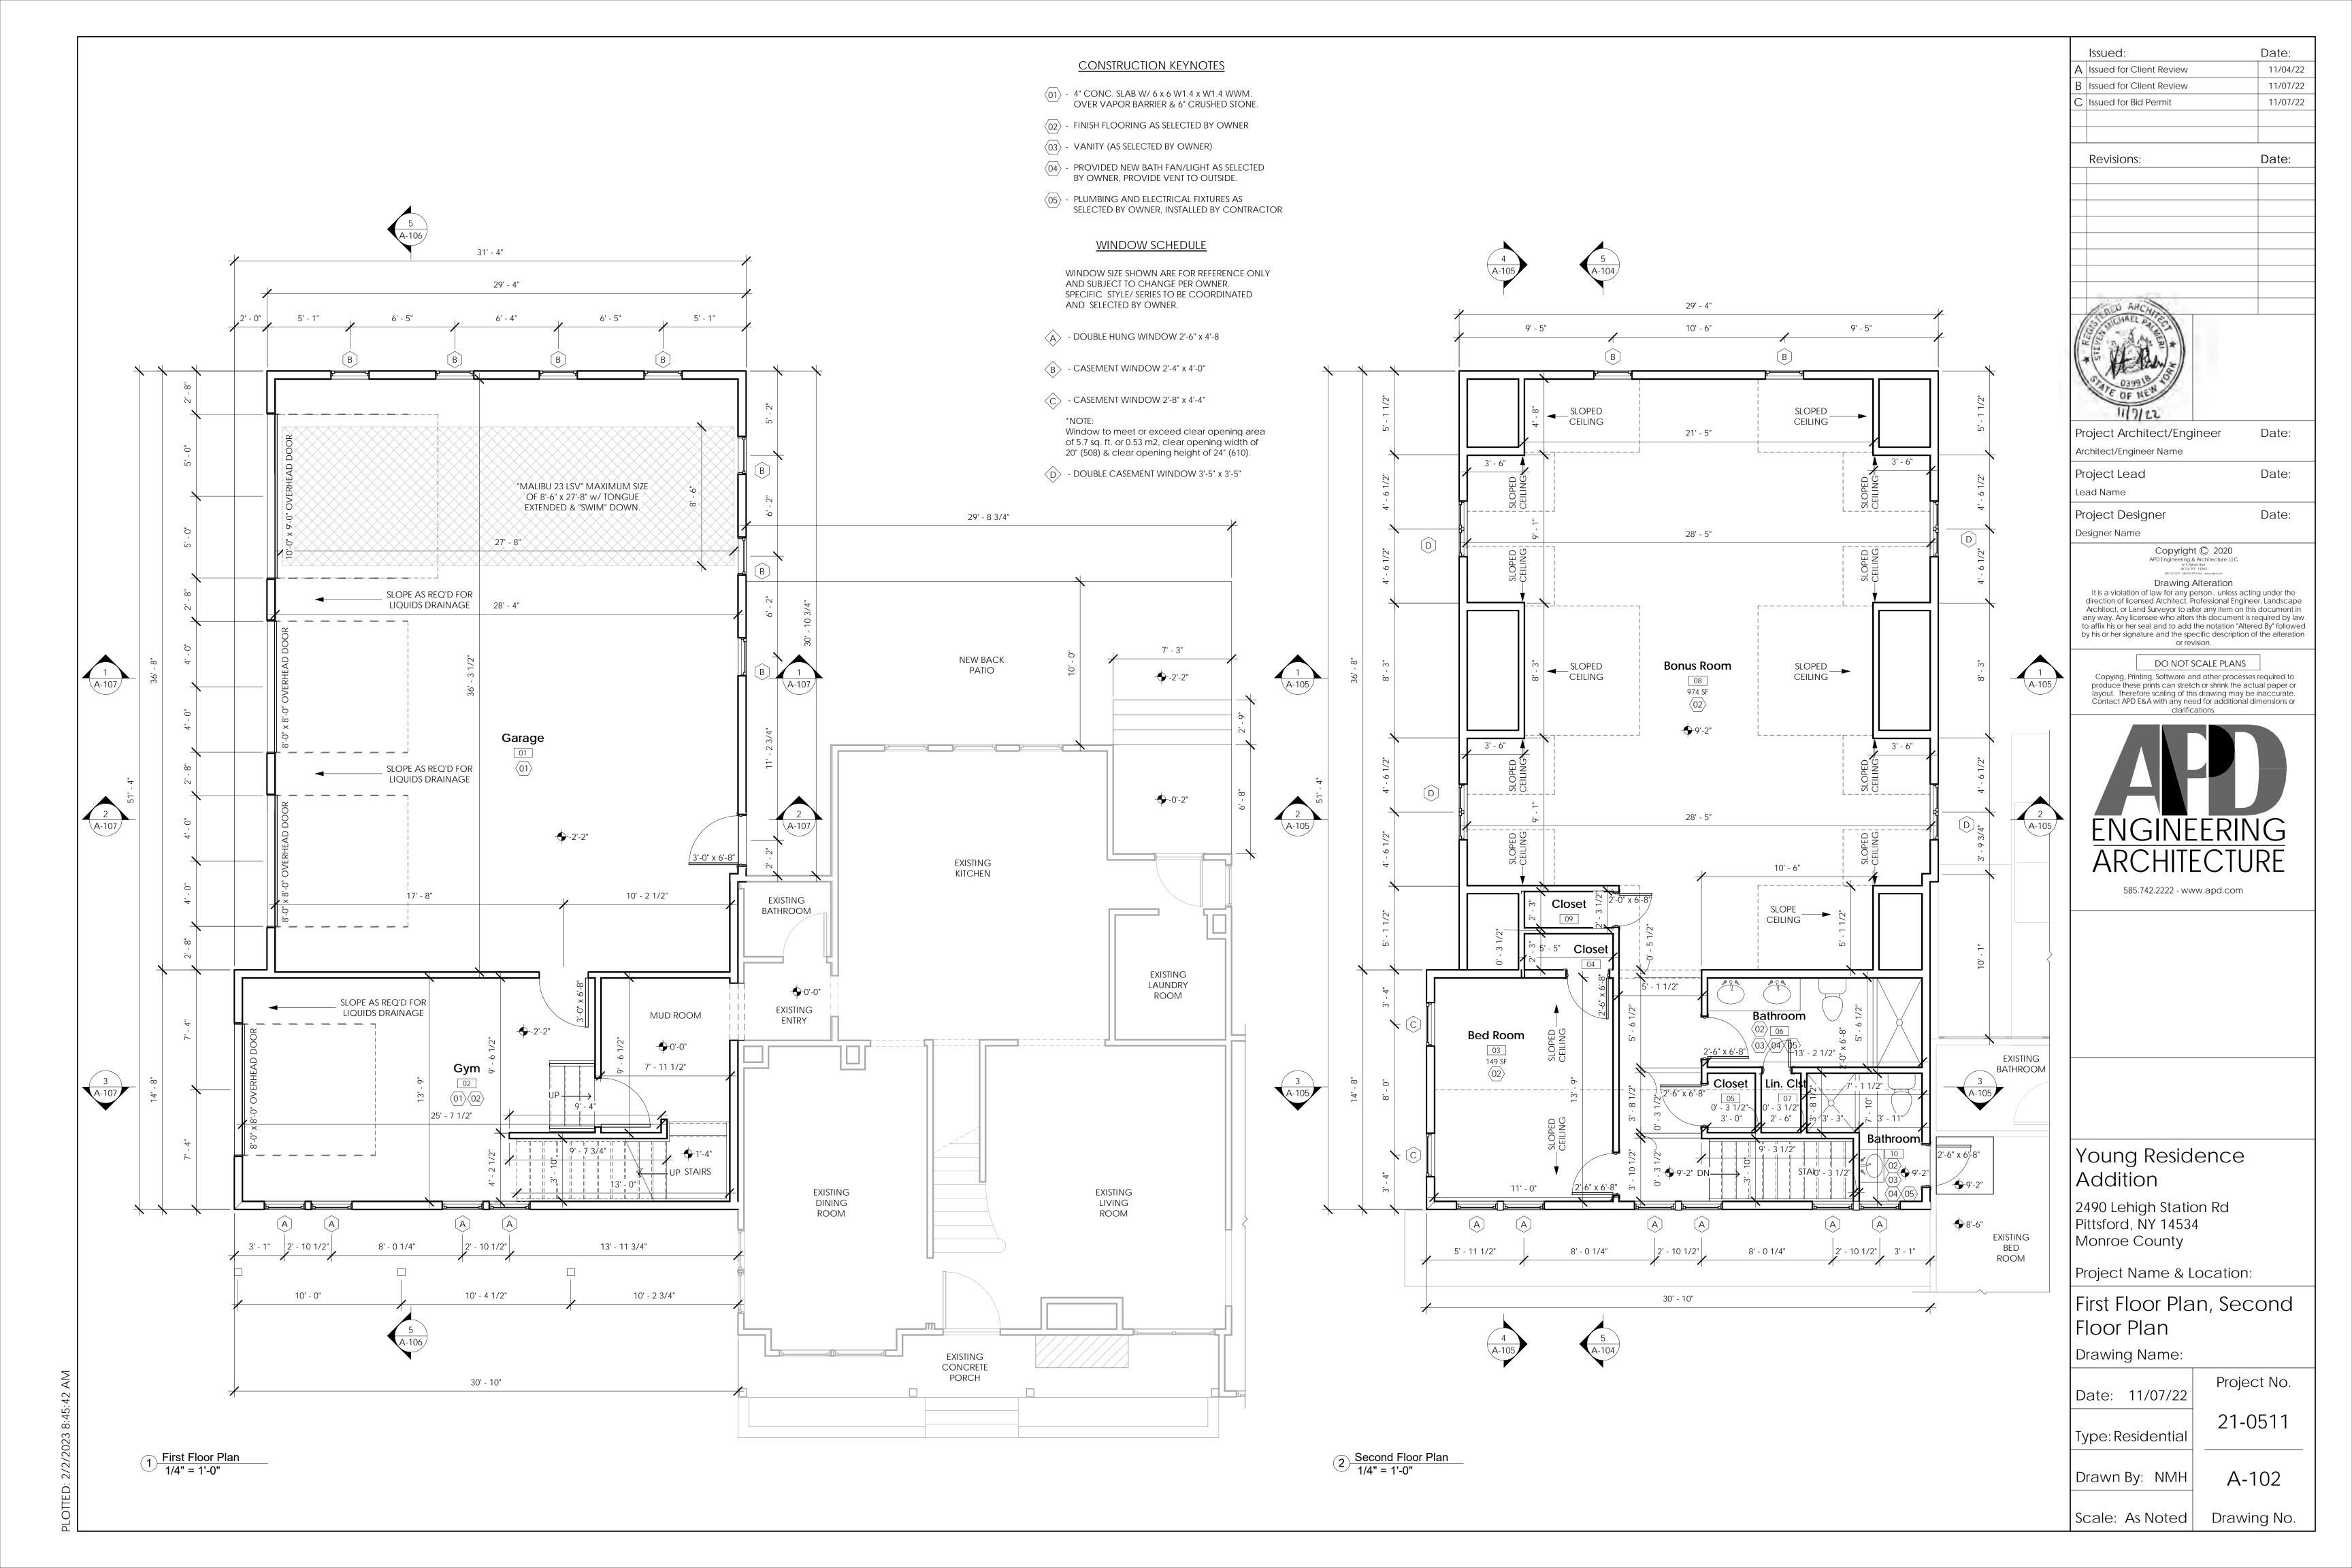


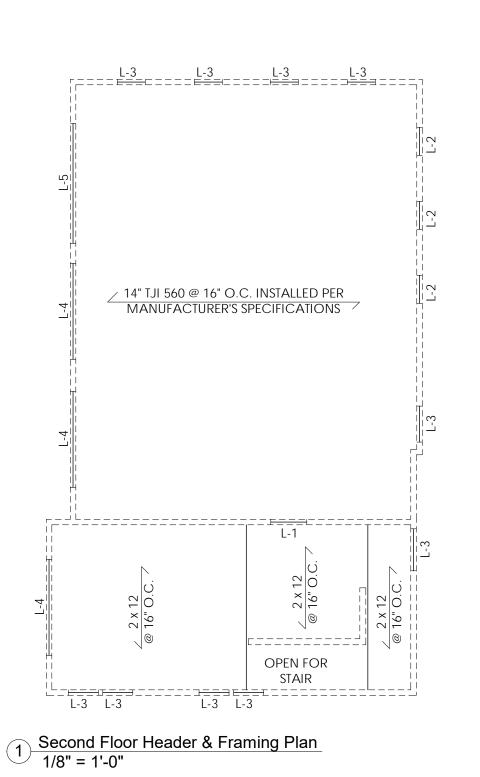



MANUFACTURER

Back Deck Framing Plan
1/4" = 1'-0"

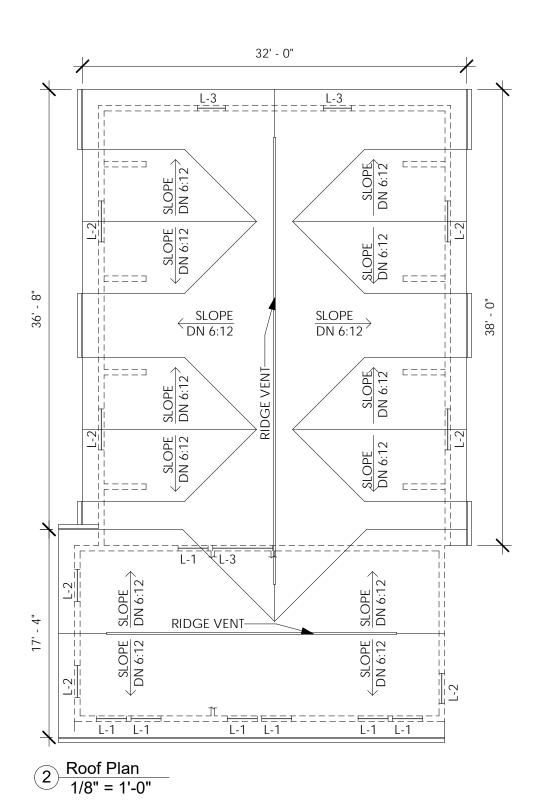

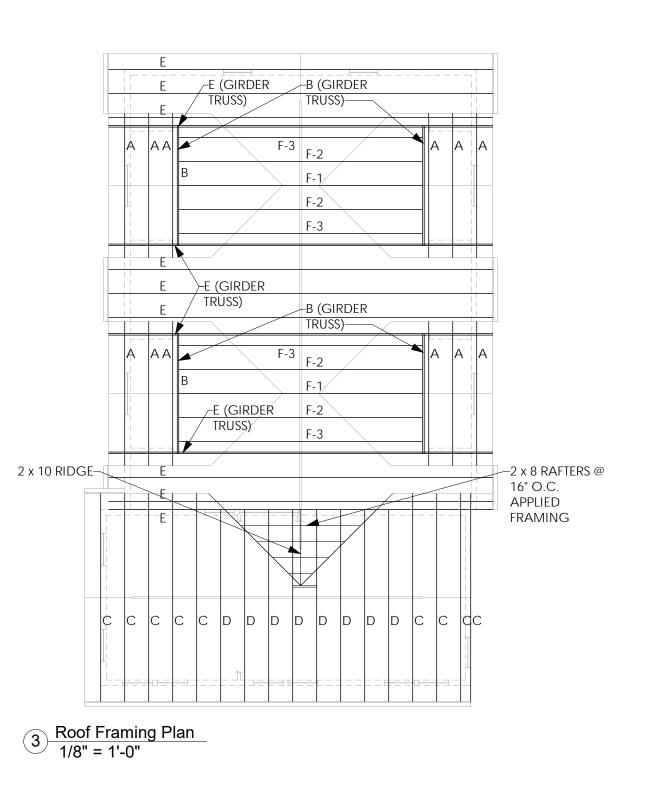

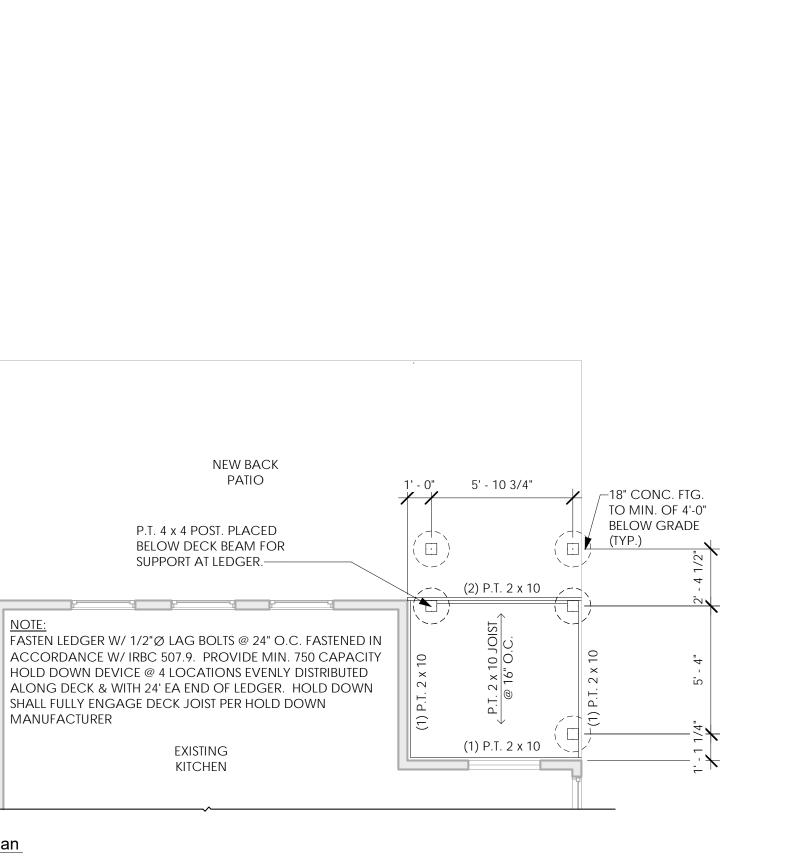

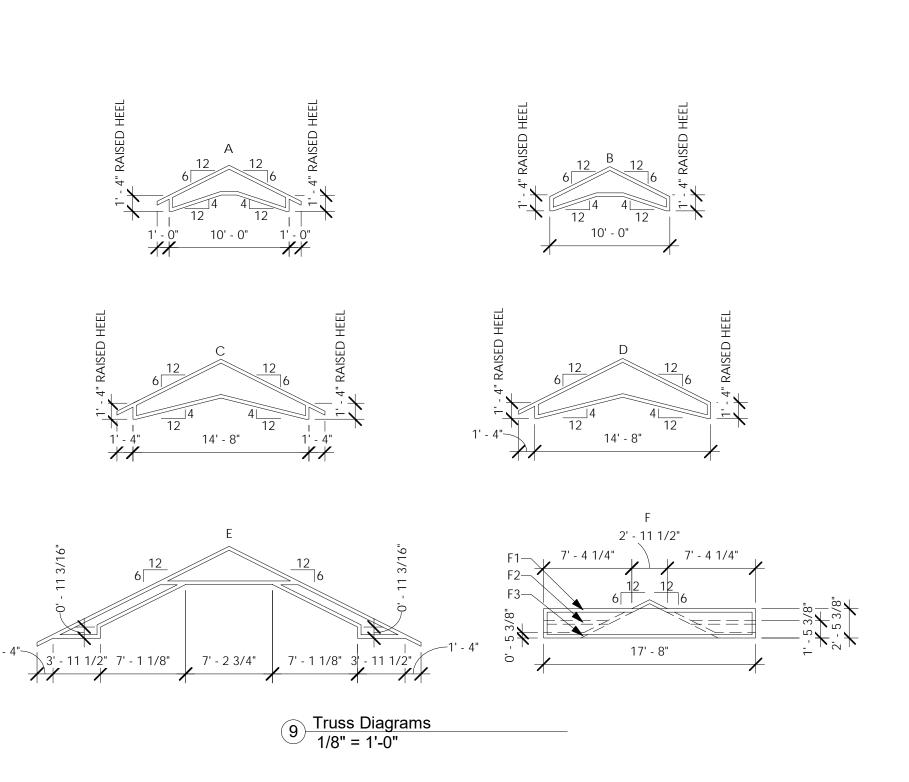

ROOF NOTES:

- PROVIDE MINIMUM 5'-0" WIDE ICE & WATER SHIELD UNDERLAYMENT ALONG EAVES AND AT VALLEYS
- PROVIDE ASPHALT SATURATED FELT UNDERLAYMENT ALL REMAINING
- PROVIDE ALUMINUM FASCIA, DRIP EDGE, VENTED SOFFITS, GUTTERS AND DOWNSPOUTS AT NEW ROOF AREAS, TO MATCH EXISTING.
- REMOVE EXISTING ROOF SHINGLES & UNDERLAYMENT. FURNISH AND INSTALL ICE & WATER UNDERLAYMENT & NEW ARCHITECTURAL SHINGLES AS REQ'D
- VERIFY IN FIELD EXISTING ROOF OVERHANGS. NEW OVERHANGS TO MATCH EXIST.

LINTEL & HEADER SCHEDULE:

- L-1 (3) 2 x 4 WITH (2)1/2" PLYWOOD GUSSET (2 x 6 EXTERIOR WALLS) L-2 - (3) 2 x 6 WITH (2)1/2" PLYWOOD GUSSET (2 x 6 EXTERIOR WALLS) L-3 - (3) 2 x 8 WITH (2)1/2" PLYWOOD GUSSET (2 x 6 EXTERIOR WALLS) L-4 - 2.0E MICROLAM LVL 5 1/4" WIDE (3 PLY) x 9 1/4" (8'-0" WIDE GARAGE DOOR)
- L-5 2.0E MICROLAM LVL 5 1/4" WIDE (3 PLY) x 11 1/4" (10'-0" WIDE GARAGE DOOR)


NOTE:

PRE-ENGINEERED WOOD TRUSS SYSTEM SHALL BE DESIGNED BY A N.Y.S. LICENSED ARCHITECT OR ENGINEER FOR THE FOLLOWING LOADS:


TOP CHORD DEAD LOAD: 10# SNOW LOAD: 50# GROUND TOP CHORD DEAD LOAD: 10# **BOTTOM CHORD**

NOTE:

- ALL TRUSSES TO BE 2'-0" O.C.
- ALL STICK FRAMING SHALL BE: 2x10 RIDGE & HIP MEMBERS 2x8 RAFTERS @ 16" O.C. UNLESS OTHERWISE NOTES
- VERIFY PITCH OF EXISTING ROOF PRIOR TO ORDERING TRUSS
- CONTRACTOR SHALL FURNISH TRUSS SHOP DRAWINGS WITH ENGINEER OR ARCHITECT SEAL & SIGNATURE
- TRUSS MANUFACTURER TO PROIVDE RECOMMENDED ROOF TRUSS SYSTEM BRACING DIAGRAM
- ROOF TRUSS SHALL BE INSTALLED USING SIMPSON HURRICANE TIES H8 OR APPROVED EQUAL.

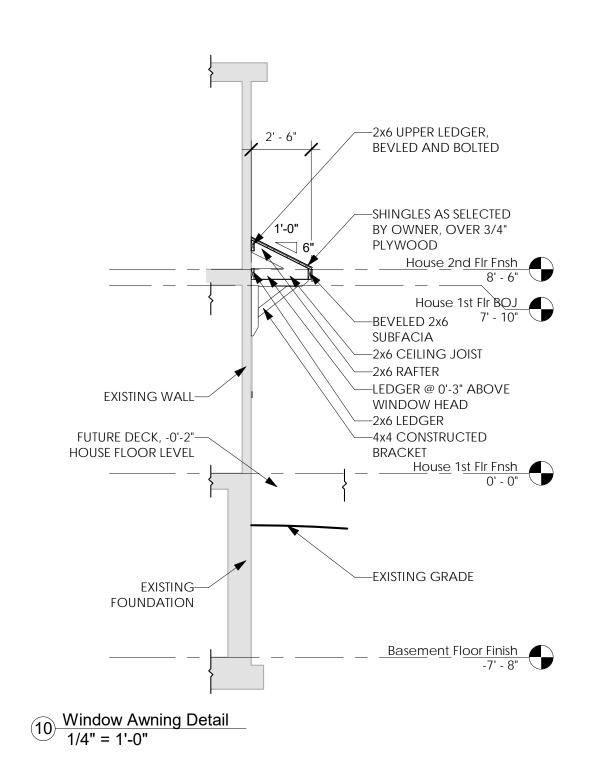

	Issued:	Date:
\	Issued for Client Review	11/04/22
3	Issued for Client Review	11/07/22
)	Issued for Bid Permit	11/07/22
	Revisions:	Date:

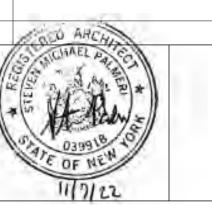

Architect/Engineer Name

Project Architect/Engineer Date:

Project Lead Date: Lead Name

Project Designer Date: Designer Name


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Young Residence Addition

2490 Lehigh Station Rd Pittsford, NY 14534 Monroe County

Project Name & Location:

Roof Framing, Plan & Truss Diagram


Drawing Name:

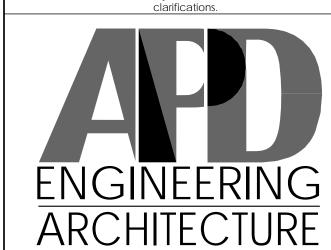
Project No. Date: 11/07/22 21-0511 Type: Residential

Drawn By: NMH

Scale: As Noted Drawing No.

A-103

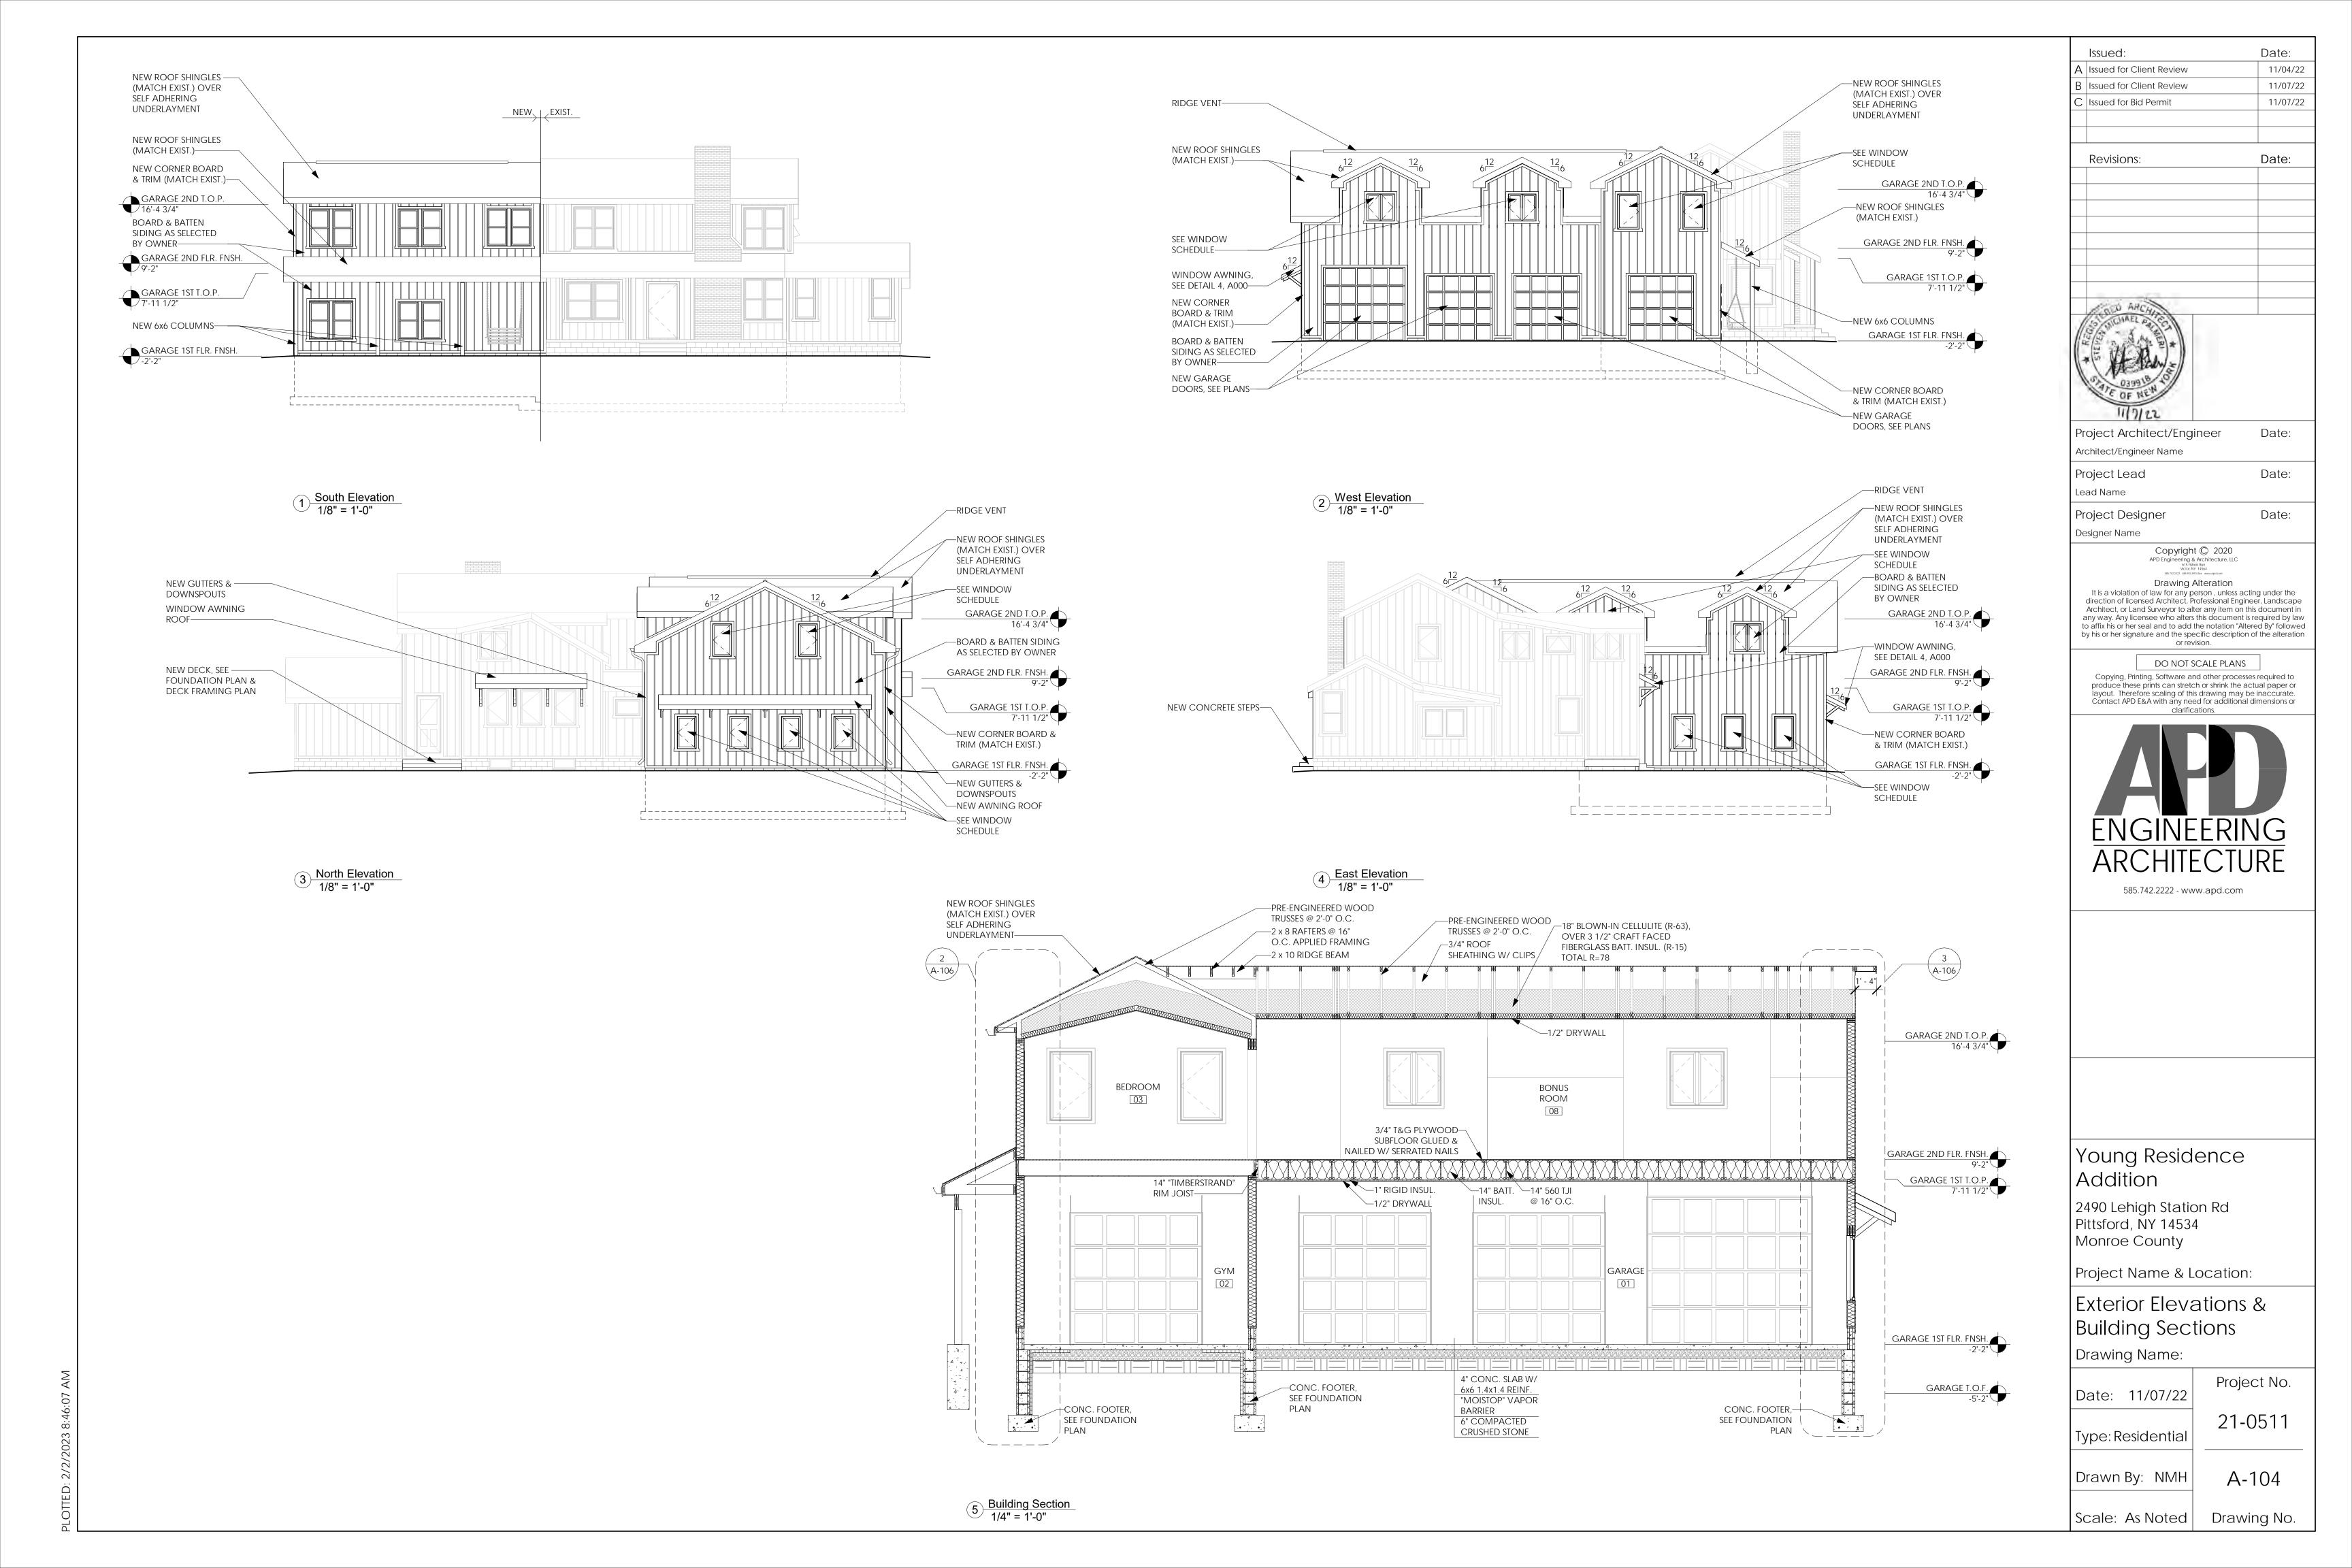


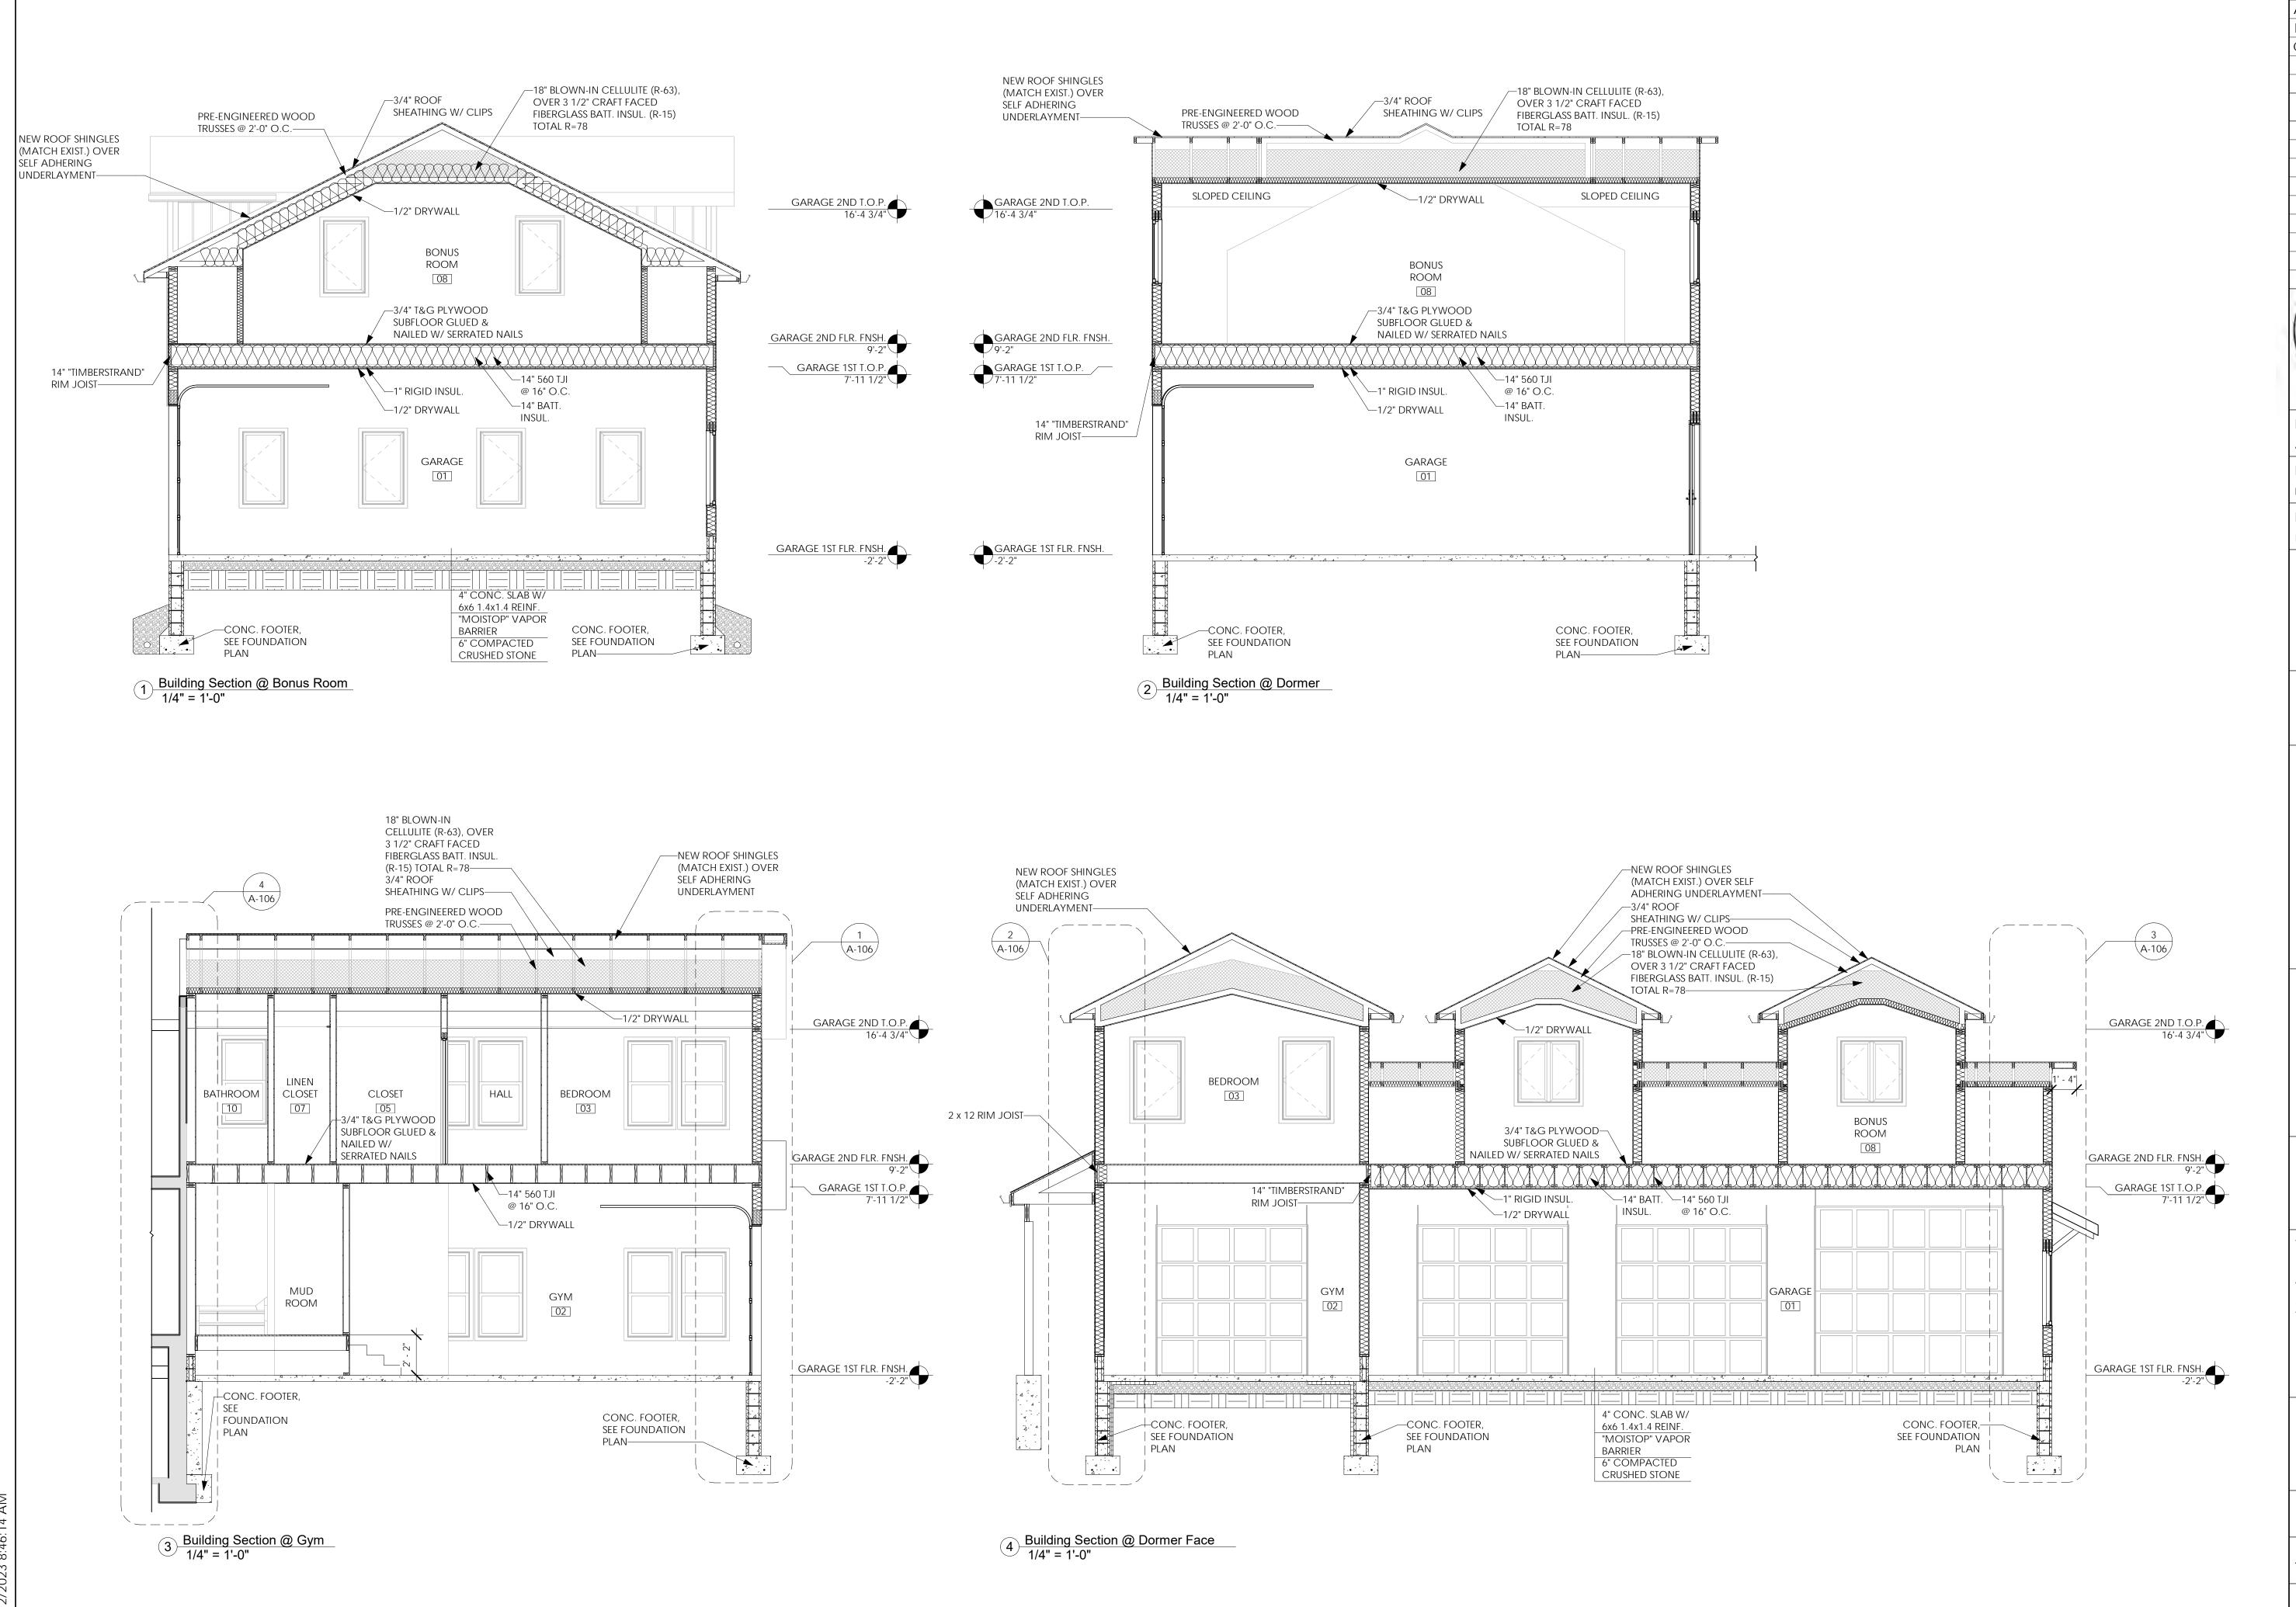


Date: Issued: 11/04/22 A Issued for Client Review 11/07/22 Issued for Client Review Issued for Bid Permit 11/07/22 Date: Revisions: Project Architect/Engineer Date: Architect/Engineer Name Date: Project Lead Lead Name Date: Project Designer Designer Name Copyright © 2020 APD Engineering & Architecture, LLC 615 Rshers Run Victor, NY 14564 5857422222 Seb-9244914 fax www.apd.com Drawing Alteration It is a violation of law for any person , unless acting under the direction of licensed Architect, Professional Engineer, Landscape Architect, or Land Surveyor to alter any item on this document in any way. Any licensee who alters this document is required by law to affix his or her seal and to add the notation "Altered By" followed by his or her signature and the specific description of the alteration or revision. DO NOT SCALE PLANS Copying, Printing, Software and other processes required to produce these prints can stretch or shrink the actual paper or layout. Therefore scaling of this drawing may be inaccurate. Contact APD E&A with any need for additional dimensions or ENGINEERING ARCHITECTURE 585.742.2222 - www.apd.com Young Residence Addition 2490 Lehigh Station Rd Pittsford, NY 14534 Monroe County Project Name & Location: Building Sections Drawing Name: Project No. Date: 11/07/22 21-0511 Type: Residential Drawn By: NMH A-105

Scale: As Noted

Drawing No.

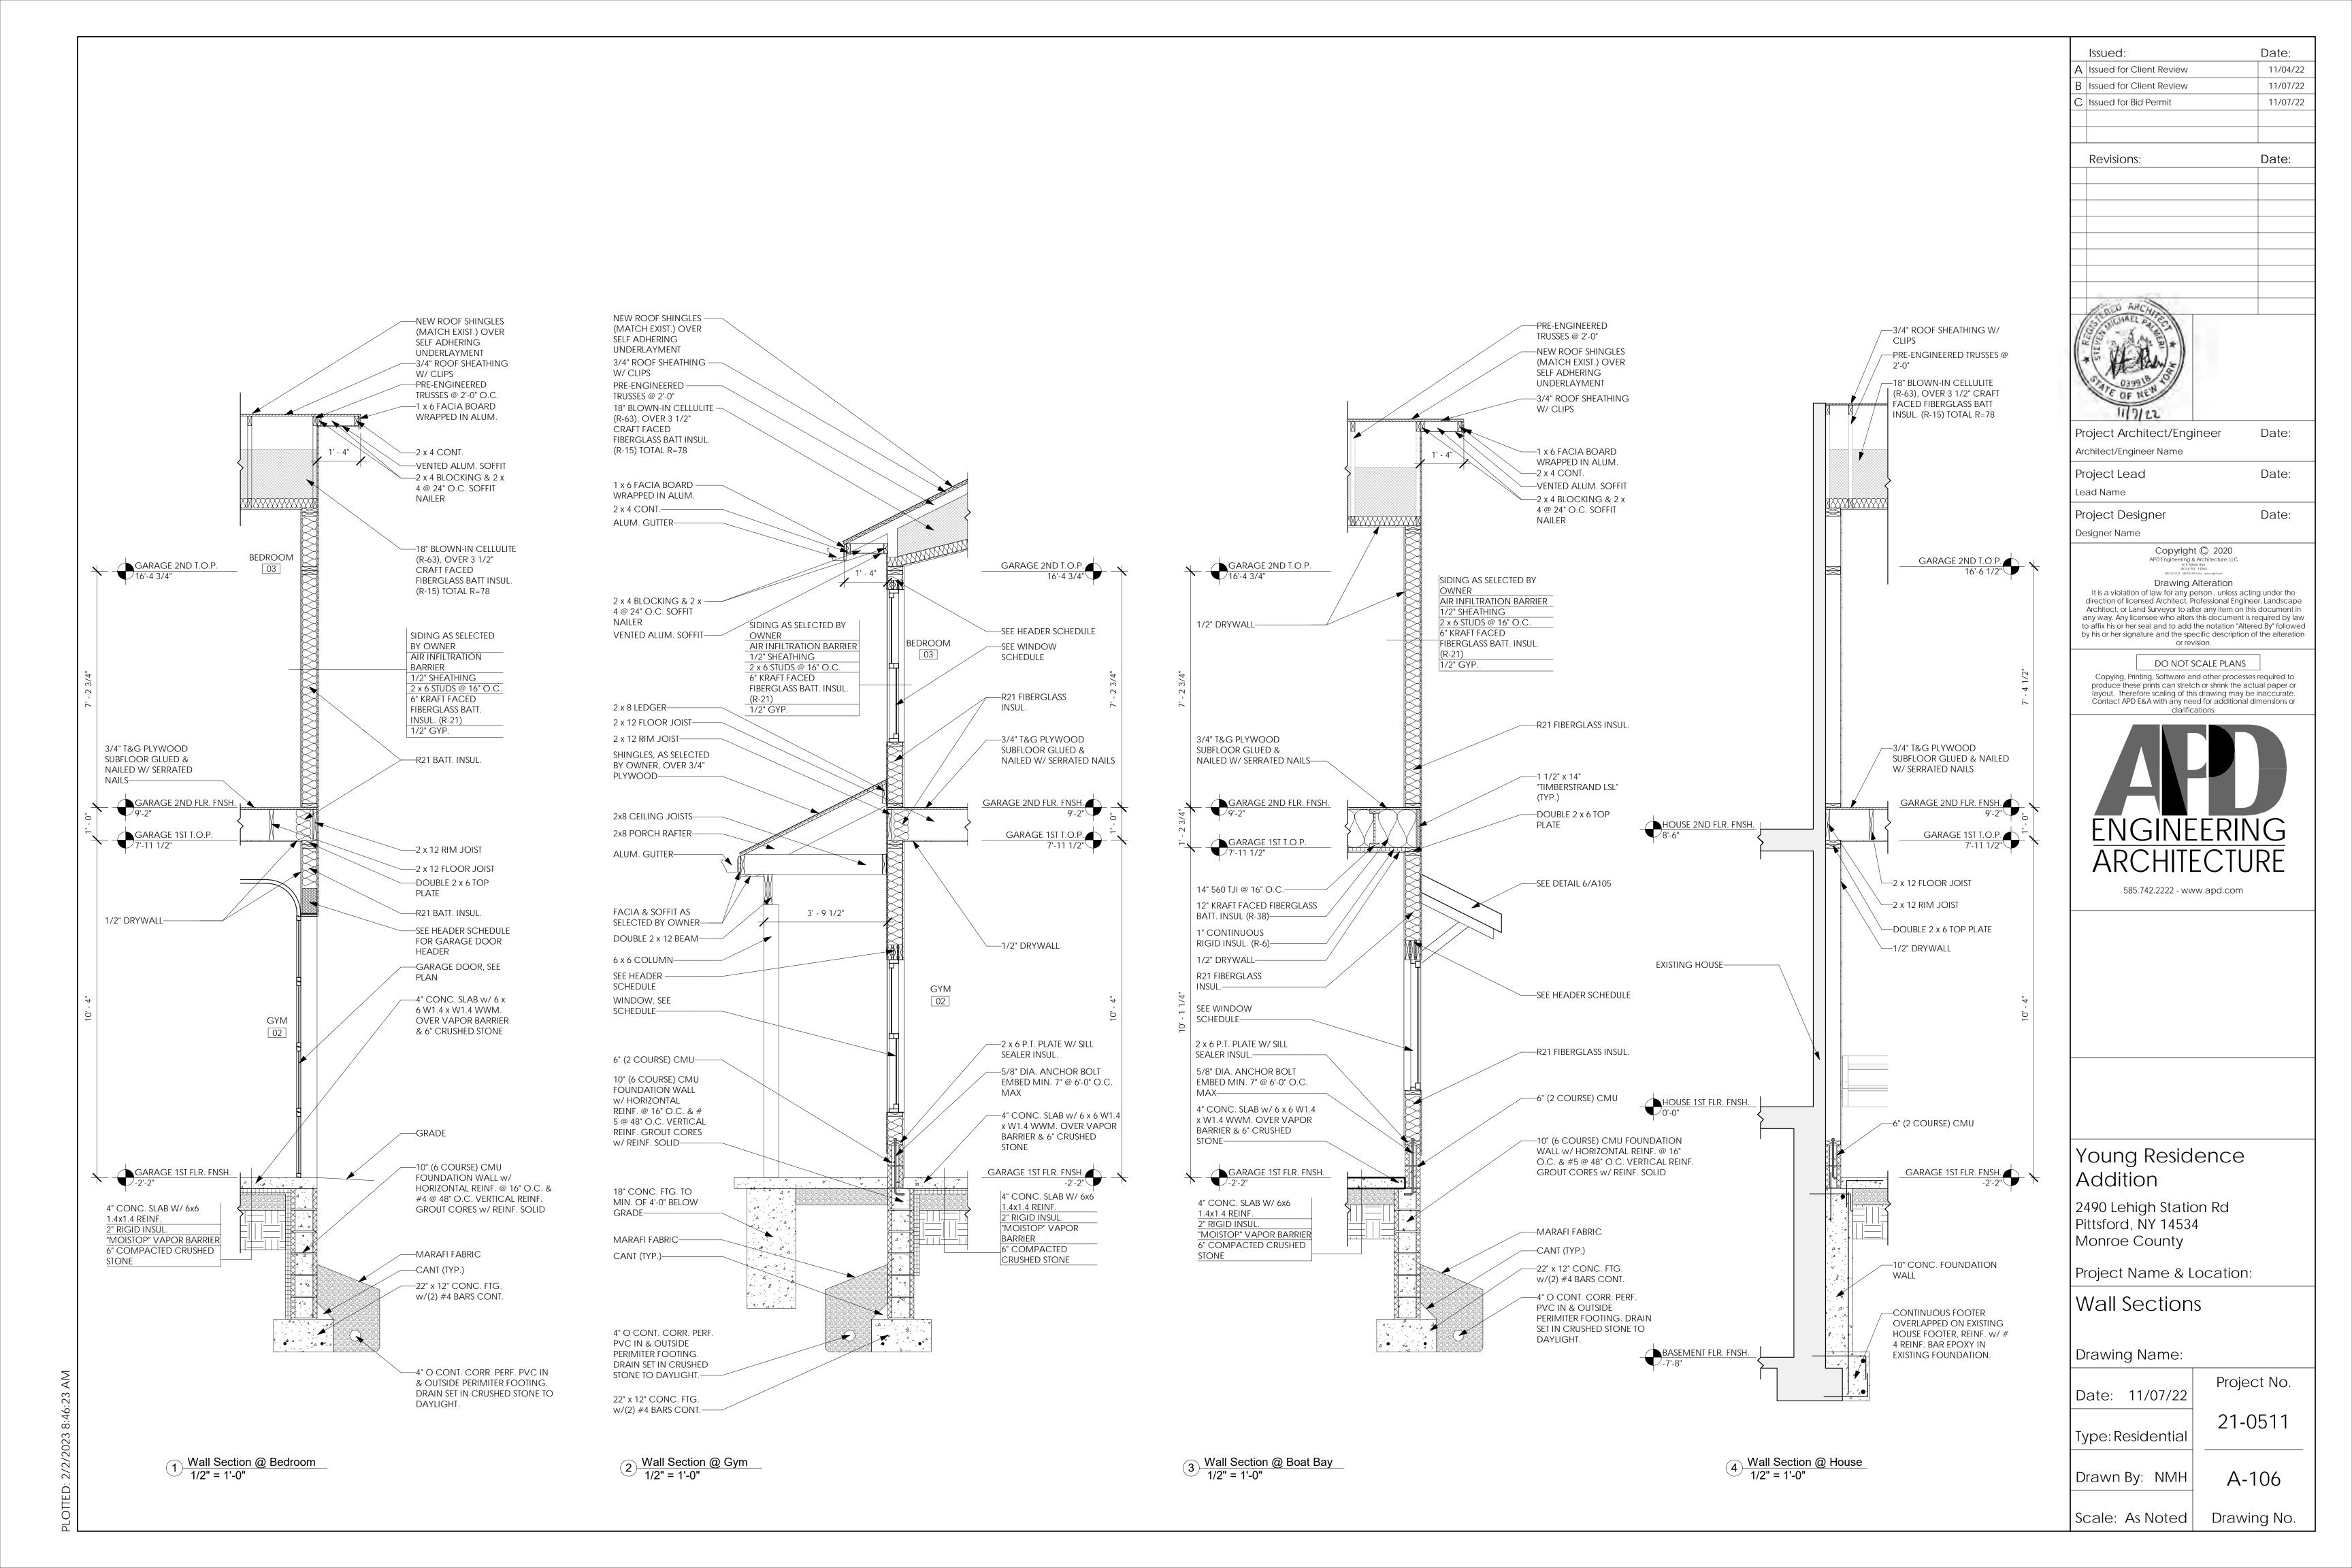

5/3/22, 4:13 PM Letter View

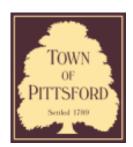

Town of Pittsford

Department of Public Works 11 South Main Street Pittsford, New York 14534

Permit # B22-000076

Phone: 585-248-6250 FAX: 585-248-6262

DESIGN REVIEW AND HISTORIC PRESERVATION BOARD REFERRAL OF APPLICATION

Property Address: 32 Rosewood Drive PITTSFORD, NY 14534

Tax ID Number: 178.20-2-20

Zoning District: RN Residential Neighborhood

Owner: Madden, Michael R Applicant: Madden, Michael R

	on Type:	tion	cat	pli	g	Α
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ilcation type:		
Residential Design Review		Build to Line Adjustment
• ,		§185-17 (B) (2)
Commercial Design Review		Building Height Above 30 Feet
§185-205 (B)		§185-17 (M)
Signage		Corner Lot Orientation
§185-205 (C)		§185-17 (K) (3)
Certificate of Appropriateness		Flag Lot Building Line Location
§185-197		§185-17 (L) (1) (c)
Landmark Designation		Undeveloped Flag Lot Requirements
§185-195 (2)		§185-17 (L) (2)
Informal Review		. , , ,
	Residential Design Review §185-205 (B) Commercial Design Review §185-205 (B) Signage §185-205 (C) Certificate of Appropriateness §185-197 Landmark Designation §185-195 (2)	Residential Design Review §185-205 (B) Commercial Design Review §185-205 (B) Signage §185-205 (C) Certificate of Appropriateness §185-197 Landmark Designation §185-195 (2)

Project Description: The Applicant is requesting design review for the construction of a covered porch off the front of the house.

Meeting Date: March 9, 2023





Town of Pittsford GIS

95

25

The information depicted on this map is representational and should be used for general reference purposes only. No warranties, expressed or implied, are provided for the data or its use or its user or its user


190

50

380 ft

100 m



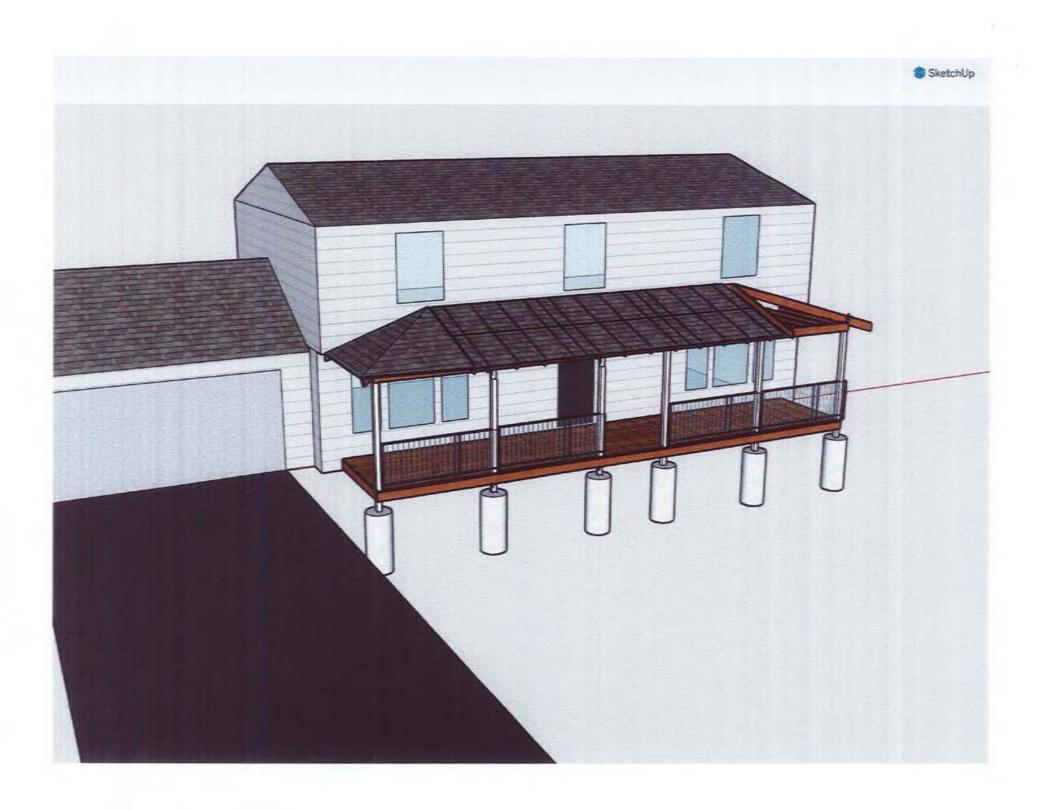













Town of Pittsford

Department of Public Works 11 South Main Street Pittsford, New York 14534

Permit # B23-000019

Phone: 585-248-6250 FAX: 585-248-6262

DESIGN REVIEW AND HISTORIC PRESERVATION BOARD REFERRAL OF APPLICATION

Property Address: 91 Caversham Woods PITTSFORD, NY 14534

Tax ID Number: 163.20-1-47

Zoning District: RN Residential Neighborhood

Owner: Ali, Omar E Applicant: Ali, Omar E


Application Typ	рe	
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application type.	
Residential Design Review §185-205 (B)	Build to Line Adjustment §185-17 (B) (2)
Commercial Design Review §185-205 (B)	Building Height Above 30 Feet §185-17 (M)
Signage §185-205 (C)	Corner Lot Orientation §185-17 (K) (3)
Certificate of Appropriateness §185-197	Flag Lot Building Line Location §185-17 (L) (1) (c)
Landmark Designation §185-195 (2)	Undeveloped Flag Lot Requirements §185-17 (L) (2)
Informal Review	


Project Description: Applicant is requesting design review for the construction of approximately a 520 SF addition off the rear of the house.

Meeting Date: March 09, 2023



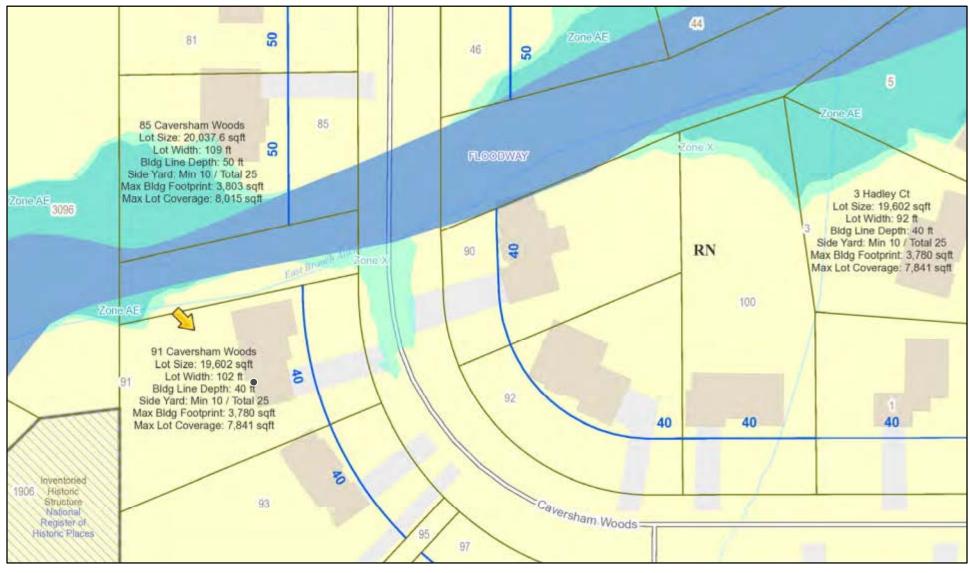

Printed March 1, 2023

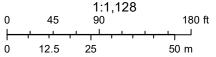

Town of Pittsford GIS

pic



- (I.) BUILDING IS CLASSIFIED AS A ONE FAMILY DWELLING. THE 2020 CODE SHALL PREVAIL AND BUILDING CONTRACTOR IS RESPONSIBLE FOR COMPLIANCE REGARDLESS OF ANY MISSING OR INCOMPLETE DETAILS OR NOTES ON THE DRAWINGS.
- THE 2020 ENERGY CONSERVATION CODE SHALL PREVAIL AND BUILDING CONTRACTOR IS RESPONSIBLE FOR COMPLIANCE REGARDLESS OF ANY MISSING OR INCOMPLETE DETAILS OR NOTES
- BUILDING CONTRACTOR AND HIS SUBCONTRACTORS SHALL CONFORM TO LOCAL CONSTRUCTION ORDINANCES AND SHALL VERIFY ALL DIMENSIONS AND CONDITIONS BEFORE PROCEEDING
- ROOF TRUSS ENGINEERING AND SIZES DETERMINED BY AND ARE THE SOLE RESPONSIBILITY OF THE MANUFACTURER. (MFR)
- (6.) NOTED DIMENSIONS TAKE PRECEDENCE OVER SCALED DIMENSIONS.
- THESE DRAWINGS HAVE BEEN PREPARED FOR DESIGN AND STRUCTURAL REFERENCE ONLY. ELECTRICAL, MECHANICAL, PLUMBING, AND OTHER BUILDING SYSTEMS IF ANY, ARE TO BE PREPARED BY AND ARE THE RESPONSIBILITY OF OTHERS.
- BEARING CAPACITY OF SOIL IS ASSUMED AT 2000 P.S.F. AND CONTRACTOR SHALL VERIFY PRIOR TO PLACEMENT OF FOOTINGS.
- ALLOWABLE STRESSES OF MATERIALS: (THE WEATHERING POTENTIAL FOR CONCRETE IS ASSUMED TO BE SEVERE. SEE
 - A.) CONCRETE (R402.2) MIN. COMPRESSIVE STRENGTH @ 28 DAYS PSI = FOOTINGS: 2500 PSI BASEMENT SLAB: 2500 PSI (W FIBER REINF. ADDITIVE, OPTIONAL) GARAGE & PORCH SLABS: 3500 PSI (AIR-ENTRAINED) BASEMENT WALLS: 3000 PSI (AIR-ENTRAINED WHERE EXPOSED TO WEATHER)
 - POURED CONC. SHALL BE PROTECTED FROM FREEZE/THAW DURING CONST-RUCTION, OR AIR ENTRAINED CONC. MUST BE USED. (TABLE R402.2, NOTE 2.)
 - B.) STRUCTURAL STEEL TO BE ASTM A36
- C.) WOOD JOISTS, BEAMS, HEADERS, AND RAFTERS SHALL HAVE AN EXTREME FIBER STRESS IN BENDING (FB) WITH REPETITIVE MEMBER USE OF 1150 P.S.I. (HEM FIR #2 OR BETTER.) IO.) FIREPLACES SHALL HAVE AN OUTSIDE AIR SOURCE FOR COMBUSTION WITH A DUCT, DAMPER ETC. & SHALL COMPLY WITH CODE SECTION RIOOI-RIO66 AS APPLICABLE.
- SETTING THE BUILDING ELEVATION IS THE RESPONSIBILITY OF THE GENERAL CONTRACTOR AND SHALL COMPLY WITH R403.1.7.3 OF THE CODE.
- THE CONTRACTOR SHALL INSTALL 4" HIGH NUMBERS ON THE FRONT OF THIS BUILDING TO IDENTIFY THE SITE ADDRESS. (SEE SECTION R319.)

- (13.) GLAZING IN DOORS, STORM DOORS, SIDELIGHTS, SHOWER SPACES, AND TUB ENCLOSURES IS DEEMED TO BE HAZARDOUS PER SECTION R308.4 OF THE 2020 CODE AND SHALL BE IDENTIFIED AS SUCH IN COMPLIANCE WITH SECTION R 308.1. DECORATIVE GLASS IS EXEMPT IN SWINGING DOORS AND SIDELIGHTS (SEE SECTION R308.4 FOR ADDITIONAL HAZARDOUS LOCATIONS).
- (14.) DESIGN CRITERIA:
- A.) ROOMS OTHER THAN SLEEPING = 40 PSF LIVE LOAD SLEEPING ROOMS = 30 PSF LIVE LOAD GROUND SNOW LOAD = 40 PSF (FIG R301.2(6)) WIND SPEED - 90 MPH, EXPOSURE B SEISMIC DESIGN CATEGORY - A OR B - R301.2(2) WEATHERING - SEVERE
- TERMITE DAMAGE CONTACT LOCAL JURISDICTION DECAY DAMAGE - NONE TO SLIGHT
- WINTER DESIGN TEMPERATURE (I) DEGREE ICE BARRIER IS REQUIRED ROOF TIE-DOWN REQUIREMENTS - R802.11
- (BASED UPON SPECIFIC ROOF DESIGN) M.) ENERGY COMPLIANCE DETAILS AND PATH - NIIOI.13

FROST LINE DEPTH - 42"

- (15.) FOOTINGS TO BEAR ON FIRM, LEVEL, UNDISTURBED NATURAL SOIL, FREE FROM FROST OR LOOSE MATERIAL
- (16.) DRAWING ALTERATION: THE FOLLOWING IS AN EXCERPT FROM THE N.Y.S. EDUCATION LAW ARTICLE 145. SECTION 7209 AND APPLIES TO THESE DRAWINGS. "IT IS A VIOLATION OF THIS LAW FOR ANY PERSON, UNLESS HE/SHE IS ACTING UNDER THE DIRECT SUPERVISION OF A LICENSED PROFESSIONAL ENGINEER OR ARCHITECT TO ALTER AN ITEM IN ANY WAY. IF AN ITEM BEARING THE SEAL OF AN ENGINEER OR ARCHITECT IS ALTERED, THE ALTERING ENGINEER OR ARCHITECT SHALL AFFIX TO THE ITEM HIS/HER SEAL AND THE NOTATION "ALTERED BY" FOLLOWED BY HIS/HER SIGNATURE AND THE DATE OF SUCH ALTERATION AND A SPECIFIC DESCRIPTION OF THE ALTERATION."
- (17.) WHERE LOCAL EXHAUST OR WHOLE-HOUSE MECHANICAL VENTILATION IS PROVIDED, THE EQUIPMENT SHALL BE DESIGNED IN ACCORDANCE WITH SECTION MISOT OF THE
- (18.) "CODE" SHALL MEAN THE 2020 RESIDENTIAL CODE OF NEW YORK STATE. "ENERGY CONSERVATION CODE" OR "ENERGY CODE" SHALL MEAN CHAPTER II OF THE CODE.
- (19.) TO THE BEST OF MY KNOWLEDGE, BELIEF AND PROFESSIONAL JUDGEMENT, THESE PLANS ARE IN COMPLIANCE WITH THE ENERGY CONSERVATION CODE.

ENERGY CONSERVATION, CHAPTER II, ENERGY EFFICIENCY

- A MINIMUM OF 90 PERCENT OF THE LAMPS IN PERMANENTLY INSTALLED LIGHTING FIXTURES SHALL BE HIGH-EFFICACY LAMPS PER SECTION NIIO4
- RECESSED LUMINARIES INSTALLED IN THE BUILDING THERMAL ENVELOPE SHALL BE SEALED WITH A GASKET OR CAULK BETWEEN THE HOUSING AND THE INTERIOR WALL OR CEILING COVERING TO LIMIT AIR LEAKAGE BETWEEN CONDITIONED AND UNCONDITIONED SPACES PER
- CONTRACTOR TO PROVIDE A PROGRAMMABLE THERMOSTAT TO CONTROL THE HVAC SYSTEM PER SECTION NIIO3.I.I
- 4. ALL DUCTS, AIR HANDLERS, FILTER BOXES SHALL BE SEALED PER SECTION NIIO3.3.2.
- ALL CIRCULATING SERVICE HOT WATER PIPING SHALL BE INSULATED TO AT LEAST R-3. CIRCULATING HOT WATER SYSTEMS SHALL INCLUDE AN AUTOMATIC OR READILY ACCESSIBLE MANUAL SMITCH THAT CAN TURN OFF THE HOT MATER CIRCULATING PUMP WHEN THE SYSTEM IS NOT IN USE. PER SECTION NIIO3.5
- 6. ATTIC ACCESS SHALL BE INSULATED WITH THE SAME R-VALUE AS THE ATTIC, WEATHER-STRIPPED AND LATCHED PER SECTION NIIO2.2.4
- AIR TIGHTNESS AND INSULATION INSTALLATION SHALL BE PER MANUFACTURERS INSTRUCTIONS AND CRITERIA LISTED IN SECTIONS NIIO2.4.1 THROUGH NIIO2.4.6.
- THE STRUCTURE SHALL BE TESTED AND VERIFIED AS HAVING AN AIR LEAKAGE RATE NOT EXCEEDING 3 AIR CHANGES PER HOUR. CONDUCT TEST ACCORDING TO ASTM ET79 OR ASTM E1827 OR NET/ICC 380 AND REPORTED AT A PRESSURE OF 0.2 INCH W.G. COMPLY WITH NIIO2.4.1.2.
- THE CONTRACTORS AND SUB-CONTRACTORS SHALL BE FAMILIAR WITH THE ENERGY CODE AND EXPERIENCED IN PERFORMING WORK THAT COMPLIES WITH ALL ASPECTS OF THE ENERGY CODE. THESE NOTES ARE NOT INTENDED TO BE ALL INCLUSIVE.

TABLE N1102.4.1.1 (402.4.1.1) AIR BARRIER AND INSULATION INSTALLATION

RESIDENTIAL ADDITION

91 CAVERSHAM WOODS PITTSFORD, NY

OMAR AND LINDSAY ALI - OWNERS

ENERGY CODE COMPLIANCE PATH: THIS PROJECT IS DESIGNED TO COMPLY WITH THE "PRESCRIPTIVE" ENERGY CODE COMPLIANCE REQUIREMENTS. CONTRACTOR SHALL PROVIDE AND INSTALL ALL MATERIALS AND COMPONENTS, NECESSARY AND IN A MANNER TO COMPLY WITH THE "PRESCRIPTIVE" REQUIREMENTS SECTION NIIO2 OF THE 2020 ENERGY CODE. CLIMATE ZONE 5A MINIMUM R - MAXIMUM U VALUES FROM TABLE NIIO2.1.2 MAX U VALUE = 0.30 MAX U VALUE = 0.55 MIN R VALUE = 49 SKYLIGHTS CEILING WOOD FRAMED WALLS MIN R VALUE = 20 MIN R VALUE = 30 FLOOR

CLIMATE ZONE 5A EQUIVALENT U-FACTORS FROM TABLE NIIO2.1.4 U-FACTOR = .026 OR MIN R VALUE = 38 U-VALUE & R-VALUE CONVERSION (U=1/R) AND (R=1/U)

BASEMENT WALLS

NIIO2.2.1 CEILINGS WITH ATTIC SPACES. WHERE SECTION NIIO2.1.2 WOULD REQUIRE R-49 INSULATION IN THE CEILING, INSTALLING R-38 OVER 100 PERCENT OF THE CEILING AREA REQUIRING INSULATION SHALL BE DEEMED TO SATISFY THE REQUIREMENT FOR R-49 INSULATION WHEREVER THE FULL HEIGHT OF UNCOMPRESSED R-38 INSULATION EXTENDS OVER THE WALL TOP PLATE AT EAVES. THIS REDUCTION SHALL NOT APPLY TO THE U-FACTOR ALTERNATIVE APPROACH IN SECTION NIIO2.1.4 AND THE TOTAL UA ALTERNATIVE IN SECTION NIIO2.1.5.

MIN R VALUE = 15 (CONTINUOUS)


GENERAL NOTES

- CONTRACTOR SHALL COMPLY WITH ALL STATE AND LOCAL CODES WHICH PERTAIN TO THE CONSTRUCTION OF THIS STRUCTURE
- CONTRACTOR SHALL VERIFY EXISTING STRUCTURAL O CONDITIONS AND DIMENSIONS PRIOR TO DEMOLITION AND / OR CONSTRUCTION

PINNING OF EXISTING STRUCTURE AS REQUIRED


- CONTRACTOR SHALL PROVIDE ANY NECESSARY BRACING, TEMPORARY FRAMING SUPPORTS (SHORING), AND UNDER-
- CONTRACTOR SHALL CO-ORDINATE THE INSTALLATION OF NEW AND / OR USE OF RELOCATED DOORS, AND
- WINDOWS WITH HOMEOWNER
- CONTRACTOR SHALL (WHERE POSSIBLE) MATCH PLATE O HEIGHTS, SUBFLOORS, AND WINDOW ROUGH OPENING HEIGHTS TO MAINTAIN CONTINUITY
- WHERE POSSIBLE MATCH CONCRETE BLOCK COURSES
- AT NEW AND EXISTING FOUNDATION WALLS MINIMUM GRADE COVER AT ALL CONCRETE FOOTINGS SHALL BE 3'-6"
- INFILL EXISTING EXPOSED EXTERIOR FRAMING CAVITIES FULL WITH INSULATION
- CONTRACTOR NOTE: IF EXISTING CONDITIONS DIFFER FROM PLANS CONTRACTOR IS TO CONTACT CARINI ENGINEERING DESIGNS, P.C.


SYMBOLS

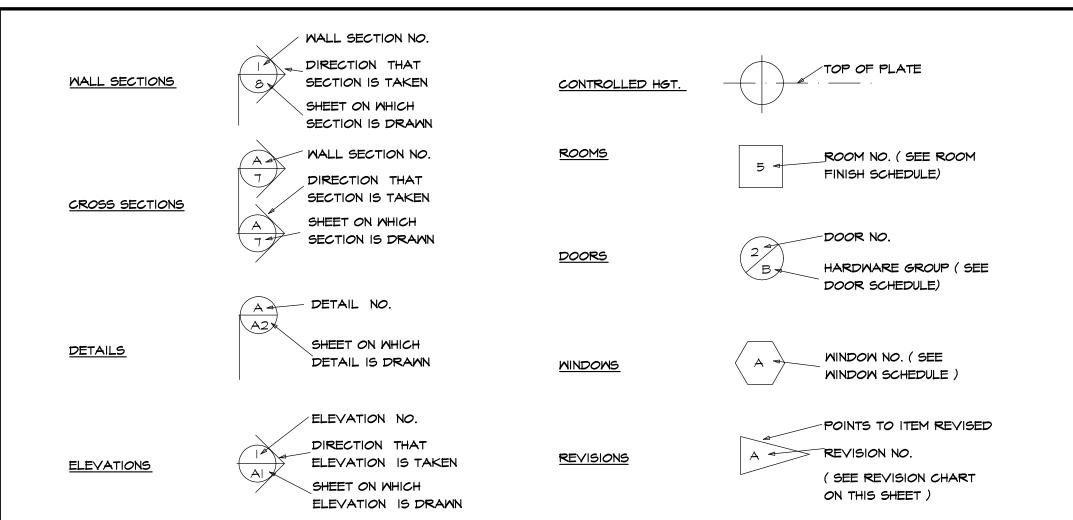

ABBREVIATIONS

APPROX	-APPROXIMATE	FT (')	-F00T	OPNG	-OPENING
\$	-AND	FT6	-FOOTING	O/A	-OVERALL
@	-AT	FDN	-FOUNDATION	O.H.D	-OVERHEAD DOOR
вм	-BEAM	GYP	-GYPSUM	O/ HANG	-OVERHANG
BLK	-BLOCK	HND'CP	-HANDICAP	0/	-OVER
BD	-BOARD	HGT	-HEIGHT	OPT	-OPTIONAL
BLDG	-BUILDING	HM	-HOT WATER	P.D.R	-POWDER ROOM
BTR	-BETTER	HDR	-HEADER	PSF	-POUNDS PER SQ. FT
CLG	-CEILING	IN (")	-INCH	PS I	-POUNDS PER SQ. IN
CL	-CENTERLINE	INCL	-INCLUDE	P.T.	-PRESSURE TREATED
COL	-COLUMN	INFO	-INFORMATION	PLY'WD	-PLYWOOD
CONC	-CONCRETE	ID	-INSIDE DIAMETER	REQ'D	-REQUIRED
CONT	-CONTINUOUS	INSUL	-INSULATION	RM	-ROOM
COMM	-COMMERCIAL	INT	-INTERIOR	RES	-RESIDENTIAL
CRS	-COURSES	IECC	-INTERNATIONAL ENERGY	R'S	-RISERS
DL	-DEAD LOAD		CONSERVATION CODE	RD & SH	-ROD & SHELF
DIA	-DIAMETER	JT	-JOINT	s	-SOUTH
DBL	-DOUBLE	JSTS	-JOISTS	SKY'LT	-SKYLIGHT
DN	-DOWN	LT	-LIGHT	SH	-SHELF
DMG	-DRAWING	LL	-LIVE LOAD	SH'S	-SHELVES
DIM	-DIMENSION	MFR	-MANUFACTURER	STOR	-STORAGE
ELEC	-ELECTRIC	MAX	-MAXIMUM	STL	-STEEL
EXP	-EXPANSION	MECH	-MECHANICAL	SUSP	-SUSPENDED
EXT	-EXTERIOR	MTL	-METAL	SYN	-SYNTHETIC
FT (')	-FEET	MIN	-MINIMUM	T'S	-TREADS
FIN	-FINISH	MISC	-MISCELLANEOUS	(TYP)	-TYPICAL
FLR	-FLOOR	N	-NORTH	T# <i>G</i>	-TONGUE & GROOVE
IST	-FIRST	NTS	-NOT TO SCALE	W	-WITH
FLUOR	-FLUORESCENT	NO	-NUMBER	Wo	-WITHOUT

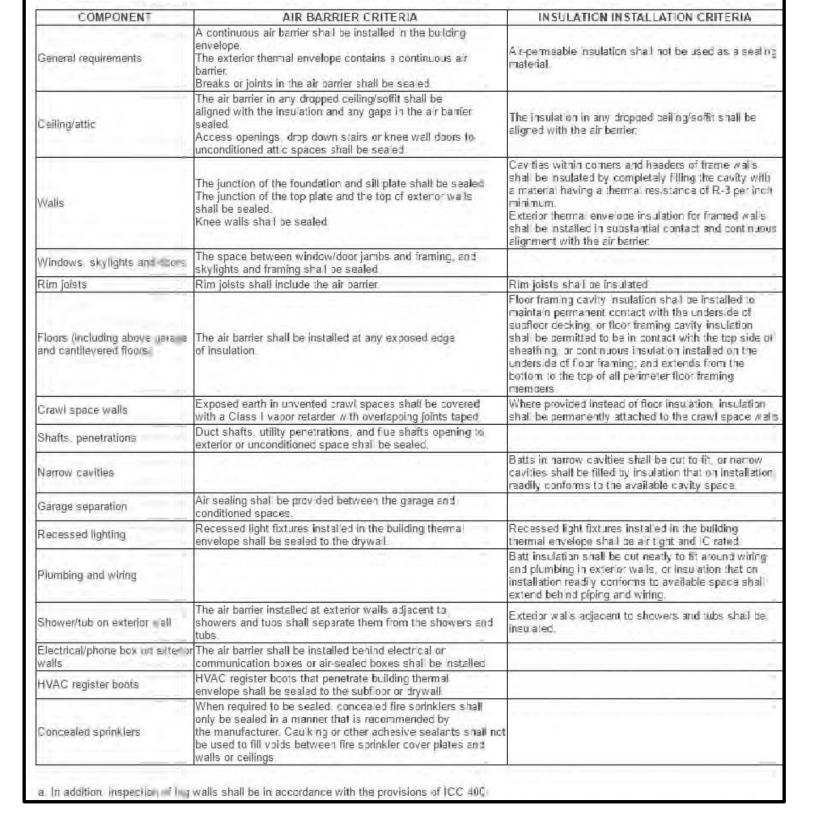

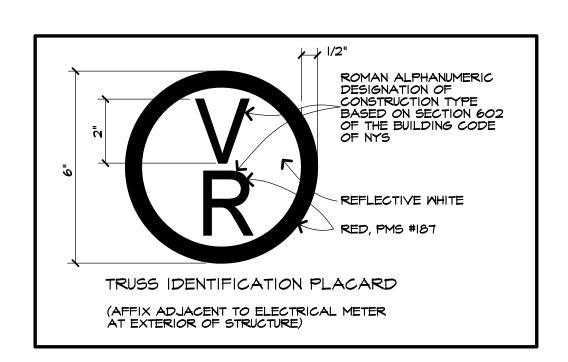



STEVEN L. CARINI, P.E.

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Also doing business as DW/EL

@theFingerLakes LIVE WELL, DO WELL. 61 NORTH MAIN STREET

CANANDAIGUA, NY 14424

PH. 585-223-5687

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These plans comply with the 2020 code. © COPYRIGHT 2023

RESIDENTIAL ADDITION

OMAR & LINDSAY ALI

Job Location: 91 CAVERSHAM WOODS

PITTSFORD, NEW YORK


COVER SHEET & NOTES

TJM / SMK

JANUARY 2023 38707

Of



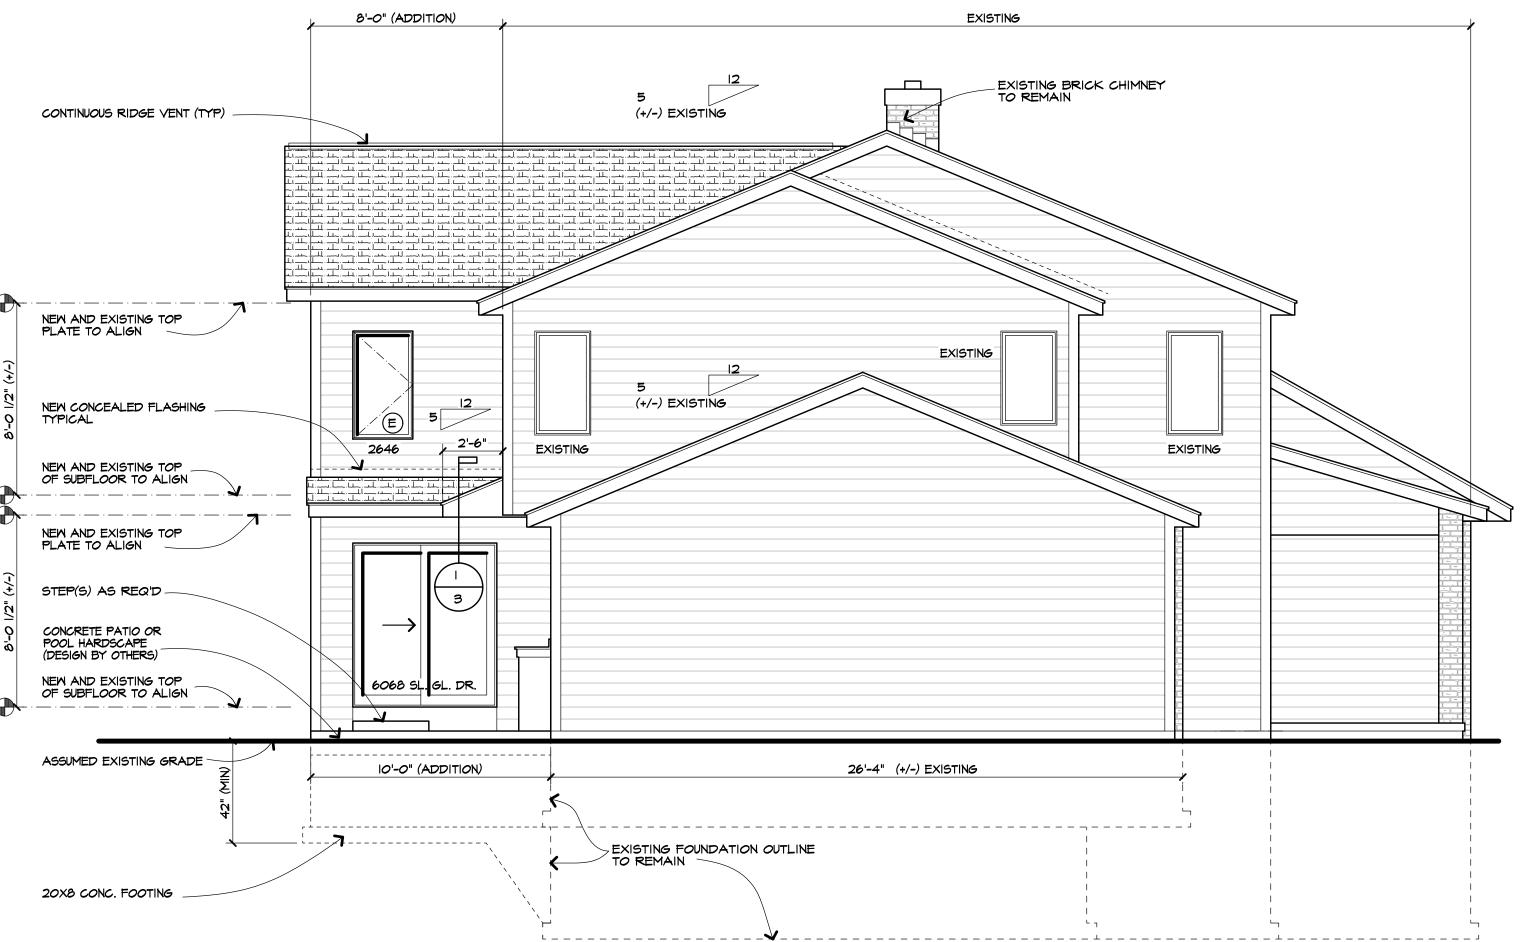

ADDITION AND EXISTING

SCALE: 1/4" = 1'-0"

LEFT SIDE ELEVATION

FRONT ELEVATION

SCALE: 1/4" = 1'-0"

NO CHANGES ARE PROPOSED
FOR THIS ELEVATION

UNLESS OTHERWISE NOTED ROOFING: ASPHALT / FIBERGLASS SHINGLES AS SEL'TD ROOF VENTING: ONE SQ.FT NET PER 300 SQ. FT. ATTIC SPACE (PER EXCEPTION IN R806.2 OF THE CODE.) FACIA: ALUM WRAP 2X6 FRIEZEBOARDS: CORNERBOARDS: CASINGS: SIDING: EAVE O/HANGS: 1'-0" RAKE O/HANGS: FOOTING DEPTH: 3'-6" BELOW GRADE PLATE HEIGHT: FIRST FLOOR: 8'-0 1/2" (+/-) MATCH EXIST. SECOND FLOOR: 8'-0 1/2" (+/-) MATCH EXIST. MINDOM R.O. HEIGHT: FIRST FLOOR: 6'-10 1/2" SECOND FLOOR: 6'-10 1/2" " ANDERSEN 100 " WINDOW MFR: W/ LOW E

MINDOM SUPPLIER TO VERIFY MINDOM MILL MEET THE FOLLOMING CRITERIA:
CLEAR OPENING MIDTH SHALL BE 20"
OR GREATER, CLEAR OPENING HEIGHT SHALL BE 24" OR GREATER, AND NET CLEAR OPENING SHALL BE 5.7 SQ. FT OR GREATER.
THE BOTTOM EDGE OF THE CLEAR OPENING SHALL BE NOT GREATER THAN 44" MEASURED FROM THE FLOOR



STEVEN L. CARINI, P.E.

1387 FAIRPORT ROAD SUITE #560 FAIRPORT, NY 14450–2002 PH. (585) 223–6420

www.carinidesigns.com

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These plans comply with the 2020 code.

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Revisions:

ect:
RESIDENTIAL ADDITION

OMAR & LINDSAY ALI

Job Location:

91 CAVERSHAM WOODS PITTSFORD, NEW YORK

Drawing Title:

ELEVATIONS


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JANUARY 2023

Job No.


| 38707| | Sheet

2 of **7**

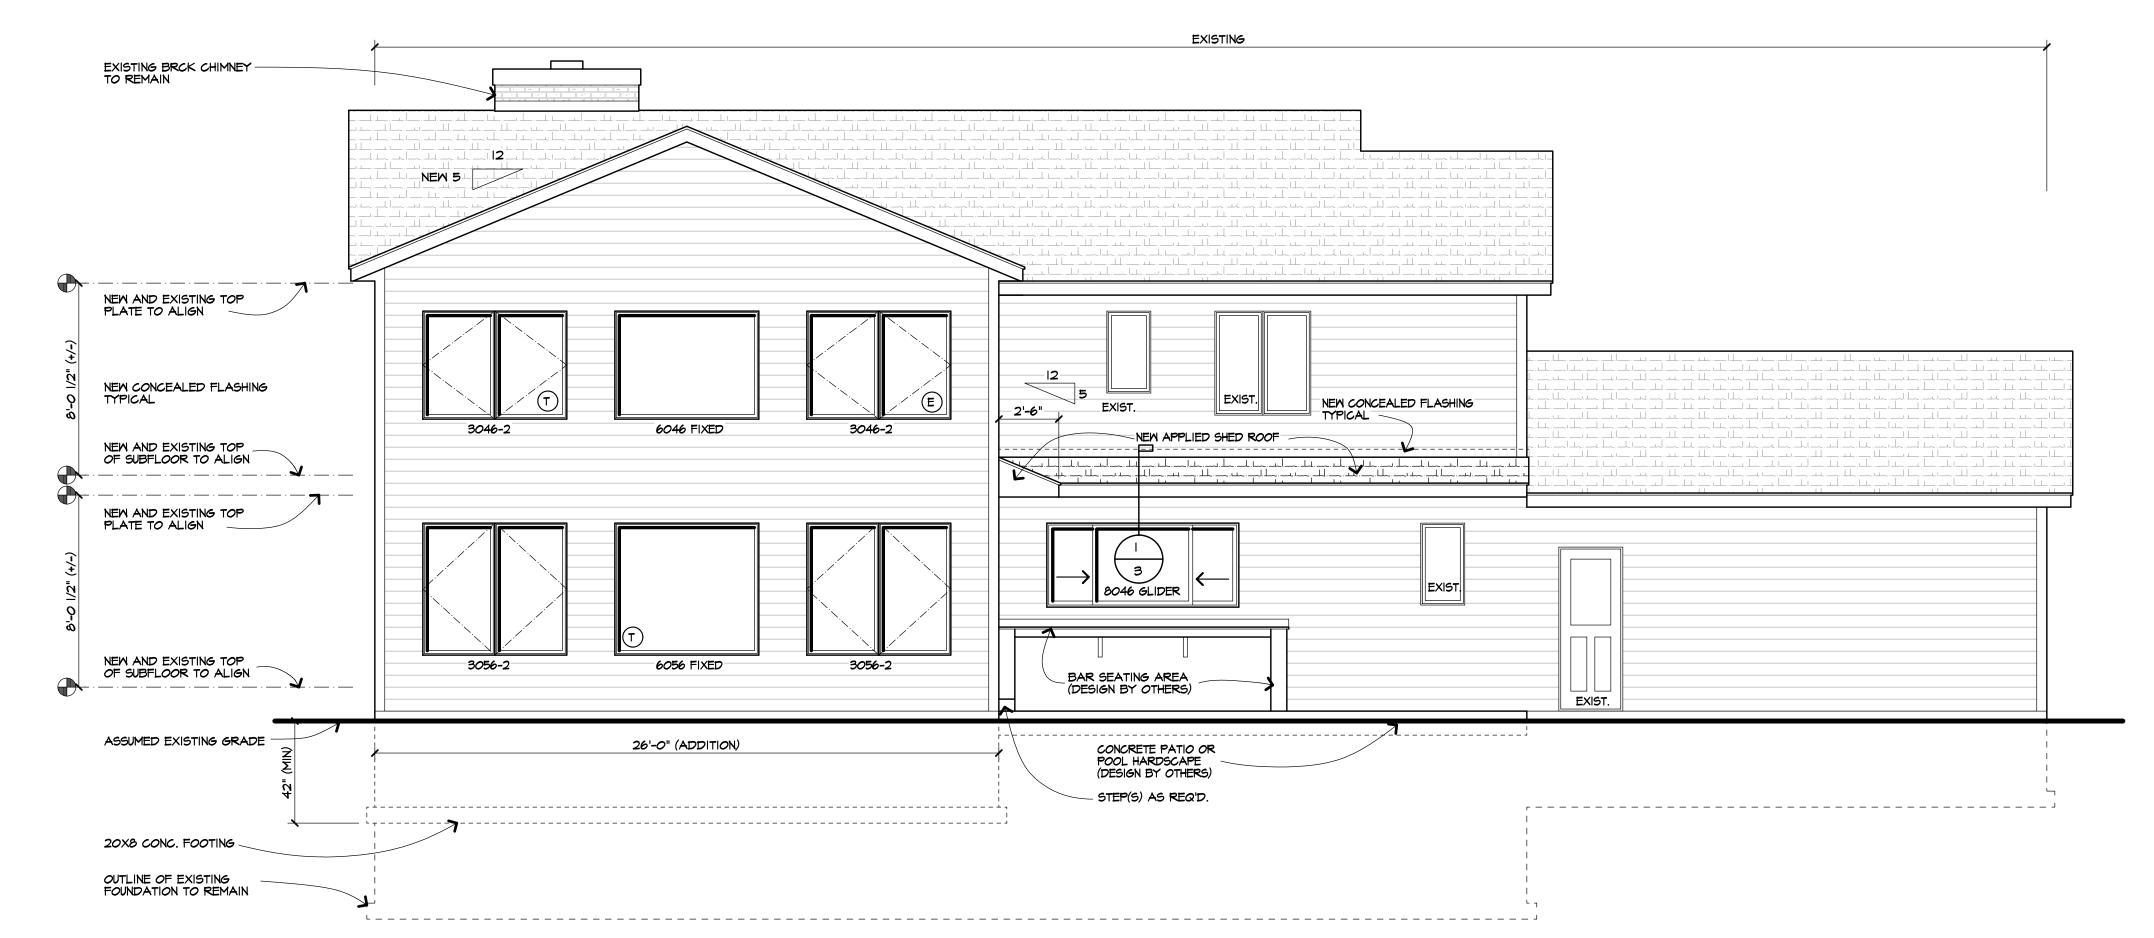

REAR ELEVATION

SCALE: 1/4" = 1'-0"

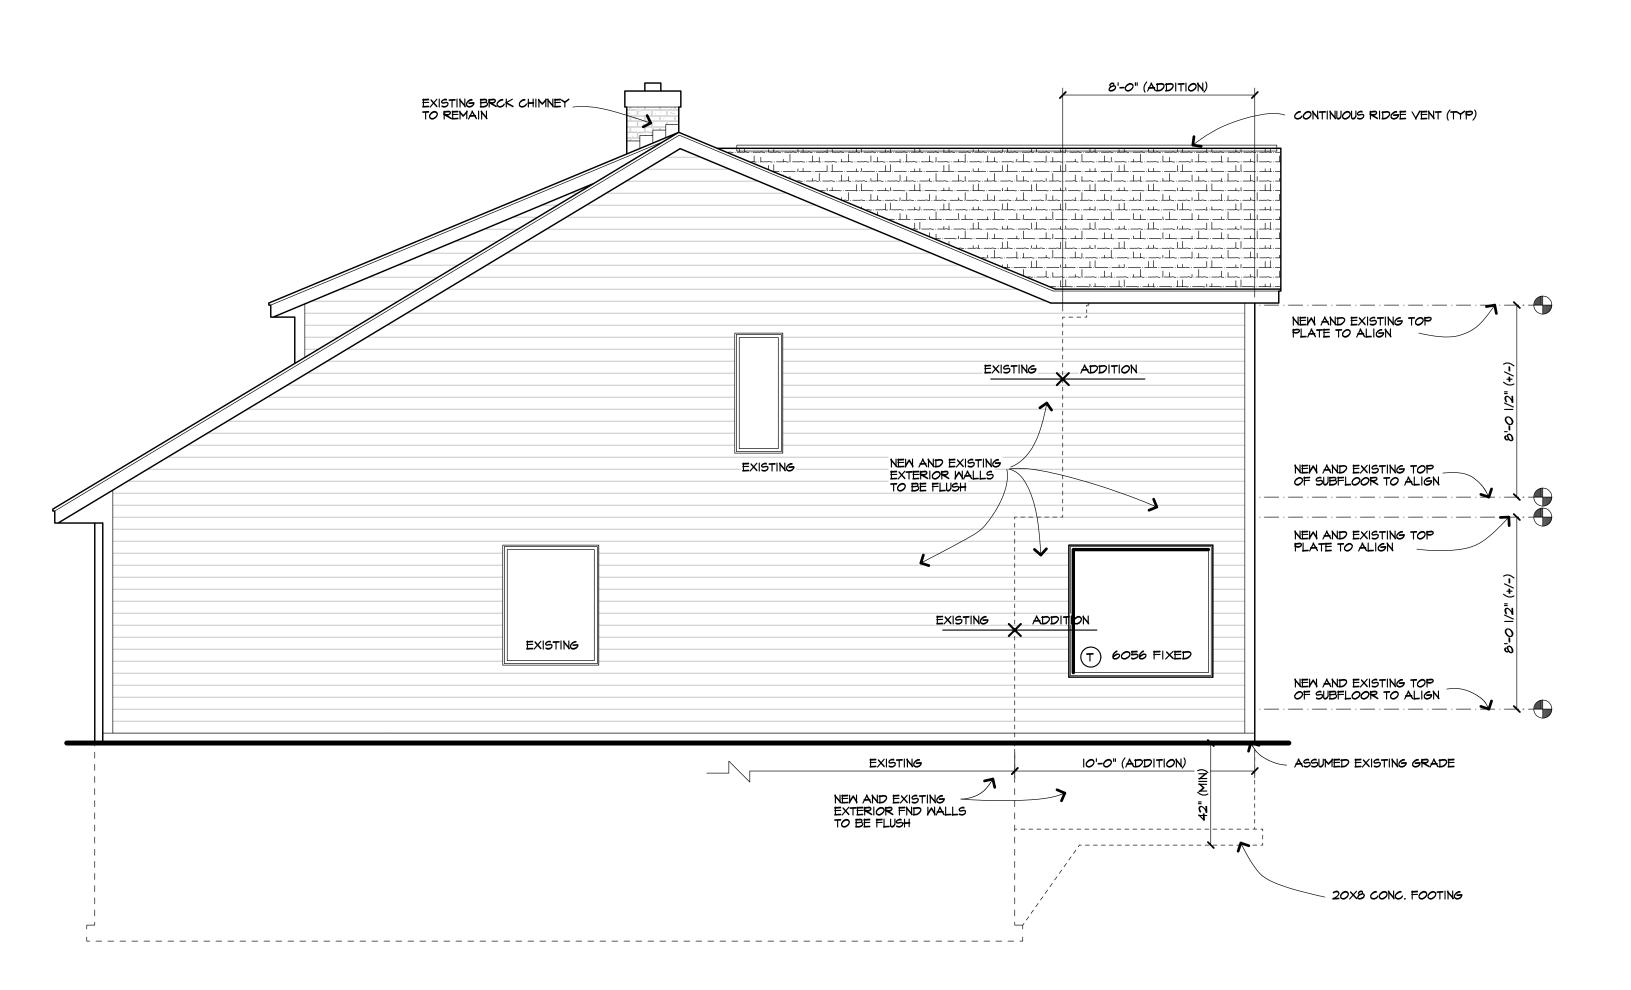

UNLESS OTHERWISE NOTED ROOFING: ASPHALT / FIBERGLASS SHINGLES AS SEL'TD ROOF VENTING: ONE SQ.FT NET PER 300 SQ. FT. ATTIC SPACE (PER EXCEPTION IN R806.2 OF THE CODE.) FACIA: ALUM WRAP 2X6 FRIEZEBOARDS: CORNERBOARDS: CASINGS: SIDING: EAVE O/HANGS: RAKE O/HANGS: FOOTING DEPTH: 3'-6" BELOW GRADE PLATE HEIGHT: FIRST FLOOR: 8'-0 1/2" (+/-) MATCH EXIST. SECOND FLOOR: 8'-0 1/2" (+/-) MATCH EXIST. MINDOW R.O. HEIGHT: FIRST FLOOR: 6'-10 1/2" SECOND FLOOR: 6'-10 1/2" WINDOW MFR: " ANDERSEN 100"

W/ LOW E CONCEALED METAL FLASHING NEW 2X8 LEDGER ANCHORED TO EXISTING SHEATHING AND STUDS — W (2) 4 1/2" FLATLOK FASTENERS INTO EACH STUD "SIMPSON" LRU28Z HANGERS (FASTENERS, (6) 0.148X3" NAILS INTO LEDGER (5) 0.148X3" NAILS INTO RAFTERS) ROOFING AS SELECTED -2X6 RAFTERS AT 24" O.C. METAL DRIP EDGE 2X6 SOFFIT MEMBERS AT 24" O.C. NEW 2X6 LEDGER SPIKED BAND JOIST W/ (2) #16 D NAILS EVERY 16" O.C. ANCHOR TO EXISTING SHEATHING AND STUDS W (2) 4 1/2" FLATLOK FASTENERS INTO EA. STUD IF BAND JOIST NOT PRESENT APPLIED ROOF DETAIL SCALE: 3/4" = 1'-0" SEE TYPICAL SECTION FOR WALL AND FLOOR SPECIFICATIONS NOTE:
WALL / FLOOR ASSEMBLY SHOWN MAY VARY PER ROOF
CONNECTION LOCATION.
ATTACH ROOF MEMBERS TO WALL / FLOOR ASSEMBLY
AS SPECIFIED PER LOCATION

WINDOW SUPPLIER TO VERIFY WINDOW
WILL MEET THE FOLLOWING CRITERIA:
CLEAR OPENING WIDTH SHALL BE 20"
OR GREATER, CLEAR OPENING HEIGHT
SHALL BE 24" OR GREATER, AND NET
CLEAR OPENING SHALL BE 5.7 SQ. FT
OR GREATER.
THE BOTTOM EDGE OF THE CLEAR
OPENING SHALL BE NOT GREATER
THAN 44" MEASURED FROM THE FLOOR

TEMPERED GLASS REQUIRED PER R308 OF N.Y.S. BUILDING CODE

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DESIGNS, P.C.

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These plans comply with the 2020 code.

prosecuted.

Education Law for any person, unless acting under the direction of a licensed Engineer to alter any item in these

agreement with the following:

or safety during construction.

Revisions:

RESIDENTIAL ADDITION

OMAR & LINDSAY ALI

lent:

Job Location:

91 CAVERSHAM MOODS PITTSFORD, NEW YORK

ELEVATIONS


Job No.

^{66 No.} 38707

3 of 7

RIGHT SIDE ELEVATION

SCALE: 1/4" = 1'-0"

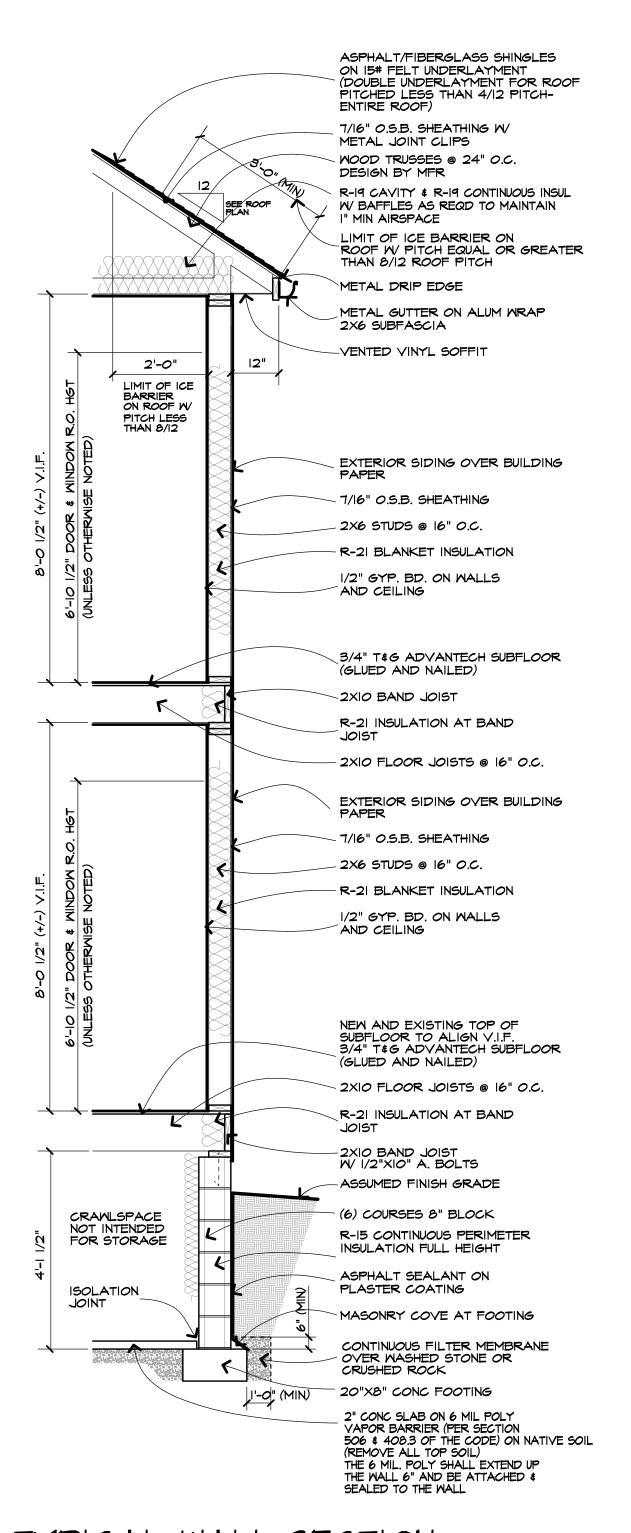


TYPICAL WALL SECTION

SCALE: 1/2" = 1'-0"

"SIMPSON" H2.5A AT EVERY TRUSS / TOP PLATE CONNECTION


"SIMPSON" LGT 2. OR 3 OR 4 FOR 2 OR 3 OR 4 PLY GIRDER TRUSSES

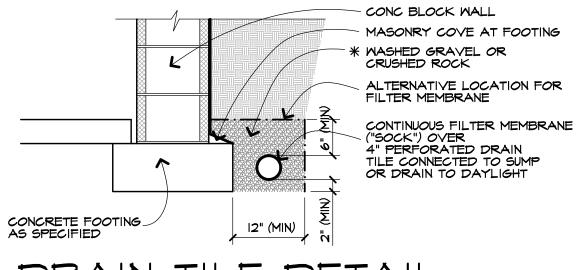

DRAIN TILE DETAIL

SCALE: 3/4" = 1'-0"

* WASHED GRAVEL OR CRUSHED ROCK SHALL NOT BE LESS THAN ONE SIEVE SIZE LARGER THAN THE TILE JOINT OPENING OR PERFORATION.

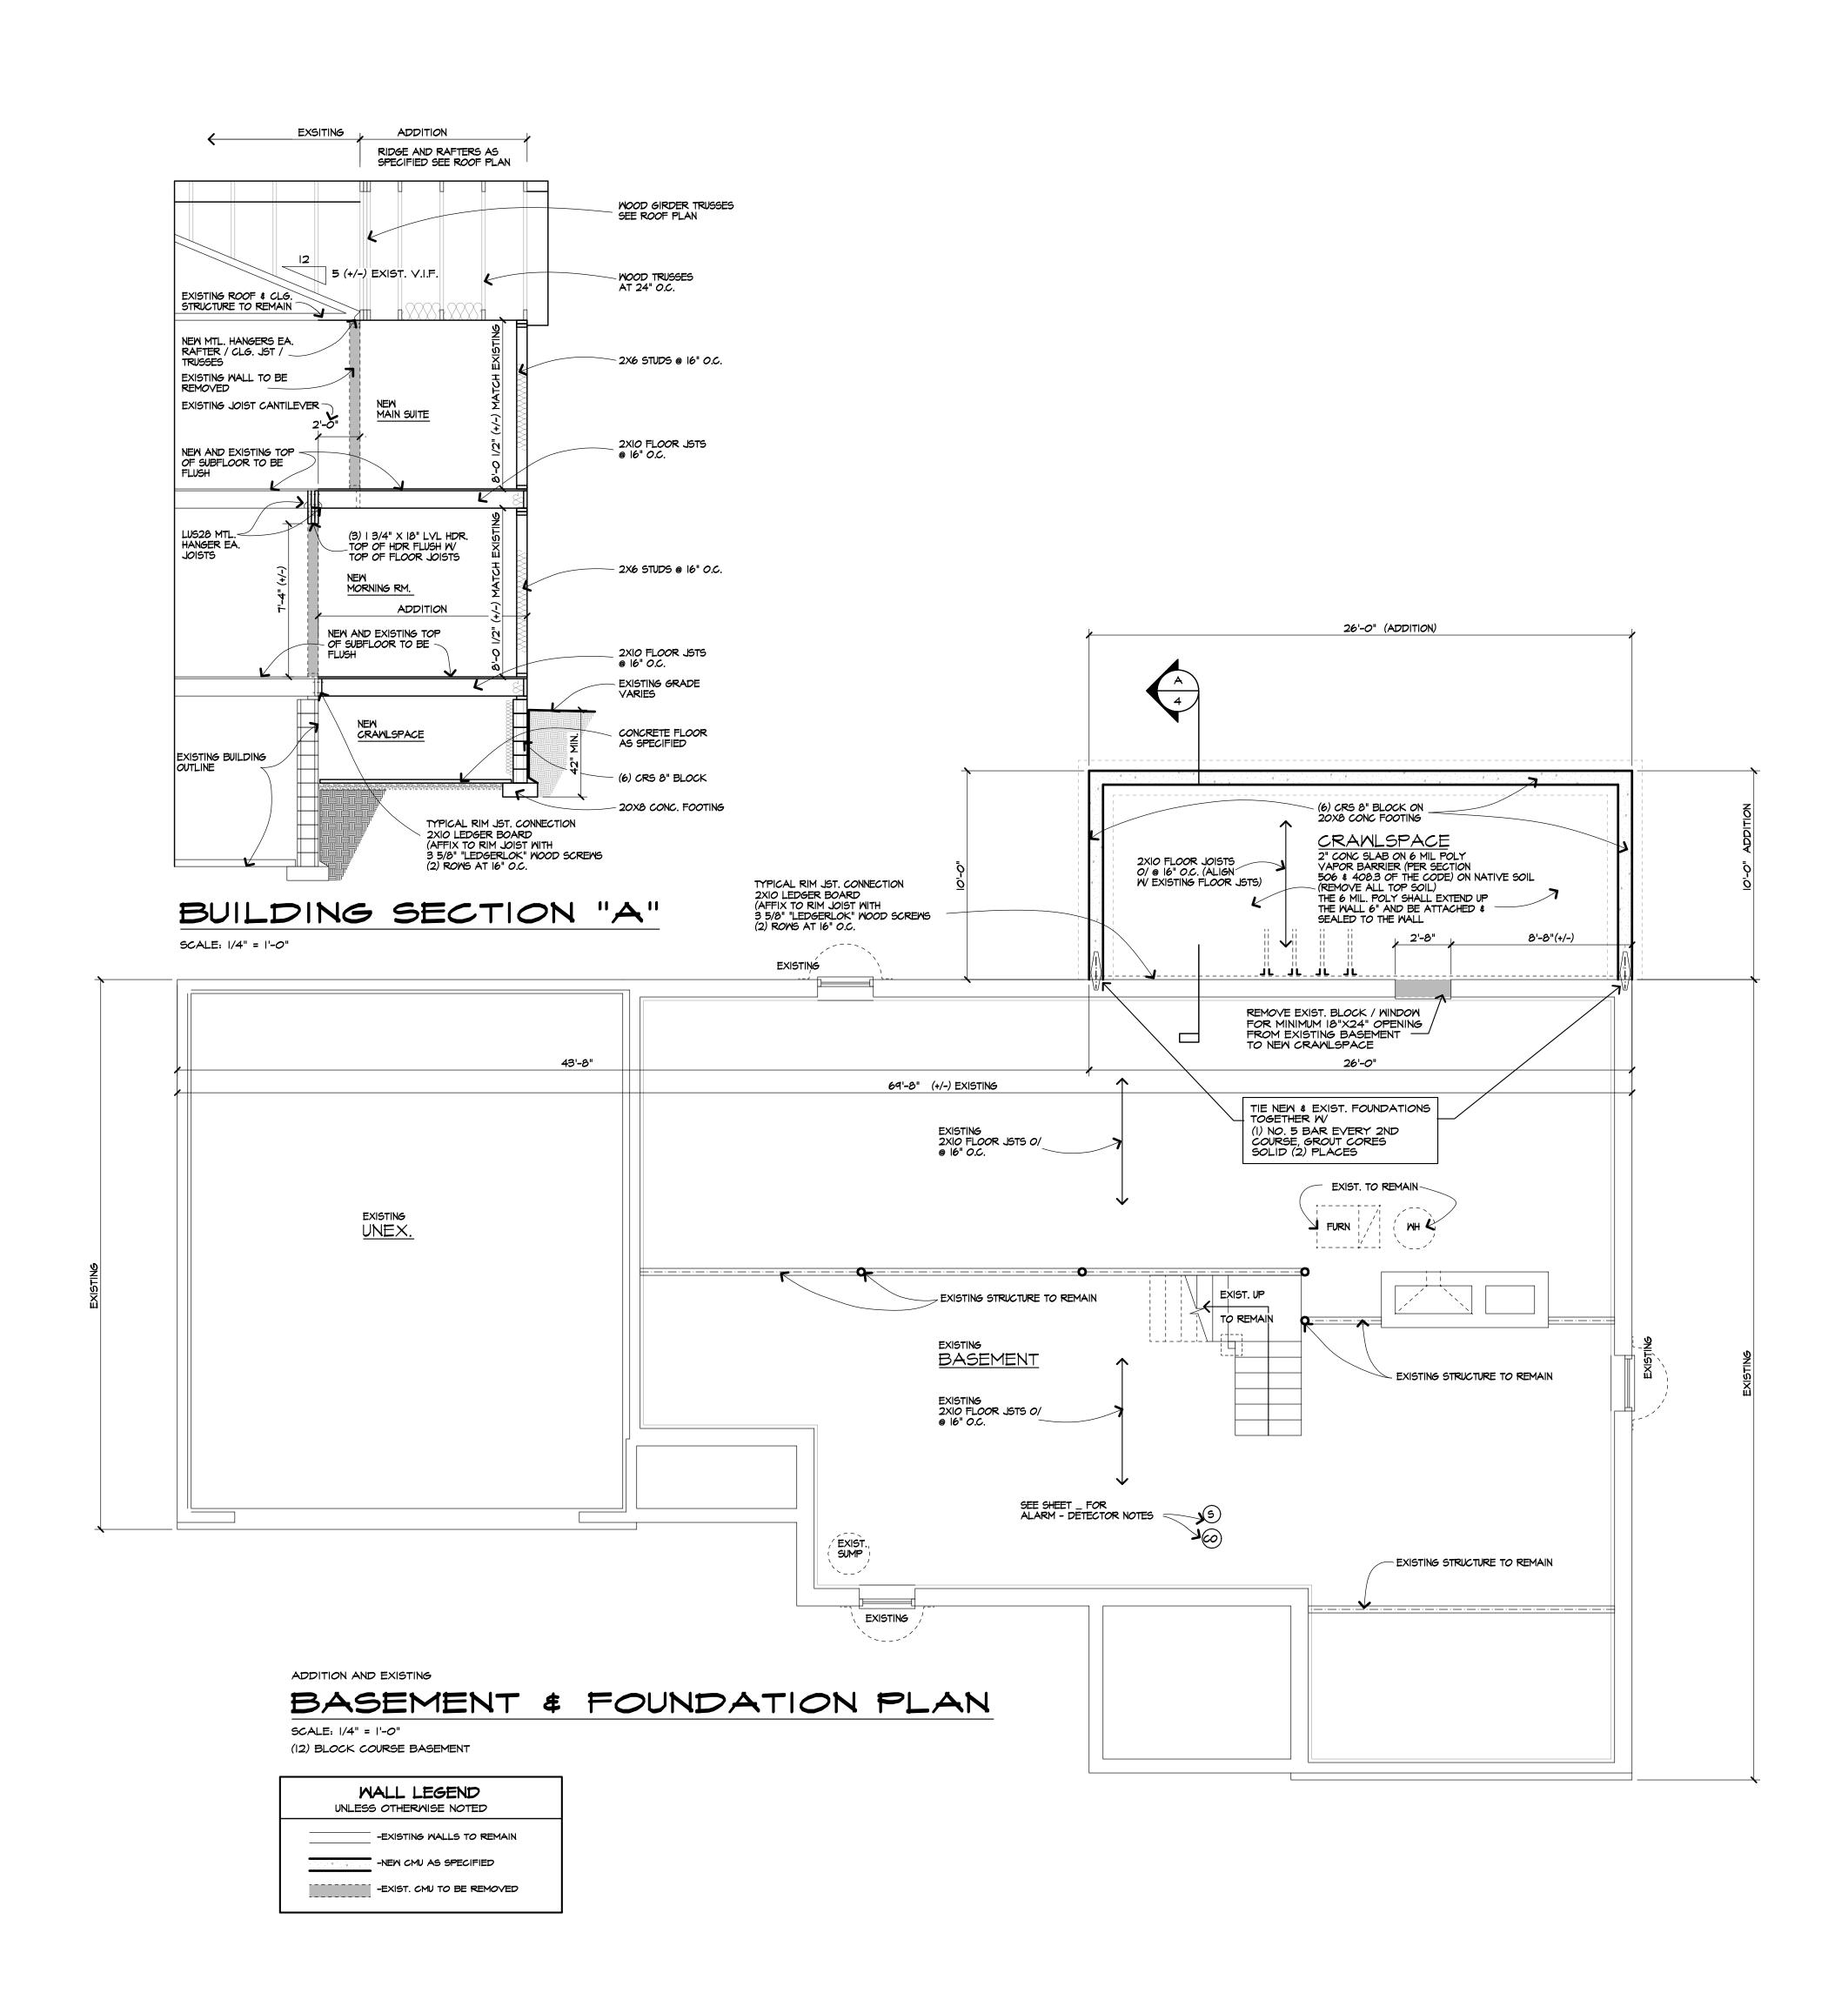



STEVEN L. CARINI, P.E.

1387 FAIRPORT ROAD SUITE #560 FAIRPORT, NY 14450-2002 PH. (585) 223-6420

www.carinidesigns.com

Also doing business as

OMELL

@theFingerLakes

61 NORTH MAIN STREET CANANDAIGUA, NY 14424 PH. 585-223-5687

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CONSTRUCTION

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OMAR & LINDSAY ALI

Job Location:

91 CAVERSHAM WOODS PITTSFORD, NEW YORK

Drawing Title:
BASEMENT PLAN

SECTIONS


Drawn
TJM / SMK

Date

JANUARY 2023

^{∞ №} 38707

4 of 7

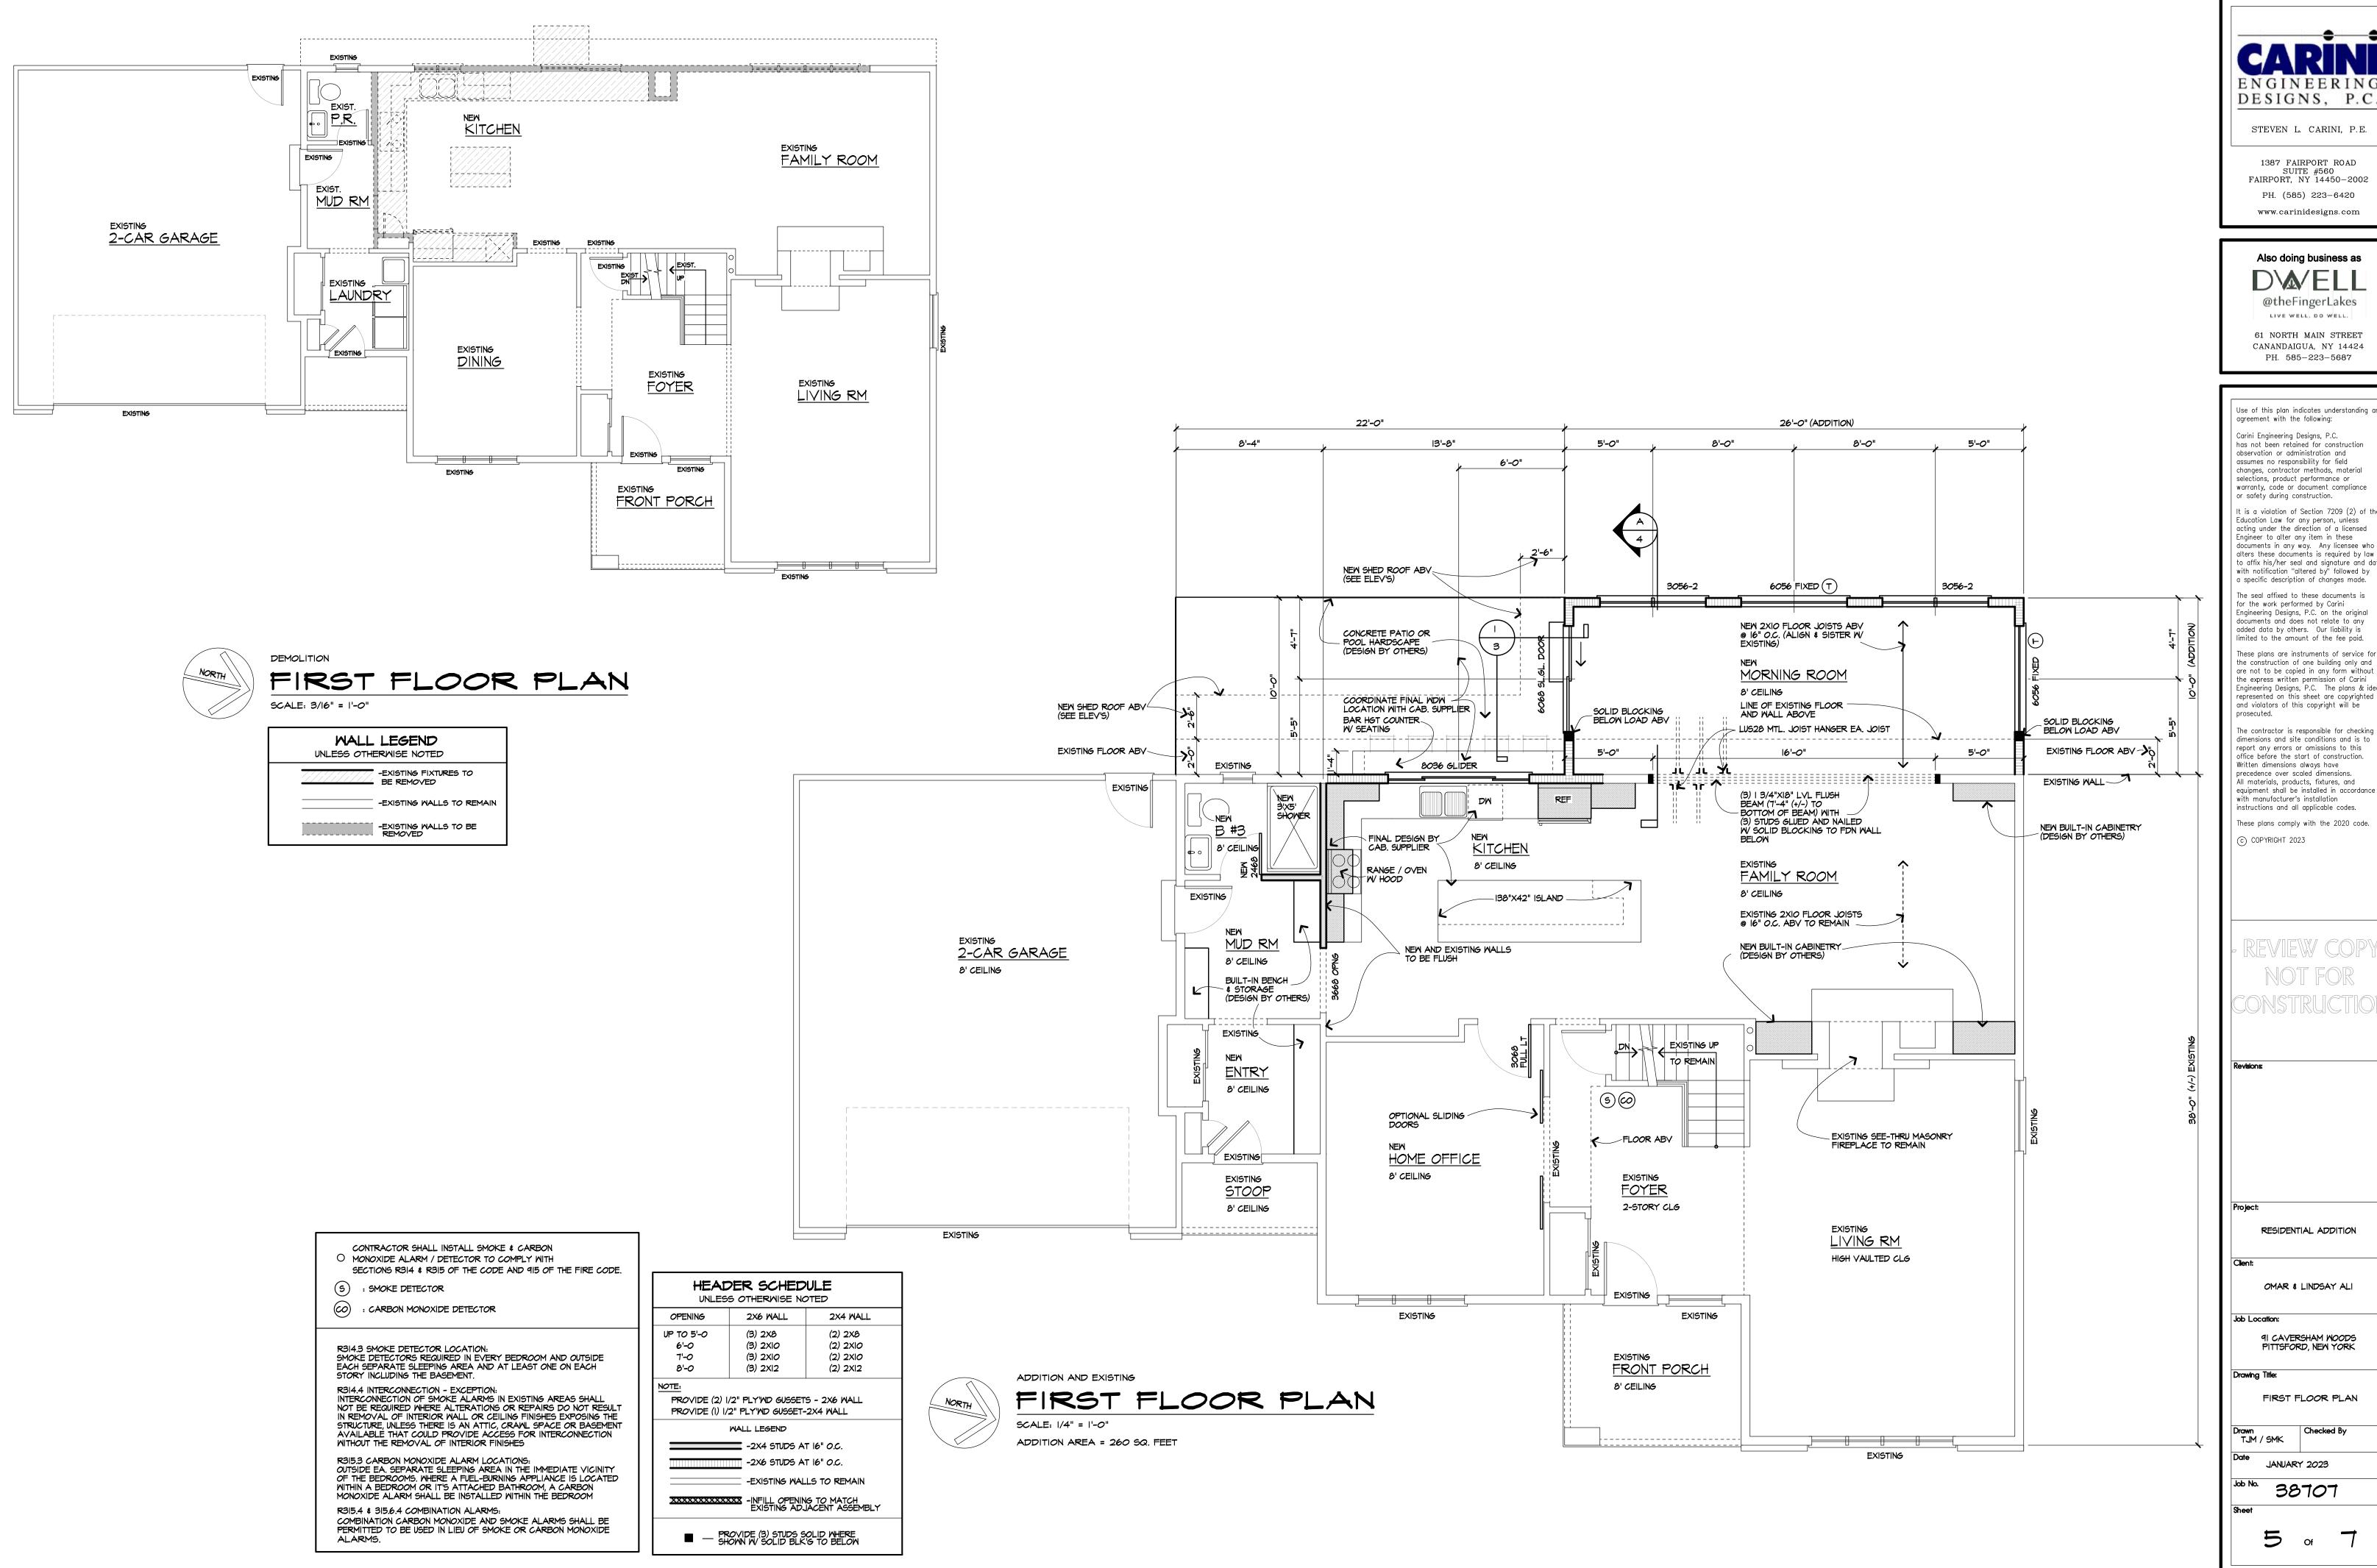



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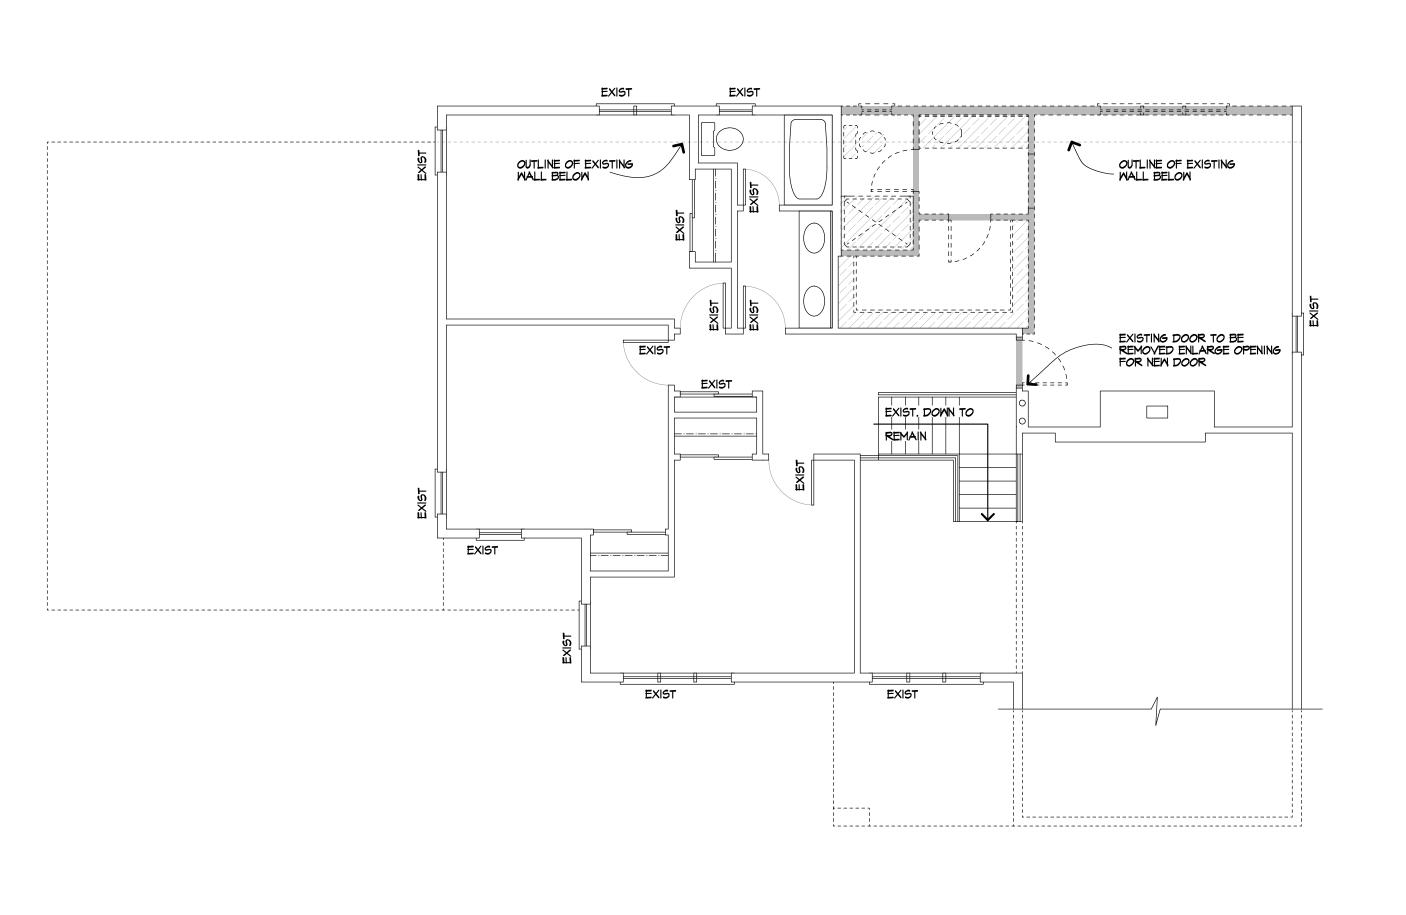
Job Location: 91 CAVERSHAM WOODS PITTSFORD, NEW YORK

FIRST FLOOR PLAN

Drawn TJM / SMK JANUARY 2023

38707


Of





SECOND FLOOR PLAN

SCALE: 3/16" = 1'-0"

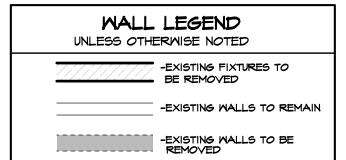

CONTRACTOR SHALL INSTALL SMOKE & CARBON O MONOXIDE ALARM / DETECTOR TO COMPLY WITH SECTIONS R314 & R315 OF THE CODE AND 915 OF THE FIRE CODE. S : SMOKE DETECTOR

: CARBON MONOXIDE DETECTOR


SMOKE DETECTORS REQUIRED IN EVERY BEDROOM AND OUTSIDE EACH SEPARATE SLEEPING AREA AND AT LEAST ONE ON EACH STORY INCLUDING THE BASEMENT.

R314.4 INTERCONNECTION - EXCEPTION: INTERCONNECTION OF SMOKE ALARMS IN EXISTING AREAS SHALL NOT BE REQUIRED WHERE ALTERATIONS OR REPAIRS DO NOT RESULT IN REMOVAL OF INTERIOR WALL OR CEILING FINISHES EXPOSING THE STRUCTURE, UNLESS THERE IS AN ATTIC, CRAWL SPACE OR BASEMENT AVAILABLE THAT COULD PROVIDE ACCESS FOR INTERCONNECTION WITHOUT THE REMOVAL OF INTERIOR FINISHES

R315.3 CARBON MONOXIDE ALARM LOCATIONS: OUTSIDE EA. SEPARATE SLEEPING AREA IN THE IMMEDIATE VICINITY OF THE BEDROOMS. WHERE A FUEL-BURNING APPLIANCE IS LOCATED WITHIN A BEDROOM OR IT'S ATTACHED BATHROOM, A CARBON MONOXIDE ALARM SHALL BE INSTALLED WITHIN THE BEDROOM

R315.4 \$ 315.6.4 COMBINATION ALARMS: COMBINATION CARBON MONOXIDE AND SMOKE ALARMS SHALL BE PERMITTED TO BE USED IN LIEU OF SMOKE OR CARBON MONOXIDE ALARMS.

HEADER SCHEDULE UNLESS OTHERWISE NOTED			
OPENING	2X6 WALL	2X4 WALL	
UP TO 5'-0	(3) 2×8	(2) 2X8	
6'-0	(3) 2XIO	(2) 2XIO	
7'-0	(3) 2XIO	(2) 2XIO	
8'-0	(3) 2XI2	(2) 2XI2	
PROVIDE (2) 1/2" PLY'WD GUSSETS - 2X6 WALL PROVIDE (1) 1/2" PLY'WD GUSSET-2X4 WALL			
MALL LEGEND			
-2X6 STUDS AT 16" O.C.			
-EXISTING WALLS TO REMAIN			

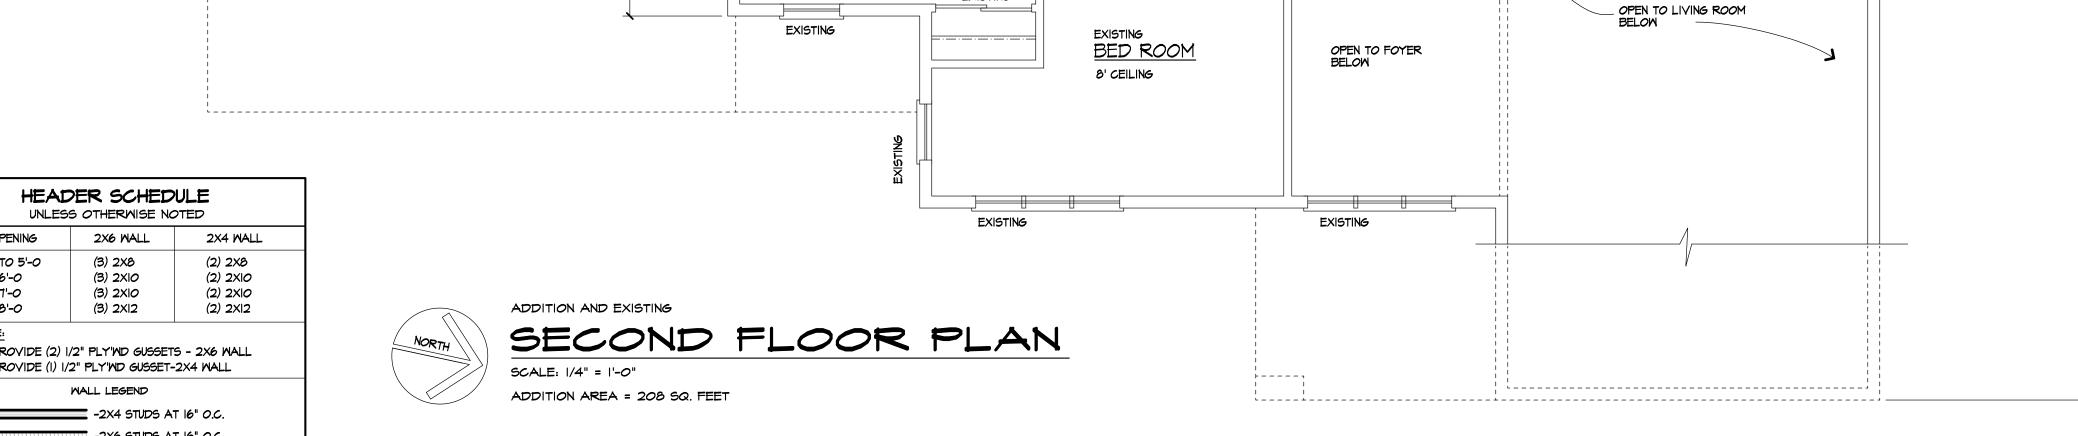

EXISTING

EXISTING

22'-0"

EXISTING

BED ROOM

8' CEILING

EXISTING

8' CEILING

BED ROOM

48'-0" (+/-) EXISTING

5'-0"

2-3046

EXISTING

EXISTING

8' CEILING

EXISTING (S)

HALLMAY

8' CEILING

<u>B #2</u>

EXISTING

_ . _ . _ . _ . _ . _ . _ . _ . _ . _

EXISTING

NEW WOOD TRUSSES 0/@ 24" O.C.

NEW (4) 2X6 STUDS SOLID BELOW GIRDER

MIRROR O/ 90" VANITY (DESIGN BY CAB/ SUPPLIER)

FUR WALL AS REQUIRED TO ALIGN W/NEW EXTERIOR WALL

EXISTING ROOF AND CEILING STRUCTURE ABOVE TO REMAIN

EXISTING DOWN

TO REMAIN

MAIN SUITE

8' CEILING

NEW MOOD GIRDER TRUSSES ABV SEE ROOF PLAN

16'-6"

8'**-**0"

26'-0" (ADDITION)

6046 FIXED

9'-6"

60"X32" FREE-STANDING
TUS AS SELECTED

2-3046

ROD & SHELF

8' CEILING

NEW BUILT-IN CABINETRY (DESIGN BY OTHERS)

3'-0"

WALK-IN CLOSET

HOME OFFICE

8' CEILING

8' CEILING

5'-0"

INSTALL R-21 UN-FACED INSUL AT TUB / SHWR WALLS W 6 MIL POLY V.B. TO CONFORM TO N 1102.4 OF THE CODE

(TYP) OF TUBS AND SHOWERS AT OUTSIDE WALLS

NEW BUILT-IN CABINETRY

NEW (4) 2X6 STUDS SOLID BELOW GIRDER

NEW 22"X30" ATTIC 9
ACCESS ABV. W (2) 2X6 4
HDR SURROUND

STACKED LAUNDRY
APPLIANCES AS SEL'TD
(36"X36" DRAIN PAN
BELOW)

(DESIGN BY OTHERS)

GLASS PANEL PER

CUSTOM WALK-IN SHOWER

ALLOWANCE



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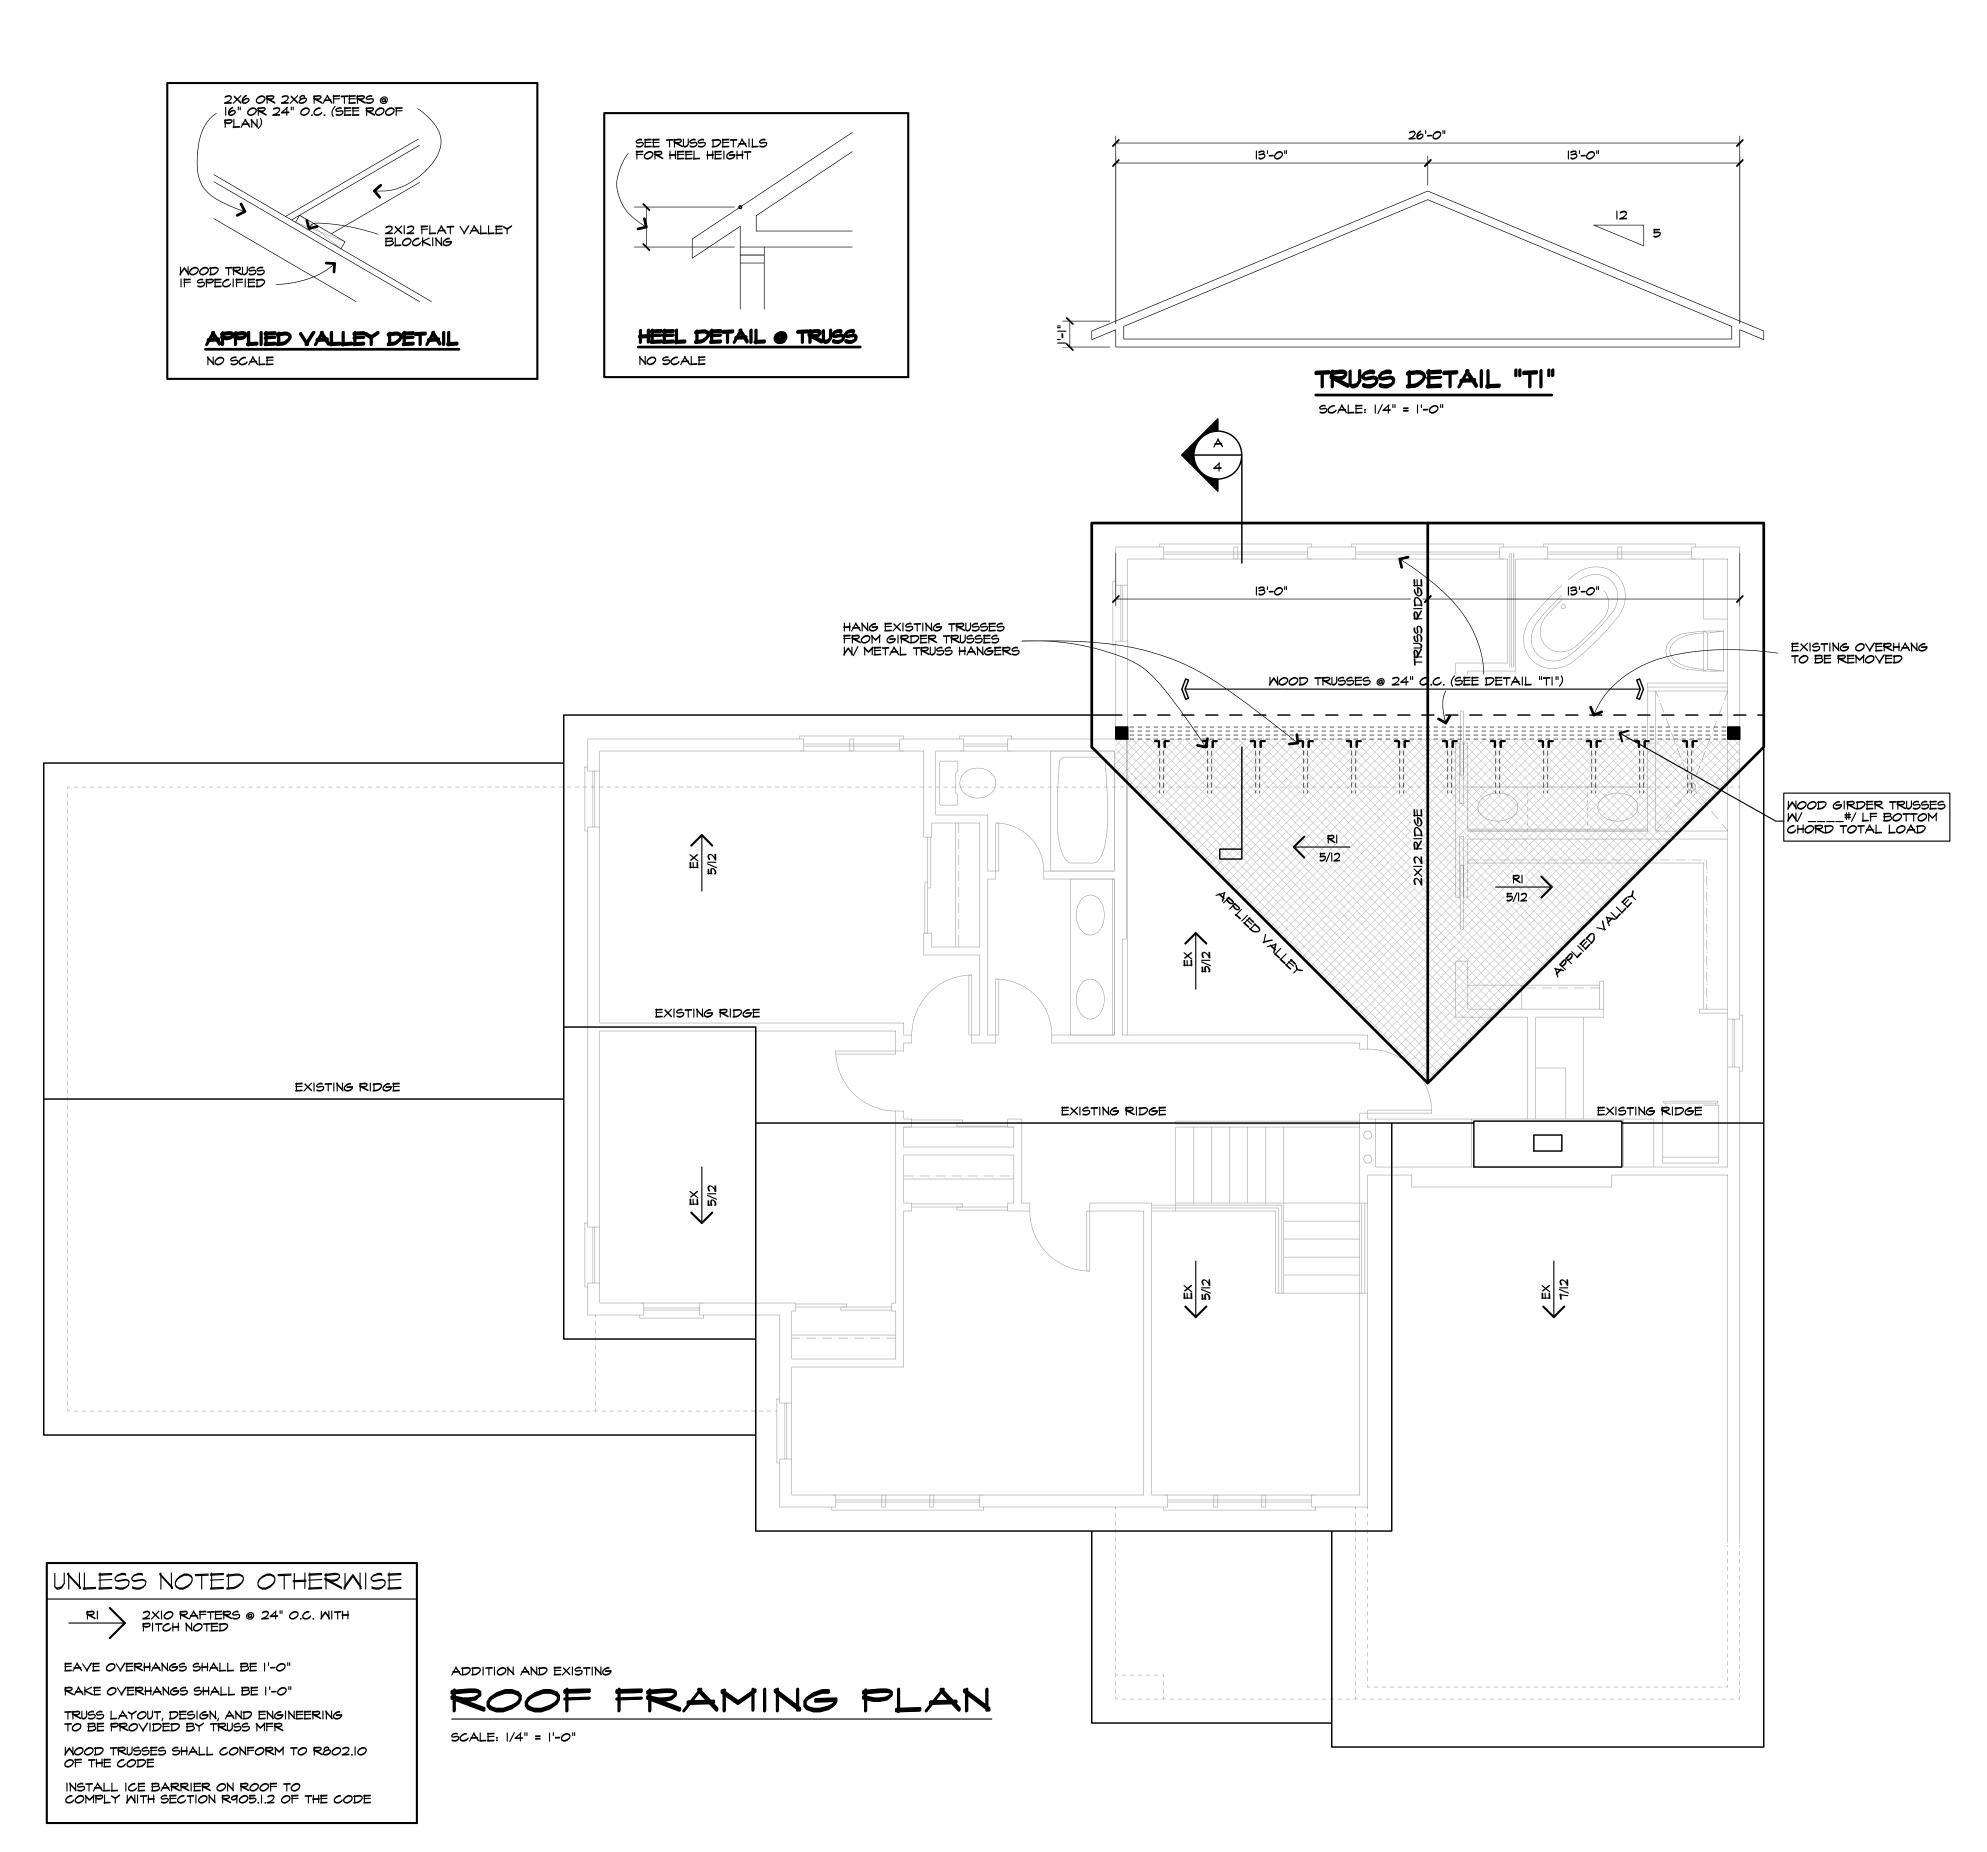
Job Location:

91 CAVERSHAM WOODS PITTSFORD, NEW YORK

SECOND FLOOR PLAN Drawn TJM / SMK

JANUARY 2023 38707

Of





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Revisions:

Project:

Clant

OMAR & LINDSAY ALI

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Job Location:

91 CAVERSHAM WOODS PITTSFORD, NEW YORK

Drawing Title:


ROOF FRAMING PLAN

Drawn
TJM / SMK
Checked By

JANUARY 2023

Job No. 38707

7 of 7

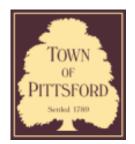

Tax ID Number: Zoning District:

Property Address: 56 & 58 Skylight,

Town of Pittsford

Department of Public Works 11 South Main Street Pittsford, New York 14534

Permit # B23-000023

Phone: 585-248-6250 FAX: 585-248-6262


DESIGN REVIEW AND HISTORIC PRESERVATION BOARD REFERRAL OF APPLICATION


Owner: Applicant: S & J Morrell	
Application Type:	Puild to Line Adjustment
Residential Design Review §185-205 (B)	Build to Line Adjustment §185-17 (B) (2)
Commercial Design Review	Building Height Above 30 Feet
§185-205 (B)	§185-17 (M)
Signage	Corner Lot Orientation
§185-205 (C)	§185-17 (K) (3)
 Certificate of Appropriateness 	 Flag Lot Building Line Location
§185-197	§185-17 (L) (1) (c)
_ Landmark Designation	Undeveloped Flag Lot Requirements
§185-195 (2)	§185-17 (L) (2)

Project Description: Applicant is requesting design review for the proposed construction of a new town home dwelling. The proposed building will consist of 2 attached single family dwellings sharing a common wall. 56 Skylight Trail will be approximately 1884 sq. ft. and 58 Skylight Trail will be 2023 sq. ft. The town homes will be located in the new Alpine Ridge development.


Meeting Date: March 09, 2023


Informal Review

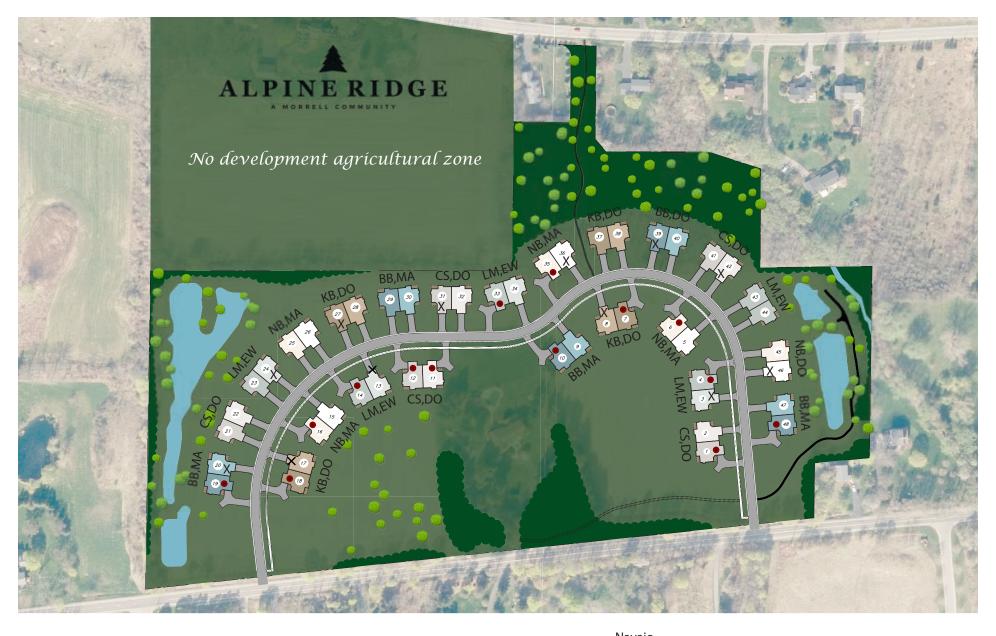

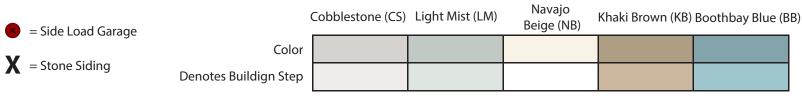

Garage Door Dark Oak (DO) Walnut (EW) Mahogany (MA) Dark Oak (DO) Mahogany (MA)

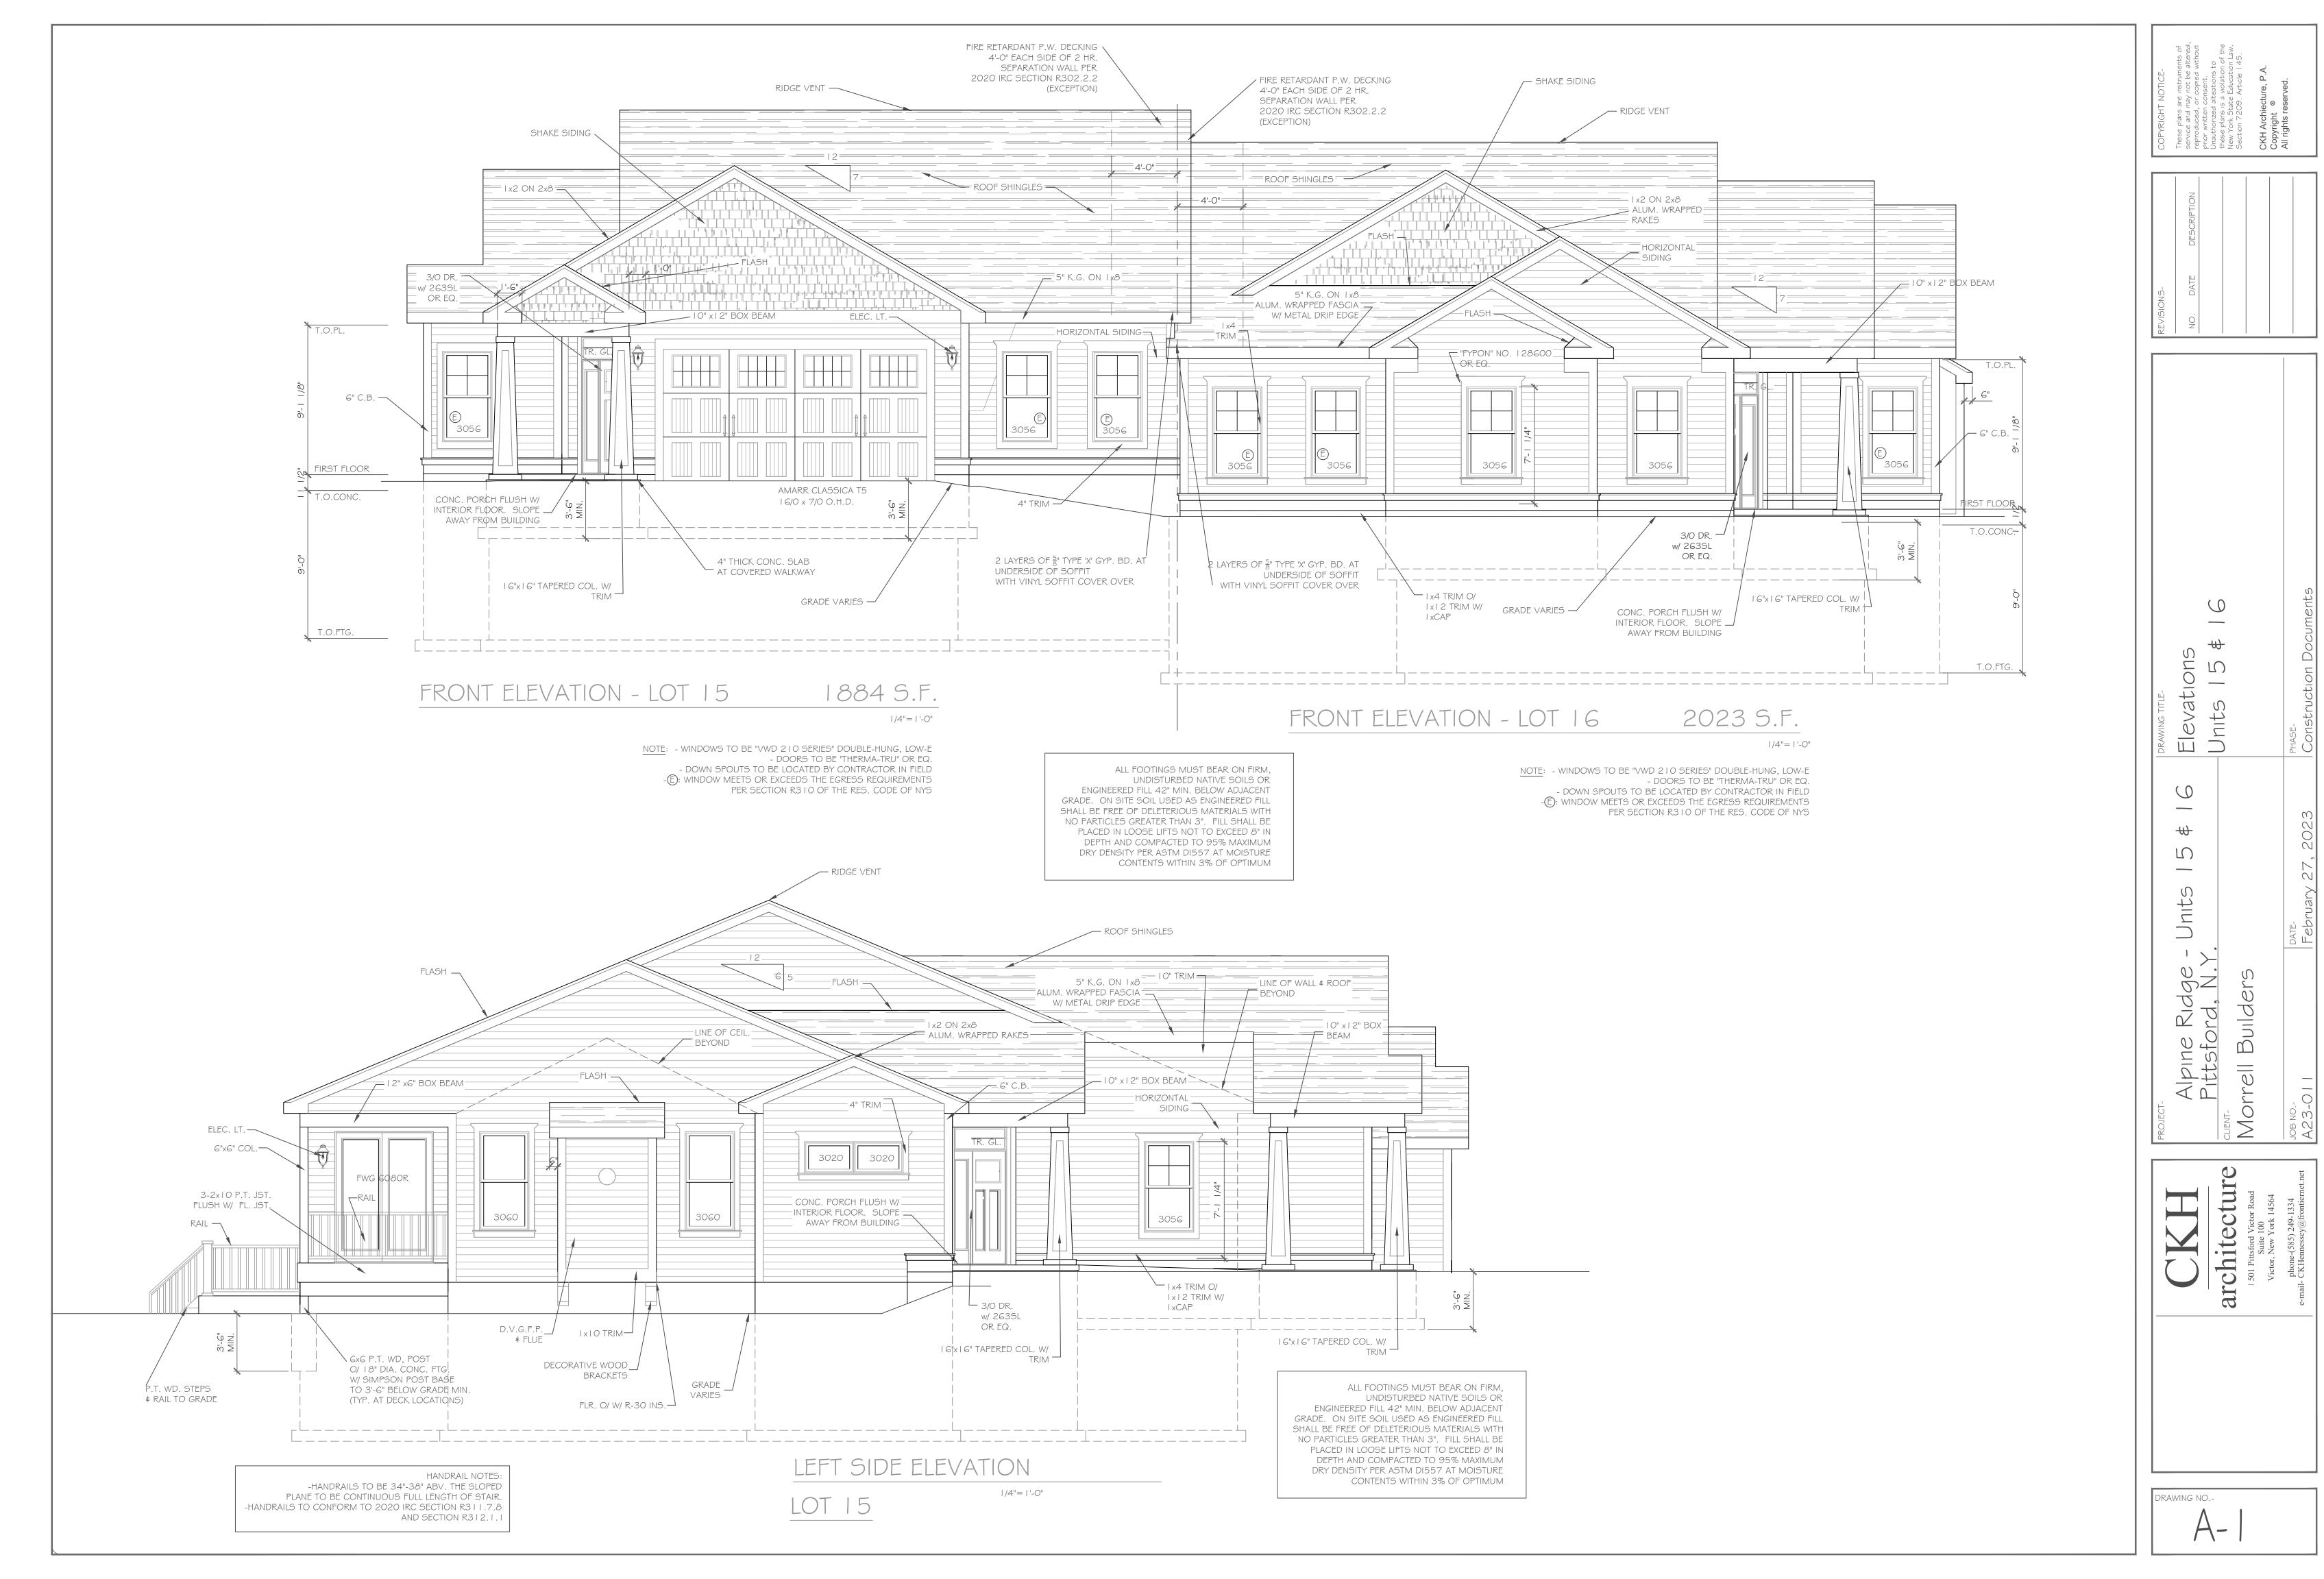

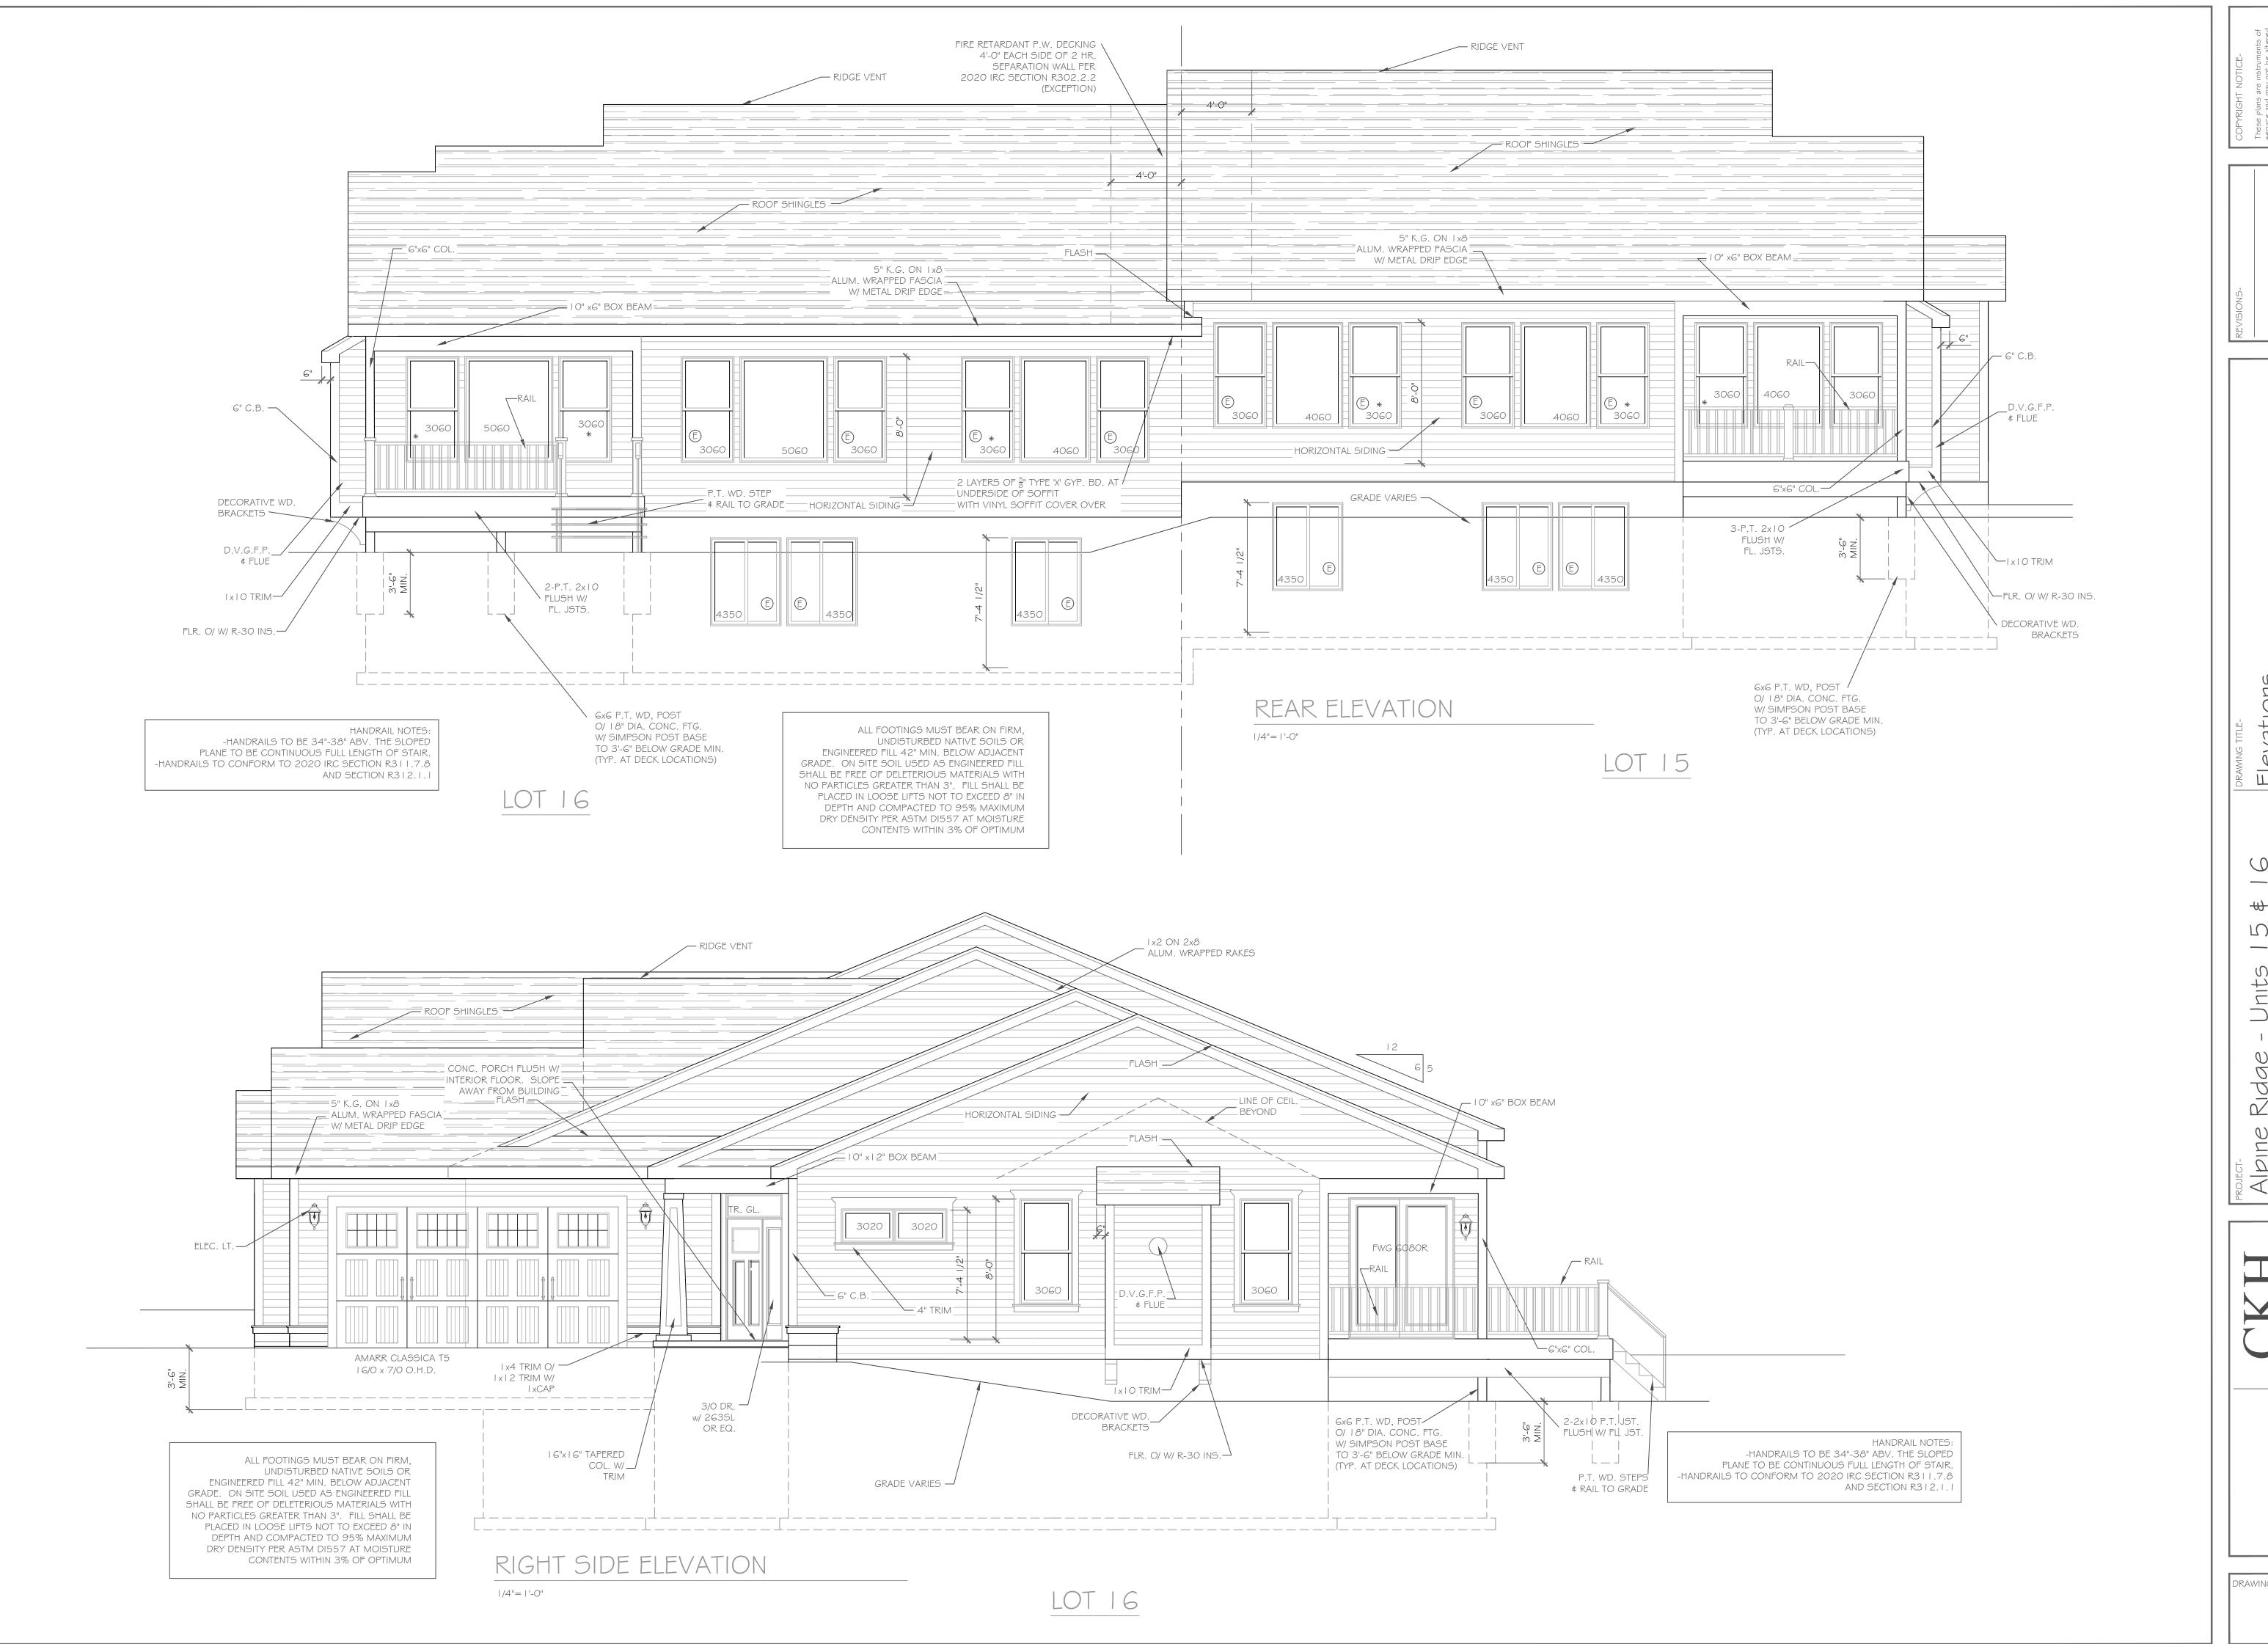

REVISIONS
These plans are instrum.

NO. DATE DESCRIPTION

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PROJECTAlpine Ridge - Units 15 \$ 16
Pittsford, N.Y.


CLIENTMorrell Builders

JOB NO.A23-011
PRASEConstruction Documents

architecture

| 501 Pittsford Victor Road Suite 100
| Victor, New York 14564
| phone-(585) 249-1334
| e-mail- CKHennessey@frontiernet.net

DRAWING NO.A-2

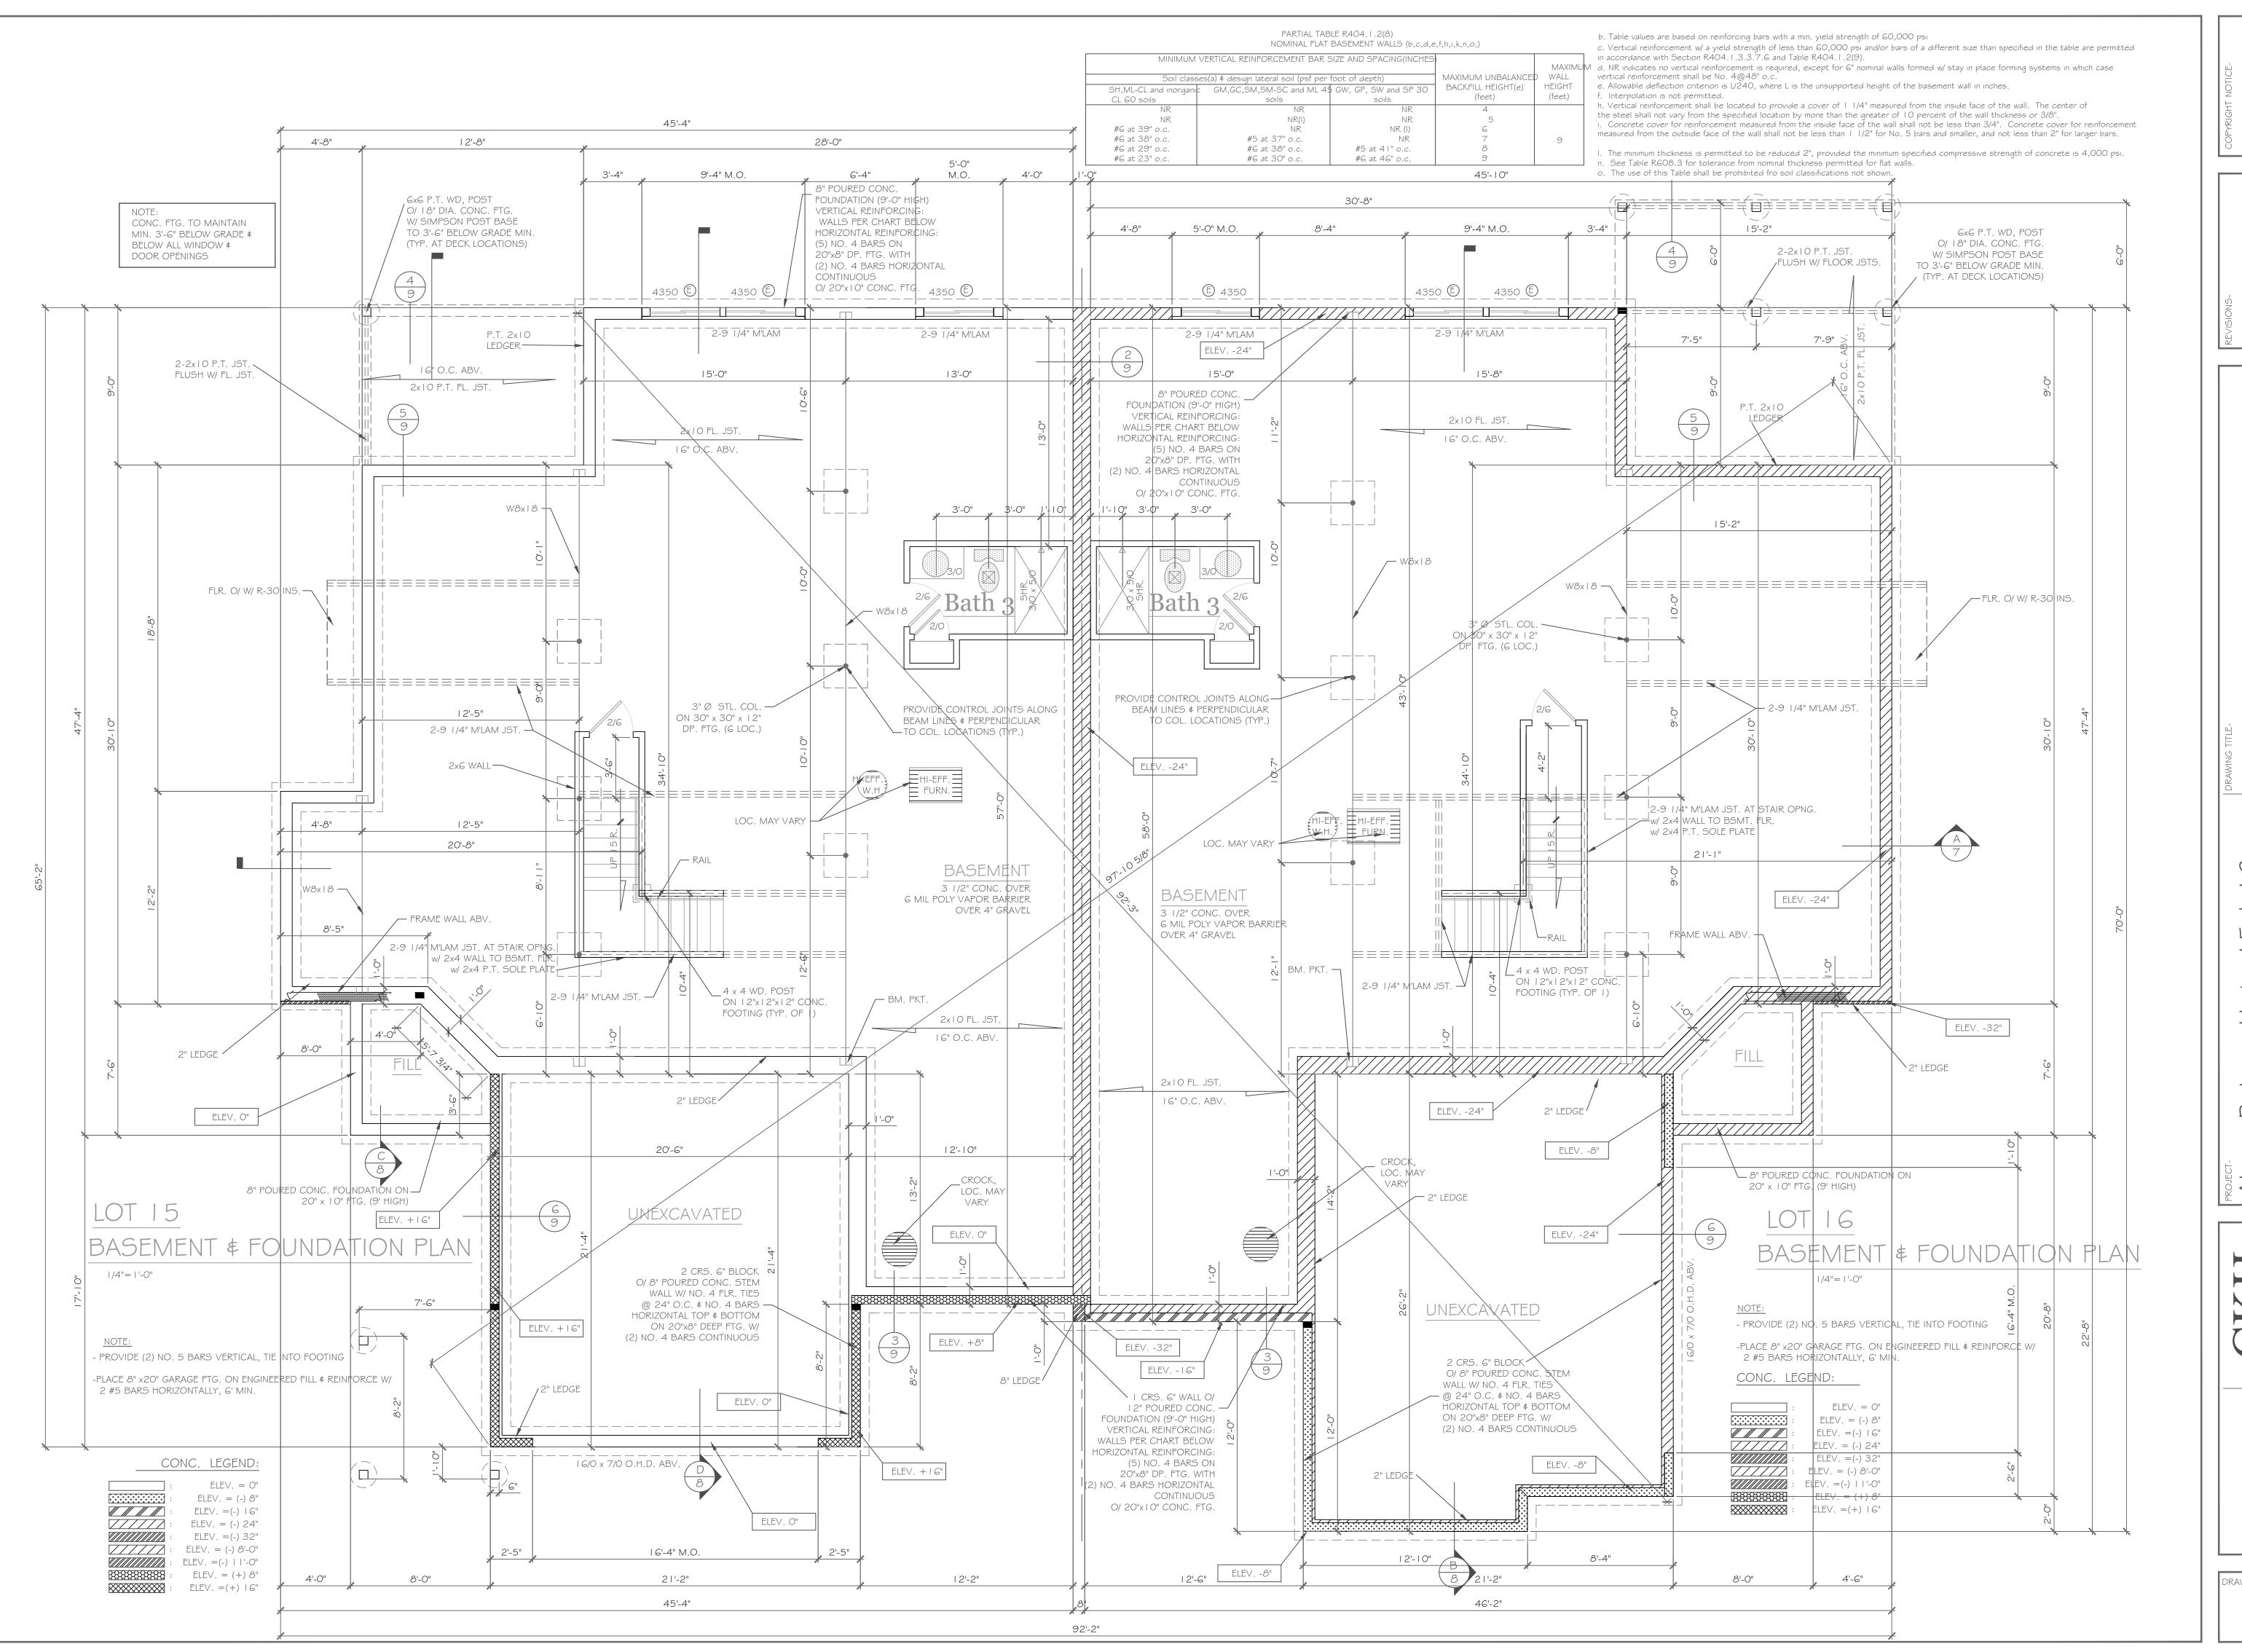


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architecture

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DRAWING NO.A-3



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REVISIONS
NO. DATE DESCRIPTION

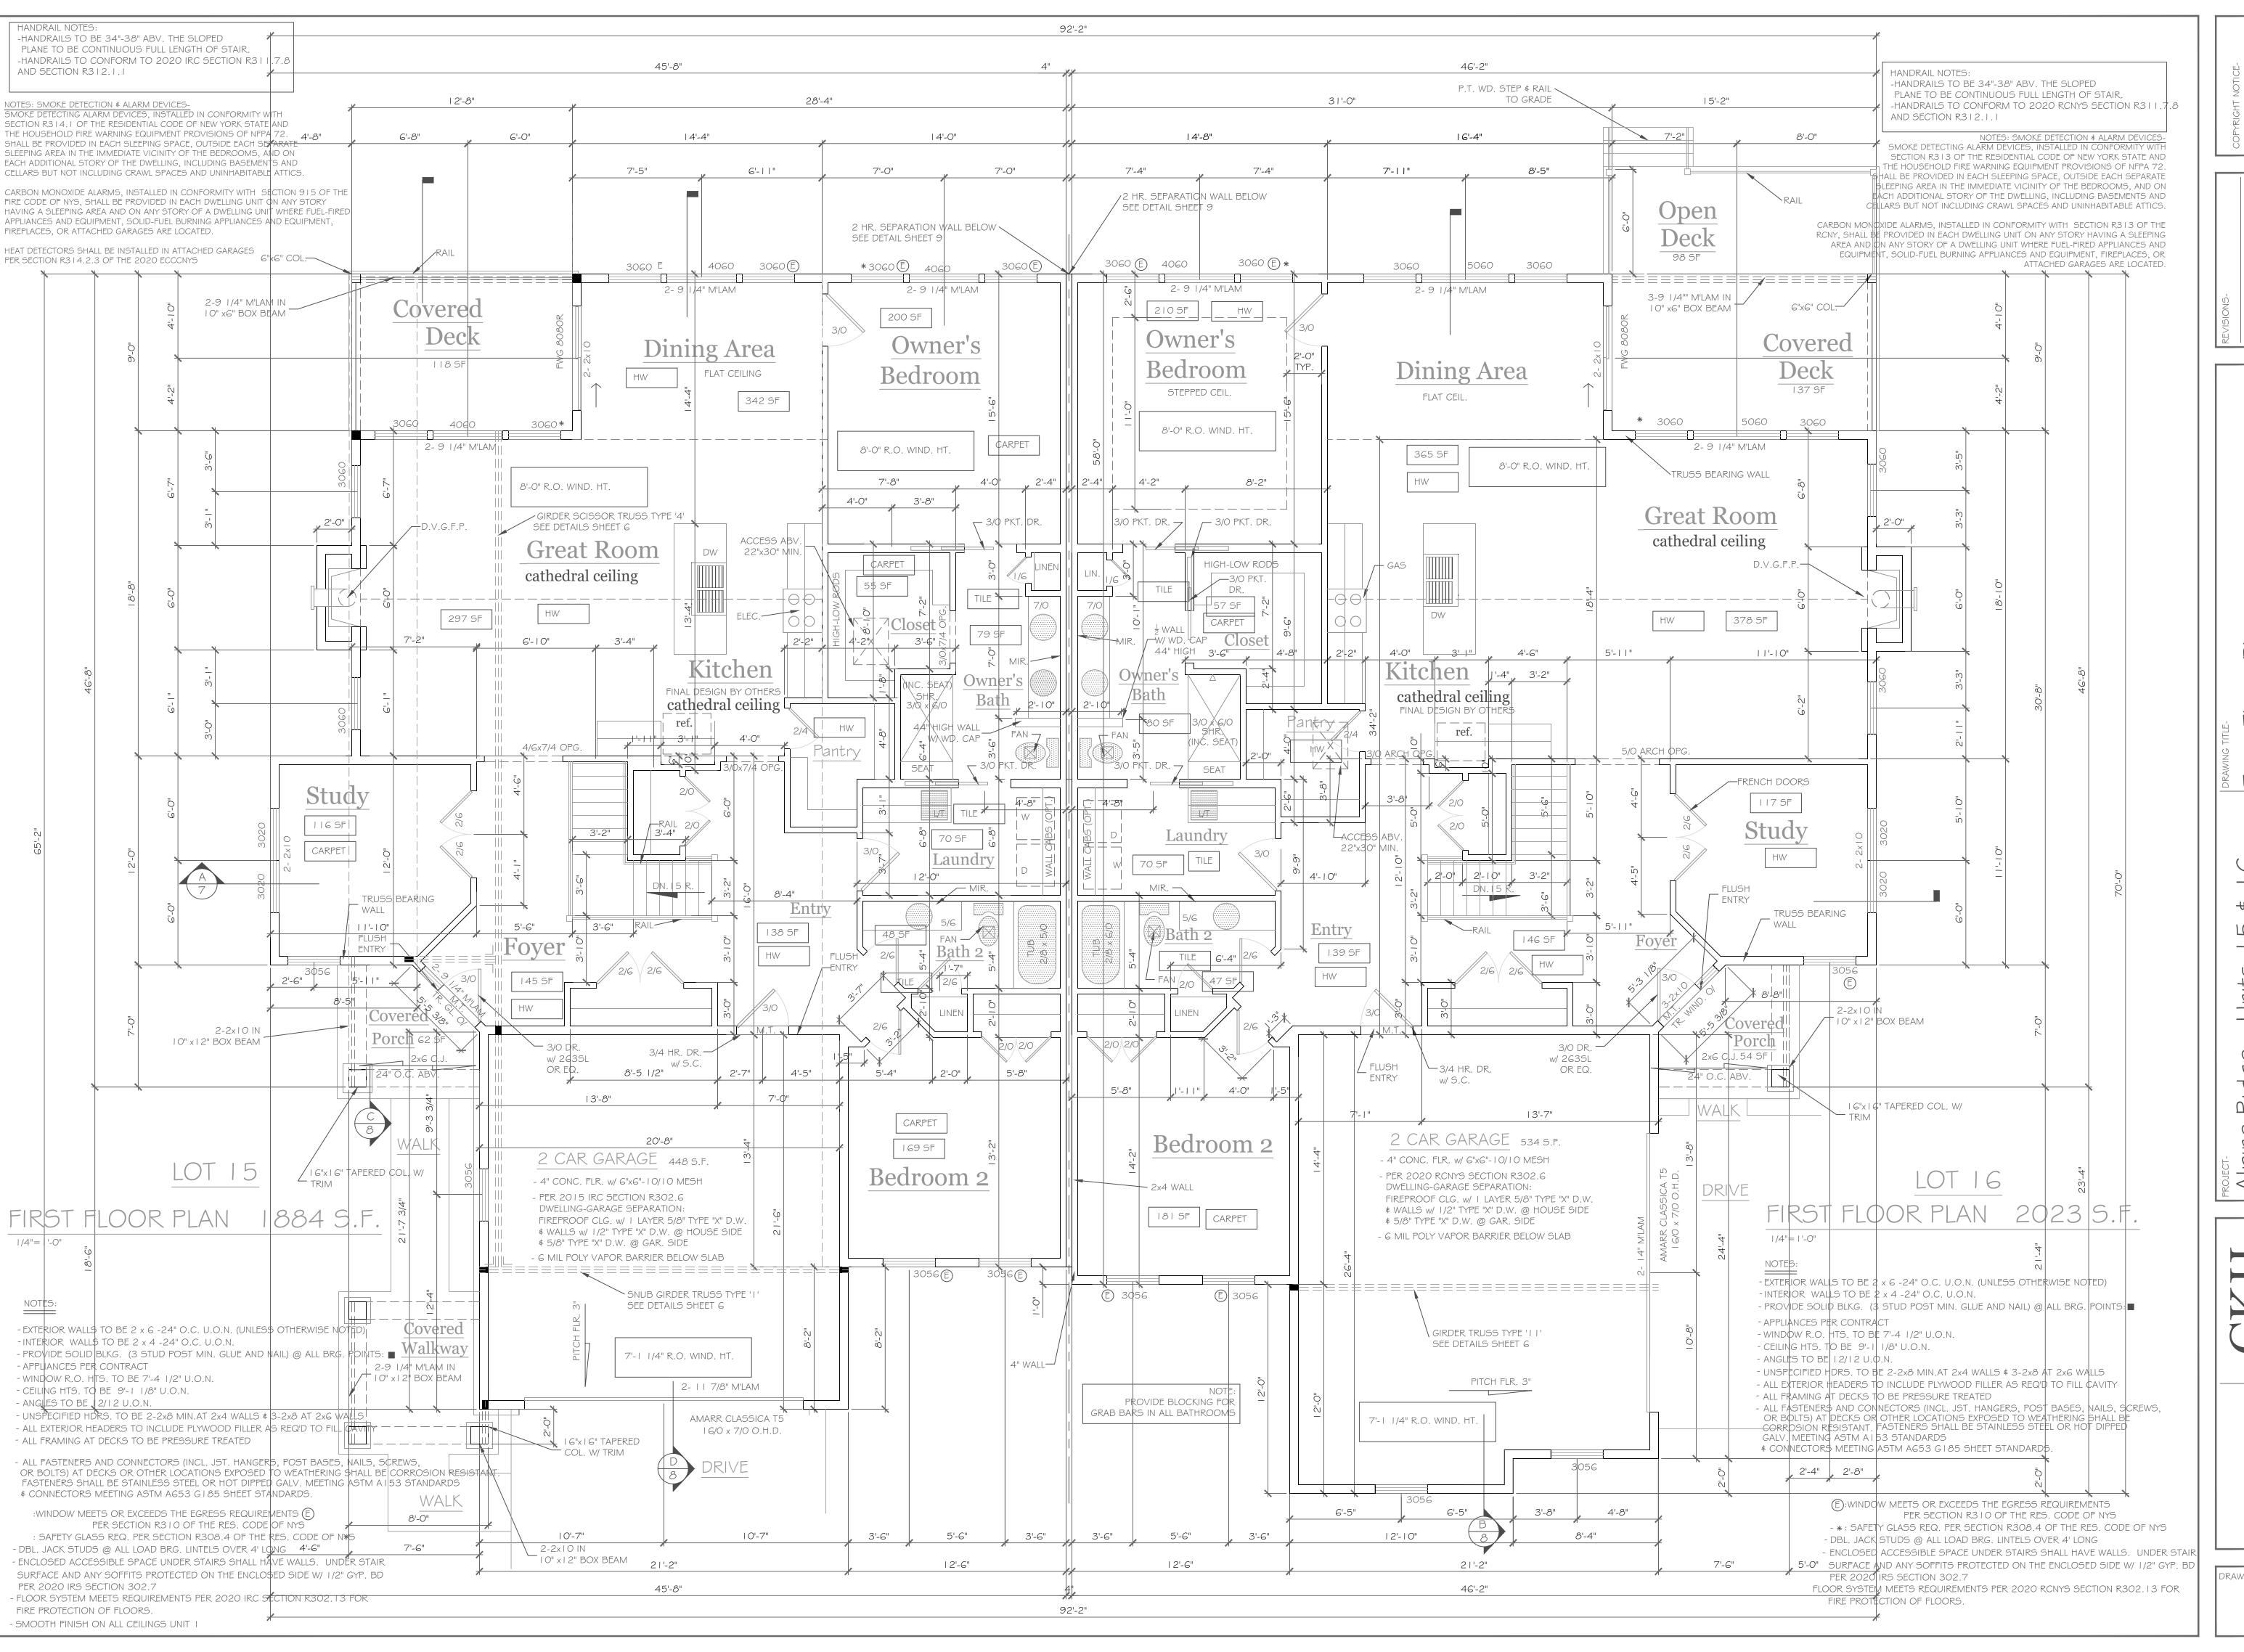Alpine Ridge - Units 15 \$ 16 | First Floor Plans | Pittsford, N.Y.

Cuent | Morrell Builders | Date | Phase | Construction Documents |

A23-011 | February 27, 2023 | Construction Documents |

architecture

| 501 Pittsford Victor Road
| Suite 100
| Victor, New York 14564
| phone-(585) 249-1334
| e-mail- CKHennessey@frontiernet.net

DRAWING NO.-

SUBJECT Lot 15-56 Skylight Trail and Lot 16-58 Skylight Trail

Siding: Almond

Front Door: New Earth Garage Door: Mahogany







Mahogany

LEFT OF SUBJECT Lot 13-50 Skylight Trail and Lot 14-52 Skylight Trail

Siding: Cape Cod Gray Front Door: Dark Maple Garage Door: Walnut





Walnut

RIGHT OF SUBJECT Lot 17- 62 Skylight Trail and Lot 18- 64 Skylight Trail


Siding: Pebble

Front Door: Driftwood Garage Door: Dark Oak





Dark Oak

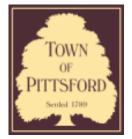

Town of Pittsford

Department of Public Works 11 South Main Street Pittsford, New York 14534

Permit # D23-00001

Phone: 585-248-6250 FAX: 585-248-6262

DESIGN REVIEW AND HISTORIC PRESERVATION BOARD REFERRAL OF APPLICATION

Property Address: 114 Sunset Boulevard PITTSFORD, NY 14534

Tax ID Number: 164.10-4-23

Zoning District: RN Residential Neighborhood

Owner: Sarajlic, Vedrana Applicant: Sarajlic, Vedrana


Application	Ty	oe:
-------------	----	-----

hh	ncation type.	
✓	Residential Design Review	Build to Line Adjustment
	§185-205 (B)	§185-17 (B) (2)
	Commercial Design Review	Building Height Above 30 Feet
	§185-205 (B)	§185-17 (M)
	Signage	Corner Lot Orientation
	§185-205 (C)	§185-17 (K) (3)
	Certificate of Appropriateness	Flag Lot Building Line Location
	§185-197	§185-17 (L) (1) (c)
	Landmark Designation	Undeveloped Flag Lot Requirements
	§185-195 (2)	§185-17 (L) (2)
	Informal Review	

Project Description: In accordance with Chapter 64 Article VIII, §64-43 of the Pittsford Town Code, the owner of 114 Sunset Boulevard is requesting approval from the Design Review and Historic Preservation Board to demolish the existing 1,872 square foot home at 114 Sunset Boulevard and rebuild a new 3,180 +/- square foot single family home on the property. Tax Parcel No. 164.10-4-23. This property is Zoned Residential Neighborhood (RN).

Meeting Date: March 09, 2023

RN Residential Neighborhood Zoning

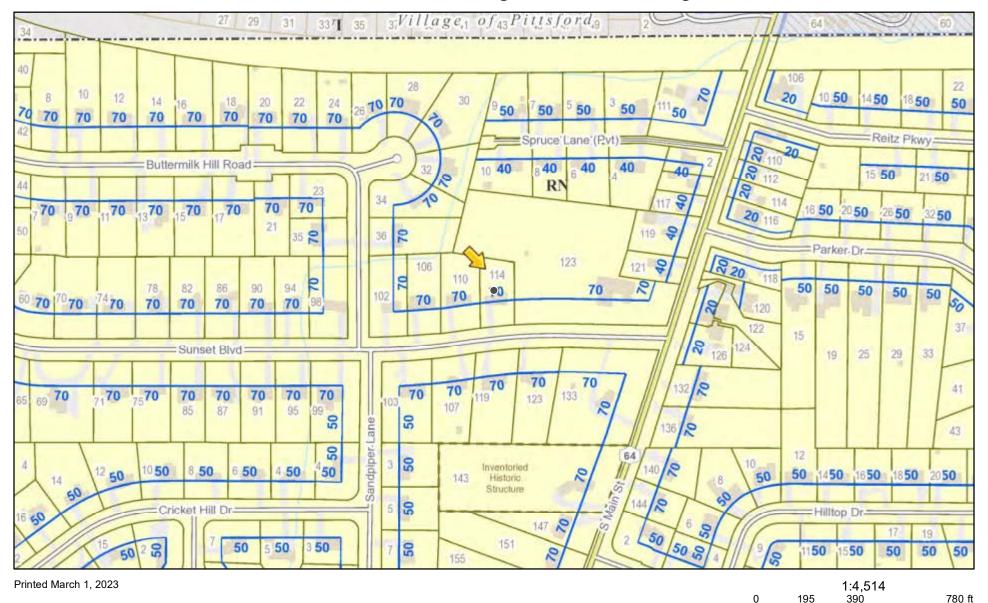

Town of Pittsford GIS

55

110

220 m

Proposed Residence

114 Sunset Boulevard Pittsford, NY 14534








Design Review & Historic Preservation Board Meeting: January 26, 2023



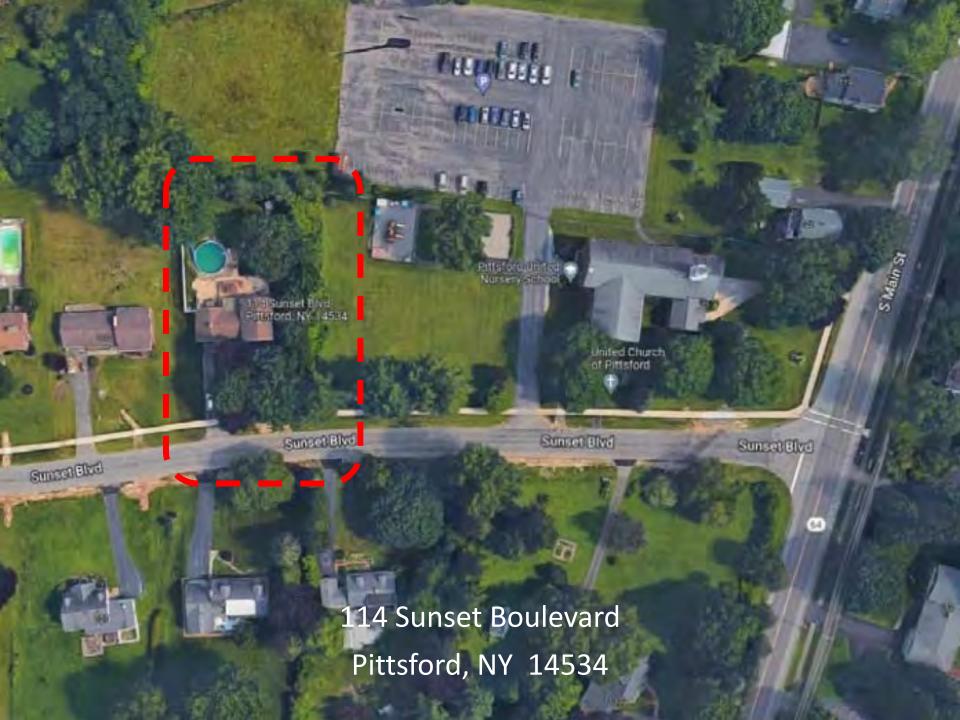

APPLICATION FOR BUILDING PERMIT

INSTRUCTIONS

A. This application must be filled in by typewriter or in ink and submitted to the Superintendent of Buildings. B. Two plot plans showing location of lot and of proposed and existing buildings on premises, relationship to adjoining premises, public streets or areas, and giving a detailed description of layout of property, with ALL measurements shown, must be submitted with this application. C. This application must be accompanied by TWO complete set of plans showing proposed construction. Plans shall describe the nature of the work to be performed, the materials and equipment to be used and installed and details of structure, mechanical, electrical and plumbing installations, sewage disposal and water drainage system. D. The work covered by this application cannot be commenced before the issuance of a Building Permit. E. Upon approval of this application, the Building Superintendent will issue a Building Permit to the applicant, together with approved set of plans. Such permit and approved plans shall be kept on the premises, available for inspection throughout the progress of the work. APPLICATION IS HEREBY MADE for the issuance of a BUILDING PERMIT pursuant to the rules and regulations, that have been adopted by the Town of Pittsford, for the construction of buildings, additions or alterations, or removal, or demolition, as herein described. The OWNER will be held responsible for compliance with all applicable laws, ordinances and regulations. LOCATION OF PREMISES: Tract JEFFERSON HEIGHTS Lot No. R.4. .. Street SUNSET. BLUD ... House No. 114. Zoned . A. LOT SIZE: Front ft. Rear ft. Depth . 200 Affront. Area Sq. Feet BUILDING: New ... X Addition Alteration Repair Demolition OWNER AND PRESENT ADDRESS ... FLMER J. PARRYT, INC., E. ROCHESTER, N.Y. NAME AND ADDRESS OF APPLICANT ... SAME.... DWELLING .X.. MULTIPLE DWELLING GARAGE .2.... CARS, COMMERCIAL INDUSTRIAL..... ESTIMATED COST \$. 1.8,000.00 FEE \$ 33.60 COMPLETED COST \$..... DIMENSIONS OF NEW CONSTRUCTION: (As Per Plans Submitted) Type of Building ... Type TII Ground Floor Area 1.120. 30. F.T. Number of Stories 2....... FOR ALTERATIONS AND ADDITIONS: Dimensions of existing structures: Front Rear......... Depth Height Number of Stories Dimension of proposed additions: Front Rear........ Depth........ Height Number of Stories Subject to the provisions of the STATE OF NEW YORK
COUNTY OF MONROE
TOWN OF PITTSFORD

Set:

Description of the back stakes must be set and protected before construction is started.

E. J. Par. A. being duly sworn and says that he is the applicant above named. He is the owner, contractor, agent, and is duly authorized to perform the said work and to make and file this application; that all statements contained in this application are true to the best of his knowledge and belief, and that the work will be performed in the manner set forth in the application and in the plans filed herewith.

FLMER S. PARENT ITMS. Town Building Code, All lot and set-Sworn to before me Close Have A Signature of Applicant) this . G . . day of DEC, 195 ..

5-

BUILD	ING INSPECTOR'S E	EDODE	
12/12/55	THE THEFT SHOW IS I	EPONT .	
Puilding Donmit No 212	Owner Flyger T	20-7-	
Lot No.R-4 Tract Jeffe Bedrooms 4 Bathrooms Interior Outs Storm Vater Sewer	CON HOTS Hous	e No. //4 Street Suns	TRI
Interior Outs	I Laundry	Sink _ Fire Flace	-
Storm later Sewer	Surface	rainage, Dry Wall Well	_
Public Vater System	1.1.0.7.7	ublic Sewage System	
Storm Water System_Sump Pump_ Basement Dragontside Tile Dragon	_ individual Sewa rainage	ge System	
Outside Tile Dra Building set back. Front	A LILLAGO CO		
and see such. Front	32 Hear	Side /9 W, 19 E	
	TOCARTON		
ZONEA	LOCATION	Setbacks o	dina.
G.F.A 1120 9			7
-		1/10/56	
400' 24" Trench			
1- 900 GAL TANK			
1 - 500 "			
1 2 2 3 3 3			
INS	PECT + WATE	R TEST	
Plumbing Inspection Date.(1	2/13/56	(2) (3)	
Plumbing and Sewage Systems	6/8/5G	(2) (3)	-
lumber BENGE	Sewer System Ins	talled by A/ HIBCOLL	
		J. H. S. F.	
	REMARKS		

Inspector	a. R. Kassel


114 Sunset Boulevard

Minimum Requirements and Current Condition

Client: Vedrana Sarajlic and John Bell





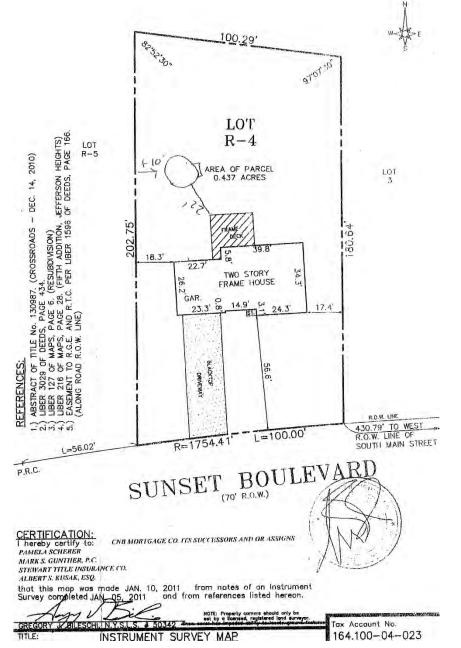





Minimum Requirements:

- Tax Account No.: 164.100-04-023
- Age of Structure: 67 (Built 1956)
- Square Footage: 1,872
- Height: +/- 25'-0"
- Style: Vernacular
- Architect: Unknown
- Historical Interest: None

^{*} Note: No existing drawings were found by the Building Department staff.

Current Condition:

- Basement water retention in the gap between floor and wall forming black mold. Frequent spraying prolongs exposure to chemicals in addition to mold.
- Basement walls have holes drilled in them because of water retention issue and pressure on the walls.
- Basement plumbing poorly configured.
- Exterior wall insulation very thin, damaged, and inadequate all through the house.

Current Condition: (cont.)

- Garage wall next to the house poorly constructed and not properly insulated.
- Grading is uneven, driveway and front of the house sloping toward the house instead of the other way.
- Five acres of adjacent church property has water flowing toward the existing house. Overall, water retention on the property is a major issue.
- Sump pump runs non-stop and already failed once last fall causing basement to flood. Damage caused to water heater and other items requiring costly repairs.

Current Condition: (cont.)

- Roof will need to be replaced in the near future.
- Interior floor plan is not functional for modern living with a small kitchen and dining area.
- The existing house does not appear to fit in with the diverse architectural characteristics of the surrounding neighborhood.

Overall, the existing house is poorly constructed, uncomfortable, and not efficient in terms of energy use.

Current Condition: (cont.)









Existing Condition of Basement Walls and Floor

Adjacent Buildings

South Main Street and Sunset Boulevard
























Proposed Residence

114 Sunset Boulevard

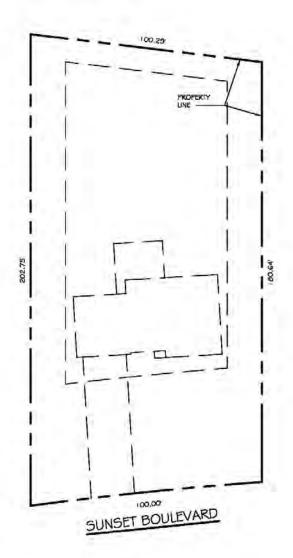

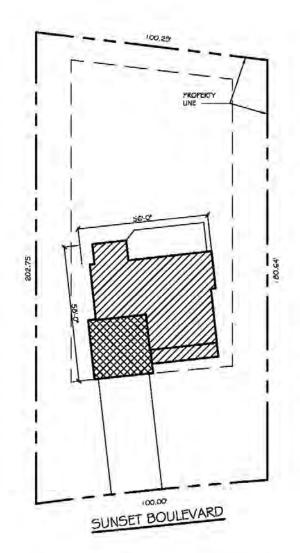




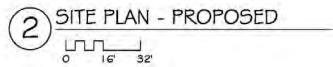





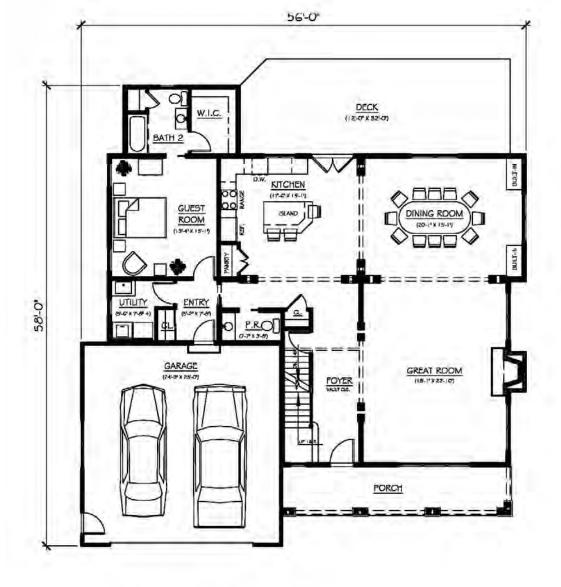











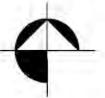






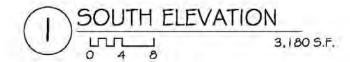






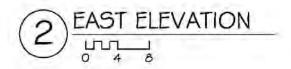






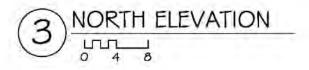





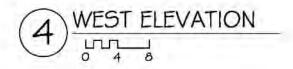









Stormwater Control

Scope of Work:

Control stormwater runoff on site to prevent soil saturation around the foundation and damage to the proposed foundation.

- Slope surface to grade away from the house.
- If space is available on the site, install swales to capture, control, and filter stormwater runoff, allowing it to percolate into the soil on site. Swales should have a 3-to-1 width-to-height ratio, a slope along the longitudinal channel of 2% to 4%, and be large enough to accommodate the volume of runoff from a 6-month, 24-hour storm event.
- If space on site is found to be limited, install drains to collect and direct water via underground French drains to drywells.