Design Review & Historic Preservation Board Agenda December 9, 2021

HISTORIC PRESERVATION DISCUSSION

APPLICATION FOR CERTIFICATE OF APPROPRIATENESS - RETURNING

• 3001 Monroe Avenue

The Applicant is requesting a Certificate of Appropriateness, pursuant to Code Section 185-196, for the expansion of an outdoor patio. This property is zoned MATZ – Monroe Avenue Transitional Zone and is designated historic.

APPLICATION FOR CERTIFICATE OF APPROPRIATENESS

• 682 Stone Road

The Applicant is requesting a Certificate of Appropriateness, pursuant to Code Section 185-196, for the construction of an oversized accessory structure on the property of a designated historic home.

RESIDENTIAL APPLICATION FOR REVIEW

• 45 Country Club Drive

The Applicant is requesting design review for the addition to an existing home. The additions will be off each side of the property as well as the back.

• 3 Summers Circle

The Applicant is requesting design review for the construction of an approximately 144 SF 3 season room off the back of the house.

• 9 High Street

The Applicant is requesting design review for the addition of a 220 SF addition off the detached garage.

97 Country Club Drive

The Applicant is requesting design review for the addition of an approximately 795 SF addition/renovation of the existing house as well as the addition of an approximately 500 SF garage.

7 Round Trail

The Applicant is requesting design review for the construction of approximately a 120 SF sunroom on the existing deck.

155 Sylvania Road

The Applicant is requesting design review for the addition of a third car garage off the side of the house as well as a pool cabana off the rear off the house.

RESIDENTIAL APPLICATION FOR REVIEW - NEW HOMES

• 35 Coventry Ridge

The Applicant is requesting design review for the construction of a two story single family home. The home will have a total living area of approximately 3005 square feet and located in the Coventry Ridge Subdivision.

COMMERCIAL APPLICATION FOR REVIEW - SIGN

• 3330 Monroe Avenue

The Applicant is requesting design review for the addition of two temporary business identification signs. The sign on the east side of the building will be approximately 41 square feet and the sign on the south side of the building will be approximately 92 squarefeet. The signs will be made with banner material and will display the "Kinecta" Logo.

COMMERCIAL APPLICATION FOR REVIEW - WRIGHT HOUSE

• 3524 East Avenue

The Applicant is requesting design review for the interior and exterior renovations to the Wright House.

Design Review and Historic Preservation Board Minutes November 11, 2021

PRESENT

Dirk Schneider, Chairman; Bonnie Salem, Dave Wigg, Paul Whitbeck, John Mitchell

ALSO PRESENT

Robert Koegel, Town Attorney; Bill Zink, Building Inspector; Susan Donnelly, Secretary to the Board

ABSENT

Kathleen Cristman, Leticia Fornataro

Dirk Schneider, Chairman, opened the meeting at 6:00 pm.

HISTORIC PRESERVATION DISCUSSION

Bonnie Salem discussed the East Burying ground signage. The new sign has not been delivered. The secondary sign located at the front fence line posted as part of an Eagle Scout project is approved to be relocated.

RESIDENTIAL APPLICATION FOR REVIEW - NEW HOMES

• 101 Coventry Ridge

The Applicant is requesting design review for the construction of a two story single family home. The home will have a total living area of approximately 5418 square feet and located in the Coventry Ridge Subdivision.

Steve Maynard representing Coventry Ridge Building Corporation was present. This home is wooded on three sides, two sides belonging to the Town of Pittsford. The garage will be angled to the street.

Bonnie Salem commented that she appreciated the use of only two materials, vinyl siding and stone.

Paul Whitbeck moved to approve the application as submitted.

John Mitchell seconded.

All Ayes.

49 & 51 Skylight Trail

The Applicant is requesting design review for the proposed construction of a new town home dwelling. The proposed building will consist of 2 attached single family dwellings sharing a common wall. Lot 27 (51 Skylight Trail) will be approximately 2000 sq. ft. and Lot 28 (49 Skylight Trail) will be 1987 sq. ft. The town homes will be located in the new Alpine Ridge development.

Bill Arieno, representing Morrell Builders, was present.

This is the first unit in the second section of Alpine Ridge subdivision. Mr. Arieno showed samples of materials being used.

The Board requested that in future submissions the map be highlighted on which home is being constructed.

Mr. Arieno reiterated that the colors are pre-chosen and the client/homeowner does not have control over the choice.

John Mitchell moved to accept the application as submitted.

David Wigg seconded.

All Ayes.

49 Van Voorhis Road

The Applicant is requesting design review for the construction of a two story single family home. The home will have a total living area of approximately 2874 square feet.

John Grasize of Gerber Homes was present to discuss the application with the Board. The siding will be different textures in all one color with dark stone and a black roof. The timber detail in the gable and porch columns will be wood color. There will be a side load garage. This home is 150 ft. from the road.

The Board commented that the design would be more successful with more simple textures. Comments were also made regarding the relatively same size of the garage to the home.

Dirk Schneider moved to approve the application with the recommendation that the shingles siding be changed to board and batten.

John Mitchell seconded.

All Ayes.

APPLICATION FOR CERTIFICATE OF APPROPRIATENESS

• 3419 Clover Street

The Applicant is returning to request a Certificate of Appropriateness, pursuant to Code Section 185-196, for the rear addition on a designated historic home. This property is zoned RN -Residential Neighborhood.

Dirk Schneider moved to open the Public Hearing.

The homeowner, Frank Dutko, was present.

Mr. Dutko is returning to amend his plan for changes to the exterior of his home. He is adding a door and two windows on the rear elevation second floor from the original approval of a sliding glass door.

The windows will be Anderson 200 series with the same mullion pattern as most of the existing windows on the home.

Wood siding that will removed will be repurposed on the exterior of the home.

There was no public comment.

Dirk Schneider moved to close the public hearing.

Bonnie Salem seconded.

All Ayes.

A resolution was moved by Board member Bonnie Salem, seconded by Board member John Mitchell, and was voted upon by members of the Board as follows:

Bonnie Salem Aye
Paul Whitbeck Aye
Kathleen Cristman Absent
John Mitchell Aye
Leticia Fornataro Absent
David Wigg Aye
Dirk Schneider Aye

The granting of the Certificate of Appropriateness was made subject to the following specific condition:

a. All work is to be completed by November 30, 2022.

3001 Monroe Avenue

The Applicant is requesting a Certificate of Appropriateness, pursuant to Code Section 185-196, for the expansion of an outdoor patio. This property is zoned MATZ – Monroe Avenue Transitional Zone and is designated historic.

Dirk Schneider opened the Public Hearing.

Aaron Malbone of Buckingham Properties was present. Kathy Mott of Monroe's Restaurant and Jillian Farrar were also in attendance. Monroe's Restaurant is looking to expand their existing patio, an additional 24 seats. A glass wall is proposed on the north side of the patio facing Monroe Avenue, similar to the one at Next Door Bar and Grill. The patio surface will be stamped concrete to match the existing. The size increase is 600 sg. ft.

The Board discussed whether there is a need for the glass wall and indicated a preference for increased landscaping or "green wall" around the patio area on the north and west sides.

Dirk Schneider called for public comment.

Joan (Declined to give last name) of 2520 Clover Street discussed her concerns that the increased patio would generate increased noise and light pollution. Dirk Schneider discussed that these are concerns best addressed directly to the Code Enforcement Officer at the Town of Pittsford, as the Design Review and Historic Preservation Board's role is to review design aspects. Robert Koegel, Town Attorney, stated that this Board has no control over her concerns and has no right to turn down the application based on her concerns.

Mr. and Mrs. Silver of 2534 Clover Street also discussed their concerns about additional noise that increased seating could present. Robert Koegel reiterated that the Design Review Board does not have control over these concerns, as it is not in their purview. They indicated that increased plantings would be appreciated despite the fact that as a Board member pointed out their property is above the area on a wooded hill.

Dirk Schneider moved to close the Public Hearing.

Bonnie Salem seconded.

All Ayes.

The Board held further discussion on the need for further landscaping. A wood fence was discussed but Kathy Mott indicated she does not want this.

Dirk Schneider indicated that the matching stamped concrete is in keeping with the existing. He recommended increased screening with the understanding that there will be no added lights or plugs to accommodate a sound system. Kathy Mott stated that there are no speakers in the area and bands are only allowed by Town permit.

David Wigg expressed preference for screening on all three sides of the patio. Ms. Mott said she could increase landscaping on two sides but the south side of the parking lot has mature trees.

John Mitchell stated that he has no opinion on the wall but felt it would be critical to see a more defined landscaping plan.

The Board determined that they would like to see a landscaping plan prior to making a decision since the project is not going under construction until Spring 2022.

The decision was made to hold this application open.

REVIEW OF MINUTES OF OCTOBER 28, 2021 MEETING

Bonnie Salem moved to accept the minutes of October 28, 2021 as written.

Paul Whitbeck seconded.

All Ayes.


ADJOURNMENT

Dirk Schneider moved to close the meeting at 8:27 pm.

All Ayes.

Respectfully submitted,

Susan Donnelly Secretary to the Design Review and Historic Preservation Board 10/6/21, 2:07 PM Letter View

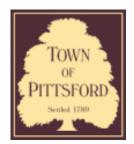

Town of Pittsford

Department of Public Works 11 South Main Street Pittsford, New York 14534

Permit # CA21-000008

Phone: 585-248-6250 FAX: 585-248-6262

DESIGN REVIEW AND HISTORIC PRESERVATION BOARD REFERRAL OF APPLICATION

Property Address: 3001 Monroe Avenue ROCHESTER, NY 14618

Tax ID Number: 150.08-1-71.1

Zoning District: C Commercial
Owner: Monroe Clover Plaza LLC
Applicant: Monroe Clover Plaza LLC

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Residential Design Review §185-205 (B)	Build to Line Adjustment §185-17 (B) (2)
Commercial Design Review §185-205 (B)	Building Height Above 30 Feet §185-17 (M)
Signage §185-205 (C)	Corner Lot Orientation §185-17 (K) (3)
Certificate of Appropriateness §185-197	Flag Lot Building Line Location §185-17 (L) (1) (c)
Landmark Designation §185-195 (2)	Undeveloped Flag Lot Requirements §185-17 (L) (2)
■ Informal Review	

Project Description: Applicant is requesting a Certificate of Appropriateness, pursuant to Code Section 185-196, for the expansion of an outdoor patio. This property is zoned MATZ - Monroe Avenue Transitional Zone and is designated historic.

Meeting Date: December 9, 2021



Restaurant West and South lot line plantings for sound and privacy buffer:

# on plan	Shrub/tree suggestion	Approx. Mature height
1	Upright pyramidal Yew(taxus) or Eastern Hemlock(both are evergreen)	10-20'
2	Oakleaf hydrangea	8'
3	Viburnum	8-10'
4	False cypress 'Soft Serve' pyramidal evergreen	10'

















TOWN OF PITTSFORD

Design Review & Historic Preservation Board Application for Certificate of Appropriateness

				Case #						
1.	Property A	Address:	3001 M	onroe Ave	enue Roo	chester,	NY 146	18		
2.	Tax Accou	unt Numb	er: 16-1	1591452						
3.	Applicant's	s Name:	Monro	e Clover P	laza LLC	;				
	Address:	259 Alex	kander S	treet				Phone:	(585) 295-	-9500
		Rochest	er, NY 1	Stree 4607	et			E-mail:		
			City		State		p Code	_		
4.	Applicant's	s Interest	in Prope	ertv:						
	Owner:			Lessee:			Holdi	ng Purch	ase Offer:	
	Other (explain):								
_		_								
5.	Owner (if o	other than a	bove):							
	Address:			Stree	-4			Phone:		
				Stree	et			E mail:		
			City		State	Zi	p Code	_ E-IIIaII.		
	Has the O	wner bee	n contac	ted by the	Applicar	nt?	Yes	\boxtimes	No	
6.	Application	n prepare	d by: B	uckingham	n Propert	ies				
	Address:	259 Alex						Phone:	(585) 797-	-3048
				Stree	et			=		
		Rochest	er, NY 1	4607				E-mail:	AMalbone@l	ouckprop.com
			City		State	Zi	p Code			
7.	Project De	esign Prof	essional	(if Available): HBT	Archited	cts			
	Address:	2 Elton S	Street					Phone:	(585) 510-	-2487
		Rochest	er, NY 1	Stree	et			E-mail:	mprattico@hb	tarchitects.com
			City		State	Zi	p Code	_ L IIIAII.	-	

Rev. 07/24/2017

8.	Project Contractor (if Available): Buckingham Properties	
	Address: 259 Alexander Street	Phone: (585) 295-9500
	Street	
	Rochester, NY 14607	E-mail:
	City State Zip Code	
9.	Present use of Property: Restuarant/Patio/Green space	
10.	Zoning District of Property: Commercial	
11.	Is the property located in a Town Designated Historic District? Yes No No	
12.	Is the property listed on the National Registry of Historic Places Yes No	?
13.	Will State or Federal Funding be used in this project, or will the application for Tax Credits or other State and Federal benefits? Yes No If Yes, please explain:	project result in an
14.	Proposed Exterior Improvements: A. Describe all exterior architectural improvements proposed project materials and finishes; attach additional sheets if n	
	No exterior architectural improvements are being proposed.	


Rev. 07/24/2017 8

B. Describe all significant site improvements proposed with this project (include proposed changes in landscaping, significant plant material alterations, and other improvements associated with hardscape materials such as driveways and retaining walls; attach additional sheets if necessary):

We are requesting an expansion of the existing slate patio to accommodate additional seating for 3001 Monroe Ave. Improvements will include removal of existing slate patio to be replaced with a

	sides of the new expanded undisturbed with new lands	tio. A glass screen wall is proposed for screening a patio. The existing landscaping the south side scaping being installed adjacent to the new glas st of decorative bushes. Please see additional p	of patio will remain s walls. New						
15.	If the structure is a Commercial Property open to the Public, please describe all interior improvements proposed at the project site (attach additional sheets if necessary).								
	No interior improvements	are proposed.							
16.	Additional materials subn Parcel map Photographs Other materials	nitted with this application (if available): Architectural elevations Architectural plans Site plan							
App	licant Certification:								
	I certify to the best of my complete and accurate. Docusigned by: REAL GASOE 348453	knowledge that the information supplied on the	10/20/2021 Date						
Owr		an the owner, does the owner concur with this	s application?						
	If Yes, owner's signatu	1							

Rev. 07/24/2017

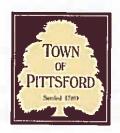


TOWN OF PITTSFORD SITE PLAN AUTHORIZATION TO MAKE APPLICATION


Planning Board - 11 S. Main Street - Pittsford, 14534 - 248-6260

If the applicant is not the owner of the subject property, this form must be completed and signed by the owner.

I, Monroe Clover Plaza LLC	,	the owner of the property located
at: 3001 Monroe Aver	nue, Rochester,	NY 14618
(Street)	(Town)	(Zip)
Tax Parcel # 150.08-1-71.1		do hereby authorize
Kathy Mott		to make application to the
Town of Pittsford Planning Board, 1	1 South Main S	treet, Pittsford NY 14534 for the
ourpose(s) of expansion of exisiting ou	tdoor patio space	
	In Septen	Signature of Owner Note: 15,2021
	7	Date


RN Residential Neighborhood Zoning

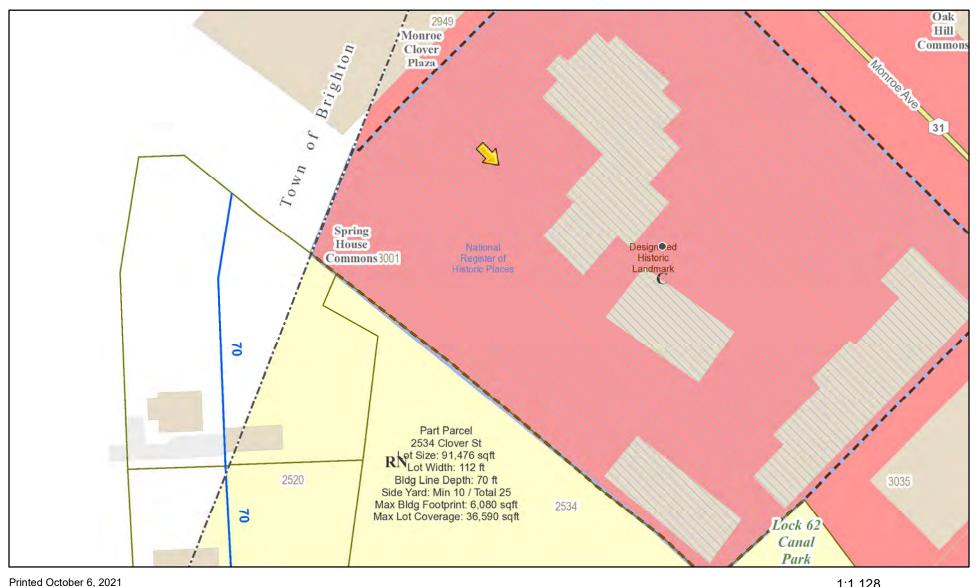

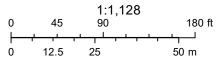


Town of Pittsford GIS

The information depicted on this map is representational and should be used for general reference purposes only. No warranties, expressed or implied, are provided for the data or its use or interpretation.

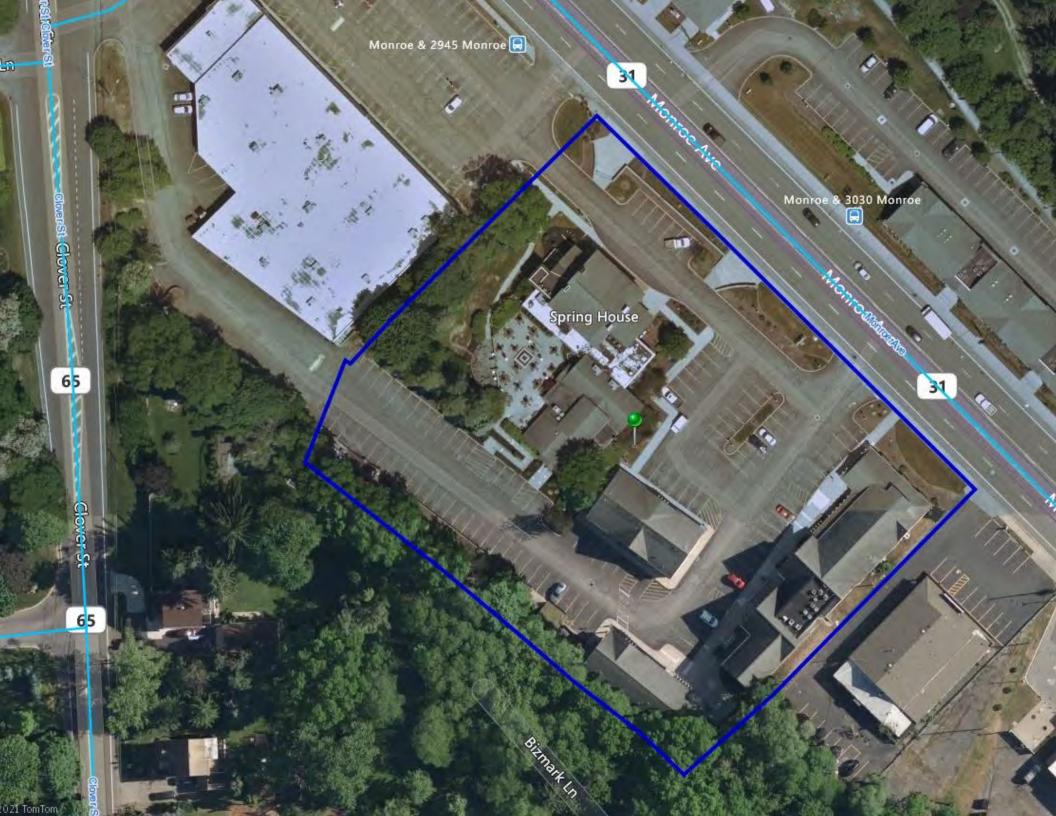



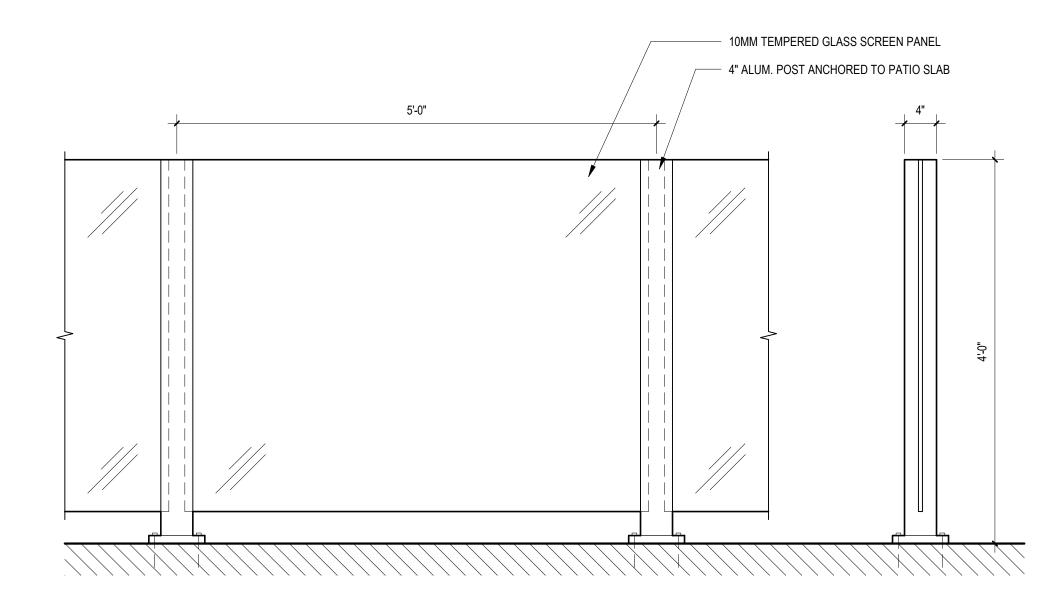





MONROE'S PROPOSED PATIO EXPANSION



P: (585) 295-9500 | F: (585) 295-9505 www.buckprop.com

Town of Pittsford

Town Planning Board

11 South Main Street

Pittsford, NY 14534

Re: Monroe's at the Spring House Outdoor Patio

To whom it may concern;

This letter is in regard to the request for additional patio space and outdoor seating for Monroe's at the Spring House located at 3001 Monroe Avenue.

Currently, per the August 10, 2009 planning board resolution 56 seats for the outdoor patio space are allowed. We are requesting an additional 24 seats to be allowed as well as the expansion of the existing patio space. Please see the attached seating and landscaping plan as reference for this request. We are planning to use the same materials and finishes as to match the existing outdoor patio space.

Thank you for your time and attention on this matter. Any questions or for further information regarding this matter please do not hesitate to contact me directly at 585-797-3048 or amalbone@buckprop.com

Respectfully,

Aaron Malbone

VP of Construction and Development

Buckingham Properties LLC


AARON MAUBONES







11/22/21, 8:48 AM Letter View

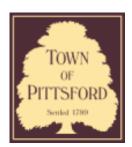

Town of Pittsford

Department of Public Works 11 South Main Street Pittsford, New York 14534

Permit # CA21-000010

Phone: 585-248-6250 FAX: 585-248-6262

DESIGN REVIEW AND HISTORIC PRESERVATION BOARD REFERRAL OF APPLICATION

Property Address: 682 Stone Road PITTSFORD, NY 14534

Tax ID Number: 163.16-1-24

Zoning District: RN Residential Neighborhood

Owner: Goldman, Richard A Applicant: Goldman, Richard A

App	lication	Type:
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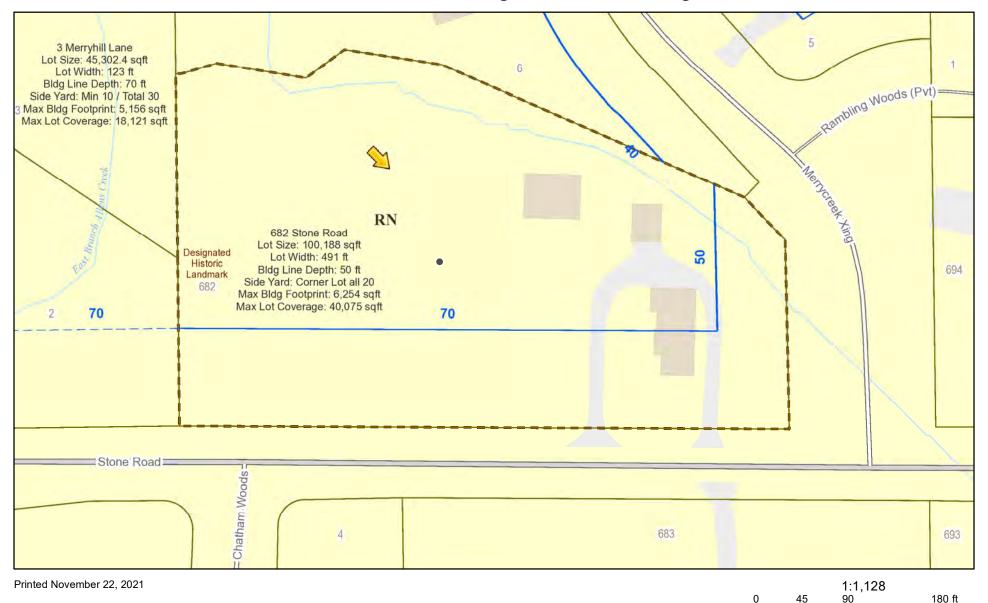
application Typo.	
Residential Design Review §185-205 (B)	Build to Line Adjustment §185-17 (B) (2)
Commercial Design Review §185-205 (B)	Building Height Above 30 Feet §185-17 (M)
Signage §185-205 (C)	Corner Lot Orientation §185-17 (K) (3)
Certificate of Appropriateness §185-197	Flag Lot Building Line Location §185-17 (L) (1) (c)
Landmark Designation §185-195 (2)	Undeveloped Flag Lot Requirements §185-17 (L) (2)
Informal Review	

Project Description: Applicant is requesting a Certificate of Appropriateness, pursuant to Code Section 185-196, for the construction of an oversized accessory structure on the property of a designated historic home.

Meeting Date: December 09, 2021



RN Residential Neighborhood Zoning





Town of Pittsford GIS

12.5

25

50 m

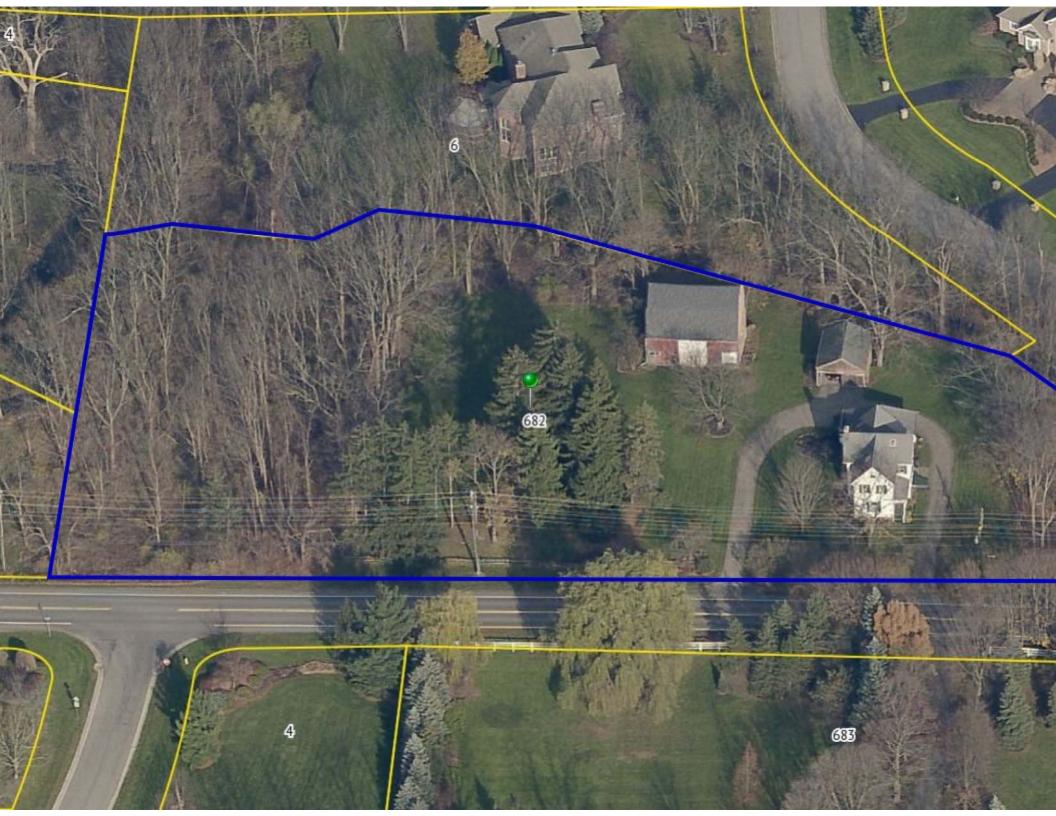

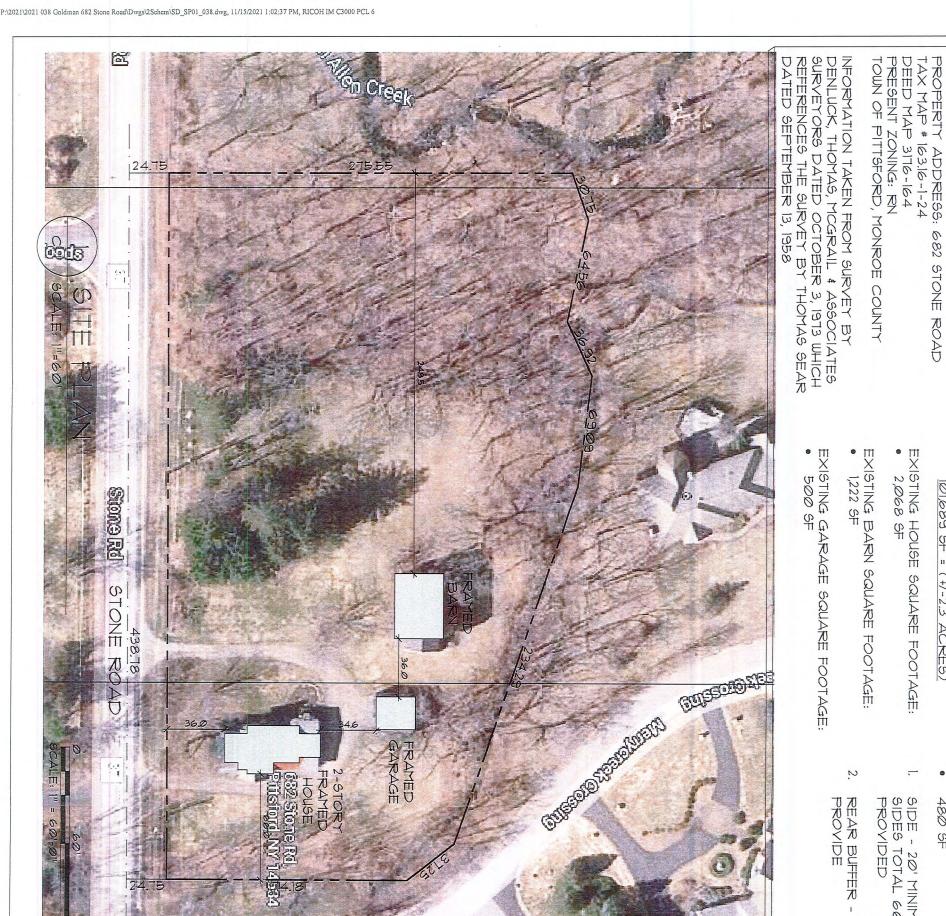

PARCEL AREA: |0|689 SF = (+/-2.3 ACRES)

PROPOSED NEW GARAGE:

480 SF

SIDE - 20' MINIMUM ONE SIDE, 120' BOTH SIDES TOTAL 66'+/- AND 314' TOTAL

0

REQUIRED, 50' +/-

ASSOCIATES ARCHITECTS, P.C.

Menyacek Grossing

en enois

GOLDMAN RESIDENCE NEW GARAGE


> 682 STONE ROAD PITTSFORD, NY 14534

PROJECT NO.: 2021-038

Spoow gallenes

DATE: 11/09/2021

DRAWN BY: JAB

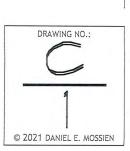



TOWN OF PITTSFORD

Design Review & Historic Preservation Board Application for Certificate of Appropriateness


			,	Case#					
1.	Property A	\ddress:	682 Stoi	ne Road, F	Pittsford N	Y 14534			
2.	Тах Ассоц	ınt Numbe	er: 163.1	16-1-24					
3.	Applicant's	s Name:	Jeffrey A	Ashline (M	ossien Ass	sociates Archited	cts, P.C.)		
	Address:	70 LInde	en Oaks, S	uite 110	ite 110			Phone: 585.262.6000	
		Roche	ster	Stree	et NY	14625	- E-mail:	jashline@r	mossien.com
			City		State	Zip Code			***************************************
4.	Applicant's	s Interest	in Proper	ty:					
	Owner:		·	Lessee:		Hold	ing Purch	ase Offer:	
	Other (6	explain): _	Owner's Ar	chitect			···		
5.	Owner (if o	ther than al	bove): Dic	ck Goldma	n				
	Address: 682 Ston						Phone:	585.953.61	103
				Stree			_ , ,,,,,,,,,		
		Pittsfor	.d		NY	14534	E-mail:	rgoldman6	82@gmail.co
			City		State	Zip Code	_		
	Has the O	wner beer	n contacte	ed by the	Applicant	? Yes	X	No	
6.	Application	n prepared	d by: ^{Je}	ffrey Ashli	ne (Mossie	en Associates A	rchitects, F	P.C.)	
	Address: 70 Linden Oaks, Sui			Suite 110	110			585.262	.6000
				Stree	t		_ Phone:		
		Roch	nester		NY	14625	E-mail:	jashline@r	mossien.com
			City		State	Zip Code			
7.	Project De	sign Profe	essional (if Available,): Same	as above			
	Address:	Address:					Phone:		
				Stree	t		<u></u>		
							_ E-mail:		
			Citv		State	Zip Code			

8.	Project Co	ntractor (if Available):	Charles Robinso	ctors		
	Address:	7455 Boughton Road	j 		Phone:	
		Bloomfield	Street NY	14469	E-mail: charlierob54@icloud.com	
		City	State	Zip Code		
9.	Present us	se of Property:Sing	le family home + o	detached garage	e + detached storage barn	
10.	Zoning Dis	strict of Property:	N			
11.	ls the prop	oerty located in a Tow No [n Designated His	storic District?		
12.	Is the prop	perty listed on the Nat	ional Registry of	Historic Places	s?	
13.	application Yes	or Federal Funding be n for Tax Credits or ot No [2 ase explain:				
14.	A. Desc	Exterior Improvemen cribe all exterior archited the control of th	ectural improven		d with this project (include necessary):	
	and replace as the curre The exterior existing store Our propose same footpronew poured siding with a There will boverhead door is prophome. The	of-work for this project incoment with a new 2-car gates and garage. The existing of a siding barn boards are worked to provide a new garant as the current garage a profile and smooth texture new composite window oor along with a single 'moosed to be 'Green' in colong proposed to add a single garant proposed to add a single proposed to add a si	garage in the same loogarage is structurally weathered and unable d in need of a new, age that is no taller to we will provide nerior walls will be woo ure that matches that son the east and we an-door' on the east or, to match that of the leand dark in color	cation and fitting wan-sound and in le to prevent water stable masonry for than the existing good framed and hard tof the existing sizest elevations, a receivation. The more existing green to match that of the existing to match that of the existing green	within the same limits need of replacement. er infiltration and the bundation and slab. garage that sits on the on walls along with a ve a white vinyl lap ingle family home. new window above the new 16' overhead garage window shutters on the the existing home. A new	

changes in landscaping, significant plant material alterations, and other improvements associated with hardscape materials such as driveways and retaining walls; attach additional sheets if necessary): As part of the scope-of-work for the project we would like to raise the garage floor slab arrpoximately 18" so that when the existing asphalt driveway is re-paved there is positive drainage away from the overhead door. This is not the case today as water drains towards and into the garage. The new foundation wall is proposed to be concrete block and can be painted or left natural like the wall is today. Existing landscaping will need to be removed in order to demolish and rebuild the new garage but similar low-lying plantings and ground-cover will be planted after garage construction. The Owner has had a new garage on his list for several years. Among the issues he has seen are: - Sliding doors that stick in the winter (He has even raised the sliding supports once) - The sticking of the doors occurs on the east side, meaning the structure is not level anymore - Water seeps into the garage and freezes on the floor in the winter - a dangerous situation - One rafter is barely secure, a risk of falling - Most of the external side boards are decaying at the bottom on the east side - Some foundation blocks are crumbling and separating from each other 15. If the structure is a Commercial Property open to the Public, please describe all interior improvements proposed at the project site (attach additional sheets if necessary). Not applicable 16. Additional materials submitted with this application (if available): Parcel map X Architectural elevations X Photographs Architectural plans X Other materials Asphalt shingle sample, exterior lap siding sample, green overhead door color sample Applicant Certification: I certify to the best of my knowledge that the information supplied on this application is complete and accurate. Signature of applicant Owner Consent: If the applicant is other than the owner, does the owner concur with this application? Yes X No Fulland A Solf If Yes, owner's signature:

Describe all significant site improvements proposed with this project (include proposed

B.

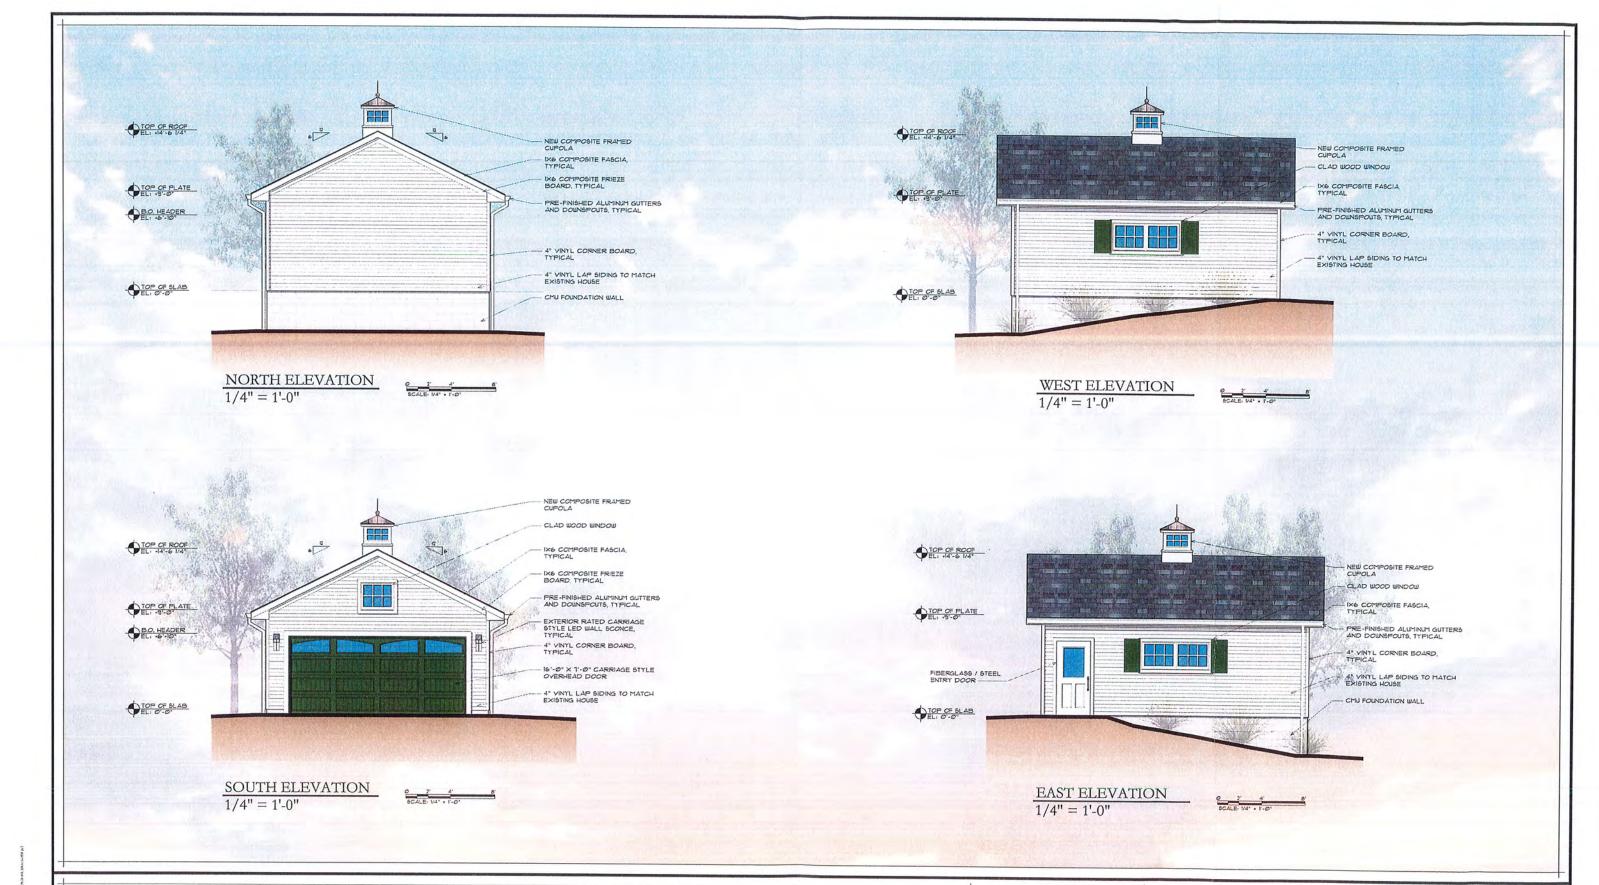

Project

PROPOSED RESIDENTIAL GARAGE - GOLDMAN RESIDENCE

682 STONE ROAD / PITTSFORD, NEW YORK OCTOBER 2021 MAA # 2021-038

Client

DICK GOLDMAN 682 Stone Road

Pittsford, NY 14534


General Contractor

CHARLES ROBINSON GENERAL CONTRACTORS 7455 BoughtonRoad


Bloomfield NY 14469


Architect ASSOCIATES

ARCHITECTS, P.C.

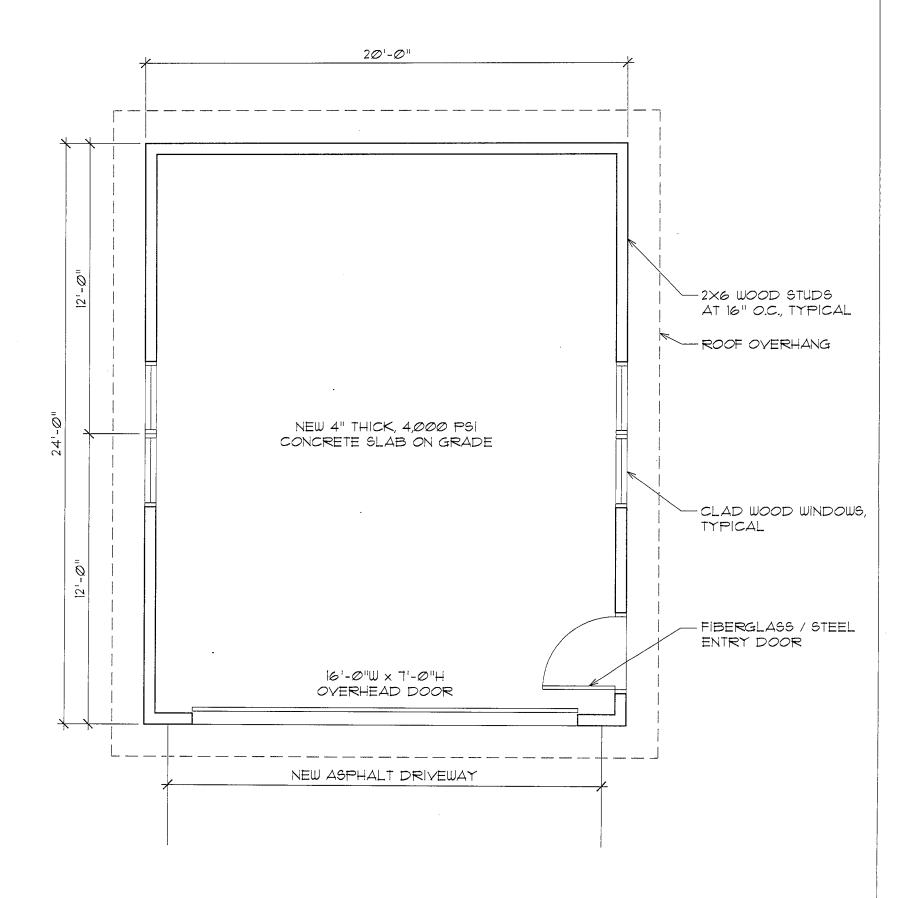



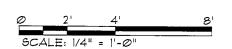

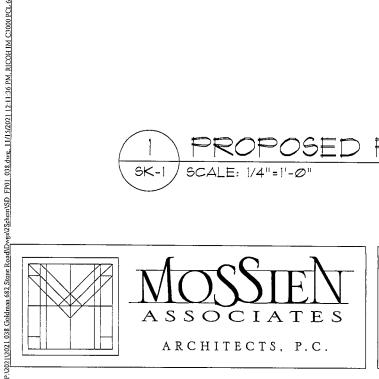

GOLDMAN RESIDENCE NEW GARAGE


> 682 STONE ROAD PITTSFORD, NY 14534







682 Stone Road - Goldman Residence Existing Barn, House & Garage - 10.12.2021




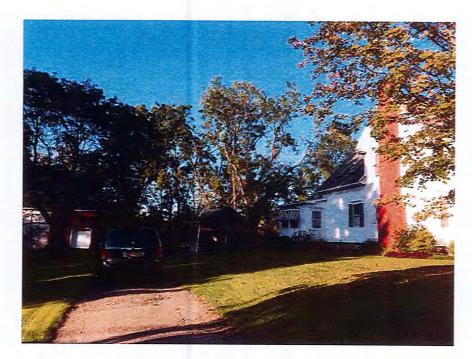


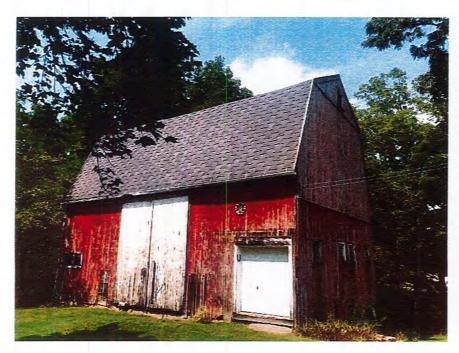

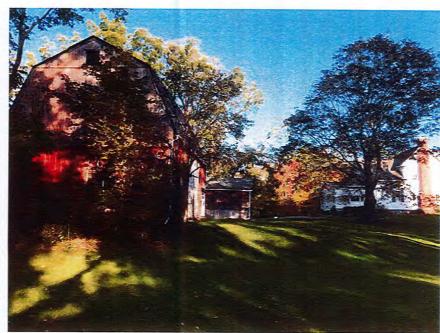

682 Stone Road - Goldman Residence Existing Garage - 10.12.2021

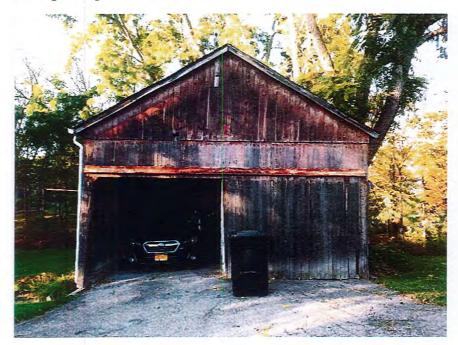

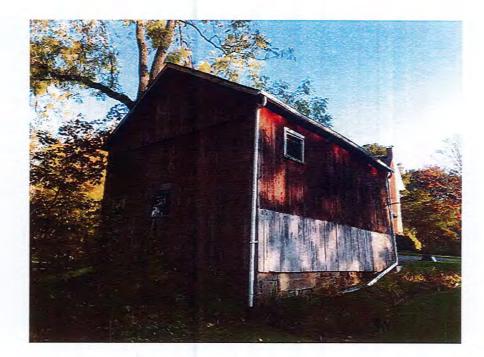






682 Stone Road - Goldman Residence Existing House - 10.12.2021





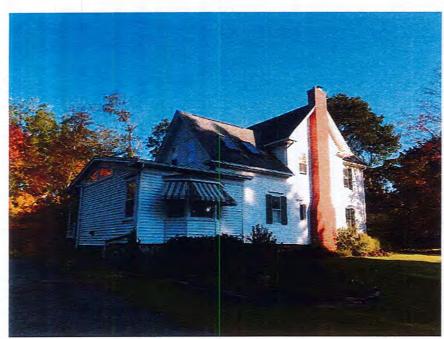








11/24/21, 8:38 AM Letter View

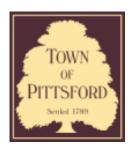

Town of Pittsford

Department of Public Works 11 South Main Street Pittsford, New York 14534

Permit # B21-000237

Phone: 585-248-6250 FAX: 585-248-6262

DESIGN REVIEW AND HISTORIC PRESERVATION BOARD REFERRAL OF APPLICATION

Property Address: 45 Country Club Drive ROCHESTER, NY 14618

Tax ID Number: 151.05-1-54

Zoning District: RN Residential Neighborhood

Owner: Margaret Boucher

Applicant: Rochester Remodeling & Home Builders

Application Type:


. P P -		
/	Residential Design Review §185-205 (B)	Build to Line Adjustment §185-17 (B) (2)
	Commercial Design Review §185-205 (B)	Building Height Above 30 Feet §185-17 (M)
	Signage §185-205 (C)	Corner Lot Orientation §185-17 (K) (3)
	Certificate of Appropriateness §185-197	Flag Lot Building Line Location §185-17 (L) (1) (c)
	Landmark Designation §185-195 (2)	Undeveloped Flag Lot Requirements §185-17 (L) (2)
	Informal Review	

Project Description: Applicant is requesting design review for the addition to an existing home. The additions will be off each side of the property as well as the back.


Meeting Date: December 09, 2021



RN Residential Neighborhood Zoning

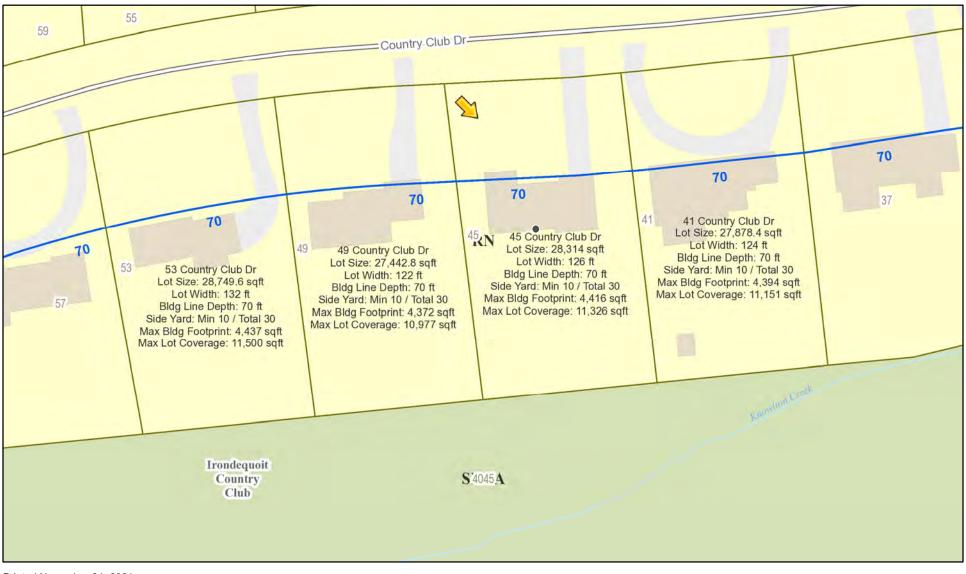


Printed November 24, 2021

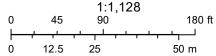

Town of Pittsford GIS



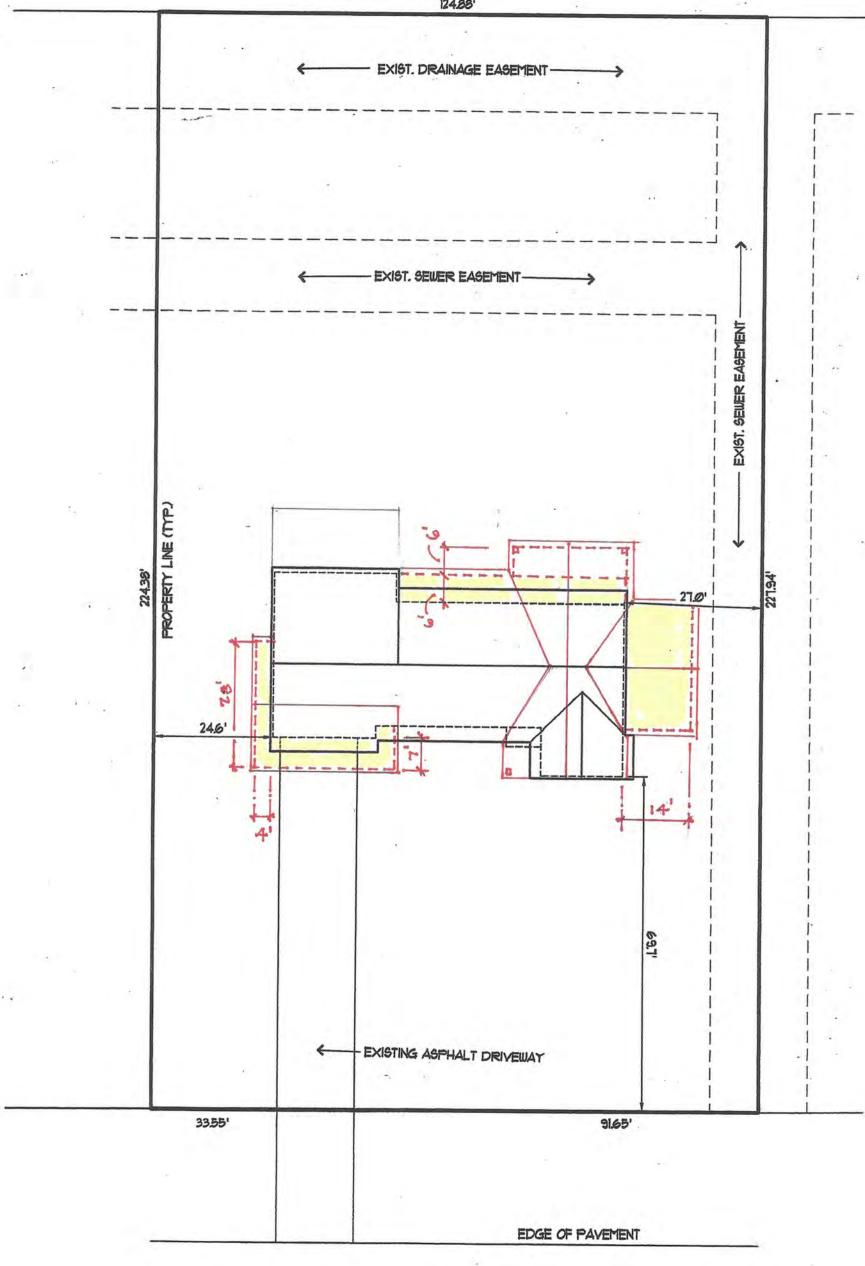


Proposed Additions to Boucher Residence

45 Country Club Drive


Site Plan

11/22/21



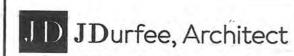

Jim Durfee | 26 Kilbourn Road, Rochester, New York 14618 585.750.9611 | jdurfee@durfeearchitect.com

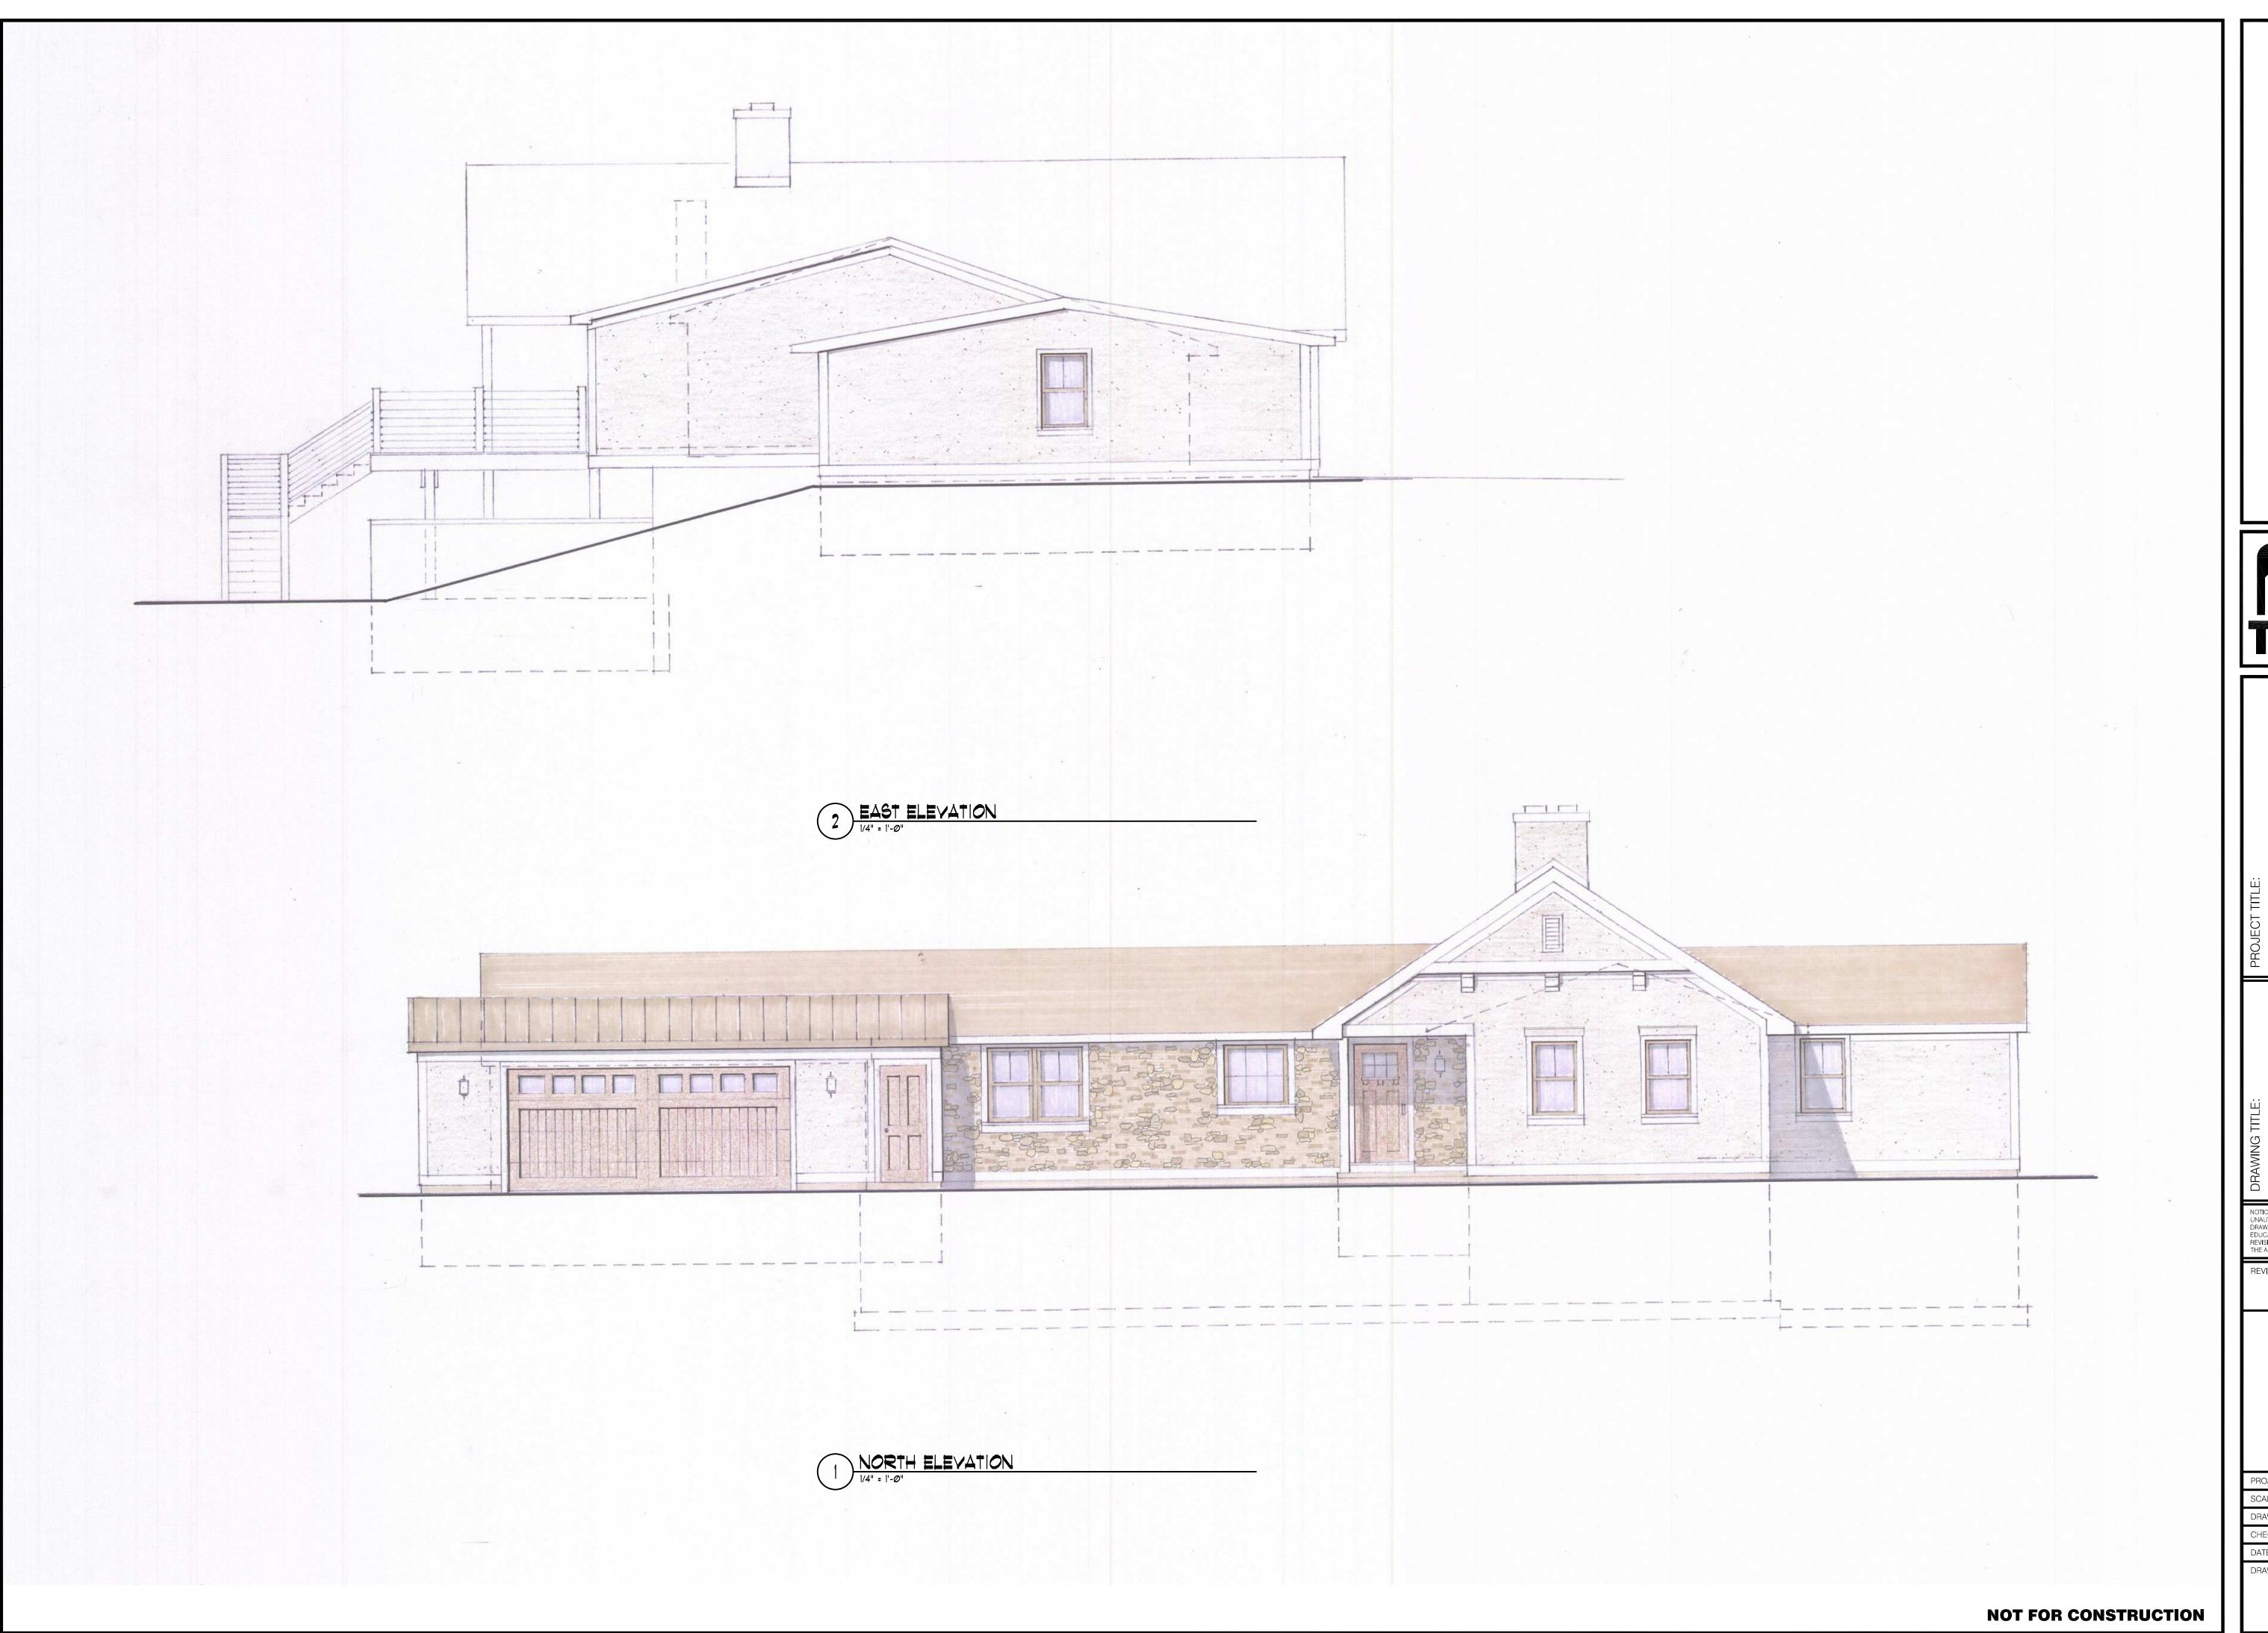

Rochester
Phone: 58
Fax: 585-3
www.TSE

ALTERATIONS TO:
THE BOUCHER RESIDENCE

ST AND NORTH
EVATIONS

NOTICE:
UNAUTHORIZED ALTERATIONS OR ADDITIONS TO THIS
DRAWING ARE IN VIOLATION OF THE NEW YORK STATE
EDUCATION LAW ARTICLE 147, SECTION 7205. NO
REVISIONS ARE PERMITTED UNLESS AUTHORIZED BY
THE ARCHITECT OF RECORD.

EVISIONS:

REVISIONS:

PROJECT NO: 21-10-05

SCALE: AS NOTED

DRAWN BY: DH

CHECKED BY: CT

DATE: 12/01/2021

SD-1



Proposed Additions to Boucher Residence

45 Country Club Drive Pittsford, NY Photos of Existing Residence (11/22/21)



North Elevation (Street View)



View Looking Northeast

Proposed Addition to Boucher Residence (continued)



South Elevation




East Elevation







11/23/21, 11:26 AM Letter View

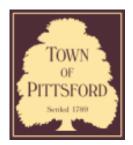

Town of Pittsford

Department of Public Works 11 South Main Street Pittsford, New York 14534

Permit # B21-000231

Phone: 585-248-6250 FAX: 585-248-6262

DESIGN REVIEW AND HISTORIC PRESERVATION BOARD REFERRAL OF APPLICATION

Property Address: 3 Summers Circle PITTSFORD, NY 14534

Tax ID Number: 177.01-4-12

Zoning District: RN Residential Neighborhood

Owner: Falcone, James P

Applicant: Santora Development

Application Type:

hh	iication Type.	
✓	Residential Design Review §185-205 (B)	Build to Line Adjustment §185-17 (B) (2)
	Commercial Design Review §185-205 (B)	Building Height Above 30 Feet §185-17 (M)
	Signage §185-205 (C)	Corner Lot Orientation §185-17 (K) (3)
	Certificate of Appropriateness §185-197	Flag Lot Building Line Location §185-17 (L) (1) (c)
	Landmark Designation §185-195 (2)	Undeveloped Flag Lot Requirements §185-17 (L) (2)
	Informal Review	

Project Description: Applicant is requesting design review for the construction of an approximately 144 SF 3 season room off the back of the house.

Meeting Date: December 09, 2021



RN Residential Neighborhood Zoning



Town of Pittsford GIS

The information depicted on this map is representational and should be used for general reference purposes only. No warranties, expressed or implied, are provided for the data or its use or interpretation.



New 3 Season Koom existing house exoting, deck Just 16 0 C windows 4 can lights of 100x64 Celling fan on existing exterin 3 additional outlets on existing curaint. 9 existing Covered purch 1/2 bead board sheeting inside. 96 x 80 French door 94x64 window hew 2x6, Frame & Will Post 3/4"dry guard serbfloor 16 OCW/ R-ZI Fibergless 12"05B Sheeting/w Vinyl Siding to match existing Spray fram_ insulation 1/2 PT Plywood_ 2×2PTCLeox

second story Porch Road SOFFI Case ment existing delication Freich existing Post South elevation


dy siding to match existing west side







12/1/21, 1:54 PM Letter View

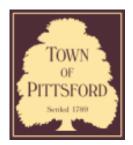

Town of Pittsford

Department of Public Works 11 South Main Street Pittsford, New York 14534

Permit # RA21-000233

Phone: 585-248-6250 FAX: 585-248-6262

DESIGN REVIEW AND HISTORIC PRESERVATION BOARD REFERRAL OF APPLICATION

Property Address: 9 High Street PITTSFORD, NY 14534

Tax ID Number: 151.14-1-55

Zoning District: RN Residential Neighborhood

Owner: Beerens, Barbara W Applicant: Beerens, Barbara W

Application Type	ogv	T۱	on	cati	oli	αA	Æ
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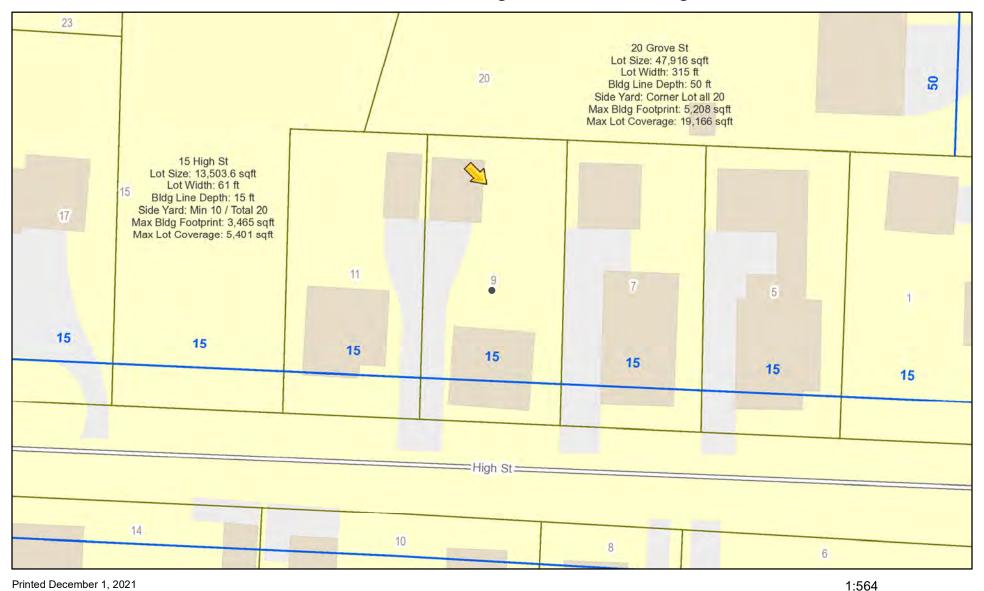
	7 1	
~	Residential Design Review	Build to Line Adjustment
	§185-205 (B)	§185-17 (B) (2)
	Commercial Design Review	Building Height Above 30 Feet
	§185-205 (B)	§185-17 (M)
	Signage	Corner Lot Orientation
	§185-205 (C)	§185-17 (K) (3)
	Certificate of Appropriateness	Flag Lot Building Line Location
	§185-197	§185-17 (L) (1) (c)
	Landmark Designation	Undeveloped Flag Lot Requirements
	§185-195 (2)	§185-17 (L) (2)
	Informal Review	

Project Description: Applicant is requesting design review for the addition of a 220 SF addition off the detached garage.

Meeting Date: December 09, 2021



RN Residential Neighborhood Zoning



Town of Pittsford GIS


20

40

10

80 ft

20 m

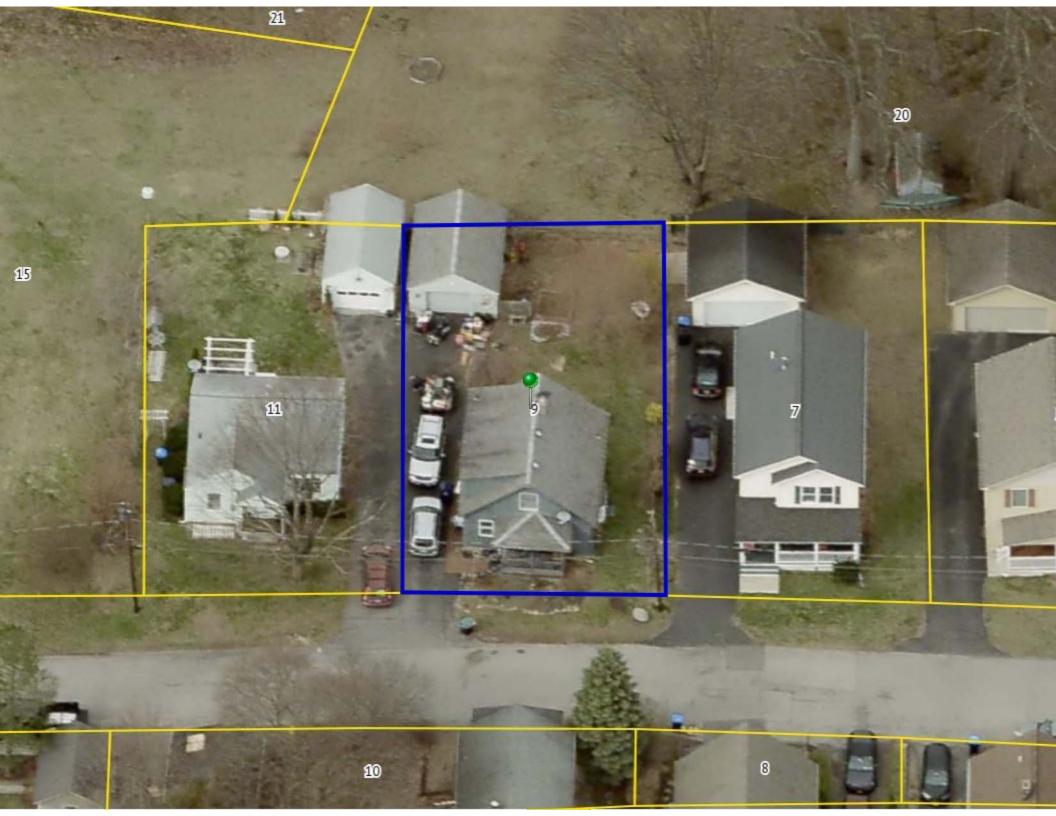

STANDARD TAPE LOCATION MAP

OKERT

ROBERT L. OWEN

- Professional Land Surveyor -

77 Thorneliff Road Phone: 352-3523 Spencerport N.V. 14550

City-

For	Parcel at PITTS Ford, Mc	Village Town County
Street 9 High STreet Reference Data Liber 25	Lot No	onroe
Reference Data: Liber 25 of Maps	Page 2.9	H-C-Clark
Showing Franc ONE story dwel		
Distance as shown from East property line actual line	ing; garage (not) attached. Monuments in Measured Main front wall in Great Main front wall in G	used [] Yes 🔯 No
line.	, and the same is (is not) an appa	irent uniform set-ba
19 Blacktop Drivs Used IN COMMON 13.17 14.5 16.4 17.0 17.0 17.0 17.0 18.0 19.0 1	9 5 to 9.5 to 9.	
HIGH		-
FINDA	STREET	
(33'w)	dE)	
TALE I'' 20		
1 (21)		

and St. This information is for ATT. Large to

This report of property for IDENTICATION PURPorts for the MORIGARDE, and is not into the or represented to a terminate property to property to the survey. No enters were set. Do not use for establishing forces or building fine.

12

9 High St. GARAGE Bundows deep 1 32" storm door windows steel roof 2x 4 walls 2x8 daybists 2x6 raftes OSB Sheating 2x6 deck floor front view of garage side of grad

side of garage












12/2/21, 8:34 AM Letter View

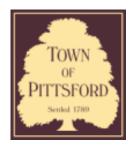

Town of Pittsford

Department of Public Works 11 South Main Street Pittsford, New York 14534

Permit # B21-000235

Phone: 585-248-6250 FAX: 585-248-6262

DESIGN REVIEW AND HISTORIC PRESERVATION BOARD REFERRAL OF APPLICATION

Property Address: 97 Country Club Drive ROCHESTER, NY 14618

Tax ID Number: 151.05-1-41

Zoning District: RN Residential Neighborhood

Owner: Stein, Mark H Applicant: Stein, Mark H

	aaA	lication	Type:
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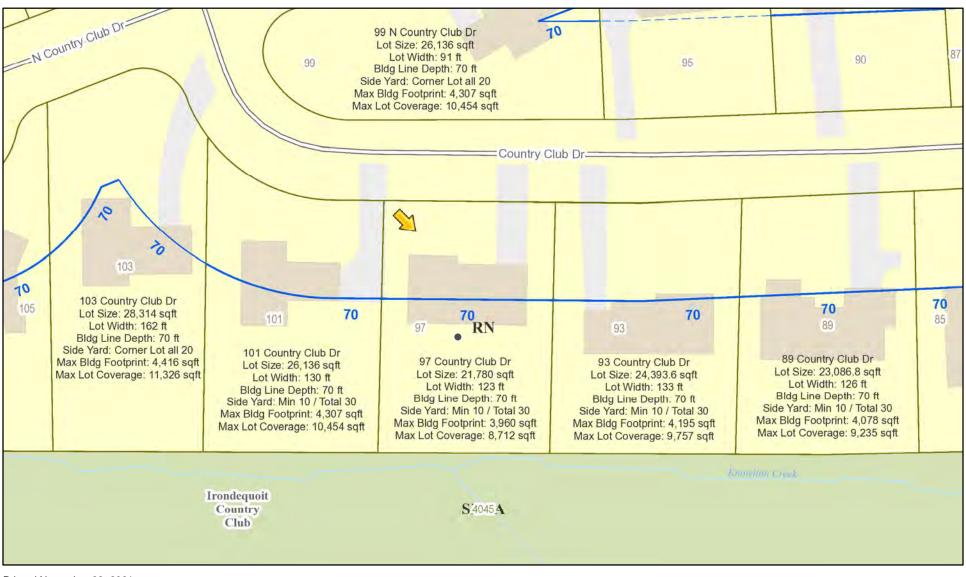
ippiioation Typo:	
Residential Design Review §185-205 (B)	Build to Line Adjustment §185-17 (B) (2)
Commercial Design Review §185-205 (B)	Building Height Above 30 Feet §185-17 (M)
Signage §185-205 (C)	Corner Lot Orientation §185-17 (K) (3)
Certificate of Appropriateness §185-197	Flag Lot Building Line Location §185-17 (L) (1) (c)
Landmark Designation §185-195 (2)	Undeveloped Flag Lot Requirements §185-17 (L) (2)
Informal Review	

Project Description: Applicant is requesting design review for the addition of an approximately 795 SF addition/renovation of the existing house as well as the addition of an approximately 500 SF garage.


Meeting Date: December 09, 2021



RN Residential Neighborhood Zoning





Printed November 22, 2021

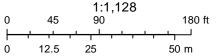

Town of Pittsford GIS




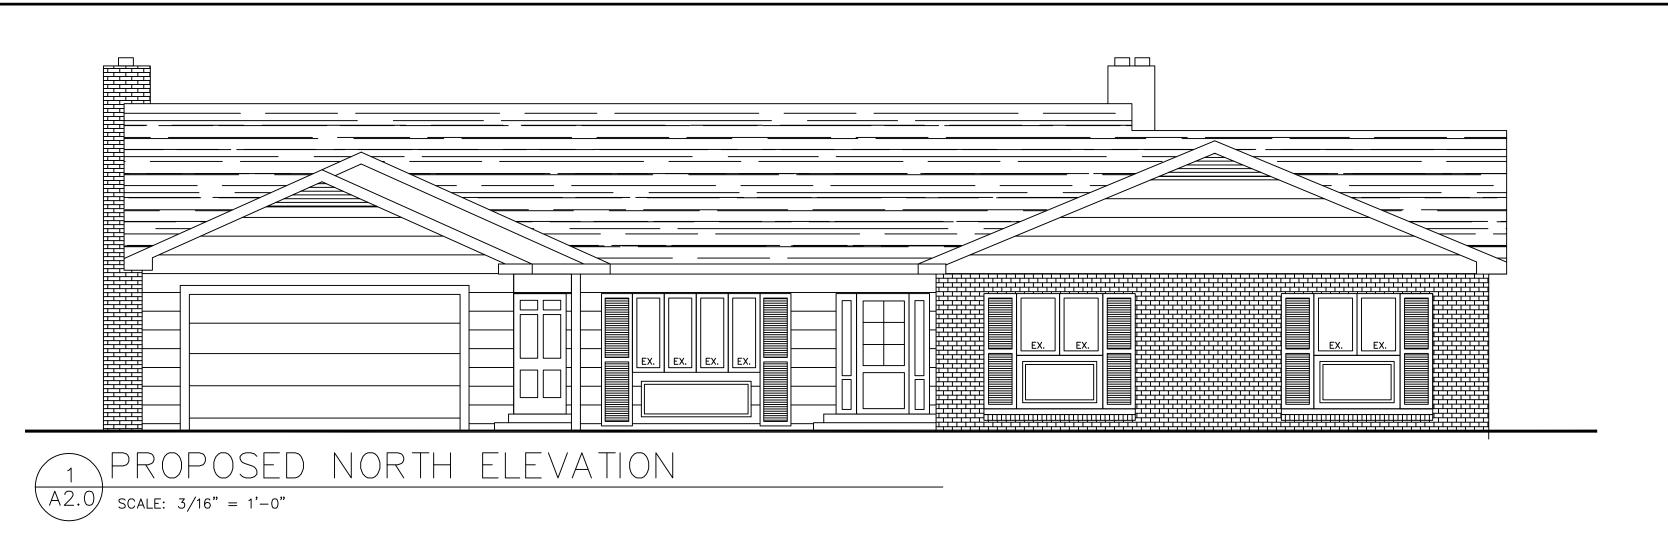

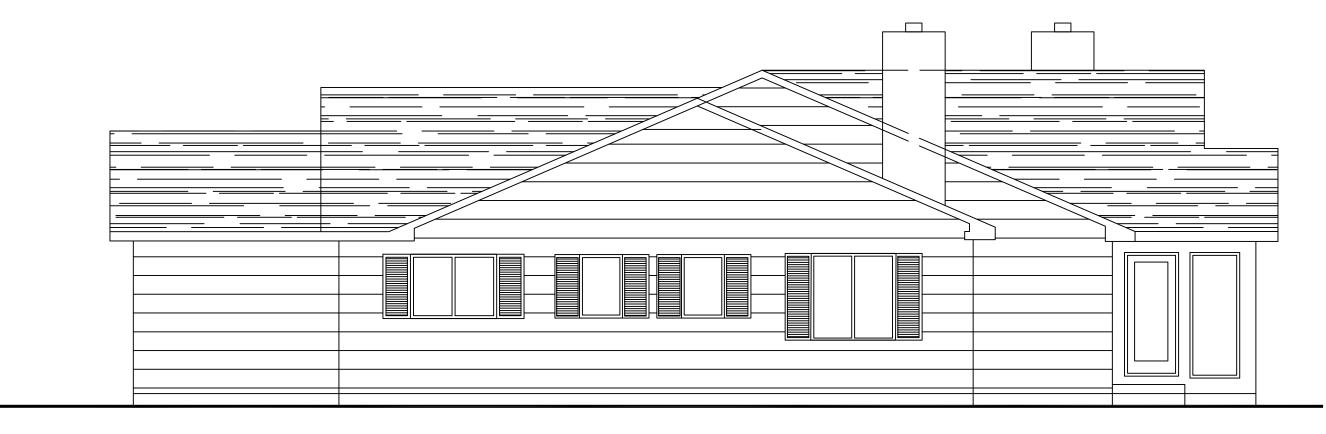


2 PROPOSED WEST SIDE ELEVATION

A2.0 SCALE: 3/16" = 1'-0"

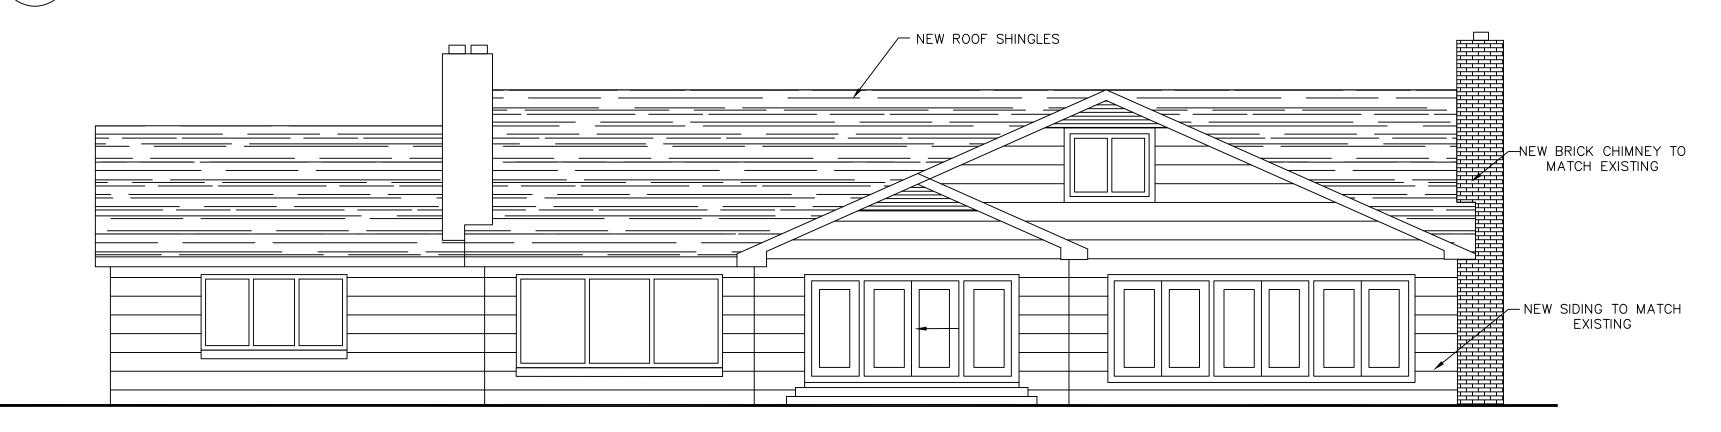

3 PROPOSED SOUTH ELEVATION

A2.0 SCALE: 3/16" = 1'-0"

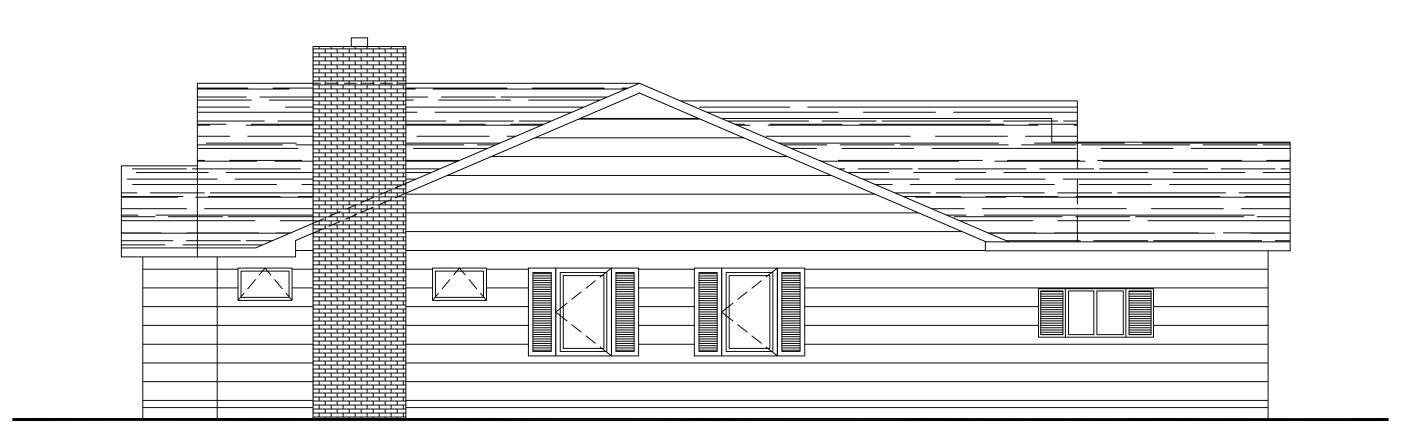

4 PROPOSED EAST SIDE ELEVATION

A2.0 SCALE: 3/16" = 1'-0"



300 State Street, Suite 201 Rochester, NY 14614 585-454-6110

labellapc.com

It is a violation of New York Education Law Article 145 Sec.7209, for any person, unless acting under the direction of a licensed architect, professional engineer, or land surveyor, to alter an item in any way. If an item bearing the seal of an architect, engineer, or land surveyor is altered; the altering architect, engineer, or land surveyor shall affix to the item their seal and notation "altered by" followed by their signature and date of such alteration, and a specific description of the alteration.

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ADDITIONS & RENOVATION PLANS FOR:

STEIN RESIDENCE


97 COUNTRY CLUB DRIVE PITTSFORD, NY


NO:	DATE:	DESCRIPTION:
REVISIONS		
PROJECT N	IUMBER:	
		P2100259
DRAWN BY		SM
REVIEWED	BY:	SM, TM
ISSUED FO		CHEMATIC DRAWINGS
DATE:		10/21/21
DRAWING 1	\ \ \ \ \ \ \ \ \ \ \ \ \ \	

PROPOSED ELEVATIONS

DRAWING NUMBER:

A2.0

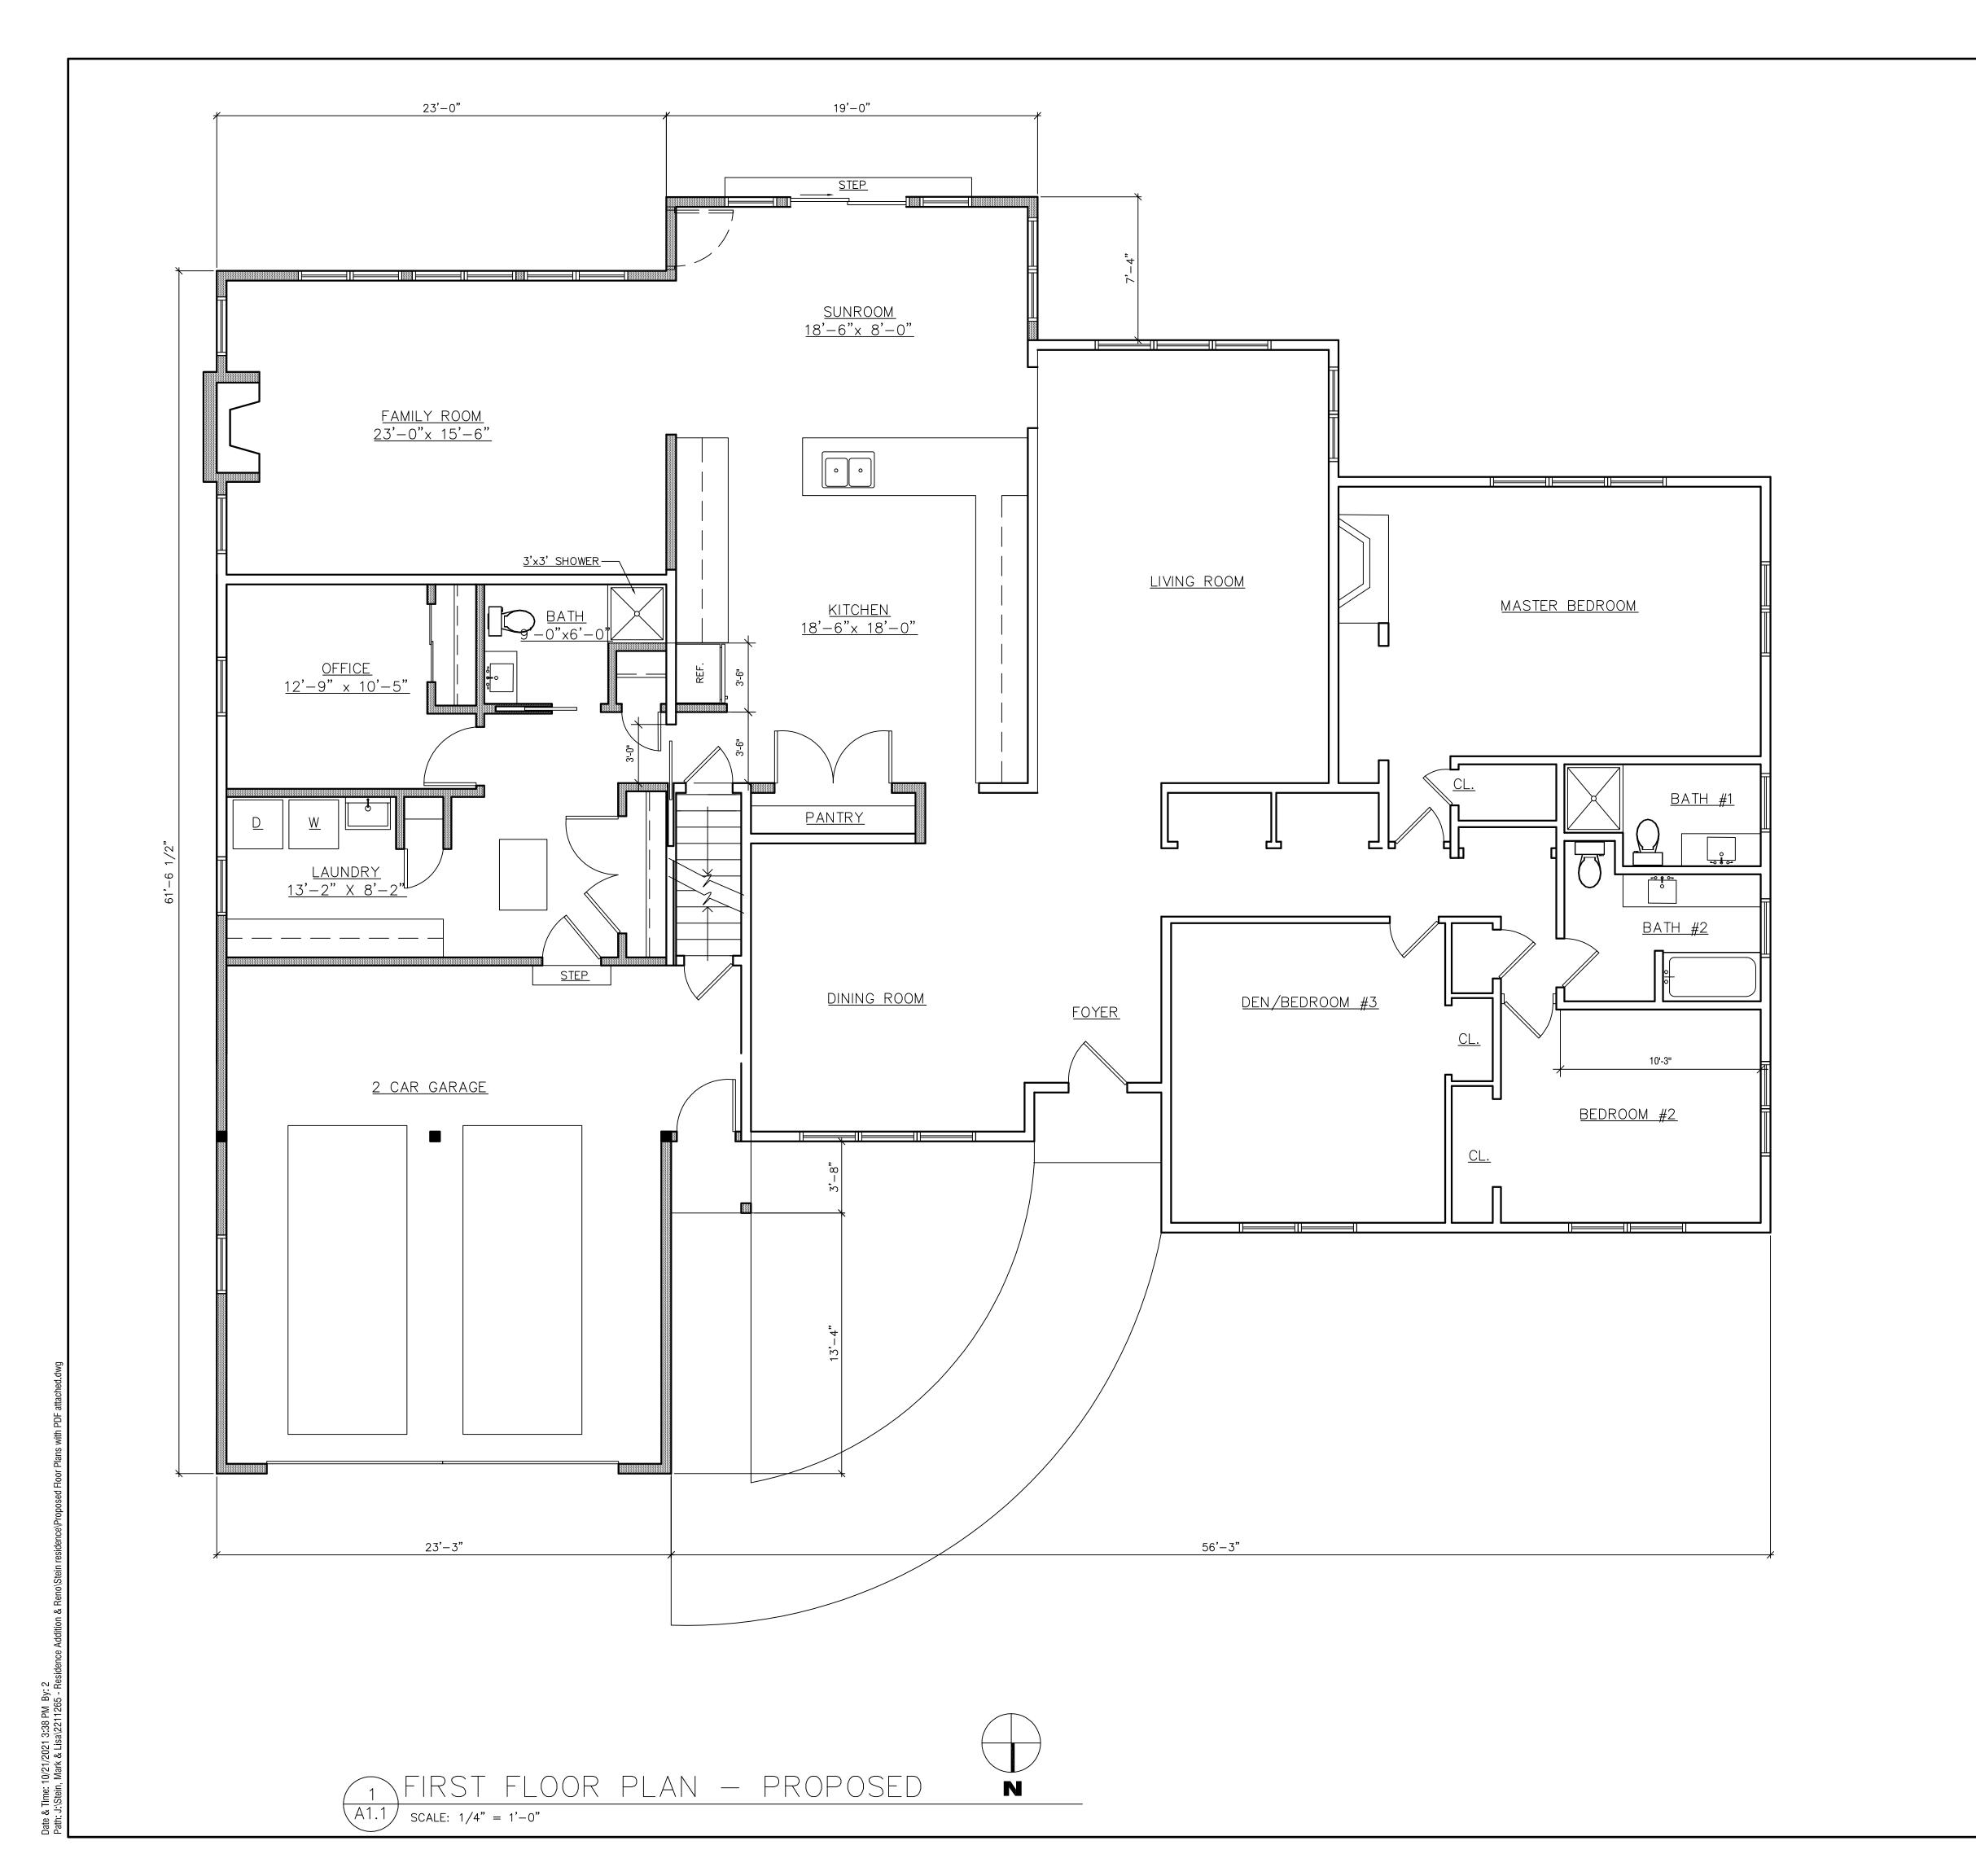

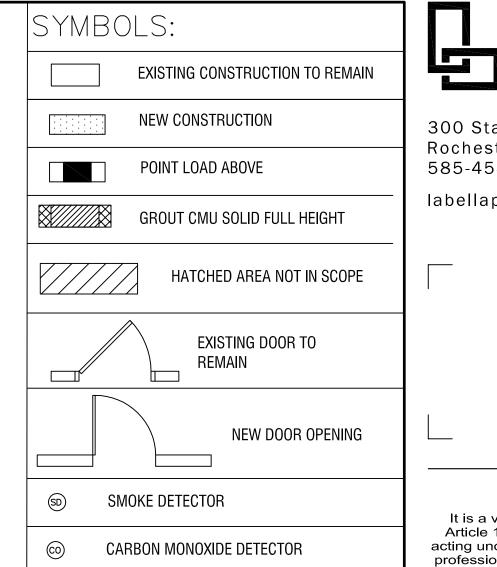

SHEET NUMBER (BOTTOM) FLOOR PLAN NOTES

DETAIL REFERENCE: DETAIL NUMBER (TOP) SHEET NUMBER (BOTTOM)

AXXX

1) ALL DIMENSIONS TO BE TAKEN FROM CENTERLINE OF WALL UNLESS INDICATED OTHERWISE. REFER TO PARTITION TYPES FOR ACTUAL DIMENSION

ELEVATION REFERENCE:

ELEVATION NUMBER (TOP)

- 2) JOINTS ABUTTING EXISTING WALLS ARE TO BE TAPED AND FINISHED
- 3) COORDINATE NEW DATA & POWER LOCATIONS WITH
- 4) CONTRACTOR SHALL PROVIDE BLOCKING AS REQUIRED FOR ALL MILLWORK AND EQUIPMENT INSTALLATION
- 5) FURNITURE AND EQUIPMENT TO BE PROVIDED BY OWNER. VERIFY FINAL LOCATION AND REQUIREMENTS OF ALL EQUIPMENT WITH OWNER
- 6) PATCH ALL EXISTING WALLS AS REQUIRED; PREPARE ALL WALLS FOR PAINT.
- 7) PROVIDE SOLID COMPACTION WITH NEW FILL AT DEMOLITION OF EXISTING FOUNDATIONS FOR NEW CONSTRUCTION.



300 State Street, Suite 201 Rochester, NY 14614 585-454-6110

labellapc.com

It is a violation of New York Education Law Article 145 Sec.7209, for any person, unless acting under the direction of a licensed architect, acting under the direction of a licensed architect, professional engineer, or land surveyor, to alter an item in any way. If an item bearing the seal of an architect, engineer, or land surveyor is altered; the altering architect, engineer, or land surveyor shall affix to the item their seal and notation "altered by" followed by their signature and date of such alteration, and a specific description of the alteration.

© 2019 LaBella Associates

ADDITIONS & RENOVATION PLANS FOR:

> STEIN **RESIDENCE**

97 COUNTRY CLUB DRIVE PITTSFORD, NY

NO:	DATE:	DESCRIPTION:
REVISIONS		•
PROJECT N	IUMBER:	
		P2100259
DRAWN BY	:	SM
REVIEWED	BY:	SM, TM
SSUED FO		SCHEMATIC DRAWING
DATE:		10/21/21

PROPOSED FLOOR PLAN


DRAWING NUMBER:







11/30/21, 1:58 PM Letter View

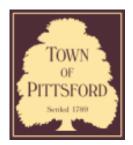

Town of Pittsford

Department of Public Works 11 South Main Street Pittsford, New York 14534

Permit # B21-000232

Phone: 585-248-6250 FAX: 585-248-6262

DESIGN REVIEW AND HISTORIC PRESERVATION BOARD REFERRAL OF APPLICATION

Property Address: 7 Round Trail Drive PITTSFORD, NY 14534

Tax ID Number: 178.07-2-64

Zoning District: RN Residential Neighborhood

Owner: Cohn, Michael H
Applicant: Marshall Exteriors

Αr	lge	icati	on	Τv	pe:
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ippiiodiioii iypoi	
Residential Design Review §185-205 (B)	Build to Line Adjustment §185-17 (B) (2)
Commercial Design Review §185-205 (B)	Building Hèight Ábove 30 Feet §185-17 (M)
Signage §185-205 (C)	Corner Lot Orientation §185-17 (K) (3)
Certificate of Appropriateness §185-197	Flag Lot Building Line Location §185-17 (L) (1) (c)
Landmark Designation §185-195 (2)	Undeveloped Flag Lot Requirements §185-17 (L) (2)
Informal Review	

Project Description: Applicant is requesting design review for the construction of approximately an 120 SF sunroom on the existing deck.


Meeting Date: December 09, 2021



RN Residential Neighborhood Zoning



Printed November 30, 2021

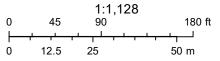

Town of Pittsford GIS









Centered on Sliding Patio



Complete Measurements

7 Round Trail Drive, Pittsford, NY

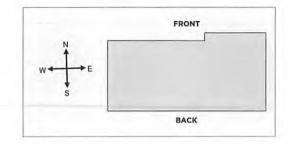

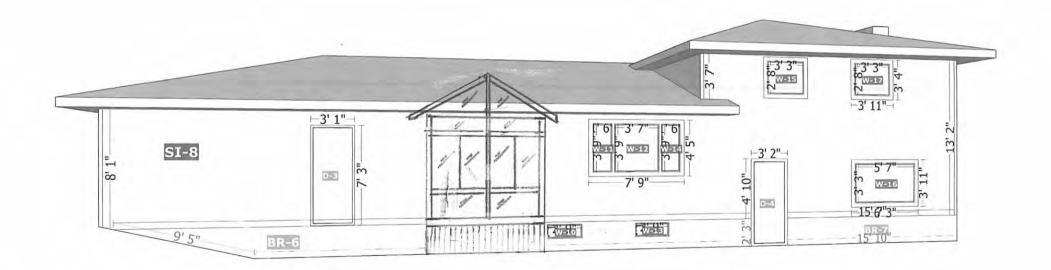



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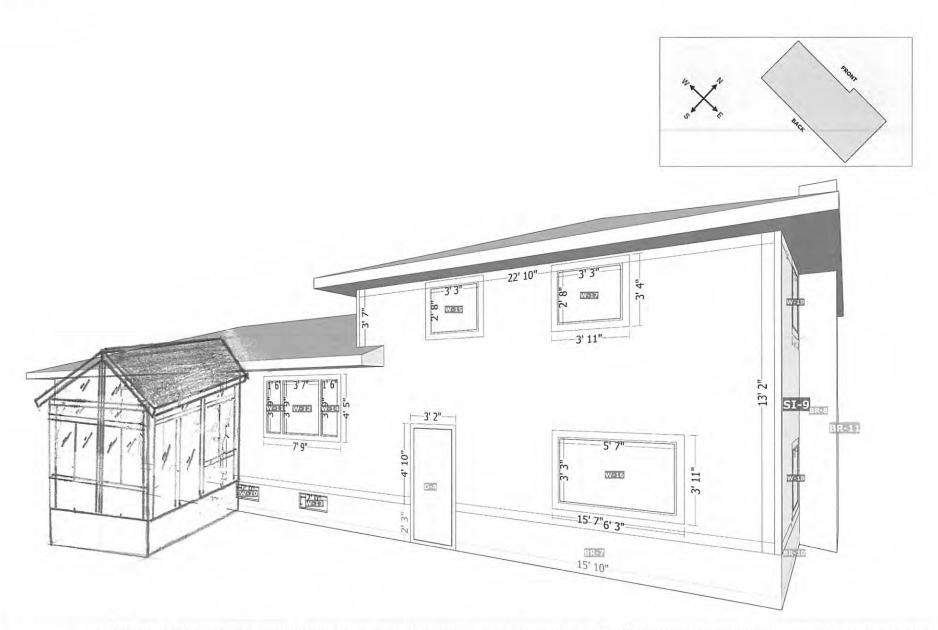
PROPERTY ID: 5493117 COHN

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Complete Measurements

7 Round Trail Drive, Pittsford, NY






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PROPERTY ID: 5493117 COHN

30 NOV 2021

Page 15



NOTES.

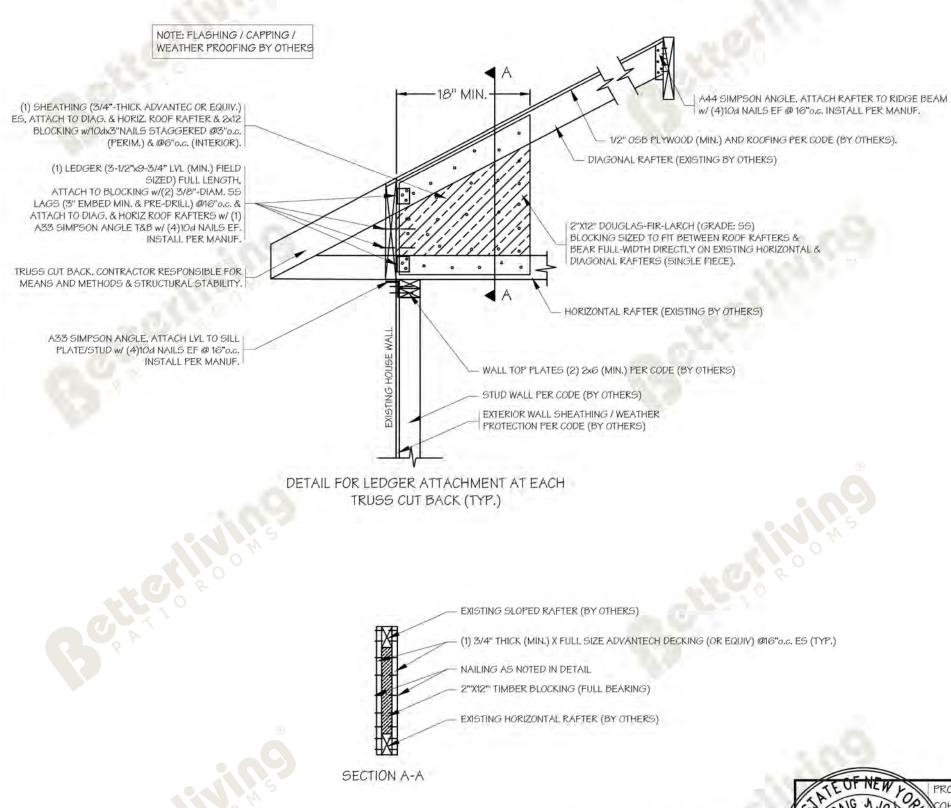 MINIMUM PROPERTIES FOR SPECIES: DOUGLAS-FIR-LARCH (GRADE STRUCTURAL SELECT (SS):

BENDING STRESS Fb (PSI): 1,500

TENSION PARALLEL TO GRAIN Ft (PSI): 1,000

SHEAR PARALLEL TO GRAIN Fv (PSI): 180

COMP. PERP. TO GRAIN Fop (PSI): 625

COMP. PARALLEL TO GRAIN Fol (PSI): 1,700

MODULUS OF ELASTICITY E (PSI): 1,900,000

SPECIFIC GRAVITY: 0.5

- 2. REF: 2018 NDS DESIGN VALUES FOR WOOD CONSTRUCTION
- ALL LUMBER EXPOSED TO WEATHER / WATER / CONCRETE / MASONRY / FUNGUS / TERMITE
 OR ANY TYPE OF DECAY TO BE PRESSURE TREATED / WOLMANIZED AND/OR PROTECTED
 PER CODE AND INSTALLED PER MANUFACTURER'S INSTRUCTIONS.
- 4. EXISTING MEMBERS TO BE ENGINEERED ACCORDING TO LOCAL CODES.
- CONTRACTOR TO INSPECT ALL EXISTING CONDITIONS AND AS NECESSARY REPAIR AND/OR REPLACE ALL MATERIALS AS REQUIRED TO RENDER THEM STRUCTURALLY SOUND AND COMPLETE...
- 6. AUTHORIZED FOR BETTERLIVING DEALER USE ONLY.
- ALL EXISTING HOUSE WALL COMPONENTS TO BE VERIFIED TO COMPLY WITH LOCAL CODES (BY OTHERS).
- 8. REPAIR / REPLACE CRACKED / DAMAGED LUMBER.
- 9. WEATHER PROOFING, CAPPING, FLASHING, BY OTHERS.
- 10. CONTRACTOR RESPONSIBLE FOR STRUCTURAL STABILITY AND MEANS & METHODS.

NYS PE NOTE: IT IS A VIOLATION OF NY STATE ARTICLE 145, PROFESSIONAL ENGINEERING, LAND SURVEYING AND GEOLOGY 7209. SPECIAL PROVISIONS, FOR ANY PERSON, UNLESS HE OR SHE IS ACTING UNDER THE DIRECTION OF A LICENSED PROFESSIONAL ENGINEER OR LAND SURVEYOR, TO ALTER AN ITEM IN ANY WAY ON PLANS, SPECIFICATIONS, PLATS AND REPORTS TO WHICH THE SEAL OF A PROFESSIONAL ENGINEER OR LAND SURVEYOR HAS BEEN APPLIED.



CONTRACTOR:

MARSHALL EXTERIORS, LLC
171 WEST SHORE BLYD.

NEWARK, NY 14513

DWG NO.: SHEET OF 6

Cohn-Gbi-Encl-12' x 10'-a

REV: R1 DATE: 10/25/21

EXISTING ROOF OVERHANG CUT BACK TYP.

FOR NOTES SEE SHEET 1 - PROJECT NOTES

101

GENERAL NOTES:

- 1. PER 2020 RCNYS / 2018 IRC R301.2.1.1.1 SUNROOMS, "SUNROOMS SHALL COMPLY WITH AAMA/NPEA/NSA Z100." CATEGORY III: A THERMALLY ISOLATED SUNROOM WITH ENCLOSED WALLS. THE OPENINGS ARE ENCLOSED WITH TRANSLUCENT OR TRANSPARENT PLASTIC OR GLASS, THE SUNROOM FENESTRATION COMPLIES WITH ADDITIONAL REQUIREMENTS FOR AIR INFILTRATION RESISTANCE AND WATER PENETRATION RESISTANCE. THE SPACE IS NON-HABITABLE AND UNCONDITIONED
- 2. ENCLOSURES TO BE INSTALLED BY BETTERLIVING DEALER USING MATERIALS SUPPLIED BY CRAFTBILT MANUFACTURING COMPANY (CBM).
- 3. MINIMUM DESIGN LOADS FOR BUILDINGS AND OTHER ENCLOSED STRUCTURES PER ASCE 7-16 AS REFERENCED IN
- 4. LOCAL DESIGN LOADS:
- GROUND SNOW LOAD 40 PSF
- WIND SPEED 120 MPH, EXP B.
- 5. ALLOWABLE STRESS DESIGN PER ALUMINUM DESIGN MANUAL (2015)
- 6. ALLOWABLE DEFLECTION NOT TO EXCEED L/120 PER IRC TABLE R301.7, NOTE c.
- 7. PROVIDE GUARDS ALONG OPEN-SIDED WALKING SURFACES (STAIRS, RAMPS, DECKS & LANDINGS) LOCATED
- 30-INCHES OR MORE ABOVE GRADE PER IRC R312.1.1, R312.1.2, R312.1.3. 6. PROVIDE WINDOW FALL PROTECTION AT OPENINGS OF OPERABLE WINDOWS LOCATED MORE THAN 72-INCHES ABOVE
- FINISHED GRADE PER IRC R312.2. 9. EXISTING CONDITIONS TO BE INSPECTED BY CONTRACTOR AND ALL MATERIALS REPAIRED AND/OR REPLACED AS
- REQUIRED TO RENDER THEM STRUCTURALLY SOUND AND COMPLETE.
- IO. CONTRACTOR SOLEY RESPONSIBLE FOR MEANS AND METHODS DURING ALL PHASES OF CONSTRUCTION
- 11. OWNER/CONTRACTOR JOINTLY RESPONSIBLE FOR COMPLIANCE WITH ALL REQUIREMENTS OF AUTHORITY HAVING JURISDICTION (AHJ):
- 12 ANY DISCREPANCIES OR DEVIATIONS FROM DRAWING(S) REQUIRE REVISED ENGINEERING.
- 13. DRAWINGS APPLY ONLY TO STRUCTURAL / FRAMING ELEMENTS OF PROJECT.
- 14. DRAWINGS NOT TO SCALE. SCALING OF DIMENSIONS OFF DRAWINGS NOT PERMITTED
- 15. ALUMINUM SHOULD NOT BE USED IN DIRECT CONTACT WITH PRESERVATIVE TREATED WOOD.
- 16. STUDIO ENCLOSURES EXCEEDING 18FTx20FT AND GABLE ENCLOSURES EXCEEDING 18FTx20FT IN SIZE REQUIRE SITE SPECIFIC ENGINEERING DRAWINGS.
- 17. STUDIO / GABLE ENCLOSURES IN HIGH SNOW LOAD (>40 PSF) AND/OR HIGH WIND AREA REQUIRE SITE SPECIFIC ENGINEERING DRAWINGS.

FRAMING NOTES:

- 1. FRAMING SHAPES AND SIZES SHOWN ON APPROVED FRAMING DRAWINGS / FASTENER TABLES REPRESENT MINIMUM DIMENSIONS TO RESIST COMBINED WIND AND ALLOWABLE GROUND SNOW LOADS (SEE TABULATED VALUES).
- 2. EXTRUDED FRAMING SECTIONS TO USE 6063-T6 ALUMINUM ALLOY / TEMPER (OR BETTER) PER MANUFACTURE
- 3. ALL STRUCTURAL COLUMNS TO BE CONTINUOUS FROM FLOOR TO ROOF.
- 4. ALL STRUCTURAL BEAMS TO BE CONTINUOUS BETWEEN SUPPORTS.
- 5. END BEARING OF FRAMING MEMBER(S) TO BE UNIFORM ACROSS FULL CROSS SECTION.
- 6. BUILTUP FRAMING MEMBERS TO BE MECHANICALLY CONNECTED IN FIELD TO ACT AS A SINGLE MEMBER (MIN. 2#85D5 @6"oc/PLY).
- 7. BARRIER MEMBRANE(5)/COATINGS TO BE INSTALLED TO PROTECT ALUMINUM MEMBERS FROM GALVANIC ACTION BY OTHER METALS AND TO PREVENT CORROSION FROM CONTACT WITH CONCRETE, WOOD TREATMENTS AND OTHER MATERIALS.
- 8. MAXIMUM MEMBER LENGTH / HEIGHT NOT TO EXCEED DIMENSIONS SHOWN & TABULATED VALUES.
- 9. MULLION SPACING NOT TO EXCEED THE LESSOR OF 7.5FT OR ONE HALF THE WALL DIMENSION
- 10. WALL HEIGHT NOT TO EXCEED 98-3/4" (ALUMINUM ENCLOSURES) OR 111-3/4" (VINYL ENCLOSURES).

- 1. FASTENER SIZES AND QUANTITIES SHOWN ON APPROVED CONNECTION DRAWINGS REPRESENT MINIMUM INSTALLATION TO RESIST COMBINED SNOW AND WIND LOADING IN TABLES.
- 2. USE FASTENERS THAT COMPLY WITH BUILDING CODES,
- 3. USE FASTENERS THAT RESIST CORROSION BY ACQ-C, ACQ-D AND CA-B OR OTHER TREATED LUMBER (WHERE APPLICABLE) AND/OR GALVANIC ACTION WHEN FASTENED THROUGH DISSIMILAR MATERIALS.
- 4. HOT-DIPPED GALVANIZED COATED FASTENERS TO CONFORM TO ASTM A153 OR BETTER.
- 5. HOT-DIPPED GALVANIZED COATED CONNECTORS TO CONFORM TO ASTM A653 (CLASS G-185) OR BETTER
- 6. STAINLESS STEEL FASTENERS AND CONNECTORS TO BE USED IN HIGHLY CORROSIVE ENVIRONMENTS AS REQUIRED BY BUILDING CODES, MOST COMMONLY AVAILABLE ELECTROPLATED GALVANIZED FASTENERS DO NOT HAVE A SUFFICIENT COATING OF ZINC AND ARE NOT RECOMMENDED.
- 7. NEVER MIX GALVANIZED STEEL WITH STAINLESS STEEL IN THE SAME CONNECTION.
- B. FASTENERS IN LUMBER (0.5 ≥ G ≥ 0.6) TO BE INSTALLED INTO PRE-DRILLED HOLES WITH DIAMETER NOT EXCEEDING FASTENER SHANK MIN DIAMETER (0.153" DIA FOR #10 WOOD SCREWS, 0.150" DIA FOR #12 WOOD SCREWS, 0.171" DIA FOR #14 WOOD SCREWS / 0.25" DIA. LAGS) PER FASTENER MANUFACTURER'S INSTRUCTIONS.
- 9. MINIMUM SPACING BETWEEN FASTENERS TO BE 2.5xNOMINAL FASTENER DIAMETER.
- 10. MINIMUM SPACING FROM FASTENER TO EDGE OF PART TO BE 1.5xNOMINAL FASTENER DIAMETER.
- 11. ALL OVERDRIVEN FASTENERS TO BE REPLACED IN NEW HOLES.
- 12. BOLT HOLES TO BE 1/32-INCH TO 1/16-INCH DIAMETER LARGER THAN THE BOLTS.
- 13. BOLTS TO MEET OR EXCEED ASTM A 307 OR SAE J429 GRADES 1 OR 2, OR BETTER.
- 14. BOLT TO EXTEND THROUGH THE FULL THICKNESS OF THE MEMBERS
- 15. BOLTS TO BE USED WITH WASHERS NOT LESS THAN A STANDARD CUT WASHER UNDER THE HEAD AND NUT MEETING ANSI B18 221
- 16. FASTENER QUANTITY / SPACING DESIGNATION 2x6 IN TABLES REQUIRES 2 ROWS OF 6 FASTENERS, OF TYPE SHOWN IN TABLE
- 17. FOR CONNECTIONS TO MASONRY/SOLID CMU, REPLACE LAGS WITH SAME DIAMETER HILTI ADHESIVE ANCHORS / TAPCONS / NAIL ANCHORS. INSTALL PER MANUFACTURER INSTRUCTIONS.
- 18. MASONRY VENEER IS NON-STRUCTURAL. DRILL THRU VENEER AND ATTACH LAGS DIRECTLY TO STRUCTURAL

WINDOWS & DOORS NOTES:

- WINDOW AND DOOR UNIT DESIGN PRESSURE (DP) RATINGS TO SATISFY ALL CODE REQUIREMENTS.
- WINDOW AND DOOR UNITS IN CONDITIONED SPACES TO COMPLY WITH ENERGY RATINGS PER CODE.
- 3. GLAZING USED IN DOORS AND WINDOWS TO BE TEMPERED OR, IF INSTALLED IN HAZARDOUS LOCATIONS, TO CONFORM TO CODE GLAZING REQUIREMENTS IRC R308.

CBM ROOF / WALL PANEL NOTES:

- TYPES, SIZES AND ATTACHMENTS OF STRUCTURAL PANELS SHOWN ON APPROVED LAYOUT DRAWINGS TO BE SELECTED TO RESIST COMBINED SNOW AND WIND LOADING (SEE TABULATED VALUES) USING PUBLISHED EVALUATION REPORT AND/OR CBM RECOMMENDATIONS
- PANELS TO USE 3004 H374 ALUMINUM ALLOY / TEMPER (OR BETTER).
- 3. PANELS/PANEL CORES TO BE CONTINUOUS BETWEEN SUPPORTS.
- PANELS TO BE INSTALLED WITH CONTINUOUS CBM SILICONE SEALANT (MIN 1.5" WIDTH) ON ALL CONTACT SURFACES.
- ALL CONTACT SURFACES TO BE PROPERLY CLEANED PER MANUFACTURER, PRIOR TO APPLYING SEALANT.
- ALL PANELS TO BE MECHANICALLY ANCHORED PER APPROVED DRAWINGS AND TABLES.
- ALL PANELS TO BE INSTALLED WITH AL H-STIFFENERS ALONG ADJOINING EDGES.
- 8. ALL PANELS TO BE ATTACHED TO H-STIFFENERS (MIN #8 5DS TEK @ 6"0C) OR AS REQUIRED TO ACHEIVE FIRE RATINGS.
- 9. PANELS TO BE USED ONLY IN ONE STORY ENGLOSURES OF CONSTRUCTION TYPE VB. AS PERMITTED BY CODE
- 10. PANELS TO BE USED ONLY IN ENCLOSURES WHERE CLASS B OR CLASS II INTERIOR FINISHES ARE PERMITTED BY
- 11. PANEL OVERHANG AT ROOM PERIMETERS NOT TO EXCEED 12-INCHES

FOOTING/FOUNDATION NOTES:

- 1. PROVISIONS OF IRC CHAPTER 4 SHALL CONTROL CONSTRUCTION OF FOUNDATIONS.
- 2. IN LIEU OF A COMPLETE GEOTECHNICAL EVALUATION, THE LOAD-BEARING VALUES IN TABLE R401.4.1 (SEE BELOW) SHALL BE ASSUMED PER IRC R401.4.1.
- REQUIRED MINIMUM FOOTING DIAMETERS/DIMENSIONS FOR CLAY, SANDY CLAY, SILTY CLAY, CLAYEY SILT, SILT AND SANDY SILT (CL. ML, MH AND CH) WITH PRESUMPTIVE LOAD-BEARING* = 1,500 PSF

FOOTING A (IN) = 22 DIA OR 20 X 20 SQUARE FOOTING B (IN) = 16 DIA

4. REQUIRED MINIMUM FOOTING DIAMETERS/DIMENSIONS FOR SAND, SILTY SAND, CLAYEY SAND, SILTY GRAVEL AND CLAYEY GRAVEL (SW. SP. SM. SC. GM. & GC) WITH

PRESUMPTIVE LOAD-BEARING* = 2,000 PSF-

FOOTING A (IN) = 20 DIA OR 18 X 18 SQUARE FOOTING B (IN) = 14 DIA

5. REQUIRED MINIMUM FOOTING DIAMETERS/DIMENSIONS FOR SANDY GRAVEL AND/OR GRAVEL (GW AND GP) WITH PRESUMPTIVE LOAD-BEARING* = 3,000 PSF

FOOTING A (IN) = 18 DIA FOOTING B (IN) = 12 DIA

NOTE: * PRESUMPTIVE LOAD-BEARING VALUES OF FOUNDATION MATERIALS FROM IRC TABLE R401.4.1. CLASS OF MATERIAL TO BE FIELD VERIFIED AT JOBSITE (BY OTHERS)

- 6. CONSTRUCT CONCRETE FOOTING PER IRC R403 OR ACI 332.
- MINIMUM SIZES FOR CONCRETE FOOTINGS TO BE 12-INCHES OR PER IRG R403.1.1, TABLES R403.1.& FIGURE R403.1(1) / FIGURE R403.1.3, AS APPLICABLE.
- MINIMUM DEPTH FOR CONCRETE FOOTINGS TO BE 12-INCHES BELOW UNDISTURBED GROUND SURFACE AND SHALL CONFORM TO IRC R403.1.4.1 PER IRC R403.1.4.
- FOOTINGS TO BE SUPPORTED ON UNDISTURBED NATURAL SOILS OR ENGINEERED FILL PER IRC R405.1. WHEN QUESTIONABLE SOILS, UNDERPINNING / SLOPING / UNSTABLE CONDITIONS, OR LOADING OF ADJACENT STRUCTURES EXIST PER IRC R401.4 & R403.1.7, CONSULT A GEOTECHNICAL ENGINEER.
- 10. PROTECT FOOTING EXCAVATIONS FROM WEATHER INCLUDING PRECIPATION / FREEZING.
- 11. UNDER NO CIRCUMSTANCES SHALL NEW FOOTING EXCAVATIONS EXTEND BELOW DEPTH OF ADJACENT EXISTING FOOTINGS.
- 12. PROTECT FOUNDATION WALLS, PIERS AND OTHER PERMANENT SUPPORTS OF BUILDINGS & STRUCTURES FROM FROST PER IRC R403141
- 13. MINIMUM CONCRETE COMPRESSIVE STRENGTH FOR FOOTINGS TO BE 3,000 PSI AT 28 DAYS OR PER IRC R402.2 & TABLE R402.2. MATERIALS FOR CONCRETE SHALL COMPLY WITH IRC R608.5.1.
- 14. FOOTING AND STEM WALL REINFORCEMENT SHALL COMPLY WITH IRC R403.1.3.5.1 THROUGH R403.1.3.5.4, AS **APPLICABLE** 15. MASONRY SYSTEMS SHALL HAVE A MINIMUM SPECIFIED COMPRESSIVE STRENGTH OF 1,500 PSI PER IRC 402.4.

DECK NOTES:

- 1. CONSTRUCT WOOD-FRAMED DECKS PER IRC R507.
- 2. LUMBER SPECIES / SIZES SHOWN ON APPROVED DECK DRAWINGS REPRESENT MINIMUM REQUIREMENTS TO SAFELY SUPPORT LOADING FROM: GROUND SNOW LOAD, LIVE LOAD = 40 PSF (MAX.) AND DEAD LOAD (10 PSF).
- 3. INSTALLED LUMBER SPECIES / SIZES TO EXCEED THE FOLLOWING MINIMUM PROPERTIES: GRADE / SPECIES / SIZE: NO. 2 SOUTHERN PINE 2"X10" 2"X6" 2"X8" BENDING STRESS Fb (PSI): 1.000 925 750 TENSION PARALLEL TO GRAIN Ft (PSI): 450 600 550 475 SHEAR PARALLEL TO GRAIN FV (PSI): 175 175 175 175 COMPRESSION PERPENDICULAR TO GRAIN Fcp (PSI): 565 565 565 565 COMPRESSION PARALLEL TO GRAIN Fol (PSI): 1.400 1,350 1.300 1.250 MODULUS OF ELASTICITY E (PSI): 1,400,000

REF: 2018 NDS DESIGN VALUES FOR WOOD CONSTRUCTION TABLE 4B (VISUALLY GRADED SOUTHERN PINE) 4. ALL LUMBER EXPOSED TO WEATHER / WATER / CONCRETE / MASONRY / FUNGUS / TERMITE OR ANY TYPE OF

DECAY TO BE PRESERVATIVE-TREATED / WOLMANIZED AND/OR PROTECTED PER IRC 317 AND INSTALLED PER MANUFACTURER'S INSTRUCTIONS

5. ELEVATED DECKS (30" OR MORE ABOVE GRADE) TO BE INSTALLED WITH BRACING TO RESIST LATERAL LOADS PER CODE

6. INSTALL A 6-MIL (0.006 INCH) POLYETHYLENE (OR APPROVED) VAPOR RETARDER WITH JOINTS LAPPED NOT LESS THAN 6-INCHES BELOW FLOORING IF REQUIRED BY CODE / IRC R408.1.

BLOCKING, NAILED BOTH SIDES, TO BE PROVIDED BETWEEN ADJACENT JOISTS AT 8FT O.C. (MAX).

8. USE METAL FASTENERS AND CONNECTORS PER IRC R317.3 AND TABLE R507.2.3.

9. USE FLASHING PER IRC R507.2.4.

10. ATTACH DECK LEDGER TO BAND JOIST PER IRC R507.9

- 11. PLACE LAG SCREWS OR BOLTS IN DECK LEDGERS AND BAND JOISTS PER IRC R507.9.1.3 & TABLE 507.9.1.3(1) & 507.9.1.3(2) & FIGURES 507.9.1.3(1) & 507.9.1.3(2).
- 12. INSTALL LATERAL LOAD CONNECTIONS FOR DECK USING HOLD-DOWN TENSION DEVICES AT 2 LOCATIONS (MIN) PER IRC R507.9.2 & FIGURE 507.9.2(1) OR 507.9.2(2).
- 13. CONTRACTOR TO VERIFY JOIST HANGERS SATISFY LOCAL CODE(S) AND ARE INSTALLED PER MANUFACTURER'S
- 14. FINAL GRADE SHALL FALL 6" (MIN) WITHIN FIRST 10 FT. AWAY FROM HOUSE / DECK / ENCLOSURE PER IRC R401.3.

INTERIOR ENGINEERED LUMBER / LAMINATED VENEER LUMBER (LVL) NOTES: CONTRACTOR: ALL LVL JOISTS ARE RATED FOR "DRY-USE / INTERIOR" APPLICATIONS ONLY.

1ENGINEERED WOOD PRODUCTS TO CONFORM TO IRC 502.

2. LVL JOISTS TO BE INSTALLED PER MANUFACTURER'S INSTRUCTIONS.

3. LVL MODULUS OF ELASTICITY 2.0 E RATED (MIN.)

- 4. LVL JOISTS NOT TO BE INSTALLED IN DIRECT CONTACT WITH CONCRETE OR MASONRY CONSTRUCTION.
- 5. LVL-JOIST BEARING AT SUPPORTS TO BE SIZED PER MANUFACTURER'S INSTRUCTIONS BUT NOT LESS THAN 3 INCHES FULL CONTACT. THE BEARING SURFACE MUST BE SOLID AND CONTINUOUS OVER THE WHOLE SURFACE.
- 6. LVL JOISTS TO BE RESTRAINED AGAINST ROTATION AT ENDS AND SUPPORTS, PER MANUFACTURER'S INSTRUCTIONS.
- 7. LVL-JOIST TOP (OR COMPRESSION EDGE) TO BE LATERALLY SUPPORTED BY PERPENDICULAR FRAMING OR BRACING AT 24-INCHES ON-CENTER OR CLOSER, PER MANUFACTURER'S INSTRUCTIONS.
- 8. EXTERIOR-RATED LYLS TO BE SUBSTITUTED PER MANUFACTURER'S RECOMMENDATION FOR APPLICATIONS WHERE LVL IS NOT PROTECTED FROM WEATHER.

ABBREVIATIONS:

CBM = CRAFT-BILT MANUFACTURING COMPANY

D = DOOR, M = MULLION, W = WINDOW, P = PANE HC = HONEYCOMB PANELS, EPS = POLYSTYRENE PANELS.

AL = ALUMINUM, H = THERMALLY-BROKEN ALUMINUM H-STIFFENER,

PT = PRESGURE-PRESERVATIVE TREATED OR APPROVED DECAY RESISTANT,
IN = INCHES, FT = FEET, MPH = MILES PER HOUR, PSF = POUNDS / SQ. FOOT, PLF = POUNDS PER LINEAR FOOT

IRC = INTERNATIONAL RESIDENTIAL CODE, IBC = INTERNATIONAL BUILDING CODE,

SPECS = SPECIFICATIONS, MAX = MAXIMUM, MIN = MINIMUM, DIA = DIAMETER. SDS = SELF DRILLING SCREW, OC = ON CENTER, ASCE = AMERICAN SOCIETY FOR CIVIL ENGINEERS

NDS = NATIONAL DESIGN SPECIFICATIONS FOR WOOD CONSTRUCTION.

PROJECT DRAWING LIST

SHEET 1 OF 6 - GABLE ENCLOSURE PROJECT NOTES

SHEET 2 OF 6 - GABLE ENCLOSURE WALLS / LAYOUT

SHEET 3 OF 6 - DECK FRAMING PLAN

SHEET 4 OF 6 - TYPICAL ALUMINIUM GABLE ENCLOSURE CONNECTION DETAILS

SHEET 5 OF 6 - ALUMINIUM GABLE ENCLOSURE STRUCTURAL FRAMING

SHEET 6 OF 6 - EXISTING ROOF OVERHANG CUT BACK TYP.

NYS PE NOTE: IT IS A VIOLATION OF NY STATE ARTICLE 145, PROFESSIONAL ENGINEERING, LAND SURVEYING AND GEOLOGY 7209. SPECIAL PROVISIONS, FOR ANY PERSON, UNLESS HE OR SHE IS ACTING UNDER THE DIRECTION OF A LICENSED PROFESSIONAL ENGINEER OR LAND SURVEYOR, TO ALTER AN ITEM IN ANY WAY ON PLANS, SPECIFICATIONS, PLATS AND REPORTS TO WHICH THE SEAL OF A PROFESSIONAL ENGINEER OR LAND SURVEYOR HAS BEEN APPLIED.



ROUND TRAIL DRIVE PITSFORD, NY 14534 AWN BY: LYF

NEWARK, NY 14513 DWG NO .: SHEET 1 OF 6

171 WEST SHORE BLVD.

MARSHALL EXTERIORS, LLC

CONTRACTOR:

Cohn-Gbl-Encl-12' X 10'-a

REV: R1 DATE: 10/25/21

ALUMINIUM GABLE **ENCLOSURE** PROJECT NOTES

LAYOUT PLANS


EXISTING BUILDING

UF 51"X70"W 51"x70"W B - WALL


> GABLE FLOOR PLAN (NOT TO SCALE)

TIE-IN TO EXISTING HOUSE BY CONTRACTOR. FULL SUPPORT REQ'D CONTINUOUS TO FOUNDATION. EXISTING STRUCTURE MUST SAFELY SUPPORT (OR BE UPGRADED TO SUPPORT) NEW SUPERIMPOSED LOADS OF: 1700 LBS - GRAVITY LOAD & 650 LBS - UPLIFT LOAD 850 LBS - LATERAL LOAD (BY OTHERS)


WALL SECTIONS

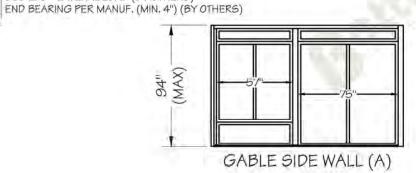



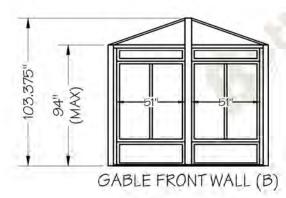

ASSEMBLY DETAILS

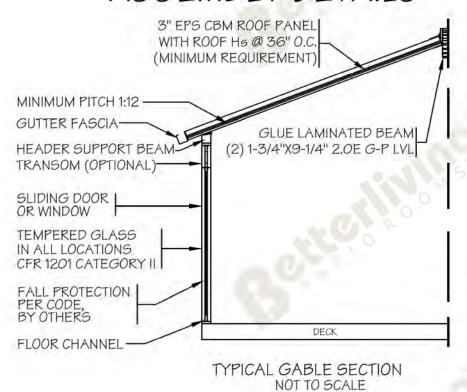

NYS PE NOTE: IT IS A VIOLATION OF NY STATE ARTICLE 145, PROFESSIONAL ENGINEERING, LAND SURVEYING TO WHICH THE SEAL OF A PROFESSIONAL ENGINEER



PROJECT: ROUND TRAIL DRIVE PITTSFORD, NY 14534 DRAWN BY: LYF

SCALE: 1" = 75"

MARSHALL EXTERIORS, LLC 171 WEST SHORE BLVD. NEWARK, NY 14513

DWG NO .: SHEET 2 OF 6


CONTRACTOR:


Cohn-Gbl-Encl-12' X 10'-a

REV: R1 DATE: 10/25/21


ALUMINIUM GABLE ENCLOSURE GENERAL LAYOUT


FOR NOTES SEE SHEET 1 - PROJECT NOTES

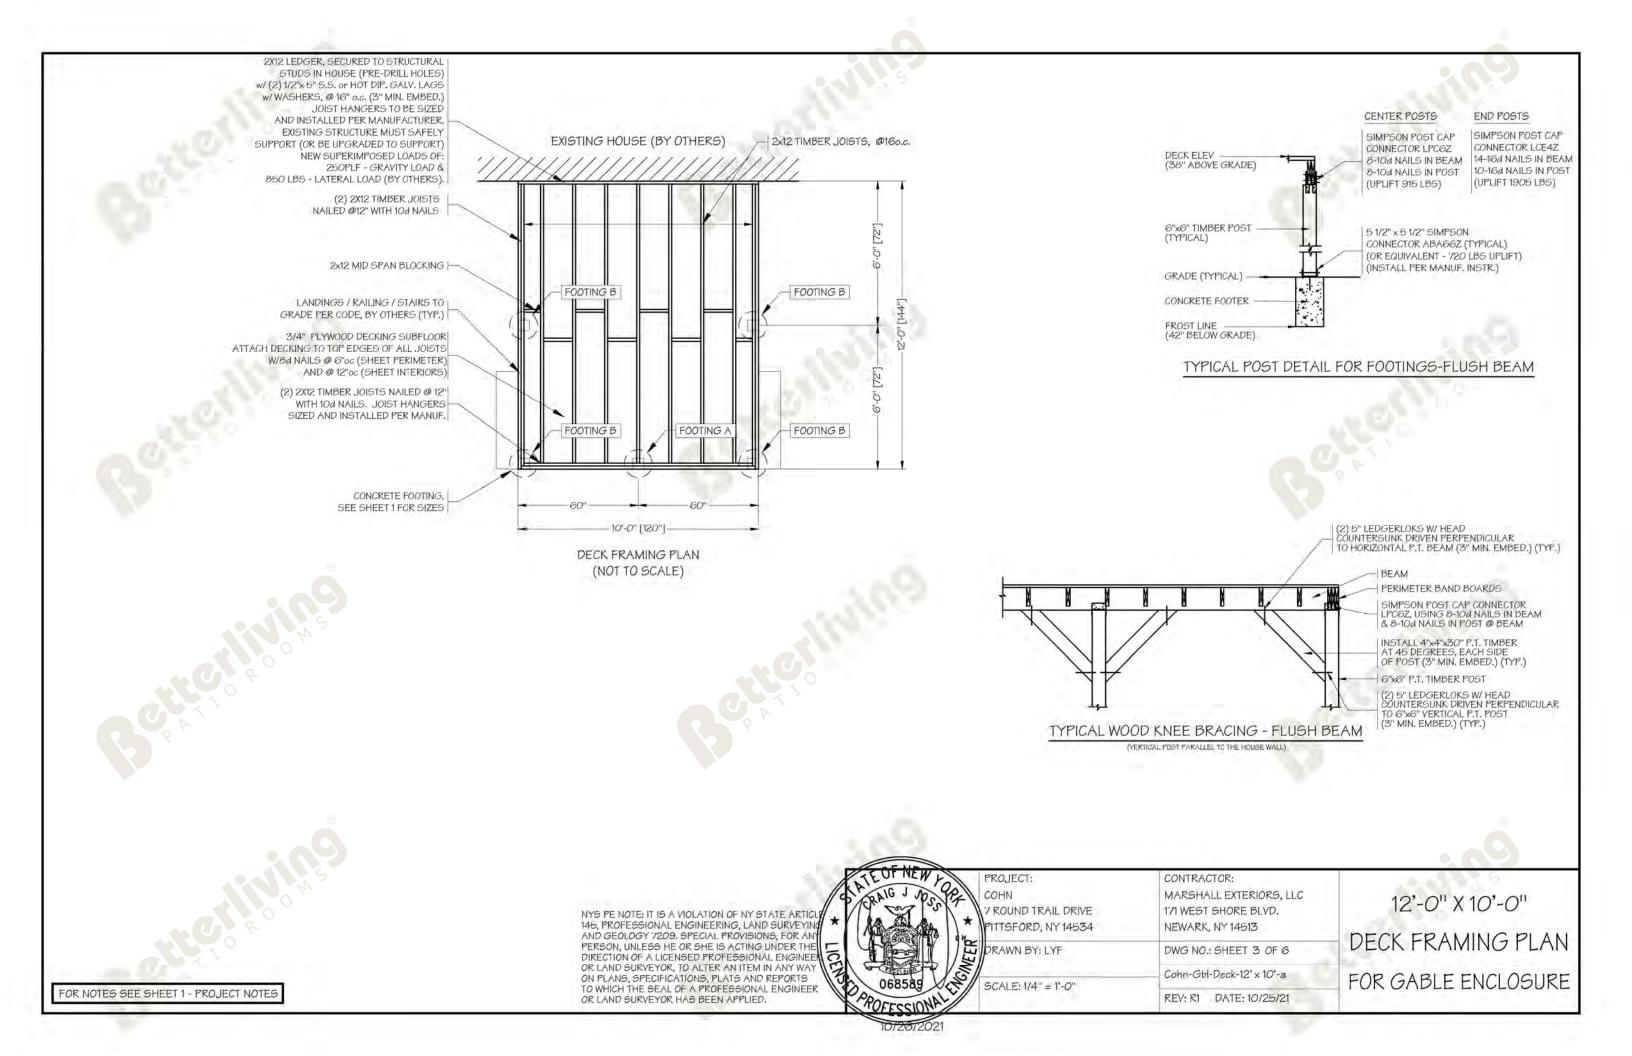

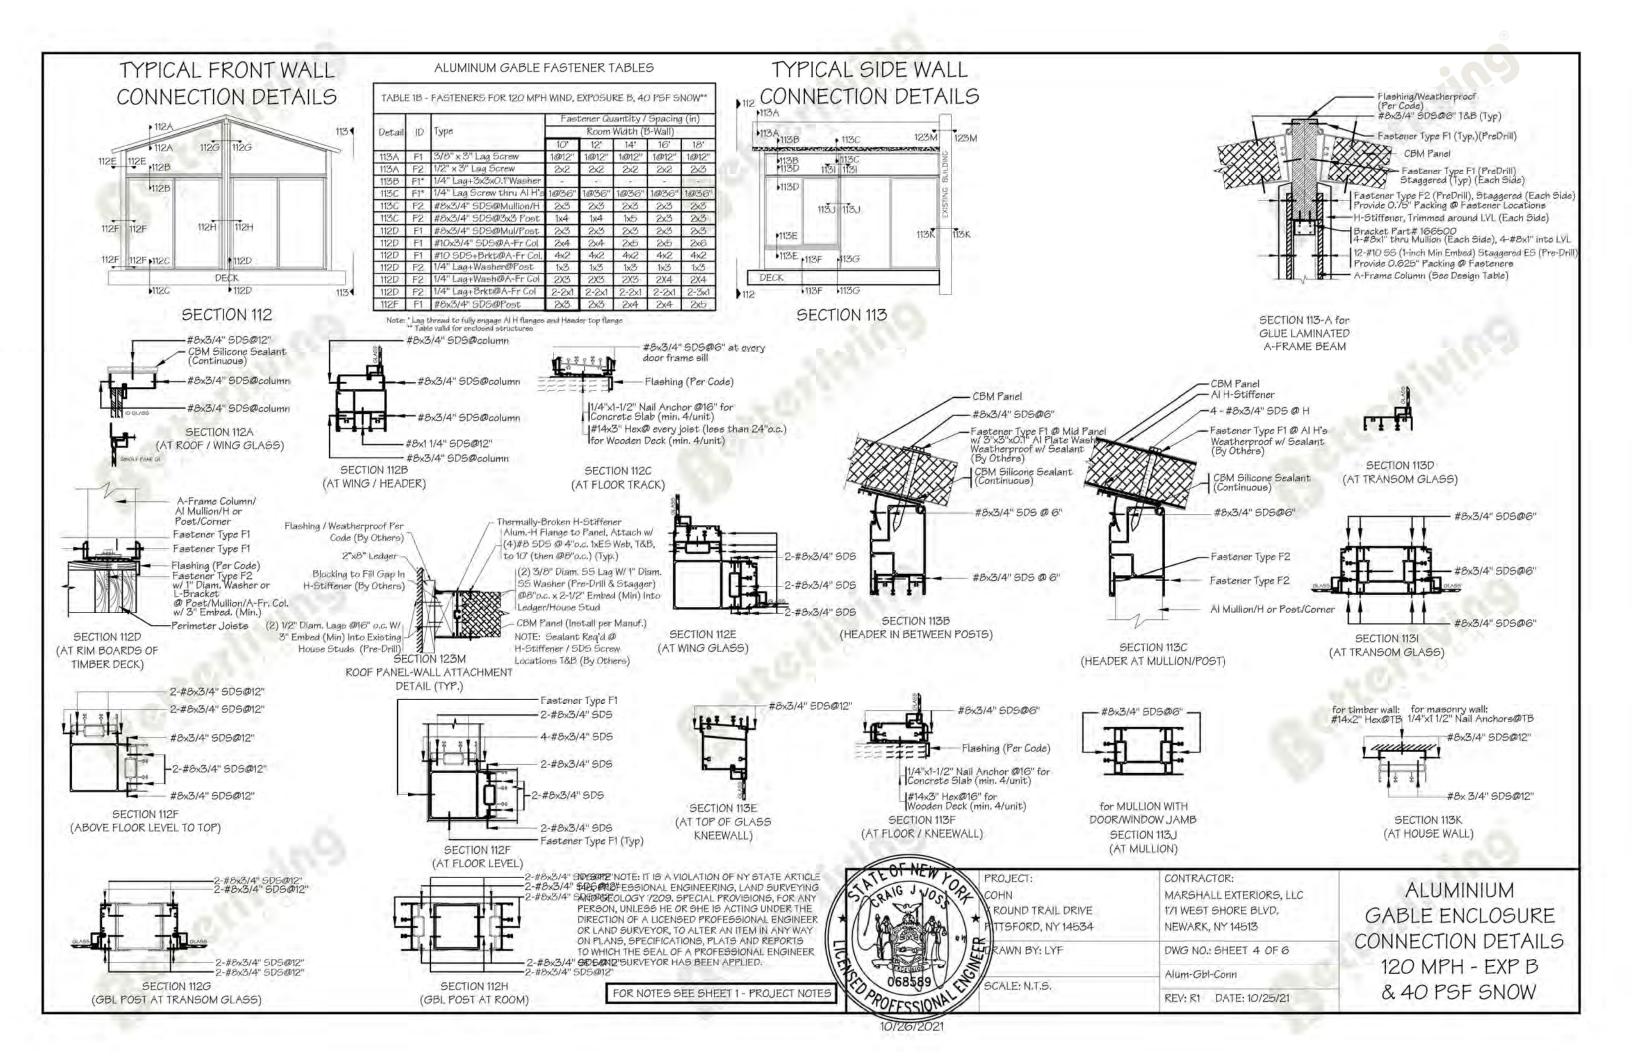

TYPICAL GABLE ENCLOSURE

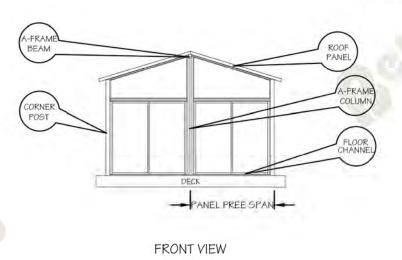

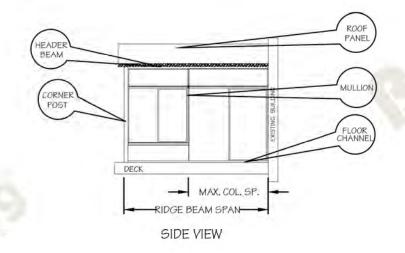

A-FRAME WALL MULLIONS / CORNER

A-FRAME WALL MULLION

WITTION	ION MAX ALLOWABLE GROUND SNOW LOAD					'SF)			
SPACING	PANEL FREE SPAN (FT)								
(FI)	5	6	7	8'	9"	10"			
5	100	100	100	100	100	100			
5.5	100	100	100	100	100	100			
6	100	100	100	100	100	100			
65	100	100	100	100	100	100			
T	100	100	100	100	100	100			

AT WALL MULLION - ELEC MULLION + 2-JAMBS (MAX HT 8 FT - INTERIOR)

A-FRAME CORNER

MULLION	MAX	ALLOWA	BLE GROU	IND SNOV	V LOAD (P	BF)
SPACING		PA	NEL FREE	SPAN (F	T)	
(FT)	5	6'	1	8'	9	10
5	100	100	100	100	100	100
5.5	100	100	100	100	100	100
6	100	100	100	100	100	100
65	100	100	100	100	100	100
7	100	100	100	100	100	100
75	100	100	100	100	100	100




		WEEF	DOR CHAI	NMET						
WILLION	MAX	MAX ALLOWABLE GROUND SNOW LOAD (PSF)								
SPACING		PANEL FREE SPAN (FT)								
(FT)	5	6	7-7-3	8'	9.	10				
5	100	100	100	100	100	100				
55	100	100	100	100	100	100				
6	100	100	100	100	100	-100				
65	100	100	100	100	100	100				
7	100	100	100	100	100	100				
75	100	100	100	100	100	100				



FLOOR / HEADER / RIDGE BEAM OPTIONS

MULLION	MAX.	MAX. ALLOWABLE GROUND SNOW LOAD (PSF)							
SPACING		PANEL FREE SPAN (FT)							
(FT)	5'	6'	7	8'	9'	10"			
5'	100	100	100	100	100	100			
5.5	100	100	100	100	100	99			
6	100	100	100	100	100	100			
65	100	100	100	100	100	100			
7	100	100	100	100	100	100			
7.5	100	100	100	100	100	100			

A-FRAME COLUMNS

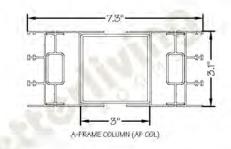

BEAM	MAX. ALLOWABLE GROUND SNOW LOAD (PSF)								
SPAN	PANEL FREE SPAN (FT)								
(FT)	5	6	7	8'	9'	10"			
8'	-100	100	100	100	100	100			
10'	100	100	100	100	100	100			
12.	100	100	100	LOO	92	84			
14	100	100	100	90	77	71			
16	100	100	98	77	67	-61			
18'	100	100	85	- 68	60	54			

TO WHICH THE SEAL OF A PROFESSIONAL ENGINEER OR LAND SURVEYOR HAS BEEN APPLIED.



OJECT:	CONTRACTOR:
HN	MARSHALL EXTERIORS, LLC
OUND TRAIL DRIVE	171 WEST SHORE BLVD.
TSFORD, NY 14534	NEWARK, NY 14513
AWN BY: LYF	DWG NO.: SHEET 5 OF 6

5 OF 6

REV: R1 DATE: 10/25/21

ALUMINIUM GABLE ENCLOSURE STRUCTURAL FRAMING UPTO 120MPH - EXP B


FOR NOTES SEE SHEET 1 - PROJECT NOTES







11/23/21, 3:42 PM Letter View

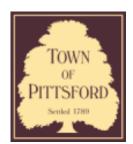

Town of Pittsford

Department of Public Works 11 South Main Street Pittsford, New York 14534

Permit # B21-000238

Phone: 585-248-6250 FAX: 585-248-6262

DESIGN REVIEW AND HISTORIC PRESERVATION BOARD REFERRAL OF APPLICATION

Property Address: 155 Sylvania Road ROCHESTER, NY 14618

Tax ID Number: 151.06-1-4

Zoning District: RN Residential Neighborhood

Owner: Herrema, Erik S Applicant: Herrema, Erik S

Application Type	IVDE	II IY	UH	au	C	ш	ν	b	м
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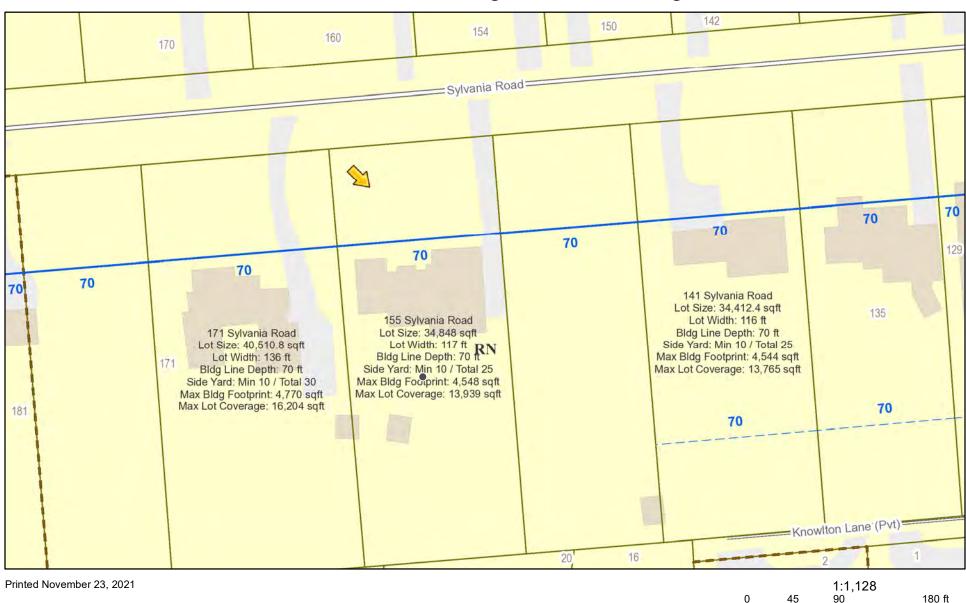
application Type:	
Residential Design Review §185-205 (B)	Build to Line Adjustment §185-17 (B) (2)
Commercial Design Review §185-205 (B)	Building Height Above 30 Feet §185-17 (M)
Signage §185-205 (C)	Corner Lot Orientation §185-17 (K) (3)
Certificate of Appropriateness §185-197	Flag Lot Building Line Location §185-17 (L) (1) (c)
Landmark Designation §185-195 (2)	Undeveloped Flag Lot Requirements §185-17 (L) (2)
Informal Review	

Project Description: Applicant is requesting design review for the addition of a third car garage off the side of the house as well as a pool cabana off the rear off the house.

Meeting Date: December 09, 2021



RN Residential Neighborhood Zoning



Town of Pittsford GIS

12.5

25

50 m





Herrema Residence
155 Sylvania Road
Rochester, NY

Front Elevation



ADDITION / RENOVATION

HERREMA RESIDENCE

155 SYLVANIA ROAD ROCHESTER, NEW YORK



CLIENT:

RIK & CORY HERREMA

ARCHITECT:

JAMES FAHY DESIGN ASSOCIATES ARCHITECTURE & ENGINEERING P.C. 2024 W. HENRIETTA RD. SUITE 3K ROCHESTER, NY 14623

TEL. (585) 272-1650 E-MAIL: info@jamesfahy.com WEBSITE: www.jamesfahy.com

DRAWING INDEX:

T1.0	CO	VER	SHI	EET

A1.0 PROPOSED & EXISTING FRONT ELEVATIONS
A1.1 PROPOSED & EXISTING REAR ELEVATIONS

A1.1 PROPOSED & EXISTING REAR ELEVATIONS
A1.2 PROPOSED & EXISTING RIGHT SIDE ELEVATIONS

A1.3 PROPOSED & EXISTING RIGHT SIDE ELEVATIONS


A3.0 EXISTING FIRST FLOOR PLAN

A3.1 PROPOSED FIRST FLOOR PLAN

A4.0 EXISTING SECOND FLOOR PLAN

4.1 PROPOSED SECOND FLOOR PLAN

Architecture & Engine 2024 W. Henretta Rd. Suite 3K Rochester, New York 14623 tel. (585) 272-1650 e-mail: info@jamesfahy.com

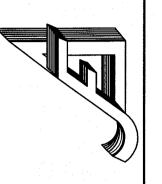

HERREMA RESIDENC

JOB NO.
A2 I -OGO

PROJECT NO.
ADDITION


PHASE:
PRELIMINARY

DRAWING NO.

10-6-2021



proposed front elevation
scale: 1/4"=1'-0"

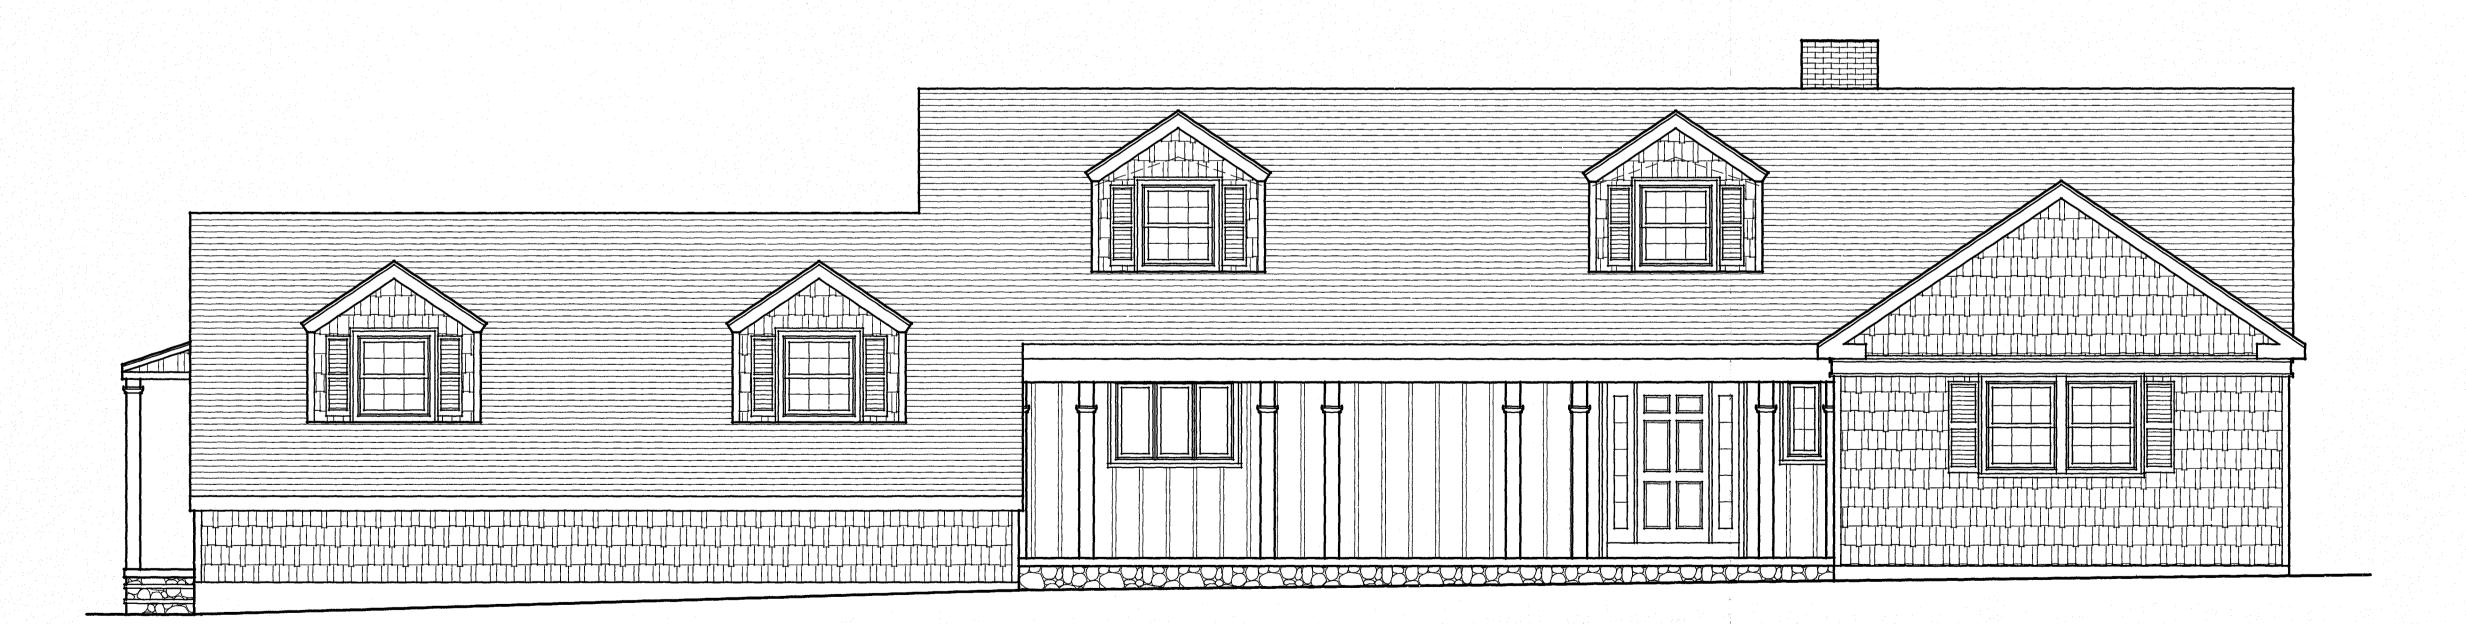

existing front elevation
scale: 1/4"=1'-0"

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STATE EDUCATION LAW, ARTICLE 145, SECTION
7209.

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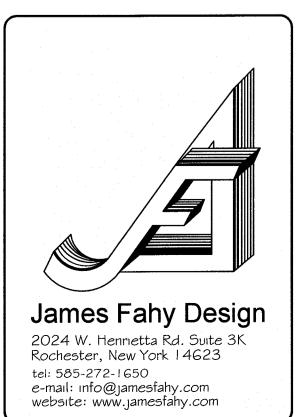
ADDITION / RENOVATION I 55 SYLVANIA RD.
ROCHESTER, NY

RIK & CORY HERREMA

DRAWING TITLE:
PROPOSED & EXISTING FRONT
ELEVATIONS

PHASE: PRELIMINARY PLAN

	JOB NO. A21-060	PROJECT NO. ADDITION
	DRAWN BY: KAD	DRAWING NO:
	CHECKED BY: JRF	AIO
	DATE: 10-6-2021	/ \ . \





proposed rear elevation scale: 1/4"=1'-0"



existing rear elevation scale: 1/4"=1'-0"

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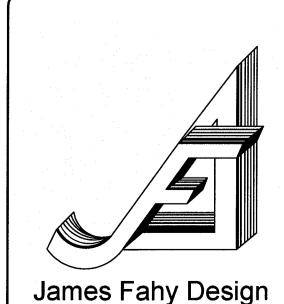
ADDITION / RENOVATION 155 SYLVANIA RD. ROCHESTER, NY

RIK & CORY HERREMA

DRAWING TITLE: PROPOSED & EXISTING REAR ELEVATIONS

PHASE: PRELIMINARY PLAN

,	JOB NO. A21-060	PROJECT NO. ADDITION
	drawn by: KAD	DRAWING NO:
	CHECKED BY: JRF	ΔΙΙ
	DATE: 0-6-202	



James Fahy Design
2024 W. Henrietta Rd. Suite 3K
Rochester, New York 14623
tel: 585-272-1650
e-mail: info@jamesfahy.com
website: www.jamesfahy.com



proposed right side elevation scale: 1/4"=1'-0"



existing right side elevation
scale: 1/4"=1'-0"

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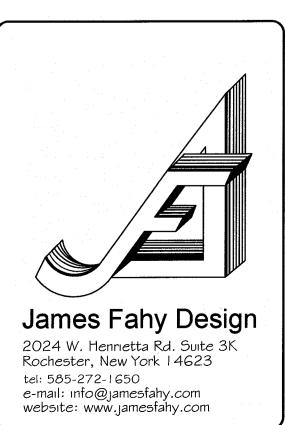
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ADDITION / RENOVATION 155 SYLVANIA RD. ROCHESTER, NY

RIK & CORY HERREMA

DRAWING TITLE: PROPOSED & EXISTING RIGHT SIDE ELEVATIONS

ЈОВ NO A21-(PROJECT NO. ADDITION
DRAWN KAD	BY:	DRAWING NO:
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DATE:	-2021] ///





proposed left side elevation
scale: 1/4"=1'-0"



existing left side elevation

cale: 1/4"=1'-0"

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ADDITION / RENOVATION
155 SYLVANIA RD.
ROCHESTER, NY


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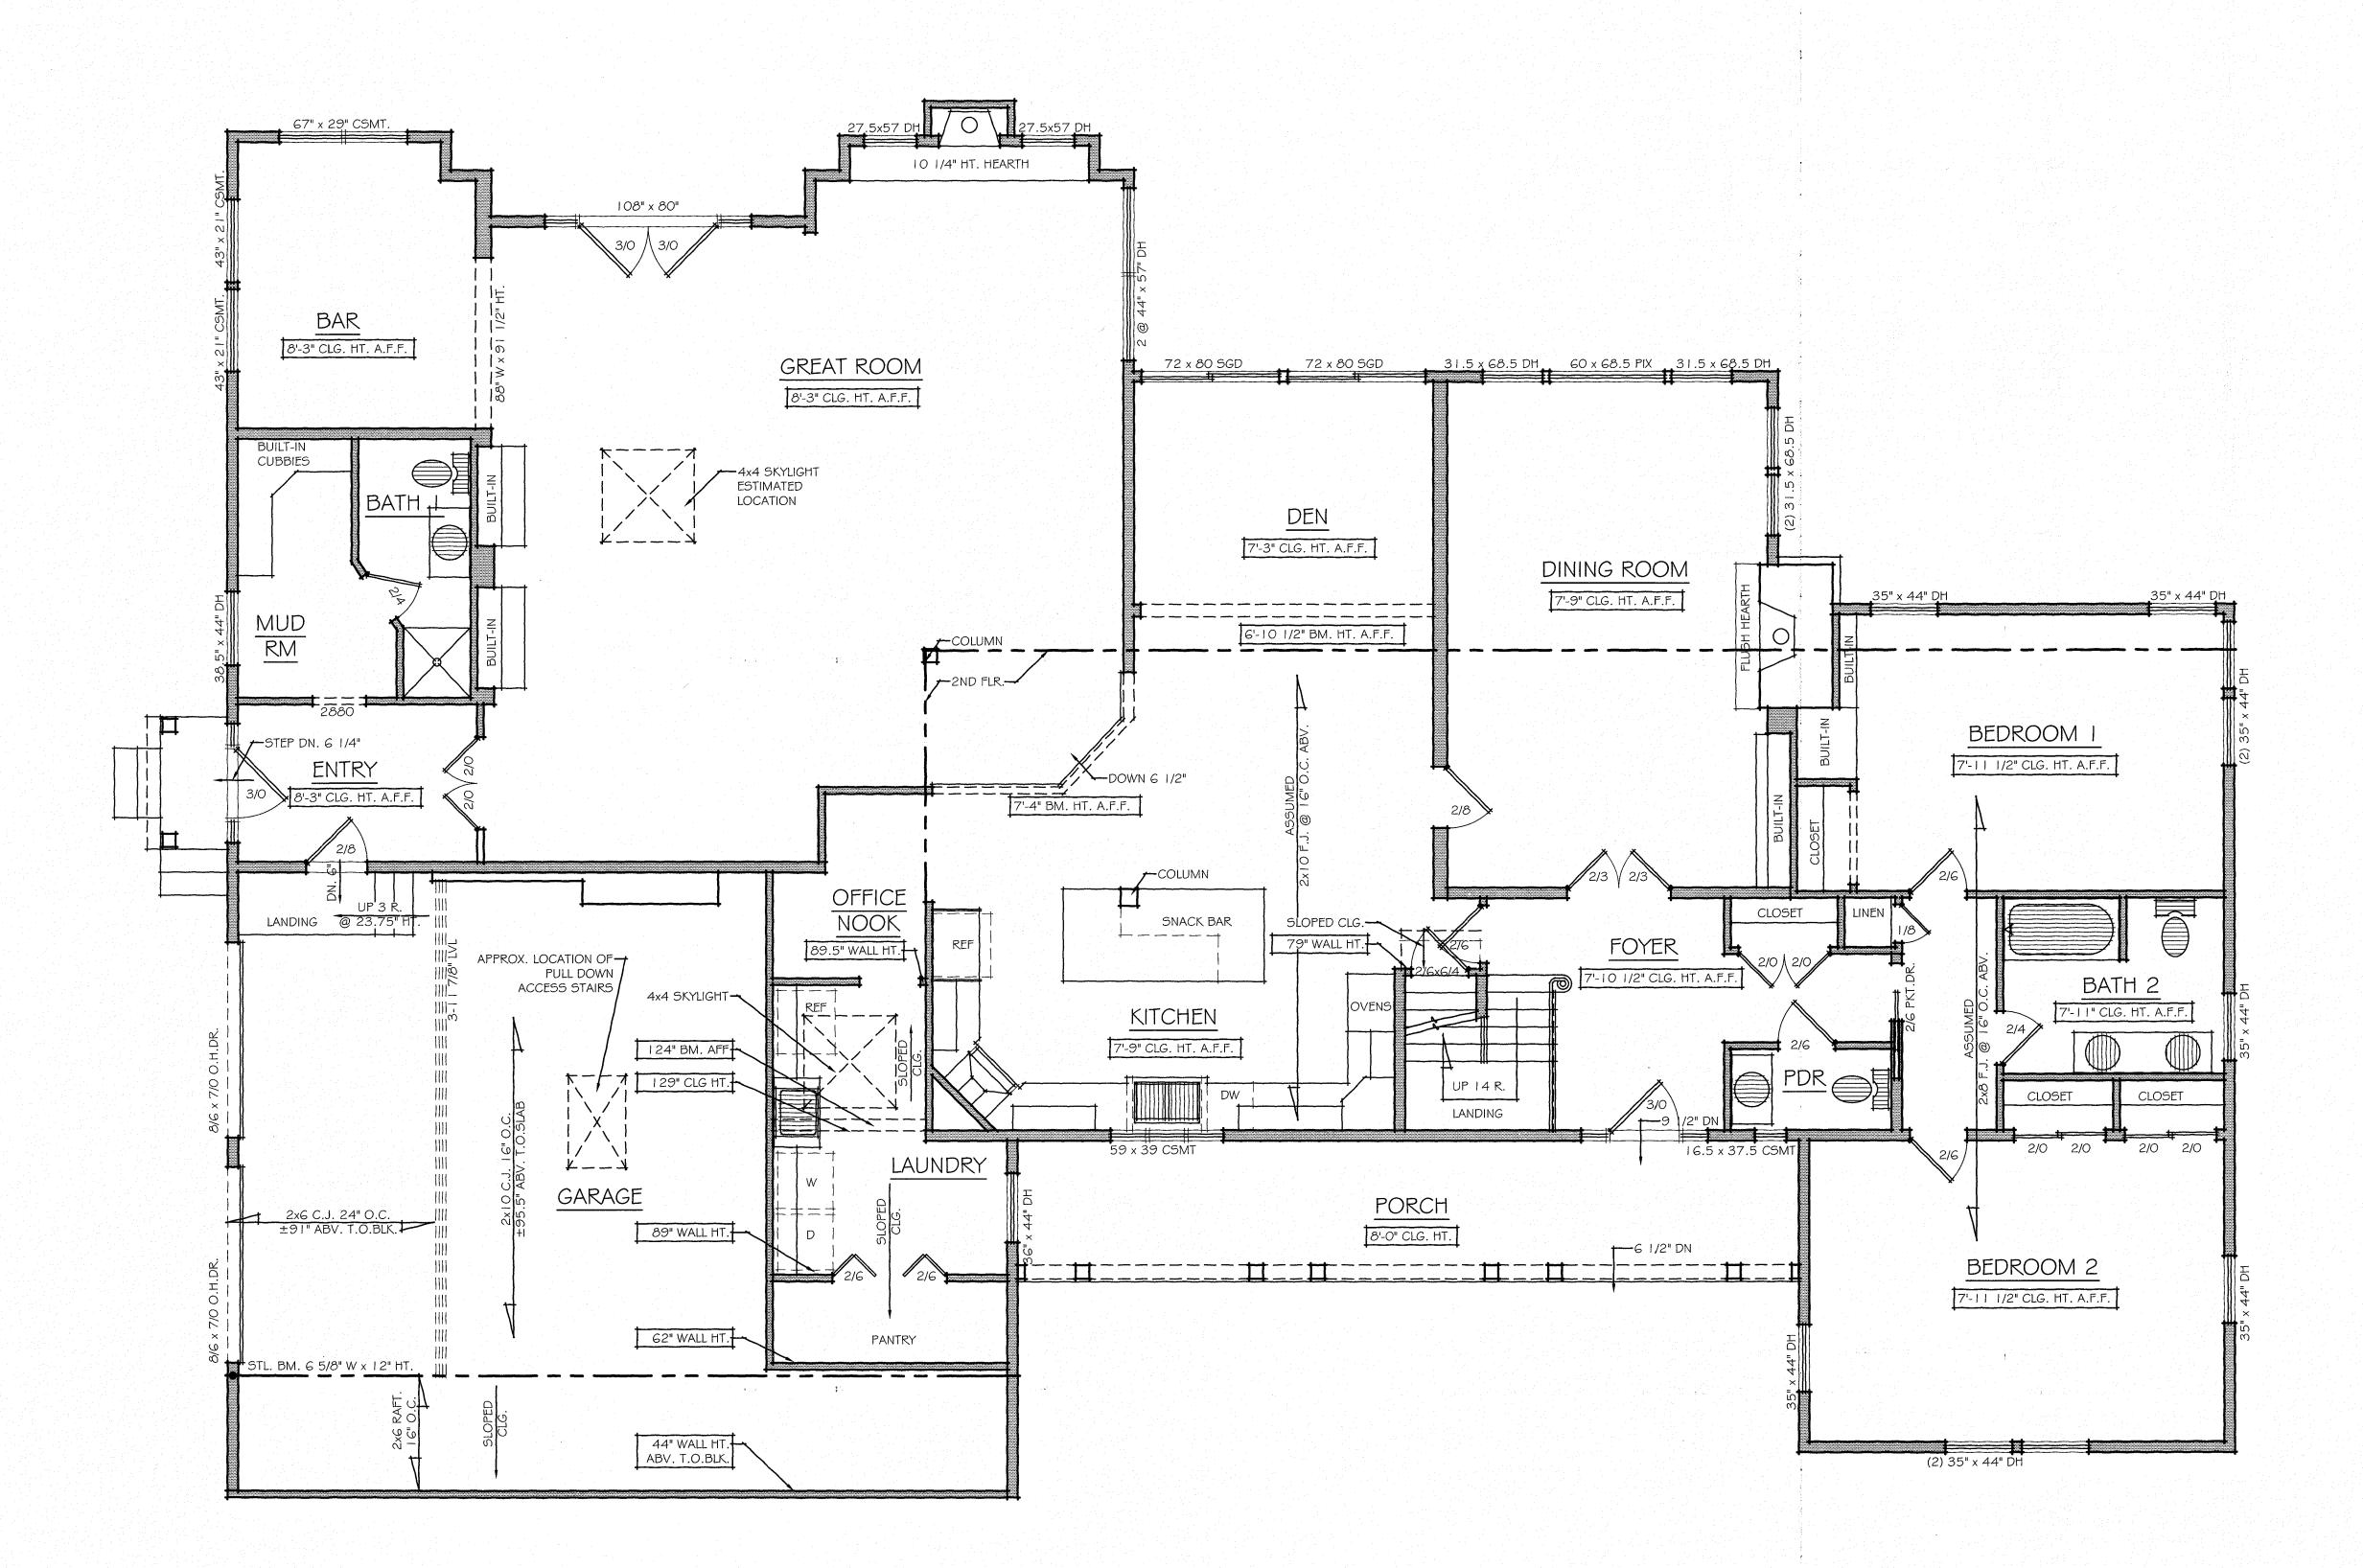
DRAWING TITLE:

PROPOSED & EXISTING LEFT SIDE

ELEVATIONS

		-
	JOB NO. A21-060	PROJECT NO. ADDITION
	DRAWN BY: KAD	DRAWING NO:
	CHECKED BY: JRF	A13
	DATE: 10-6-2021	



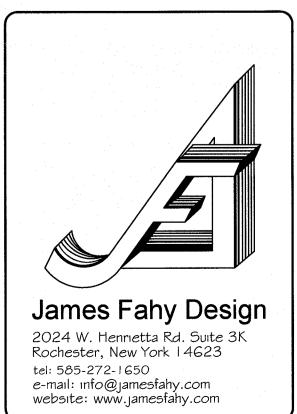

existing first floor plan 3170 s.f.

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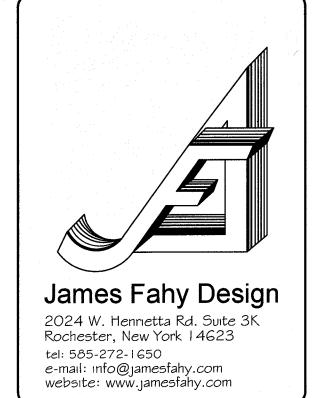
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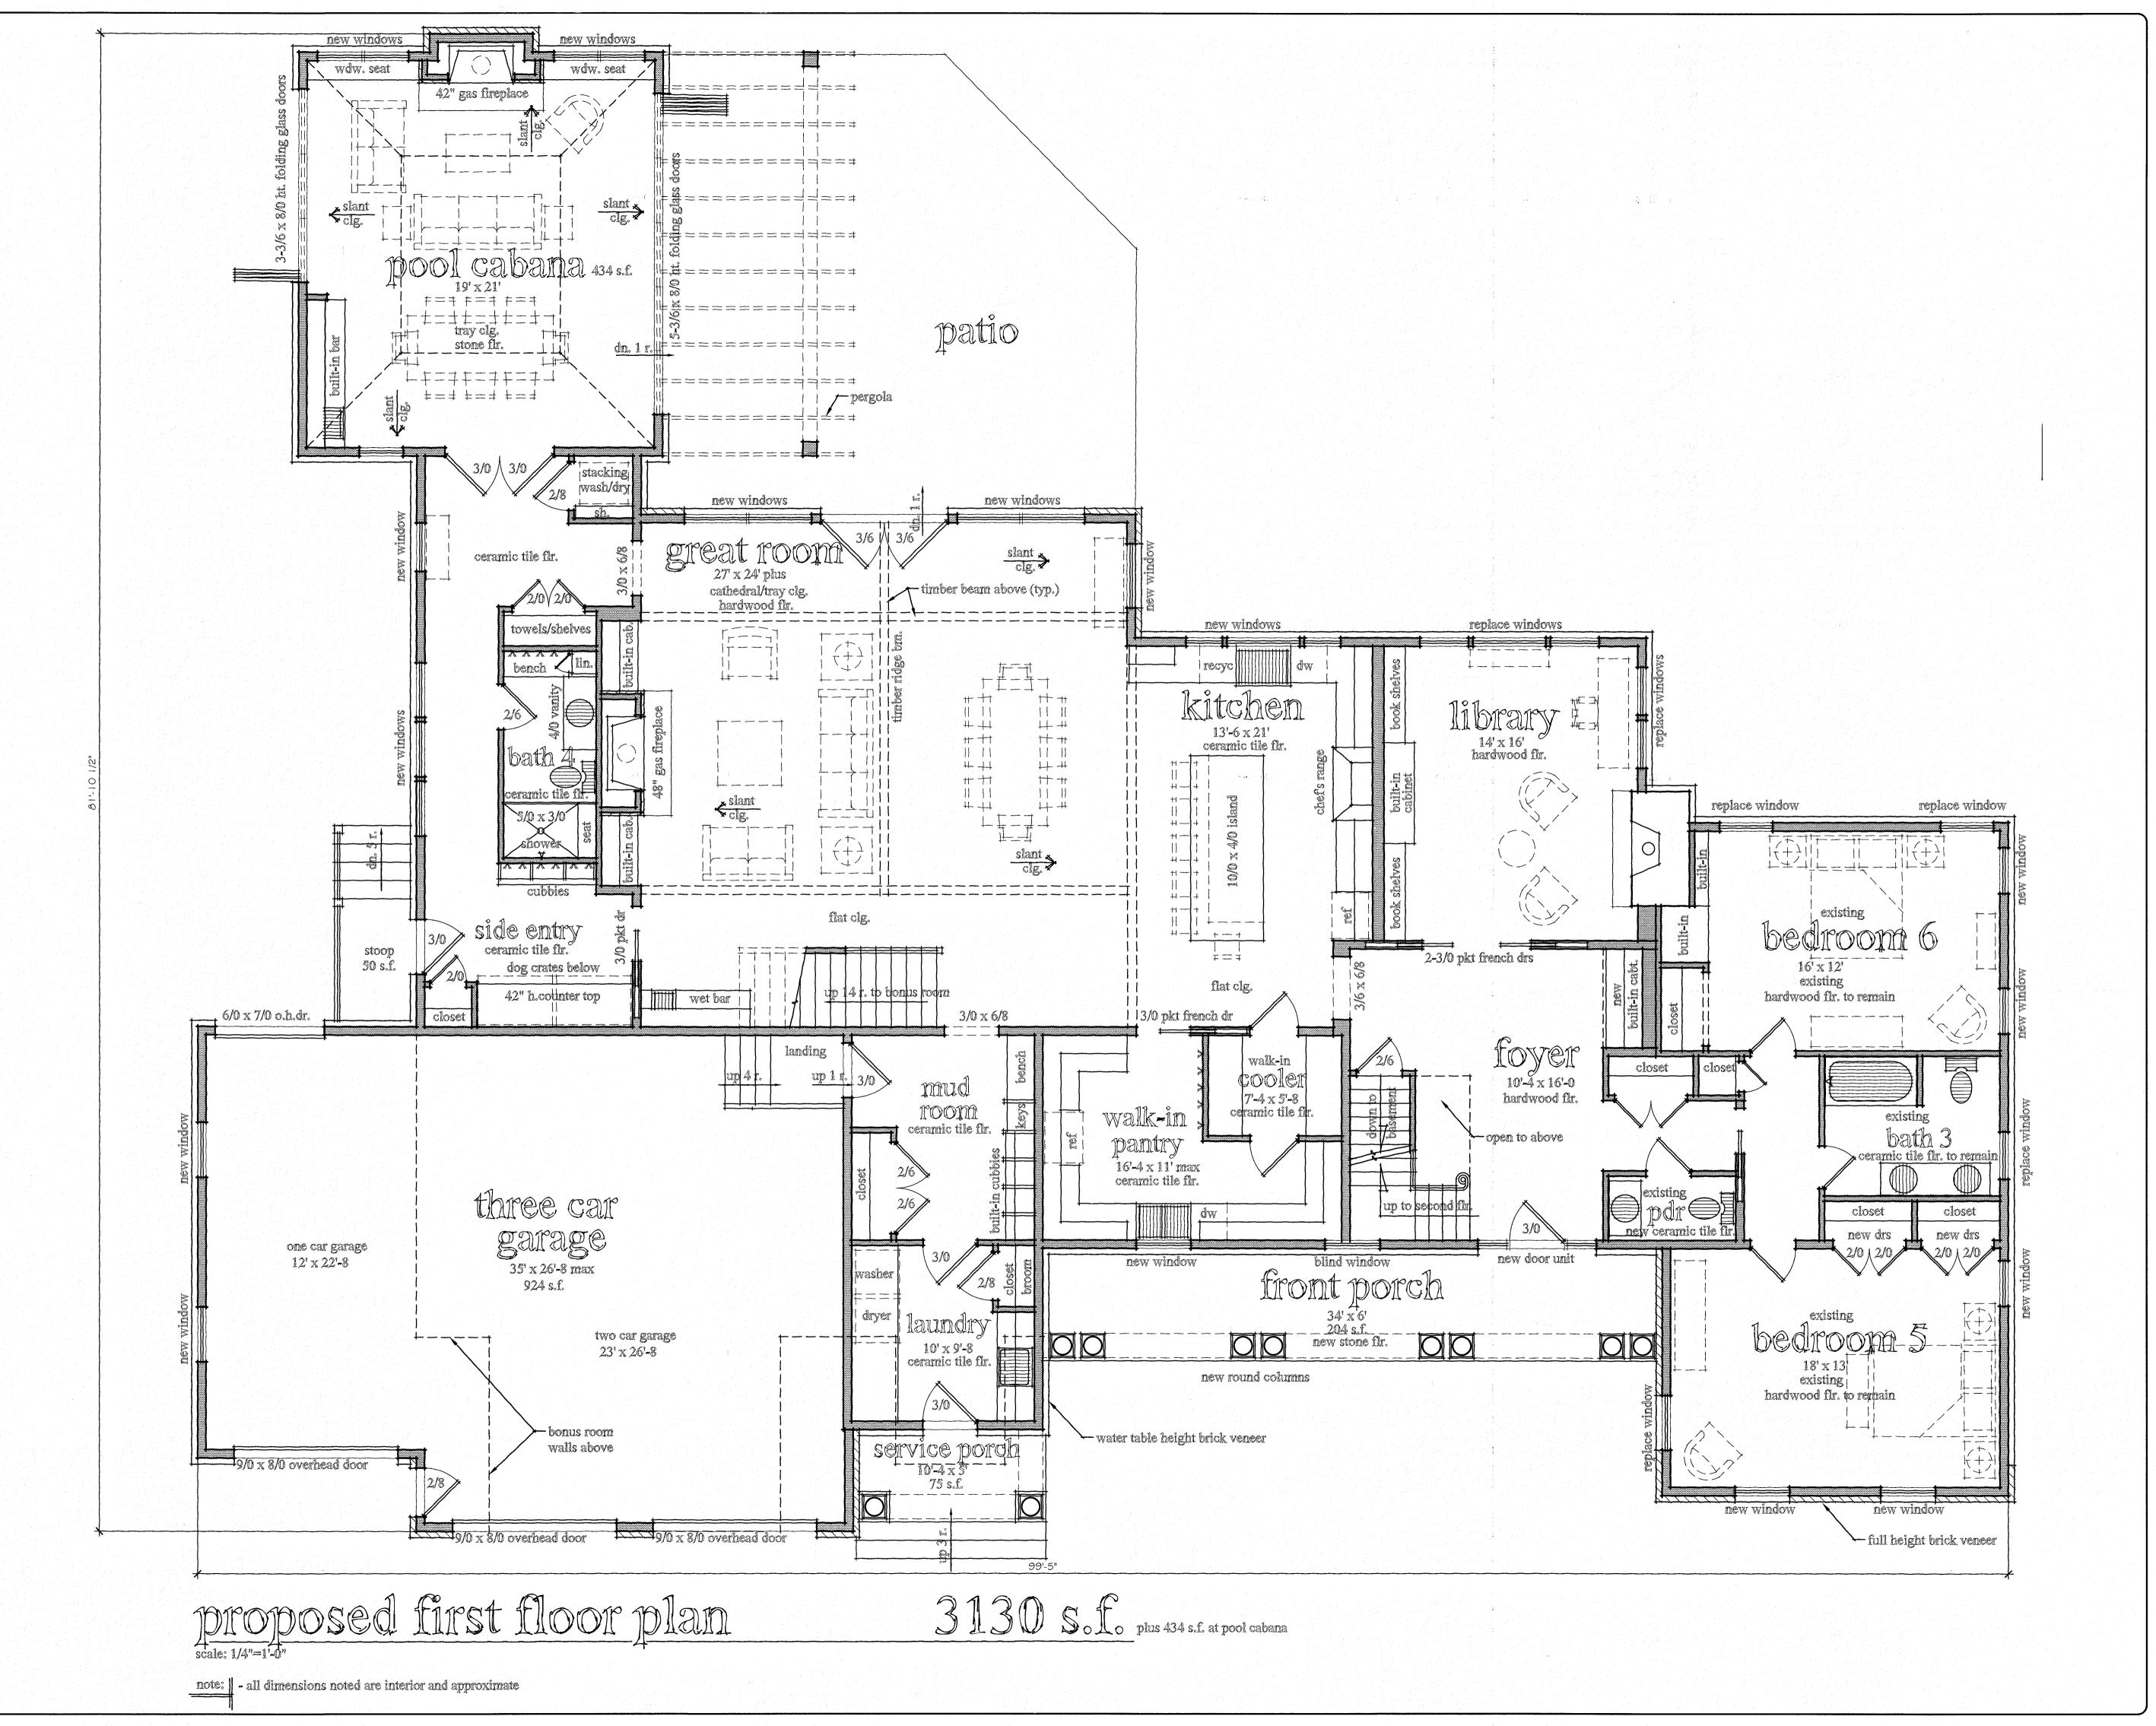
ADDITION / RENOVATION 155 SYLVANIA RD. ROCHESTER, NY

RIK & CORY HERREMA

DRAWING TITLE:
EXISTING FIRST FLOOR PLAN

JOB NO. A21-060	PROJECT NO. ADDITION
DRAWN BY: KAD	DRAWING NO:
CHECKED BY: JRF	A30
DATE: 10-6-2021	10.0





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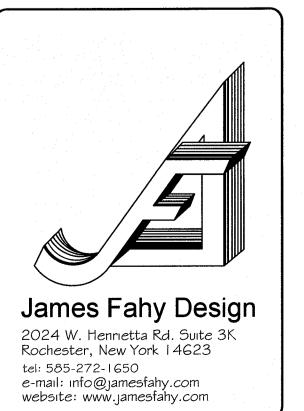
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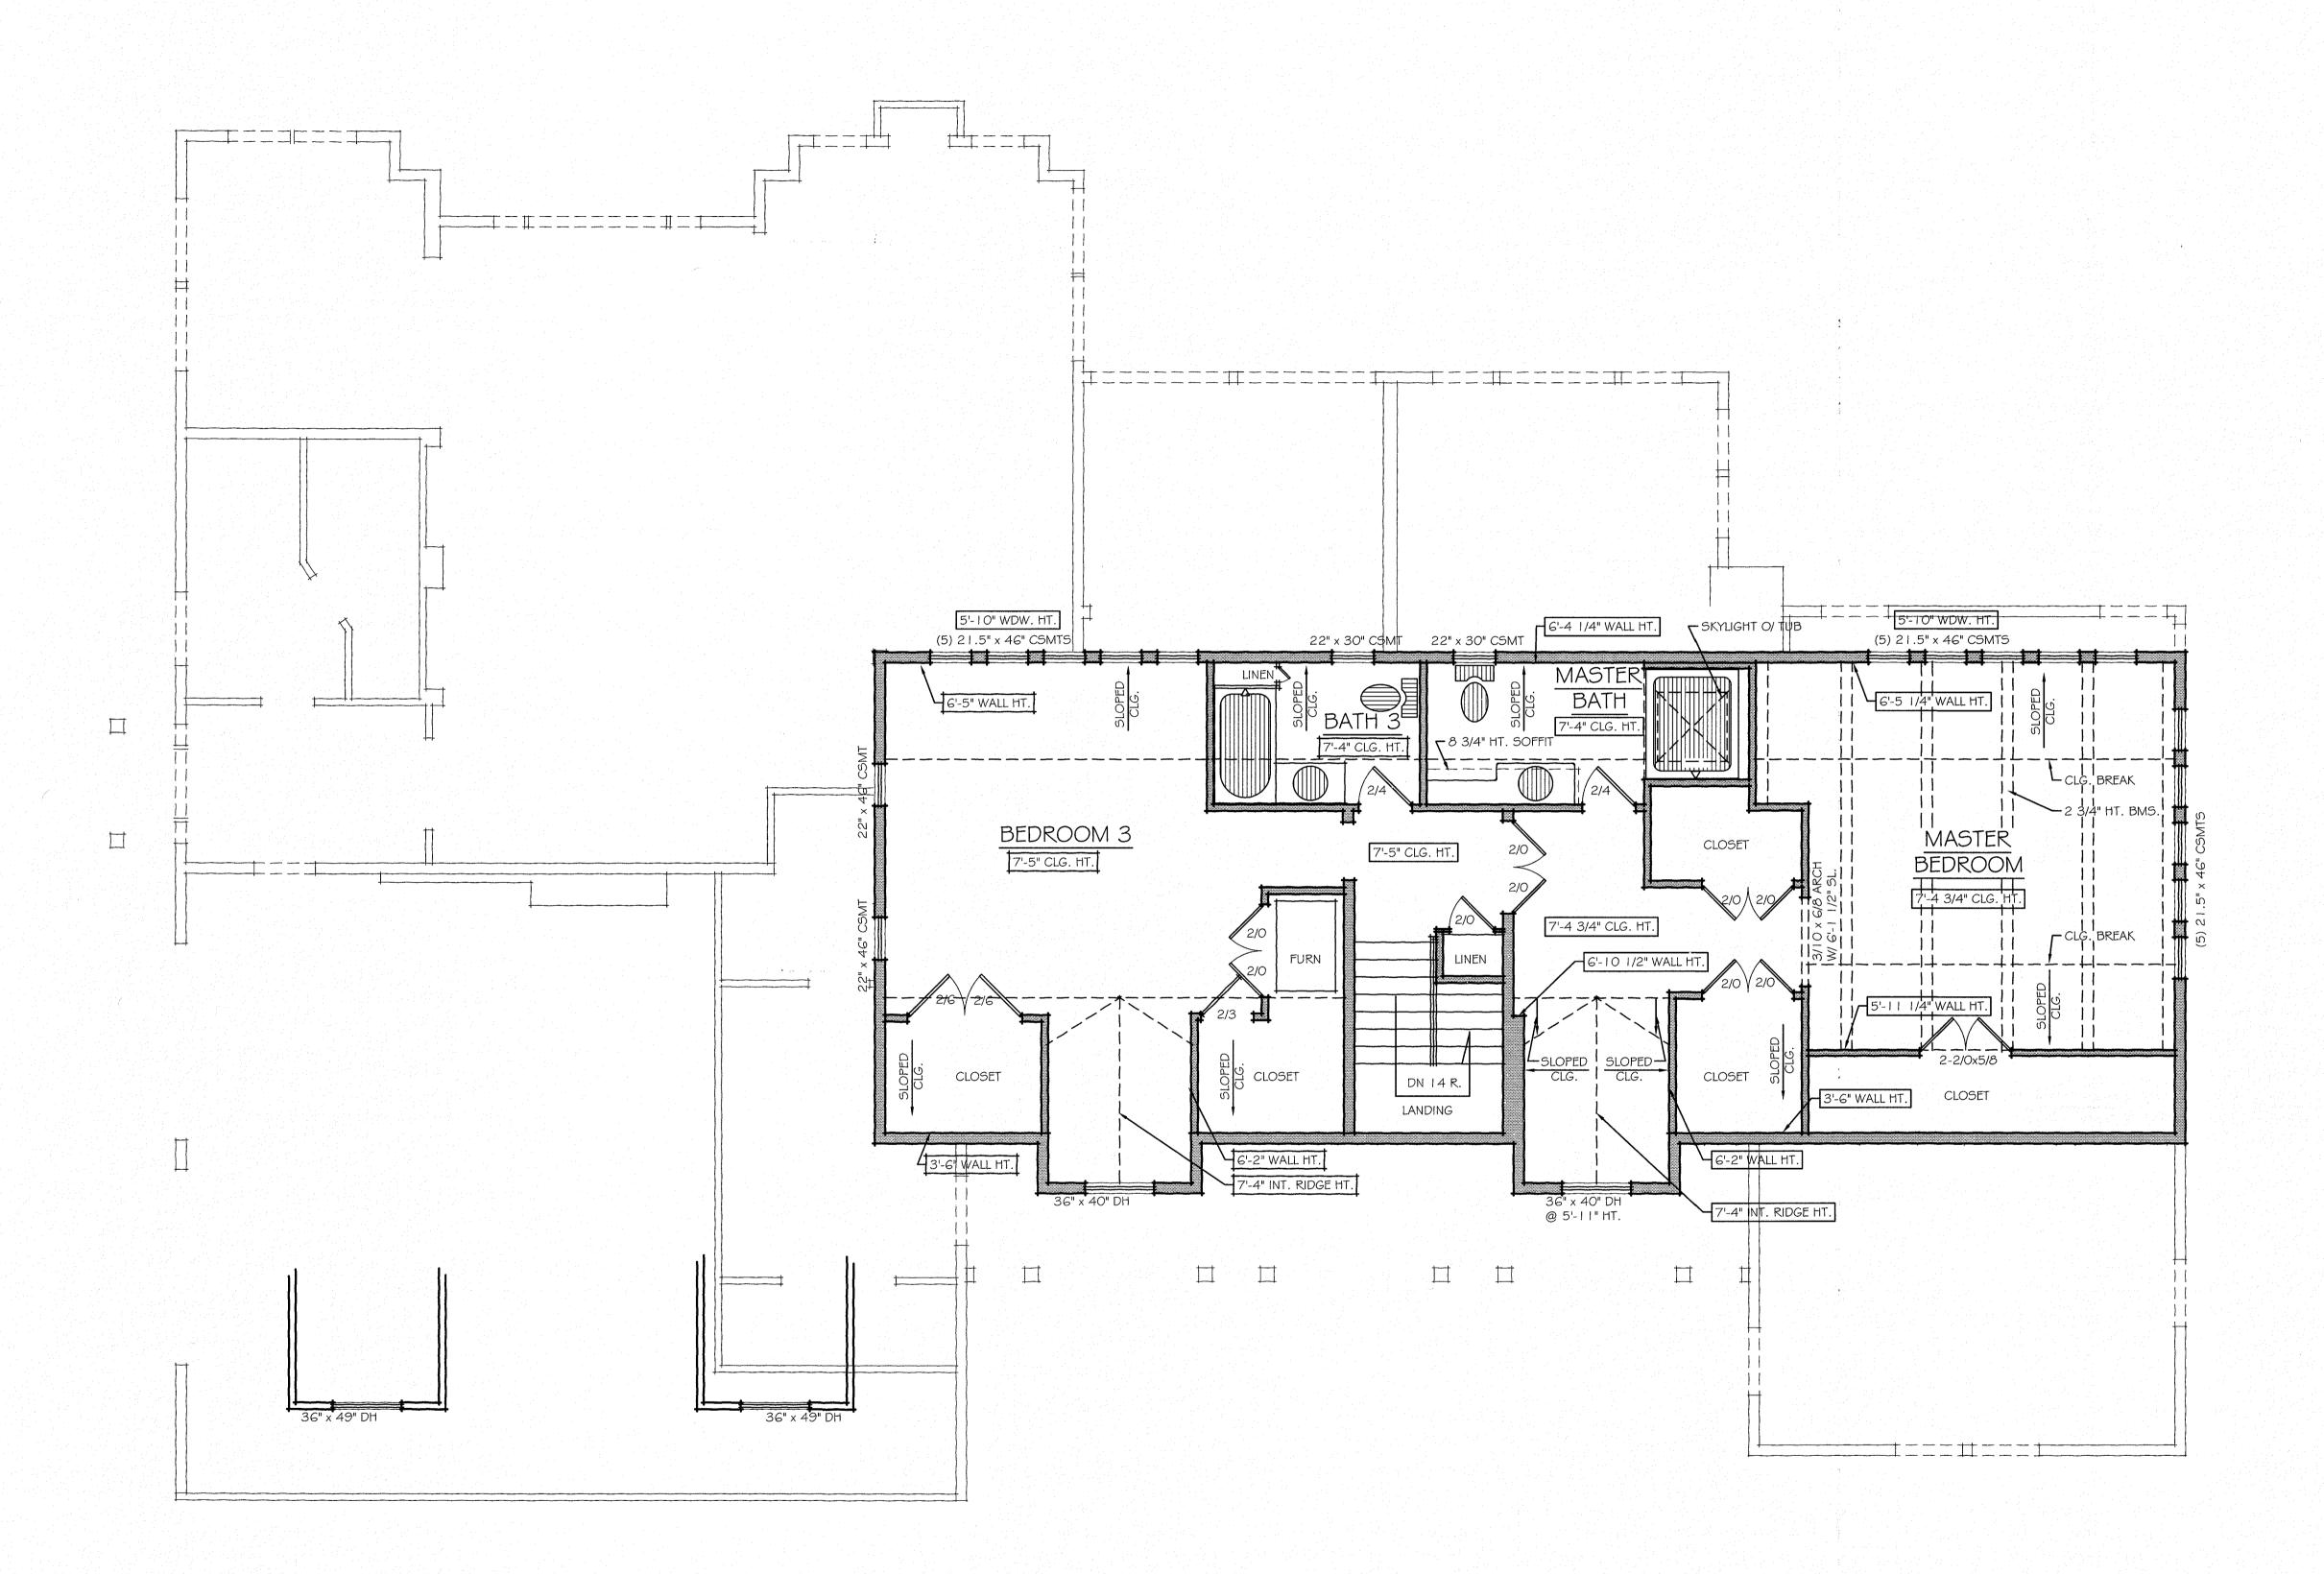
ADDITION / RENOVATION I 55 SYLVANIA RD. ROCHESTER, NY

RIK & CORY HERREMA

DRAWING TITLE:
PROPOSED FIRST FLOOR PLAN

JOB NO. A21-060	PROJECT NO. ADDITION
DRAWN BY: KAD	DRAWING NO:
CHECKED BY: JRF	A3 1
DATE: 10-6-2021	70.1





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RIK & CORY HERREMA


DRAWING TITLE:
EXISTING SECOND FLOOR PLAN

PHASE: PRELIMINARY PLAN

JOB NO. A21-060	PROJECT NO. ADDITION
 DRAWN BY: KAD	DRAWING NO:
CHECKED BY: JRF	A4 0
DATE: 10-6-2021	



existing second floor plan 1245 s.f.

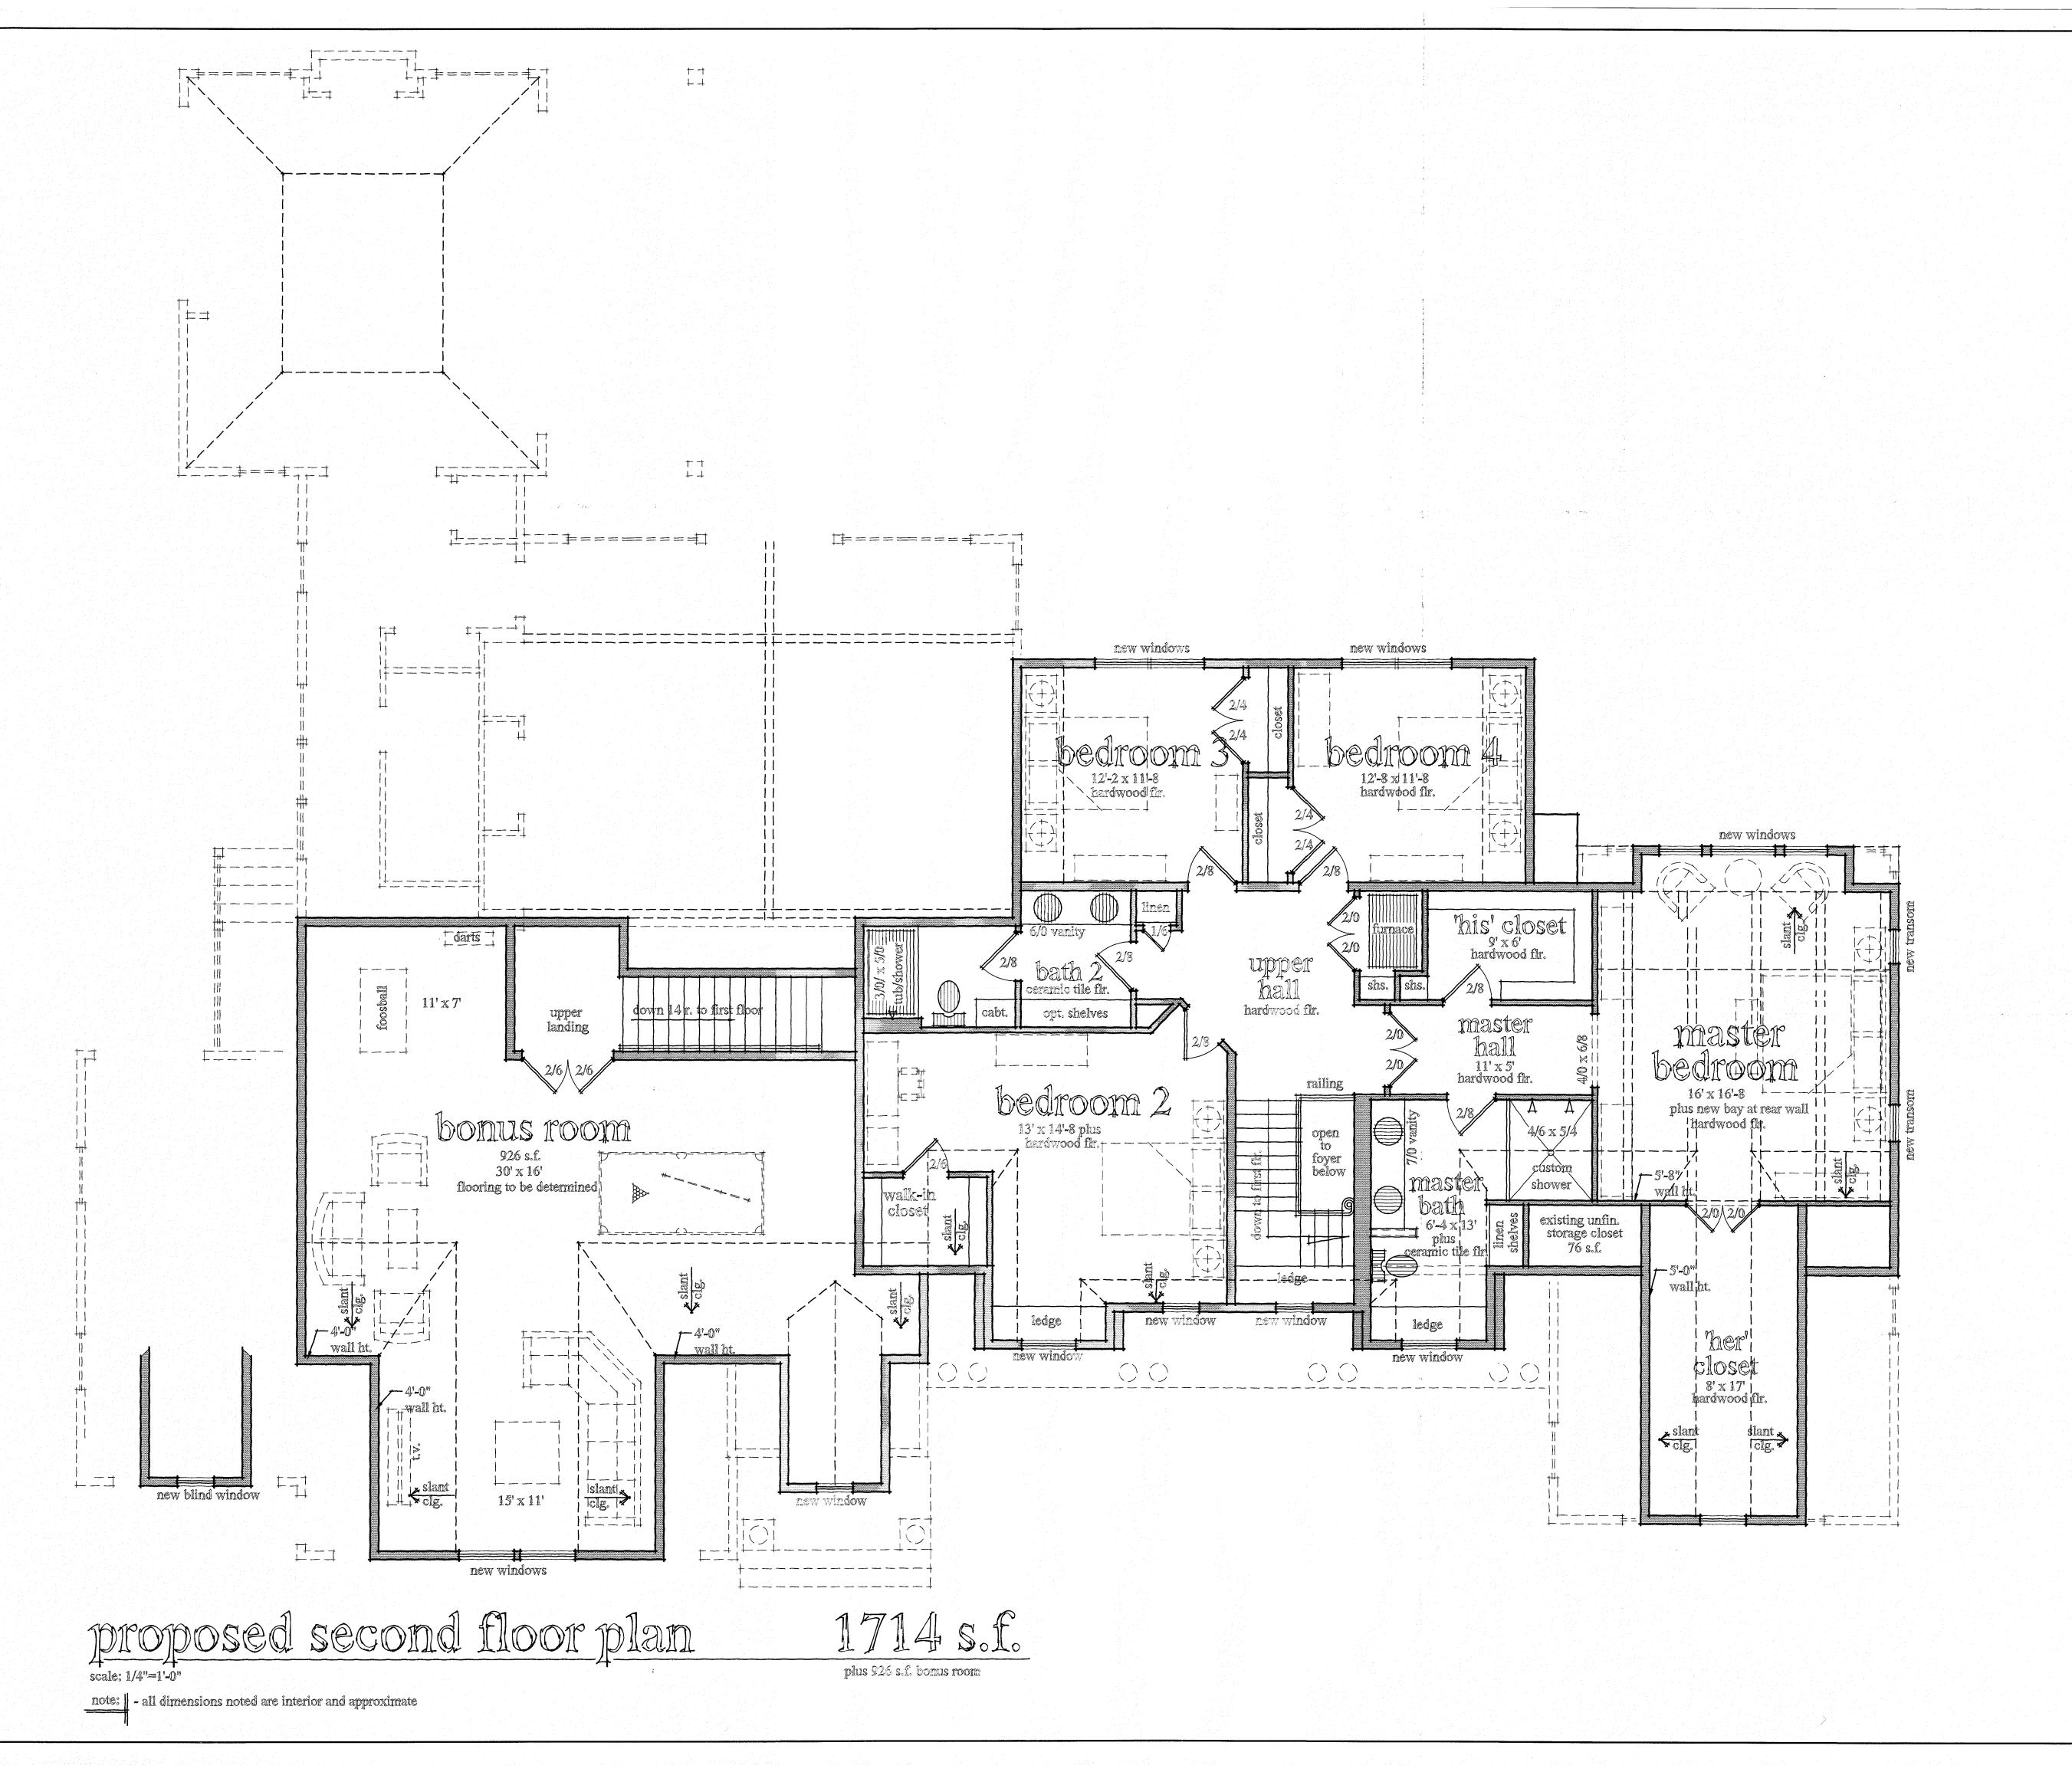

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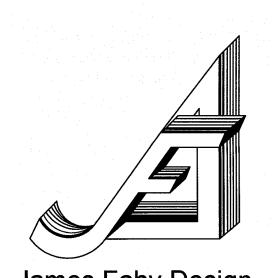
ADDITION / RENOVATION 155 SYLVANIA RD. ROCHESTER, NY

CLIENT: RIK & CORY HERREMA

DRAWING TITLE:
PROPOSED SECOND FLOOR PLAN

PHASE: PRELIMINARY PLAN

JOB NO. A21-060	PROJECT NO. ADDITION
DRAWN BY: KAD	DRAWING NO:
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DATE: 10-6-2021	



James Fahy Design
2024 W. Henrietta Rd. Suite 3K
Rochester, New York 14623
tel: 585-272-1650
e-mail: info@jamesfahy.com
website: www.jamesfahy.com



proposed front elevation scale: 1/8"=1'-0"

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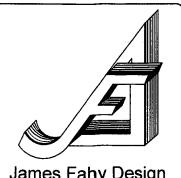
HERREMA RENOVATION 155 SYLVANIA ROAD ROCHESTER, NEW YORK

RIK & CORY HERREMA

DRAWING TITLE: PROPOSED FRONT ELEVATION

PRELIMINARY PLAN

JOB NO. A21-060	PROJECT NO. RENOVATION
DRAWN BY: KAD	DRAWING NO:
CHECKED BY: JRF	1 of 4
DATE: 0- 5-202	1 01 1



James Fahy Design



proposed rear elevation scale: 1/8"=1'-0"

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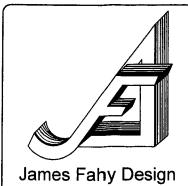
HERREMA RENOVATION 155 SYLVANIA ROAD ROCHESTER, NEW YORK

RIK & CORY HERREMA

DRAWING TITLE: PROPOSED REAR ELEVATION

PRELIMINARY PLAN

JOB NO. A21-060	PROJECT NO. RENOVATION
DRAWN BY: KAD	DRAWING NO:
CHECKED BY: JRF	2 of 4
DATE: 10-15-2021	L 01 1





proposed right side elevation scale: 1/8"=1'-0"

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HERREMA RENOVATION 155 SYLVANIA ROAD ROCHESTER, NEW YORK

RIK & CORY HERREMA


DRAWING TITLE:

PROPOSED RIGHT ELEVATION

PHASE:

PRELIMINARY PLAN

JOB NO. A21-060	PROJECT NO. RENOVATION
DRAWN BY: KAD	DRAWING NO:
CHECKED BY: JRF	3 of 4
DATE: 10-15-2021	0017

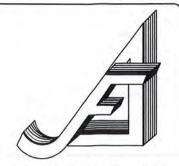

James Fahy Design



proposed left side elevation scale: 1/8"=1'-0"

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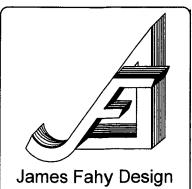
PROJECT: HERREMA RENOVATION 155 SYLVANIA ROAD ROCHESTER, NEW YORK


RIK & CORY HERREMA


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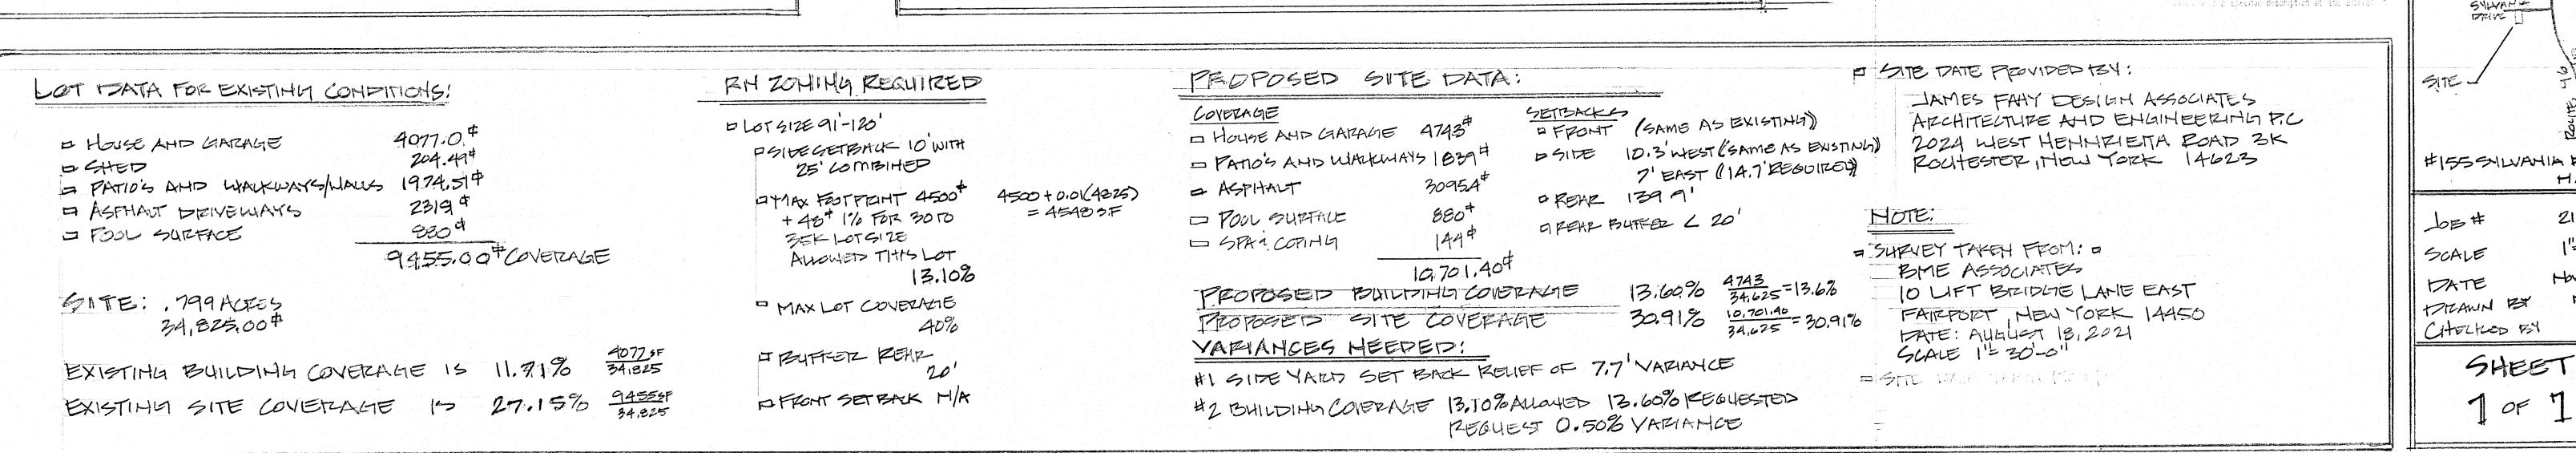
PHASE: PRELIMINARY PLAN

JOB NO. A21-060	PROJECT NO. RENOVATION
DRAWN BY: KAD	DRAWING NO:
CHECKED BY: JRF	4 of 4
DATE: 10-15-2021	





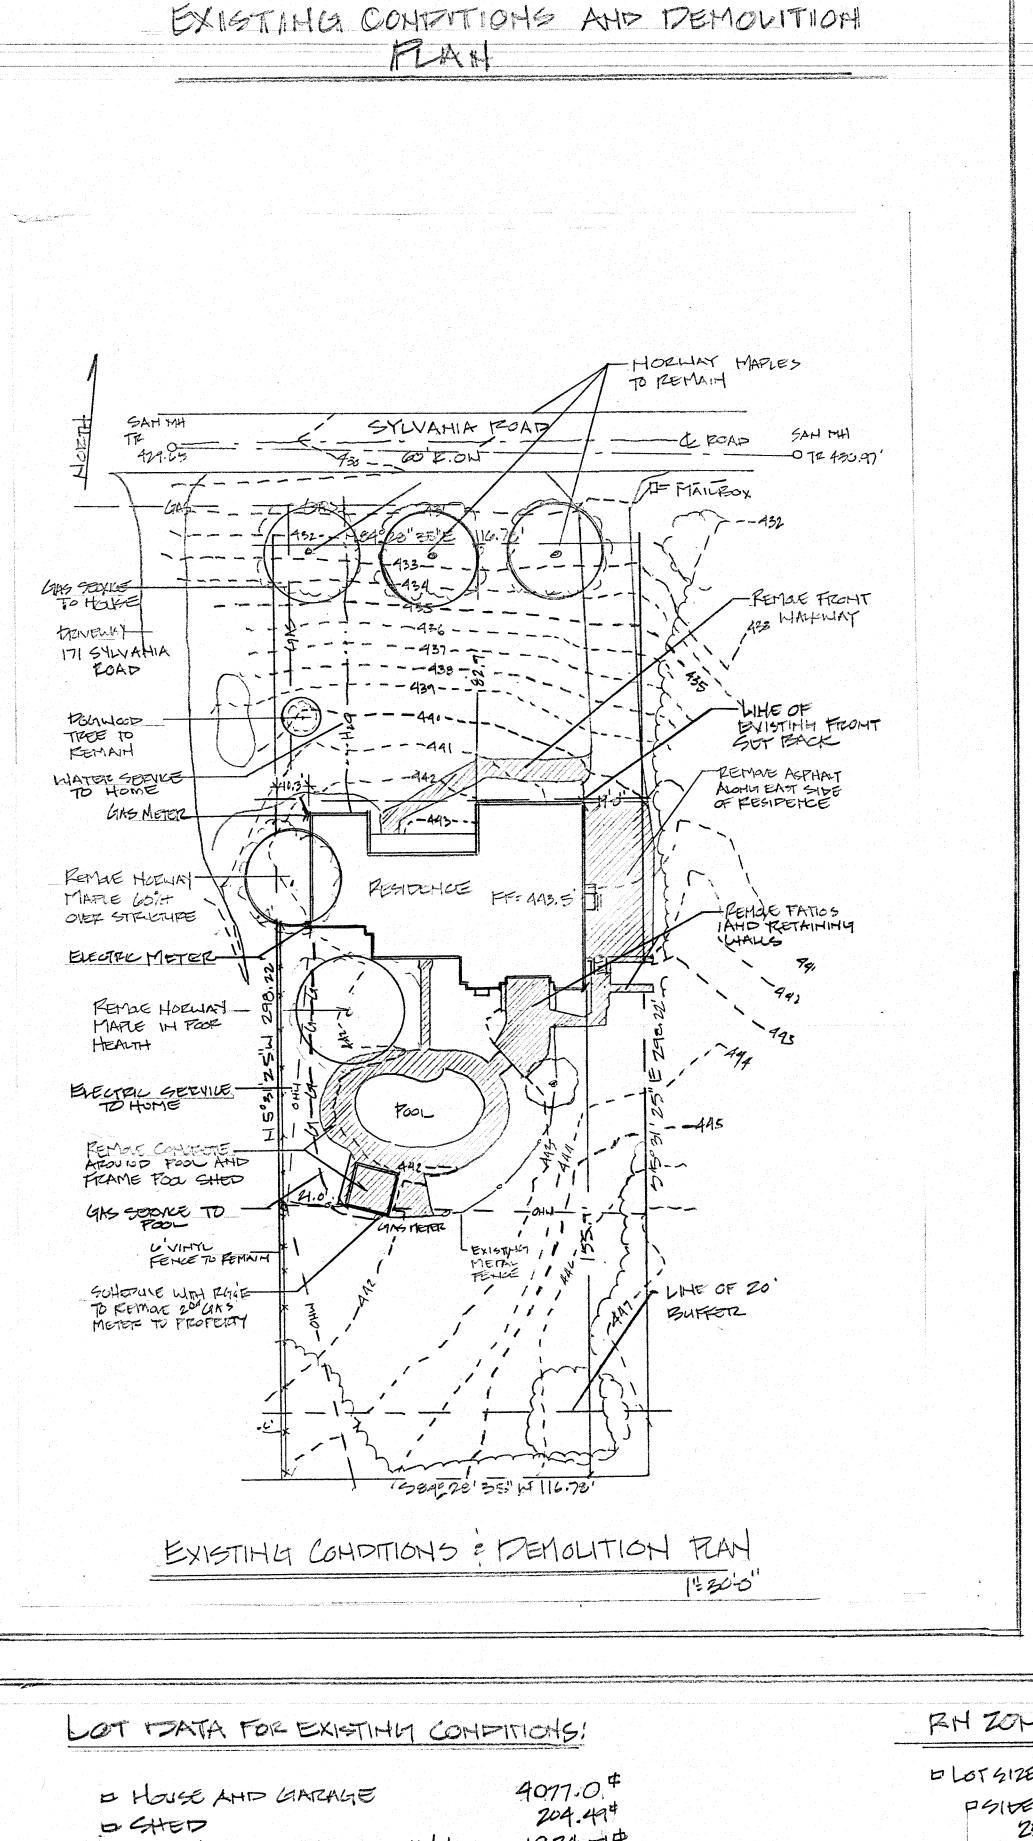

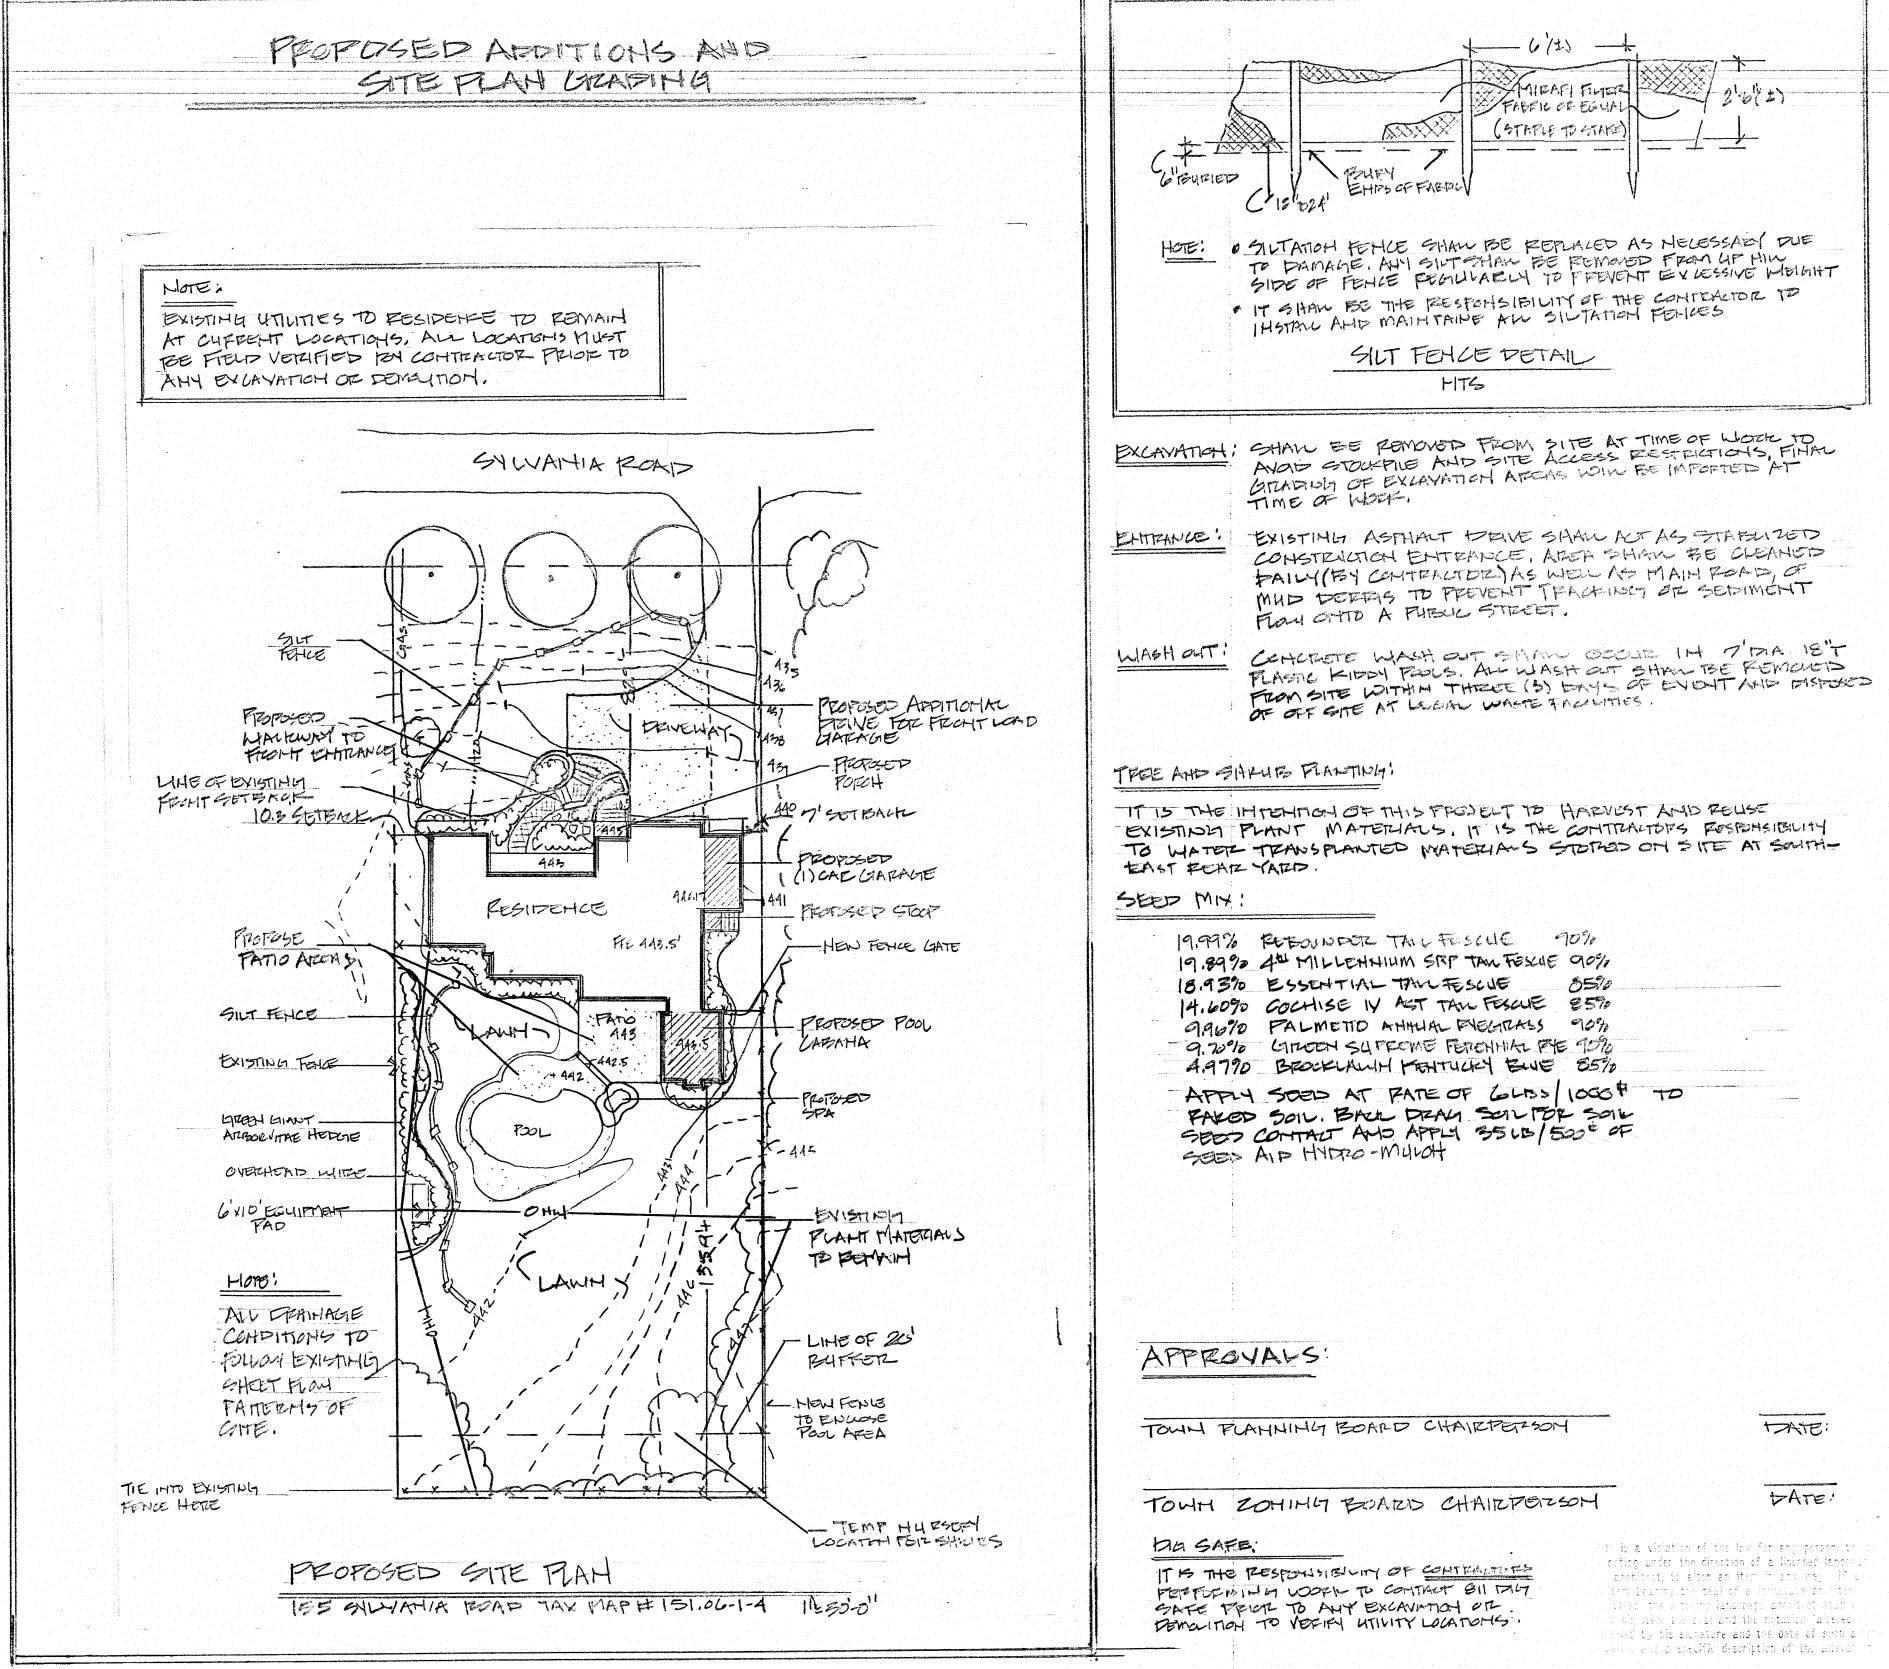

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AND SITE PLAH

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FIKE CORY HERREMA 155 SYWAHIA DRIVE FITTERDED, NEW YOU'L 14532

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LOCATION MAP

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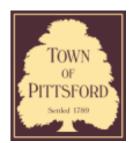
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11/30/21, 8:58 AM Letter View



Town of Pittsford

Department of Public Works 11 South Main Street Pittsford, New York 14534

Permit # B21-000239

Phone: 585-248-6250 FAX: 585-248-6262

DESIGN REVIEW AND HISTORIC PRESERVATION BOARD REFERRAL OF APPLICATION

Property Address: 35 Coventry Ridge PITTSFORD, NY 14534

Tax ID Number: 177.03-5-41

Zoning District: IZ Incentive Zoning

Owner: Two Rivers Son LLC

Applicant: Coventry Ridge Building Corp.


Application Type:

PP.		
~	Residential Design Review §185-205 (B)	Build to Line Adjustment §185-17 (B) (2)
	Commercial Design Review §185-205 (B)	Building Height Above 30 Feet §185-17 (M)
	Signage §185-205 (C)	Corner Lot Orientation §185-17 (K) (3)
	Certificate of Appropriateness §185-197	Flag Lot Building Line Location §185-17 (L) (1) (c)
	Landmark Designation §185-195 (2)	Undeveloped Flag Lot Requirements §185-17 (L) (2)
	Informal Review	


Project Description: Applicant is requesting design review for the construction of a two story single family home. The home will have a total living area of approximately 3005 square feet and located in the Coventry Ridge Subdivision.

Meeting Date: December 09, 2021

RN Residential Neighborhood Zoning

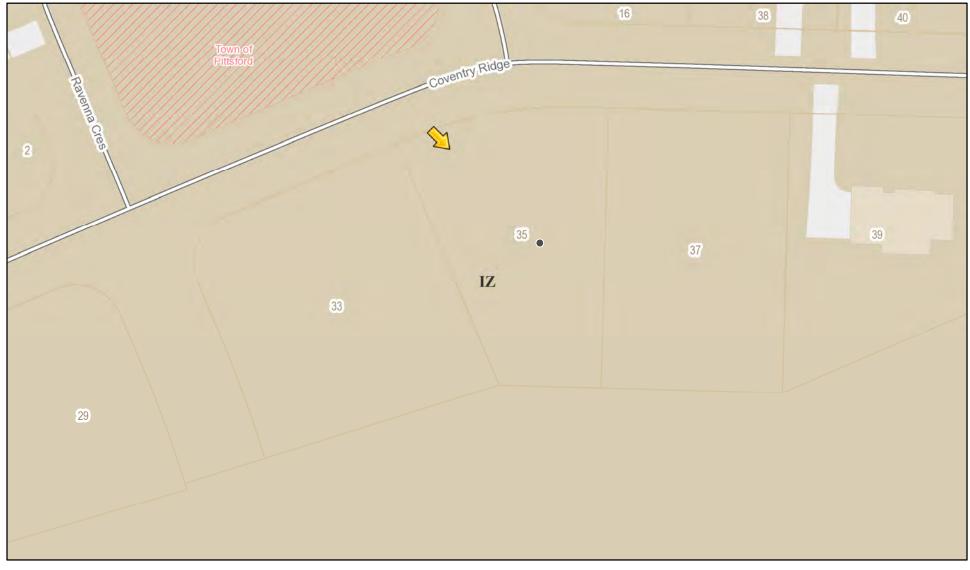

Printed November 30, 2021

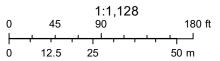

Town of Pittsford GIS

The information depicted on this map is representational and should be used for general reference purposes only. No warranties, expressed or implied, are provided for the data or its use or interpretation.





GENERAL NOTES:

THESE PLANS COMPLY WITH THE 2020 RESIDENTIAL CODE OF NEW YORK STATE (RCNYS) AND THE 2018 ENERGY CONSERVATION CONSTRUCTION CODE OF NEW YORK STATE (ECCCNYS).

COMPLIANCE METHOD: RESCHECK CERTIFICATE OR PRESCRIPTIVE

SANITARY AND ENERGY CONSERVATION CODES - STATE AND OR LOCAL.

BUILDING CODE SHOULD IT DIFFER FROM THESE PLANS.

EXIT REQUIREMENTS.

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IT IS THE RESPONSIBILITY OF THE CONTRACTOR, BUILDER OR OWNER OF THIS BUILDING TO NOTIFY GREATER LIVING ARCHITECTURE OF ANY DEVIATION FROM THESE DRAWINGS.

CONTRACTOR TO BE RESPONSIBLE FOR COMPLIANCE WITH ALL APPLICABLE BUILDING/ ELECTRICAL/ MECHANICAL/

CONTRACTOR TO BE RESPONSIBLE TO LOCAL BUILDING DEPARTMENT AND THAT DEPARTMENT'S INTERPRETATION OF THE

CONTRACTOR TO BE RESPONSIBLE THAT BRAND NAME OF WINDOWS AND DOORS INSTALLED MEET NEW YORK STATE

IN THE EVENT OF ANY DISCREPANCIES BETWEEN PLANS, ELEVATIONS, AND/OR DETAILS, THE CONTRACTOR / SUB-CONTRACTOR SHALL CONTACT GREATER LIVING ARCHITECTURE BEFORE CONSTRUCTION FOR CLARIFICATION. IF GREATER LIVING ARCHITECTURE IS NOT CONTACTED, THE CONTRACTOR / SUB-CONTRACTOR WILL ASSUME FULL RESPONSIBILITY.

CONTRACTOR TO BE RESPONSIBLE FOR CONSTRUCTION MEANS, METHODS, TECHNIQUES, SEQUENCES, PROCEDURES AND SAFETY PRECATIONS/ PROGRAMS IN CONNECTION WITH THE WORK.

THESE DRAWINGS ARE NOT TO BE SCALED FOR DIMENSIONS - USE DIMENSIONS GIVEN.

THE CONTRACTOR/ OWNER SHALL REQUEST LOCATION OF ALL UTILITIES PRIOR TO ANY DIGGING.

THE CONTRACTOR SHALL INDEMNIFY THE OWNER AND OWNER'S AGENTS THROUGH ADEQUATE INSURANCE COVERAGE AGAINST ANY CLAIMS ARISING FROM INJURIES DURING CONSTRUCTION, OR FAILURE TO MAINTAIN SAFE CONDITIONS ON THE SITE.

THESE DRAWINGS HAVE BEEN PREPARED FOR STUCTURAL REFERENCE ONLY. ELECTRICAL, MECHANICAL AND OTHER BUILDING

SYSTEMS, IF REQUIRED, ARE TO BE DONE BY OTHERS R806.2 MINIMUM VENT AREA. THE MINIMUM NET FREE VENTILATION AREA SHALL BE LEG OF THE AREA OF THE VENTED SPACE.

GAS PIPING SHALL BE INSTALLED IN ACCORDANCE WITH PART VI OF THE 2020 RCNYS. A SHUTOFF VALVE SHALL BE PROVIDED AHEAD OF EVERY GAS APPLIANCE OR OUTLET FOR A GAS CONNECTION. VALVES SHALL BE LOCATED IN THE SAME ROOM AS, & WITHIN 6' OF THE APPLIANCE, EXCEPT THAT VALVES FOR VENTED GAS FIREPLACES, INSERTS, LOGS & ROOM HEATERS MAY BE REMOTE FROM THE APPLIANCE WHERE PROVIDED WITH READY ACCESS. SUCH VALVES SHALL BE PERMANENTLY IDENTIFIED & SERVE NO OTHER EQUIPMENT. SHUTOFF VALVES SHALL BE INSTALLED IN ACCORDANCE W/ SECTION G242O.

DRYER EXHAUST DUCTS SHALL HAVE A SMOOTH INTERIOR FINISH & BE CONSTRUCTED OF METAL HAVING A MINIMUM THICKNESS OF 0.0157" (NO. 28 GUAGE), & SHALL BE 4" NOMINAL IN DIAMETER. EXHAUST DUCTS SHALL TERMINATE ON THE OUTSIDE OF THE BUILDING AS PER MANUFACTURER'S INSTALLATION INSTRUCTIONS, BUT NOT LESS THAN 3' IN ANY DIRECTION FROM OPENINGS INTO BUILDINGS.

ENERGY EFFICIENCY:

R401.3 CERTIFICATE (MANDATORY) A PERMANENT CERTIFICATE COMPLETED SHALL BE COMPLETED BY THE BUILDER OR OTHER APPROVED PARTY, AND POSTED ON A WALL IN THE SPACE WHERE THE FURNACE IS LOCATED, A UTILITY ROOM OR AN APPROVED LOCATION INSIDE THE BUILDING.

R402.2.4 ATTIC ACCESS SHALL BE INSULATED WITH THE SAME R- VALUE AS THE ATTIC, WEATHER STRIPPED & LATCHED

R402.4 AIR LEAKAGE. THE BUILDING THERMAL ENVELOPE SHALL BE CONSTRUCTED TO LIMIT AIR LEAKAGE IN ACCORDANCE WITH THE REQUIREMENTS OF SECTIONS R402.4.1 THROUGH R402.4.5.

R402.4.1BUILDING THERMAL ENVELOPE . THE BUILDING THERMAL ENVELOPE SHALL COMPLY WITH SECTIONS R402.4.1.1 AND R402.4.1.2. THE SEALING METHODS BETWEEN DISSIMILAR MATERIALS SHALL ALLOW FOR DIFFERENTIAL

R402.4.1.1 INSTALLATION. THE COMPONENTS OF THE BUILDING THERMAL ENVELOPE AS LISTED IN TABLE 402.4.1.1 SHALL BE INSTALLED IN ACCORDANCE WITH THE MANUFACTURER'S INSTRUCTIONS AND THE CRITERIA LISTED IN TABLE R402.4.1.1, AS APPLICABLE TO THE METHOD OF CONSTRUCTION. WHERE REQUIRED BY THE CODE OFFICIAL, AN APPROVED THIRD PARTY SHALL INSPECT ALL COMPONENTS AND VERIFY COMPLIANCE. SEE PAGE N-2 FOR TABLE.

R402.4.1.2 TESTING. THE BUILDING OR DWELLING UNIT SHALL BE TESTED AND VERIFIED AS HAVING AN AIR LEAKAGE RATE NOT EXCEEDING THREE AIR CHANGES PER HOUR. TESTING SHALL BE CONDUCTED IN ACCORDANCE WITH RESNET/ICC 380, ASTM E779, OR ASTM E1827 AND REPORTED AT A PRESSURE OF 0.2 INCH w.g. (50 PASCALS). TESTING SHALL BE PERFORMED AT ANY TIME AFTER CREATION OF ALL PENETRATIONS OF THE BUILDING THERMAL ENVELOPE. A WRITTEN REPORT OF THE TEST RESULTS SHALL BE SUPPLIED TO THE CODE OFFICIAL PRIOR TO RECEIPT OF A C OF O. THE CONTRACTOR SHALL BE RESPONSIBLE TO PROVIDE AN APPROVED PARTY INDEPENDENT OF THE INSULATION INSTALLER TO DO THE INSPECTIONS

EXPANSION AND CONTRACTION.

- 1. EXTERIOR WINDOWS AND DOORS, FIREPLACES AND STOVE DOORS SHALL BE CLOSED, BUT NOT SEALED, BEYOND THE INTENDED WEATHERSTRIPPING OR OTHER INFILTRATION CONTROL MEASURES.
- 2. DAMPERS INCLUDING EXHAUST, INTAKE, MAKEUP AIR, BACKDRAFT AND FLUE DAMPERS SHALL BE CLOSED, BUT NOT SEALED BEYOND INTENDED INFILTRATION CONTROL MEASURES.
- 3. INTERIOR DOORS, IF INSTALLED AT THE TIME OF THE TEST, SHALL BE OPEN.
- 4. EXTERIOR DOORS FOR CONTINUOUS VENTILATION SYSTEMS AND HEAT RECOVERY VENTILATORS SHALL BE CLOSED AND SEALED.
- 5. HEATING AND COOLING SYSTEMS, IF INSTALLED AT THE TIME OF REST, SHALL BE TURNED OFF. 6. SUPPLY AND RETURN REGISTERS, IF INSTALLED AT THE TIME OF REST, SHALL BE FULLY OPEN.

R402.4.5 RECESSED LIGHTING. RECESSED LUMINAIRES INSTALLED IN THE BUILDING THERMAL ENVELOPE SHALL BE SEALED TO LIMIT AIR LEAKAGE BETWEEN CONDITIONED AND UNCONDITIONED SPACES. RECESSED LUMINARIES SHALL BE IC-RATED AND LABELED AS HAVING AN AIR LEAKAGE RATE OF NOT GREATER THAN 2.0 c.f.m (0.944 L/s) WHEN TESTED IN ACCORDANCE WITH ASTM E283 AT A PRESSURE DIFFERENTIAL OF 1.57 p.s.f. (75 Pa.). RECESSED LUMINARIES SHALL BE SEALED WITH A GASKET OR CAULKED BETWEEN THE HOUSING AND THE INTERIOR WALL OR CEILIN COVERING.

R402.5 MAXIMUM FENESTRATION U-FACTOR & SHGC (MANDATORY) THE AREA-WEIGHTED AVERAGE MAXIMUM FENESTRATION U-FACTOR PERMITTED USING TRADEOFFS FROM SECT. R402.1.5 OR R405 SHALL BE .48 IN CLIMATE ZONES 4 & 5 AND 0.40 IN CLIMATE ZONES 6-8 FOR VERTICAL FENESTRATION, & 0.75 IN CLIMATE ZONES 4-8 FOR SKYLIGHTS. THE AREA-WEIGHTED AVERAGE MAXIMUM FENESTRATION SHGC PERMITTED USING TRADEOFFS FROM SECTION R405 IN CLIMATE ZONES 1-3 SHALL BE 0.50

R403.1.1 PROGRAMMABLE THERMOSTAT. THE THERMOSTAT CONTROLLING THE PRIMARY HEATING AND COOLING SYSTEM SHALL BE CAPABLE OF CONTROLLING THE HEATING AND COOLING SYSTEM ON A DAILY SCHEDULE TO MAINTAIN DIFFERENT TEMPERATURE SET POINTS AT DIFFERENT TIMES OF THE DAY. THIS THERMOSTAT SHALL INC. THE CAPABILITY TO SET BACK OR TEMP. OPERATE THE SYSTEM TO MAINTAIN ZONE TEMPERATURES DOWN TO 55 DEG OR UP TO 85 DEG.. THE THERMOSTAT SHALL INITIALLY BE PROGRAMMED BY THE MANF. WITH A HEATING TEMP. SET POINT NO HIGHER THAN 70 DEG. & A COOLING TEMP. SET POINT NO LOWER THAN 78 DEG.

R403.1.2 HEAT PUMP SUPPLEMENTARY HEAT (MANDATORY). HEAT PUMPS HAVING SUPPLEMENTARY ELECTRIC-RESISTANCE HEAT SHALL HAVE CONTROLS THAT, EXCEPT DURING DEFROST, PREVENT SUPPLEMENTAL HEAT OPERATION WHEN THE HEAT PUMP COMPRESSOR CAN MEET THE HEATING LOAD.

R403.3.1 INSULATION (PRESCIPTIVE) SUPPLY & RETURN DUCTS IN ATTICS SHALL BE INSULATED TO A MIN. OF R-8. WITH THE EXCEPTION OF DUCTS OR PORTIONS THEREOF LOCATED COMPLETELY INSIDE THE BUILDING THERMAL ENVELOPE

R403.3.2 SEALING (MANDATORY). DUCTS, AIR HANDLERS AND FILTER BOXES SHALL BE SEALED. JOINTS AND SEAMS SHALL COMPLY WITH EITHER THE MECHANICAL CODE OF NEW YORK STATE (MCONYS) OR RCNYS, AS APPLICABLE.

R403.3.3 DUCT TESTING (MANDATORY). DUCTS SHALL BE PRESSURE TESTED TO DETERMINE AIR LEAKAGE BY ONE OF

THE FOLLOWING METHODS: 1. ROUGH IN TEST: TOTAL LEAKAGE SHALL BE MEASURED WITH A PRESSURE DIFFERENTIAL OF 0.1 INCH w.g. (25 Pa) ACCROSS THE SYSTEM, INCLUDING THE MANUFACTURER'S AIR HANDLER ENCLOSURE IF INSTALLED AT THE TIME OF THE TEST. ALL REGISTERS SHALL BE TAPED OR OTHERWISE SEALED DURING THE TEST.

2. POSTCONSTUCTION TEST: TOTAL LEAKAGE SHALL BE MEASURED WITH A PRESSURE DIFFERENTIAL OF 0.1 INCH w.g. (25 Pa) ACCROSS THE SYSTEM, INCLUDING THE MANUFACTURER'S AIR HANDLER ENCLOSURE. ALL REGISTERS SHALL BE TAPED OR OTHERWISE SEALED DURING THE TEST.

R403.3.5 BUILDING CAVITIES (MANDATORY). BUILDING FRAMING CAVITIES SHALL NOT BE USED AS DUCTS OR PLENUMS. R403.4 MECHANICAL SYSTEM PIPING CAPABLE OF CARRYING FLUIDS ABOVE 105 DEGREES F OR BELOW 55 DEGREES F SHALL BE INSULATED TO A MINIMUM OF R-3.

R403.5.1 HEATED WATER CIRCULATION & TEMPERATURE MAINTENANCE SYSTEMS (MANDATORY). HEATED WATER CIRCULATION SYSTEMS SHALL BE IN ACCORDANCE WITH SECTION R403.5.1.1. HEAT TRACE TEMPERATURE MAINTENANCE SYSTEMS SHALL BE IN ACCORDANCE WITH SECTION R403.5.1.2. AUTOMATIC CONTROLS, TEMPERATURE SENSORS & PUMPS SHALL BE ACCESSIBLE. MANUAL CONTROLS SHALL BE READILY ACCESSIBLE.

R403.5.3 HOT WATER PIPE INSULATION (PRESCRIPTIVE). INSULATION FOR HOT WATER PIPE WITH A MIN. R-3 SHALL BE APPLIED TO THE FOLLOWING:

- 1. PIPING 3/4" AND LARGER IN NOMINAL DIAMETER.
- 2. PIPING SERVING MORE THAN ONE DWELLING UNIT.
- 3. PIPING LOCATED OUTSIDE THE CONDITIONED SPACE. 4. PIPING FROM THE WATER HEATER TO A DISTRIBUTION MANIFOLD.
- 5. PIPING LOCATED UNDER A FLOOR SLAB.
- 7. SUPPLY & RETURN PIPING IN RECIRCULATION SYSTEMS OTHER THAN DEMAND RECIRCULATION SYSTEMS

R403.6 MECHANICAL VENTILATION (MANDATORY). THE BUILDING SHALL BE PROVIDED WITH VENTILATION THAT MEETS THE REQUIREMENTS OF THE IRC OR IMC, AS APPLICABLE, OR WITH OTHER APPROVED MEANS OF VENTILATION. OUTDOOR AIR INTAKES AND EXHAUSTS SHALL HAVE AUTOMATIC OR GRAVITY DAMPERS THAT CLOSE WHEN THE VENTILATION

R403.6.1 WHOLE-HOUSE MECHANICAL VENTILATION SYSTEM FAN EFFICACY. MECHANICAL VENTILATION SYSTEM FANS SHALL MEET THE EFFICACY REQUIREMENTS OF TABLE R403.6.1.

R403.7 EQUIPMENT SIZING & EFFICIENCY RATING (MANDATORY). HEATING & COOLING EQUIPMENT SHALL BE SIZED IN ACCORDANCE W/ ACCA MANUAL S BASED ON BUILDING LOADS CALCULATED IN ACCORDANCE W/ ACCA MANUAL J OR OTHER APPROVED HEATING & COOLING CALCULATION METHODOLOGIES. NEW OR REPLACEMENT HEATING & COOLING EQUIPMENT SHALL HAVE A EFFICIENCY RATING EQUAL TO OR GREATER THAN THE MINIMUM REQUIRED BY FEDERAL LAW FOR THE GEOGRAPHIC LOCATION WHERE THE EQUIPMENT IS INSTALLED.

R404.1 LIGHTING EQUIPMENT (MANDATORY) A MINIMUM OF 90% OF THE LAMPS IN PERMANENTLY INSTALLED LIGHTING FIXTURES SHALL BE HIGH-EFFICACY LAMPS.

SYSTEM IS NOT OPERATING

THESE PLANS HAVE BEEN PREPARED ACCORDING TO THE 2020 RCNYS AND IECC REQUIREMENTS TO SUIT A GENERAL RANGE OF CONDITIONS THAT MAY BE AFFECTED BY A PARTICULAR BUILDING SITE OR BUILDER/ OWNER CONTRACTUAL AGREEMENT. CONTRACTOR TO BE RESPONSIBLE TO ADAPT THESE PLANS TO SUIT THE NEEDS OF THE BUILDING ON SITE AS REQUIRED, PROVIDED THAT SUCH ADJUSTMENTS DO NOT VIOLATE THE CODE OR ALTER THE STRUCTURAL INTEGRITY OF THE BUILDING.

CONTRACTOR/ OWNER SHALL PERFORM EXPLORATORY EXCAVATION TO DETERMINE ACTUAL FIELD CONDITIONS AND NOTIFY THIS OFFICE OF THE FINDINGS TO ALLOW FOR DESIGN CHANGES PRIOR TO ACTUAL CONSTRUCTION. IT SHALL BE THE RESPONSIBILITY OF THE CONTRACTOR/ OWNER TO DEVELOP THE NECESSARY FOUNDATION SOIL TO SUSTAIN THE LOAD DESIGNS OF 2500 P.S.F. AND TO HIRE, IF NECESSARY, A SOILS ENGINEER TO INSPECT AND VERIFY SOIL CONDITIONS PRIOR TO POURING OF FOUNDATIONS.

THE CONTRACTOR, BUILDER OR OWNER SHALL NOTIFY GREATER LIVING ARCHITECTURE OF ANY UNUSUAL SITE CONDITIONS WHICH MAY EFFECT THE FOUNDATION, DRAINAGE OR STRUCTURAL MEMBERS INCLUDING REQUIREMENTS FOR ADDITIONAL DEPTH OF FOOTINGS, UNSTABLE SOIL CONDITIONS AND HIGH GROUND WATER TABLE.

NO SITE INSPECTIONS ARE TO BE MADE BY THIS OFFICE. CONTRACTOR TO BE RESPONSIBLE FOR MATERIALS AND WORKMANSHIP. SUBSTITUTIONS FOR MATERIALS SPECIFIED TO BE MADE WITH THE PERMISSION OF THE LOCAL BUILDING DEPT.

LOT 112 COVENTRY RIDGE PITTSFORD, NY COVENTRY RIDGE BUILDING CORP. PLAN 3005 / PROJECT 15399 B

SHEET INDEX

- C-1 COVER SHEET
- 1/6 ELEVATIONS
- 2/6 ELEVATIONS
- 3/6 FOUNDATION PLAN
- 4/6 FIRST FLOOR PLAN
- 5/6 SECOND FLOOR PLAN
- 6/6 SECTIONS
- N-1 DETAILS

N-2 REINFORCING NOTES

FOUNDATION:

THE BOTTOM OF ALL FOOTINGS SHALL BE AT LEAST 48" BELOW FINISHED GRADE & TO REST ON (ORIGINAL) UNDISTURBED SOIL, & ASSUMED MINIMUM SOIL BEARING PRESSURE TO BE 2500 P.S.F. CONTRACTOR TO BE RESPONSIBLE FOR ALL SUBGRADE CONDITIONS

BASEMENT/CELLAR WALLS AND FOOTING DESIGNS ASSUMED PARTIALLY SATURATED SOIL CONDITIONS TO TO THE FULL WALL DEPTH. SHOULD SATURATED CONDITIONS BE ENCOUNTERED, OUR OFFICE SHOULD BE CONTACTED FOR REVIEW AND POSSIBLE REVISIONS TO THE PLANS.

CONTRACTOR ASSUMES FULL RESPONSIBILITY FOR PROVIDING PROPER DRAINAGE SHOULD INTERMITTENT SPRINGS OR PERCHED WATER BE ENCOUNTERED.

POSITIVE DRAINAGE SHALL BE PROVIDED SO THAT FINISHED GRADE SLOPES AWAY FROM PERIMETER WALLS & FOOTINGS. CONTINUOUS 4" DIAM. PERFORATED DRAIN PIPE SHALL BE PLACED ALONG THE PERIMETER OF THE BASEMENT WALLS WHICH DRAINS TO THE SUMP PUMP. A MINIMUM OF 6" GRANULAR BASE SHALL BE PLACED OVER THE DRAIN TILE AND MINIMUM OF 2"

CONCRETE AND MASONRY FOUNDATION WALLS SHALL BE CONSTRUCTED AS SET FORTH AS PER TABLES ON N-2.

VENTED GAS FIREPLACE SHALL BE LISTED, LABELED & INSTALLED IN ACCORDANCE WITH ANSI Z21.50, SECT. G2434 OF THE 2020 RCNYS & THE MANUFACTURER'S INSTRUCTIONS. INSTRUCTIONS SHALL BE AVAILABLE ON SITE FOR BUILDING INSPECTOR. APPLIANCE SHALL BE EQUIPED WITH A FLAME SAFEGUARD DEVICE IN ACCORDANCE WITH SECT. G2431.

NEW WOOD-BURNING FIREPLACES SHALL HAVE TIGHT-FITTING FLUE DAMPERS OR DOORS, AND OUTDOOR COMBUSTION AIR WHERE USING TIGHT-FITTING DOORS ON FACTORY BUILT FIREPLACES LISTED AND LABELED IN ACCORDANCE WITH UL 127, THE DOORS SHALL BE TESTED AND LISTED FOR THE FIREPLACE. WHERE USING TIGHT FITTING DOORS ON MASONRY FIREPLACES, THE DOORS SHALL BE LISTED AND LABELED IN ACCORDANCE WITH UL 907.

WOOD ROOF TRUSSES ARE TO BE METAL PLATE CONNECTED WOOD CHORD, WOOD WEB TRUSSES. TRUSS LAYOUT IS SCHEMATIC ONLY. TRUSS MANUFACTURER SHALL BE RESPONSIBLE FOR THE DESIGN (INCLUDING SPACING) OF ALL TRUSSES. TRUSSES TO BE DESIGNED AND CERTIFIED BY AN ENGINEER LICENSED IN THE GOVERNING STATE

PROVIDE ALL TEMPORARY BRACING AND SHORING TO AVOID EXCESSIVE STRESSES AND HOLD STRUCTURAL ELEMENTS IN PLACE DURING CONSTRUCTION.

UNDER ALL CONCEALED WOOD BEARING POSTS, PROVIDE ADDITIONAL WOOD BLOCKING AS REQUIRED IN FLOOR JOIST SPACE UNDER POST, TO ENSURE SOLID BEARING FROM HEADER OR BEAM DOWN TO FOUNDATION WALL.

ALL WINDOWS AND DOORS ARE TO BE FRAMED WITH MINIMUM (2)2X8 OR (3)2X6 HEADER UNLESS NOTED OTHERWISE.

BUILDER ASSUMES FULL RESPONSIBILITY FOR MAINTAINING THE STRUCTURAL INTEGRITY OF JOISTS. BEAMS OR STUDS WHICH ARE NOTCHED OR DRILLED TO ACCOMMODATE MECHANICAL OR ELECTRICAL LINES. SEE DETAILS ON PG. N-1 FOR ALLOWABLE DRILLING LOCATION ON BEAMS AND JOISTS.

ALL STRESS GRADE LUMBER CONSTRUCTION SHALL COMPLY WITH AITC TIMBER CONSTRUCTION STANDARDS LATEST EDITION EACH PIECE SHALL BEAR THE STAMP OF A GRADING RULES AGENCY, APPROVED BY THE AMERICAN LUMBER STANDARDS COMMITTEE . GRADE LOSS RESULTING FROM EFFECTS OF WEATHER, HANDLING, STORAGE, RESAWING, OR DIVIDING LENGTHS WILL BE CAUSE FOR REJECTION.

ALL WOOD, IN CONTACT WITH CONCRETE OR EXPOSED TO THE ELEMENTS, SHALL BE PRESSURE TREATED OR OF A SPECIES SUITABLE FOR OUTDOOR USE. ALL FASTENER, JOIST HANGERS, & FLASHING SHALL BE HOT DIP GALVANIZED, STAINLESS STEEL, SILICON, BRONZE, OR COPPER, & SHALL BE APPROVED BY THE MANUFACTURER FOR USE W/ PRESSURE TREATED WOOD.

FLASHING IS REQUIRED IN THE FOLLOWING LOCATIONS: AT WALL & ROOF INTERSECTIONS & PROJECTING WOOD TRIM, TOP OF ALL EXTERIOR WINDOWS & DOOR OPENINGS, CHIMNEYS, UNDER & AT ENDS OF MASONRY, WOOD OR METAL COPINGS & SILLS, & WHERE EXTERIOR PORCHES, DECKS OR STAIRS ATTACH TO A WALL OR FLOOR ASSEMBLY OF WOOD-FRAMED CONSTRUCTION & BUILT-IN GUTTERS. FLASHINGS SHALL BE PROVIDED AS REQ'D. TO COMPLY WITH ALL OF SECT. R703.4 OF THE 2020 RCNYS. STRUCTURAL COLUMNS SHALL BE RESTRAINED TO PREVENT LATERAL DISPLACEMENT AT THE BOTTOM END. WOOD COLUMNS SHALL NOT BE LESS IN NOMINAL SIZE THAN 4" X 4" & STEEL COLUMNS SHALL NOT BE LESS THAN 3" DIAM. STANDARD PIPE OR APPROVED EQUIVALENT.

STAIRWAY & GUARD REQUIREMENTS:

THE PASSAGE OF A SPHERE 4 INCHES IN DIAMETER. AS PER SECTION 312.1.3 OF THE 2020 RCNYS.

STAIRWAYS SHALL BE AT LEAST 36" WIDE. TREADS SHALL BE AT LEAST 9" DEEP PLUS 3/4" TO 1 1/4" NOSING FOR CLOSED RISER TYPE, OR 9" FOR OPEN RISER TYPE. RISERS SHALL BE NO MORE THAN 8 1/4" HIGH. STAIRS SHALL COMPLY WITH SECTION R3 1 1.7 OF THE 2020 RCNYS.

HANDRAILS SHALL BE PROVIDED ON AT LEAST ONE SIDE OF STAIRWAYS WITH FOUR OR MORE RISERS. TOP SURFACE OF HANDRAILS SHALL BE BETWEEN 34" & 36" ABOVE TREAD NOSING. GUARDS SHALL BE LOCATED ALONG AN OPEN SIDED WALKING SURFACE THAT ARE LOCATED MORE THAN 30 INCHES

MEASURED VERTICALLY TO THE FLOOR OR GRADE BELOW AT ANY POINT WITHIN 36 INCHES HORIZONTALLY TO THE EDGE OF THE OPEN SIDE. REQUIRED GUARDS SHALL NOT BE LESS THAN 36" IN HEIGHT MEASURED VERTICALLY ABOVE WALKING SURFACE. REQUIRED GUARDS SHALL NOT HAVE OPENINGS FROM THE WALKING SURFACE TO THE REQUIRED GUARD HEIGHT THAT ALLOW

GARAGE FIREPROOFING:

3/4 HOUR FIRE RESISTANCE RATING REQUIRED BETWEEN HOUSE & GARAGE CAN BE ACHIEVED WITH ONE LAYER 5/8" TYPE X DRYWALL ON GARAGE SIDE AND ONE LAYER 1/2" TYPE X DRYWALL ON THE HOUSE SIDE.

IF HORIZONTAL CONSTRUCTION IS USED TO SEPARATE THE GARAGE FROM LIVING AREA OR BONUS AREAS ABOVE, THEN ONE LAYER OF 5/8" TYPE X DRYWALL ON THE CEILING IS REQUIRED. WHERE THE HORIZONTAL CONSTRUCTION IS A FLOOR-CEILING ASSEMBLY, THE STRUCTURE SUPPORTING THE SEPARATION SHALL ALSO PROTECTED BY 5/8" TYPE X DRYWALL.

STRUCTURAL MATERIAL SPECIFICATIONS:

STRUCTURAL STEEL ASTM A-36, Fy = 36 ksiREINFORCED STEEL ASTM A-615, Fy = 40 ksiWIRE MESH ASTM A-185, 6 x 6 - 10/10 W.W.M.

> ALL STUCTURAL MEMBERS, JOISTS, RAFTERS, ETC TO BE #2 GRADE LUMBER (DOUGLAS FIR-LARCH, HEM-FIR, SOUTHERN PINE OR SPRUCE PINE-FIR) WITH A MIN. FIBER STRESS OF 850 P.S.I. **UNLESS NOTED OTHERWISE**

CDX, PANEL INDEX LVL, PSL, LSL Fb = 2600Fv = 285

MASONRY ASTM C90, GRADE N-1, Fm = 1350 PSI

MORTAR ASTM C270, TYPE S GROUT Fc = 2000 PSI ASTM C476

CONCRETE Fc = 2500 PSI MIN. (FOOTINGS, BASEMENT SLAB) Fc = 3500 PSI MIN. (GARAGE SLAB, PORCH SLAB, & POURED FOUNDATION WALLS

ASTM A307, Fy - 33 KSI

DESIGN CRITERIA: (FOR GREATER ROCHESTER AREA & ADJACENT COUNTIES)

LOCAL JURISDICTION DESIGN CRITERIA MAY VARY AND

PLYWOOD

SHALL BE STRICTLY ADHERED TO 40 P.S.F. LIVING AREA LIVE LOAD 2ND FLOOR 30 P.S.F. LIVING AREA LIVE LOAD 1ST & 2ND FLOOR DEAD LOAD 15 P.S.F.

40 P.S.F. GROUND SNOW LOAD ROOF DEAD LOAD 10 P.S.F.

ALLOWABLE SOIL BEARING 2500 P.S.F. AT MINIMUM 42" BELOW FINISHED GRADE WIND SPEED 115 MPH, EXPOSURE B

CATEGORY B SEISMIC DESIGN SEVERE WEATHERING **42 INCHES** FROST LINE DEPTH SLIGHT TO MODERATE TERMITE DAMAGE NONE TO SLIGHT DECAY DAMAGE


WINTER DESIGN TEMPERATURE 1 DEGREE REQUIRED 24" INSIDE OF EXTERIOR WALL LINE ICE SHEILD UNDERLAYMENT

FLOOD HAZARD FIRM - 2008

ROOF TIE DOWN REQUIREMENTS R802.11, BASED UPON SPECIFIC ROOF DESIGN

TRUSS IDENTIFICATION:

IDENTIFICATION OF FLOOR AND ROOF TRUSS CONSTRUCTION SHALL BE PROVIDED BY SIGN OR SYMBOL & SHALL BE AFFIXED TO THE EXTERIOR WALL OF THE RESIDENTIAL STRUCTURE IN COMPLIANCE WITH 19 NYCRR PART 1264 & 1265. RESIDENTIAL STRUCTURES WITH TRUSS TYPE CONSTRUCTION, PRE-ENGINEERED WOOD CONSTRUCTION AND / OR TIMBER CONSTRUCTION.

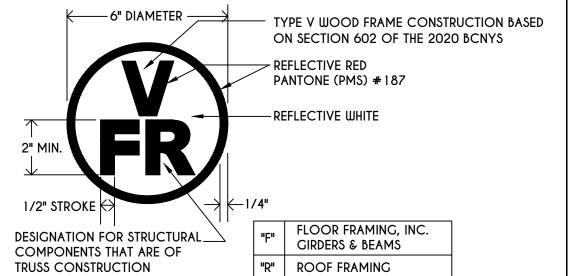


"FR" | FLOOR & ROOF FRAMING

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CLIENT/LOCATION:

LOT 112

PITTSFORD, NY

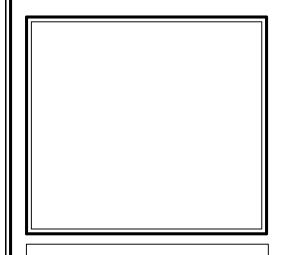
COVENTRY RIDGE

BUILDER: COVENTRY RIDGE BUILDING CORP.

COVER PAGE

GLA PLAN 3005 drawn: checked: CDK date: 11/21

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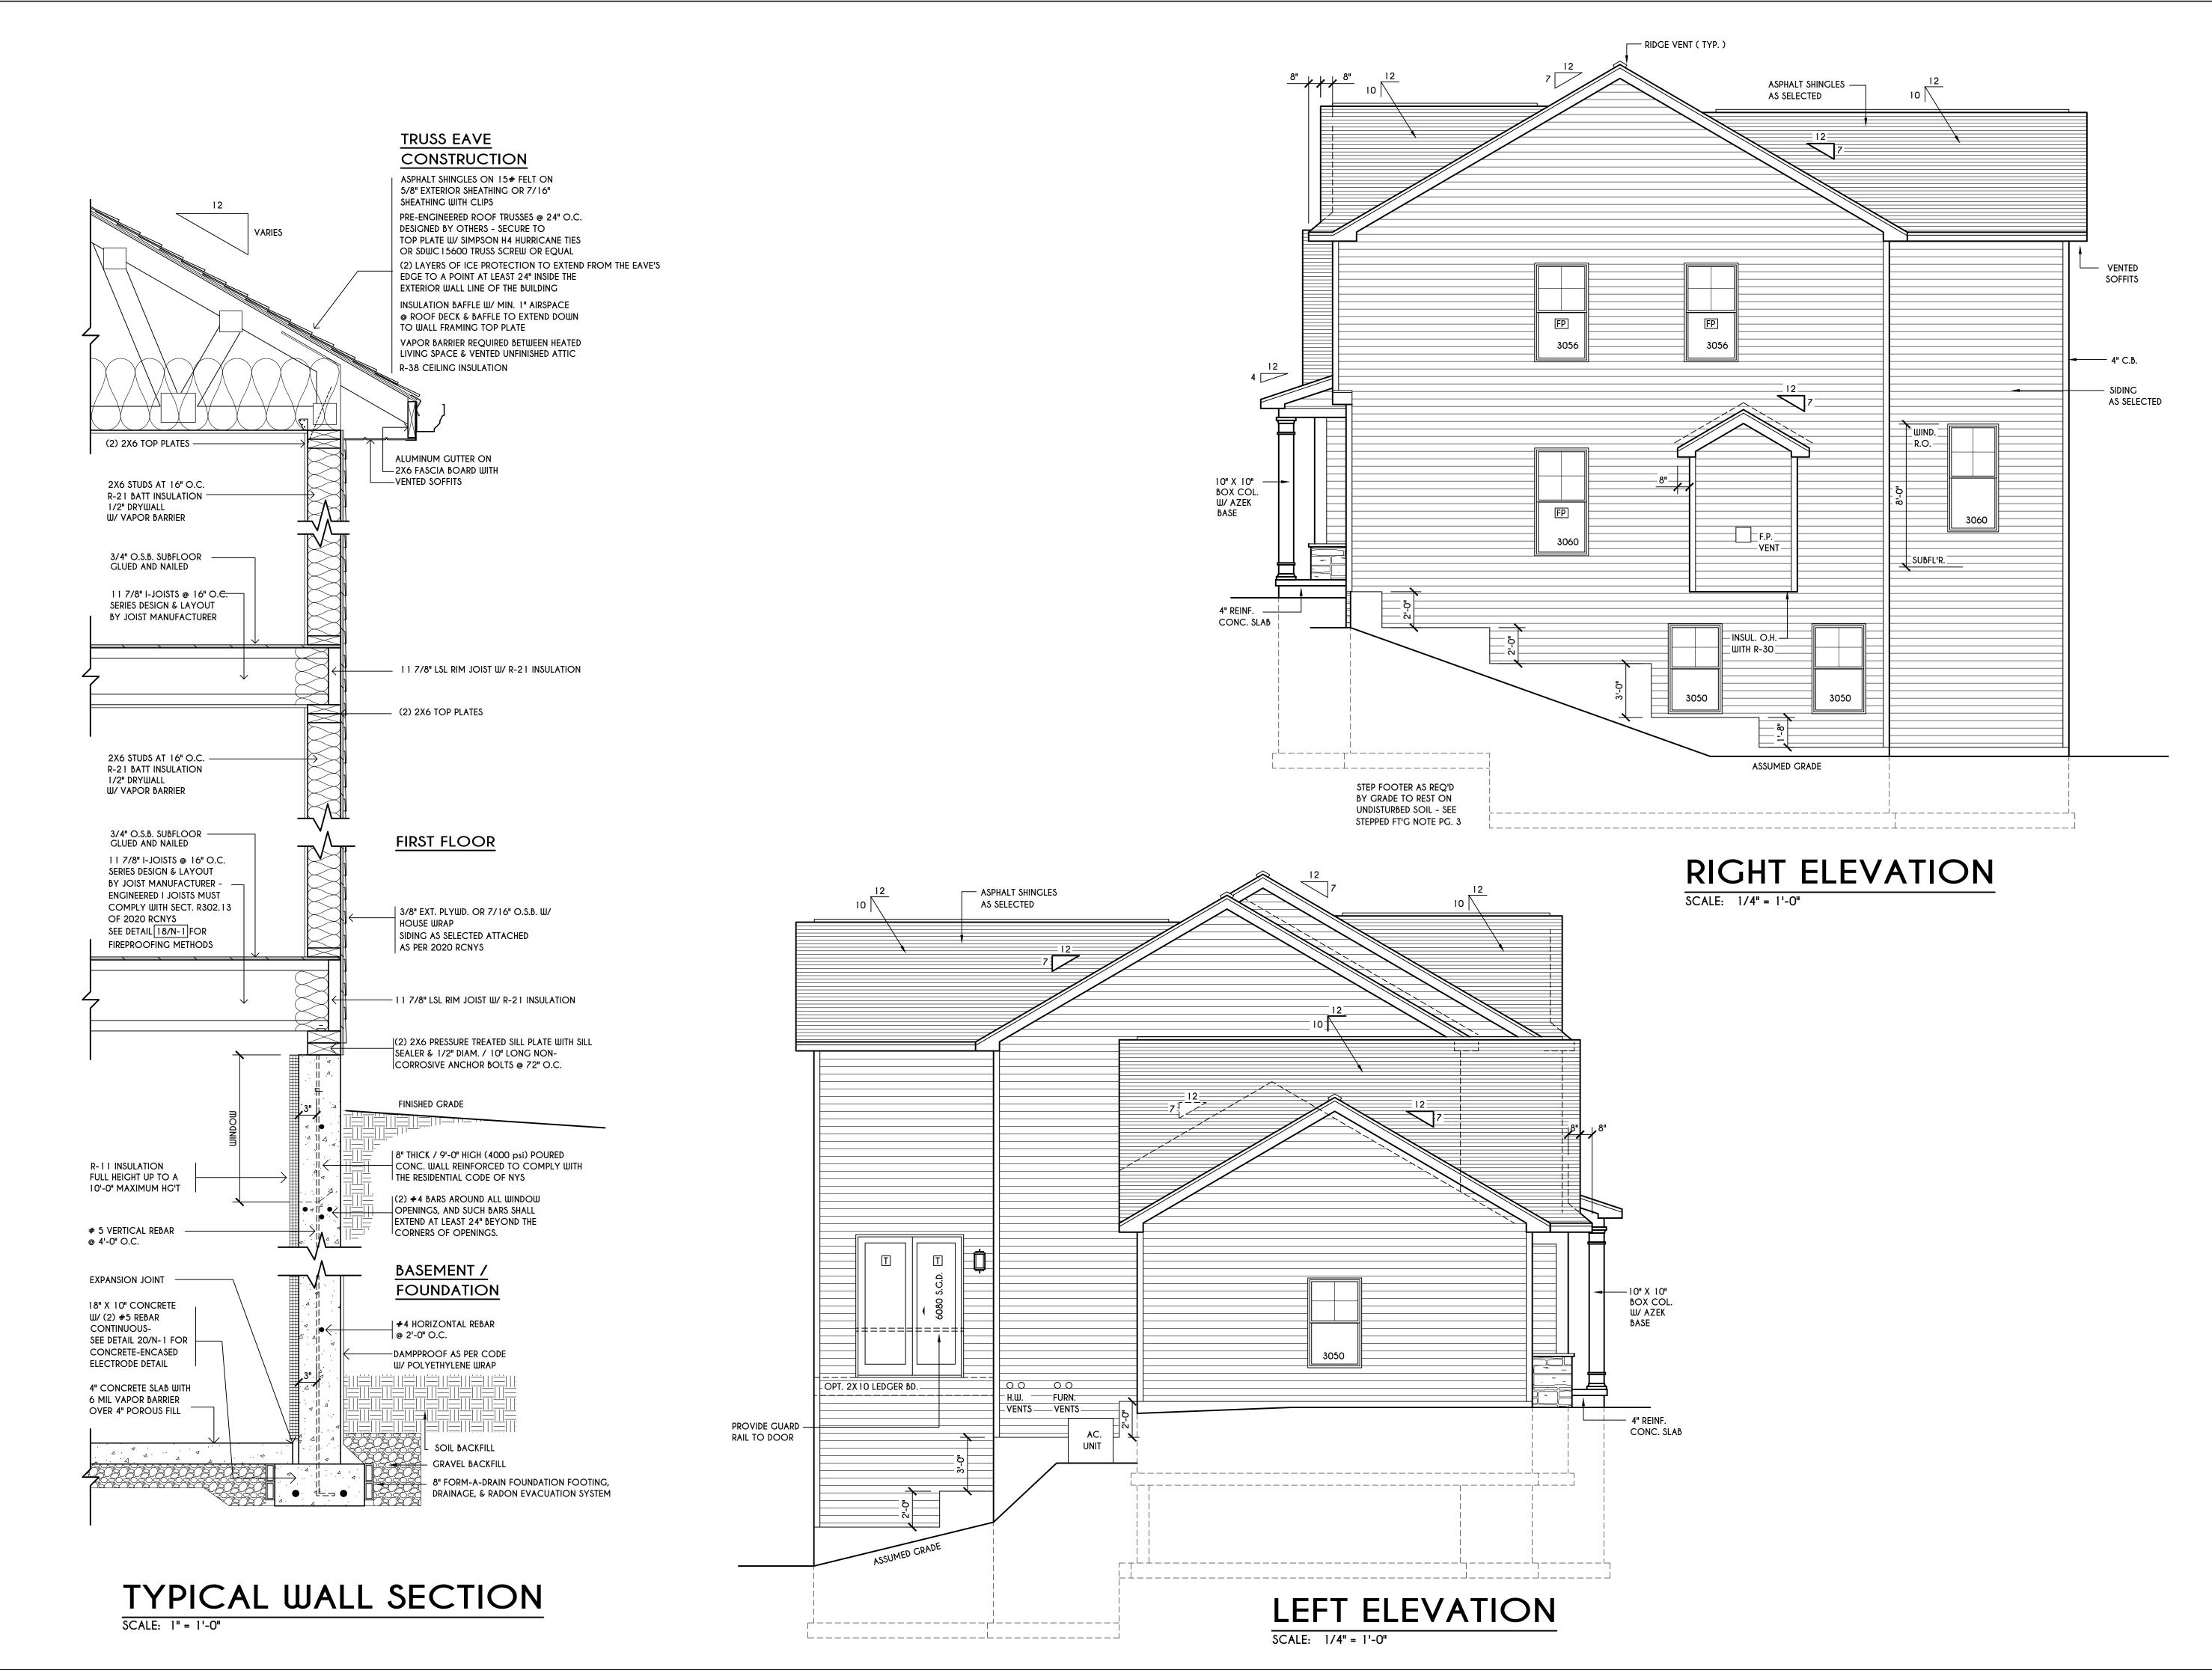
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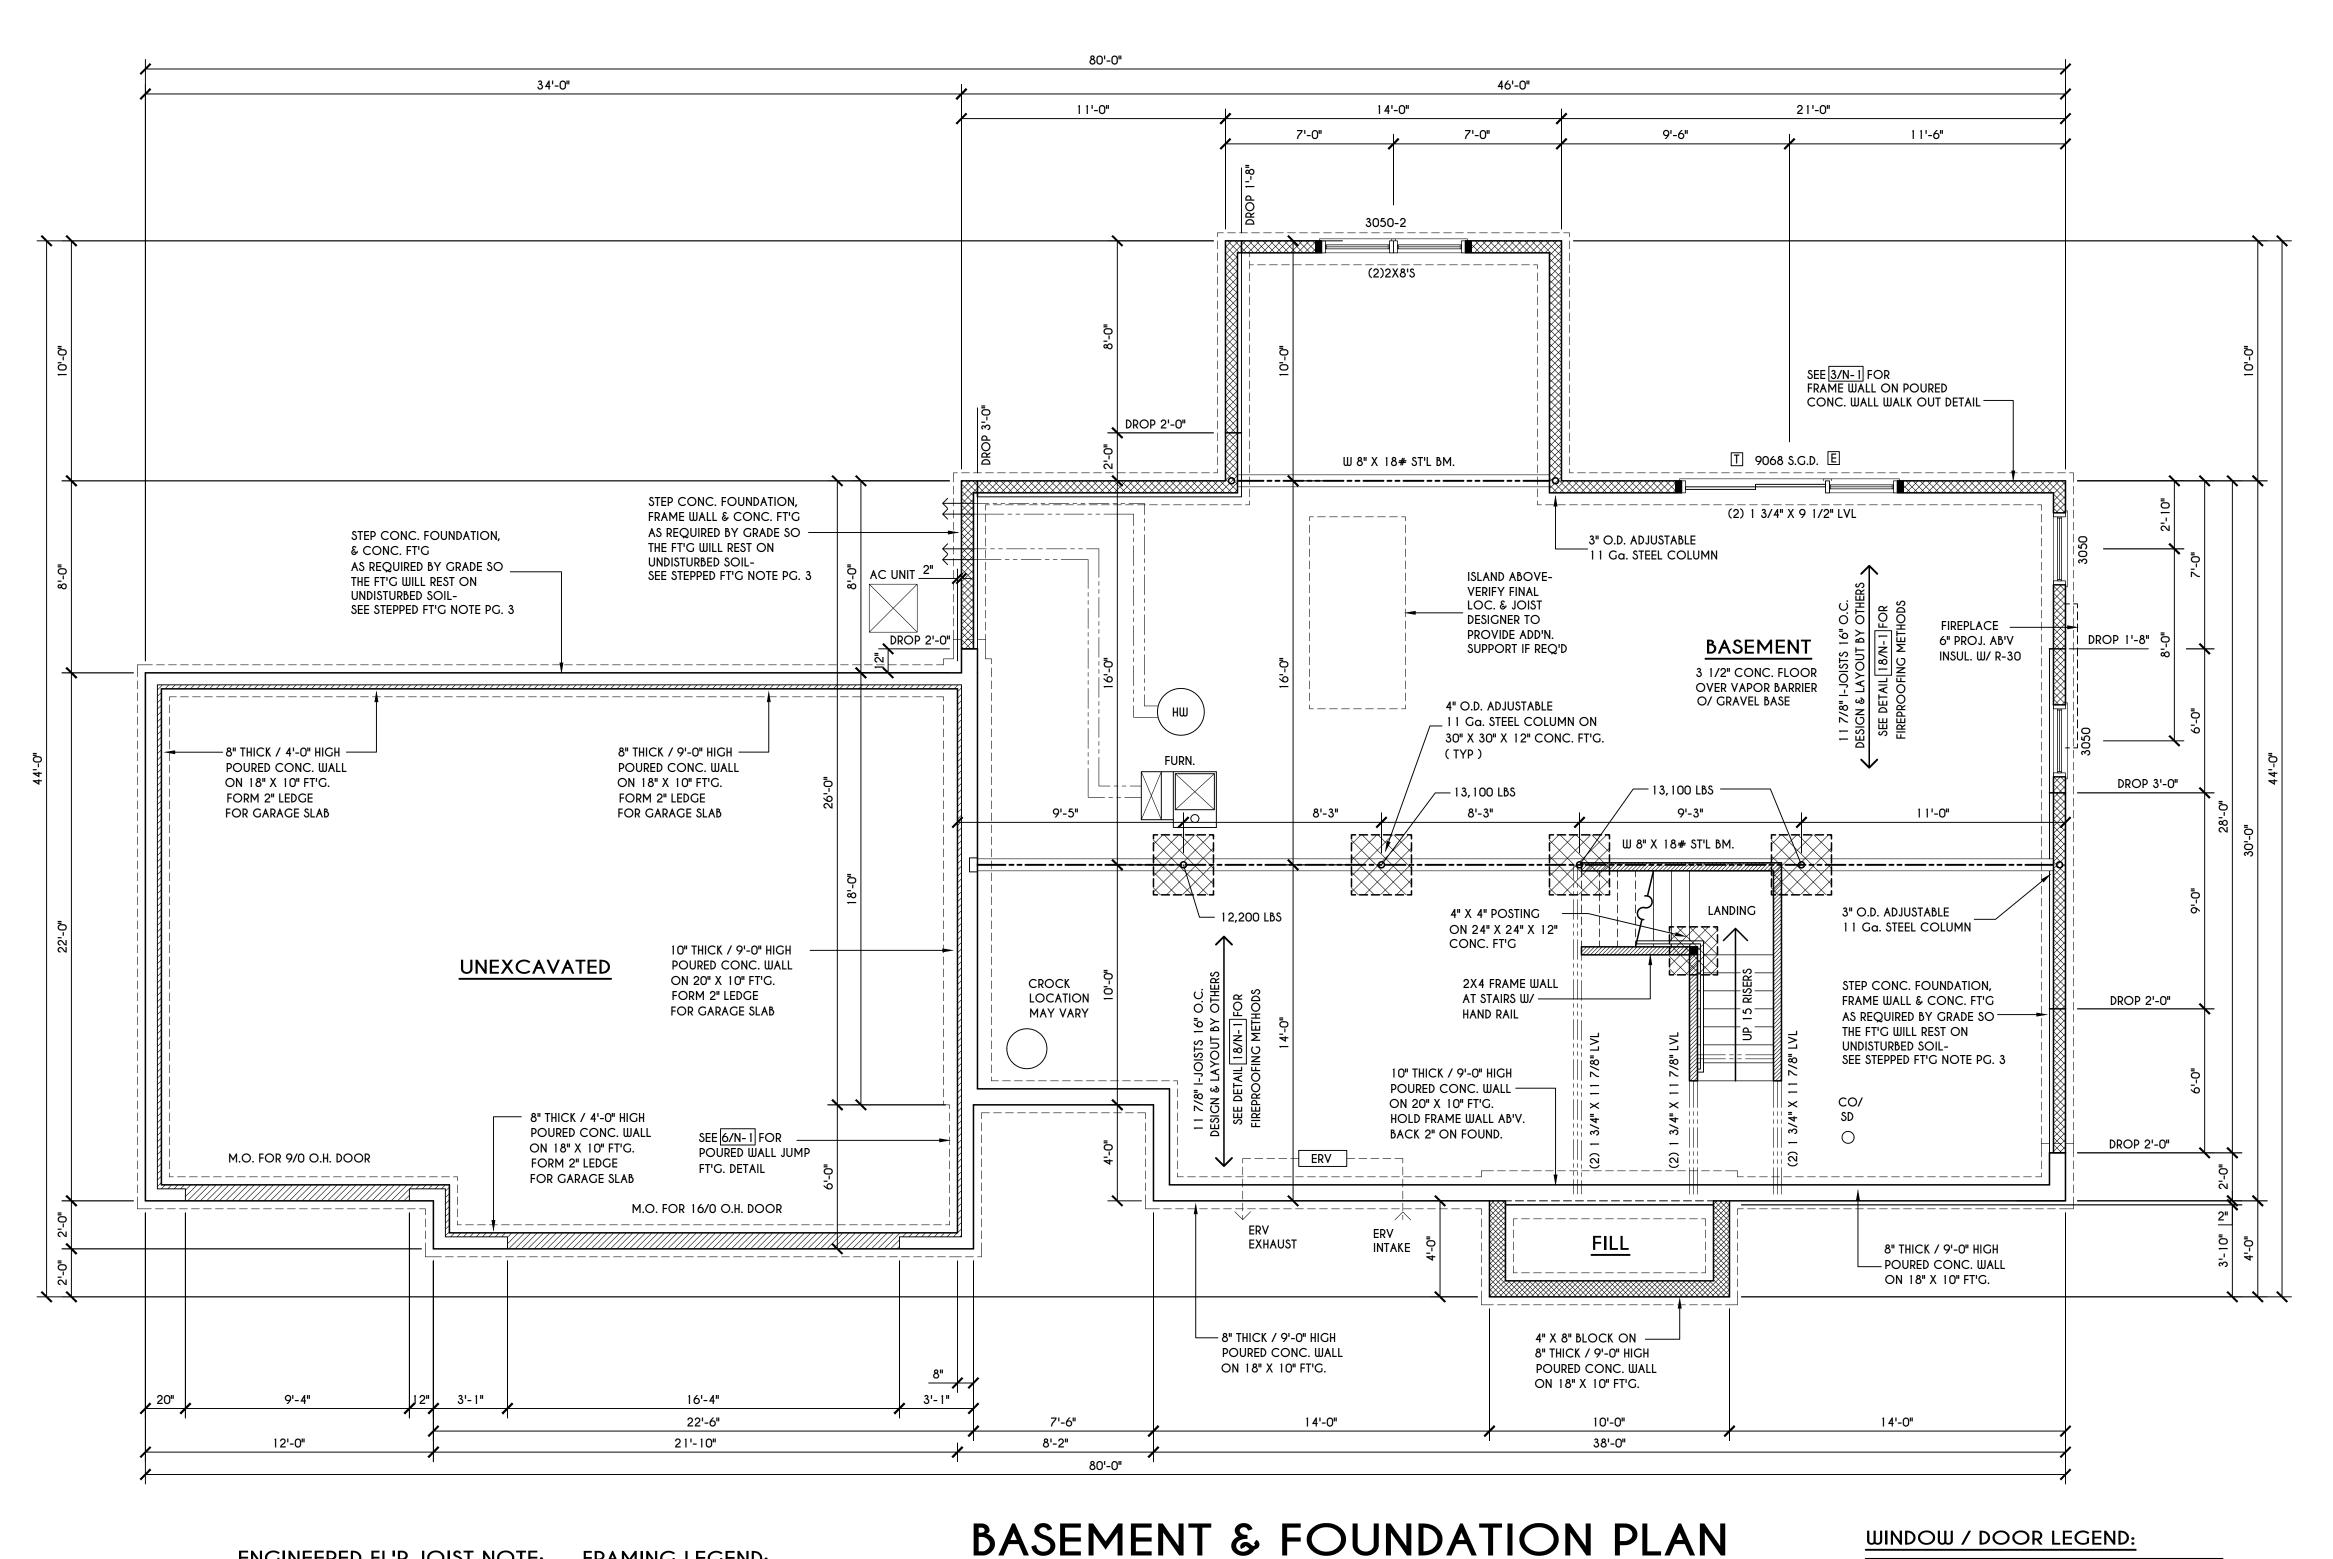
LOT 112 COVENTRY RIDGE PITTSFORD, NY

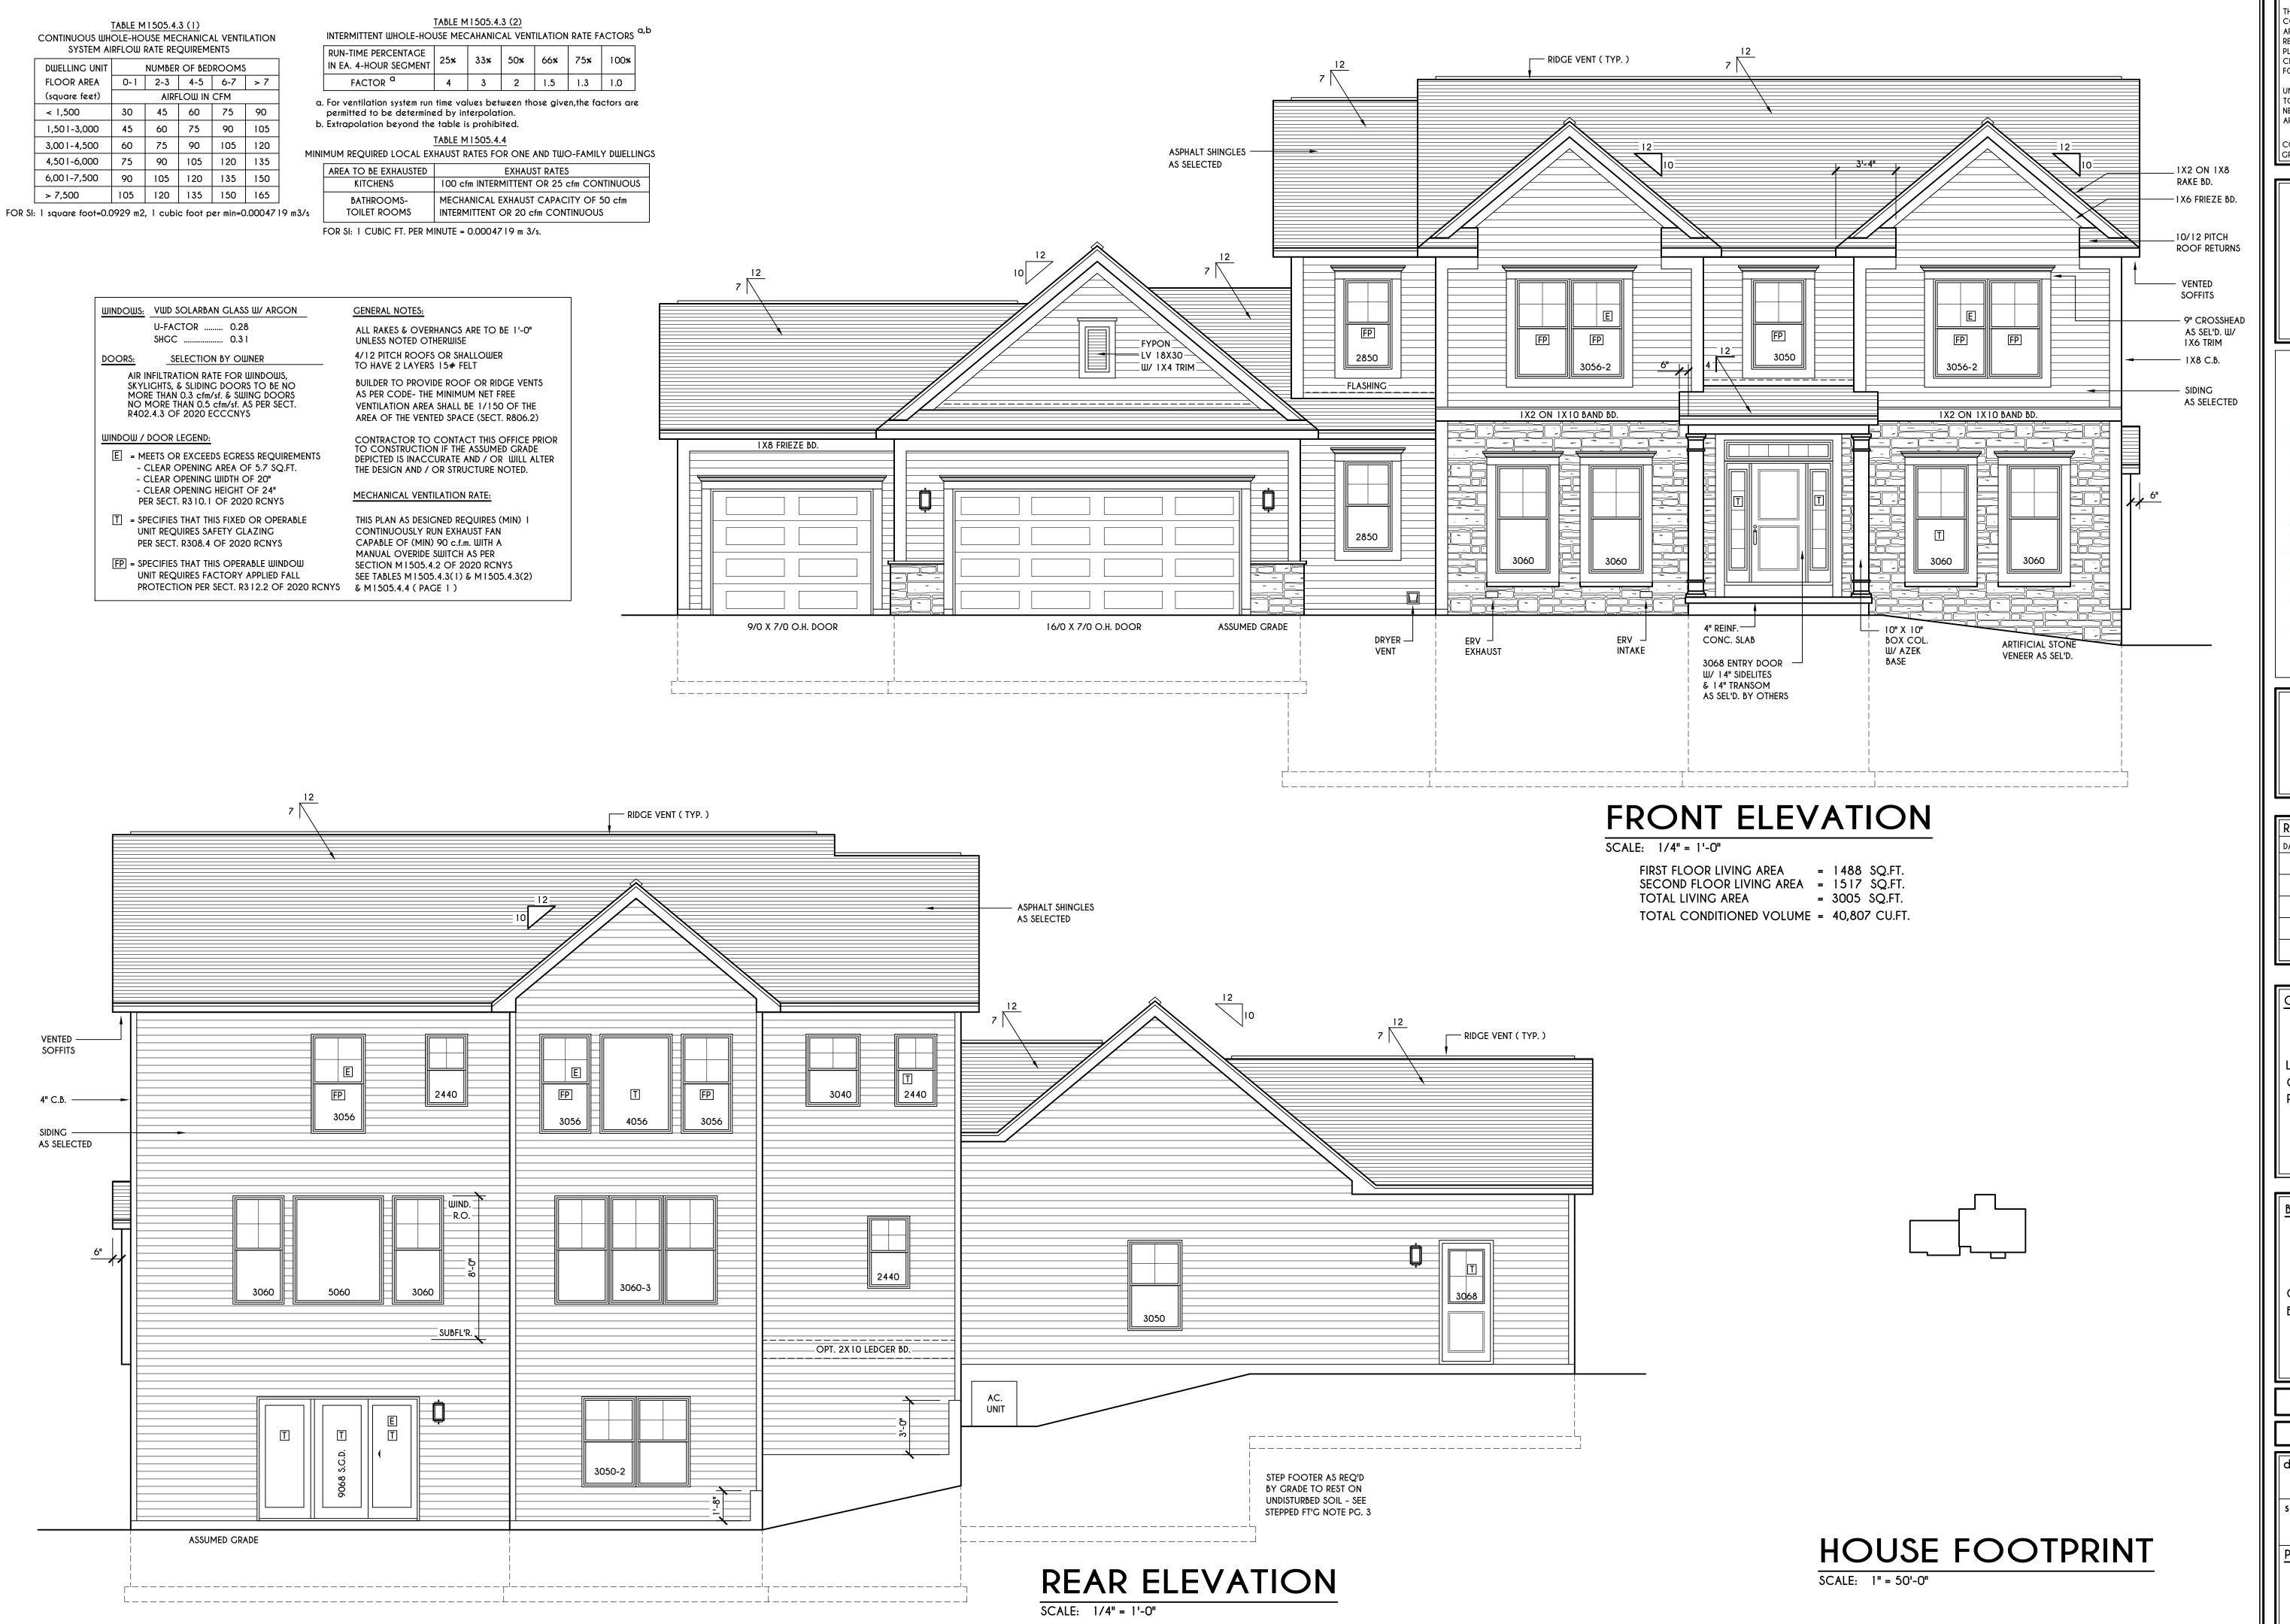BUILDER:

COVENTRY RIDGE BUILDING CORP.

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STEPPED FOOTING NOTE:

R403.1.5 OF RCNYS SLOPE:

THE TOP SURFACE OF THE FOOTINGS SHALL BE LEVEL. THE BOTTOM SURFACE OF FOOTINGS SHALL NOT HAVE A SLOPE EXCEEDING ONE UNIT VERTICAL IN 10 UNITS HORIZONTAL (10% SLOPE). FOOTINGS SHALL BE STEPPED WHERE IT IS NECESSARY TO CHANGE THE ELEVATION OF THE TOP SURFACE OF THE FOOTINGS OR WHERE THE SLOPE OF THE BOTTOM SURFACE OF THE FOOTINGS WILL EXCEED ONE UNIT VERTICAL IN 10 UNITS HORIZONTAL (10% SLOPE).

ENGINEERED FL'R JOIST NOTE:

ALL ENGINEERED FLOOR JOISTS TO BE DESIGNED BY & LAYOUT TO BE DONE BY MANUFACTURER TO THE SPECS BELOW: ALL <u>LIVING AREA</u> JOISTS TO BE DESIGNED FOR 55 P.S.F. TOTAL LOAD ALL SLEEPING AREA JOISTS TO BE

DESIGNED FOR 45 P.S.F. TOTAL LOAD

ENGINEERED I JOISTS MUST COMPLY WITH SECT. R302.13 OF 2020 RCNYS SEE DETAIL 18/N-1 FOR FIREPROOFING METHODS

FRAMING LEGEND:

- PROVIDE SOLID POSTING- GLUED & NAILED, EQUAL TO THE # OF HEADERS TO BE SUPPORTED- UNLESS NOTED OTHERWISE ____ - DROPPED HEADER

=== - FLUSH HEADER - 2X4 STUDS @ 16" O.C.

- 2X6 STUDS @ 16" O.C.

NOTES: CONTRACTOR TO CONTACT THIS OFFICE PRIOR TO CONSTRUCTION IF THE ASSUMED GRADE DEPICTED

IS INACCURATE AND / OR WILL ALTER THE FOUNDATION DESIGN AND /OR STRUCTURE NOTED

ALL WINDOW R.O. HGT'S TO BE 6'-10 1/2" U.N.O.

WHERE EMERGENCY ESCAPE & RESCUE OPENINGS ARE PROVIDED THEY SHALL HAVE A SILL HEIGHT OF NOT MORE THAN 44" ABOVE FLOOR. THE MIN. HORIZONTAL AREA OF THE WINDOW WELL SHALL BE 9 SQ. FT. WITH A MINIMUM HORIZONTAL PROJECTION & WIDTH OF 36"

PROVIDE SOLID BLOCKING UNDER ALL BEARING POINTS DOWN TO FOUNDATION WALL AND / OR BEAMS PROVIDE DB'L JACK STUDS EA. SIDE OF LOAD BEARING OPENINGS > / = 4'-0"

ALL ANGLES TO BE 45 DEG. U.N.O. ALL EXTERIOR WINDOW & DOOR HEADERS TO HAVE MIN. R-5 INSUL. & TO BE MIN. (2)2X8'S

ALL APPLIANCES SHOWN TO BE BY OWNER OR AS PER CONTRACT BY BUILDER

SMOKE (SD) & HEAT DETECTOR (HD), SHALL BE INSTALLED AS PER SECT. R314 OF 2020 RCNYS CARBON MONOXIDE ALARMS SHALL BE INSTALLED AS PER SECT. 915.33 FCNYS & BE WITHIN 10' OF ALL SLEEPING AREAS REINFORCE FOUNDATION WALLS AS PER 2020 RCNYS. SEE PG. N-2 FOR REINFORCING CHARTS

SEE CONCRETE-ENCASED ELECTRODE DETAIL 19/N-1

WINDOW / DOOR LEGEND:

E = MEETS OR EXCEEDS EGRESS REQUIREMENTS - CLEAR OPENING AREA OF 5.7 SQ.FT.

- CLEAR OPENING WIDTH OF 20" - CLEAR OPENING HEIGHT OF 24" PER SECT. R310.2.1 OF 2020 RCNYS

T = SPECIFIES THAT THIS FIXED OR OPERABLE UNIT REQUIRES SAFETY GLAZING PER SECT. R308.4 OF 2020 RCNYS

FP = SPECIFIES THAT THIS OPERABLE WINDOW UNIT REQUIRES FACTORY APPLIED FALL PROTECTION PER SECT. R312.2 OF 2020 RCNYS

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DATE	BY	DESCRIPTION

CLIENT/LOCATION:

LOT 112 COVENTRY RIDGE PITTSFORD, NY


BUILDER:

COVENTRY RIDGE BUILDING CORP.

FOUNDATION PLAN

GLA PLAN 3005

drawn:	checked:
CSB	CDK
scale:	date:
AS NOTED	11/21
PROJECT:	sheet:
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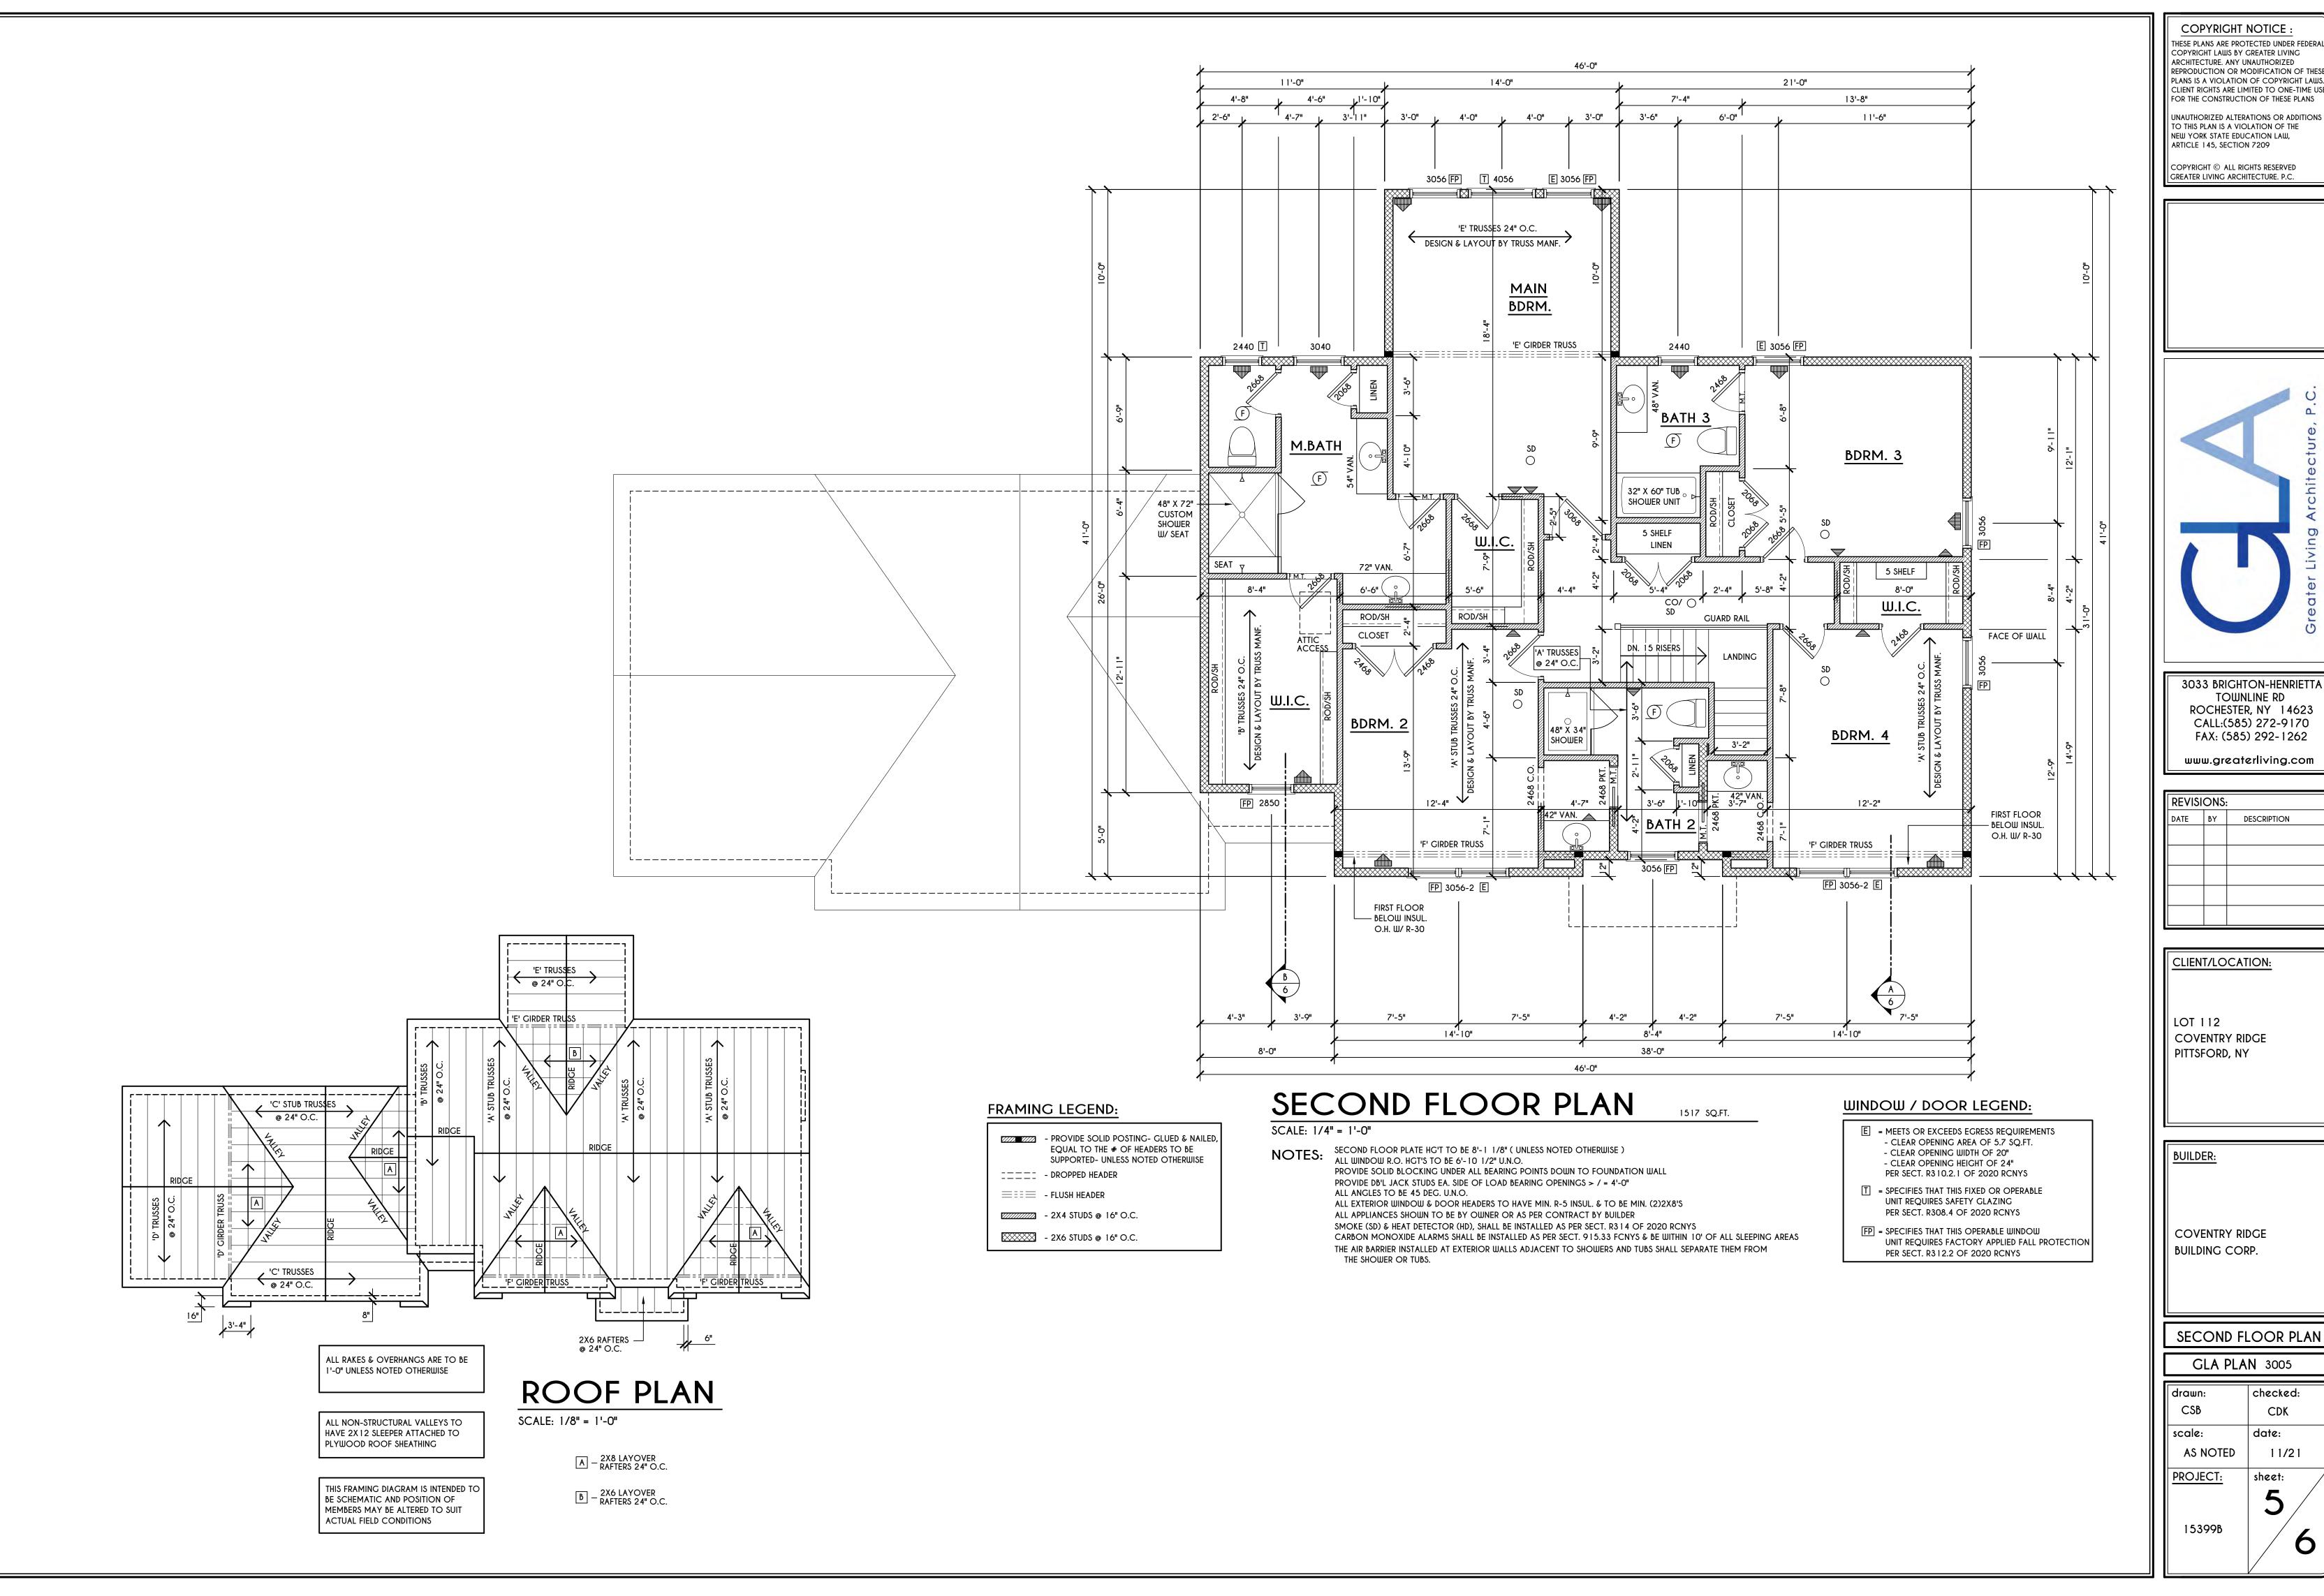
BUILDER:
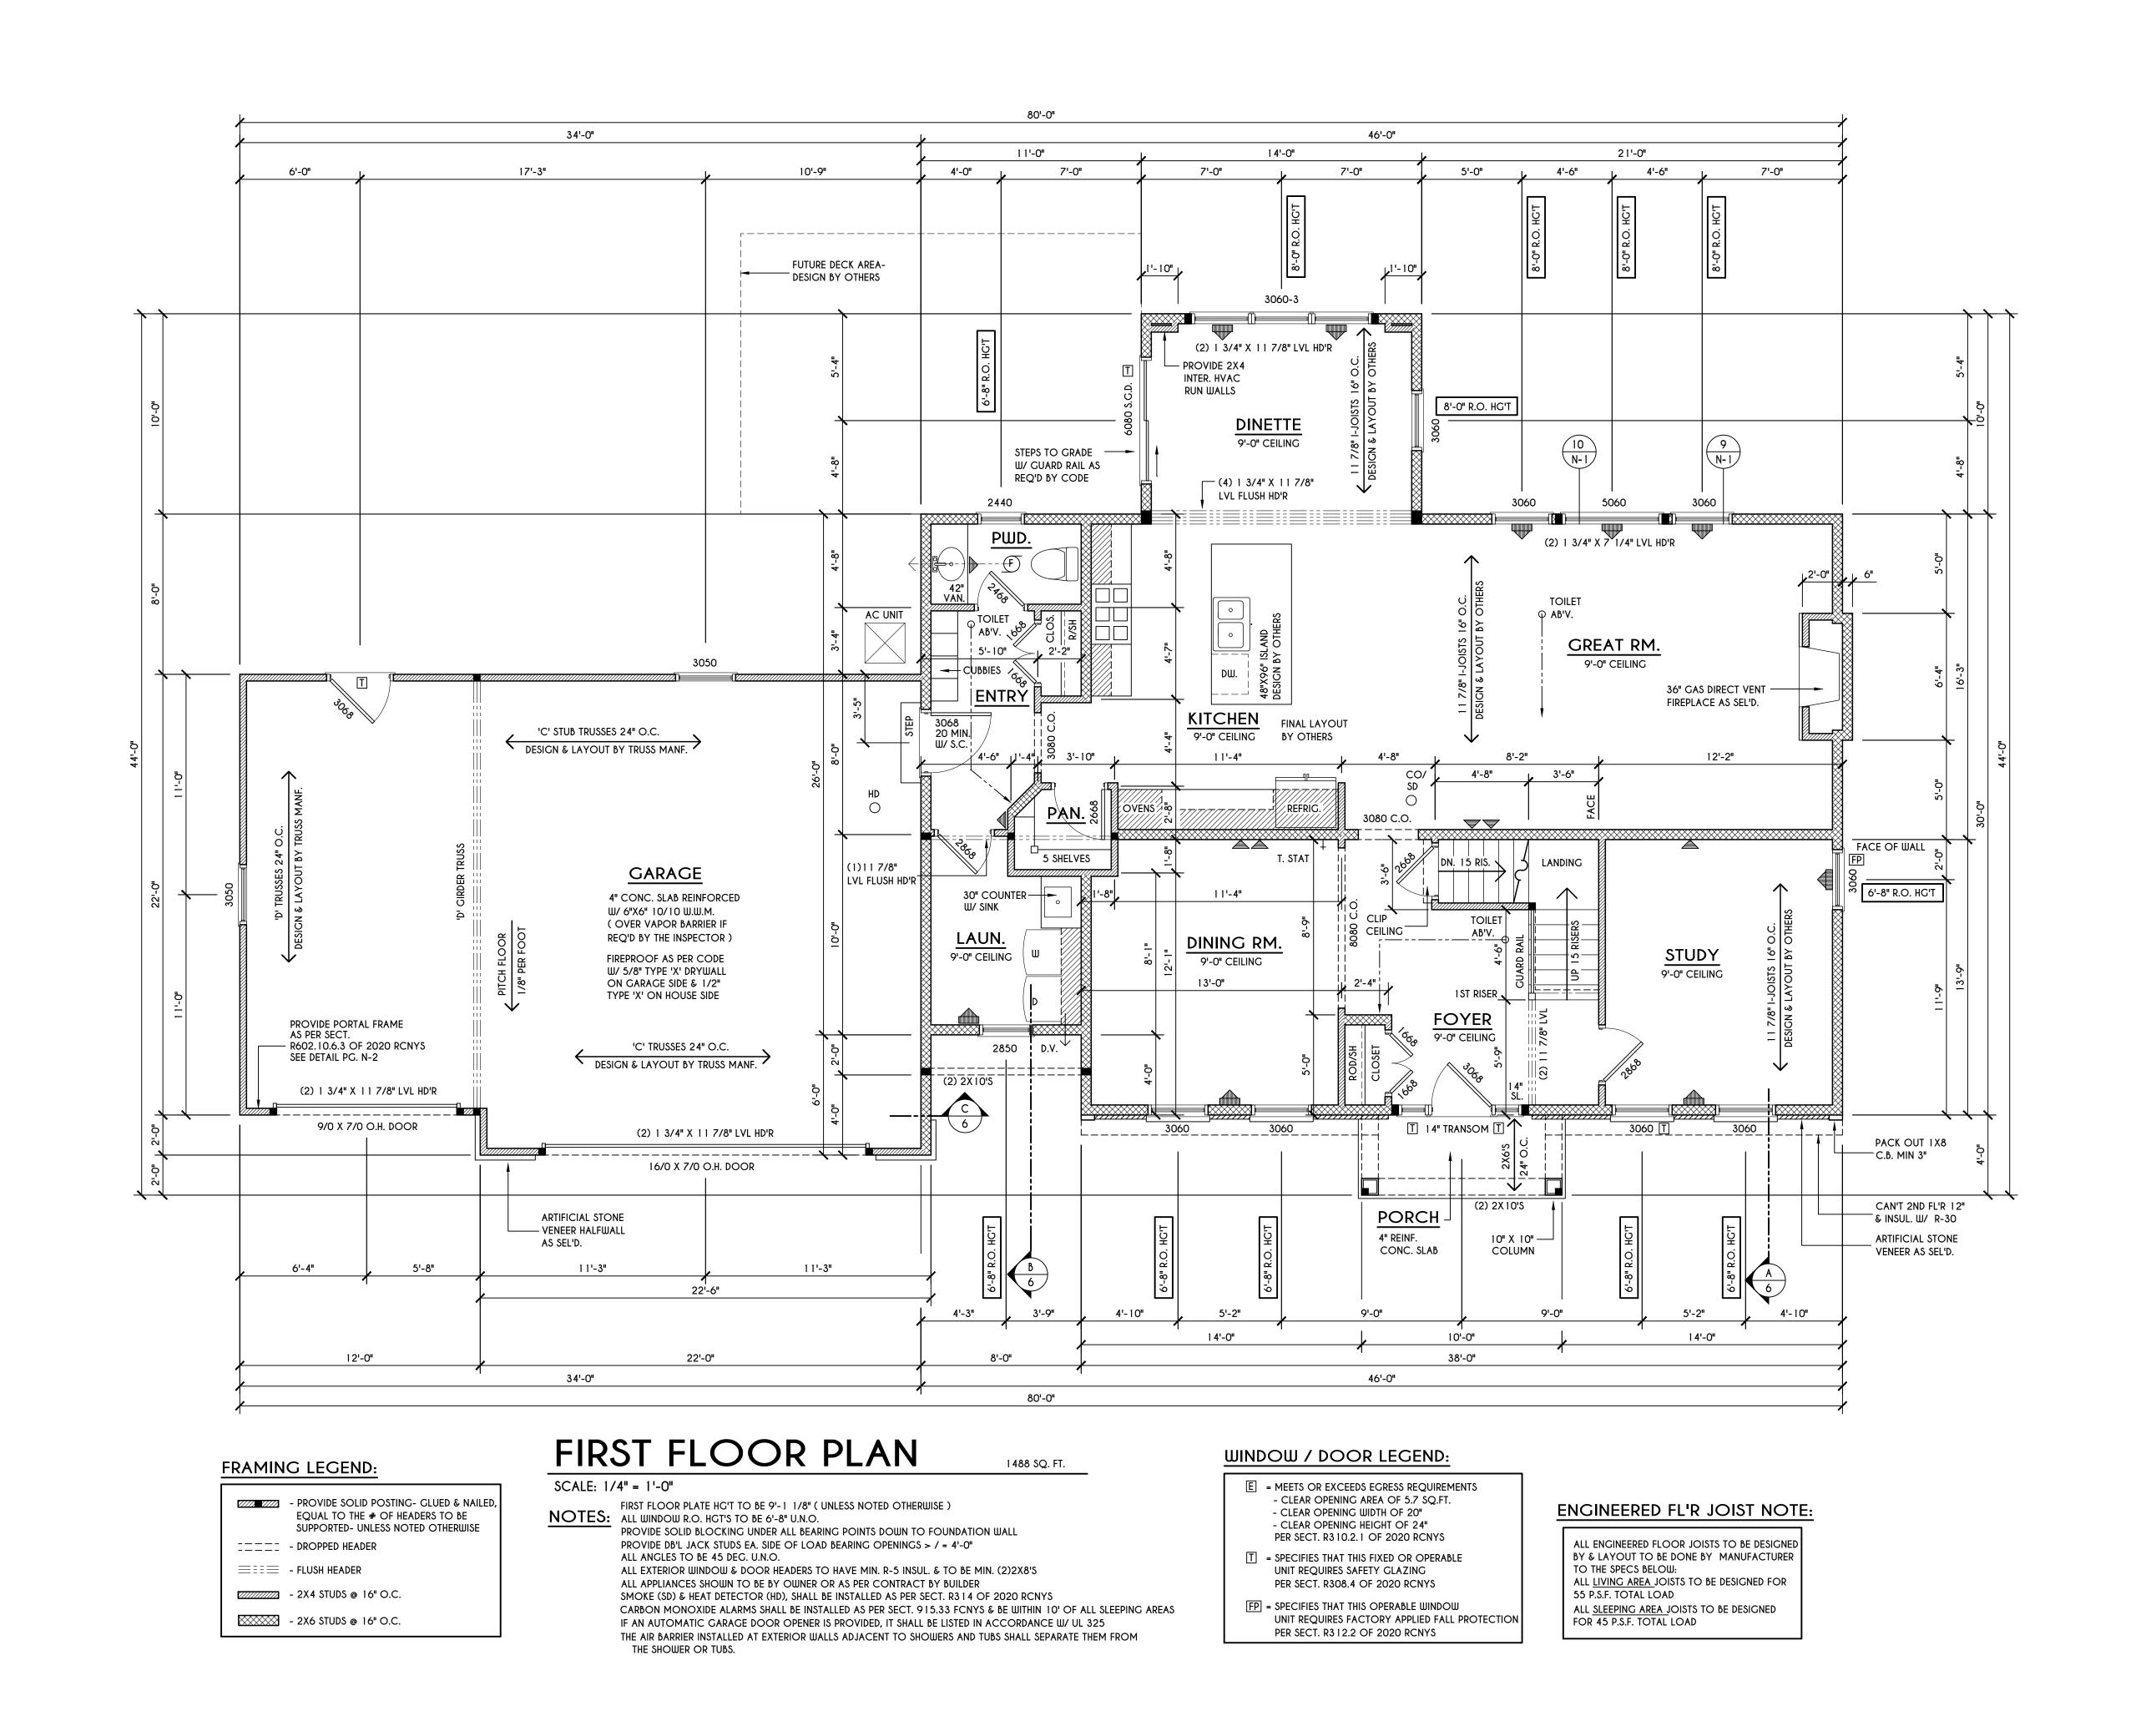
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FIRST FLOOR PLAN

GLA PLAN 3005

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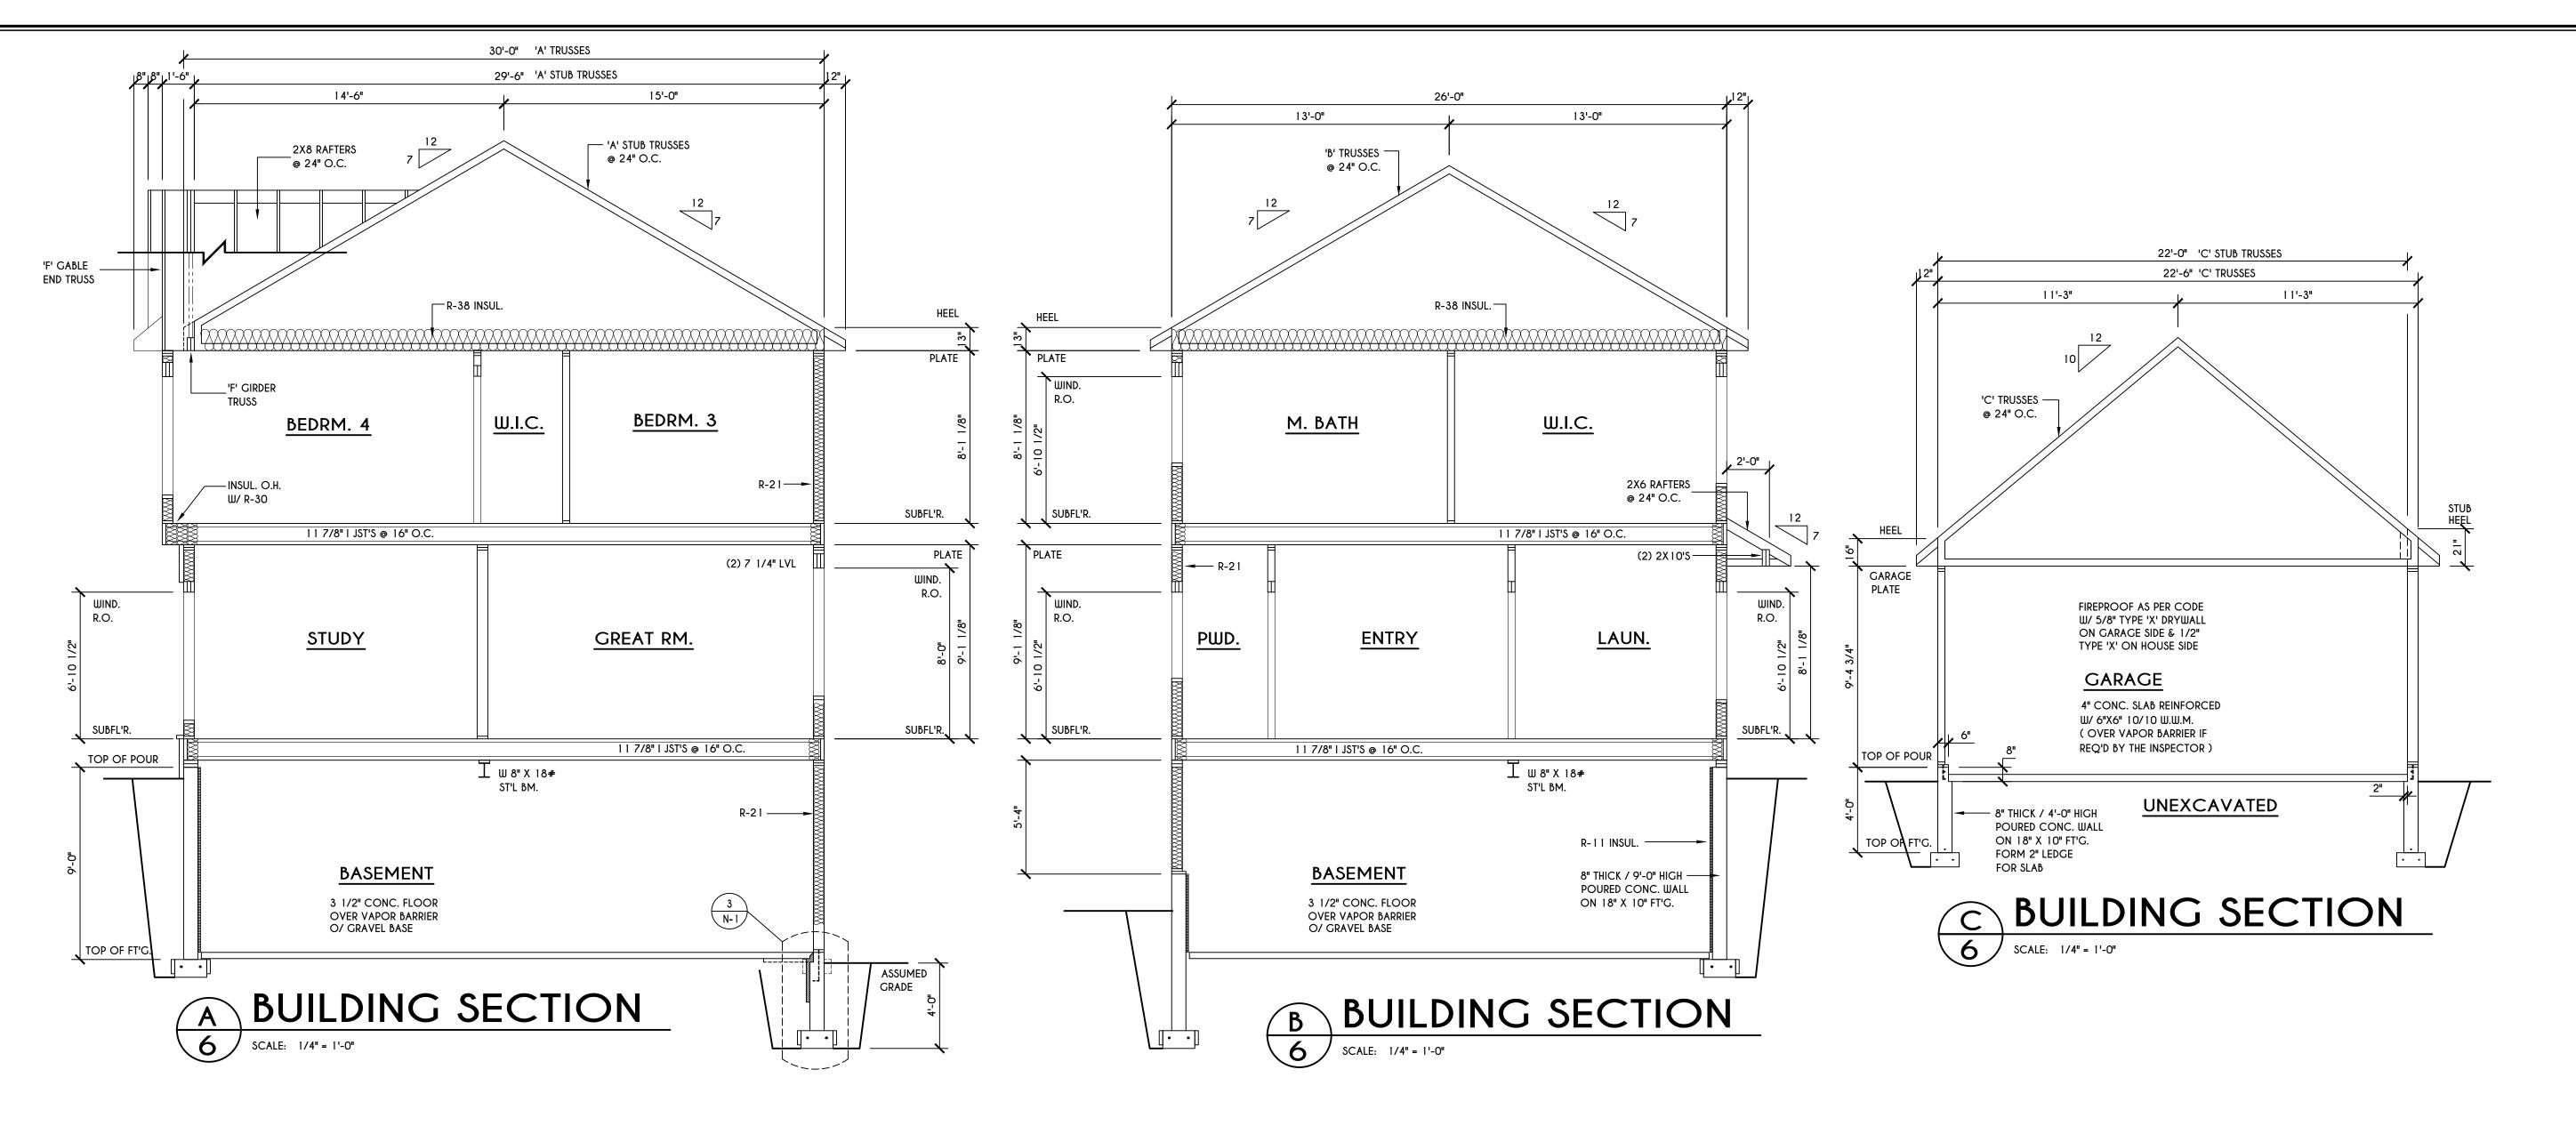
COVENTRY RIDGE


COVENTRY RIDGE

SECOND FLOOR PLAN


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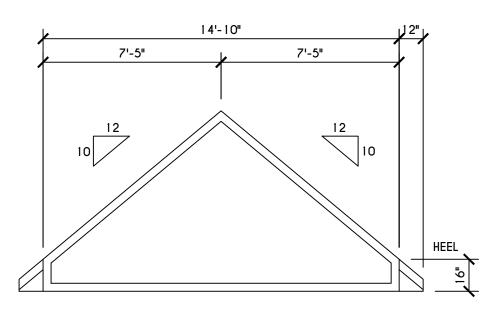


SCALE: 1/4" = 1'-0"

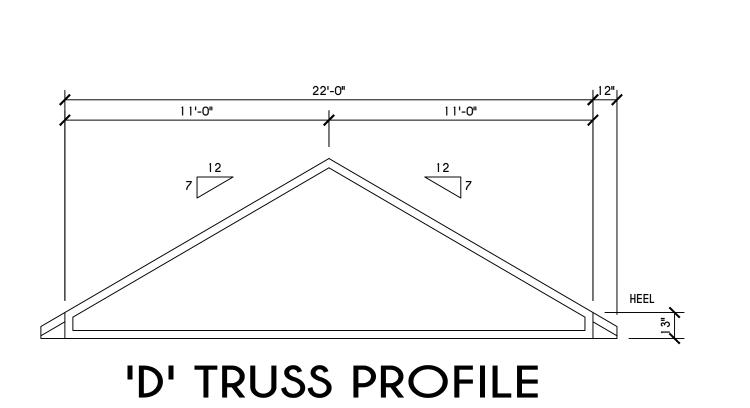


'E' TRUSS PROFILE

SCALE: 1/4" = 1'-0"

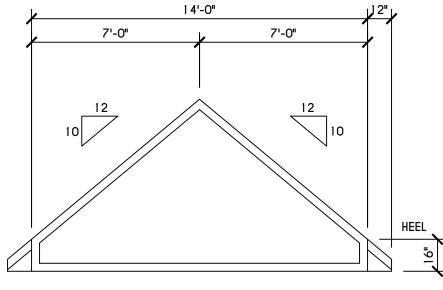

'F' TRUSS PROFILE

SCALE: 1/4" = 1'-0"

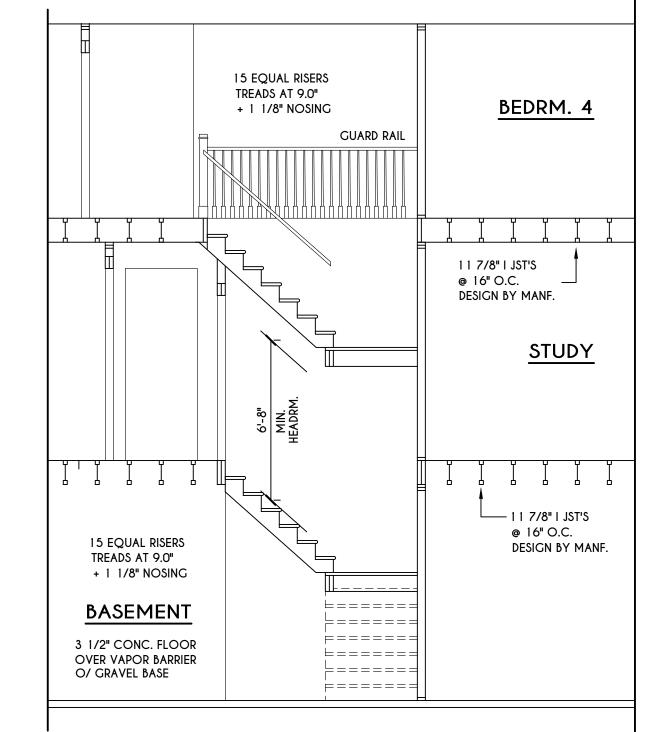

TRUSS NOTES:

TRUSS PROFILE SHOWN FOR REFERENCE ONLY - MANUFACTURER IS RESPONISBLE FOR CHORD LAYOUT AS REQ'D FOR DESIGN LOAD

TRUSS MANUFACTURER TO VERIFY ACTUAL LOAD AT GIRDER-TO-GIRDER

CONNECTIONS & TO SPECIFY A MIN. METAL HANGER TO SUPP. THAT LOAD

PROVIDE TRUSS BRACING AS INDICATED BY TRUSS DESIGNER

STAIR SECTION

SCALE: 1/4" = 1'-0"

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BUILDER:

COVENTRY RIDGE
BUILDING CORP.


SECTIONS

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DETAILS

GLA PLAN 3005

checked: CDK date: **AS NOTED** 11/21 sheet: 15399В

TABLE R404.1.1(2)

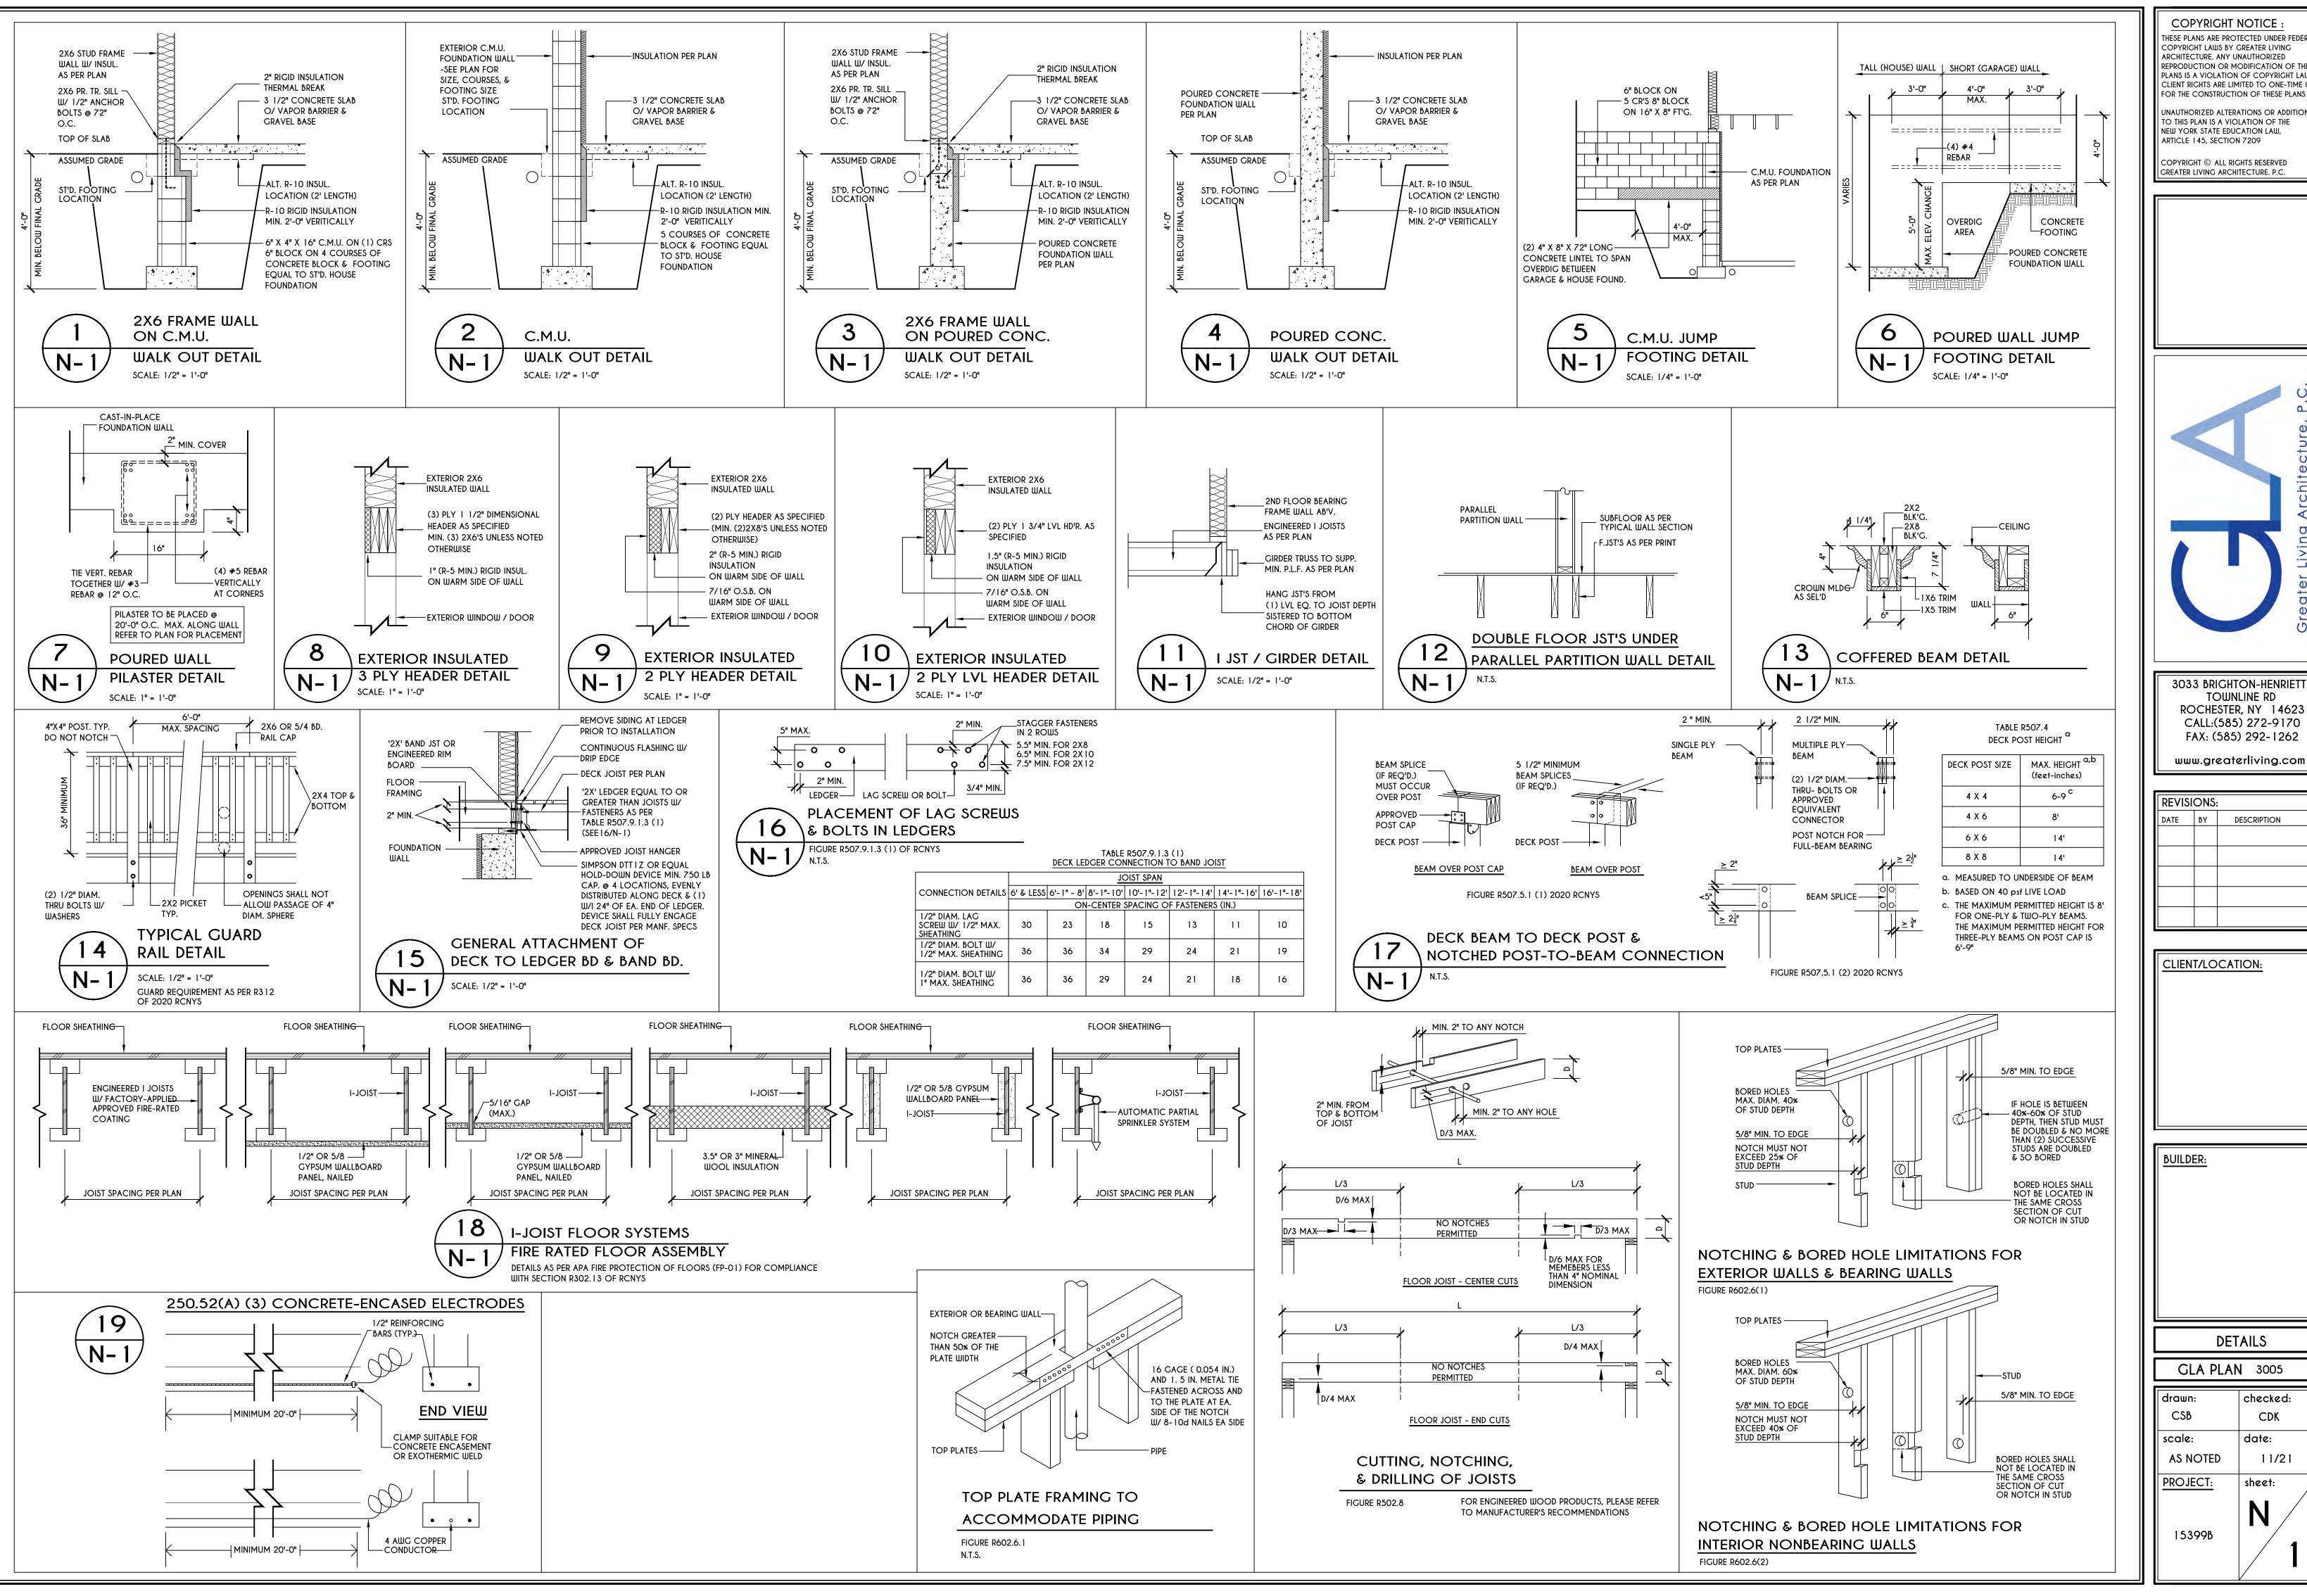8-INCH MASONRY FOUNDATION WALLS WITH REINFORCING WHERE d > 5 INCHES $^{\alpha, c, f}$ MINIMUM VERTICAL REINFORCEMENT AND SPACING (INCHES) b, c SOIL CLASSES AND LATERAL SOIL LOAD d (psf PER FOOT BELOW GRADE CW, GP, SW, AND SP SOILS GM, GS, SM-SC AND ML SOILS SC, MH, ML-CL AND INORGANIC CL SOILS WALL HEIGHT BACKFILL® #4 @ 48" O.C. #4 @ 48" O.C. 4' (OR LESS) 6'-8" #4 @ 48" O.0 #4 @ 48" O.0 #4 @ 48" O. 6'-8" #4 @ 48" O.C #5 @ 48" O.0 #6 @ 48" O.C. 4' (OR LESS #4 @ 48" O.C. #4 @ 48" O.C. #4 @ 48" O.C. #4 @ 48" O.C #4 @ 48" O.C #4 @ 48" O.C. 7'-4" #5 @ 48" O.C #5 @ 48" O.C #5 @ 48" O.C #6 @ 40" O.C. 4' (OR LESS) #4 @ 48" O.C. 8'-0" #4 @ 48" O.C. #5 @ 48" O.C. #5 @ 48" O.C. #5 @ 48" O.C #6 @ 40" O.C. #6 @ 32" O.C. 4' (OR LESS #4 @ 48" O.C #4 @ 48" O.C #4 @ 48" O.C. #4 @ 48" O.C #4 @ 48" O.C #5 @ 48" O.C #4 @ 48" O.C #5 @ 48" O.C #6 @ 48" O.C #5 @ 48" O.C #6 @ 48" O.C #6 @ 40" O.C. 8'-8" 4' (OR LESS #4 @ 48" O.C #4 @ 48" O.C. #4 @ 48" O.C. #4 @ 48" O.C. #4 @ 48" O.C. #5 @ 48" O.C. #4 @ 48" O.C. #5 @ 48" O.C. #6 @ 48" O.C. 9'-4" #5 @ 48" O.C. #6 @ 48" O.C. #6 @ 40" O.C. #6 @ 48" O.C #6 @ 40" O.C #6 @ 24" O.C #6 @ 16" O.C. 4' (OR LESS #4 @ 48" O.C. #4 @ 48" O.C #4 @ 48" O.C. #5 @ 48" O.C. #4 @ 48" O. #5 @ 48" O.C #6 @ 48" O.0

a. MORTAR SHALL BE TYPE M OR S AND MASONRY SHALL BE LAID IN RUNNING BOND.

#5 @ 48" O.C

#6 @ 40" O.C.

#6 @ 48" O.C

#6 @ 32" O.

10'-0"

CONCRETE SLAB IS PERMITTED.

b. ALTERNATIVE REINFORCING BAR SIZES AND SPACING'S SHALL HAVE AN EQUIVALENT CROSS-SECTIONAL AREA OF REINFORCEMENT PER LINEAL FOOT OF WALL SHALL BE PERMITTED PROVIDED THE SPACING OF THE REINFORCEMENT DOES NOT EXCEED 72" IN SEISMIC DESIGN CATEGORIES A, B AND C, AND 48 INCHES IN SEISMIC DESIGN CATEGORIES DO, D I AND D2.

c. VERTICAL REINFORCEMENT SHALL BE GRADE 60 MINIMUM. THE DISTANCE FROM THE FACE OF THE SOIL SIDE OF THE WALL TO THE

#6 @ 48" O.C

#6 @ 32" O.C

#6 @ 24" O.C

#6 @ 16" O.C

#6 @ 32" O.C.

#6 @ 24" O.C.

#6 @ 16" O.C.

#6 @ 16" O.C

CENTER OF VERTICAL REINFORCEMENT SHALL BE NOT LESS THAN 5 INCHES.

d. SOIL CLASSES ARE IN ACCORDANCE WITH THE UNIFIED SOIL CLASSIFICATION SYSTEM AND DESIGN LATERAL SOIL LOADS ARE FOR

MOIST CONDITIONS WITHOUT HYDROSTATIC PRESSURE. REFER TO TABLE R405.1.

e. UNBALANCED BACKFILL HEIGHT IS THE DIFFERENCE IN HEIGHT BETWEEN THE EXTERIOR FINISH GROUND LEVEL AND THE LOWER OF THE TOP OF THE CONCRETE FOOTING THAT SUPPORTS THE FOUNDATION WALL OR THE INTERIOR FINISH GROUND LEVEL. WHERE AN INTERIOR CONCRETE SLAB-ON-GRADE IS PROVIDED AND IS IN CONTACT WITH THE INTERIOR SURFACE OF THE FOUNDATION WALL, MEASUREMENT OF THE UNBALANCED BACKFILL HEIGHT FROM THE EXTERIOR FINISH GROUND LEVEL TO THE TOP OF THE INTERIOR

f. THE USE OF THIS TABLE SHALL BE PROHIBITED FOR SOIL CLASSIFICATIONS NOT SHOWN.

TABLE R404.1.1(3)

	10-INC	H MASONRY FOUNDATION W.	ALLS WITH REINFORCING WHERE	d > 6.75 INCHES ^{a, c} , f
			1 VERTICAL REINFORCEMENT AND	
			S AND LATERAL SOIL LOAD d (
WALL HEIGHT	HEIGHT OF UNBALANCED BACKFILL [©]	GW, GP, SW, AND SP SOILS 30	GM, GS, SM-SC AND ML SOILS 45	SC, MH, ML-CL AND INORGANIC CL SOILS 60
6'-8"	4' (OR LESS) 5' 6'-8"	#4 @ 56" O.C. #4 @ 56" O.C. #4 @ 56" O.C.	#4 @ 56" O.C. #4 @ 56" O.C. #5 @ 56" O.C.	#4 @ 56" O.C. #4 @ 56" O.C. #5 @ 56" O.C.
7'-4"	4' (OR LESS) 5' 6' 7'-4"	#4 @ 56" O.C. #4 @ 56" O.C. #4 @ 56" O.C. #4 @ 56" O.C.	#4 @ 56" O.C. #4 @ 56" O.C. #4 @ 56" O.C. #5 @ 56" O.C.	#4 @ 56" O.C. #4 @ 56" O.C. #5 @ 56" O.C. #6 @ 56" O.C.
8'-0"	4' (OR LESS) 5' 6' 7' 8'	#4 @ 56" O.C. #4 @ 56" O.C. #4 @ 56" O.C. #4 @ 56" O.C. #5 @ 56" O.C.	#4 @ 56" O.C. #4 @ 56" O.C. #4 @ 56" O.C. #5 @ 56" O.C. #6 @ 56" O.C.	#4 @ 56" O.C. #4 @ 56" O.C. #5 @ 56" O.C. #6 @ 56" O.C. #6 @ 48" O.C.
8'-8"	4' (OR LESS) 5' 6' 7' 8'-8"	#4 @ 56" O.C. #4 @ 56" O.C. #4 @ 56" O.C. #4 @ 56" O.C. #5 @ 56" O.C.	#4 @ 56" O.C. #4 @ 56" O.C. #4 @ 56" O.C. #5 @ 56" O.C. #6 @ 56" O.C.	#4 @ 56" O.C. #4 @ 56" O.C. #5 @ 56" O.C. #6 @ 56" O.C. #6 @ 32" O.C.
9'-4"	4' (OR LESS) 5' 6' 7' 8' 9'-4"	#4 @ 56" O.C. #4 @ 56" O.C. #4 @ 56" O.C. #4 @ 56" O.C. #5 @ 56" O.C. #6 @ 56" O.C.	#4 @ 56" O.C. #4 @ 56" O.C. #5 @ 56" O.C. #5 @ 56" O.C. #6 @ 56" O.C. #6 @ 40" O.C.	#4 @ 56" O.C. #4 @ 56" O.C. #5 @ 56" O.C. #6 @ 56" O.C. #6 @ 40" O.C. #6 @ 24" O.C.
10'-0"	4' (OR LESS) 5' 6' 7' 8' 9'	#4 @ 56" O.C. #4 @ 56" O.C. #4 @ 56" O.C. #5 @ 56" O.C. #6 @ 56" O.C. #6 @ 48" O.C.	#4 @ 56" O.C. #4 @ 56" O.C. #5 @ 56" O.C. #6 @ 56" O.C. #6 @ 48" O.C. #6 @ 40" O.C. #6 @ 32" O.C.	#4 @ 56" O.C. #4 @ 56" O.C. #5 @ 56" O.C. #6 @ 48" O.C. #6 @ 40" O.C. #6 @ 24" O.C.
		!		

a. MORTAR SHALL BE TYPE M OR S AND MASONRY SHALL BE LAID IN RUNNING BOND.

b. ALTERNATIVE REINFORCING BAR SIZES AND SPACINGS SHALL HAVE AN EQUIVALENT CROSS-SECTIONAL AREA OF REINFORCEMENT PER LINEAL FOOT OF WALL SHALL BE PERMITTED PROVIDED THE SPACING OF THE REINFORCEMENTDOES NOT EXCEED 72" IN SEISMIC DESIGN CATEGORIES A, B AND C, AND 48 INCHES IN SEISMIC DESIGN CATEGORIES DD, D1 AND D2.

c. VERTICAL REINFORCEMENT SHALL BE GRADE 60 MINIMUM. THE DISTANCE FROM THE FACE OF THE SOIL SIDE OF THE WALL TO THE CENTER OF VERTICAL REINFORCEMENT SHALL BE NOT LESS THAN 6.75 INCHES.

d. SOIL CLASSES ARE IN ACCORDANCE WITH THE UNIFIED SOIL CLASSIFICATION SYSTEM AND DESIGN LATERAL SOIL LOADS ARE FOR MOIST CONDITIONS WITHOUT HYDROSTATIC PRESSURE. REFER TO TABLE R405.1.

6. UNBALANCED BACKFILL HEIGHT IS THE DIFFERENCE IN HEIGHT BETWEEN THE EXTERIOR FINISH GROUND LEVEL AND THE LOWER OF THE TOP OF THE CONCRETE FOOTING THAT SUPPORTS THE FOUNDATION WALL OR THE INTERIOR FINISH GROUND LEVEL. WHERE AN INTERIOR CONCRETE SLAB-ON-GRADE IS PROVIDED AND IS IN CONTACT WITH THE INTERIOR SURFACE OF THE FOUNDATION WALL, MEASUREMENT OF THE UNBALANCED BACKFILL HEIGHT FROM THE EXTERIOR FINISH GROUND LEVEL TO THE TOP OF THE INTERIOR

f. THE USE OF THIS TABLE SHALL BE PROHIBITED FOR SOIL CLASSIFICATIONS NOT SHOWN.

TABLE R404.1.1(4)

12-INCH MASONRY FOUNDATION WALLS WITH REINFORCING WHERE d > 8.75 INCHES a, c, f

MINIMUM VERTICAL REINFORCEMENT AND SPACING (INCHES) b, c SOIL CLASSES AND LATERAL SOIL LOAD ^d (psf PER FOOT BELOW GRADE GW, GP, SW, AND SP SOILS GM, GS, SM-SC AND ML SOILS SC, MH, ML-CL AND INORGANIC CL SOILS WALL HEIGHT BACKFILL® #4 @ 72" O.C. 4' (OR LESS) #4 @ 72" O.C. 6'-8" #4 @ 72" O.C #4 @ 72" O.C #5 @ 72" O.C #4 @ 72" O.C. #4 @ 72" O.C. #4 @ 72" O.C. 4' (OR LESS) #4 @ 72" O.C. #5 @ 72" O.C. 7'-4" #4 @ 72" O.C. #6 @ 72" O.C. 4' (OR LESS) #4 @ 72" O.C. 8'-0" #4 @ 72" O.C. #5 @ 72" O.C. #6 @ 72" O.C. #6 @ 64" O.C. #4 @ 72" O.C. 4' (OR LESS) #4 @ 72" O.C. #4 @ 72" O.C 8'-8" #5 @ 72" O.C. #6 @ 72" O.C. 4' (OR LESS) #4 @ 72" O.C. #5 @ 72" O.C. #5 @ 72" O.C. 9'-4" #4 @ 72" O.C. #5 @ 72" O.C. #6 @ 72" O.C. #6 @ 72" O.C. #6 @ 56" O.C. 4' (OR LESS) #4 @ 72" O.C. #4 @ 72" O.C. #4 @ 72" O.C

a. MORTAR SHALL BE TYPE M OR S AND MASONRY SHALL BE LAID IN RUNNING BOND.
b. ALTERNATIVE REINFORCING BAR SIZES AND SPACINGS SHALL HAVE AN EQUIVALENT CROSS-SECTIONAL AREA OF REINFORCEMENT PER LINEAL FOOT OF WALL SHALL BE PERMITTED PROVIDED THE SPACING OF THE REINFORCEMENTDOES NOT EXCEED 72" IN SEISMIC DESIGN CATEGORIES A, B AND C, AND 48 INCHES IN SEISMIC DESIGN CATEGORIES DO, D1 AND D2.

c. VERTICAL REINFORCEMENT SHALL BE GRADE 60 MINIMUM. THE DISTANCE FROM THE FACE OF THE SOIL SIDE OF THE WALL TO THE CENTER OF VERTICAL REINFORCEMENT SHALL BE NOT LESS THAN 8.75 INCHES.

#5 @ 72" O.C

#6 @ 72" O.C.

#6 @ 72" O.C.

#6 @ 56" O.C.

#5 @ 72" O.C.

#6 @ 72" O.C.

#6 @ 48" O.C.

#6 @ 40" O.C.

#6 @ 32" O.0

d. SOIL CLASSES ARE IN ACCORDANCE WITH THE UNIFIED SOIL CLASSIFICATION SYSTEM AND DESIGN LATERAL SOIL LOADS ARE FOR MOIST CONDITIONS WITHOUT HYDROSTATIC PRESSURE. REFER TO TABLE R405.1.

2. UNBALANCED BACKFILL HEIGHT IS THE DIFFERENCE IN HEIGHT BETWEEN THE EXTERIOR FINISH GROUND LEVEL AND THE LOWER OF THE

TOP OF THE CONCRETE FOOTING THAT SUPPORTS THE FOUNDATION WALL OR THE INTERIOR FINISH GROUND LEVEL. WHERE AN INTERIOR CONCRETE SLAB-ON-GRADE IS PROVIDED AND IS IN CONTACT WITH THE INTERIOR SURFACE OF THE FOUNDATION WALL, MEASUREMENT OF THE UNBALANCED BACKFILL HEIGHT FROM THE EXTERIOR FINISH GROUND LEVEL TO THE TOP OF THE INTERIOR CONCRETE SLAB IS PERMITTED.

f. THE USE OF THIS TABLE SHALL BE PROHIBITED FOR SOIL CLASSIFICATIONS NOT SHOWN.

#4@72"O.0

#4 @ 72" O.C.

#5 @ 72" O.C

#6 @ 72" O.C.

#6 @ 64" O.

TABLE R404.1.2(8)

			MINIMUM VERTICAL REINFORCEMENT FOR 6-, 8-, 10- AND 12-INCH NOMINAL FLAT BASEMENT WALLS b, c, d, e, f, h, i, k, n, o										
		MINIMUM VERTICAL REINFORCEMENT-BAR SIZE & SPACING (inches)											
				SOIL CLASS	SES	AND DESIG	N LATERAL	SOIL (ps	f PER FOC	OT OF DEPT	H)		
MAXIMUM	MAXIMUM UNBALANCED BACKFILL	GW, GP, SW, AND SP 30			GM	GM, GS, SM-SC AND ML 45			SC, MH, ML-CL AND INORGANIC CL				
WALL HEIGHT	HEIGHT ⁹		MIMIMUM WALL THICKNESS (INCHES)										
(FEET)	(FEET)	6	8	10	12	6	8	10	12	6	8	10	12
5	4	NR	NR	NR	NR	NR	NR	NR	NR	NR	NR	NR	NR
,	5	NR	NR	NR	NR	NR	NR	NR	NR	NR	NR	NR	NR
6	4	NR	NR	NR	NR	NR	NR	NR	NR	NR	NR	NR	NR
Ĭ	5	NR	NR	NR	NR	NR	NR ¹	NR	NR	#4@35"	NR ¹	NR	NR
	6	NR	NR	NR	NR	#5 @ 48"	NR	NR	NR	#5 @ 36"	NR	NR	NR
	4	NR	NR	NR	NR	NR	NR	NR	NR	NR	NR	NR	NR
7	5	NR	NR	NR	NR	NR	NR	NR	NR	#5 @ 47"	NR	NR	NR
'	6	NR	NR	NR	NR	#5 @ 42"	NR	NR	NR	#6 @ 43"	#5 @ 48"	NR ¹	NR
	7	#5 @ 46"	NR	NR	NR	#6 @ 42"	#5 @ 46"	NR ¹	NR	#6@34"	#6 @ 48"	NR	NR
	4	NR	NR	NR	NR	NR	NR	NR	NR	NR	NR	NR	NR
	5	NR	NR	NR	NR	#4@38"	NR ¹	NR	NR	#5 @ 43"	NR	NR	NR
8	6	#4@37"	NR 1	NR	NR	#5 @ 37"	NR	NR	NR	#6 @ 37"	#5 @ 43"	NR ¹	NR
	7	#5 @ 40"	NR	NR	NR	#6 @ 37"	#5 @ 41"	NR ¹	NR	#6 @ 34"	#6 @ 43"	NR	NR
	8	#6 @ 43"	#5 @ 47"	NR ¹	NR	#6 @ 34"	#6 @ 43"	NR	NR	#6 @ 27"	#6 @ 32"	#6 @ 44"	NR
	4	NR	NR	NR	NR	NR	NR	NR	NR	NR	NR	NR	NR
	5	NR	NR	NR	NR	#4@35"	NR ¹	NR	NR	#5 @ 40"	NR	NR	NR
9	6	#4@34"	NR ¹	NR	NR	#6 @ 48"	NR	NR	NR	#6 @ 36"	#6 @ 39"	NR ¹	NR
. [7	#5 @ 36"	NR	NR	NR	#6@34"	#5 @ 37"	NR	NR	#6 @ 33"	#6 @ 38"	#5 @ 37"	NR ¹
	8	#6 @ 38"	#5 @ 41"	NR	NR	#6 @ 33"	#6 @ 38"	#5 @ 37"	NR ¹	#6@24"	#6 @ 29"	#6 @ 39"	#4@48
	9	#6@34"	#6 @ 46"	NR	NR	#6 @ 26"	#6 @ 30"	#6 @ 41"	NR	#6@19"	#6 @ 23"	#6 @ 30"	#6 @ 39
	4	NR	NR	NR	NR	NR	NR	NR	NR	NR	NR	NR	NR
10	5	NR	NR	NR	NR	#4@33"	NR ¹	NR	NR	#5 @ 38"	NR	NR	NR
	6	#5 @ 48"	NR ¹	NR	NR	#6 @ 45"	NR	NR	NR	#6@34"	#5 @ 37"	NR	NR
	7	#6 @ 47"	NR	NR	NR	#6@34"	#6 @ 48"	NR	NR	#6 @ 30"	#6 @ 35"	#6 @ 48"	NR ¹
Ī	8	#6 @ 34"	#5 @ 38"	NR	NR	#6 @ 30"	#6@34"	#6 @ 47"	NR ¹	#6 @ 22"	#6 @ 26"	#6 @ 35"	#6 @ 45
Ī	9	#6 @ 34"	#6@41"	#4@48"	NR 1	#6 @ 23"	#6 @ 27"	#6 @ 35"	#4 @48" ^m	DR	#6 @ 22"	#6 @ 27"	#6@34
ļ	10	#6 @ 28"	#6 @ 33"	#6 @ 45"	NR	DR ^j	#6 @ 23"	#6 @ 29"	#6 @ 38"	DR	#6 @ 22"	#6 @ 22"	#6 @ 28

a. SOIL CLASSES ARE IN ACCORDANCE WITH THE UNIFIED SOIL CLASSIFICATION SYSTEM. REFER TO TABLE R405.1.

b. TABLE VALUES ARE BASED ON REINFORCING BARS WITH A MINIMUM YEID STRENGTH OF 60,000 PSI
c. VERTICAL REINFOREMENT WITH A YIELD STRENGTH OF LESS THAN 60,000 PSI AND / OR BARS OF A DIFFERENT SIZE THAN SPECIFIED IN THE TABLE

ARE PERMITTED IN ACCORDANCE WITH SECTION R404.1.3.3.7.6 AND TABLE R404.1.2 (9)

d. NR INDICATES NO VERTICAL WALL REINFORCEMENT IS REQUIRED, EXCEPT FOR 6-INCH NOMINAL WALLS FORMED WITH STAY-IN-PLACE FORMING

d. NR INDICATES NO VERTICAL WALL REINFORCEMENT IS REQUIRED, EXCEPT FOR 6-INCH NOMINAL WALLS FORMED WITH STAY-IN-PLACE FORMING SYSTEMS IN WHICH CASE VERTICAL REINFORCEMENT SHALL BE NO. 4 @ 48 INCHES ON CENTER.

e. ALLOWABLE DEFLECTION CRITERION IS L/240, WHERE L IS THE UNSUPPORTED HEIGHT OF THE BASEMENT WALL IN INCHES.

f. INTERPOLATION IS NOT PERMITTED.

g. WHERE WALLS WIL REMAIN 4 FEET OR MORE OF UNBALANCED BACKFILL, THEY SHALL BE LATERALLY SUPPORTED AT THE TOP AND BOTTOM BEFORE BACKFILLING.
 h. VERTICAL REINFORCEMENT SHALL BE LOCATED TO PROVIDE A COVER OF 1 1/4 INCHES MEASURED FROM THE INSIDE FACE OF THE WALL. THE CENTER OF THE STEEL

SHALL NOT VARY FROM THE SPECIFIED LOCATION BY MORE THAN THE GREATER OF 10 PERCENT OF THE WALL THICKNESS OR 3/8 INCH.

i. CONCRETE COVER FOR THE REINFORCEMENT MEASURE FROM THE INSIDE FACE OF THE WALL SHALL BE NOT LESS THAN 3/4 INCH. CONCRETE COVER FOR REINFORCEMENT MEASURED FROM THE OUTSIDE FACE OF THE WALL SHALL BE NOT LESS THAN 1 1/2 INCHES FOR NO. 5 BARS AND SMALLER, AND NOT LESS THAN 2 INCHES FOR LARGER BARS.

j. DR MEANS DESIGN IS REQUIRED IN ACCORDANCE WITH THE APPLICABLE BUILDING CODE, OR WHERE THERE IS NO CODE, IN ACCORDANCE WITH ACI 3 18.

k. CONCRETE SHALL HAVE A SPECIFIED COMPRESSIVE STRENGTH, fc OF NOT LESS THAN 2,500 PSI AT 28 DAYS, UNLESS A HIGHER STRENGTH IS REQUIRED BY FOOTNOTE 1 OR m.

I. THE MINIMUM THICKNESS IS PERMITTED TO BE REDUCED 2 INCHES, PROVIDED THE MINIMUM SPECIFIED COMPRESSIVE STRENGTH OF CONCRETE, fc IS 4,000 PSI.

m. A PLAIN CONCRETE WALL WITH A MINIMUM NOMINAL THICKNESS OF 12 INCHES IS PERMITTED, PROVIDED MINIMUM SPECIFIED COMPRESSIVE STRENGTH OF CONCRETE, fc IS 3,500 PSI.

n. SEE TABLE R608.3 FOR TOLERANCE FROM NOMINAL THICKNESS PERMITTED FOR FLAT WALLS.

o. THE USE OF THIS TABLE SHALL BE PROHIBITED FOR SOIL CLASSIFICATIONS NOT SHOWN.

TABLE R 402.4.1.1 AIR BARRIER AND INSULATION INSTALLATION

COMPONENT	AIR BARRIER CRITERIA	INSULATION INSTALLATION CRITERIA				
	A CONTINUOUS AIR BARRIER SHALL BE INSTALLED IN THE BUILDING ENVELOPE.					
GENERAL REQUIREMENTS	THE EXTERIOR THERMAL ENVELOPE CONTAINS A CONTINUOUS AIR BARRIER.	AIR-PERMEABLE INSULATION SHALL NOT BE USED AS A SEALING MATERIAL.				
	BREAKS OR JOINTS IN THE AIR BARRIER SHALL BE SEALED.					
CEILING / ATTIC	THE AIR BARRIER IN ANY DROPPED CEILING / SOFFIT SHALL BE ALIGNED WITH THE INSULATION AND ANY GAPS IN THE AIR BARRIER SHALL BE SEALED.	THE INSULATION IN ANY DROPPED CEILING / SOFFIT SHALL BE ALIGNED WITH THE AIR BARRIER.				
	ACCESS OPENINGS, DROP DOWN STAIRS, OR KNEE WALL DOORS TO UNCONDITIONED ATTIC SPACES SHALL BE SEALED.	SOTTH STATE DE ALIGNED WITH THE AIR DARRIER.				
	THE JUNCTION OF THE FOUNDATION AND SILL PLATE SHALL BE SEALED.	CAVITIES WITH CORNERS AND HEADERS OF FRAME WALLS SHALL BE INSULATED BY COMPLETELY FILLING THE CAVITY WITH A MATERIAL HAVING A THERMAL				
WALLS	THE JUNCTION OF THE TOP PLATE AND THE TOP OF EXTERIOR WALLS SHE BE SEALED.	RESISTANCE OF R-3 PER INCH MINIMUM.				
	KNEE WALLS SHALL BE SEALED.	EXTERIOR THERMAL ENVELOPE INSULATION FOR FRAMED WALLS SHALL BE INSTALLED IN SUBSTANTIAL CONTACT AND CONTINUOUS ALIGNMENT WITH THE AIR BARRIER.				
WINDOWS, SKYLIGHTS AND DOORS	THE SPACE BETWEEN WINDOW / DOOR JAMBS AND FRAMING, AND SKYLIGHTS AND FRAMING SHALL BE SEALED.					
RIM JOISTS	RIM JOISTS SHALL INCLUDE THE AIR BARRIER.	RIM JOISTS SHALL BE INSULATED.				
FLOORS (INCLUDING ABOVE GARAGE AND CANTILEVERED FLOORS)	THE AIR BARRIER SHALL BE INSTALLED AT ANY EXPOSED EDGE OF INSULATION.	FLOOR FRAMING CAVITY INSULATION SHALL BE INSTALLED TO MAINTAIN PERMANENT CONTACT WITH THE UNDERSIDE OF SUBFLOOR DECKING, OR FLOOR FRAMING CAVITY INSULATION SHALL BE PERMITTED TO BE IN CONTACT WITH THE TOP SIDE OF SHEATHING, OR CONTINUOUS INSULATION INSTALLED ON THE UNDERSIDE OF FLOOR FRAMING AND EXTENDS FROM THE BOTTOM TO THE TOP OF ALL PERIMETER FLOOR FRAMING MEMBERS.				
CRAWL SPACE WALLS	EXPOSED EARTH IN UNVENTED CRAWL SPACES SHALL BE COVERED WITH A CLASS I VAPOR RETARDER WITH OVERLAPPING JOINTS TAPED.	WHERE PROVIDED INSTEAD OF FLOOR INSULATION, INSULATION SHALL BE PERMANENTLY ATTACHED TO THE CRAWLSPACE WALLS.				
SHAFTS, PENETRATIONS	DUCT SHAFTS, UTILITY PENETRATIONS, AND FLUE SHAFTS OPENING THE EXTERIOR OR UNCONDITIONED SPACE SHALL BE SEALED.					
NARROW CAVITIES		BATTS IN NARROW CAVITIES SHALL BE CUT TO FIT, OR NARROW CAVITIES SHALL BE FILLED BY INSULATION THAT ON INSTALLATION READILY CONFORMS TO THE AVAILABLE CAVITY SPACE.				
GARAGE SEPARATION	AIR SEALING SHALL BE PROVIDED BETWEEN THE GARAGE AND CONDITIONED SPACES.					
RECESSED LIGHTING	RECESSED LIGHT FIXTURES INSTALLED IN THE BUILDING THERMAL ENVELOPE SHALL BE SEALED TO THE DRYWALL.	RECESSED LIGHT FIXTURES INSTALLED IN THE BUILDING THERMAL ENVELOPE SHALL BE AIR TIGHT AND IC RATED.				
PLUMBING AND WIRING		BATT INSULATION SHALL BE CUT NEATLY TO FIT AROUND WIRING AND PLUMBING IN EXTERIOR WALLS, OR INSULATION THAT ON INSTALLATION READILY CONFORMS TO AVAILABLE SPACE SHALL EXTEND BEHIND PIPING AND WIRING.				
SHOWER / TUB ON EXTERIOR WALL	THE AIR BARRIER INSTALLED AT EXTERIOR WALLS ADJACENT TO SHOWERS AND TUBS SHALL SEPARATE THEM FROM THE SHOWERS AND TUBS.	EXTERIOR WALLS ADJACENT TO SHOWERS AND TUBS SHALL BE INSULATED.				
ELECTRICAL / PHONE BOX ON EXTERIOR WALLS	THE AIR BARRIER SHALL BE INSTALLED BEHIND ELECTRICAL OR COMMUNICATION BOXES OR AIR-SEALED BOXES SHALL BE INSTALLED.					
HVAC REGISTER BOOTS	HVAC REGISTER BOOTS THAT PENETRATE BUILDING THERMAL ENVELOPE SHALL BE SEALED TO THE SUBFLOOR OR DRYWALL.					
CONCEALED SPRINKLERS	WHEN REQUIRED TO BE SEALED, CONCEALED FIRE SPRINKLERS SHALL ONLY BE SEALED IN A MANNER THAT IS RECOMMENDED BY THE MANUFACTURER. CAULKING OR OTHER ADHESIVE SEALANTS SHALL NOT BE USED TO FILL VOIDS BETWEEN FIRE SPRINKLER COVER PLATES AND WALL OR CEILINGS.					

a. IN ADDITION, INSPECTION OF LOG WALLS SHALL BE IN ACCORDANCE WITH THE PROVISIONS OF ICC-400.

R401.4 SOIL TESTS.

WHERE QUANTIFIABLE DATA CREATED BY ACCEPTED SOIL SCIENCE METHODOLOGIES INDICATE EXPANSIVE, COMPESSIBLE, SHIFTING OR OTHER QUESTIONABLE SOIL CHARACTERISTICS ARE LIKELY TO BE PRESENT, THE BUILDING OFFICIAL SHALL DETERMINE WHETHER TO REQUIRE A SOIL TEST TO DETERMINE THE SOIL'S CHARACTERISTICS AT A PARTICULAR LOCATION. THIS TEST BE DONE BY AN APPROVED AGENCY USING AN APPROVED METHOD.

R401.4.1 GEOTECHNICAL EVALUATION. IN LIEU OF A COMPLETE GEOTECHNICAL EVALUATION, THE LOAD-BEARING VALUES IN TABLE R401.4.1

10'-0"

TABLE R401.4.1

PRESUMPTIVE LOAD-BEARING VALUES OF FOUNDATION MATERIALS


CLASS OF MATERIALS	LOAD-BEARING PRESSURE (pounds per square foot)
CRYSTALLINE BEDROCK	12,000
SEDIMENTARY & FOLIATED ROCK	4,000
SANDY GRAVEL AND/OR GRAVEL (GW & GP)	3,000
SAND, SILTY SAND, CLAYEY SAND, SILTY GRAVEL, AND CLAYEY GRAVEL (SW, SP, SM, SC, GM, & GC)	2,000
CLAY, SANDY CLAY, SILTY CLAY, CLAYEY SILT, SILT AND SANDY SILT (CL, ML, MH, & CH)	1,500 ^b

a. WHERE SOIL TESTS ARE REQUIRED BY SECTION R401.4, THE ALLOWABLE BEARING CAPACITIES OF THE SOIL SHALL BE PART OF THE RECOMMENDATIONS.

b. WHERE THE BUILDING OFFICIAL DETERMINES THAT IN-PLACE SOILS WITH AN ALLOWABLE BEARING CAPACITY OF LESS THAN 1,500 psf are likely to be present at the site, the allowable bearing capacity shall be determined by a soils investigation.

UNIFIED SOIL CLASSIFICATION SYSTEM

	OCIL CL/(OCII IC
UNIFIED SOIL CLASSIFICATION SYSTEM SYMBOL	
GШ	WELL-GRADED GRAVELS, GRAVEL SAND MIXTURES, LITTLE OR NO FINES
GP	POORLY GRADED GRAVELS OR GRAVEL SAND, LITTLE OR NO FINES
SW	WELL-GRADED SANDS, GRAVELLY SANDS, LITTLE OR NO FINES
SP	POORLY GRADED SANDS OR GRAVELLY SANDS, LITTLE OR NO FINES
GM	SILTY GRAVELS, GRAVEL-SAND-SILT MIXTURES
SM	SILTY SAND, SAND-SILT MIXTURES
GC	CLAYEY GRAVELS, GRAVEL-SAND-CLAY MIXTURES
SC	CLAYEY SANDS, SAND-CLAY MIXTURE MIXTURES
ML	INORGANIC SILTS & VERY FINE SANDS, ROCK FLOUR, SILTY OR CLAYEY FINE SANDS OR CLAYEY SILTS WITH SLIGHT PLASTICITY
CL	INORGANIC CLAYS OF LOW TO MEDIUM PLASTICITY, GRAVELLY CLAYS, SANDY CLAYS, SILTY CLAYS, LEAN CLAYS
СН	INORGANIC CLAYS OF HIGH PLASTICITY, FAT CLAYS
МН	INORGANIC SILTS, MICACEOUS OR DIATOMACEOUS FINE SANDY OR SILTY SOILS, ELASTIC SILTS
OL	ORGANIC SILTS & ORGANIC SILTY CLAYS OF LOW PLASTICITY
ОН	ORGANIC CLAYS OF MEDIUM TO HIGH PLASTICITY, ORGANIC SILTS
PT	PEAT & OTHER HIGHLY ORGANIC SOILS

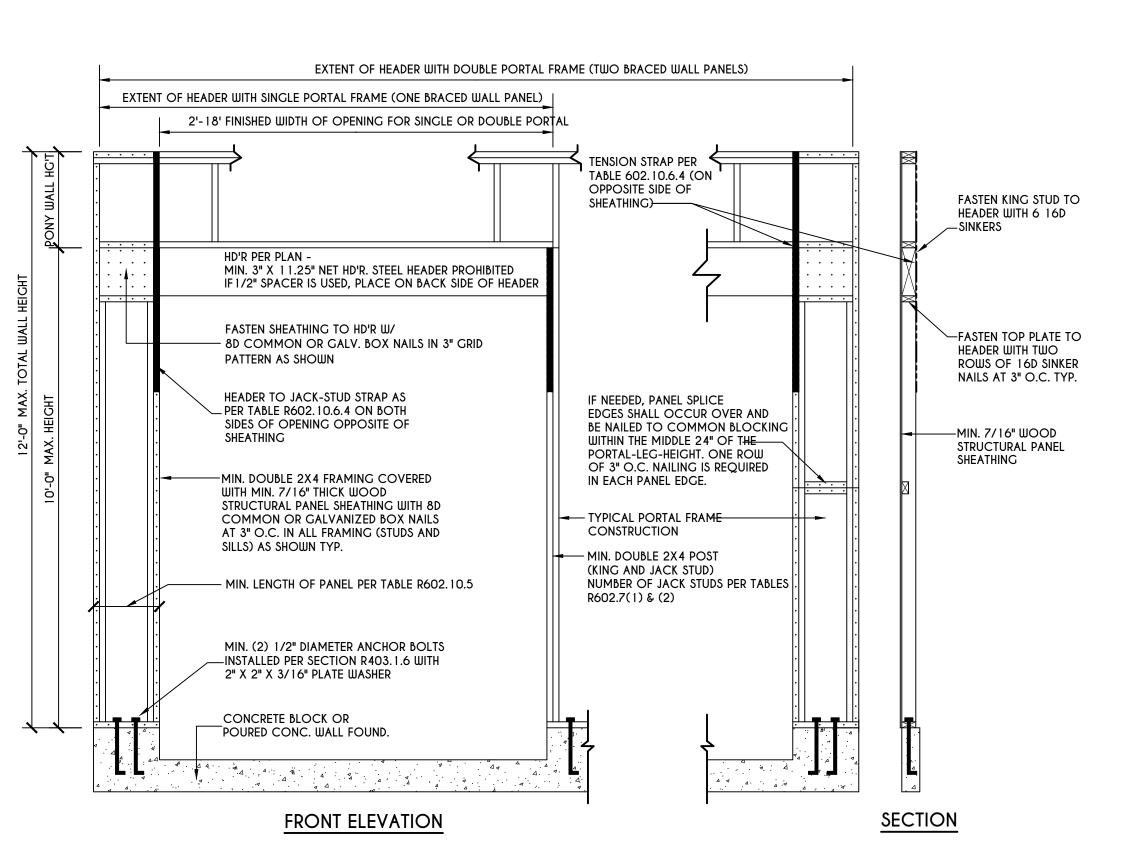

PORTAL FRAME AT GARAGE DOOR OPENINGS IN SEISMIC DESIGN CATEGORIES A, B, AND C

SCALE: N.T.S. FIGURE R602.10.6.3

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Greater Living Architecture, P.C.

3033 BRIGHTON-HENRIETTA TOWNLINE RD ROCHESTER, NY 14623 CALL:(585) 272-9170 FAX: (585) 292-1262

www.greaterliving.com

REVIS	IONS:	
DATE	BY	DESCRIPTION

CLIENT/LOCATION:	
<u> </u>	

BUILDER:

REINFORCING NOTES

GLA PLAN 3005

drawn: checked:
CSB CDK

scale: date:
AS NOTED 11/21


PROJECT: sheet:
N

15399B







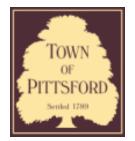

Town of Pittsford

Department of Public Works 11 South Main Street Pittsford, New York 14534

Permit # S21-000005

Phone: 585-248-6250 FAX: 585-248-6262

DESIGN REVIEW AND HISTORIC PRESERVATION BOARD REFERRAL OF APPLICATION

Property Address: 3330 Monroe Avenue ROCHESTER, NY 14618

Tax ID Number: 150.12-1-16

Zoning District: C Commercial


Owner: Kinecta


Applicant: Rochester Sign Company

Application Type:	
Residential Design Review	Build to Line Adjustment
□ §185-205 (B) □ Commercial Design Review	□ §185-17 (B) (2) □ Building Height Above 30 Feet
§185-205 (B)	§185-17 (M)
Signage	Corner Lot Orientation
- 9185-205 (C)	□ §185-17 (K) (3)
 Certificate of Appropriateness 	Flag Lot Building Line Location
[└] §185-197	[└] §185-17 (L) (1) (c)
─ Landmark Designation	Undeveloped Flag Lot Requirements
[└] §185-195 (2)	└ §185-17 (L) (2)
☐ Informal Review	

Project Description: Applicant is requesting design review for the addition of two temporary business identification signs. The sign on the east side of the building will be approximately 41 square feet and the sign on the south side of the building will be approximately 92 square feet. The signs will be made with banner material and will display the "Kinecta" Logo.

Meeting Date: December 9, 2021

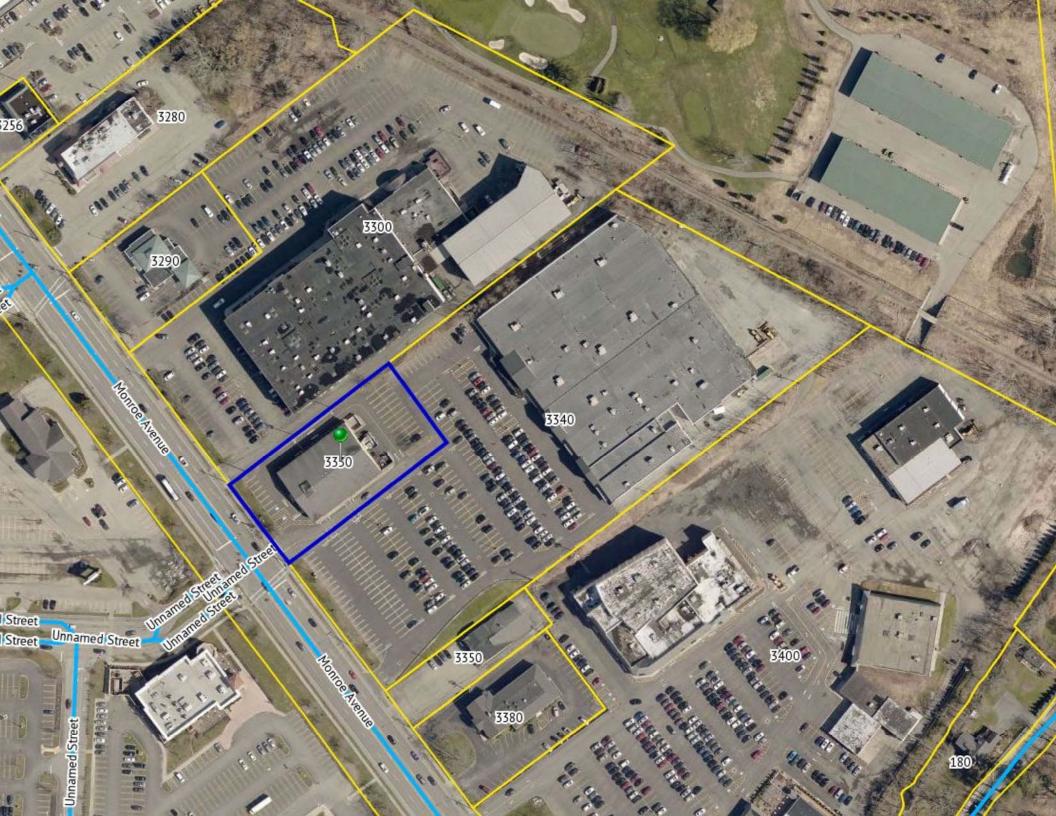

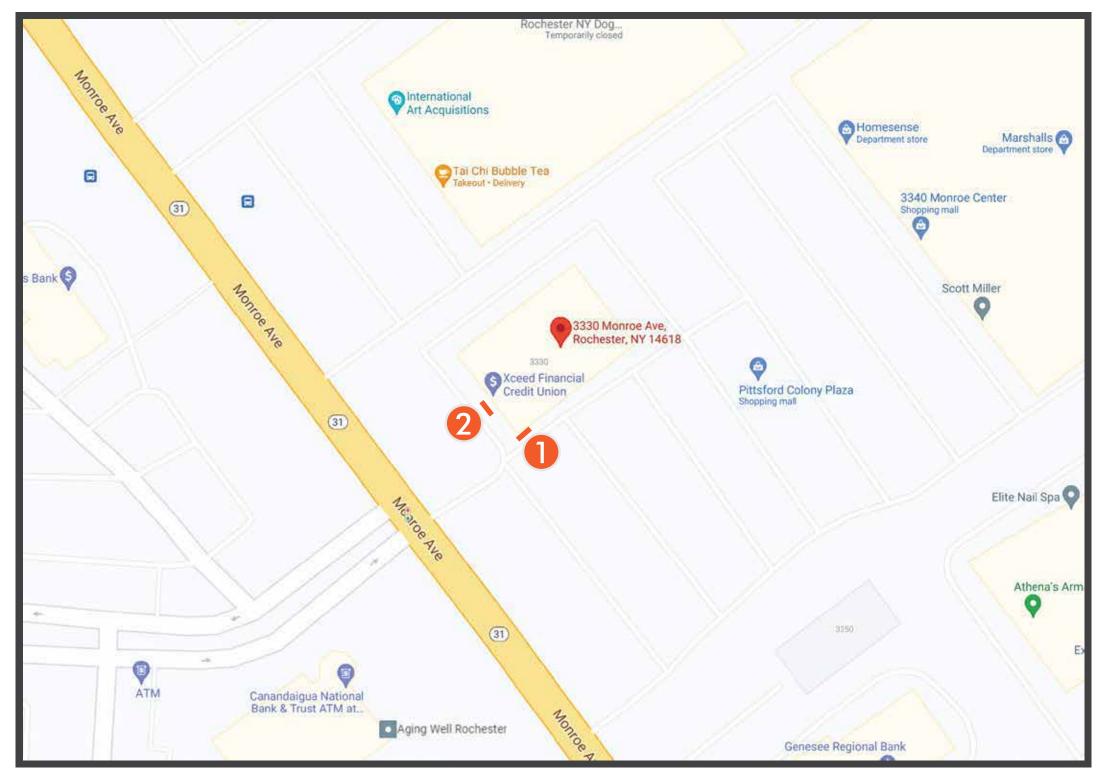



tako	
tyko	

Project Name.	Project Address.
Kinecta	3330 Monroe Av
21 - 10140	

3330 Monroe Ave.,	Rochester,	NY	14618	

Account	Rep.
Eric Cie	elak

Designer.
L. Moreno

 Approvals:

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Page.



KINECTA

3330 Monroe Ave., Rochester, NY 14618





Sq. Ft. = 41.6 - Qty - 1

Side View

Scope: Remove existing signs, Patch and paint walls.

kinecta banking done different

150"

.090 Aluminum Face with Vinyl Copy and Logo

> 5/16" x 3" screws with Washers every 24" Minimum 12 -



40"

Project Name. Kinecta 21 - 10140

Project Address.

3330 Monroe Ave., Rochester, NY 14618

Account Rep. Eric Cielak

Designer. L. Moreno

Date. 4-22-2021 Approvals:





Sq. Ft. = 92.5' - Qty - 1

Side View

Scope: Remove existing signs, Patch and paint walls.



.090 Aluminum Face with Vinyl Copy and Logo

> 5/16" x 3" screws with Washers every 24" Minimum 12 -

180"



74"

Project Name. Kinecta 21 - 10140

Project Address.

3330 Monroe Ave., Rochester, NY 14618


Account Rep. Eric Cielak

Designer. L. Moreno

Date. 4-22-2021

Approvals:

Awnings and Builing Stripes

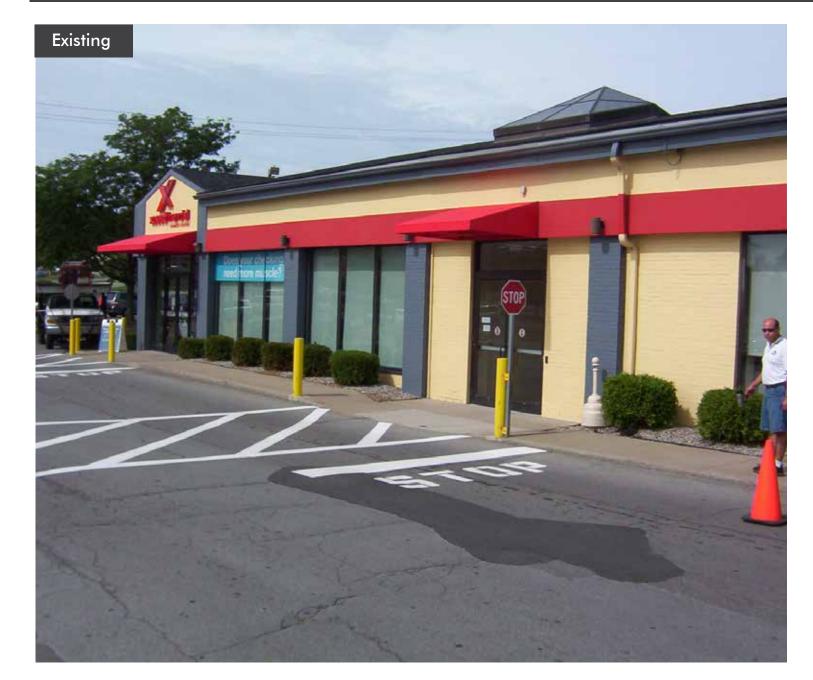



tako	
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LYNU	
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Project Name.

Kinecta
21 - 10140

Project Address.


3330 Monroe Ave., Rochester, NY 14618

Account Rep.
Eric Cielak

Designer.
L. Moreno

Date. 4-22-2021 evisions

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Town of Pittsford

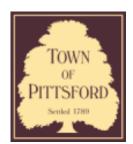Department of Public Works 11 South Main Street Pittsford, New York 14534

Permit # B21-000229

Phone: 585-248-6250 FAX: 585-248-6262

DESIGN REVIEW AND HISTORIC PRESERVATION BOARD REFERRAL OF APPLICATION

Property Address: 3524 East Avenue ROCHESTER, NY 14618

Tax ID Number: 138.14-1-66.3

Zoning District: IZ Incentive Zoning **Owner:** Kilbourn Place Associates, LP **Applicant:** Kilbourn Place Associates, LP

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	Residential Design Review §185-205 (B)	Build to Line Adjustment §185-17 (B) (2)
~	Commercial Design Review §185-205 (B)	Building Height Above 30 Feet §185-17 (M)
	Signage §185-205 (C)	Corner Lot Orientation §185-17 (K) (3)
	Certificate of Appropriateness §185-197	Flag Lot Building Line Location §185-17 (L) (1) (c)
	Landmark Designation §185-195 (2)	Undeveloped Flag Lot Requirements §185-17 (L) (2)
	Informal Review	

Project Description: Applicant is requesting design review for the interior and exterior renovations to the Wright House.

Meeting Date: December 09, 2021



RN Residential Neighborhood Zoning



Town of Pittsford GIS


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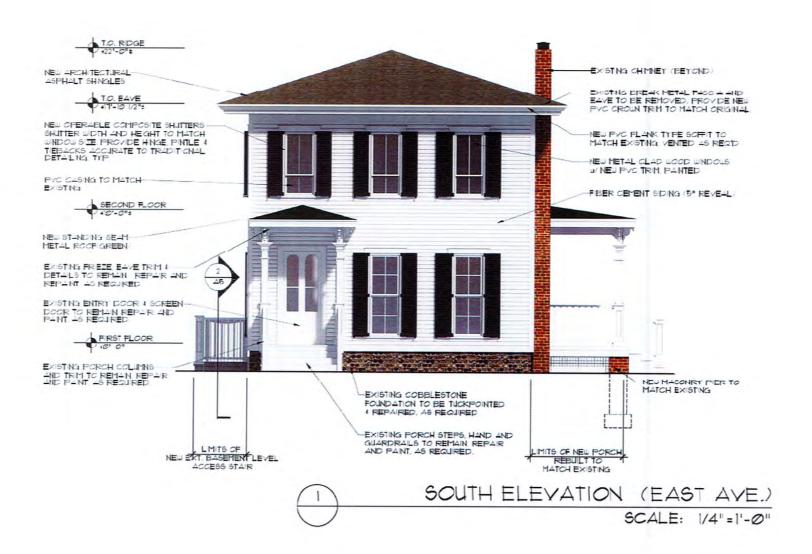
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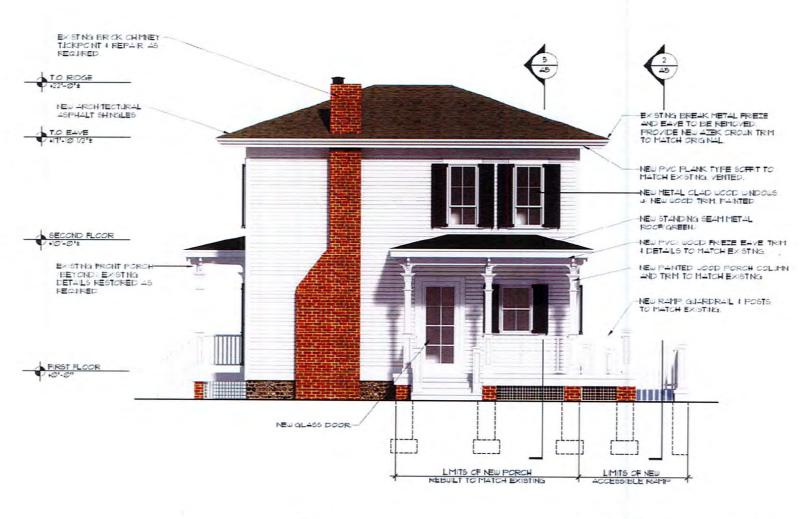
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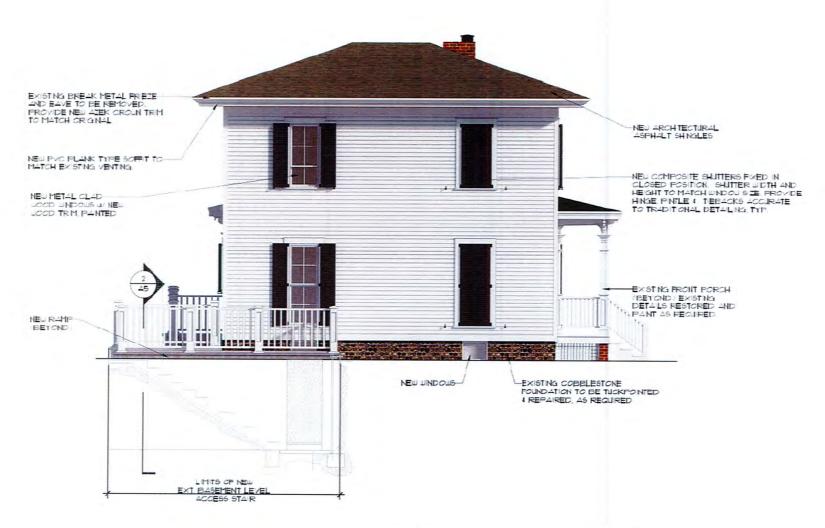








EAST ELEVATION


SCALE: 1/4"=1'-0"

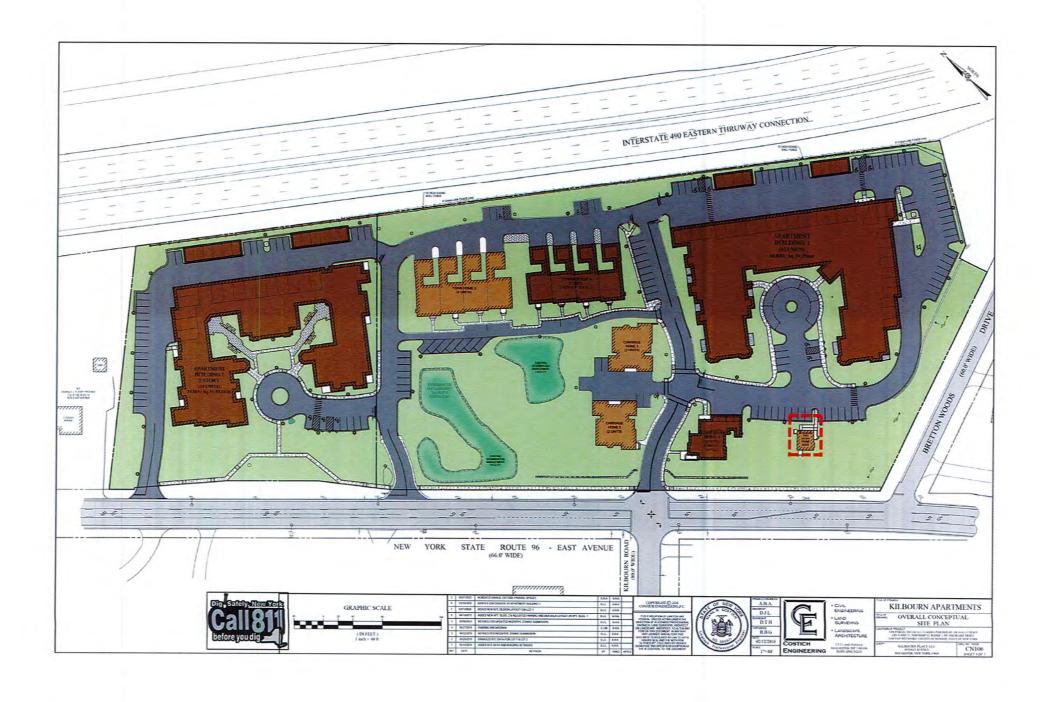




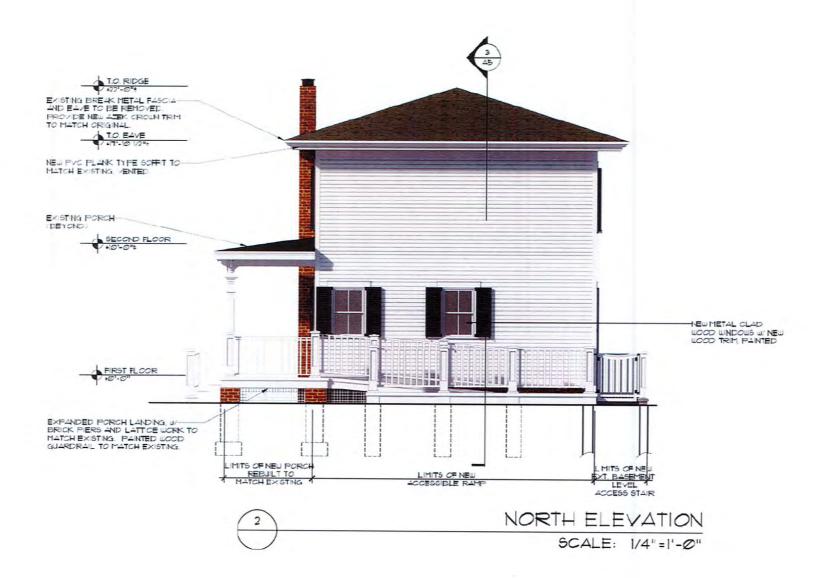


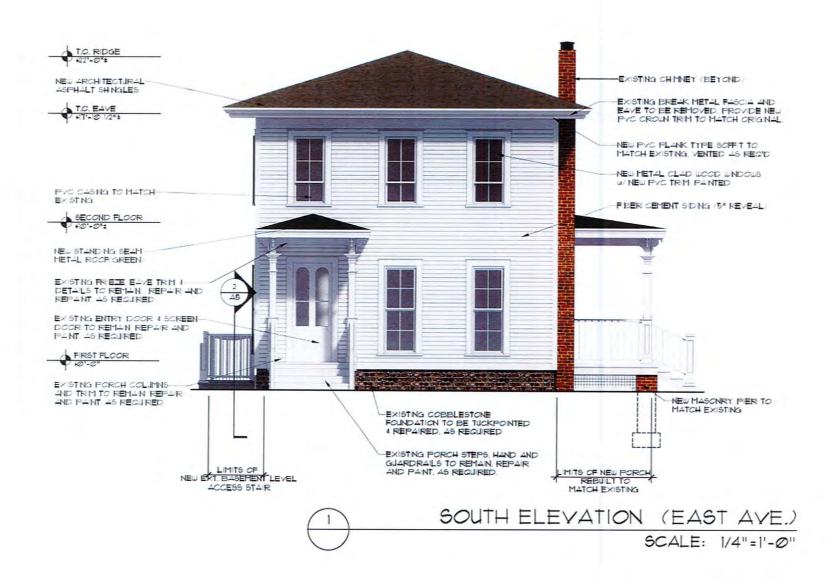


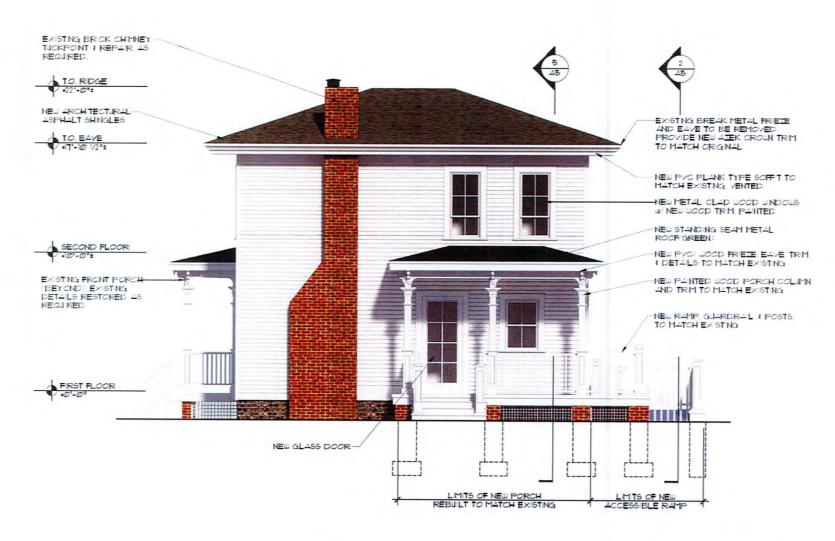


EAST ELEVATION SCALE: 1/4"=1'-0"

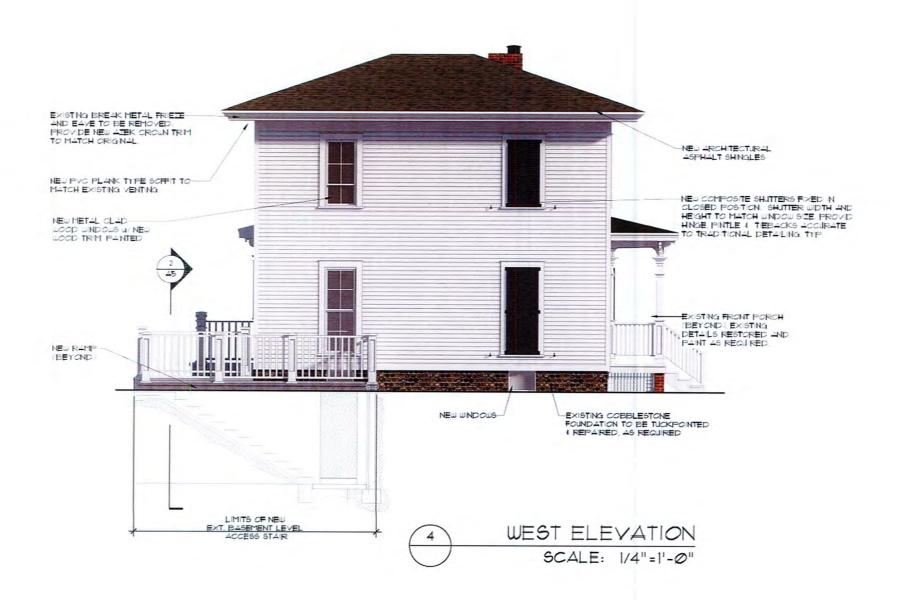

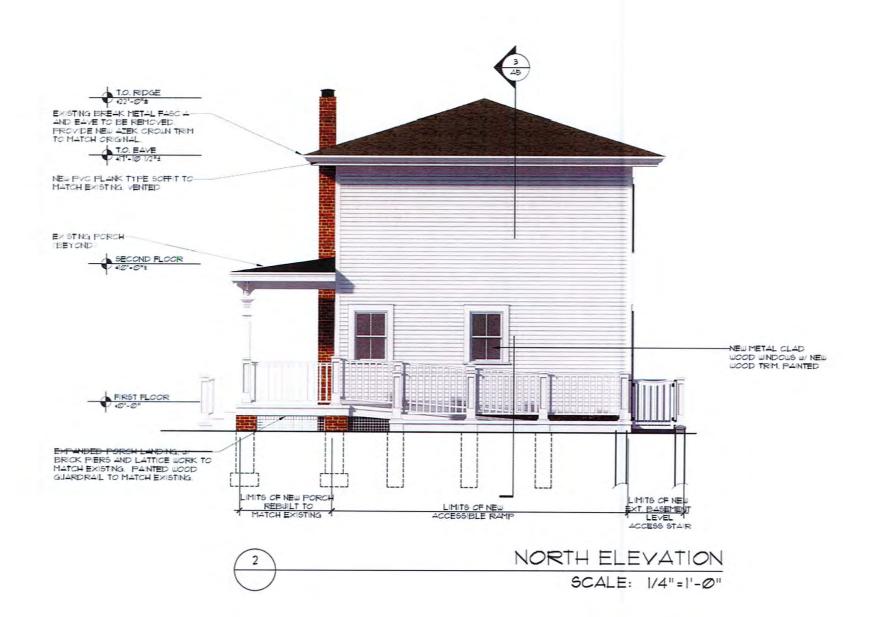


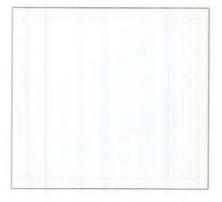

WINDOW: METAL CLAD WOOD.
WHITE WITH TRUE DIVIDED LIGHTS

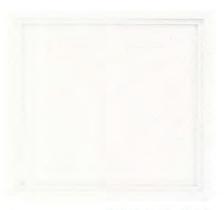

TRIM: PAINTED WOOD

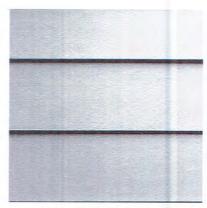

SIDING: FIBER CEMENT LAP SIDING. WHITE, SMOOTH



ROOFING: ARCHITECTURAL ROOF SHINGLES W/ ACCENT STANDING SEAM METAL ROOF



SHUTTERS: EXISTING TO BE RESTORED
AND REPAINTED. NEW SHUTTERS
TO MATCH EXISTING



PORCH RAILING: EXISTING TO BE RESTORED AND REPAINTED. NEW RAILINGS TO MATCH EXISTING



BRICK: TO MATCH EXISTING



WRIGHT HOUSE

KILBOURN APARTMENTS
PROPOSED EXTERIOR FINISH MATERIALS
NOVEMBER 30, 2020