## Design Review & Historic Preservation Board Agenda July 23, 2020

#### HISTORIC PRESERVATION DISCUSSION

#### RESIDENTIAL APPLICATION FOR REVIEW

#### 323 East Street

The Applicant is requesting design review for a kitchen and bath addition. The addition will be approximately 340 sq. ft. and will be located to the rear of the existing home.

#### • 355 East Street

The Applicant is requesting design review for the garage extension. The extension will be approximately 72 sq. ft. and will be located behind the 3rd bay of the garage.

#### **RESIDENTIAL APPLICATION FOR REVIEW - NEW**

#### • 16 Ravenna Crescent

The Applicant is requesting design review for the construction of a two story single family home. The home will be approximately 2800 sq. ft. and will be located in the Coventry Ridge Subdivision.

#### 4 San Rafael Drive

The Applicant is requesting design review for the construction of a new single family home. The home will be approximately 6440 sq. ft. of livable space and will be located on a vacant lot in the San Rafael Drive neighborhood.

#### 23 & 25 Skylight Trail

The Applicant is returning to request design review for the proposed construction of a new town home dwelling. The proposed building will consist of 2 attached single family dwellings sharing a common wall. Lot 40 (23 Skylight Trail) will be approximately 2013 sq. ft. and Lot 39 (25 Skylight Trail) will be 2000 sq. ft. The town homes will be located in the new Alpine Ridge development.

#### 40 Skylight Trail

The Applicant is requesting design review for the construction of a community building. The building will be approximately 820 sq. ft. and will be located in the Alpine Ridge Subdivision.

#### 25 Parker Drive

The applicant is requesting Design Review for the proposed construction of an addition and an oversized accessory structure. The proposed construction is a 2 story 1,007 Sq. Ft. addition and a 468 Sq. Ft. workshop/Storage structure. The addition will create living space and a new garage. The Zoning Board of Appeals has heard these applications on July 20, 2020.

#### **COMMERCIAL APPLICATION**

#### 3001 Monroe Avenue

The Applicant is requesting design review for the addition of a business identification sign. The sign will be approximately 10.5 sq. ft. and will identify "Blonsky Family Chiropractic".

#### OTHER - REVIEW OF 7/9/2020 MINUTES

#### How to view the meeting:

#### 1. Zoom

- In your web browser, go to https://townofpittsford.zoom.us/j/81368200858?pwd=QmNRMFIYOGczSjlxUmZsc2lzRVZMZz09
- You will be connected to the meeting.

#### 2. Telephone

You can access the meeting by phone. Use any of the phone numbers below, then enter the
meeting ID when prompted. The Meeting ID is 813 6820 0858. No password is
necessary.

(929) 205-6099	(312) 626-6799
(253) 215-8782	(301) 715-8592
(346) 248-7799	(669) 900-6833

#### Draft

#### Design Review and Historic Preservation Board Minutes July 9, 2020

#### **PRESENT**

Dirk Schneider, Chairman; Paul Whitbeck, Bonnie Salem, Kathleen Cristman, John Mitchell

#### ALSO PRESENT

Mark Lenzi, Building Inspector; Susan Donnelly, Secretary to the Board; Robert Koegel, Town Attorney

Proceedings of a regular meeting of the Pittsford Design Review and Historic Preservation Board were held on Thursday, June 25 at 6:00 P.M. local time. The meeting took place with Board members and applicants participating remotely using Zoom.

#### **ABSENT**

Leticia Fornataro, David Wigg

Dirk Schneider opened the meeting at 6:00 pm.

#### HISTORIC PRESERVATION DISCUSSION

The Board discussed the reception for inventoried homeowners. A tentative date of November 5 is now preferred. This is a good date for the speaker Wayne Goodman to attend. Letters should be sent out a month in advance in October.

Bonnie Salem discussed the banners for the historic district. Although Mr. Beckford was not in attendance at this meeting, it was reported by Dirk Schneider that he sent communication to the Town finance director regarding approval for the funds to purchase them. Dirk indicated that he will forward this communication from Kevin Beckford to Allen Reitz and Mark Lenzi.

#### RESIDENTIAL APPLICATION FOR REVIEW

#### 60 Falcon Trail

The Applicant is requesting design and review for a kitchen addition. The addition will be approximately 95 sq. ft. and will be located to the rear of the home.

The homeowner, Kristin Dawe was present to discuss the application with the Board.

The proposed project will be to add an addition to expand the kitchen to include a 10'  $\times$  9 ½' kitchen nook. The roof will be a hip roof.

The Board felt this was a fitting addition to the home.

Kathleen Cristman moved to accept the application as submitted.

Paul Whitbeck seconded.

Dirk Schneider called for a roll call vote.

Schneider voted aye. Salem voted aye. Mitchell voted aye. Cristman voted aye. Whitbeck voted aye.

#### RESIDENTIAL APPLICATION FOR REVIEW - NEW

#### • 23 & 25 Skylight Drive

The Applicant is requesting design review for the proposed construction of a new town home dwelling. The proposed building will consist of 2 attached single family dwellings sharing a common wall. Lot 40 (23 Skylight Trail) will be approximately 2013 sq. ft. and Lot 39 (25 Skylight Trail) will be 2000 sq. ft. The town homes will be located in the new Alpine Ridge development.

Jeff Brokaw of Morrell Builders was present to discuss this application.

The submission from the applicant provided provided much confusion with the Board.

In general it was determined that it was difficult for the Board to discern given the submission of many different colors of X's and no key to those X's which unit was proposed to be built.

Once this was determined which unit would be built and after lengthy discussion, it was determined that the color rendering provided did not reflect the windows, garage doors or orientation of the garage that are proposed to be built and was only intended as a color representation of one of the units. Mr. Brokaw indicated that the blueprint drawing with front facing garages is the unit proposed to be built. However, the "color rendering" provided showed only the Booth Bay Blue coloration and not the Light Mist coloration of the second unit as Mr. Brokaw indicated that this townhouse unit would be two toned as indicated in the key plan. There was additional confusion from the key as to what the building step color meant. Mr. Brokaw explained the assigned color indicates which unit is to be stepped.

Several Board members indicated again that the use of three materials is overkill and "too busy". When the Board inquired what type of stone is going to be used Mr. Brokaw indicated he did not know that it is drawn on the blueprint to represent that stone is present. Mr. Brokaw stated three materials are what customers want and the Board has approved this at other locations. The Board indicated that it is time to put

something in place as multiple materials are counter to the recommendations of the Design Guidelines. The Board feels this is a concern and it is not too late to correct the situation at this subdivision.

Bonnie Salem noted her concerns about the lack of front door diversity. She quoted from the meeting minutes of October 19, 2019 where Jeff Morrell indicated that the design of the front doors could be "tweaked" to provide greater diversity. Bonnie asked if this is going to happen. Jeff Brokaw indicated he had no knowledge of this conversation with Mr. Morrell. Bonnie also inquired whether the same garage door would be used for all garages and Mr. Brokaw indicated yes. Bonnie Salem indicated that this lends to excessive similarity which is also discouraged in the guidelines. It was also noted that an overwhelming majority of the homes (34) have front loaded garages also discouraged in the guidelines. Mark Lenzi indicated that this parcel is approved as a subdivision and the number of units limits the amount of side load garages which can be used. The Board noted that the approval goes against what is outlined in the guidelines.

The Board further asked for further clarification of exactly what they being asked to approve by the Applicant. It was determined that the building with the red X with submitted blueprint drawing A-1 and A-2 and the two toned colors Booth Bay Blue and Light Mist are the colors submitted.

Finally, it was noted that corbels should be added under the right and left side fireboxes.

Dirk Schneider moved to approve the application for 23 & 25 Skylight Trail as submitted with the following conditions:

- 1. Corbels or brackets to be added under the right and left side fireboxes.
- 2. The colors of the units are two toned: Booth Bay Blue and Light Mist.

John Mitchell seconded.

Dirk Schneider moved for a roll call vote.

Mitchell voted aye Schneider voted aye Whitbeck voted nay Cristman voted nay Salem voted nay

The motion did not carry.

Jeff Brokaw asked what the problem is with the submission.

Dirk Schneider noted the following concerns:

The Board requires clearer documentation and clarification in the renderings they are asked to approve – the submission is not cohesive. He feels the renderings need to be clearly labeled and a better presentation of what is meaningful needs to be given.

Kathleen Cristman referenced the monotony of the design and the expection that the Design Guidelines would be taken into account into the drawings and plans. This expectation has not been met. She also expressed difficulty understanding the renderings.

Robert Koegel stated that the rendering needs to reflect what the Board is being asked to approve.

Mark Lenzi expressed to Mr. Brokaw that one of the largest concerns of this development was that of excessive similarity of design. He indicated that this was made clear to Jeff Morrell. He indicated to Mr. Brokaw is that the burden of proof of what was going to be built in on the builder and the Board needs to be able to visualize in no uncertain terms what they are being asked to approve.

#### INFORMAL REVIEW - DEMOLITION OF STORAGE BUILDING

Mark Lenzi shared with the Board a request from Oak Hill Country Club for the demolition of a storage shed building in 1986. The building is not over 50 years old but Oak Hill Country Club clubhouse is an inventoried structure.

Bonnie Salem indicated that it is a dilemma because the materials of the storage shed matches the clubhouse and is one of the outbuildings of a historic building but the age does not justify keeping it.

Kathleen Cristman stated that the shed can be seen from the clubhouse. She felt that Oak Hill is removing trees and sinking down garage cans for a better view of the course and that the removal of this building which is not in use may be part of that.

Dirk Schneider added that this structure was not part of the original design of the Club and the removal of this shed may be part of an effort to return the course back to its original luster.

Mark Lenzi stated that this building was added for storage and bathroom facilities for tennis courts which are no longer in use. In addition, a tree has fallen on the porch of the structure.

Bonnie Salem supported the removal as a way of preserving the original look of the course. Paul Whitbeck indicated that Oak Hill Country Club is an important historic structure and it is important to pay attention to any changes. It was requested that a picture be taken before demolition to document what was there.

#### OTHER - REVIEW OF 6/25/2020 MINUTES

Bonnie Salem moved to accept the application as submitted.


John Mitchell seconded.

All Ayes.

The meeting adjourned at 7:15 pm.

Respectfully submitted,

Susan Donnelly Secretary to the Board

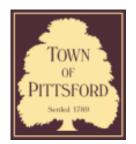

#### **Town of Pittsford**

Department of Public Works 11 South Main Street Pittsford, New York 14534

Permit # B20-000091

Phone: 585-248-6250 FAX: 585-248-6262

## DESIGN REVIEW AND HISTORIC PRESERVATION BOARD REFERRAL OF APPLICATION

Property Address: 323 East Street PITTSFORD, NY 14534

**Tax ID Number:** 178.16-1-12

Zoning District: RN Residential Neighborhood

Owner: Hamann, Karl W

**Applicant:** The Unlimited Enterprise

An	plica	tion	Type	٥.
AP.	piica	LIVII	I y P	•


-P P		
<b>✓</b>	Residential Design Review §185-205 (B)	Build to Line Adjustment §185-17 (B) (2)
	Commercial Design Review §185-205 (B)	Building Height Above 30 Feet §185-17 (M)
	Signage §185-205 (C)	Corner Lot Orientation §185-17 (K) (3)
	Certificate of Appropriateness §185-197	Flag Lot Building Line Location §185-17 (L) (1) (c)
	Landmark Designation §185-195 (2)	Undeveloped Flag Lot Requirements §185-17 (L) (2)
	Informal Review	

**Project Description:** Applicant is requesting design review for a kitchen and bath addition. The addition will be approximately 340 sq. ft. and will be located to the rear of the existing home.

Meeting Date: July 23, 2020



### RN Residential Neighborhood Zoning

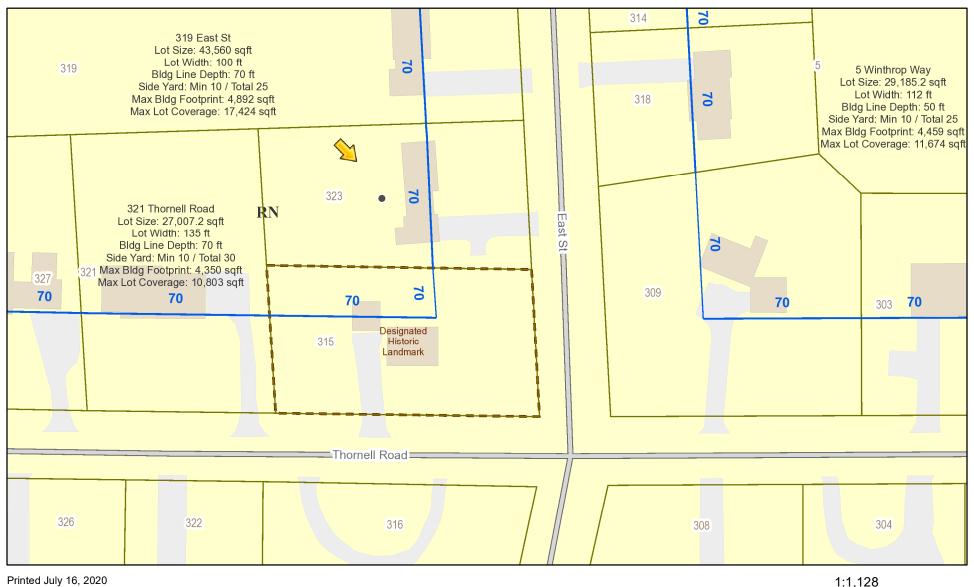

1.1,128 0 45 90 180 ft 1.1,128 0 12.5 25 50 m

Town of Pittsford GIS

The information depicted on this map is representational and should be used for general reference purposes only. No warranties, expressed or implied, are provided for the data or its use or interpretation.







## HAMANN RESIDENCE

## JULY 20, 2020 PERMIT DRAWINGS

ARCHITECT:

WOLFE ARCHITECTURE

3 NORTH MAIN ST. SUITE 2 HONEOYE FALLS, NEW YORK 14472 (585)-582-6277

D.F.

D.I.P.

E.W.

ELEC.

E.C.

ELEV.

EQUIP.

EXIST.

EXP.

EXP.

EXT.

F.F.

FTG.

GΑ

G.F.I.

GYP.

G.W.B.

FIN.FLR.

F.A.C.P.

DRINKING FOUNTAIN

**ELECTRICAL CONTRACTOR** 

FIRE ALARM CONTROL PANEL

FIRE EXTINGUISHER CABINET

GENERAL CONTRACTOR

GYPSUM WALL BOARD

**HEATING CONTRACTOR** 

GROUND FAULT INTERRUPTER

HEATING, VENTILATION & AIR CONDITIONING

**DUCTILE IRON PIPE** 

EACH WAY

ELECTRICAL

**ELEVATION** 

ELEVATION

**EQUIPMENT** 

EXISTING

EXPOSED

**EXTERIOR** 

FOOTING

GAUG

**EXHAUST FAN** 

EXPANSION

FINISH FLOOR

FINISH FLOOR

EXPANSION JOINT

**CONTRACTOR:** 

SHAWN MCHUGH


52 NORTH MAIN ST. HONEOYE FALLS, NEW YORK 14472 (585)-905-1819

**OWNER:** 

HAMANN FAMILY

PITTSFORD, NY 14534

323 EAST ST.

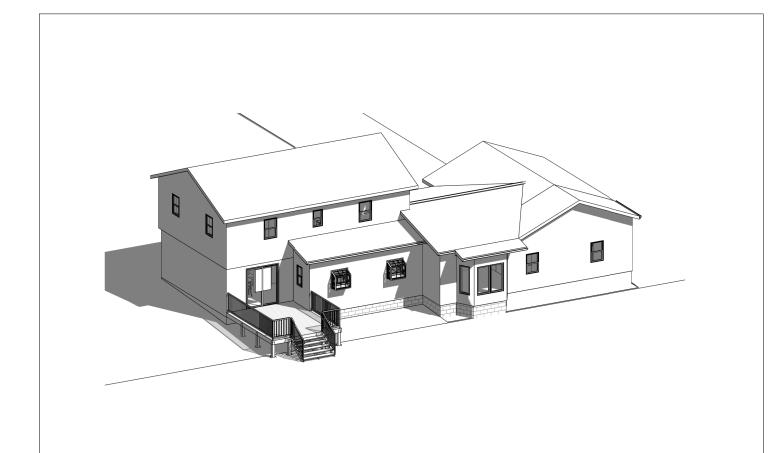

## **DEFINITIONS**

NOTE: ALL DEFINITIONS NOT NECESSARILY USED

ARE NOT ALLOWED, UNLESS SPECIFICALLY INDICATED.

"SUPPLY" OR ITS DERIVATIVE, MEANS: PURCHASE PRODUCT OR MATERIAL AS PART OF THE PROJECT FOR INSTALLATION BY OTHERS

"INSTALL" OR ITS DERIVATIVE, MEANS: FOLLOWING MANUFACTURERS RECOMMENDATIONS, INCORPORATE PRODUCT OR MATERIAL, SUPPLIED BY OTHERS, ALLOWING PRODUCT OR MATERIAL TO PERFORM FULLY AS MANUFACTURER OF PRODUCT OR MATERIAL INTENDED.

"PROVIDE" MEANS: SUPPLY AND INSTALL

"repair": to stabilize, consolidate, or conserve; to retain existing materials and features while employing as little new MATERIAL AS POSSIBLE. REPAIR INCLUDES PATCHING, PIECING-IN, SPLICING, CONSOLIDATING, OR OTHERWISE REINFORCING OR UPGRADING MATERIALS. WITHIN RESTORATION, REPAIR ALSO INCLUDES LIMITED REPLACEMENT OF MATERIALS IN KIND, REHABILITATION, AND RECONSTRUCTION, WITH COMPATIBLE SUBSTITUTE MATERIALS FOR DETERIORATED OR MISSING PARTS OF FEATURES WHEN THERE ARE

"REPLACE": TO DUPLICATE AND REPLACE ENTIRE FEATURES WITH NEW MATERIAL IN KIND. REPLACEMENT INCLUDES THE FOLLOWING

**DUPLICATION**: INCLUDES REPLACING ELEMENTS DAMAGED BEYOND REPAIR OR MISSING. ORIGINAL MATERIAL IS INDICATED AS THE

PATTERN FOR CREATING NEW DUPLICATED ELEMENTS. REPLACEMENT WITH NEW MATERIALS INCLUDES REPLACEMENT WITH NEW MATERIAL WHEN ORIGINAL MATERIAL IS NOT AVAILABLE

AS PATTERS FOR CREATING NEW DUPLICATED ELEMENTS. REPLACEMENT WITH SUBSTITUTE INCLUDES REPLACEMENT WITH COMPATIBLE SUBSTITUTE MATERIALS. SUBSTITUTE MATERIALS

"REMOVE": TO DETACH ITEMS FROM EXISTING CONSTRUCTION AND LEGALLY DISPOSE OF THEM OFF-SITE UNLESS INDICATED TO BE REMOVED AND SALVAGED OR REMOVED AND REINSTALLED.

"REMOVE AND SALVAGE": TO DETACH ITEMS FROM EXISTING CONSTRUCTION AND DELIVER THEM TO OWNER READY FOR REUSE.


"REMOVE AND REINSTALL": TO DETACH ITEMS FROM EXISTING CONSTRUCTION, REPAIR AND CLEAN THEM FOR REUSE, AND REINSTALL

THEM WHERE INDICATED.

"EXISTING TO REMAIN" OR "RETAIN": EXISTING ITEMS OF CONSTRUCTION THAT ARE NOT TO BE REMOVED AND THAT ARE NOT OTHERWISE INDICATED TO BE REMOVED AND SALVAGED, OR REMOVED AND REINSTALLED.

"MATERIAL IN KIND": MATERIAL THAT MATCHES EXISTING MATERIALS, AS MUCH AS POSSIBLE, IN SPECIES, CUTE, COLOR, GRAIN AND FINISH.

## SYMBOLS & MATERIAL LEGEND

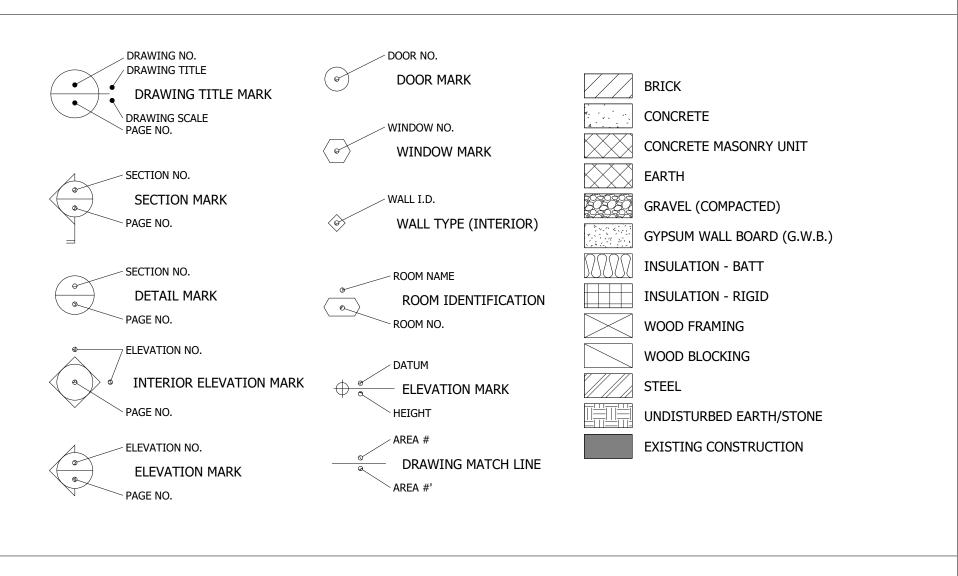

ALL INTELLECTUAL AND OTHER RIGHTS ARE RESERVED, INCLUDING BUT NOT LIMITED TO COPYRIGHT.

**ABBREVIATIONS** 

NOTE: ALL ABBREVIATIONS NOT NECESSARILY USED

HOLLOW METAL ABOVE FINISH FLOOR HORIZ. HORIZONTAL ABSORB. **ABSORPTIVE** H.W. **HOT WATER ACCESS PANEL** HOUR ACOUST. **ACOUSTICAL** H.S. HOSPITAL STOP A.C.T. ACOUSTICAL CEILING TILE ADH. **ADHESIVE INSULATED METAL ADJUST** I.M **ADJUSTABLE** INSULATION OR INSULATED **AGGR AGGREGATE** INT. INTERIOR A.C INVERT **ALTERATION** ISO. ISOLATION ALTN. ALTERNATE JANITOR'S CLOSET ALUM. ALUMINU APPD. **APPROVED** LAM LAMINATE APPROX. **APPROXIMATE** LAV. LAVATORY ARCH. ASB. MAGNETIC DOOR HOLDER ASPH. **ASPHALT** AUTO. MANHOLE AUTOMATIC MANUFACTURER AVG **AVERAGE** MAXIMU BLOCK **MECHANICA** BOARD C.I.P. CAST IRON PIPE MINIMU C.B. CATCH BASIN MISCELLANEOUS CEM **NOT IN CONTRACT** CERAMIC MOSAIC TILE N.T.S. NOT TO SCALE C.T. CERAMIC TILE O.C ON CENTER C.O **CLEANOUT** OPP. **OPPOSITE** CLO CLOSET O.H. **OVERHEAD** C.W. COLD WATER COL PR. COLUM CONC PLAS. PLASTER CONCRETE PLAS.LAM PLASTIC LAMINATE C.M.U CONCRETE MASONRY UNIT PLUMBING CONTRACTOR P.C. CONT. CONTINUOUS PLYWD. PLYWOOD COORD COORDINATE POLY. POLYETHYLENE CORR. CORRIDOR P.V.C. POLYVINYL CHLORIDE C.M.P CORRUGATED METAL PIPE PRE-FAB. PREFABRICATED CRS. COURSES REFRIGERATOR DIA. DIAMETER R.C.P. REINFORCED CONCRETE PIPE DIM DIMENSION REINFORCEMENT DR. D.S. DOWNSPOUT RUN OF BANK DWG DRAWING

R.O.B. SCHED. SCHEDULE SIMILAR SOLID CORE SQUARE **SQUARE FOOT** STAINLESS STEEL STEEL STOR. STORAGE STR. STRUCTURAL **TELEPHONE** TONGUE & GROOVE T.O. TOP OF T.G. TOP OF GRATE T.O.S. TOP OF STEEL TYP. TYPICAL U.N.O. UNLESS NOTED OTHERWISE VAPOR BARRIER V.B. VERT. VERTICAL **VESTIBULE** VINYL COMPOSITION TILE WATER HEATER WELDED WIRE FABRIC WITHOUT WOO

## **DRAWING INDEX**

STRUCTURAL / ARCHITECTURAL

CS **COVER SHEET** STRUCTURA

GENERAL

A401

A701

S001 STRUCTURAL NOTES AND DETAILS S002 FIRST FLOOR FRAMING PLAN S003 ROOF FRAMING PLAN S004 WALL DETAILS AND NOTES

**ARCHITECTURAL** D100 DEMOLITION FLOOR PLANS AND ROOF PLAN DEMOLITION ELEVATIONS D200 A100 FOUNDATION PLAN

A101 FIRST FLOOR PLAN SECOND FLOOR PLAN A103 ROOF PLAN A200 **EXTERIOR ELEVATIONS BUILDING SECTIONS** A301 WALL SECTIONS WALL DETAILS

> STAIR & DECK DETAILS FIRST FLOOR REFLECTED CEILING PLAN ENLARGED PLANS AND ELEVATIONS DOOR & WINDOW SCHEDULES

- 2. G.C. SHALL INVESTIGATE SITE AND VERIFY ALL DIMENSIONS AND CONDITIONS AND NOTIFY ARCHITECT OF ANY DISCREPANCIES PRIOR TO PROCEEDING WITH WORK.
- LANDLORD, G.C. AND EACH SUBCONTRACTOR SHALL NOT COMMENCE WORK UNDER THIS CONTRACT UNTIL THEY HAVE PROVIDED PROOF OF INSURANCE IN SUCH AMOUNTS AS WILL PROVIDE ADEQUATE PROTECTION FOR THE OWNER, THE ARCHITECT, THE MEMBERS THEREOF AND THEIR SUCCESSORS, ALL AGENTS, OFFICERS AND SERVANTS OF THE OWNER AND THE G.C. AND SUBCONTRACTOR AGAINST ALL CLAIMS, LIABILITIES, DAMAGES AND ACCIDENTS. SUCH INSURANCE SHALL REMAIN IN FORCE THROUGHOUT THE LIFETIME OF THIS CONTRACT. SEE PROJECT MANUAL FOR MORE INFORMATION.
- OF THE WORK AND SHALL CROSS-CHECK ALL SHOP DRAWINGS, SPECIFICATIONS AND INSTALLATIONS. EACH CONTRACTOR SHALL COORDINATE THEIR WORK WITH ALL ADJACENT WORK AND SHALL COORDINATE WITH ALL TRADES. EACH TRADE SHALL AFFORD ALL OTHER TRADES EVERY REASONABLE OPPORTUNITY FOR THE INSTALLATION OF THEIR WORK AND FOR THE STORAGE OF THEIR MATERIAL. EACH TRADE SHALL BE FAMILIAR WITH THE ENTIRE PROJECT AND HAVE THEIR WORK

- 10. G.C. SHALL KEEP PROJECT SITE FREE OF DEBRIS AND MAKE FINAL CLEAN UP TO THE SATISFACTION OF THE OWNER. G.C. SHALL BE RESPONSIBLE FOR REMOVAL OF ALL CONSTRUCTION DEBRIS FROM PROJECT SITE AND SHALL PROVIDE DUMPSTERS AS REQUIRED. REMOVE ALL DEBRIS ON A DAILY BASIS.
- 11. G.C. IS RESPONSIBLE FOR SECURING ALL PERMITS REQUIRED BY THE LOCAL
- 12. G.C. TO PROVIDE SUBMITTALS FOR ALL FINISHES, AND SHOP DRAWINGS, FOR
- COLLECT WASTE DAILY AND DISPOSE OF WASTE OFF-SITE ACCORDING TO LOCAL ORDINANCES, WHEN CONTAINERS ARE FULL. IT IS NOT KNOWN HETHER HAZARDOUS MATERIALS WILL BE ENCOUNTERED IN THE WORK. IF SUCH MATERIALS ARE ENCOUNTERED, DISPOSE OF THE MATERIALS ACCORDINGLY TO APPLICABLE LAWS AND REGULATIONS.
- PROVIDE PRODUCTS OF SAME KIND FROM A SINGLE SOURCE. DELIVER, STORE AND HANDLE PRODUCTS ACCORDING TO THE MANUFACTURERS WRITTEN INSTRUCTIONS, USING MEANS AND METHODS THAT WILL PREVENT DAMAGE, DETERIORATION, AND

TYPICAL CAULKING - CLEAN & PRIME SUBSTRATE PER MFR'S RECOMMENDATIONS. INSTALL CLOSED CELL BACKER ROD & MASK JOINT. APPLY SILICONE CAULK TO MFR'S INSTRUCTIONS, RECOMMENDED DEPTH TO BONDING RATIO. ALL JOINTS SHALL BE TOOLED CONCAVE, TYPICAL AT ALL CAULK APPLICATIONS.

CONTRACTOR(S) WILL BE RESPONSIBLE TO REPAIR ANY DAMAGE TO THE

## **GENERAL CONTRACTOR NOTES**

GENERAL CONTRACTOR (G.C.) IS RESPONSIBLE FOR ALL REQUIREMENTS FOR
LOCAL CODES & ORDINANCES. ALL GENERAL CONSTRUCTION WORK SHALL
COMPLY WITH GOVERNING CODES AS ADMINISTERED BY THE LOCAL BUILDING
OFFICIALS AND SHALL BE CONSIDERED AS A PART OF THESE CONSTRUCTION
DOCUMENTS.

- G.C. SHALL INVESIGATE SITE AND NOTIFY ARCHITECT & OWNER OF ANY FIELD CONDITIONS NOT NOTED ON THE DRAWINGS.
- ALL WORK PERFORMED AS A PART OF THIS CONTRACT IS TO BE GUARANTEED BY THE G.C. AND SUBCONTRACTORS TO BE FREE FROM DEFECTS ON MATERIAL AND WORKSMANSHIP FOR A PERIOD OF (1) YEAR FROM THE DATE OF COMPLETION OF THE WORK. THE G.C. AND SUBCONTRACTORS AGREE TO RETURN TO THE JOB AND MAKE REPAIRS AND REPLACEMENTS TO SUCH DEFECTS AT NO COST TO THE OWNER.
- ALL SUBCONTRACTORS SHALL BE RESPONSIBLE FOR REVIEWING ALL DRAWINGS AND SPECIFICATIONS FOR THE COORDINATION OF THEIR WORK. ANY DISCREPANCIES SHALL BE REPORTED TO THE OWNER BEFORE FINALIZING BIDS AND COMMENCING
- THE G.C. SHALL ASSUME FULL RESPONSIBILITY FOR THE COORDINATION OF ALL PARTS RELATE TO THE JOB IN TOTAL.
- 8. MAINTAIN ACCESS TO EXITS AND EXIT STAIRS AT ALL TIMES. FIRE ALARM AND SMOKE DETECTOR SYSTEMS SHALL REMAIN OPERATIONAL. PROTECT SMOKE DETECTORS AS
- 9. PROVIDE TEMPORARY PARTITIONS/ DUST PROTECTION AT THE DOORS.
- GOVERNING JURISDICTIONS.
- REVIEW AND APPROVAL BY OWNER AND ARCHITECT.

GROUNDS OR THE BUILDING CAUSED BY THEIR PERSONNEL OR EQUIPMENT.

DRAWING ALTERATION

THE FOLLOWING IS AN EXCERPT FROM


145, SECTION 7209, SPECIAL PROVISIONS. VIOLATION OF THIS LAW FOR ANY SUCH ALTERATION, AND A SPECIFIC DESCRIPTION OF THE ALTERATION'

> WOLFE ARCHITECTURE ALL RIGHTS RESERVED

<u>REVISIO</u>	REVISIONS:		
MARK	DESCRIPTION	DAT	
$\triangle$			



Honeoye Falls, NY 14472 Phone: (585) 582-6277 www.WolfeArchitecture.com

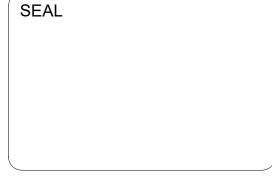

**OWNER:** MR & MRS HAMANN

PROJECT:

Hamann Residence

LOCATION:

323 EAST ST. PITTSFORD, NY 14534

DATE:	7/20/202	20 1:53:07 PM
ARCHITEC	CT:	RHW
DRAWING BY:		Author
JOB NUMBER:		19-117
FILE: W:\Projects\19-117 Hamann Residence\3 Drawings\20 07		dence\3 Drawings\20 07
DRAWING	•	

**COVER SHEET** 

SHEET NUMBER:

#### **GENERAL NOTES:**

- DESIGN AND CONSTRUCTION SHALL CONFORM TO THE RESIDENTIAL BUILDING CODE OF NEW YORK STATE 2020
- LIVE LOADS: ALL ELEVATED FLOORS = 40PSF

SNOW LOADS:

Pg = 40psf Ce = 1.0 Is = 1.0Psloped = 31psf

**FOUNDATION AND FLOOR SLAB NOTES:** 

4. WIND LOADS

### V = 115mph

- FOOTING DESIGN IS BASED ON A PRESUMPTIVE SOIL BEARING CAPACITY OF 1,500psf. VERIFY SOIL CONDITION PRIOR
- TO CONSTRUCTION. CONTRACTOR SHALL VERIFY EXISTING BELOW GRADE UTILITIES.
- EXCAVATION FOR FOUNDATION SHALL BE TAKEN TO FIRM UNDISTURBED SOIL, DRY AND FREE FROM FROST OR LOOSE MATERIAL.
- BACKFILL BELOW GRADE SHALL BE WELL GRADED SAND AND GRAVEL OR CRUSHER RUN STONE HAVING A MAXIMUM SIZE OF 3" AND NO MORE THAN 10% PARTICLES PASSING THE #200 SIVE. BACKFILL SHALL BE PLACED IN 6" TO 8" LIFTS. EACH LIFT SHALL BE COMPACTED TO AT LEASE 95% OF MAXIMUM DENSITY AS DETERMINED BY THE MODIFIED PROCTOR METHOD.
- ALL PIPING SLEEVES THROUGH FOUNDATION WALLS AND FOOTING STEPS TO ACCOMMODATE PIPING SHALL BE COORDINATED WITH THE PLUMBING CONTRACTOR/DRAWINGS.
- CONCRETE COVER FOR REINFORCEMENT:

CONCRETE CAST AGAINST EARTH...

- CONCRETE EXPOSED TO WEATHER OR EARTH.....2"
- BOTTOM OF ALL FOOTINGS SHALL BE A MINIMUM OF 4'-0" BELOW GRADE EXCEPT WHERE FIELD CONDITIONS
- REQUIRE AN ADJUSTMENT.
- REFERENCE ARCHITECTURAL AND PLUMBING PLANS FOR SLOPED FLOOR SLABS. ALL SLABS TO MAINTAIN FULL
- NO BACKFILLING OF FOUNDATION WALLS TO BE DONE UNLESS WALLS ARE ADEQUATELY BRACED OR FILLING IS
- 10. PROVIDE CORNER BARS TO MATCH HORIZONTAL REINFORCING IN ALL WALLS AND FOOTINGS.

#### **MASONRY NOTES:**


- CONCRETE MASONRY SHALL CONFORM TO THE REQUIREMENTS OF ACI 530-05, AND ACI 350.1-50
- CONCRETE MASONRY UNITS SHALL CONFORM TO ASTM C-90, TYPE 1, GRADE N, MOISTURE CONTROLLED UNITS. MORTAR SHALL BE TYPE M OR S. PROVIDE GALVANIZED HORIZONTAL JOINT REINFORCING AT 16"O.C. UNLESS
- GROUT FOR FILLING BLOCK CORES SHALL CONFORM TO ASTM C476 WITH A MINIMUM COMPRESSIVE STRENGTH OF 3,000psi AT 28 DAYS. GROUT SHALL BE PLACED IN LIFTS NOT EXCEEDING 7 COURSES IN HEIGHT UNLESS OTHERWISE APPROVED BY THE ENGINEER.
- LAP SPLICES IN VERTICAL REINFORCING FOR CONCRETE BLOCK MASONRY WALLS AND PILASTERS SHALL BE A MINIMUM OF 48 BAR DIAMETERS UNLESS DETAILED OTHERWISE ON THE DRAWINGS.


#### **CONCRETE NOTES:**

- CONCRETE DESIGN AND CONSTRUCTION SHALL CONFORM TO ACI 318-05 AND ACI 301-05.
- MINIMUM COMPRESSIVE STRENGTH AT 28 DAYS SHALL BE: 4000PSI
- REINFORCING STEEL SHALL CONFORM TO ASTM A615, GRADE 60. WELDED WIRE FABRIC SHALL CONFORM TO ASTM A185, AND SHALL BE SUPPLIED IN SHEETS ONLY.
- THE REINFORCING STEEL CONTRACTOR SHALL FABRICATE ALL REINFORCEMENT AND FURNISH ALL ACCESSORIES, CHAIRS, SPACER BARS AND SUPPORTS NECESSARY TO SECURE THE REINFORCEMENT UNLESS SHOWN OTHERWISE ON THE DRAWINGS.


#### **WOOD NOTES:**


- WOOD CONSTRUCTION SHALL CONFORM TO THE AMERICAN FOREST and PAPER ASSOCIATION'S (AF&PA) NATIONAL DESIGN SPECIFICATIONS. LUMBER SHALL BE #2 HEM-FIR OR BETTER WITH Fb=850 psi, Fv=150 psi AND E=1,300,000
- WOOD IN CONTACT WITH MASONRY, CONCRETE OR EARTH, OR WITHIN 1'-0" OF GRADE OR EXPOSED TO THE EXTERIOR SHALL BE PRESSURE PRESERVATIVE TREATED.
- MICRO-LAM LUMBER AND TRUSS-JOISTS SHALL BE AS MANUFACTURED BY "TRUSS-JOIST, iLEVEL by Weyerhaeuser". BEAMS SHALL BE PROPERLY FASTENED TOGETHER WITH A MINIMUM OF (2)-ROWS OF 16d NAILS PER FOOT. INSTALL PER MANUFACTURERS RECOMMENDATIONS.
- FRAMING ANCHORS AND MISCELLANEOUS METAL DEVICES FOR WOOD FRAMING SHALL BE GALVANIZED STEEL OF AT LEAST 16 GAGE THICKNESS INSTALL IN STRICT ACCORDANCE WITH MANUFACTURER'S RECOMMENDATIONS. USE NAILS SUPPLIED BY OR RECOMMENDED BY THE MANUFACTURER.
- ROOF TRUSSES, INCLUDING DESIGN, CONNECTIONS, BRACING ERECTION AND QUALITY SHALL CONFORM TO THE SPECIFICATIONS AND RECOMMENDATIONS OF NFPA AND THE TRUSS PLATE INSTITUTE (TPI). TEMPORARY AND PERMANENT BRACING SHALL BE IN STRICT ACCORDANCE WITH TPI BWT-76, BRACING WOOD TRUSSES. TRUSS MANUFACTURER'S REPRESENTATIVE SHALL BE ON SITE AS NECESSARY TO INSURE THAT TRUSSES AND BRACING IS INSTALLED PER MANUFACTURER'S SHOP DRAWINGS.
- SUBMIT DESIGN CALCULATIONS AND SHOP DRAWINGS FOR ROOF TRUSSES, PREPARED AND SEALED BY A PROFESSIONAL ENGINEER LICENSED IN THE STATE OF NEW YORK, TO THE ARCHITECT FOR REVIEW BEFORE BEGINNING FABRICATION.
- **SHEATHING NOTES:**
- A. ROOF SHEATHING: 1/2" ADVANTECH SHEATHING FASTEN w/ 10dx214"Lg. NAILS, SPACED @6" O.C. ALONG PANEL EDGES AND 12" O.C. IN PANEL FIELDS.
- FLOOR SHEATHING: 3/4" TONGUE & GROOVE PLYWOOD FASTEN w/ 8dx212"Lg. NAILS, SPACED @6" O.C. ALONG
- PANEL EDGES AND 12" O.C. IN PANEL FIELDS.
- EXTERIOR WALL SHEATHING: 1/2" PLYWOOD, FASTEN w/ 16ga x 3" STAPLES (716" CROWN), SPACED @ 3" O.C. ALONG PANEL EDGES AND 6" O.C. IN PANEL FIELDS. PROVIDE SOLID 2x WOOD BLOCKING AT ALL HORIZONTAL PANEL JOINTS.

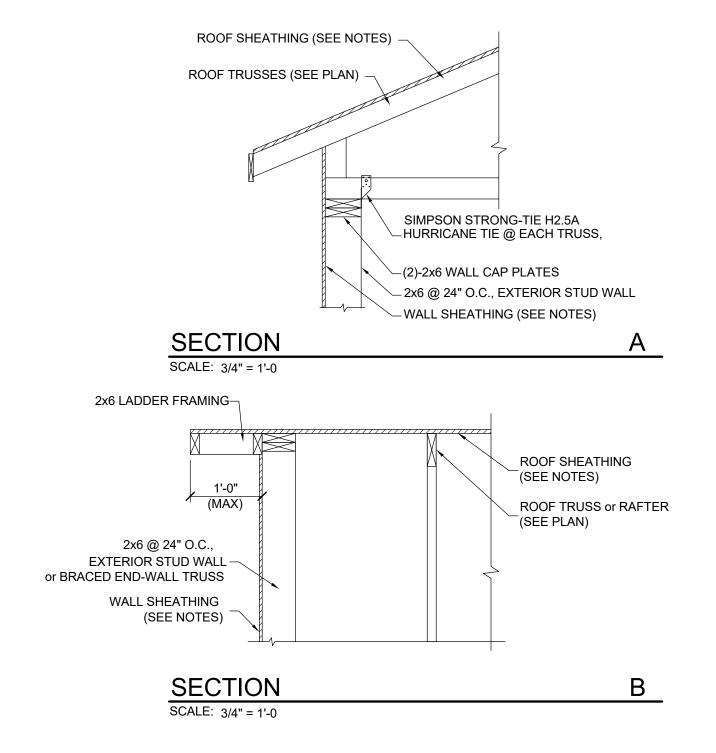

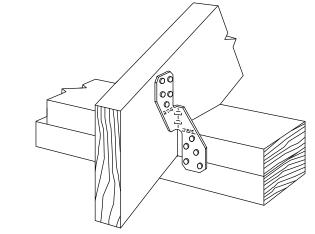

SIMPSON STRONG-TIE H2.5A HURRICANE TIE DETAIL SCALE: N.T.S.

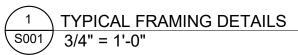

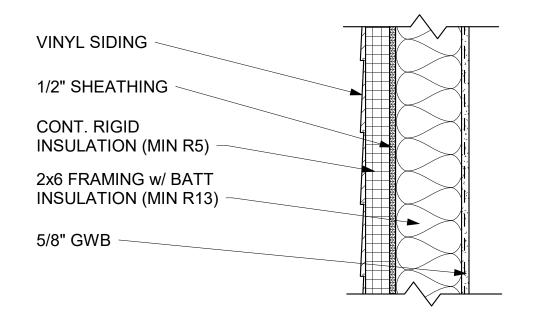

<sup>2</sup> TYP. EXTERIOR WALL DETAIL S001 1 1/2" = 1'-0"




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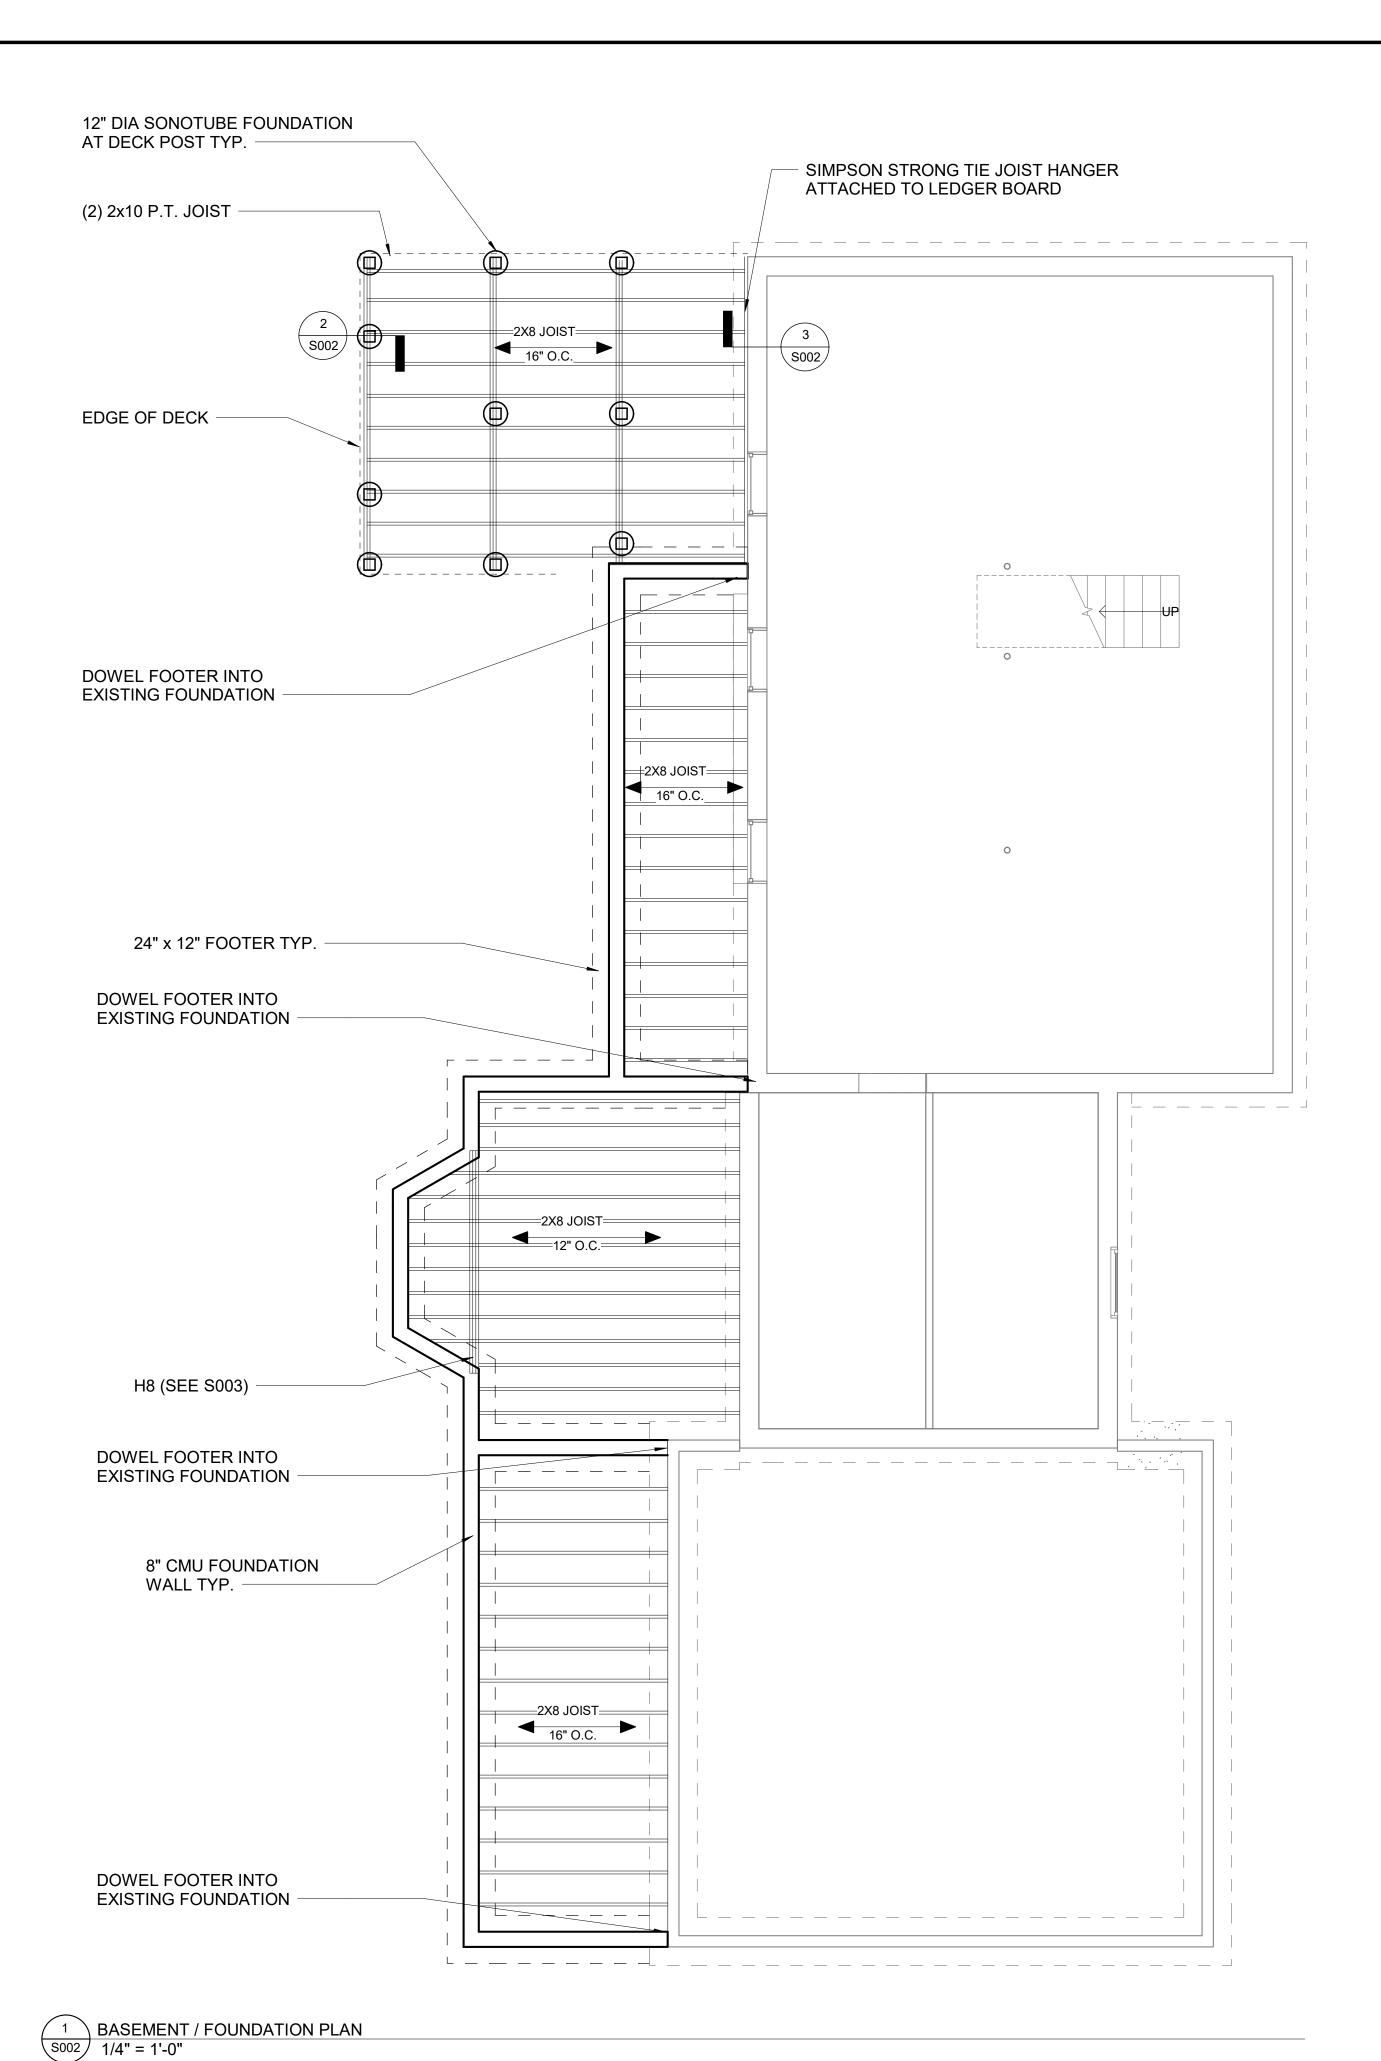
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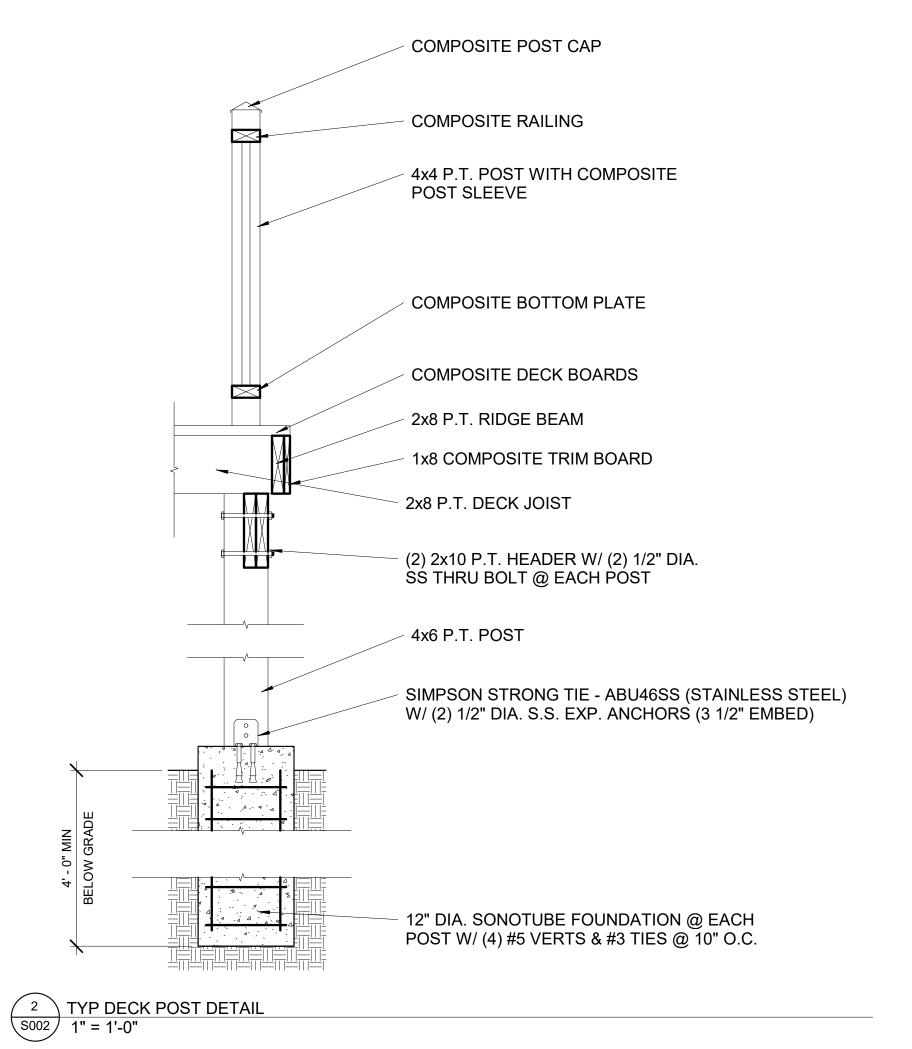
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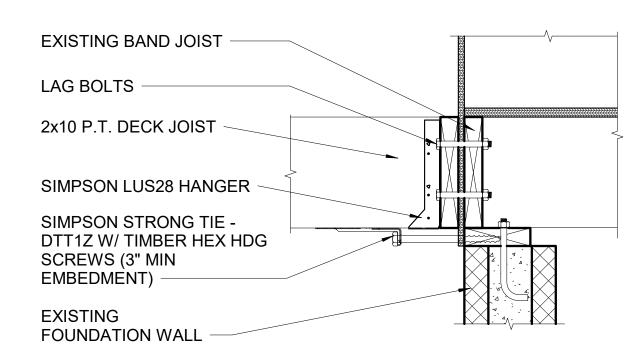
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## STRUCTURAL **NOTES AND DETAILS**

SHEET NUMBER:





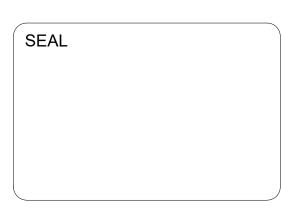

3 LEDGER BOARD DETAIL 8002 1 1/2" = 1'-0" DRAWING ALTERATION


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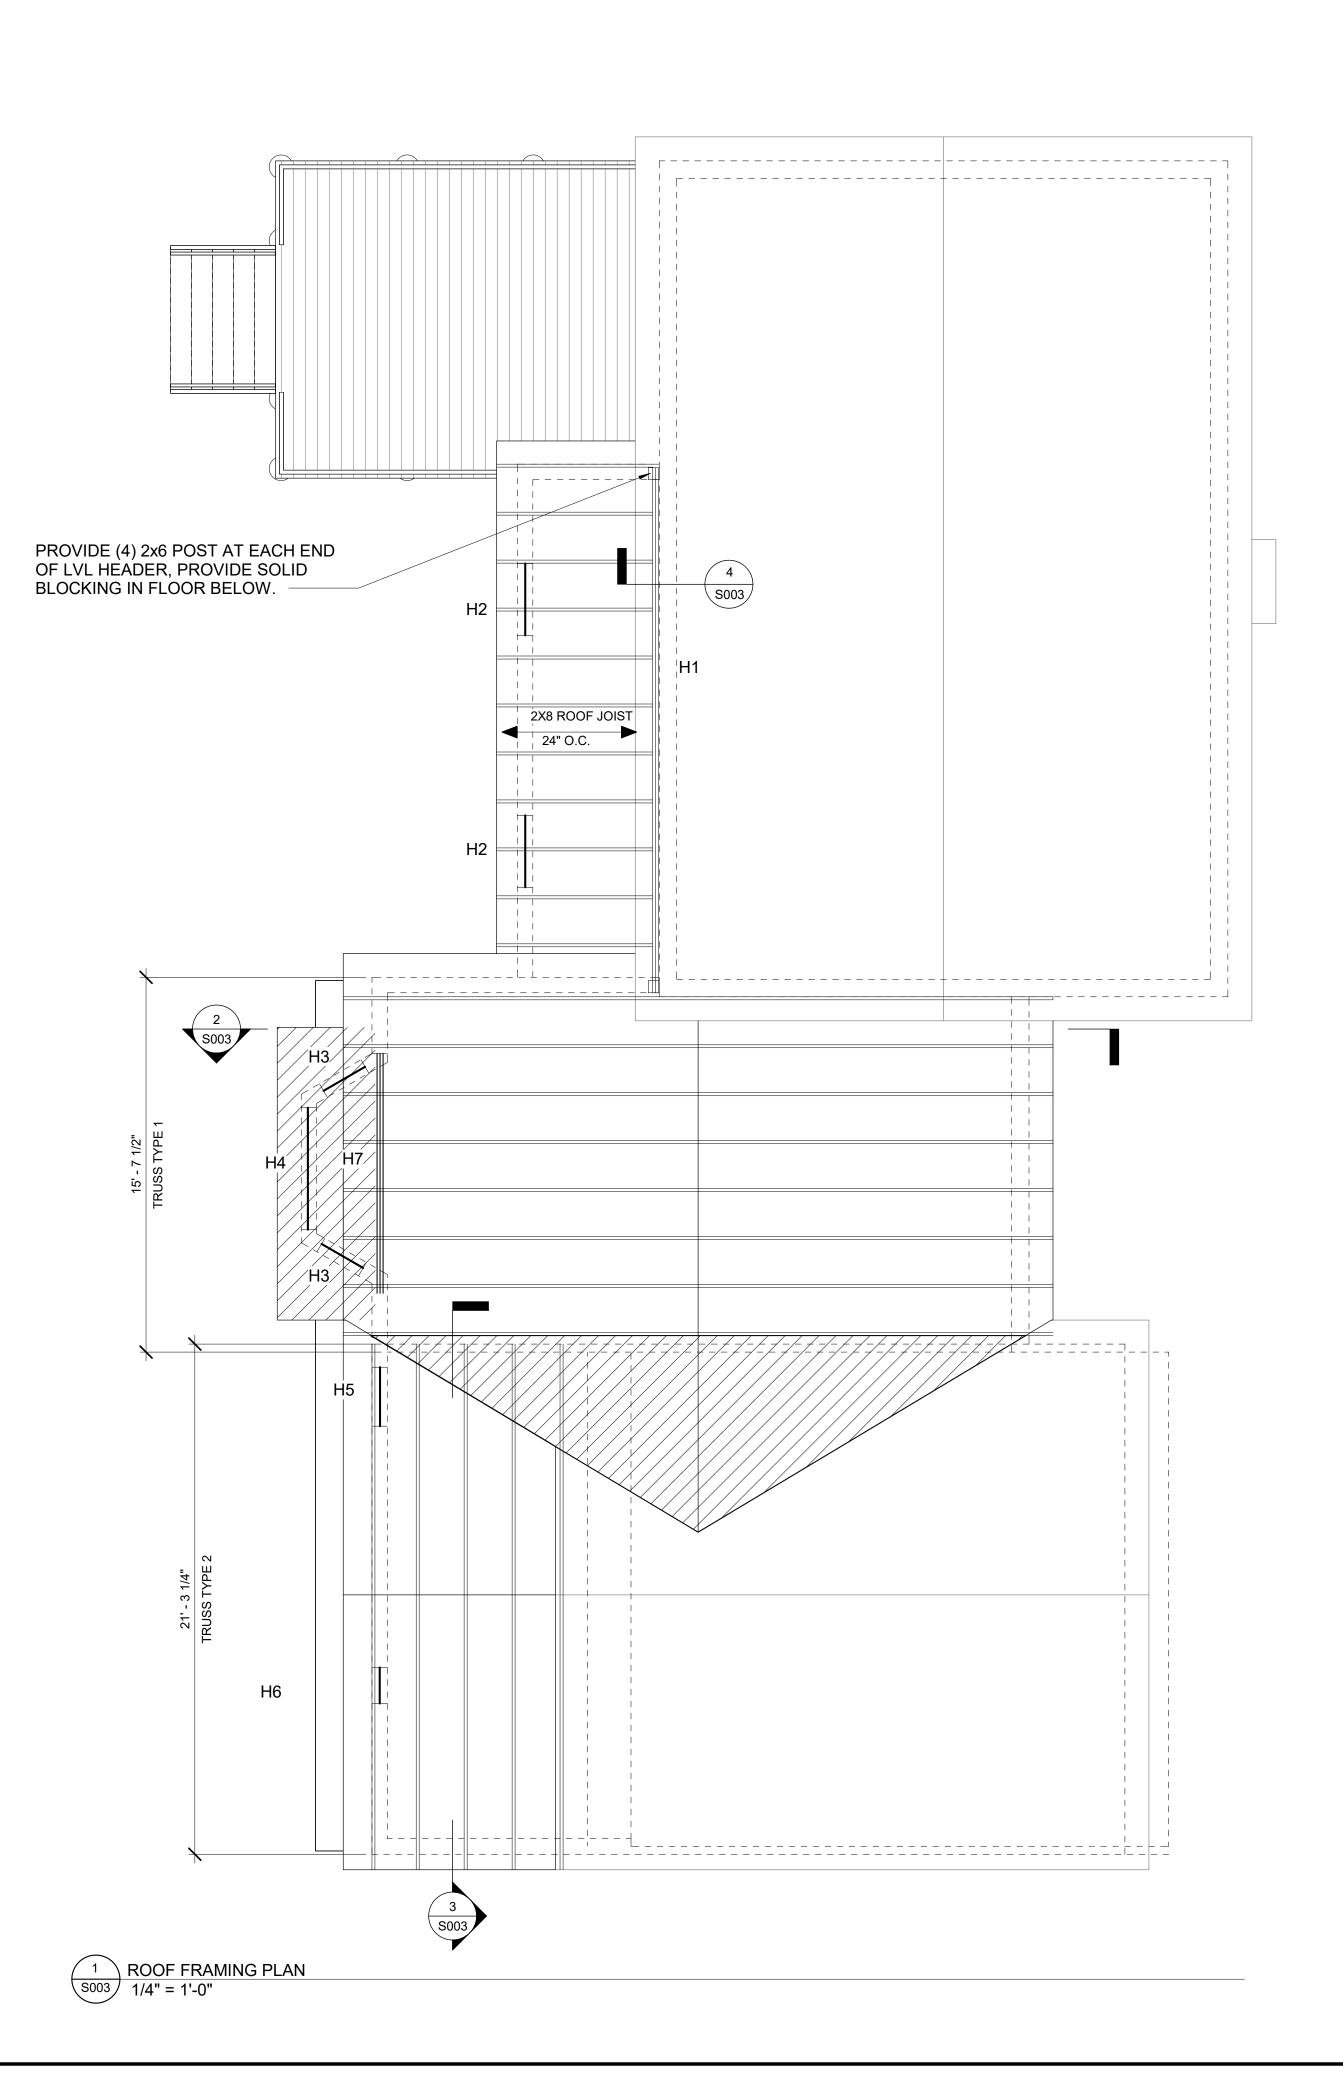
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## FIRST FLOOR FRAMING PLAN

SHEET NUMBER:

S002



#### **ROOF FRAMING NOTES:** 1. ROOF TRUSS LOADS:

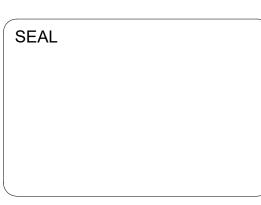TOP CHORD DEAD LOADS: 10psf TOP CHORD LIVE LOADS: 31 psf (SNOW) BOTTOM CHORD DEAD LOADS: 10psf

BOTTOM CHORD LIVE LOADS: 0psf TOP CHORD WIND UPLIFT LOADS: END ZONE: 15.5psf, INT. ZONE: 13psf

2. ALL ROOF TRUSSES SHALL BE DESIGNED FOR AN UNBALANCED SNOW LOAD CONDITION PER ASCE 7-16

3. SEE S001 FOR ROOF, FLOOR AND WALL SHEATHING REQUIREMENTS.

4. SEE S001 FOR STANDARD FLOOR AND ROOF FRAMING DETAILS

5. PROVIDE MINIMUM (1) 2X JACK STUD AND (1) 2X KING STUD AT EACH END OF ALL INTERIOR AND EXTÉRIOR BEARING WALL HEADERS, UNLESS NOTED OTHERWISE ON PLAN.

6. TRUSS SPACING 2' - 0" O.C.


	HEADER SCHEUDLE		
	BEAM	LENGTH	MEMBER
	H1	19' - 0"	(3) 1 3/4 X 18 LVL
	H2	3' - 0"	(2) 2x6
	H3	2' - 0"	(2) 2x6
-	H4	5' - 1"	(2) 2x8
	H5	2' - 6"	(2) 2x6
	H6	1' - 6"	(2) 2x6
	H7	9' - 0"	(2) 9 1/2" LVL
	H8	9' - 2"	(3) 7 1/4" LVL


## **LEDGEND**


---- = ROOF EDGE




= OVER BUILD AREA

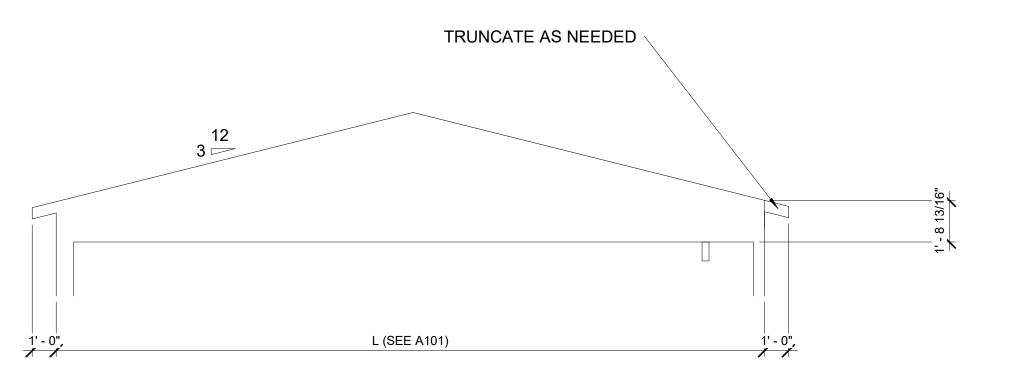

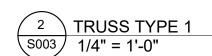

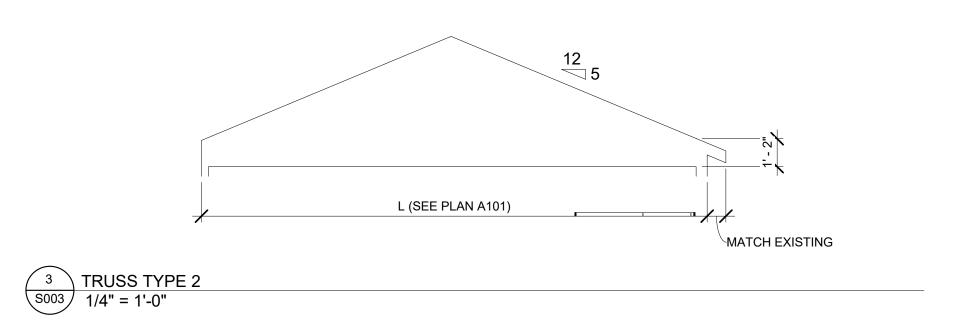

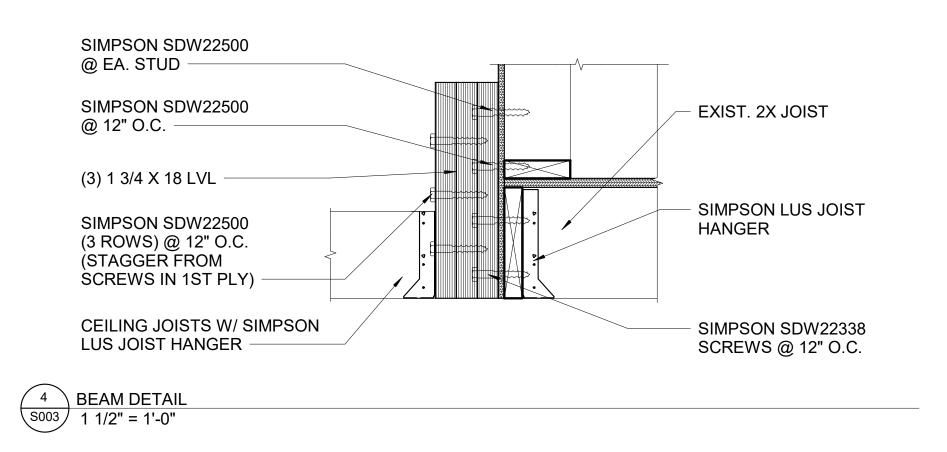

= EXISTING ROOF EDGE



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PROFESSIONAL ARCHITECT, TO ALTER AN

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THE SEAL OF AN ARCHITECT IS ALTERED

THE ALTERING ENGINEER SHALL AFFIX TO

THE ITEM HIS OR HER SEAL AND THE

NOTATION "ALTERED BY" FOLLOWED BY HIS OR HER SIGNATURE AND THE DATE OF

SUCH ALTERATION, AND A SPECIFIC


DESCRIPTION OF THE ALTERATION".

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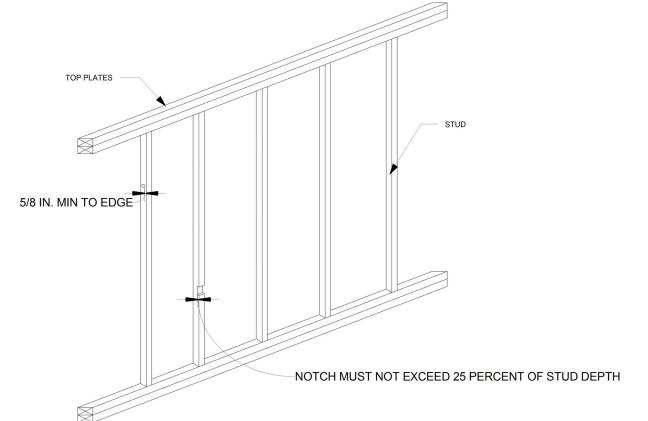
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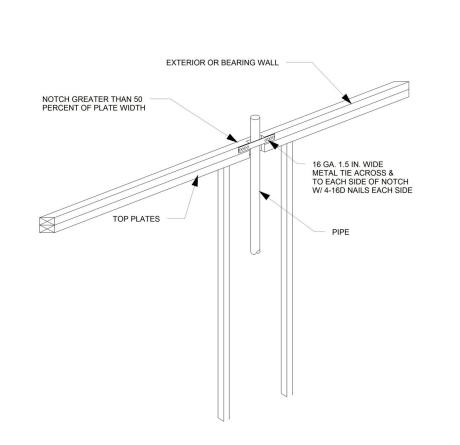
## **ROOF FRAMING** PLAN

SHEET NUMBER:

S003

#### WALL CONSTRUCTION

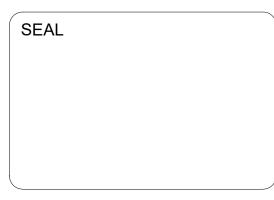



		SPACING	OF FASTENERS
NOMINAL MATERIAL THICKNESS (inches)	(inches)	Edges (inches)	Intermediate supports (inches)
Wood structur	ral panels subfloor, roof and wall sheathing to framing and particl	eboard wall sheathing to	framing <sup>f</sup>
<sup>5</sup> / <sub>16</sub>	0.097 - 0.099 Nail 1 <sup>1</sup> / <sub>2</sub> Staple 15 ga. 1 <sup>3</sup> / <sub>8</sub> Staple 16 ga. 1 <sup>3</sup> / <sub>4</sub>	6	12
	Staple 15 ga. 1 <sup>3</sup> / <sub>8</sub>	6	12
<sup>3</sup> / <sub>8</sub>	0.097 - 0.099 Nail 1 <sup>1</sup> / <sub>2</sub>	4	10
	Staple 16 ga. 1 <sup>3</sup> / <sub>4</sub>	6	12
	Staple 15 ga. 1 <sup>1</sup> / <sub>2</sub>	6	12
$^{15}/_{32}$ and $^{1}/_{2}$	0.097 - 0.099 Nail 1 <sup>5</sup> / <sub>8</sub>	3	6
	Staple 16 ga. 1 <sup>3</sup> / <sub>4</sub>	6	12
$^{19}/_{32}$ and $^{5}/_{8}$	$0.113$ Nail $1^7/_8$ Staple 15 and 16 ga. $1^5/_8$	6	12
	0.097 - 0.099 Nail 1 <sup>3</sup> / <sub>4</sub>	3	6
	Staple 14 ga. 1 <sup>3</sup> / <sub>4</sub>	6	12
$^{23}/_{32}$ and $^{3}/_{4}$	Staple 15 ga. 1 <sup>3</sup> / <sub>4</sub>	5	10
732 4114 74	0.097 - 0.099 Nail 1 <sup>7</sup> / <sub>8</sub>	3	6
	Staple 16 ga. 2	4	8
	Staple 14 ga. 2	5	10
1	0.113 Nail 2 <sup>1</sup> / <sub>4</sub> , Staple 15 ga. 2	4	8
	0.097 - 0.099 Nail 2 <sup>1</sup> / <sub>8</sub>	3 .	6
		SPACING	OF FASTENERS
NOMINAL MATERIAL THICKNESS (inches)	DESCRIPTION <sup>a,b</sup> OF FASTENER AND LENGTH (inches)	Edges (inches)	Body of panel <sup>d</sup> (inches)
	Floor underlayment; plywood-hardboard-particlebo	oard <sup>f</sup>	
	Plywood		
$^{1}/_{4}$ and $^{5}/_{16}$	1 <sup>1</sup> / <sub>4</sub> ring or screw shank nail—minimum 12 <sup>1</sup> / <sub>2</sub> ga. (0.099") shank diameter	3	6
	Staple 18 ga., <sup>7</sup> / <sub>8</sub> , <sup>3</sup> / <sub>16</sub> crown width	2	5
$^{11}/_{32}$ , $^{3}/_{8}$ , $^{15}/_{32}$ and $^{1}/_{2}$	$1^{1}$ / <sub>4</sub> ring or screw shank nail—minimum $12^{1}$ / <sub>2</sub> ga. (0.099) shank diameter	6	8e
$^{19}/_{32}$ , $^{5}/_{8}$ , $^{23}/_{32}$ and $^{3}/_{4}$	$1^{1}/_{2}$ ring or screw shank nail—minimum $12^{1}/_{2}$ ga. (0.099) shank diameter	6	12
	Staple 16 ga. 1 <sup>1</sup> / <sub>4</sub>	6	8
	Hardboard <sup>f</sup>		
	1 <sup>1</sup> / <sub>2</sub> long ring-grooved underlayment nail	6	6
0.200	4d cement-coated sinker nail	6	6
	Staple 18 ga., <sup>7</sup> / <sub>8</sub> long (plastic coated)	3	6
	Particleboard		
1/,	4d ring-grooved underlayment nail	3	6
1/4	4d ring-grooved underlayment nail Staple 18 ga., <sup>7</sup> / <sub>8</sub> long, <sup>3</sup> / <sub>16</sub> crown	3	6
			6
1/ <sub>4</sub>	Staple 18 ga., <sup>7</sup> / <sub>8</sub> long, <sup>3</sup> / <sub>16</sub> crown	3	
	Staple 18 ga., <sup>7</sup> / <sub>8</sub> long, <sup>3</sup> / <sub>16</sub> crown 6d ring-grooved underlayment nail	3 6	6 10

For SI: 1 inch = 25.4 mm.


a. Nail is a general description and may be T-head, modified round head or round head.

b. Staples shall have a minimum crown width of <sup>7</sup>/<sub>16</sub>-inch on diameter except as noted.
 c. Nails or staples shall be spaced at not more than 6 inches on center at all supports where spans are 48 inches or greater. Nails or staples shall be spaced at not more than 12 inches on center at intermediate supports for floors.


d. Fasteners shall be placed in a grid pattern throughout the body of the panel.


e. For 5-ply panels, intermediate nails shall be spaced not more than 12 inches on center each way.

f. Hardboard underlayment shall conform to ANSI/AHA A135.4.

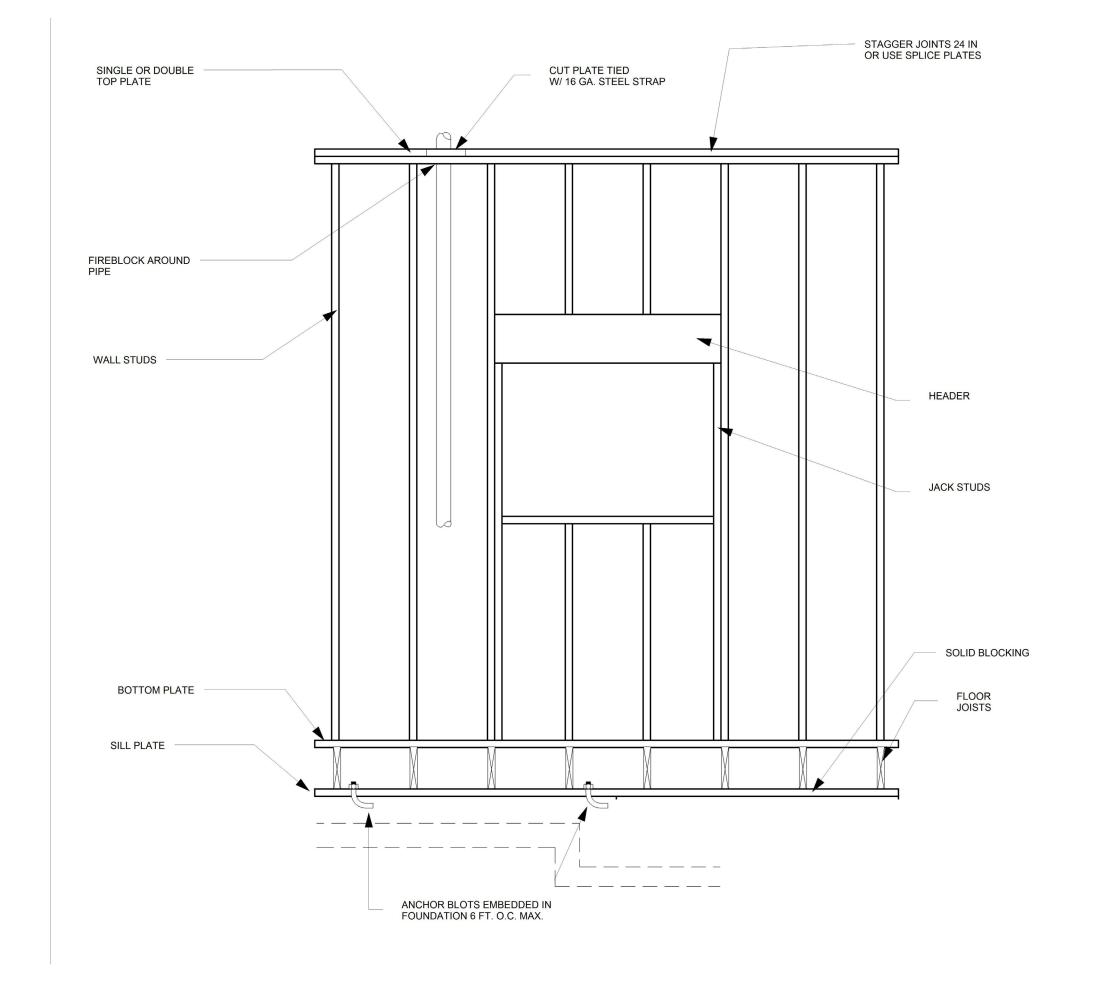

WALL FRAMING DETAIL
12" = 1'-0"

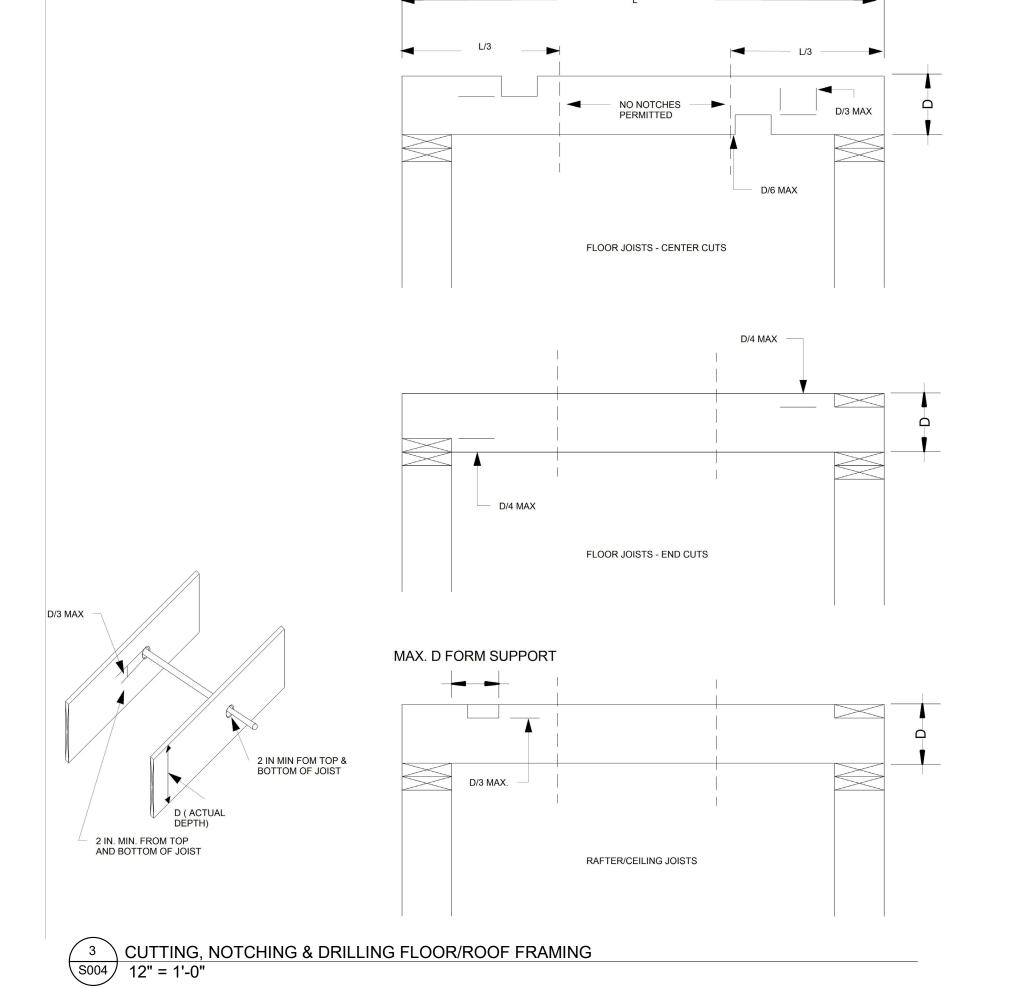

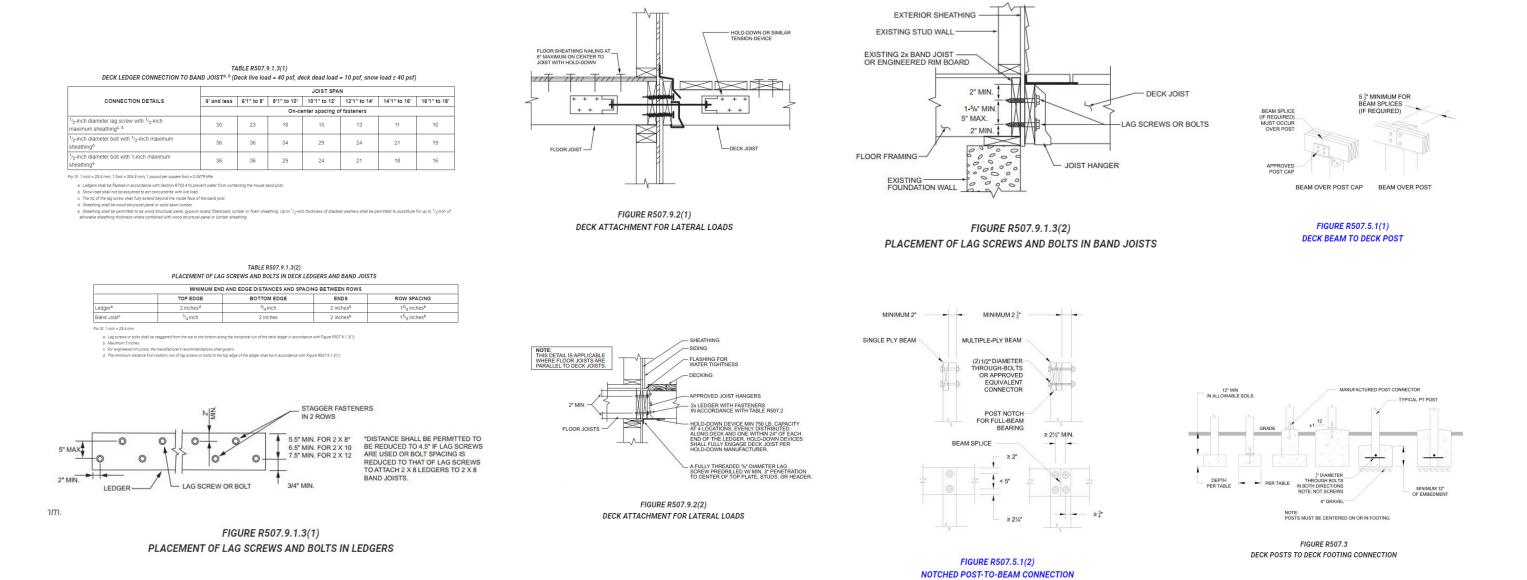

4 DECK/POST LEDGER CONNECTION DETAILS AND TABLES
6" = 1'-0"


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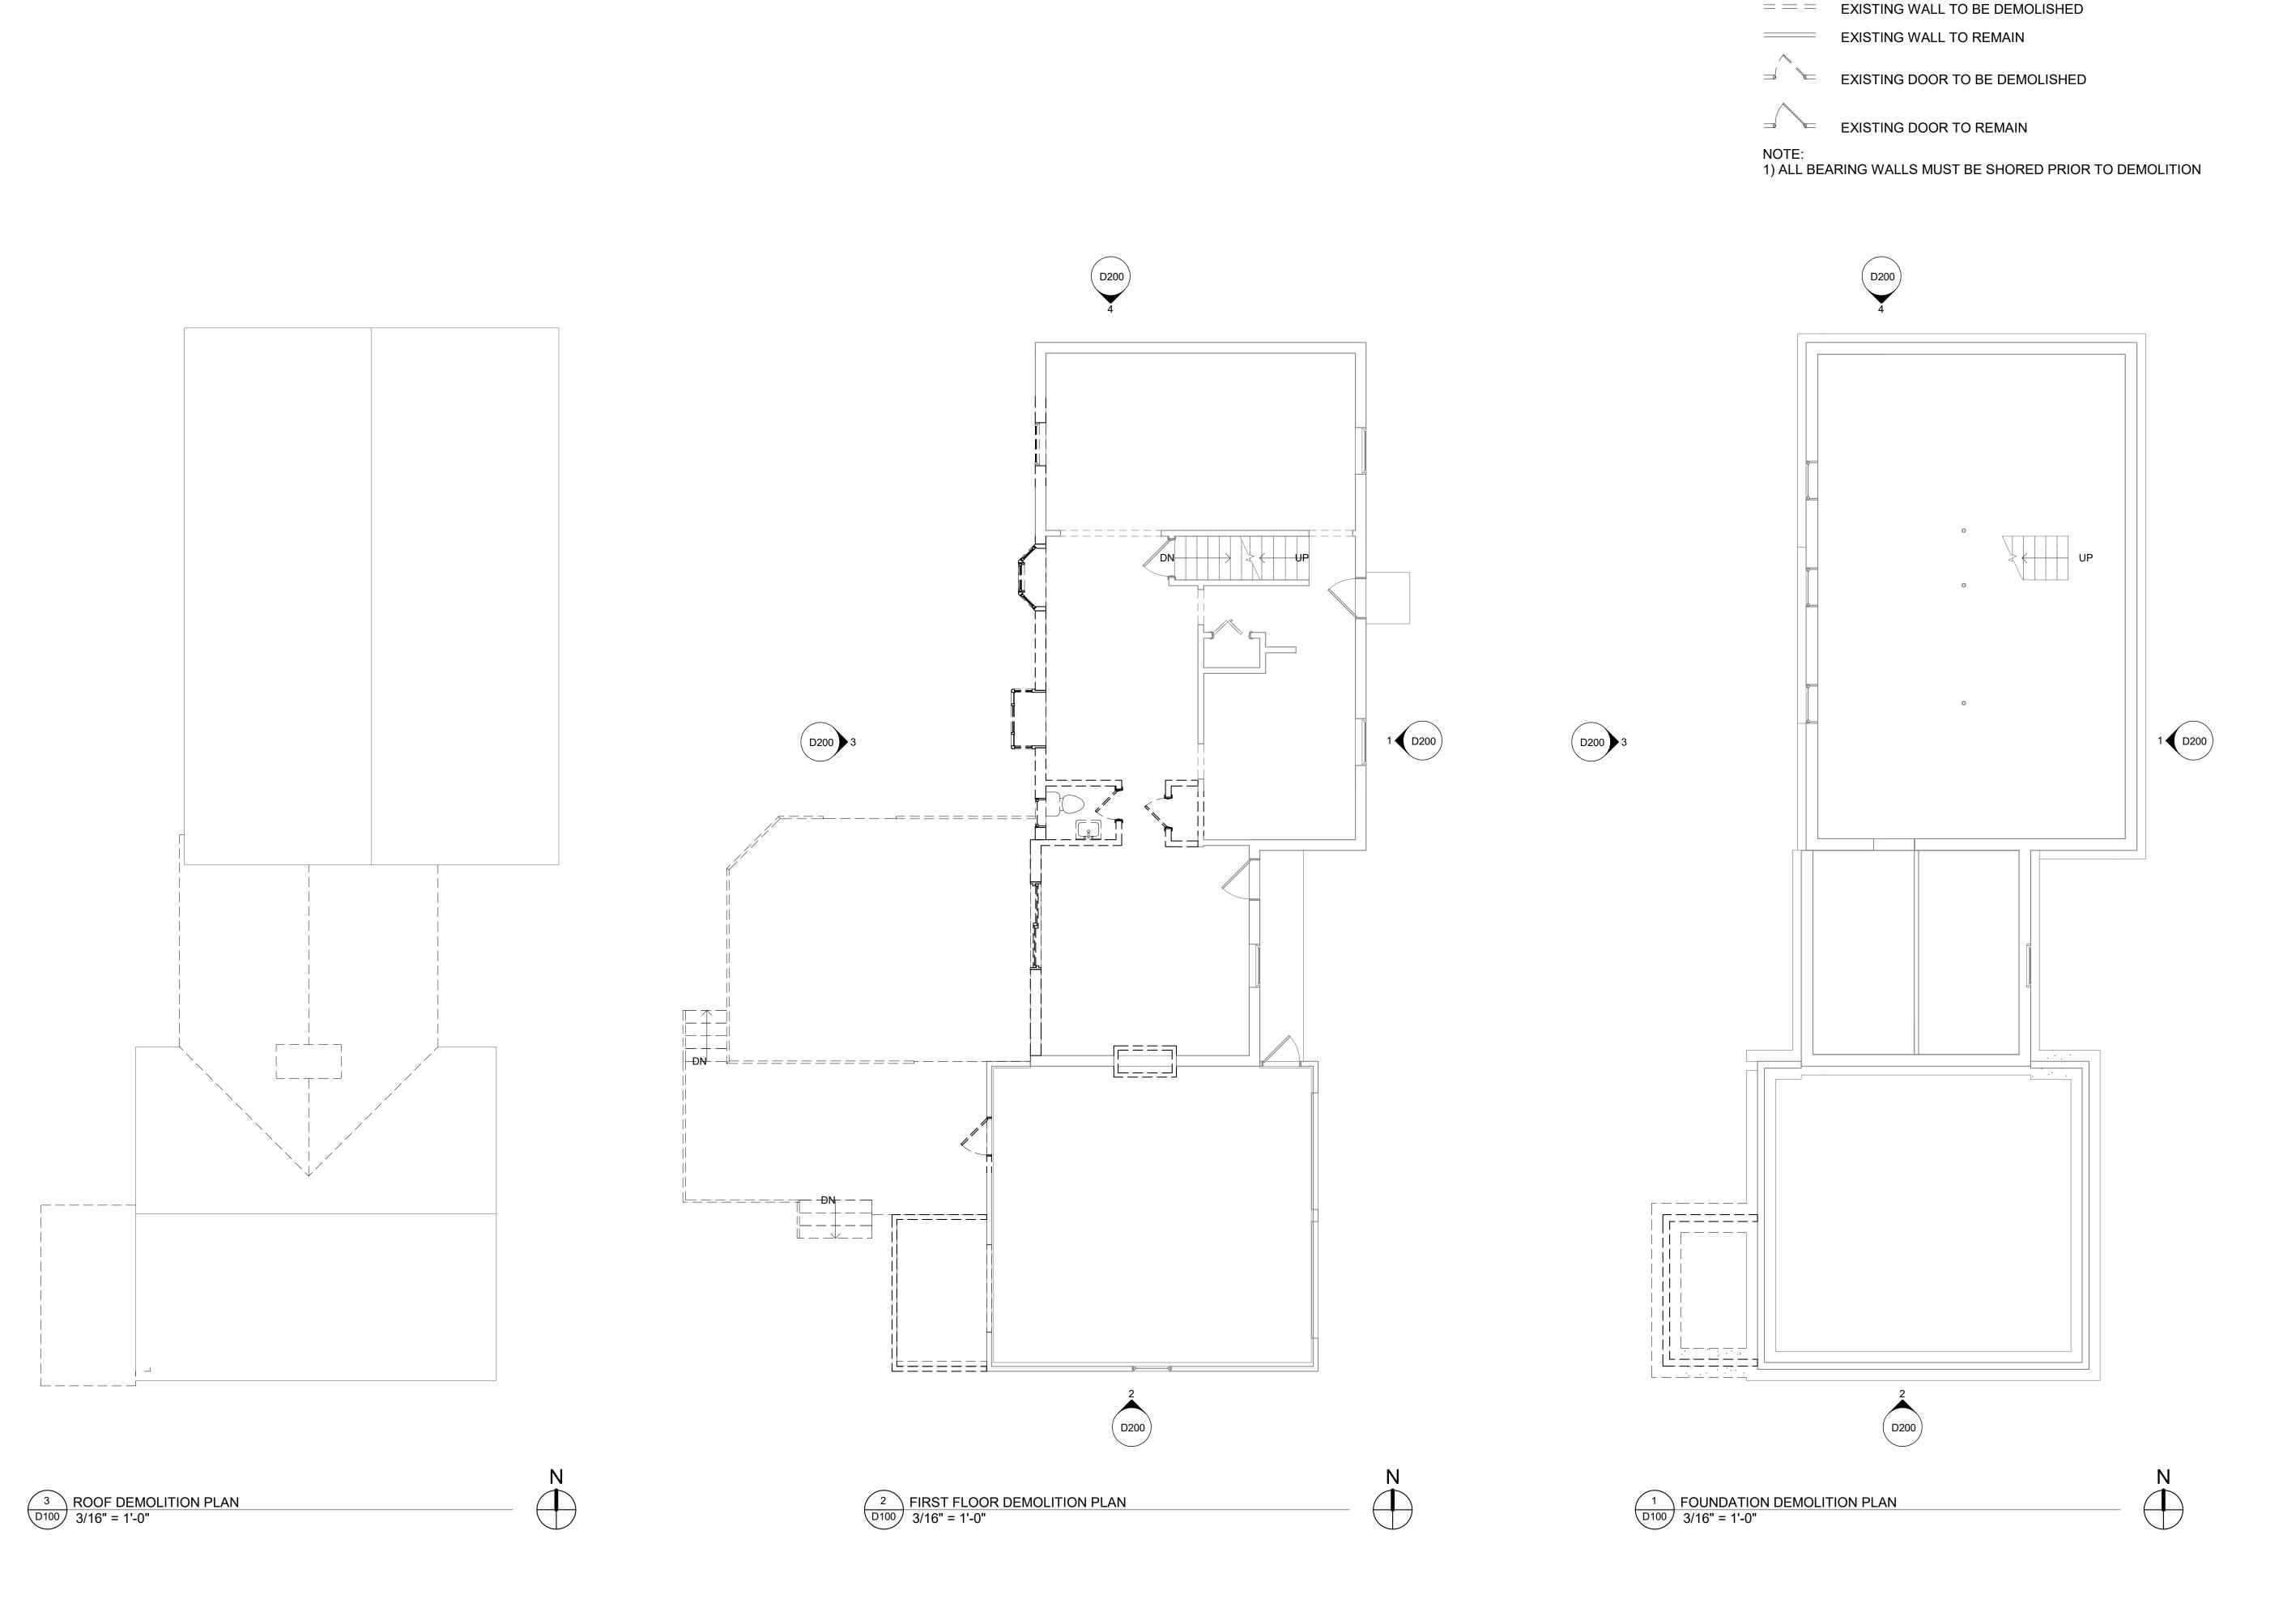
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## WALL DETAILS AND NOTES

SHEET NUMBER:

S004



DEMOLITION LEGEND

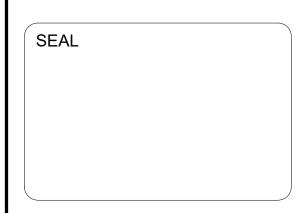
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DEMOLITION
FLOOR PLANS
AND ROOF PLAN

SHEET NUMBER:

D100




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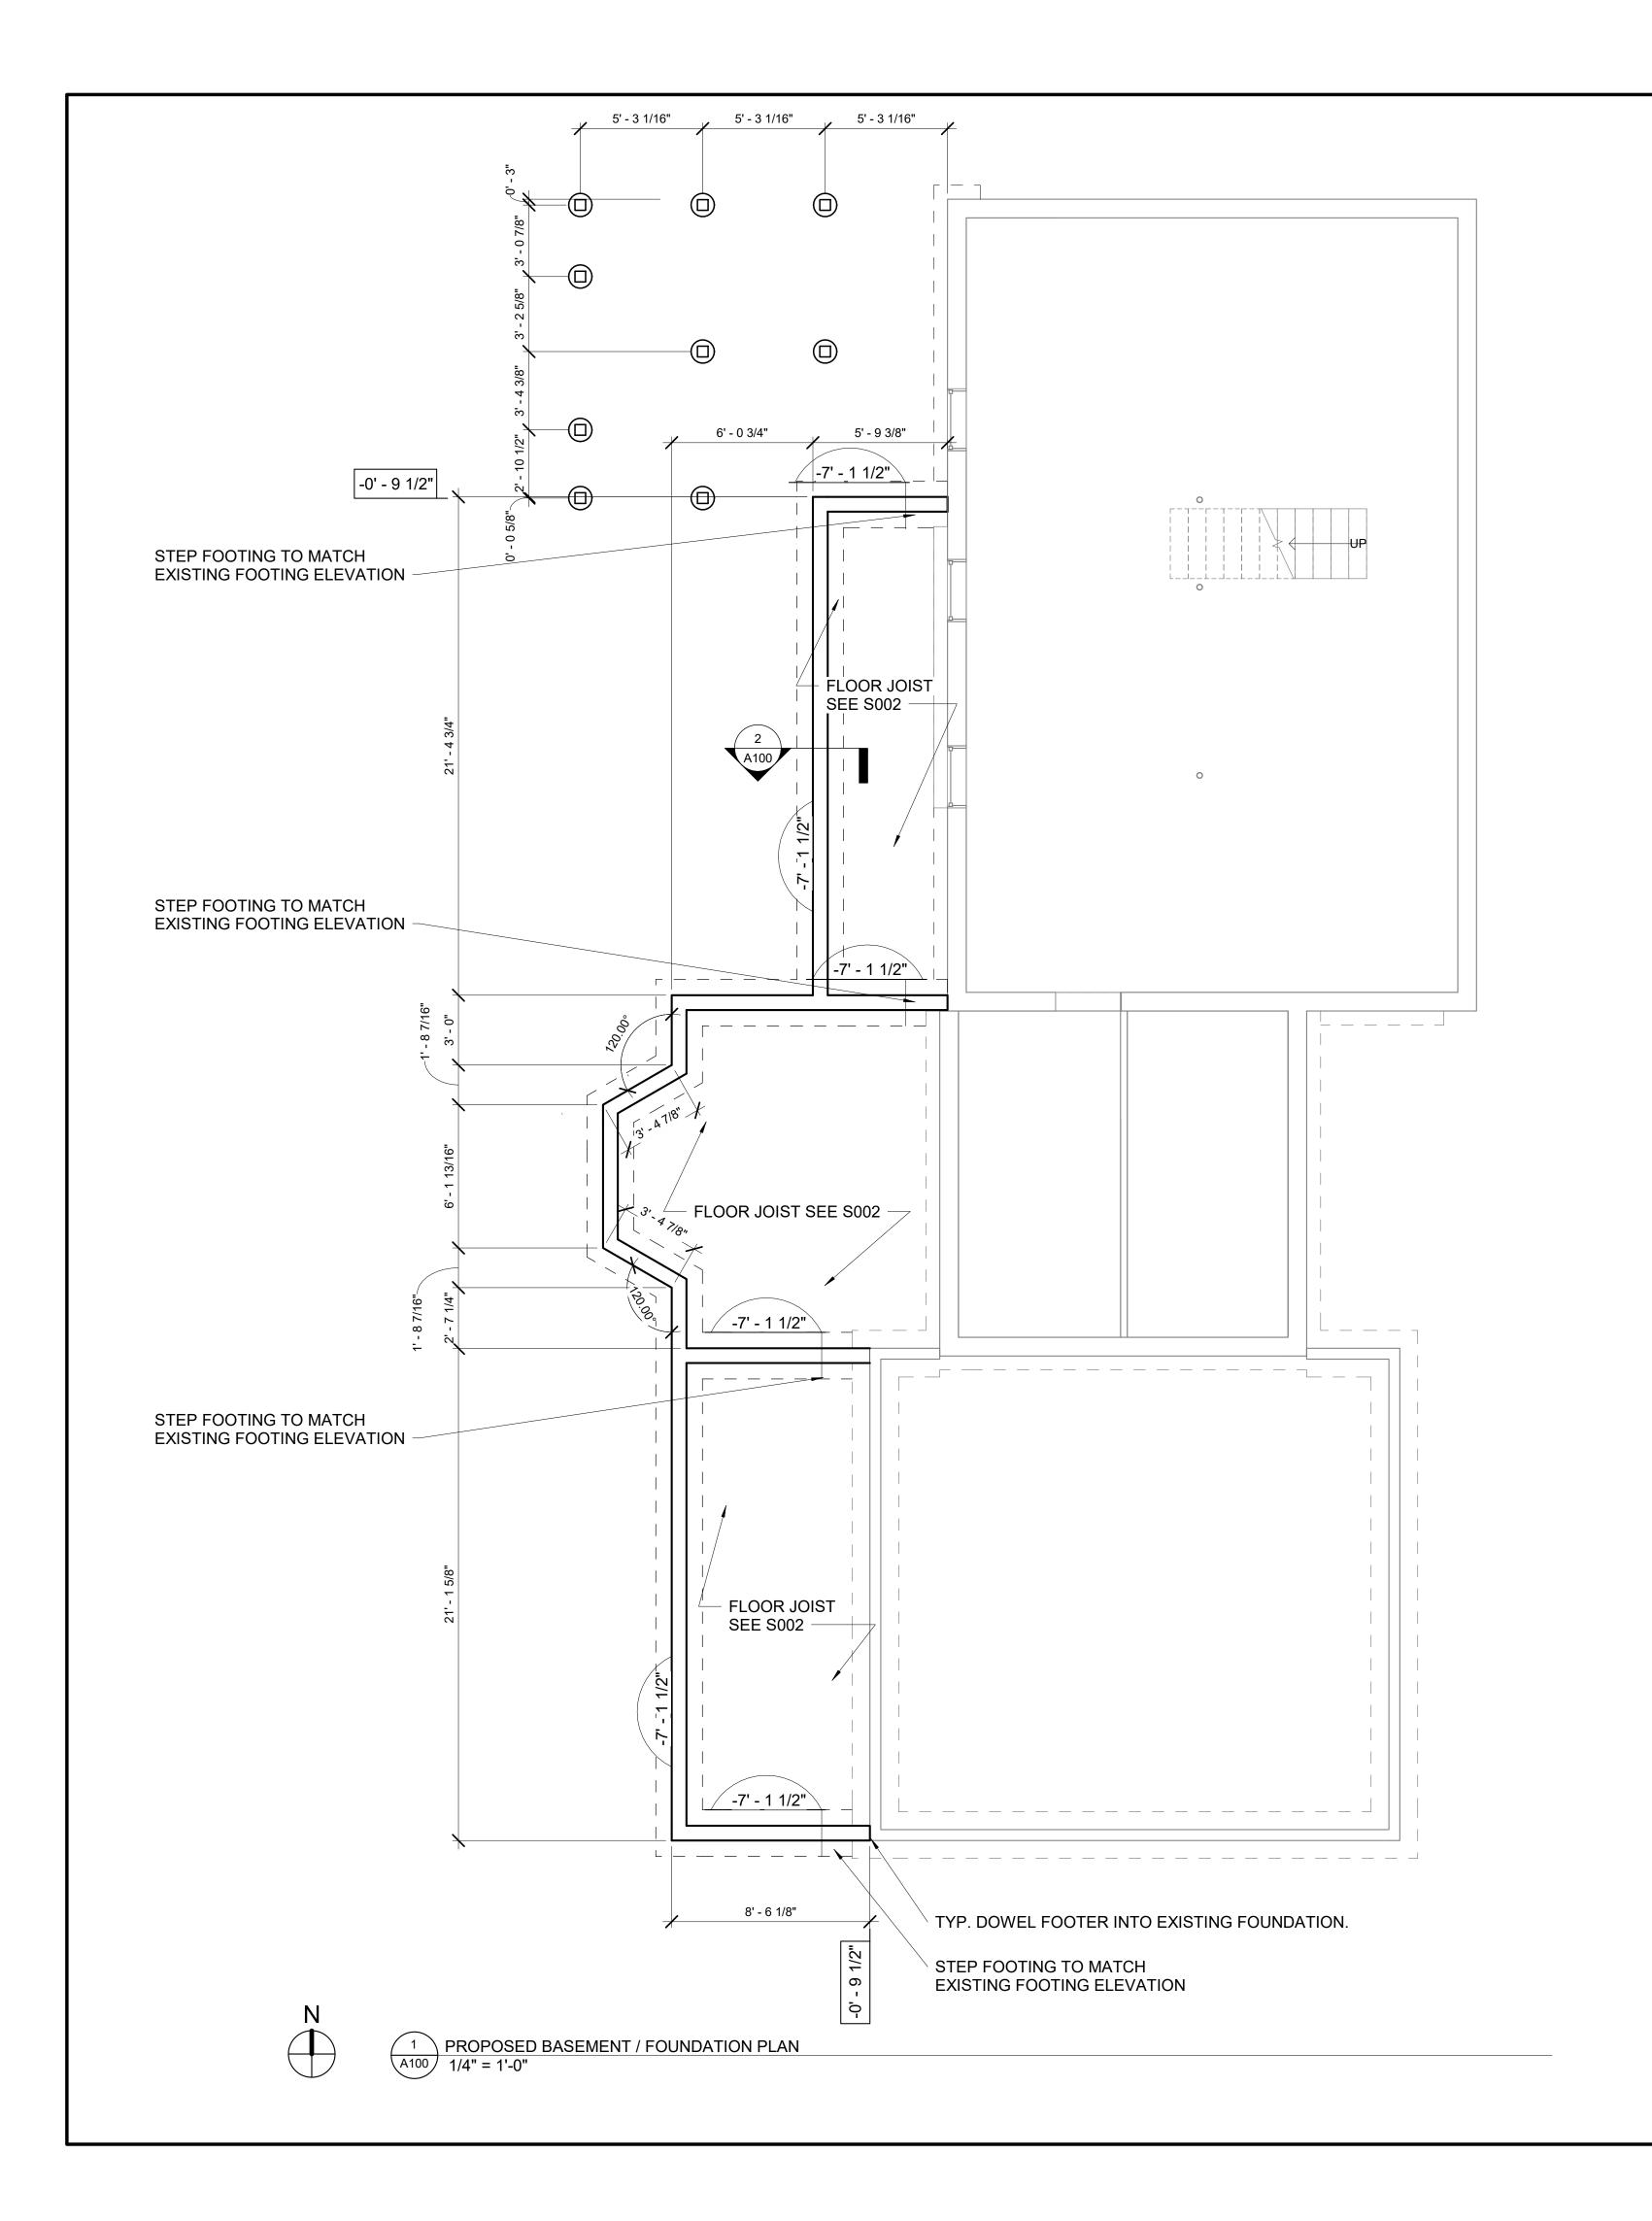
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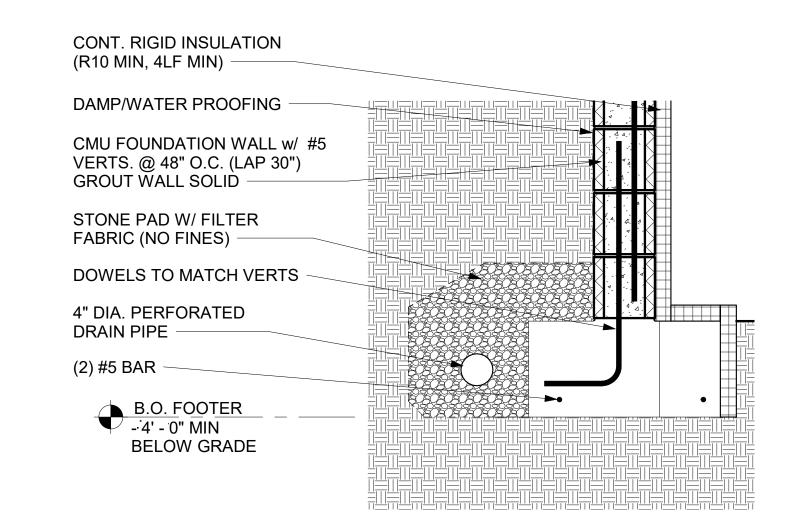
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## DEMOLITION **ELEVATIONS**

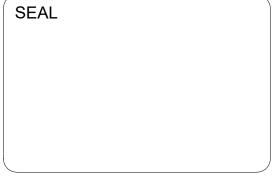SHEET NUMBER:

D200



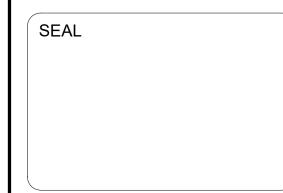

PLAN NOTE:

1. 8" CMU FOUNDATION WALL UNLESS NOTED OTHERWISE.

2. 24 X 12 FOOTER TYP.

2 TYPICAL WALL SECTION
1" = 1'-0"

3. ALL DIMENSIONS TAKEN TO FACE OF FOUNDATION U.N.O.

### FOUNDATION PLAN LEGEND



= MATCH EXISTING, STEP FOOTING AS NECESSARY

= TOP OF FOUNDATION WALL ELEVATION CHANGE

= TOP OF FOOTING ELEVATION

NOTE: TOP OF FOUNDATION WALL TO ALIGN WITH EXISTING.

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Hamann Residence

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323 EAST ST. PITTSFORD, NY 14534

DATE: 7/20/2020 1:52:51 PM

ARCHITECT: RHW


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JOB NUMBER: 19-117

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FOUNDATION PLAN

SHEET NUMBER:



**GENERAL FIRST FLOOR SCOPE OF WORK:** 

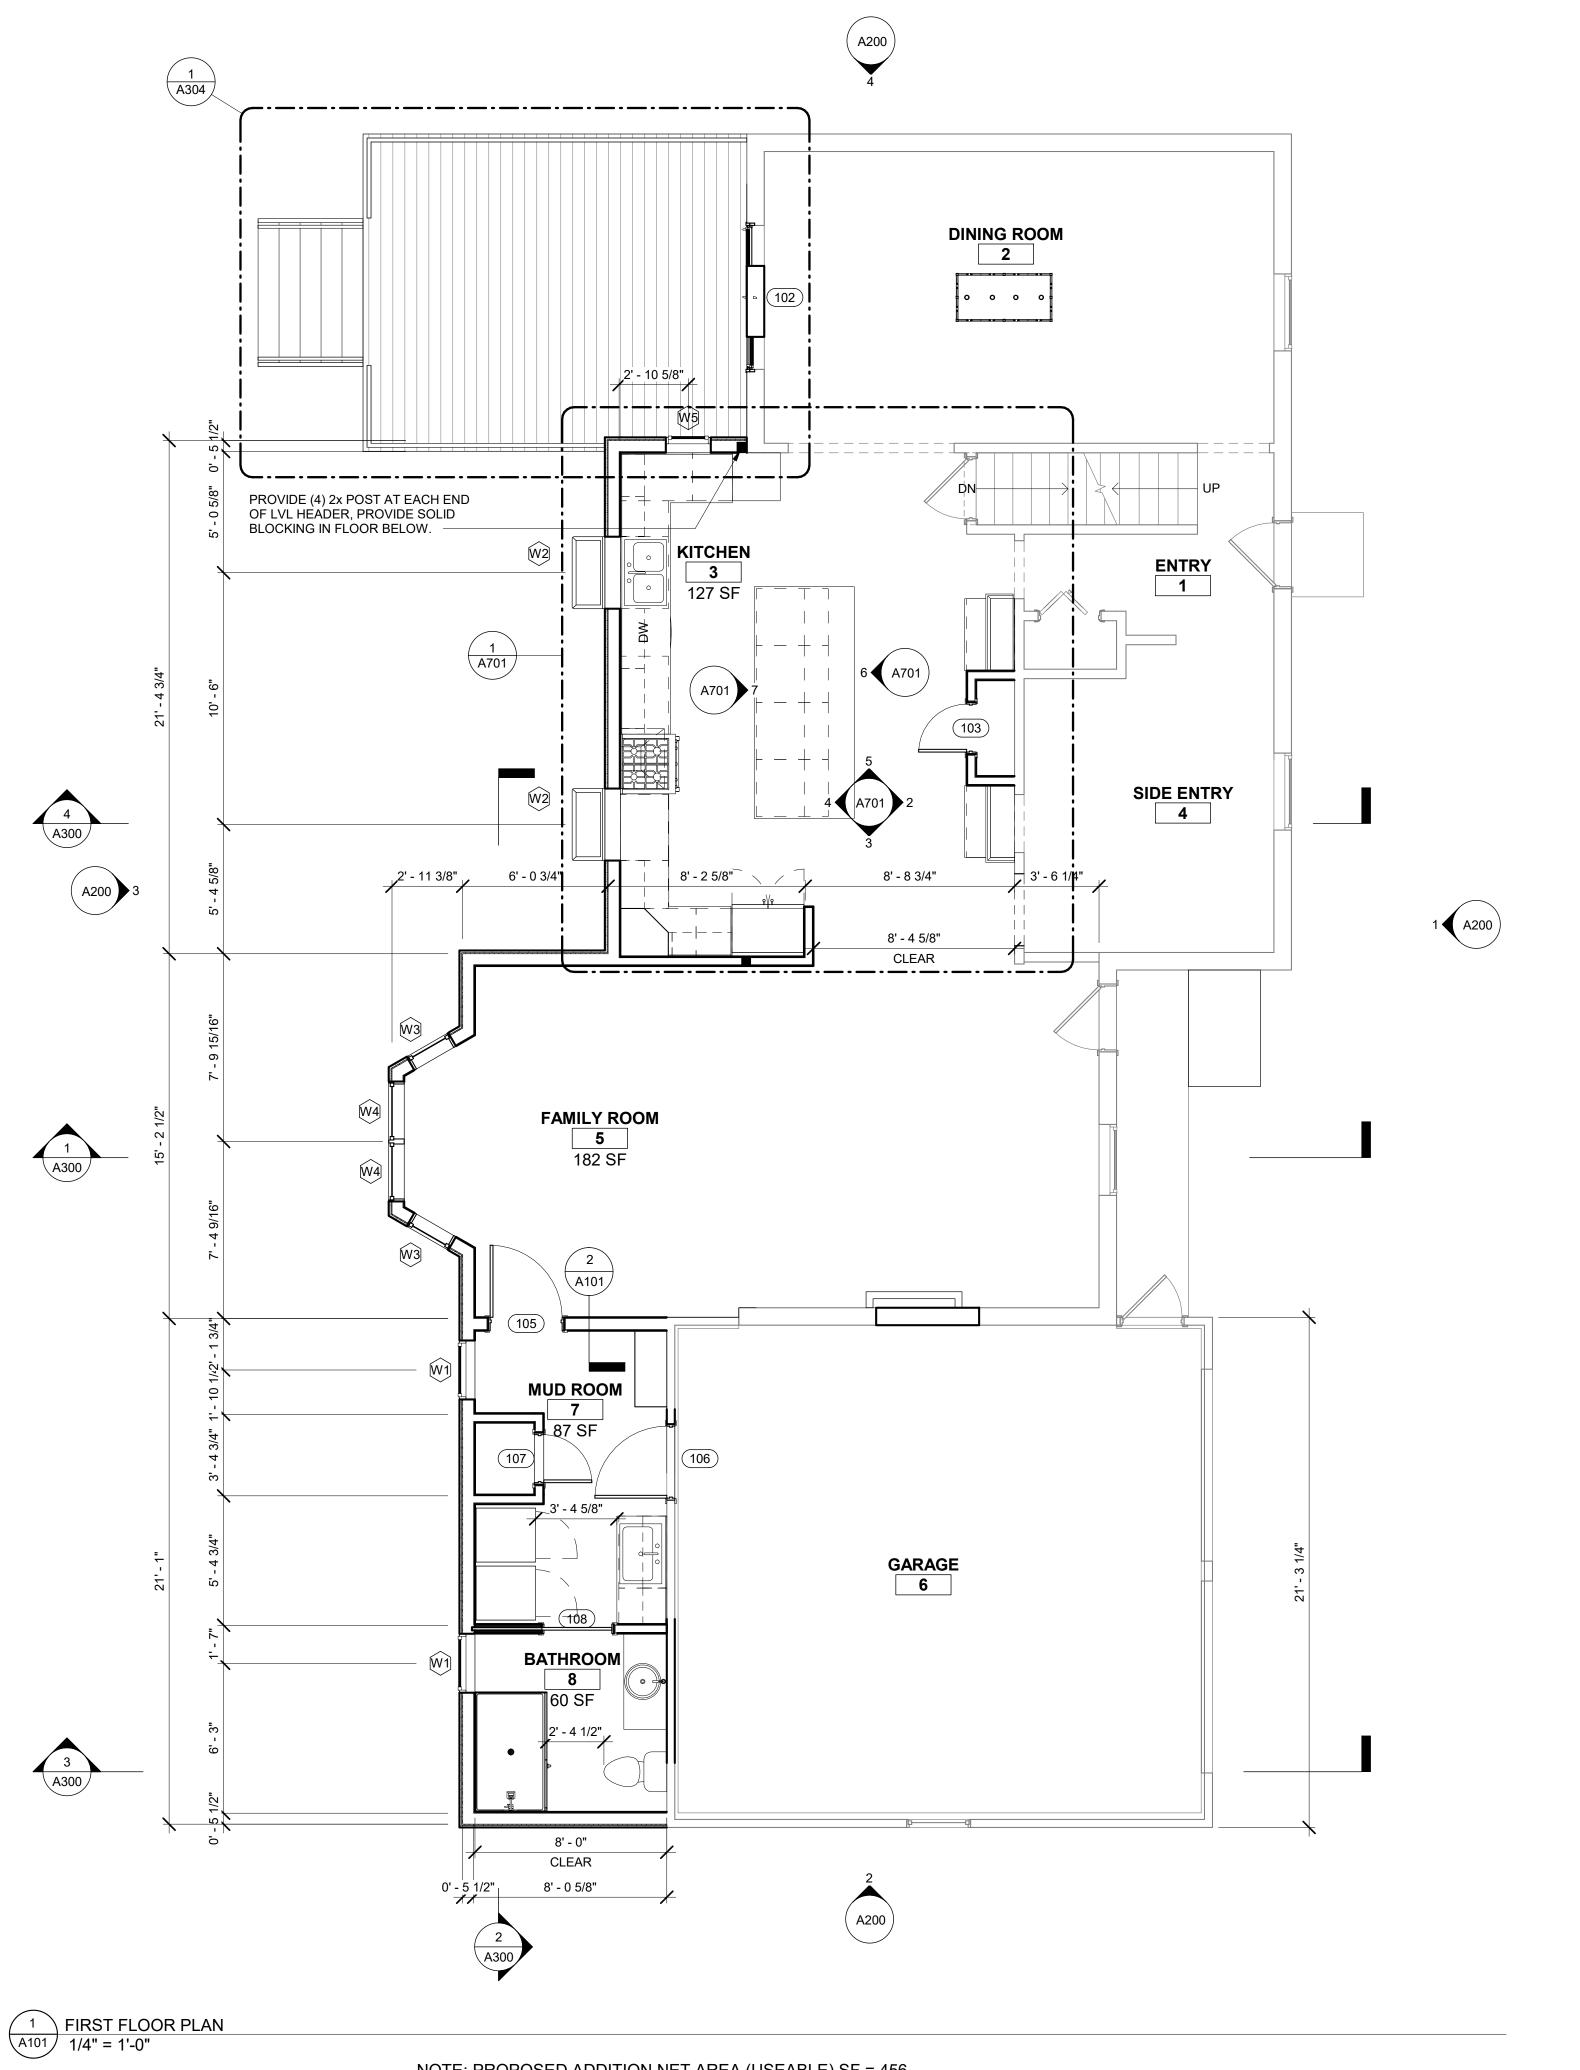- EXTERIOR WALLS TO BE 2X6 WD. STUD CONSTRUCTION W/ R-13 MIN. CAVITY INSULATION, R-5 MIN CONTINUOUS INSULATION, AND VAPOR BARRIER. U.N.O. SEE STRUCTURAL DRAWINGS. - PROVIDE WINDOWS AS INDICATED - REFER TO HEADER

SCHEDULE FOR SIZING

- COORDINATE NEW ELECTRICAL WIRING & FIXTURE DIAGRAM W/ ELECTRICAL CONTRACTOR

- UPON WIRING COMPLETION, CONTACT BUILDING OFFICIAL FOR INSPECTION

- PROVIDE 1/2" GYP. WALLS/ CEILINGS

- COORDINATE FINISHES W/ OWNER

- PROVIDE WALL PAINT - COORDINATE W/ OWNER

- PROVIDE FLOORING - COORDINATE W/ OWNER - PROVIDE CASING AND TRIM - COORDINATE W/ OWNER

PLAN NOTES:

1. ALL NEW WALL DIMENSIONS, TO FACE OF DRYWALL FOR LAYOUT PURPOSES.

2. ALL BEARING WALLS TO BE 2X6 WOOD CONSTRUCTION U.N.O. SEE STRUCTURAL PLANS.

3. ALL NON-BEARING WALLS TO BE 2X4 WOOD CONSTRUCTION U.N.O.


4. ALL CABINET DIMENSIONS TO BASE UNITS.


5. ALL HINGE SIDE DOOR JAMBS TO BE 9" FROM ADJACENT FINISHED WALL MIN. U.N.O. SEE A800.

6. ALL CLOSET DOORS TO BE CENTERED ON CLOSET AREA U.N.O.

7. REF. 2/A301 FOR WALL TYPES

8. REF. HEADER SCHEDULE FOR DOOR AND WINDOW HEADER SIZING. SEE STRUCTURAL DRAWINGS FOR DETAILS.

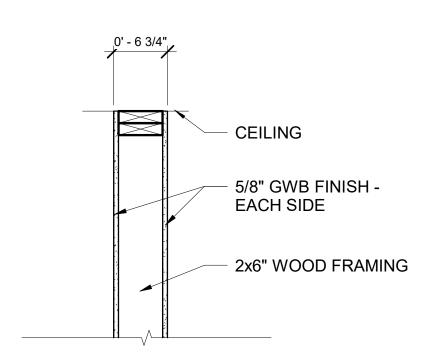

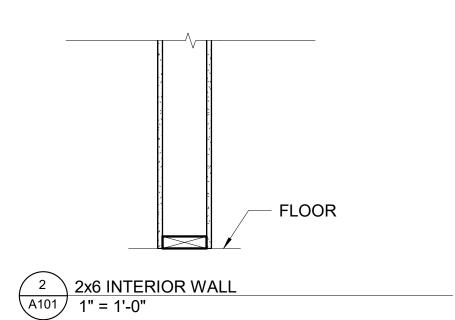


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OWNER: MR & MRS HAMANN

PROJECT:

Hamann Residence


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DRAWING	BY:	Author
JOB NUME	BER:	19-117
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FIRST FLOOR PLAN

SHEET NUMBER:

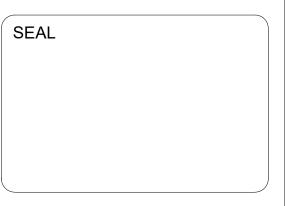

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## Hamann Residence


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## SECOND FLOOR PLAN
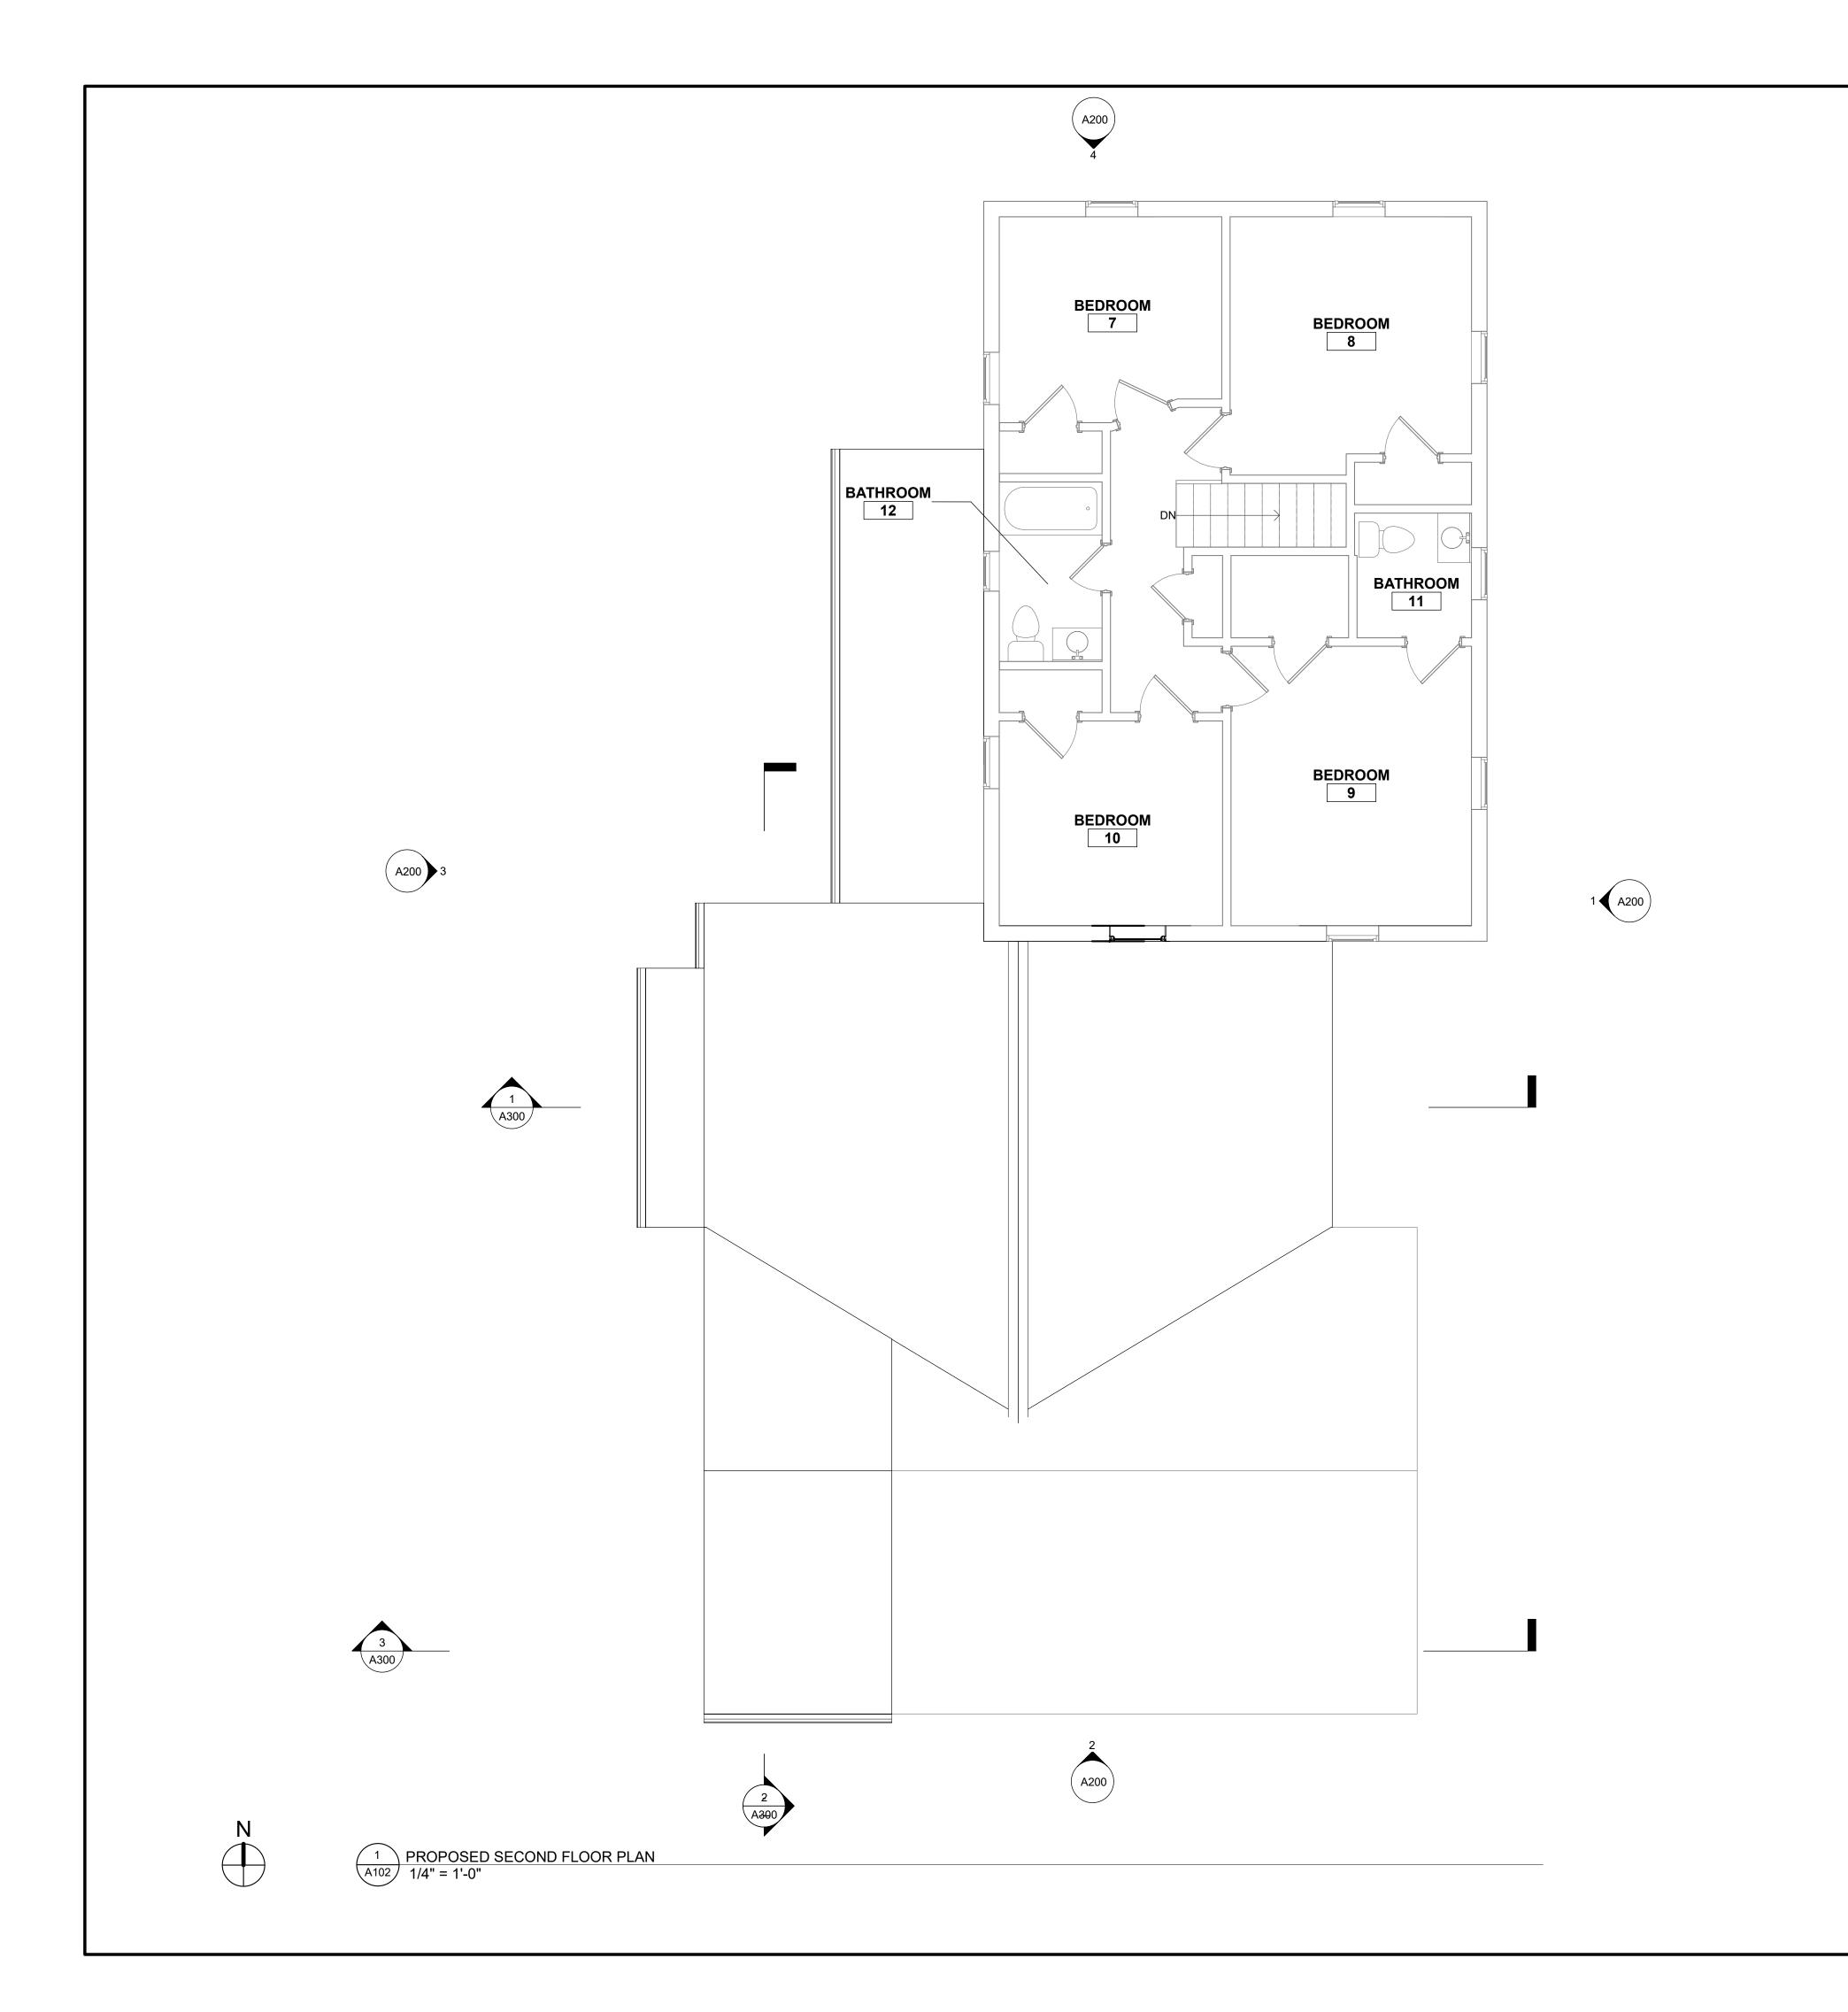
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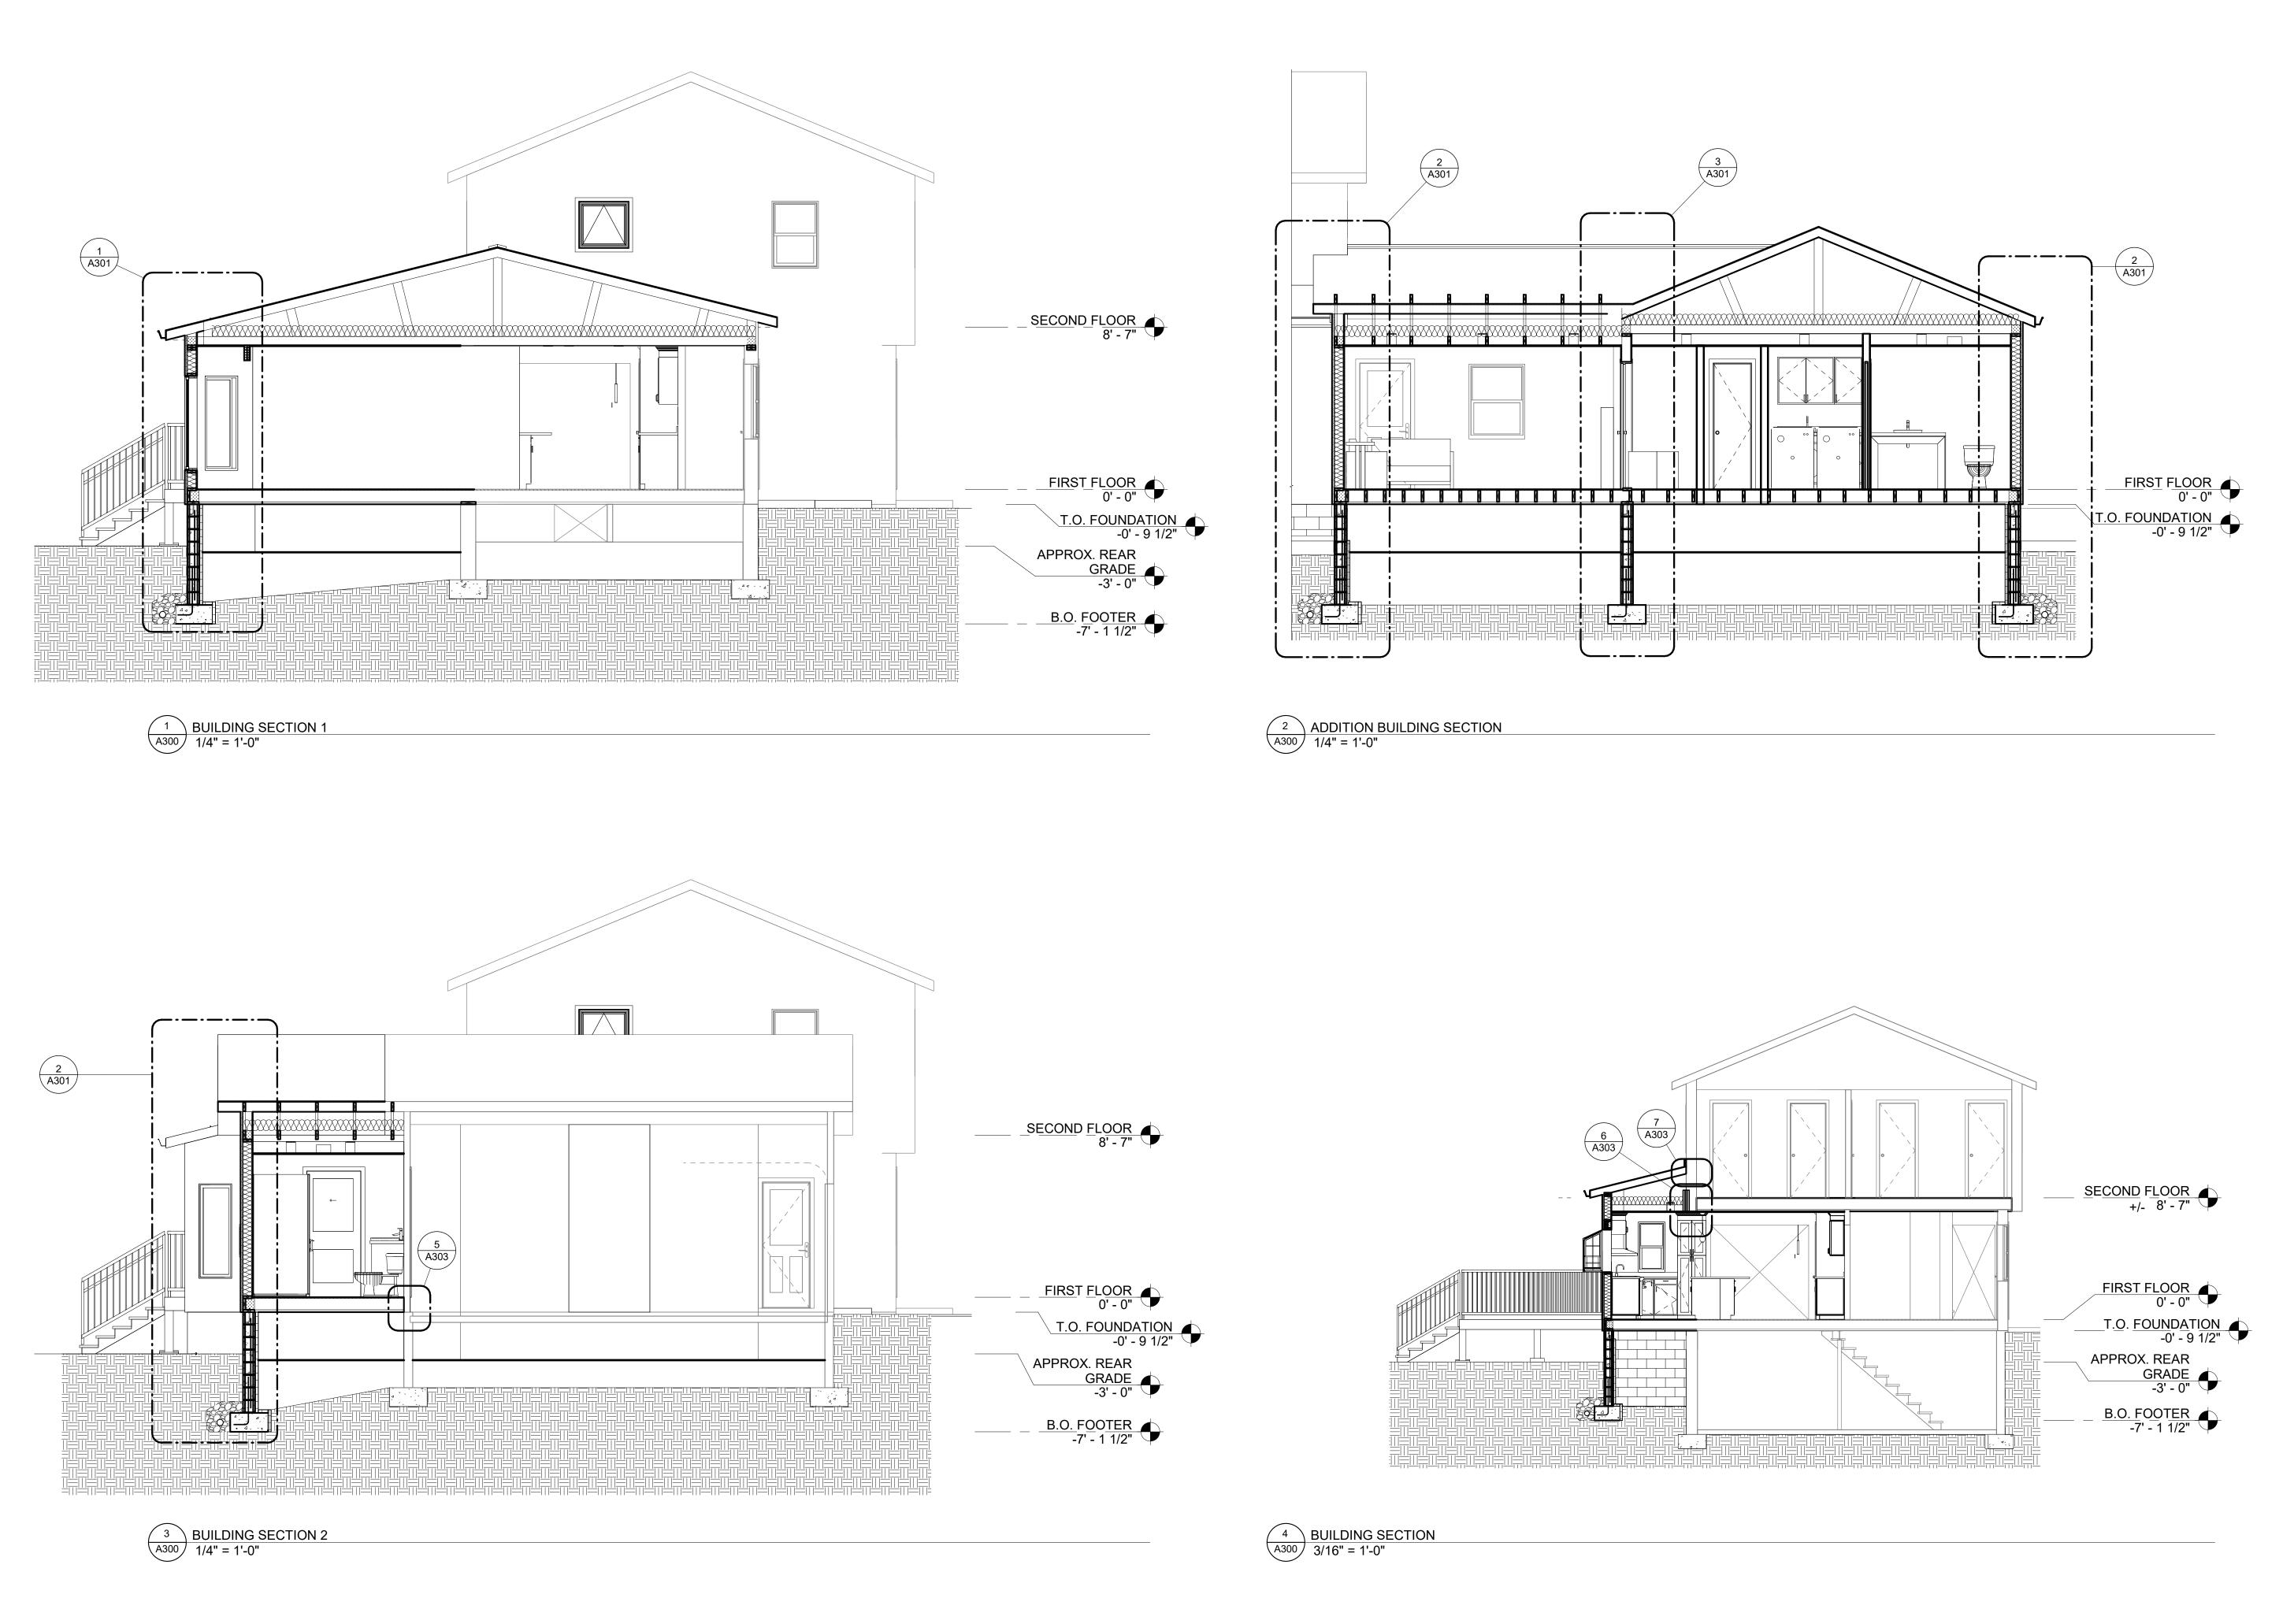
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ROOF PLAN

SHEET NUMBER:




Author 19-117

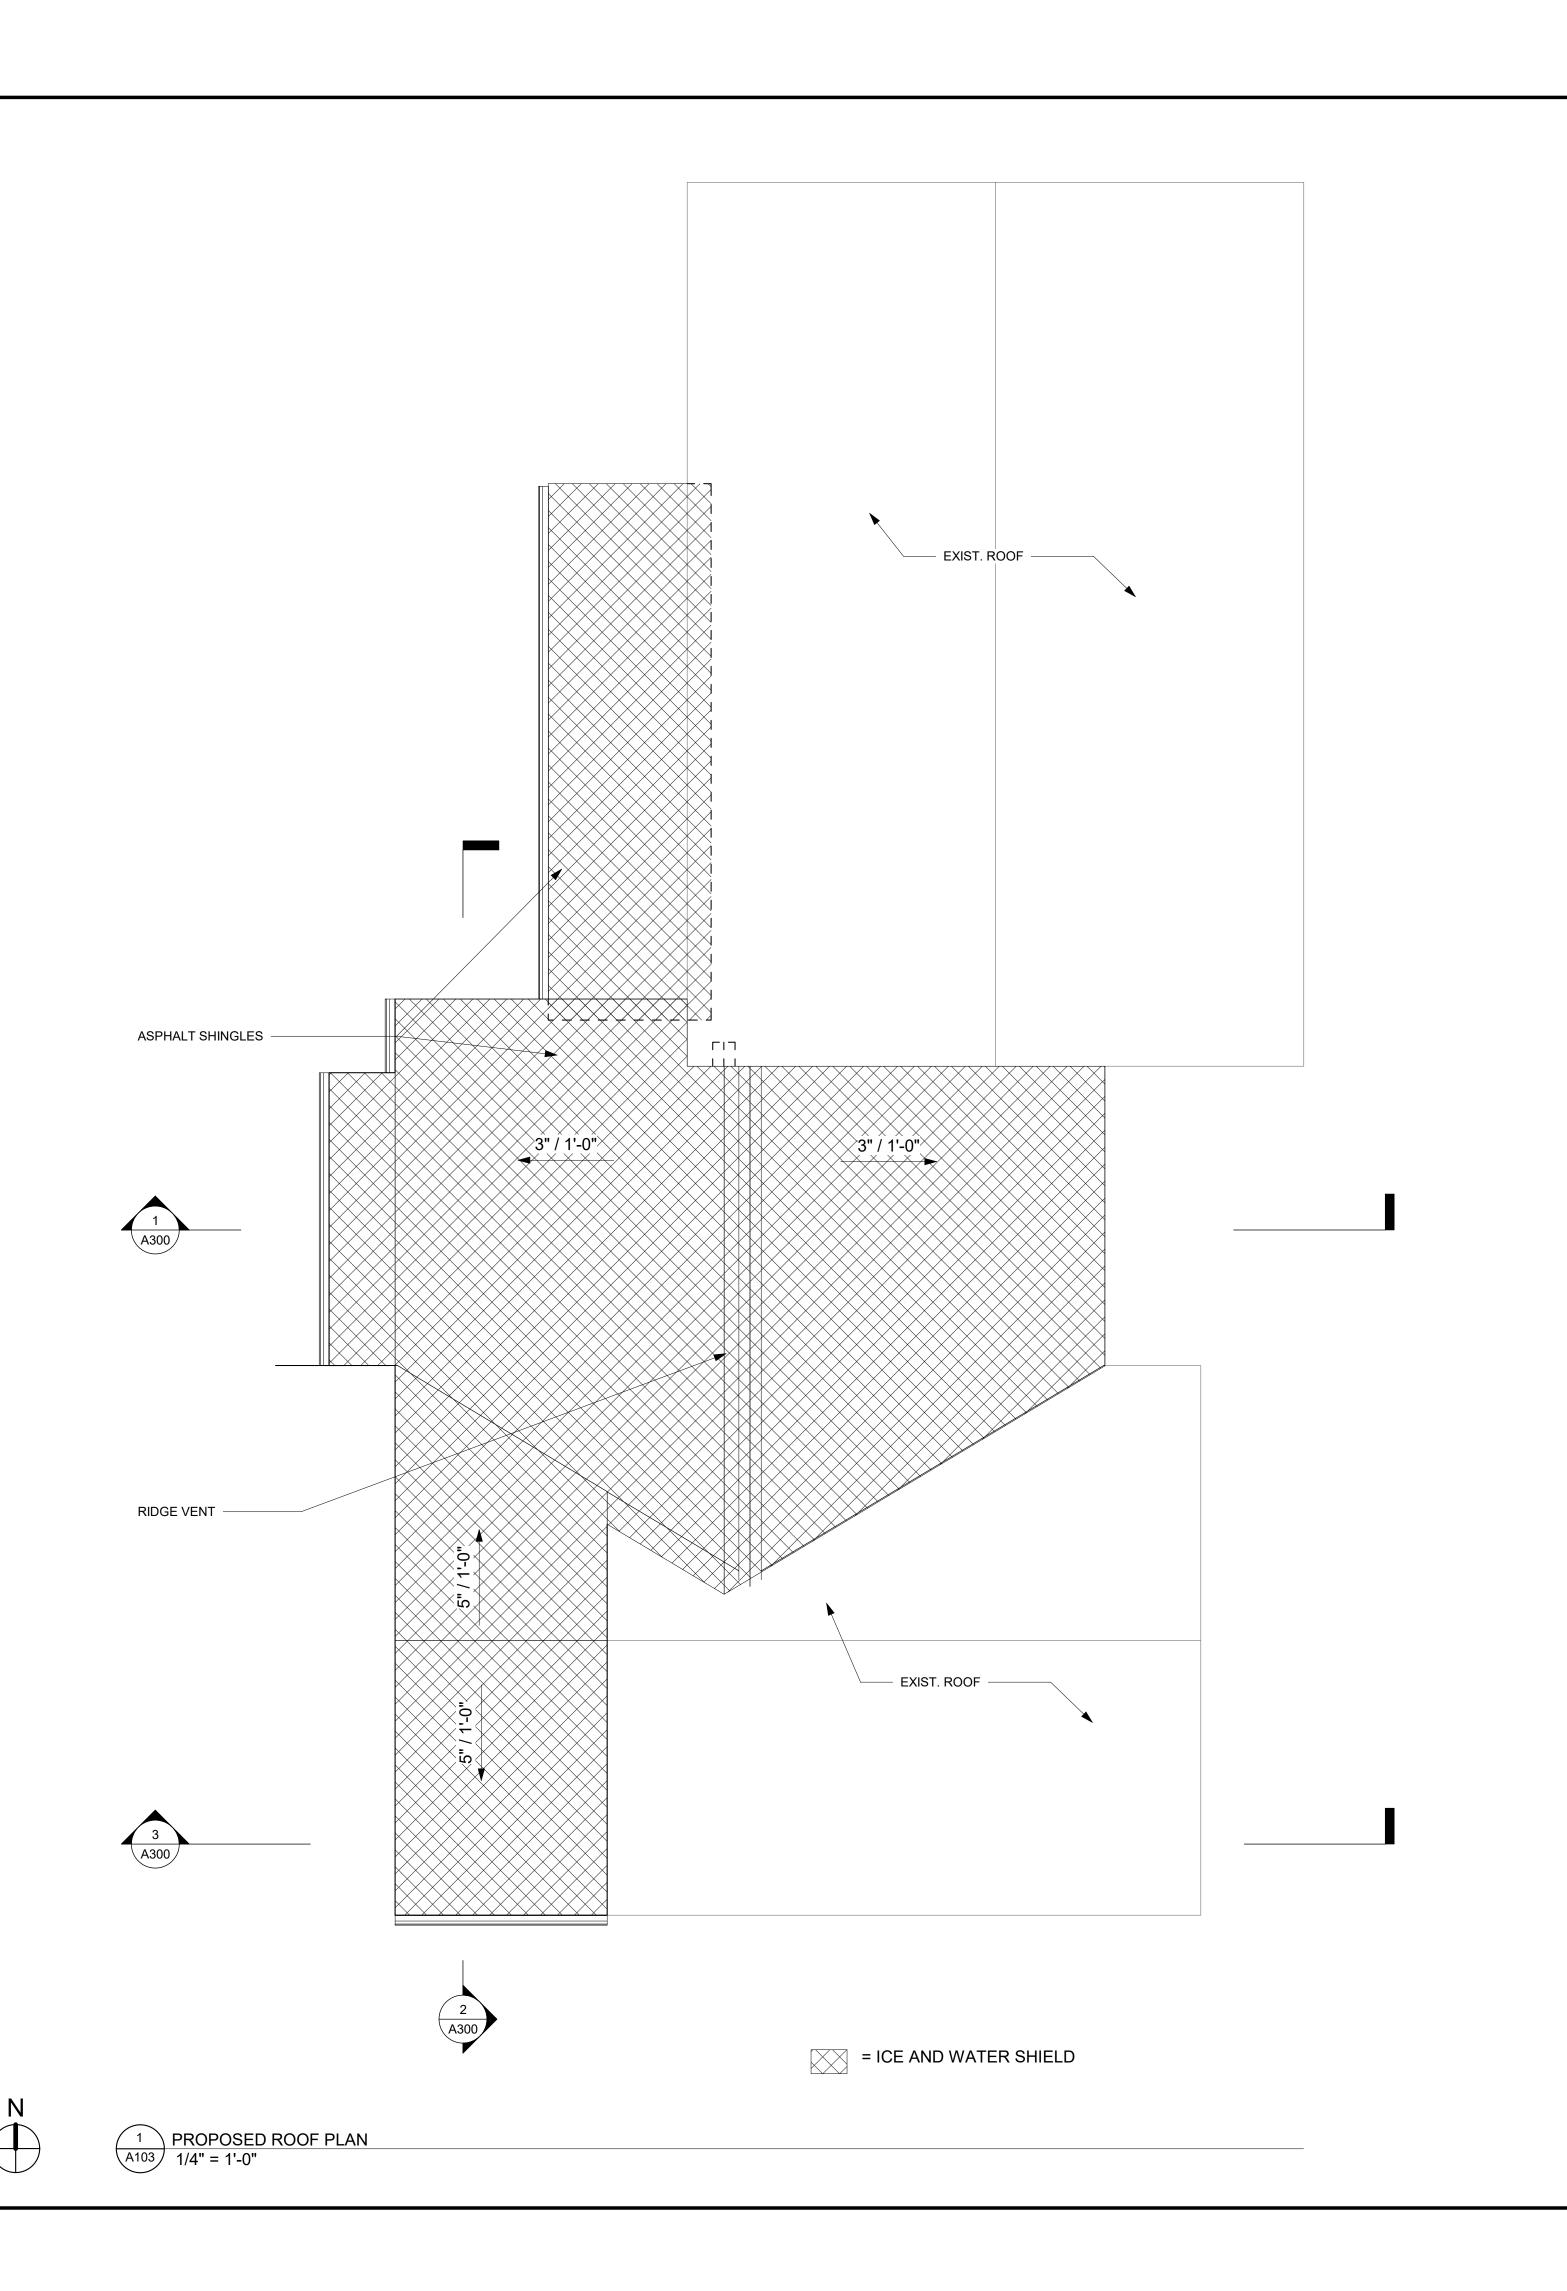

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DRAWING BY: Author


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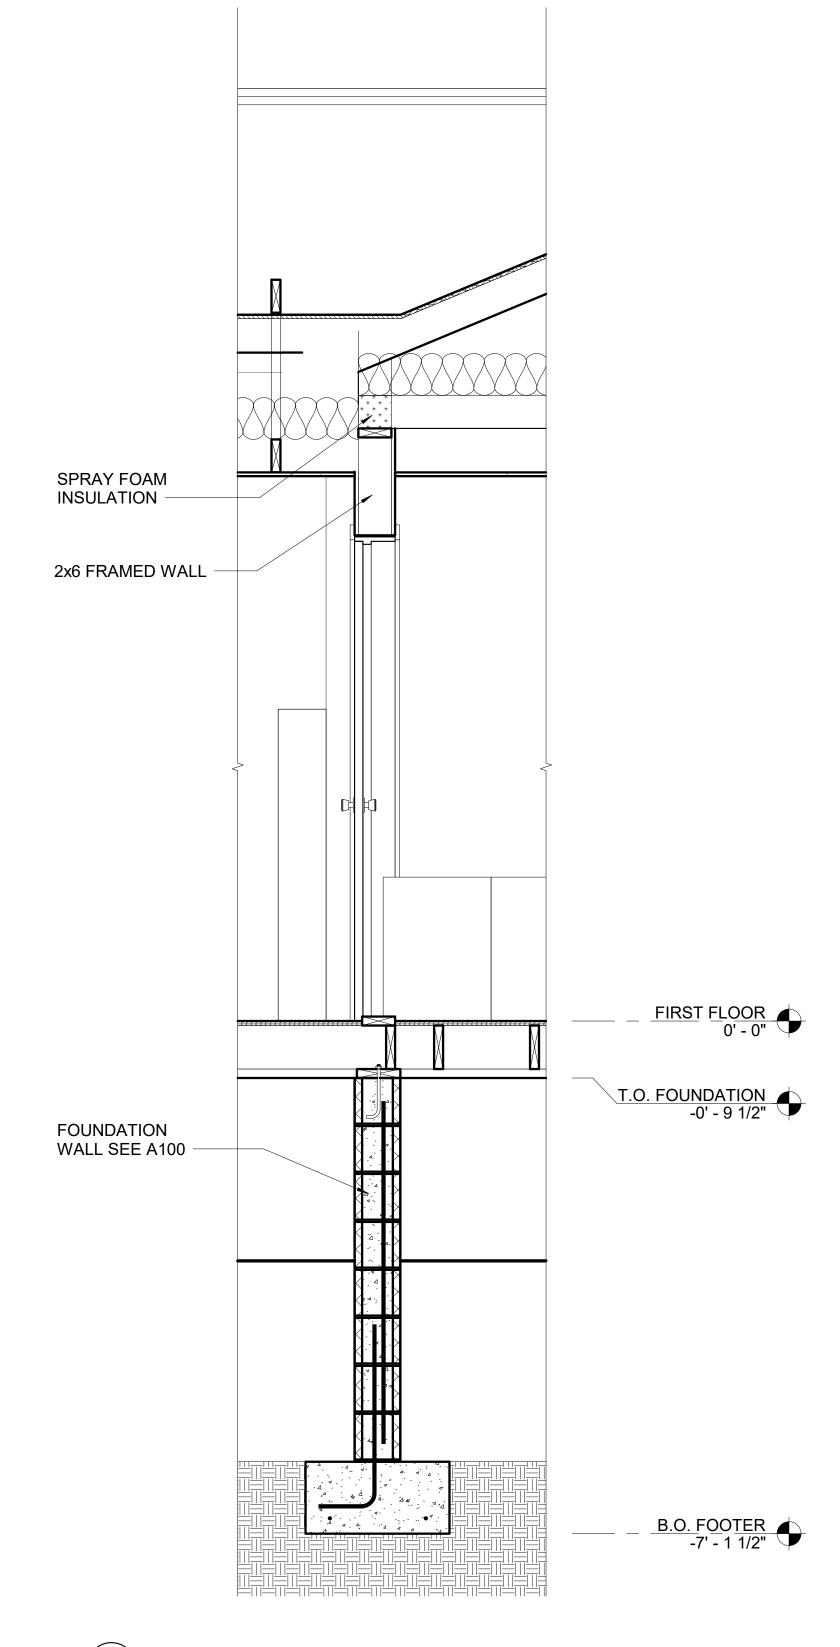
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BUILDING SECTIONS

SHEET NUMBER:

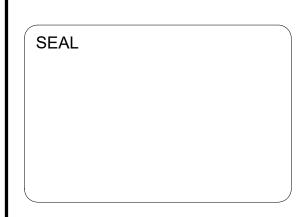




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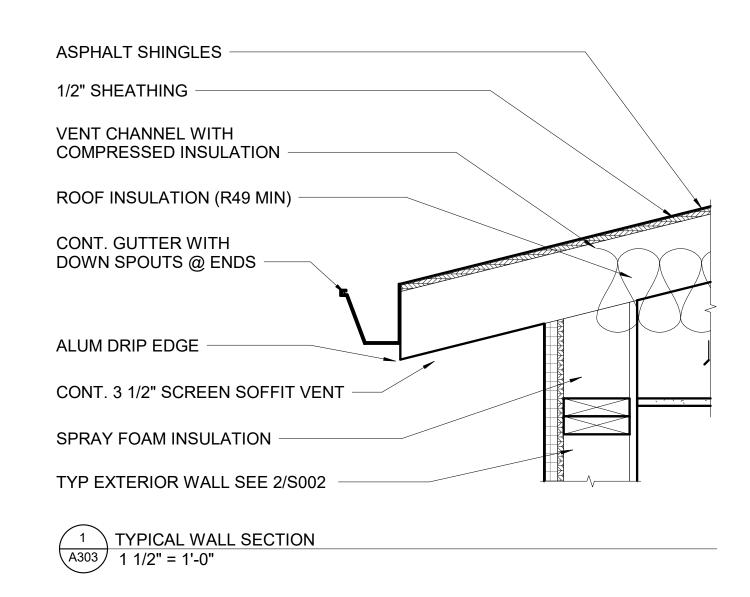
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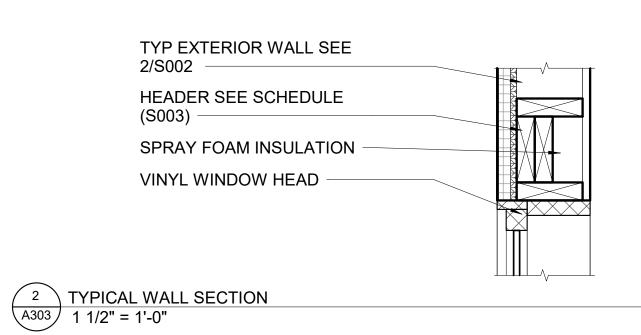
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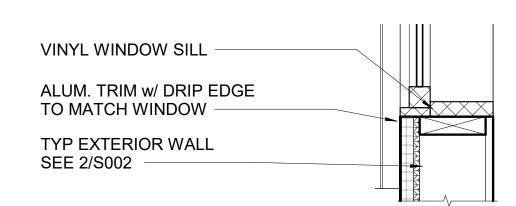
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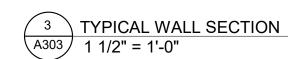
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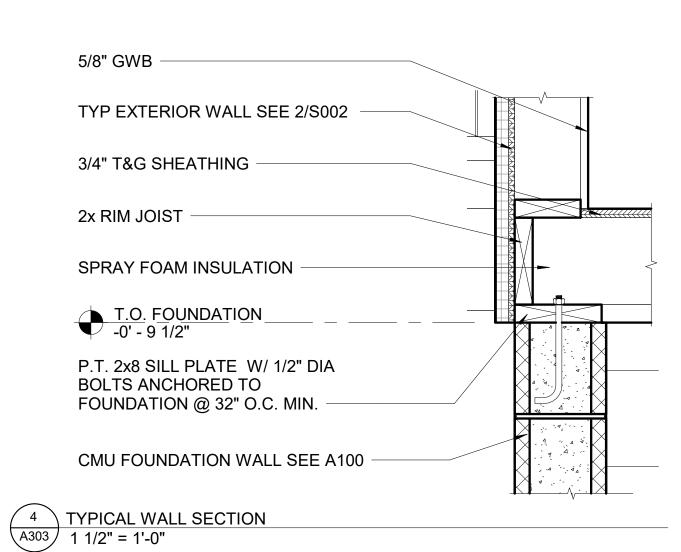
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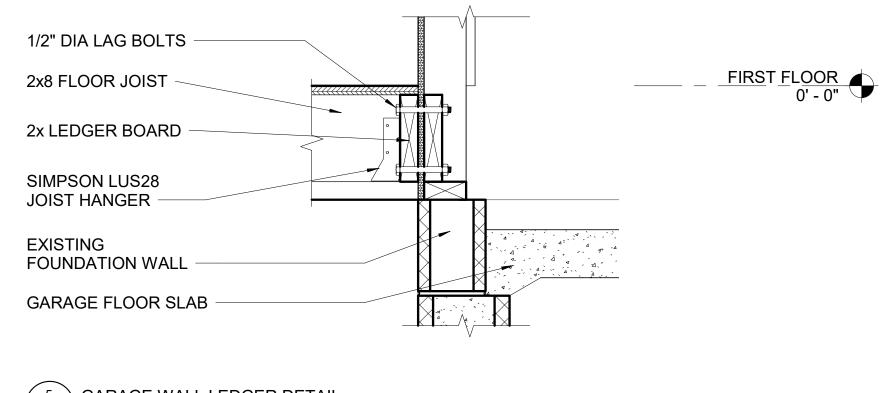


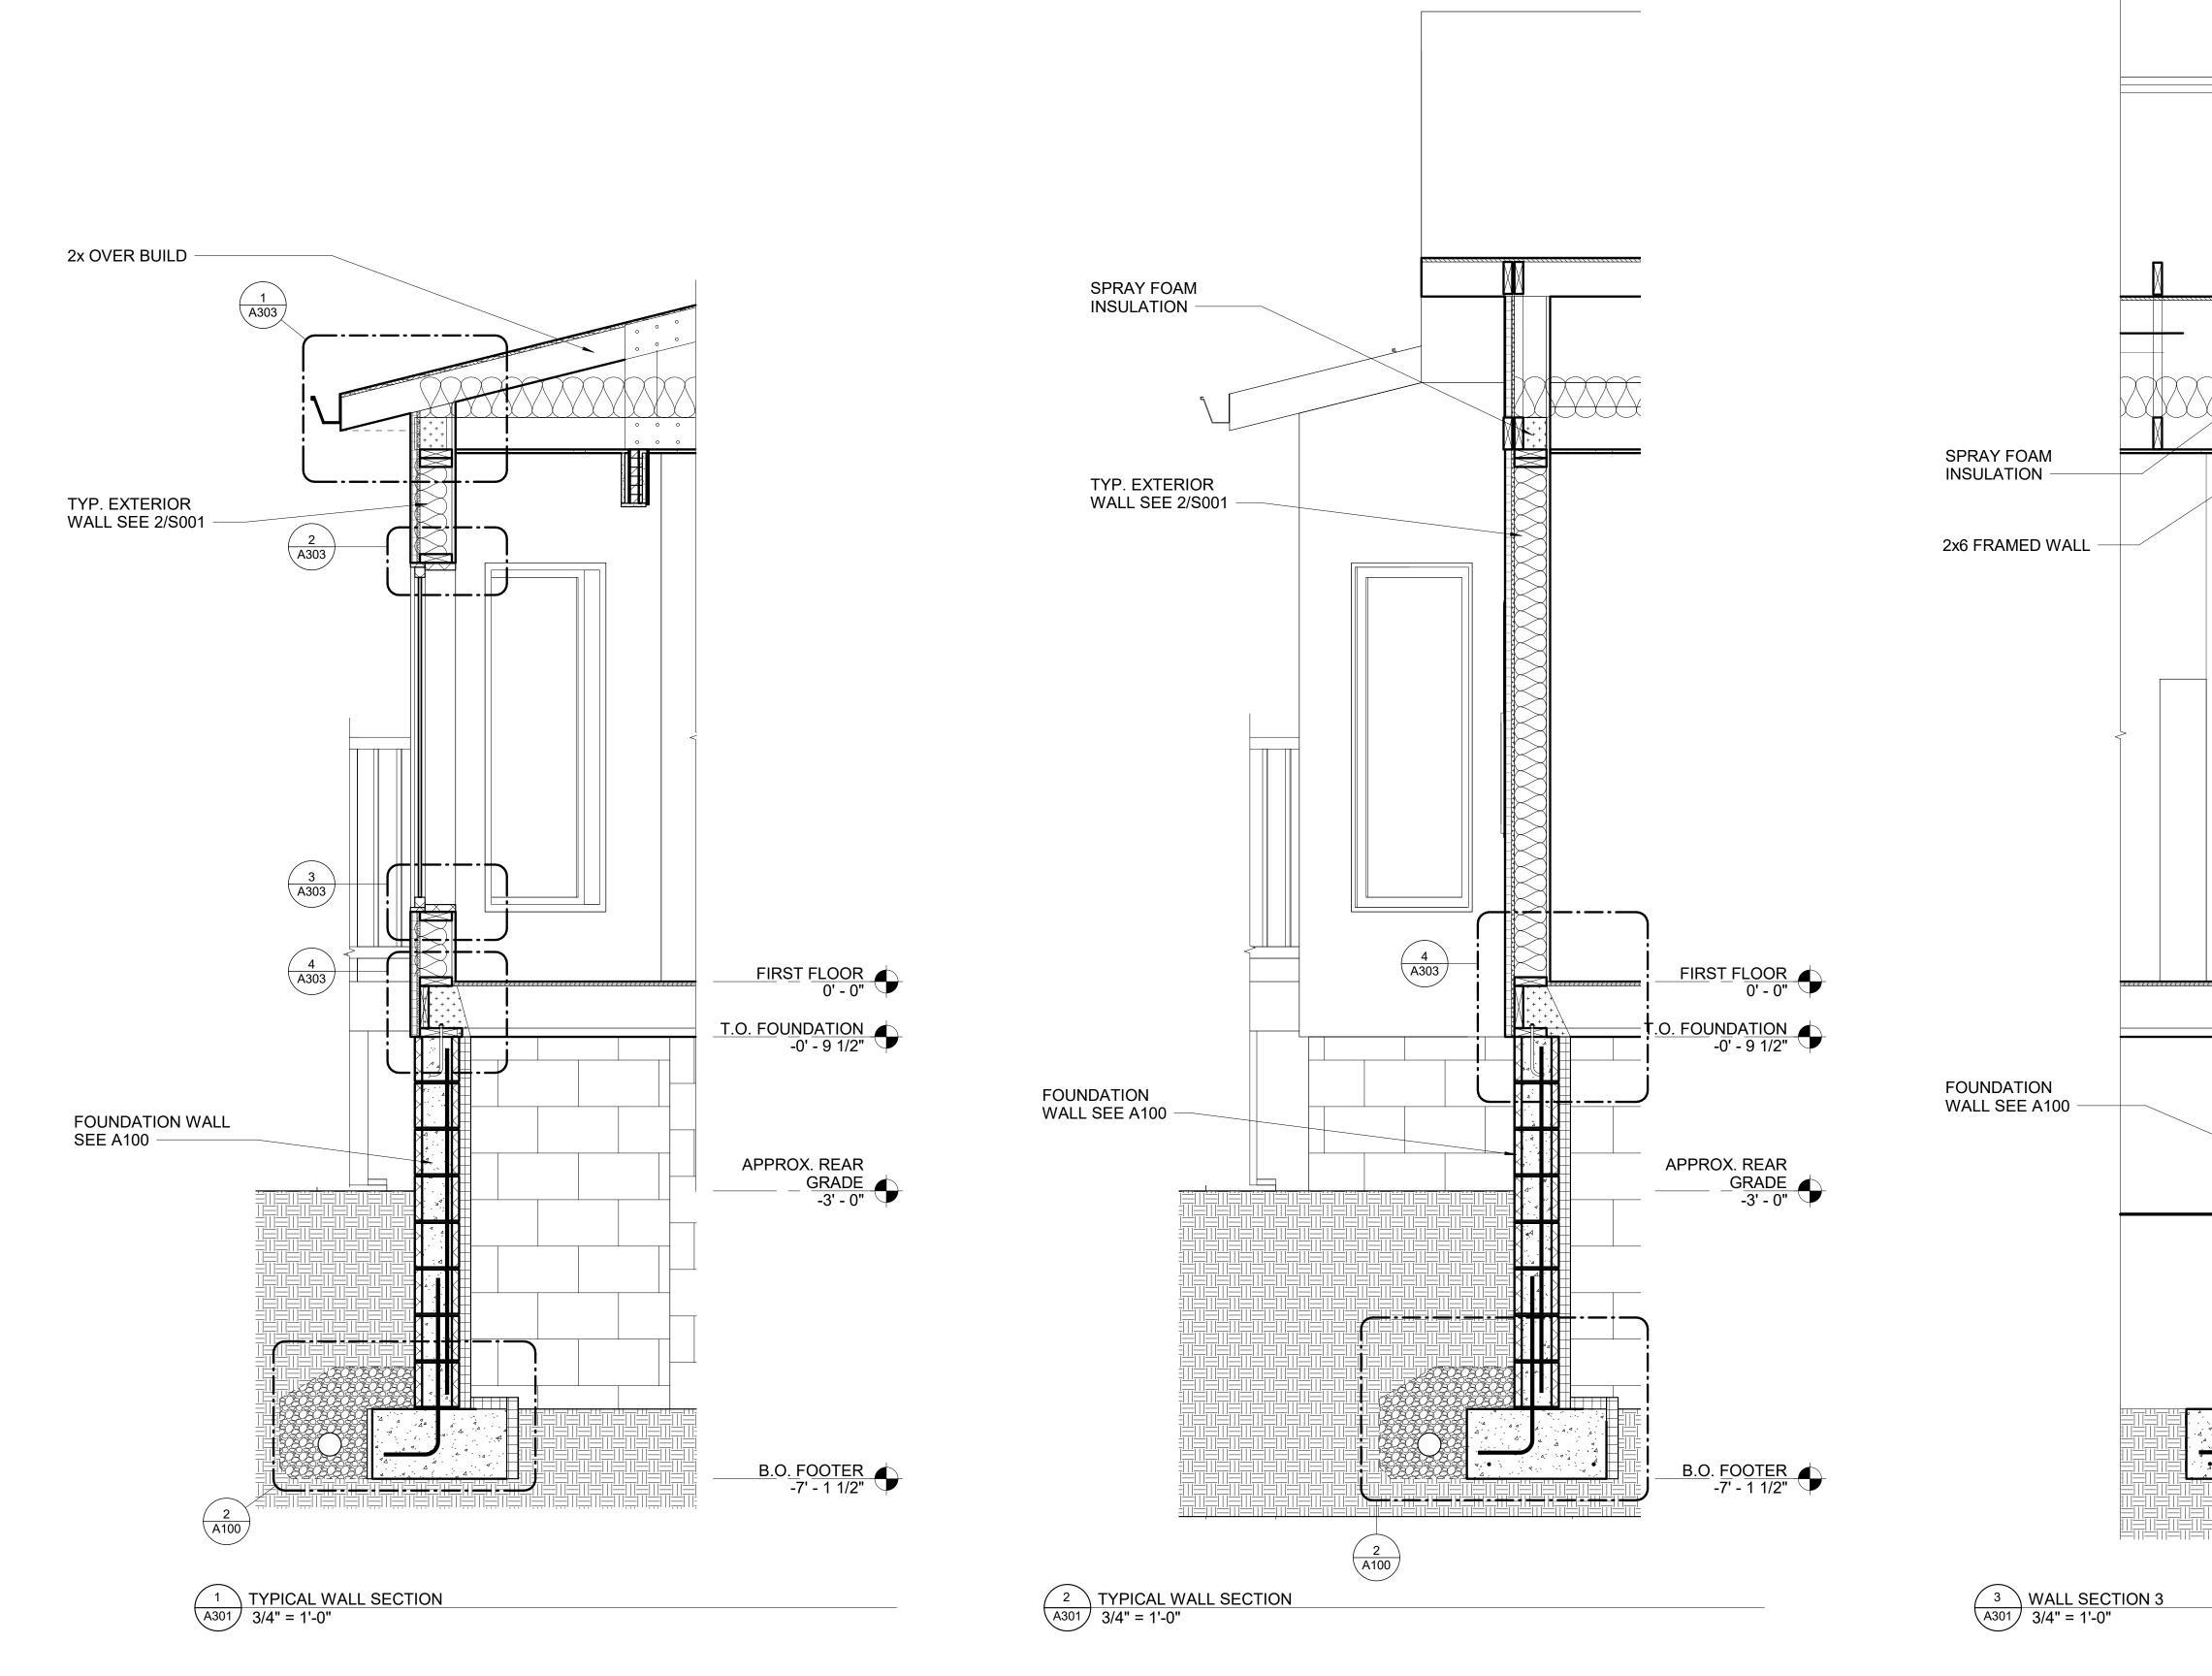






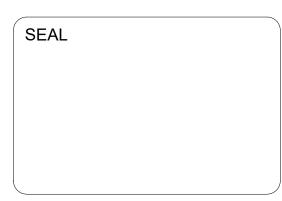





GARAGE WALL LEDGER DETAIL

1 1/2" = 1'-0"

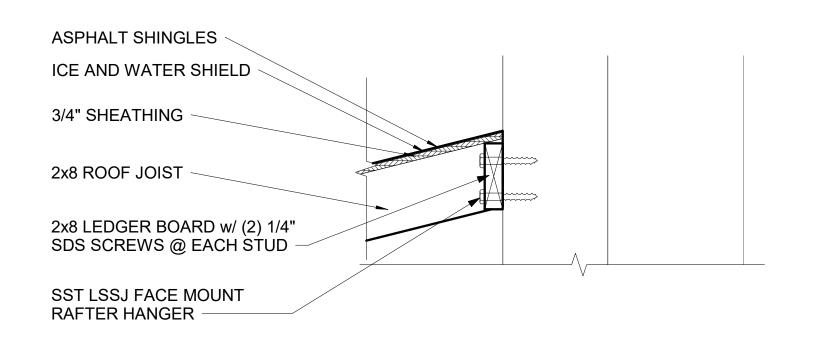

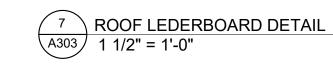

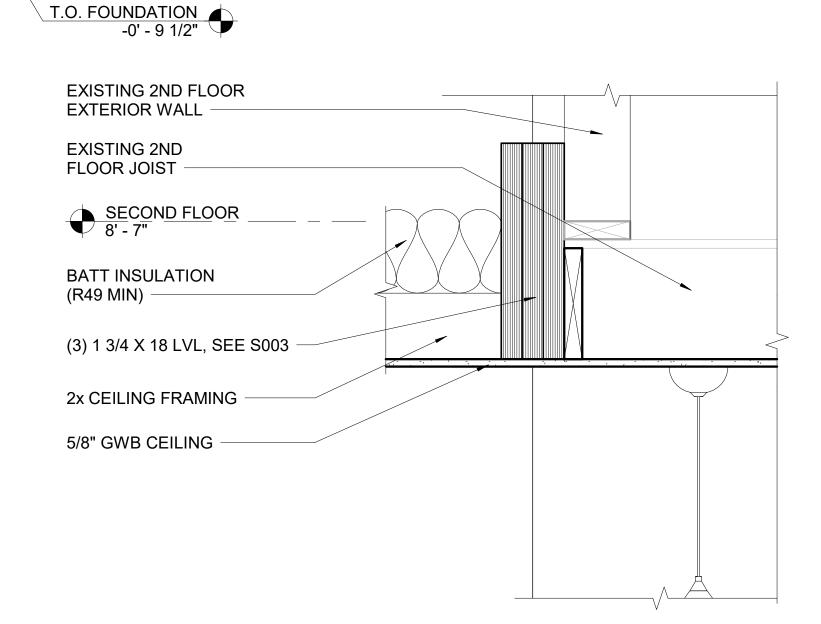

NOTE: ASSUMING PLATFORM FRAMING VERIFY IN FIELD.


6 H1 BEAM DETAIL 1 1/2" = 1'-0" DRAWING ALTERATION

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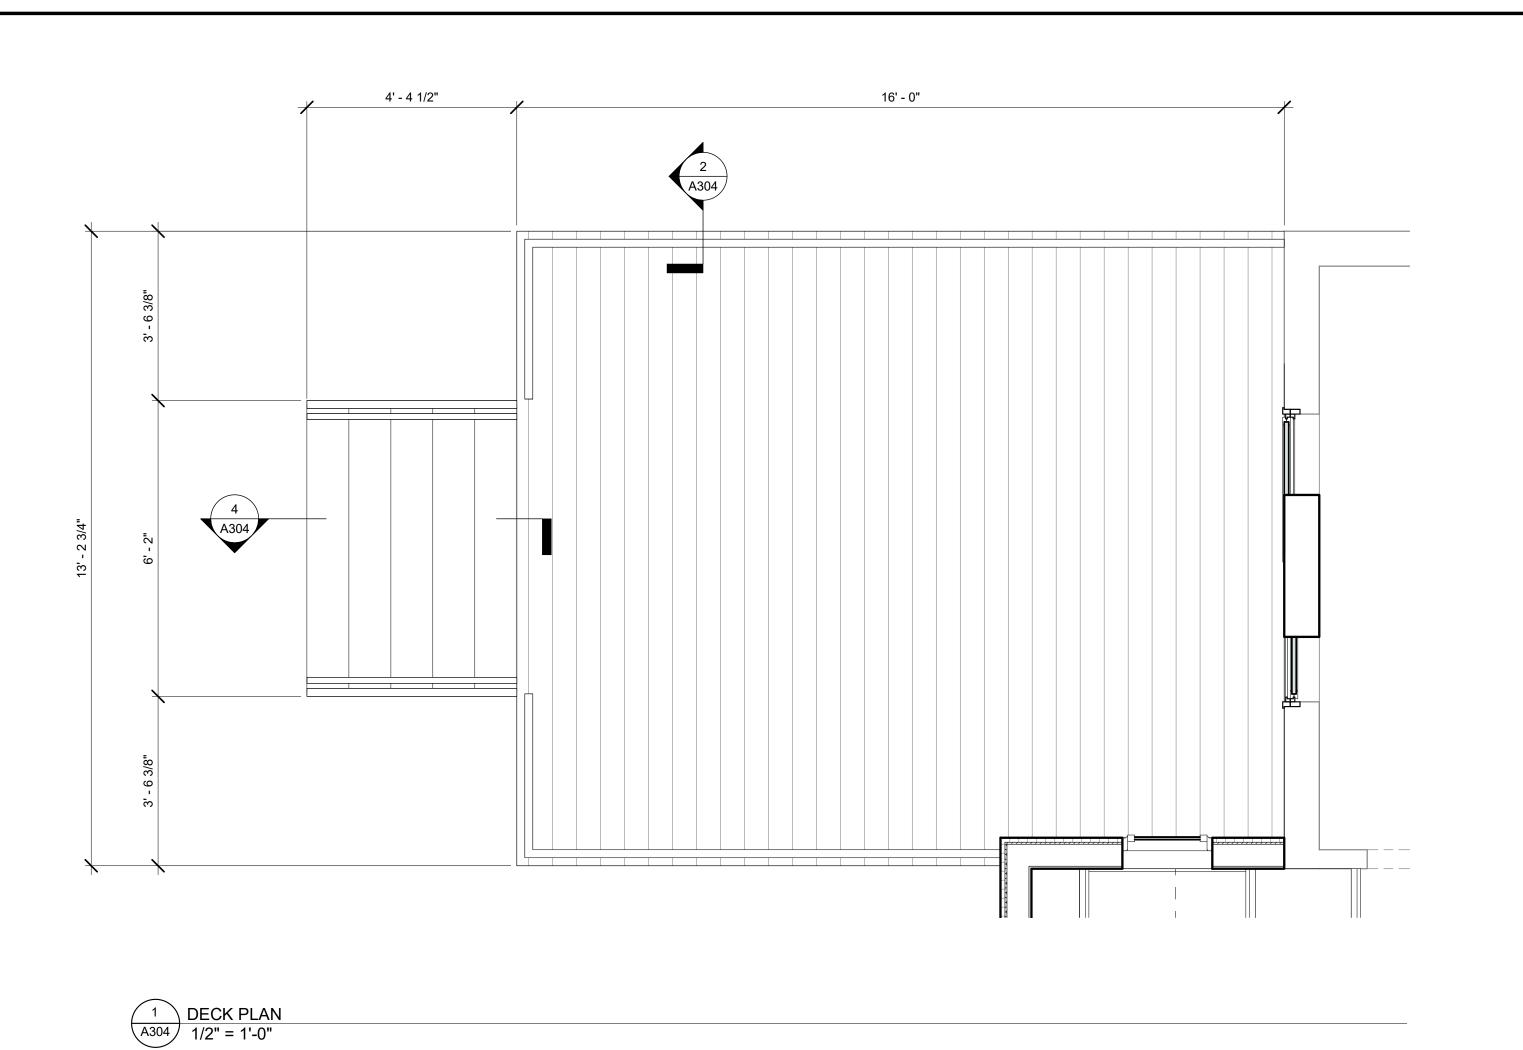
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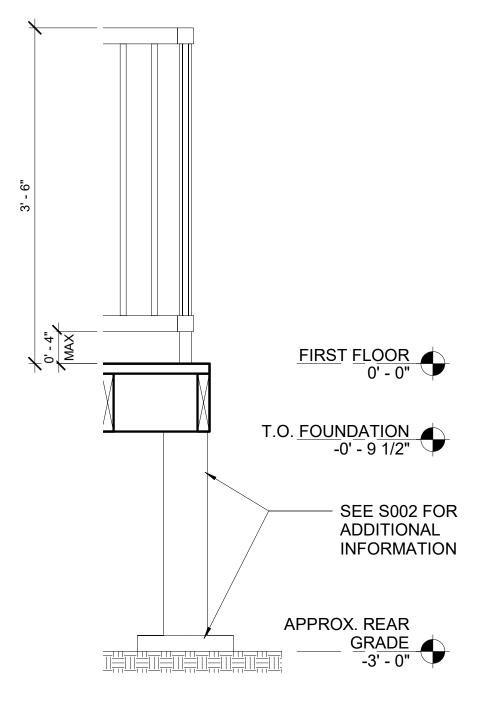
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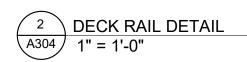
WALL DETAILS


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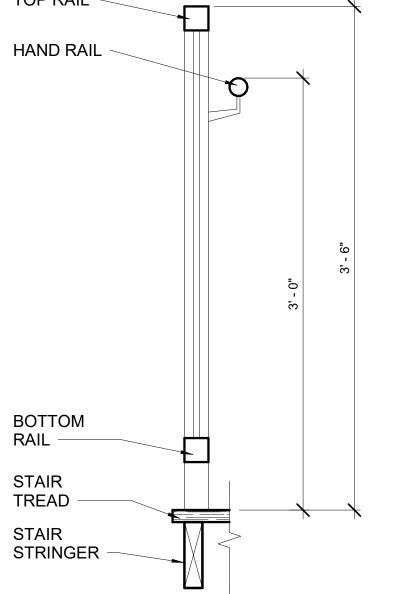
NOTE: COORDINATE DECK RAIL DESIGN WITH OWNER



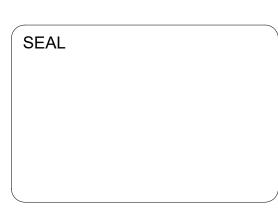

NOTE: COORDINATE DECK RAIL DESIGN WITH OWNER

3 STAIR RAILING DETAIL A304 1 1/2" = 1'-0"

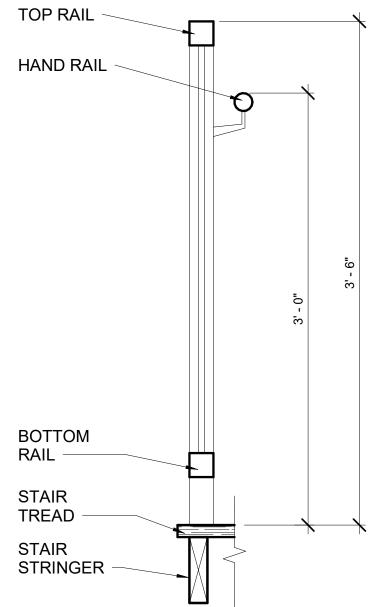

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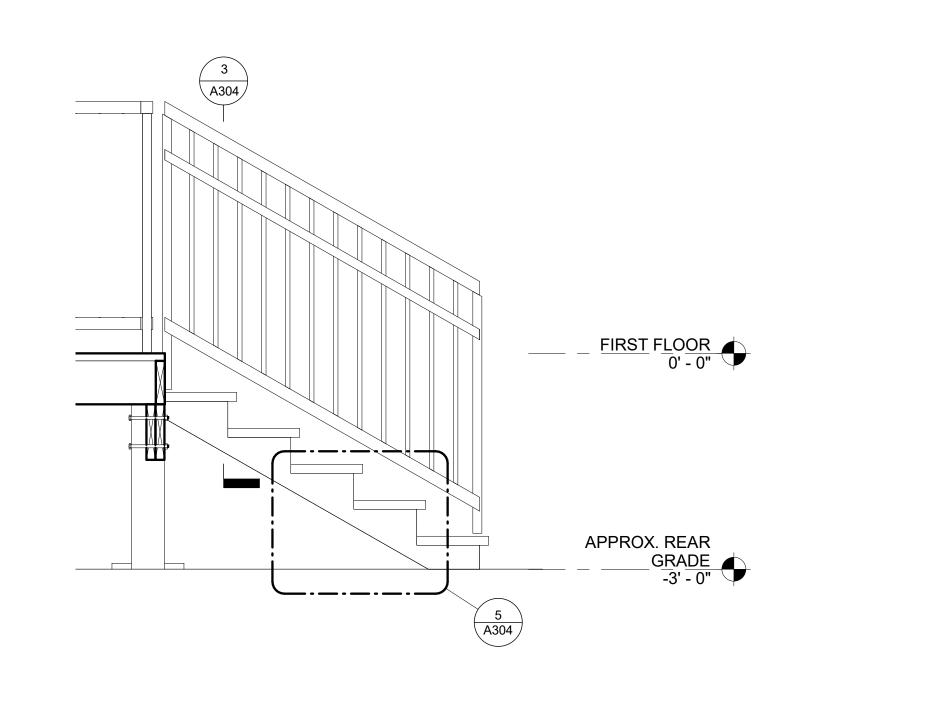
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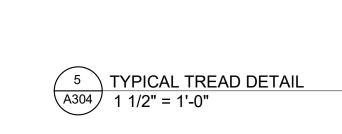
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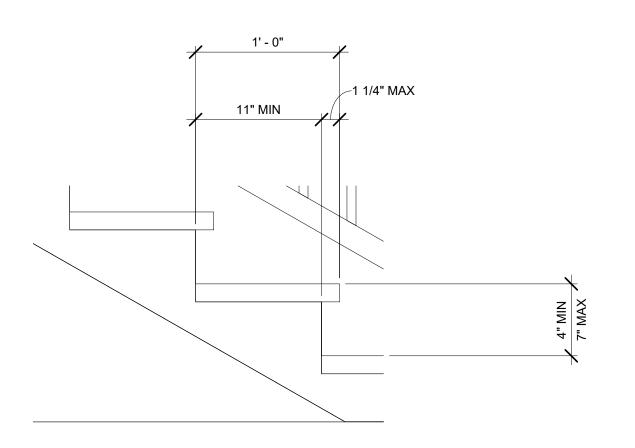
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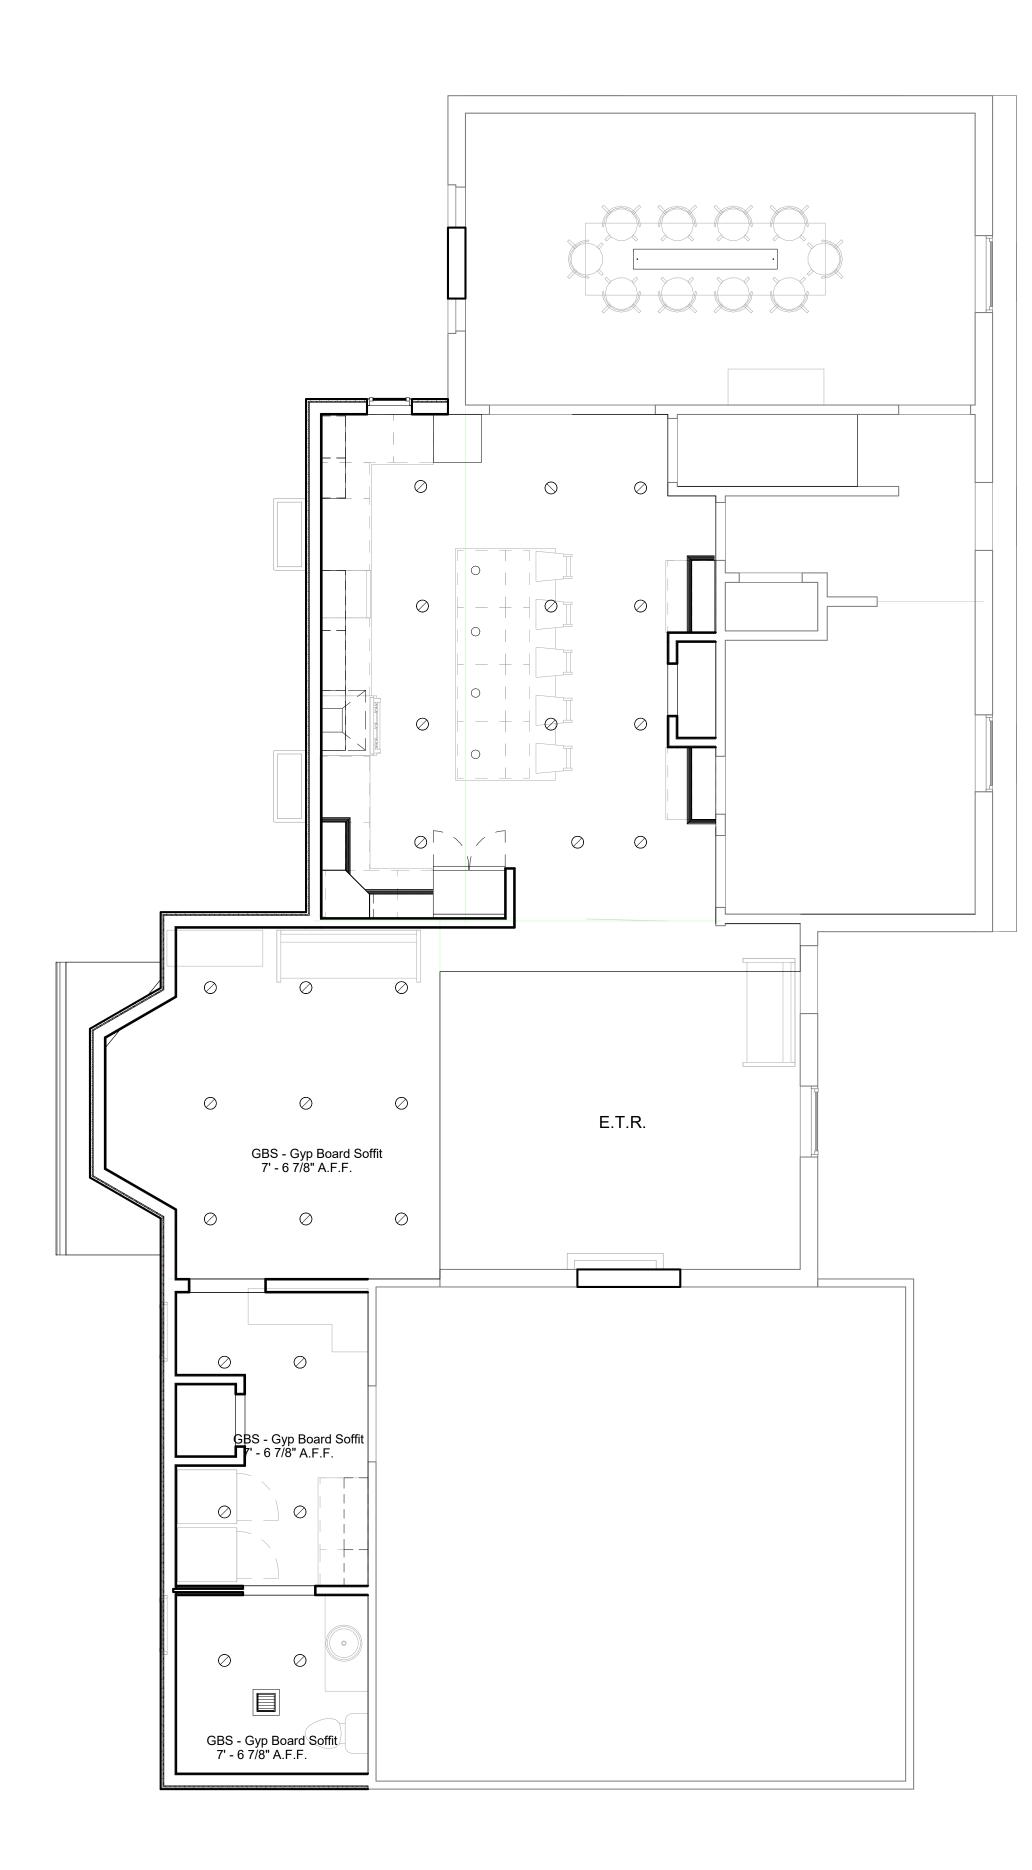
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4 DECK STAIR SECTION 3/4" = 1'-0"







PROPOSED FIRST FLOOR REFLECTED CEILING PLAN
1/4" = 1'-0"

### REFLECTED CEILING KEY

○ = 6" RECESSED DOWN LIGHT

O = PENDENT LIGHT

= EXHAUST FAN

= LINEAR PENDENT

NOTE: COORDINATE LIGHTING WITH OWNER

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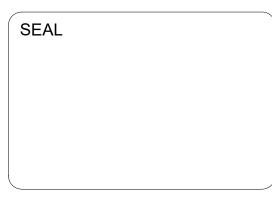
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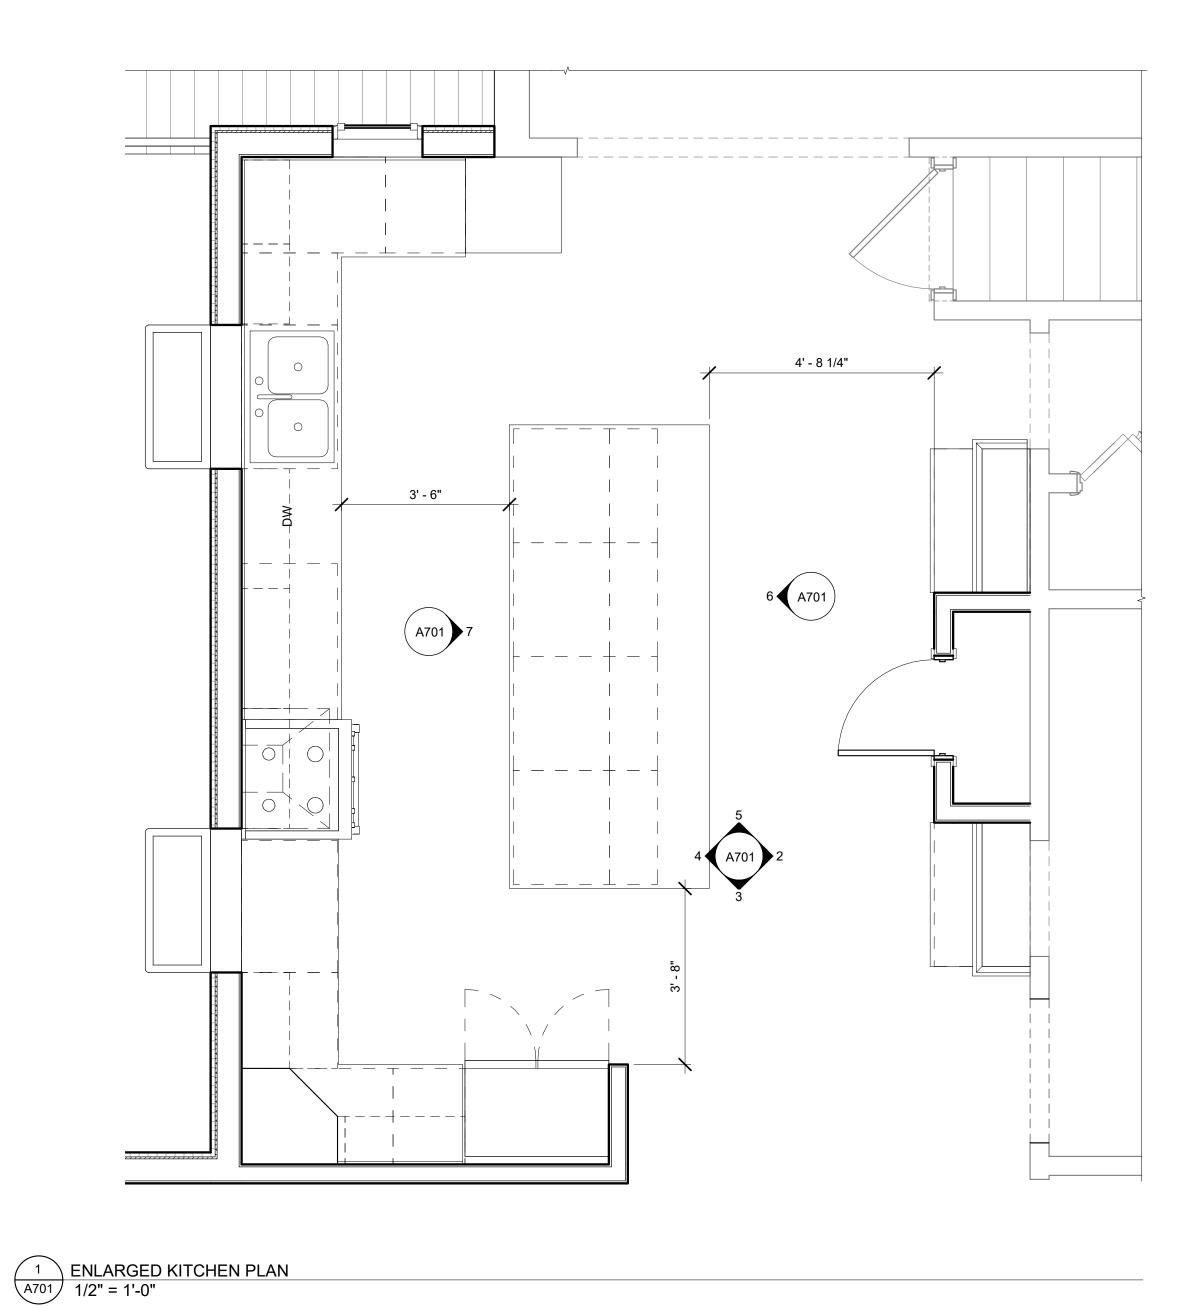
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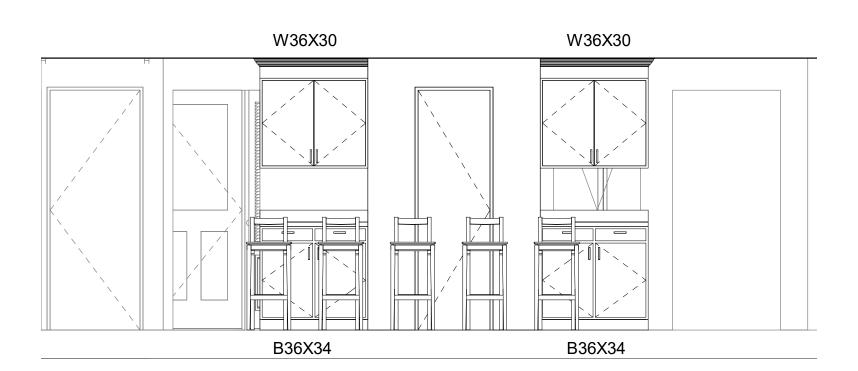
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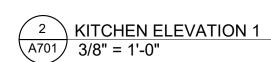
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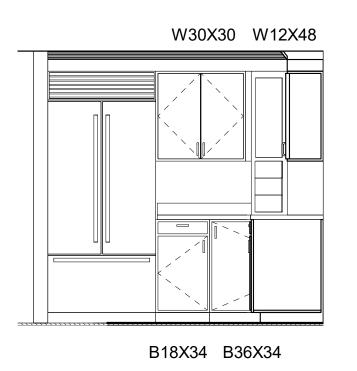
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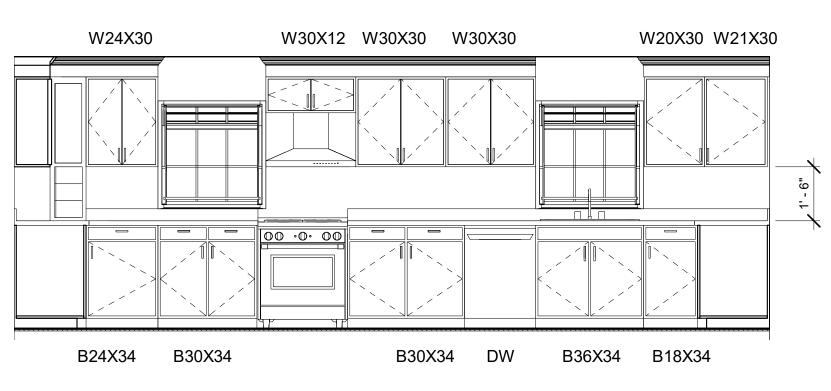











3 KITCHEN ELEVATION 2
A701 3/8" = 1'-0"



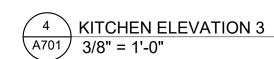


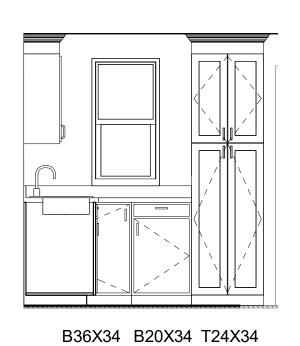

5 KITCHEN ELEVATION 4
3/8" = 1'-0"

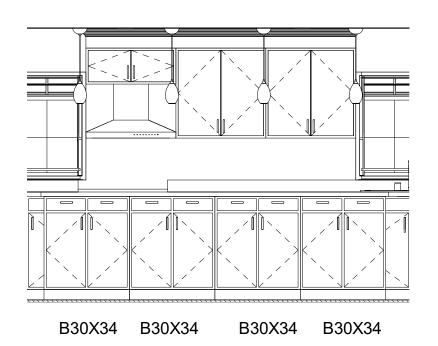

6 KITCHEN ISLAND ELEVATION 1
3/8" = 1'-0"

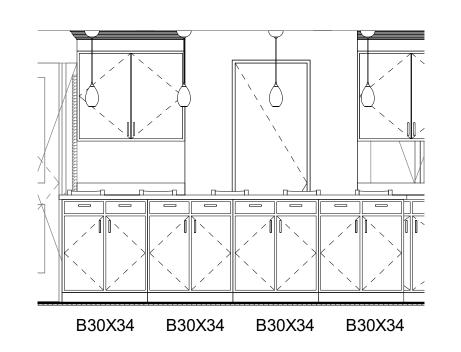

7 KITCHEN ISLAND ELEVATION 2
A701 3/8" = 1'-0"


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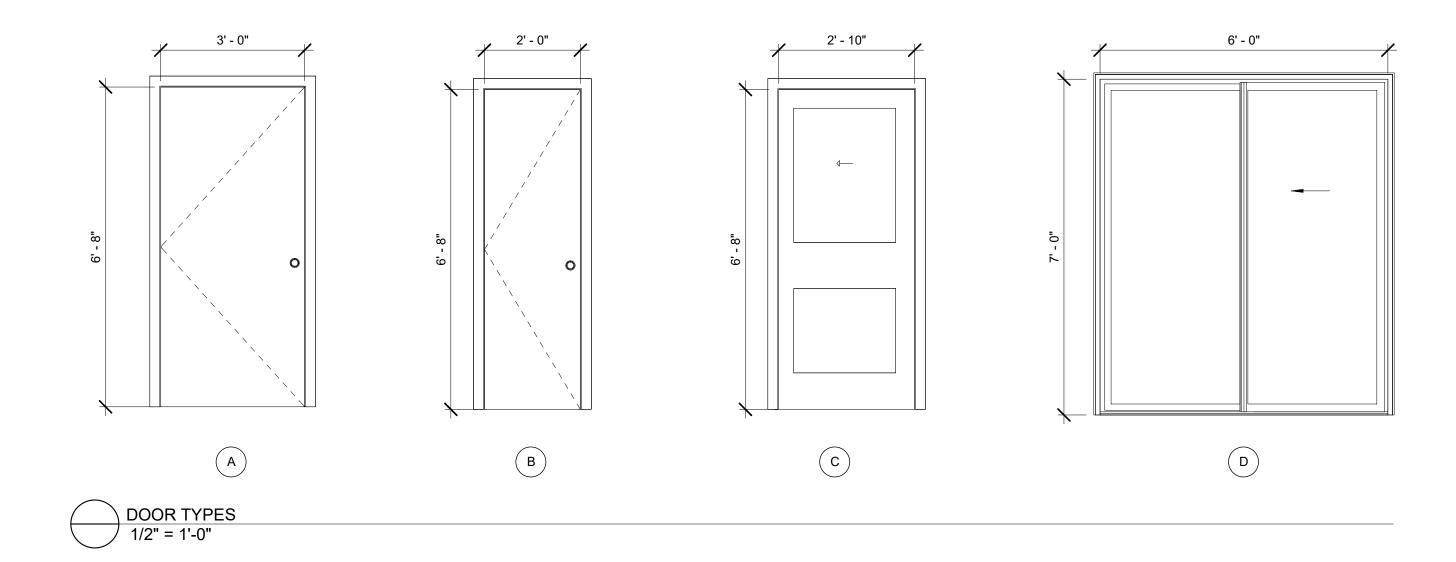
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ENLARGED PLANS AND ELEVATIONS

SHEET NUMBER:



	DOOR SCHEDULE				
MARK	ROOM NAME	WIDTH	HEIGHT	DOOR TYPE	REMARK
102	DINING ROOM	6' - 0"	7 '- 0"	D	
103	KITCHEN	2' - 0"	6' - 8"	В	
105	FAMILY ROOM	3' - 0"	6' - 8"	А	
106	GARAGE	3' - 0"	6' - 8"	А	
107	MUD ROOM	2' - 0"	6' - 8"	В	
108	BATHROOM	2' - 10"	6' - 8"	С	Pocket Door

2' - 5 1/2"	3' - 0"	2'-0"	2' - 6"	3 6.
<u>W1</u>	<u>W2</u>	<u>W3</u>	<u>W4</u>	<u>W5</u>
WINDOW TYPES 1/2" = 1'-0"				

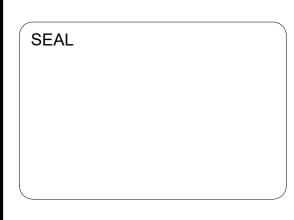WINDOW SCHEDULE					
MARK	WINDOW TYPE	WIDTH	HEIGHT	QUANTITY	REMARK
W1	DOUBLE HUNG	2' - 5 1/2"	3' - 6 1/2"	3	
W2	GARDEN BOX	3' - 0"	3' - 0"	2	
W3	PICTURE	2' - 0"	5' - 0"	2	
W4	PICTURE	2' - 6"	5' - 0"	2	

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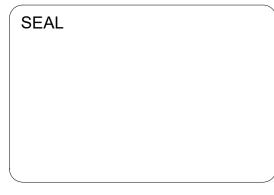
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## **REVISIONS**:

MARK DESCRIPTION DATE



3 N. Main St, Suite #2 Honeoye Falls, NY 14472 Phone: (585) 582-6277 www.WolfeArchitecture.com



## OWNER:

MR & MRS HAMANN

PROJECT:

## Hamann Residence

LOCATION:

323 EAST ST. PITTSFORD, NY 14534

DATE:	7/20/2020 1:5	53:02 PM
ARCHITEC	Γ:	RHV
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JOB NUMBI	ER:	19-11
FILE: W:\Projects\1	9-117 Hamann Residence\3 [ Residence.rvt	Drawings\20 07
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DRAWING:


## DOOR & WINDOW SCHEDULES

SHEET NUMBER:







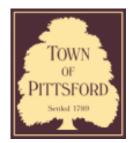

#### **Town of Pittsford**

Department of Public Works 11 South Main Street Pittsford, New York 14534

Permit # B20-000092

Phone: 585-248-6250 FAX: 585-248-6262

## DESIGN REVIEW AND HISTORIC PRESERVATION BOARD REFERRAL OF APPLICATION

Property Address: 355 East Street PITTSFORD, NY 14534

**Tax ID Number:** 178.16-2-23

Zoning District: RN Residential Neighborhood

Owner: Sashittal, Hemant C Applicant: Sashittal, Hemant C

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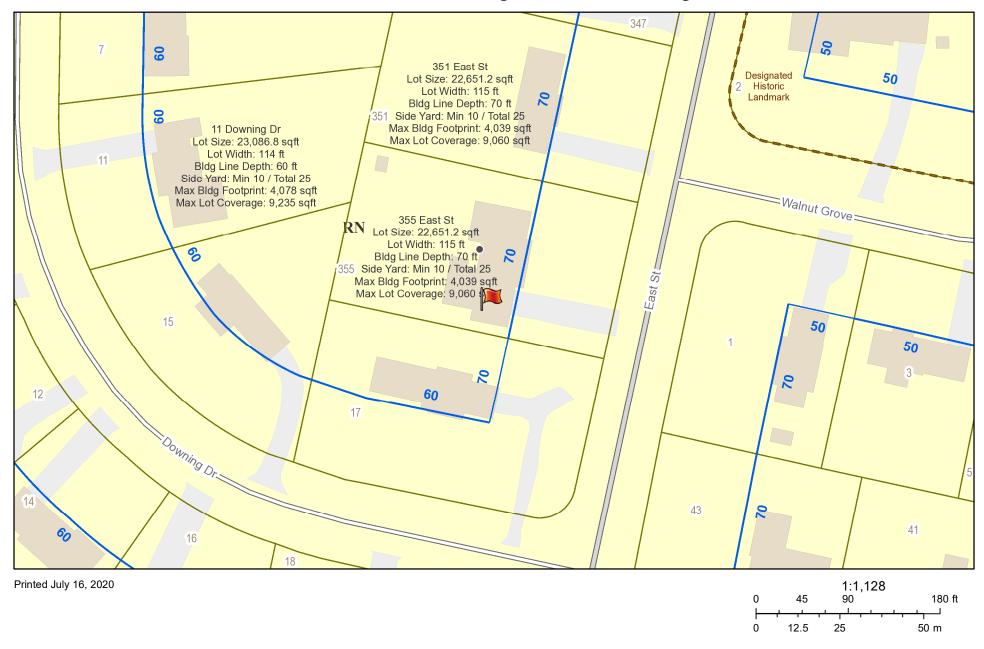
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<b>✓</b>	Residential Design Review §185-205 (B)	Build to Line Adjustment §185-17 (B) (2)	
	Commercial Design Review §185-205 (B)	Building Height Above 30 Feet §185-17 (M)	
	Signage §185-205 (C)	Corner Lot Orientation §185-17 (K) (3)	
	Certificate of Appropriateness §185-197	Flag Lot Building Line Location §185-17 (L) (1) (c)	
	Landmark Designation §185-195 (2)	Undeveloped Flag Lot Requirements §185-17 (L) (2)	
	Informal Review		

**Project Description:** Applicant is requesting design review for the garage extension. The extension will be approximately 72 sq. ft. and will be located behind the 3rd bay of the garage.


Meeting Date: July 23, 2020



### RN Residential Neighborhood Zoning



Town of Pittsford GIS

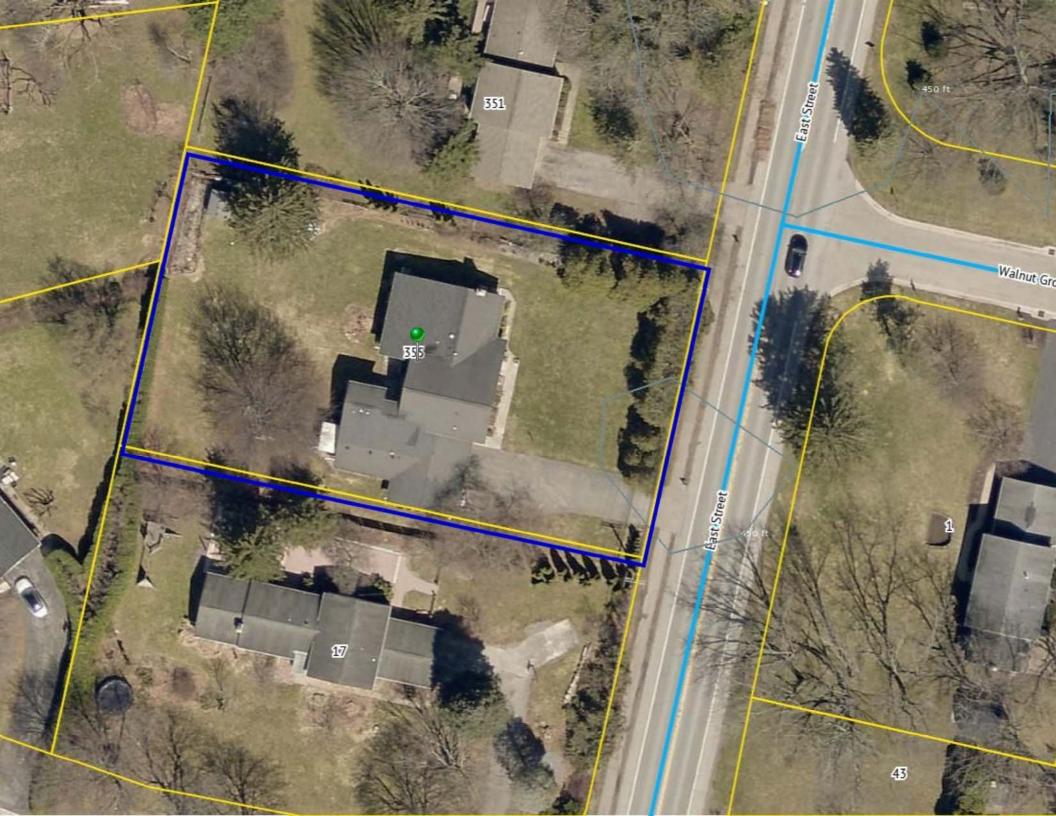

From: Hemant C. Sashittal

355 East Street, Pittsford NY 14534

Tel: 585 218 0692 Email: <a href="mailto:sashi@sjfc.edu">sashi@sjfc.edu</a>

To: Town of Pittsford

**Application for Building Permit** 

Please consider this letter and the attached form as my application for a building permit.

I want to extend my garage; the best way to explain that is to show you the site map, and a few drawings.

#### Exhibit 1

Please see the hand drawn section. The extension will be *behind* the third car garage (to the left of the drawing, at the south end of the map). The garage wall is 9 feet broad; the extension will be 9 feet broad and will be flush with the south facing garage wall.

The drawing below shows the proposed footprint of the extension. There will be no outside access to the structure, it will be accessible from inside the garage. The floor will be poured concrete to integrate with current floor. The side walls will be framed by lumber, and covered with siding to integrate with siding outside (white color).


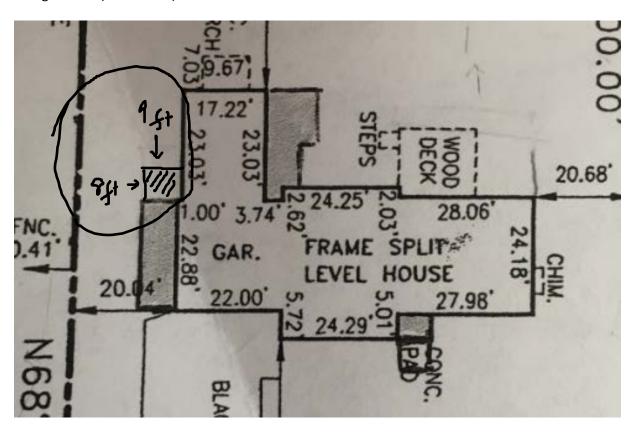



Exhibit 2
This is what it would look life if seen from the back.
The curved lines at the bottom and right are meant to signify gravel. The perimeter, shown later, is gravel, then two tiers of cinderblocks (placed partly in a trench along perimeter).



Exhibit 3: Back view
As can be seen, there is a privacy fence between our property and the immediate neighbor.

I am showing the footprint below.

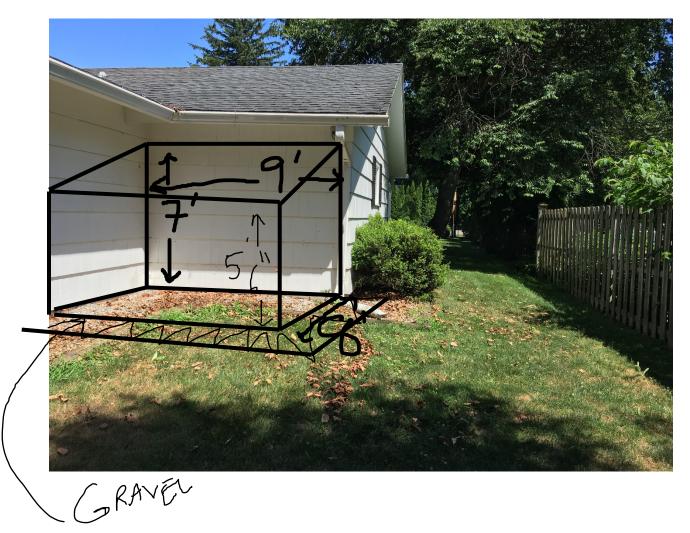

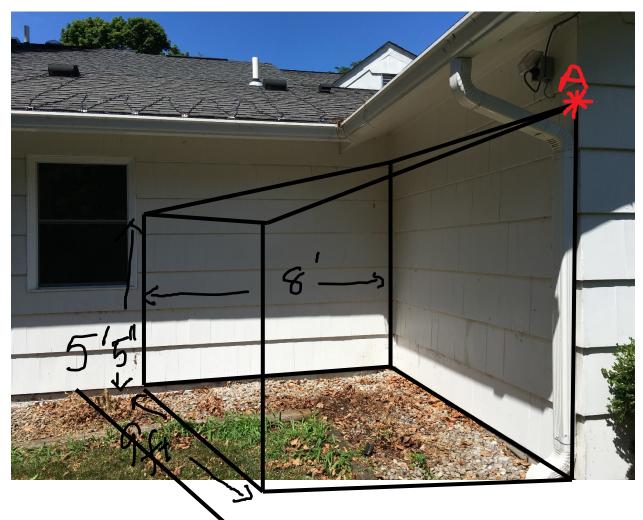

Note:

The roof line is not integrated with that of the main structure

The footprint is 9 feet by 8 feet.

Roof touching the existing structure at point A, is 7 feet high.

The roof at the other end is 5 feet 6 inches.

There are no windows. The siding shingles removed from the walls will be reused on the side, others added to match the finish and paint (I have shingles in stock).

All fire codes will be followed.


#### Exhibit 5

#### Ground Prep.

At the perimeter, a trench will be dug, cinder blocks placed.

Inside the perimeter, earth will be excavated, graveled, and cement poured to be flush with the floor of the garage.

The right end wall will be gone. A header (3 2x6s across on pillars of three 2X6s).

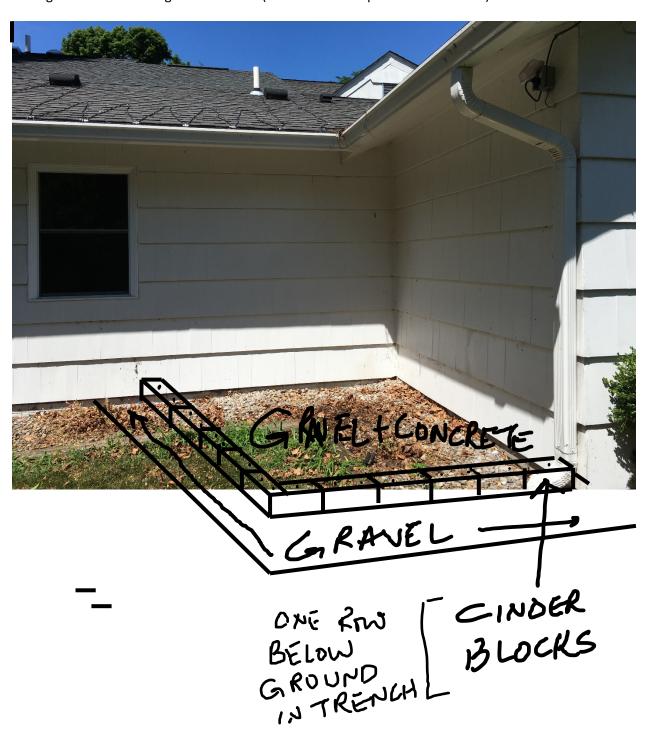









#### **Town of Pittsford**

Department of Public Works 11 South Main Street Pittsford, New York 14534

Permit # B20-00093

Phone: 585-248-6250 FAX: 585-248-6262

## DESIGN REVIEW AND HISTORIC PRESERVATION BOARD REFERRAL OF APPLICATION

Property Address: 16 Ravenna PITTSFORD, NY 14534

**Tax ID Number:** 177.03-5-29

Zoning District: IZ Incentive Zoning Owner: Clover Street Development Applicant: Clover Street Development

	Αpi	plica	ation	Tvp	e:
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application Type:	
Residential Design Review §185-205 (B)	Build to Line Adjustment §185-17 (B) (2)
Commercial Design Review §185-205 (B)	Building Height Above 30 Feet §185-17 (M)
Signage §185-205 (C)	Corner Lot Orientation §185-17 (K) (3)
Certificate of Appropriateness §185-197	Flag Lot Building Line Location §185-17 (L) (1) (c)
Landmark Designation §185-195 (2)	Undeveloped Flag Lot Requirements §185-17 (L) (2)
Informal Review	

**Project Description:** Applicant is requesting design review for the construction of a two story single family home. The home will be approximately 2800 sq. ft. and will be located in the Coventry Ridge Subdivision.


Meeting Date: July 23, 2020



### RN Residential Neighborhood Zoning




Printed July 16, 2020

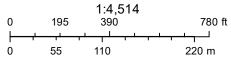

Town of Pittsford GIS

The information depicted on this map is representational and should be used for general reference purposes only. No warranties, expressed or implied, are provided for the data or its use or interpretation.

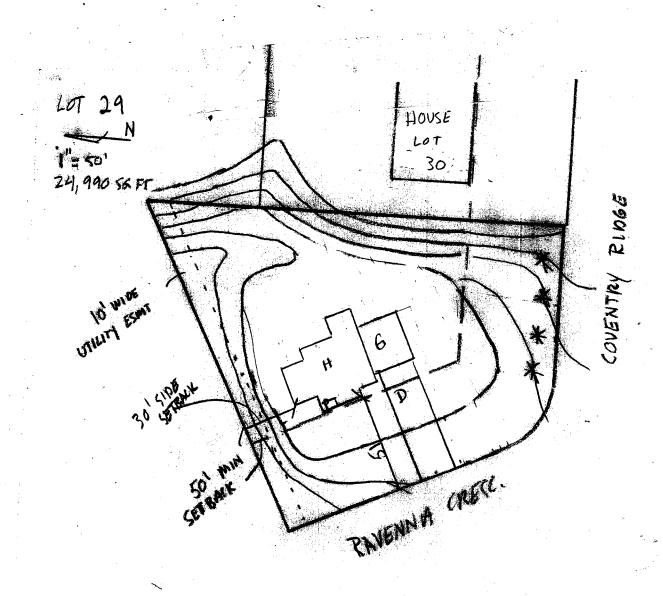



TRADEOFFS FROM SECTION R405 IN CLIMATE ZONES 1-3 SHALL BE 0.50

### **GENERAL NOTES:**

THESE PLANS COMPLY WITH THE 2020 RESIDENTIAL CODE OF NEW YORK STATE ( RCNYS) AND THE 2020 ENERGY CONSERVATION CONSTRUCTION CODE OF NEW YORK STATE ( ECCCNYS ).

COMPLIANCE METHOD: RESCHECK CERTIFICATE OR PRESCRIPTIVE

THESE PLANS ARE PROTECTED UNDER FEDERAL COPYRIGHT LAWS BY GREATER LIVING ARCHITECTURE. ANY UNAUTHORIZED REPRODUCTION OR MODIFICATION OF THESE PLANS IS A VIOLATION OF COPYRIGHT LAWS. CLIENT RIGHTS ARE LIMITED TO ONE-TIME USE FOR THE CONSTRUCTION OF THESE PLANS.

UNAUTHORIZED ALTERATIONS OR ADDITIONS TO THIS PLAN IS A VIOLATION OF THE NEW YORK STATE EDUCATION LAW, ARTICLE 145, SECTION 7209.

IT IS THE RESPONSIBILITY OF THE CONTRACTOR, BUILDER OR OWNER OF THIS BUILDING TO NOTIFY GREATER LIVING ARCHITECTURE OF ANY DEVIATION FROM THESE DRAWINGS.

CONTRACTOR TO BE RESPONSIBLE FOR COMPLIANCE WITH ALL APPLICABLE BUILDING/ ELECTRICAL/ MECHANICAL/ SANITARY AND ENERGY CONSERVATION CODES - STATE AND OR LOCAL.

CONTRACTOR TO BE RESPONSIBLE TO LOCAL BUILDING DEPARTMENT AND THAT DEPARTMENT'S INTERPRETATION OF THE BUILDING CODE SHOULD IT DIFFER FROM THESE PLANS.

CONTRACTOR TO BE RESPONSIBLE THAT BRAND NAME OF WINDOWS AND DOORS INSTALLED MEET NEW YORK STATE

IN THE EVENT OF ANY DISCREPANCIES BETWEEN PLANS, ELEVATIONS, AND/OR DETAILS, THE CONTRACTOR / SUB-CONTRACTOR SHALL CONTACT GREATER LIVING ARCHITECTURE BEFORE CONSTRUCTION FOR CLARIFICATION. IF GREATER LIVING ARCHITECTURE IS NOT CONTACTED, THE CONTRACTOR / SUB-CONTRACTOR WILL ASSUME FULL RESPONSIBILITY.

CONTRACTOR TO BE RESPONSIBLE FOR CONSTRUCTION MEANS, METHODS, TECHNIQUES, SEQUENCES, PROCEDURES

AND SAFETY PRECATIONS/ PROGRAMS IN CONNECTION WITH THE WORK.

THESE DRAWINGS ARE NOT TO BE SCALED FOR DIMENSIONS - USE DIMENSIONS GIVEN. THE CONTRACTOR/ OWNER SHALL REQUEST LOCATION OF ALL UTILITIES PRIOR TO ANY DIGGING.

THE CONTRACTOR SHALL INDEMNIFY THE OWNER AND OWNER'S AGENTS THROUGH ADEQUATE INSURANCE COVERAGE AGAINST

ANY CLAIMS ARISING FROM INJURIES DURING CONSTRUCTION, OR FAILURE TO MAINTAIN SAFE CONDITIONS ON THE SITE. THESE DRAWINGS HAVE BEEN PREPARED FOR STUCTURAL REFERENCE ONLY. ELECTRICAL, MECHANICAL AND OTHER BUILDING SYSTEMS, IF REQUIRED, ARE TO BE DONE BY OTHERS

R806.2 MINIMUM VENT AREA. THE MINIMUM NET FREE VENTILATION AREA SHALL BE  $\frac{1}{150}$  OF THE AREA OF THE VENTED SPACE.

### **ENERGY EFFICIENCY:**

EXPANSION AND CONTRACTION.

R401.3 CERTIFICATE ( MANDATORY ) A PERMANENT CERTIFICATE COMPLETED BY OUR FIRM AND INCLUDED AS THE LAST PAGE OF THE RESCHECK SHALL BE POSTED ON A WALL IN THE SPACE WHERE THE FURNACE IS LOCATED, A UTILITY ROOM OR AN APPROVED LOCATION INSIDE THE BUILDING.

R402.2.4 ATTIC ACCESS SHALL BE INSULATED WITH THE SAME R- VALUE AS THE ATTIC, WEATHER STRIPPED & LATCHED

R402.4 AIR LEAKAGE. THE BUILDING THERMAL ENVELOPE SHALL BE CONSTRUCTED TO LIMIT AIR LEAKAGE IN ACCORDANCE WITH THE REQUIREMENTS OF SECTIONS R402.4.1 THROUGH R402.4.5.

R402.4.1BUILDING THERMAL ENVELOPE . THE BUILDING THERMAL ENVELOPE SHALL COMPLY WITH SECTIONS R402.4.1.1 AND R402.4.1.2. THE SEALING METHODS BETWEEN DISSIMILAR MATERIALS SHALL ALLOW FOR DIFFERENTIAL

R402.4.1.1 INSTALLATION. THE COMPONENTS OF THE BUILDING THERMAL ENVELOPE AS LISTED IN TABLE 402.4.1.1 SHALL BE INSTALLED IN ACCORDANCE WITH THE MANUFACTURER'S INSTRUCTIONS AND THE CRITERIA LISTED IN TABLE R402.4.1.1, AS APPLICABLE TO THE METHOD OF CONSTRUCTION. WHERE REQUIRED BY THE CODE OFFICIAL, AN APPROVED THIRD PARTY SHALL INSPECT ALL COMPONENTS AND VERIFY COMPLIANCE. SEE PAGE N-2 FOR TABLE.

R402.4.1.2 TESTING.THE BUILDING OR DWELLING UNIT SHALL BE TESTED AND VERIFIED AS HAVING AN AIR LEAKAGE RATE NOT EXCEEDING THREE AIR CHANGES PER HOUR. TESTING SHALL BE CONDUCTED IN ACCORDANCE WITH RESNET/ICC 380, ASTM E779, OR ASTM E1827 AND REPORTED AT A PRESSURE OF 0.2 INCH w.g. (50 PASCALS). TESTING SHALL BE PERFORMED AT ANY TIME AFTER CREATION OF ALL PENETRATIONS OF THE BUILDING THERMAL ENVELOPE. **DURING TESTING:** 

- 1. EXTERIOR WINDOWS AND DOORS, FIREPLACES AND STOVE DOORS SHALL BE CLOSED, BUT NOT SEALED, BEYOND THE INTENDED WEATHERSTRIPPING OR OTHER INFILTRATION CONTROL MEASURES.
- 2. DAMPERS INCLUDING EXHAUST, INTAKE, MAKEUP AIR, BACKDRAFT AND FLUE DAMPERS SHALL BE CLOSED, BUT NOT SEALED BEYOND INTENDED INFILTRATION CONTROL MEASURES.
- 3. INTERIOR DOORS, IF INSTALLED AT THE TIME OF THE TEST, SHALL BE OPEN.
- 4. EXTERIOR DOORS FOR CONTINUOUS VENTILATION SYSTEMS AND HEAT RECOVERY VENTILATORS SHALL BE
- CLOSED AND SEALED.
- 5. HEATING AND COOLING SYSTEMS, IF INSTALLED AT THE TIME OF REST, SHALL BE TURNED OFF.

6. SUPPLY AND RETURN REGISTERS, IF INSTALLED AT THE TIME OF REST, SHALL BE FULLY OPEN.

R402.4.5 RECESSED LIGHTING. RECESSED LUMINAIRES INSTALLED IN THE BUILDING THERMAL ENVELOPE SHALL BE SEALED TO LIMIT AIR LEAKAGE BETWEEN CONDITIONED AND UNCONDITIONED SPACES. RECESSED LUMINARIES SHALL BE IC-RATED AND LABELED AS HAVING AN AIR LEAKAGE RATE OF NOT GREATER THAN 2.0 c.f.m (0.944 L/s) WHEN TESTED IN ACCORDANCE WITH ASTM E283 AT A PRESSURE DIFFERENTIAL OF 1.57 p.s.f. (75 Pa.). RECESSED LUMINARIES SHALL BE SEALED WITH A GASKET OR CAULKED BETWEEN THE HOUSING AND THE INTERIOR WALL OR CEILIN COVERING.

R402.5 MAXIMUM FENESTRATION U-FACTOR & SHGC (MANDATORY) THE AREA-WEIGHTED AVERAGE MAXIMUM FENESTRATION U-FACTOR PERMITTED USING TRADEOFFS FROM SECT. R402.1.5 OR R405 SHALL BE .48 IN CLIMATE ZONES 4 & 5 AND 0.40 IN CLIMATE ZONES 6-8 FOR VERTICAL FENESTRATION, & 0.75 IN

CLIMATE ZONES 4-8 FOR SKYLIGHTS. THE AREA-WEIGHTED AVERAGE MAXIMUM FENESTRATION SHGC PERMITTED USING

R403.1.1 PROGRAMMABLE THERMOSTAT. THE THERMOSTAT CONTROLLING THE PRIMARY HEATING AND COOLING SYSTEM SHALL BE CAPABLE OF CONTROLLING THE HEATING AND COOLING SYSTEM ON A DAILY SCHEDULE TO MAINTAIN DIFFERENT TEMPERATURE SET POINTS AT DIFFERENT TIMES OF THE DAY. THIS THERMOSTAT SHALL INC. THE CAPABILITY TO SET BACK OR TEMP. OPERATE THE SYSTEM TO MAINTAIN ZONE TEMPERATURES DOWN TO 55 DEG OR UP TO 85 DEG.. THE THERMOSTAT SHALL INITIALLY BE PROGRAMMED BY THE MANF. WITH A HEATING TEMP. SET POINT NO HIGHER THAN 70 DEG. & A COOLING TEMP. SET POINT NO LOWER THAN 78 DEG.

R403.1.2 HEAT PUMP SUPPLEMENTARY HEAT (MANDATORY). HEAT PUMPS HAVING SUPPLEMENTARY ELECTRIC-RESISTANCE HEAT SHALL HAVE CONTROLS THAT, EXCEPT DURING DEFROST, PREVENT SUPPLEMENTAL HEAT OPERATION WHEN THE HEAT PUMP COMPRESSOR CAN MEET THE HEATING LOAD.

R403.3.1 INSULATION (PRESCIPTIVE) SUPPLY & RETURN DUCTS IN ATTICS SHALL BE INSULATED TO A MIN. OF R-6. WITH THE EXCEPTION OF DUCTS OR PORTIONS THEREOF LOCATED COMPLETELY INSIDE THE BUILDING THERMAL ENVELOPE

R403.3.2 SEALING (MANDATORY). DUCTS, AIR HANDLERS AND FILTER BOXES SHALL BE SEALED. JOINTS AND SEAMS SHALL COMPLY WITH EITHER THE MECHANICAL CODE OF NEW YORK STATE ( MCONYS) OR RCNYS, AS APPLICABLE.

R403.3.3 DUCT TESTING (MANDATORY). DUCTS SHALL BE PRESSURE TESTED TO DETERMINE AIR LEAKAGE BY ONE OF

1. ROUGH IN TEST: TOTAL LEAKAGE SHALL BE MEASURED WITH A PRESSURE DIFFERENTIAL OF 0.1 INCH w.g. (25 Pg) ACCROSS THE SYSTEM, INCLUDING THE MANUFACTURER'S AIR HANDLER ENCLOSURE IF INSTALLED AT THE TIME OF THE TEST. ALL REGISTERS SHALL BE TAPED OR OTHERWISE SEALED DURING THE TEST.

2. POSTCONSTUCTION TEST: TOTAL LEAKAGE SHALL BE MEASURED WITH A PRESSURE DIFFERENTIAL OF 0.1 INCH w.g. (25 Pg) ACCROSS THE SYSTEM, INCLUDING THE MANUFACTURER'S AIR HANDLER ENCLOSURE. ALL REGISTERS SHALL BE TAPED OR OTHERWISE SEALED DURING THE TEST.

R403.3.5 BUILDING CAVITIES (MANDATORY). BUILDING FRAMING CAVITIES SHALL NOT BE USED AS DUCTS OR PLENUMS. R403.4 MECHANICAL SYSTEM PIPING CAPABLE OF CARRYING FLUIDS ABOVE 105 DEGREES F OR BELOW 55 DEGREES F

R403.5.1 HEATED WATER CIRCULATION & TEMPERATURE MAINTENANCE SYSTEMS (MANDATORY). HEATED WATER CIRCULATION SYSTEMS SHALL BE IN ACCORDANCE WITH SECTION R403.5.1.1. HEAT TRACE TEMPERATURE MAINTENANCE SYSTEMS SHALL BE IN ACCORDANCE WITH SECTION R403.5.1.2. AUTOMATIC CONTROLS, TEMPERATURE

SENSORS & PUMPS SHALL BE ACCESSIBLE. MANUAL CONTROLS SHALL BE READILY ACCESSIBLE. R403.5.3 HOT WATER PIPE INSULATION (PRESCRIPTIVE). INSULATION FOR HOT WATER PIPE WITH A MIN. R-3 SHALL BE

APPLIED TO THE FOLLOWING:

- 1. PIPING 3/4" AND LARGER IN NOMINAL DIAMETER.
- 2. PIPING SERVING MORE THAN ONE DWELLING UNIT. 3. PIPING LOCATED OUTSIDE THE CONDITIONED SPACE.
- 4. PIPING FROM THE WATER HEATER TO A DISTRIBUTION MANIFOLD. 5. PIPING LOCATED UNDER A FLOOR SLAB.
- 6. BURIED IN PIPING.

SHALL BE INSULATED TO A MINIMUM OF R-3.

7. SUPPLY & RETURN PIPING IN RECIRCULATION SYSTEMS OTHER THAN DEMAND RECIRCULATION SYSTEMS

R403.6 MECHANICAL VENTILATION (MANDATORY). THE BUILDING SHALL BE PROVIDED WITH VENTILATION THAT MEETS THE REQUIREMENTS OF THE IRC OR IMC, AS APPLICABLE, OR WITH OTHER APPROVED MEANS OF VENTILATION. OUTDOOR AIR INTAKES AND EXHAUSTS SHALL HAVE AUTOMATIC OR GRAVITY DAMPERS THAT CLOSE WHEN THE VENTILATION SYSTEM IS NOT OPERATING

R403.6.1 WHOLE-HOUSE MECHANICAL VENTILATION SYSTEM FAN EFFICACY. MECHANICAL VENTILATION SYSTEM FANS SHALL MEET THE EFFICACY REQUIREMENTS OF TABLE R403.6.1.

R403.7 EQUIPMENT SIZING & EFFICIENCY RATING ( MANDATORY ). HEATING & COOLING EQUIPMENT SHALL BE SIZED IN ACCORDANCE W/ ACCA MANUAL S BASED ON BUILDING LOADS CALCULATED IN ACCORDANCE W/ ACCA MANUAL J OR OTHER APPROVED HEATING & COOLING CALCULATION METHODOLOGIES. NEW OR REPLACEMENT HEATING & COOLING EQUIPMENT SHALL HAVE A EFFICIENCY RATING EQUAL TO OR GREATER THAN THE MINIMUM REQUIRED BY FEDERAL LAW FOR THE GEOGRAPHIC LOCATION WHERE THE EQUIPMENT IS INSTALLED.

R404.1 LIGHTING EQUIPMENT ( MANDATORY ) A MINIMUM OF 90% OF THE LAMPS IN PERMANENTLY INSTALLED LIGHTING FIXTURES SHALL BE HIGH-EFFICACY LAMPS.

THESE PLANS HAVE BEEN PREPARED ACCORDING TO THE 2020 RCNYS AND IECC REQUIREMENTS TO SUIT A GENERAL RANGE OF CONDITIONS THAT MAY BE AFFECTED BY A PARTICULAR BUILDING SITE OR BUILDER/ OWNER CONTRACTUAL AGREEMENT. CONTRACTOR TO BE RESPONSIBLE TO ADAPT THESE PLANS TO SUIT THE NEEDS OF THE BUILDING ON SITE AS REQUIRED, PROVIDED THAT SUCH ADJUSTMENTS DO NOT VIOLATE THE CODE OR ALTER THE STRUCTURAL INTEGRITY OF THE BUILDING.

CONTRACTOR/ OWNER SHALL PERFORM EXPLORATORY EXCAVATION TO DETERMINE ACTUAL FIELD CONDITIONS AND NOTIFY THIS OFFICE OF THE FINDINGS TO ALLOW FOR DESIGN CHANGES PRIOR TO ACTUAL CONSTRUCTION. IT SHALL BE THE RESPONSIBILITY OF THE CONTRACTOR/ OWNER TO DEVELOP THE NECESSARY FOUNDATION SOIL TO SUSTAIN THE LOAD DESIGNS OF 2500 P.S.F. AND TO HIRE, IF NECESSARY, A SOILS ENGINEER TO INSPECT AND VERIFY SOIL CONDITIONS PRIOR TO POURING OF FOUNDATIONS.

THE CONTRACTOR, BUILDER OR OWNER SHALL NOTIFY GREATER LIVING ARCHITECTURE OF ANY UNUSUAL SITE CONDITIONS WHICH MAY EFFECT THE FOUNDATION, DRAINAGE OR STRUCTURAL MEMBERS INCLUDING REQUIREMENTS FOR ADDITIONAL DEPTH OF FOOTINGS, UNSTABLE SOIL CONDITIONS AND HIGH GROUND WATER TABLE.

NO SITE INSPECTIONS ARE TO BE MADE BY THIS OFFICE. CONTRACTOR TO BE RESPONSIBLE FOR MATERIALS AND WORKMANSHIP. SUBSTITUTIONS FOR MATERIALS SPECIFIED TO BE MADE WITH THE PERMISSION OF THE LOCAL BUILDING DEPT.

## SPEC HOUSE

LOT 29 COVENTRY RIDGE PITTSFORD, NY COVENTRY RIDGE BUILDING CORP.

## PLAN 2800 / PROJECT 15420

WIRE MESH

**BOLTS** 

1ST FLOOR

### SHEET INDEX

- C-1 COVER SHEET
- 1/6 FRONT & LEFT ELEVATIONS
- 2/6 RIGHT & REAR ELEVATIONS
- 3/6 BASEMENT & FOUNDATION PLAN
- 4/6 FIRST FLOOR PLAN
- 5/6 SECOND FLOOR & ROOF PLAN
- 6/6 SECTIONS
- N-1 DETAILS
- N-2 REINFORCING NOTES

### REINFORCED STEEL FOUNDATION

ALL FOOTINGS TO REST ON (ORIGINAL) UNDISTURBED SOIL, ASSUMED MINIMUM SOIL BEARING PRESSURE TO BE 2500 P.S.F. CONTRACTOR TO BE RESPONSIBLE FOR ALL SUBGRADE CONDITIONS.

BASEMENT/CELLAR WALLS AND FOOTING DESIGNS ASSUMED PARTIALLY SATURATED SOIL CONDITIONS TO TO THE FULL WALL DEPTH. SHOULD SATURATED CONDITIONS BE ENCOUNTERED, OUR OFFICE SHOULD BE CONTACTED FOR REVIEW AND POSSIBLE REVISIONS TO THE PLANS.

CONTRACTOR ASSUMES FULL RESPONSIBILITY FOR PROVIDING PROPER DRAINAGE SHOULD INTERMITTENT SPRINGS OR PERCHED WATER BE ENCOUNTERED.

POSITIVE DRAINAGE SHALL BE PROVIDED SO THAT FINISHED GRADE SLOPES AWAY FROM PERIMETER WALLS & FOOTINGS.

CONTINUOUS 4" DIAM. PERFORATED DRAIN PIPE SHALL BE PLACED ALONG THE PERIMETER OF THE BASEMENT WALLS WHICH DRAINS TO THE SUMP PUMP. A MINIMUM OF 6" GRANULAR BASE SHALL BE PLACED OVER THE DRAIN TILE AND MINIMUM OF 2" UNDER THE TILE.

CONCRETE AND MASONRY FOUNDATION WALLS SHALL BE CONSTRUCTED AS SET FORTH AS PER TABLES ON N-2.

### **FIREPLACES**

DIRECT VENT GAS FIREPLACE UNIT TO BE SELECTED BY OWNER AND INSTALLED ACCORDING TO MANUFACTURER'S SPECIFICATIONS.

UNDER POST, TO ENSURE SOLID BEARING FROM HEADER OR BEAM DOWN TO FOUNDATION WALL.

NEW WOOD-BURNING FIREPLACES SHALL HAVE TIGHT-FITTING FLUE DAMPERS OR DOORS, AND OUTDOOR COMBUSTION AIR. WHERE USING TIGHT-FITTING DOORS ON FACTORY BUILT FIREPLACES LISTED AND LABELED IN ACCORDANCE WITH UL 127, THE DOORS SHALL BE TESTED AND LISTED FOR THE FIREPLACE. WHERE USING TIGHT FITTING DOORS ON MASONRY FIREPLACES, THE DOORS SHALL BE LISTED AND LABELED IN ACCORDANCE WITH UL 907.

WOOD ROOF TRUSSES ARE TO BE METAL PLATE CONNECTED WOOD CHORD, WOOD WEB TRUSSES. TRUSS LAYOUT IS SCHEMATIC ONLY. TRUSS MANUFACTURER SHALL BE RESPONSIBLE FOR THE DESIGN (INCLUDING SPACING) OF ALL TRUSSES. TRUSSES TO BE DESIGNED AND CERTIFIED BY AN ENGINEER LICENSED IN THE GOVERNING STATE.

PROVIDE ALL TEMPORARY BRACING AND SHORING TO AVOID EXCESSIVE STRESSES AND HOLD STRUCTURAL ELEMENTS IN

PLACE DURING CONSTRUCTION. UNDER ALL CONCEALED WOOD BEARING POSTS, PROVIDE ADDITIONAL WOOD BLOCKING AS REQUIRED IN FLOOR JOIST SPACE

ALL WINDOWS AND DOORS ARE TO BE FRAMED WITH MINIMUM 3-2X6 OR 2-2X8 HEADER UNLESS NOTED OTHERWISE.

BUILDER ASSUMES FULL RESPONSIBILITY FOR MAINTAINING THE STRUCTURAL INTEGRITY OF JOISTS, BEAMS OR STUDS WHICH ARE NOTCHED OR DRILLED TO ACCOMMODATE MECHANICAL OR ELECTRICAL LINES. SEE DETAILS ON PG. N-1 FOR ALLOWABLE DRILLING LOCATION ON BEAMS AND JOISTS.

ALL STRESS GRADE LUMBER CONSTRUCTION SHALL COMPLY WITH AITC TIMBER CONSTRUCTION STANDARDS LATEST EDITION. EACH PIECE SHALL BEAR THE STAMP OF A GRADING RULES AGENCY, APPROVED BY THE AMERICAN LUMBER STANDARDS COMMITTEE . GRADE LOSS RESULTING FROM EFFECTS OF WEATHER, HANDLING, STORAGE, RESAWING, OR DIVIDING LENGTHS WILL BE CAUSE FOR REJECTION.

### STAIRWAY GUARD REQUIREMENTS:

GUARDS SHALL BE LOCATED ALONG AN OPEN SIDED WALKING SURFACE, THAT ARE LOCATED MORE THAN 30 INCHES MEASURED VERTICALLY TO THE FLOOR OR GRADE BELOW AT ANY POINT WITHIN 36 INCHES HORIZONTALLY TO THE EDGE OF THE OPEN SIDE. AS PER SECTION 312.1.1 OF THE 2020 RCNYS.

REQUIRED GUARDS SHALL NOT BE LESS THAN 36 INCHES IN HEIGHT AS MEASURED VERTICALLY ABOVE THE ADJACENT WALKING SURFACE. AS PER SECTION 312.1.2 OF THE 2020 RCNYS.

GUARDS ON THE OPEN SIDES OF STAIRS SHALL HAVE A HEIGHT NOT LESS THAN 34 INCHES. AS PER SECTION 312.1.2 OF THE 2020 RCNYS. WHERE THE TOP OF THE GUARD SERVES AS A HANDRAIL ON THE OPEN SIDES OF THE STAIRS, THE TOP OF THE GUARD SHALL BE

NO LOESS THAN 34 INCHES AND NOT MORE THAN 38 INCHES. AS PER SECTION 312.1.2 OF THE 2020 RCNYS. REQUIRED GUARDS SHALL NOT HAVE OPENINGS FROM THE WALKING SURFACE TO THE REQUIRED GUARD HEIGHT THAT ALLOW THE PASSAGE OF A SPHERE 4 INCHES IN DIAMETER. AS PER SECTION 312.1.3 OF THE 2020 RCNYS.

### GARAGE FIREPROOFING

3/4 HOUR FIRE RESISTANCE RATING REQUIRED BETWEEN HOUSE & GARAGE CAN BE ACHIEVED WITH ONE LAYER 5/8" TYPE X DRYWALL ON GARAGE SIDE AND ONE LAYER 1/2" TYPE X DRYWALL ON THE HOUSE SIDE.

IF HORIZONTAL CONSTRUCTION IS USED TO SEPARATE THE GARAGE FROM LIVING AREA OR BONUS AREAS ABOVE, THEN ONE LAYER OF 5/8" TYPE X DRYWALL ON THE CEILING IS REQUIRED. WHERE THE HORIZONTAL CONSTRUCTION IS A FLOOR-CEILING ASSEMBLY, THE STRUCTURE SUPPORTING THE SEPARATION SHALL ALSO PROTECTED BY 5/8" TYPE X DRYWALL.

### STRUCTURAL MATERIAL SPECIFICATIONS:

ASTM A-185, 6 x 6 - 10/10 W.W.M.

WITH A MIN. FIBER STRESS OF 850 P.S.I.

STRUCTURAL STEEL ASTM A-36, Fy = 36 ksiASTM A-615, Fy = 40 ksi

ALL STUCTURAL MEMBERS, JOISTS, RAFTERS, ETC TO BE #2 GRADE LUMBER ( DOUGLAS FIR-LARCH, HEM-FIR, SOUTHERN PINE OR SPRUCE PINE-FIR )

 $Fc^{\perp} = 750$ 

40 P.S.F.

ASTM A307, Fy - 33 KSI

PLYWOOD CDX, PANEL INDEX LVL, PSL, LSL Fv = 285E x  $10^6$  - 1.9

MASONRY ASTM C90, GRADE N-1, Fm = 1350 PSI ASTM C270, TYPE S MORTAR

Fc = 2000 PSI ASTM C476 GROUT Fc = 2500 PSI MIN. (FOOTINGS, BASEMENT SLAB) CONCRETE

Fc = 3500 PSI MIN. ( GARAGE SLAB, PORCH SLAB, & POURED FOUNDATION WALLS)

LOCAL JURISDICTION DESIGN CRITERIA MAY VARY AND SHALL BE STRICTLY ADHERED TO

LIVING AREA LIVE LOAD 30 P.S.F. LIVING AREA LIVE LOAD 1ST & 2ND FLOOR DEAD LOAD 15 P.S.F. GROUND SNOW LOAD 40 P.S.F. ROOF DEAD LOAD 10 P.S.F.

ALLOWABLE SOIL BEARING 2500 P.S.F. AT MINIMUM 42" BELOW FINISHED GRADE

WIND SPEED 115 MPH, EXPOSURE B CATEGORY B SEISMIC DESIGN SEVERE WEATHERING FROST LINE DEPTH **42 INCHES** SLIGHT TO MODERATE TERMITE DAMAGE DECAY DAMAGE NONE TO SLIGHT WINTER DESIGN TEMPERATURE 1 DEGREE

ICE SHEILD UNDERLAYMENT REQUIRED 24" INSIDE OF EXTERIOR WALL LINE FLOOD HAZARD FIRM - 2008

**ROOF TIE DOWN REQUIREMENTS** R802.11, BASED UPON SPECIFIC ROOF DESIGN


COMPONENTS THAT ARE OF

TRUSS CONSTRUCTION

### TRUSS IDENTIFICATION:

IDENTIFICATION OF FLOOR AND ROOF TRUSS CONSTRUCTION SHALL BE PROVIDED BY SIGN OR SYMBOL & SHALL BE AFFIXED TO THE EXTERIOR WALL OF THE RESIDENTIAL

WITH TRUSS TYPE CONSTRUCTION, PRE-ENGINEERED WOOD CONSTRUCTION AND / OR TIMBER CONSTRUCTION.

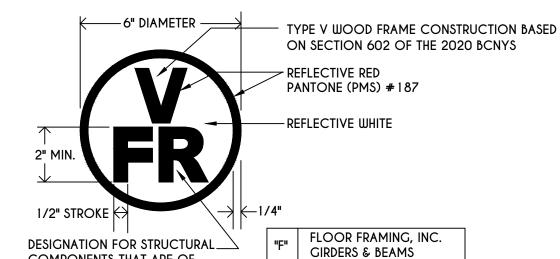

"R" | ROOF FRAMING

"FR" | FLOOR & ROOF FRAMING

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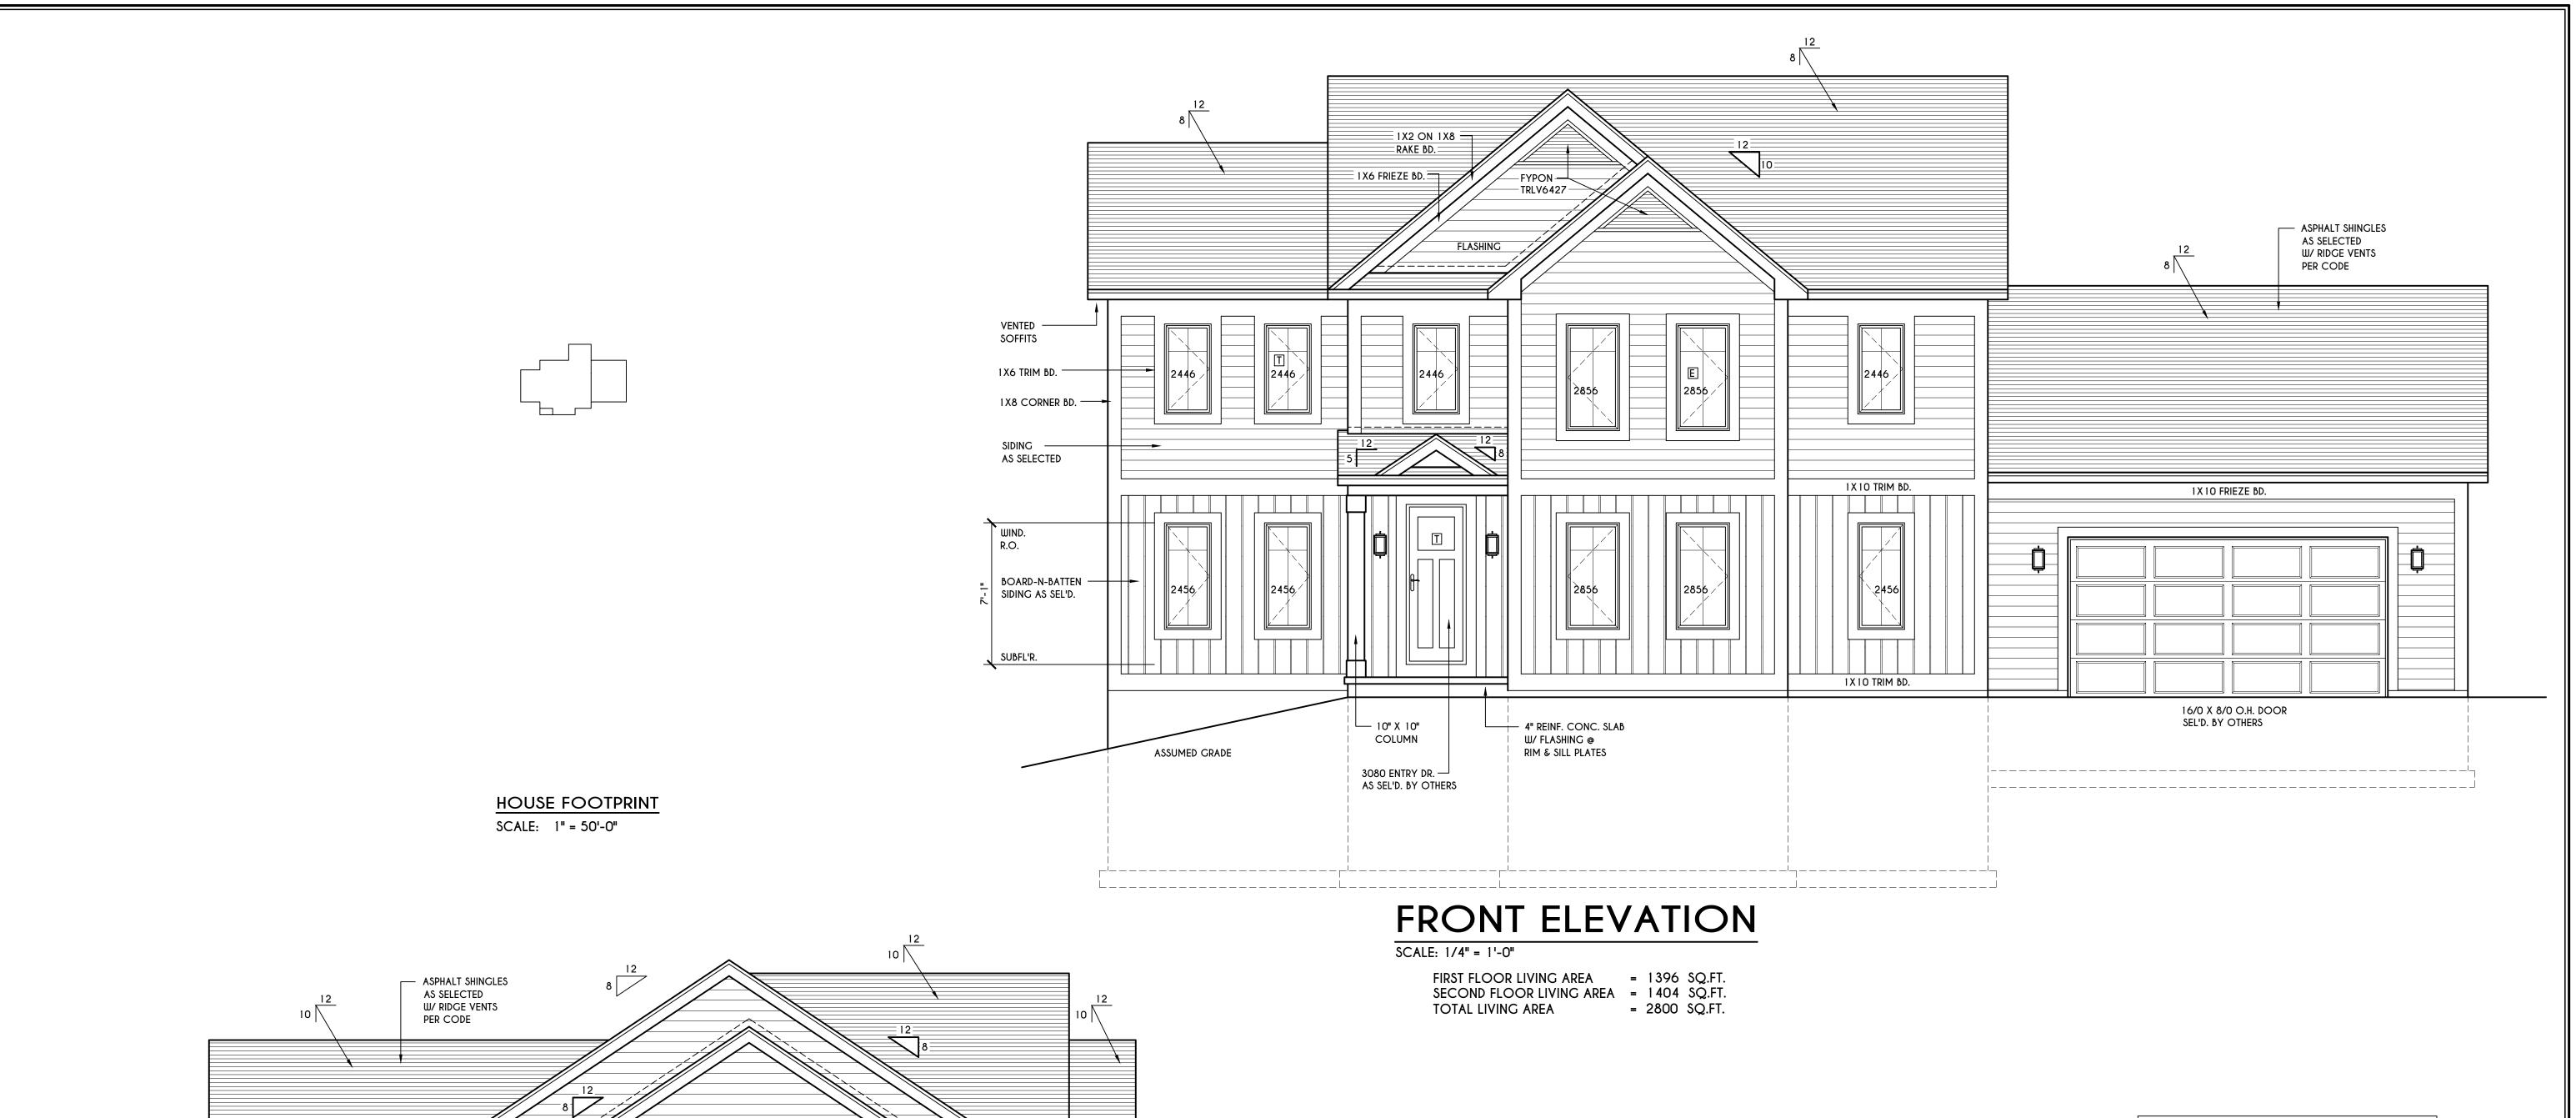
CLIENT/LOCATION: **COVENTRY RIDGE** PITTSFORD, NY

BUILDER: **COVENTRY RIDGE** BUILDING CORP.

**COVER PAGE** 

GLA PLAN 2800

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CONTINUOUS WHOLE-HOUSE MECHANICAL VENTILATION SYSTEM AIRFLOW RATE REQUIREMENTS NUMBER OF BEDROOMS FLOOR AREA 0-1 2-3 4-5 6-7 > 7 (square feet) AIRFLOW IN CFM < 1,500 30 | 45 | 60 | 75 | 90 1,501-3,000 | 45 | 60 | 75 | 90 | 105 3,001-4,500 | 60 | 75 | 90 | 105 | 120 4,501-6,000 | 75 | 90 | 105 | 120 | 135 6,001-7,500 90 105 120 135 150 > 7,500 105 | 120 | 135 | 150 | 165 FOR SI: 1 square foot=0.0929 m2, 1 cubic foot per min=0.0004719 m3/s

TABLE M 1505.4.3 (1)

INTERMITTENT WHOLE-HOUSE MECAHANICAL VENTILATION RATE FACTORS a,b

IN EA. 4-HOUR SEGMENT 25% 33% 50% 66% 75% 100% RUN-TIME PERCENTAGE 4 3 2 1.5 1.3 1.0

a. For ventilation system run time values between those given, the factors are permitted to be determined by interpolation. b. Extrapolation beyond the table is prohibited.

TABLE M 1505.4.4 MINIMUM REQUIRED LOCAL EXHAUST RATES FOR ONE AND TWO-FAMILY DWELLINGS

AREA TO BE EXHAUSTED EXHAUST RATES 100 cfm INTERMITTENT OR 25 cfm CONTINUOUS MECHANICAL EXHAUST CAPACITY OF 50 cfm BATHROOMS-TOILET ROOMS INTERMITTENT OR 20 cfm CONTINUOUS FOR SI: 1 CUBIC FT. PER MINUTE = 0.0004719 m 3/s.

WINDOWS: VWD 210C DH SOLAR GAIN W/ ARGON

U-FACTOR ...... 0.29 SHGC ..... 0.56

DOORS: SELECTION BY OWNER

AIR INFILTRATION RATE FOR WINDOWS, SKYLIGHTS, & SLIDING DOORS TO BE NO MORE THAN 0.3 cfm/sf. & SWING DOORS NO MORE THAN 0.5 cfm/sf. AS PER SECT. R402.4.3 OF 2020 ECCCNYS

WINDOW / DOOR LEGEND:

E = MEETS OR EXCEEDS EGRESS REQUIREMENTS - CLEAR OPENING AREA OF 5.7 SQ.FT. - CLEAR OPENING WIDTH OF 20" - CLEAR OPENING HEIGHT OF 24" PER SECT. R3 10.1 OF 2020 RCNYS

T = SPECIFIES THAT THIS FIXED OR OPERABLE UNIT REQUIRES SAFETY GLAZING PER SECT. R308.4 OF 2020 RCNYS

FP = SPECIFIES THAT THIS OPERABLE WINDOW UNIT REQUIRES FACTORY APPLIED FALL PROTECTION PER SECT. R3 12.2 OF 2020 RCNYS

GENERAL NOTES:

ALL RAKES & OVERHANGS ARE TO BE 1'-0" UNLESS NOTED OTHERWISE

BUILDER TO PROVIDE ROOF OR RIDGE VENTS AS PER CODE- THE MINIMUM NET FREE VENTILATION AREA SHALL BE 1/150 OF THE AREA OF THE VENTED SPACE (SECT. R806.2)

CONTRACTOR TO CONTACT THIS OFFICE PRIOR TO CONSTRUCTION IF THE ASSUMED GRADE DEPICTED IS INACCURATE AND / OR WILL ALTER THE DESIGN AND / OR STRUCTURE NOTED.

MECHANICAL VENTILATION RATE:

THIS PLAN AS DESIGNED REQUIRES (MIN) 1 CONTINUOUSLY RUN EXHAUST FAN CAPABLE OF (MIN) 60 c.f.m. WITH A MANUAL OVERIDE SWITCH AS PER SECTION M1505.4.2 OF 2020 RCNYS SEE TABLES M1505.4.3(1) & M1505.4.3(2) & M1505.4.4 ( PAGE 1 )

– WIND. -— 10" X 10" — R.O. – COLUMN - BOARD-N-BATTEN SIDING AS SEL'D. \_ SUBFL'R. \_ 4" REINF. CONC. SLAB W/ FLASHING @ 5040 RIM & SILL PLATES CUSTOM WINDOW <u>L======</u> WELL TO CONFORM L\_\_\_\_\_\_ TO SECT. R310 OF 2020 RCNYS 

1X10 FRIEZE BD.

VENTED SOFFITS

1X8 CORNER BD.

AS SELECTED

— SIDING

LEFT ELEVATION SCALE: 1/4" = 1'-0"

STEPS TO GRADE -

REQ'D BY CODE

W/ GUARD RAIL AS


ASSUMED GRADE

**∦** 2850 ∫

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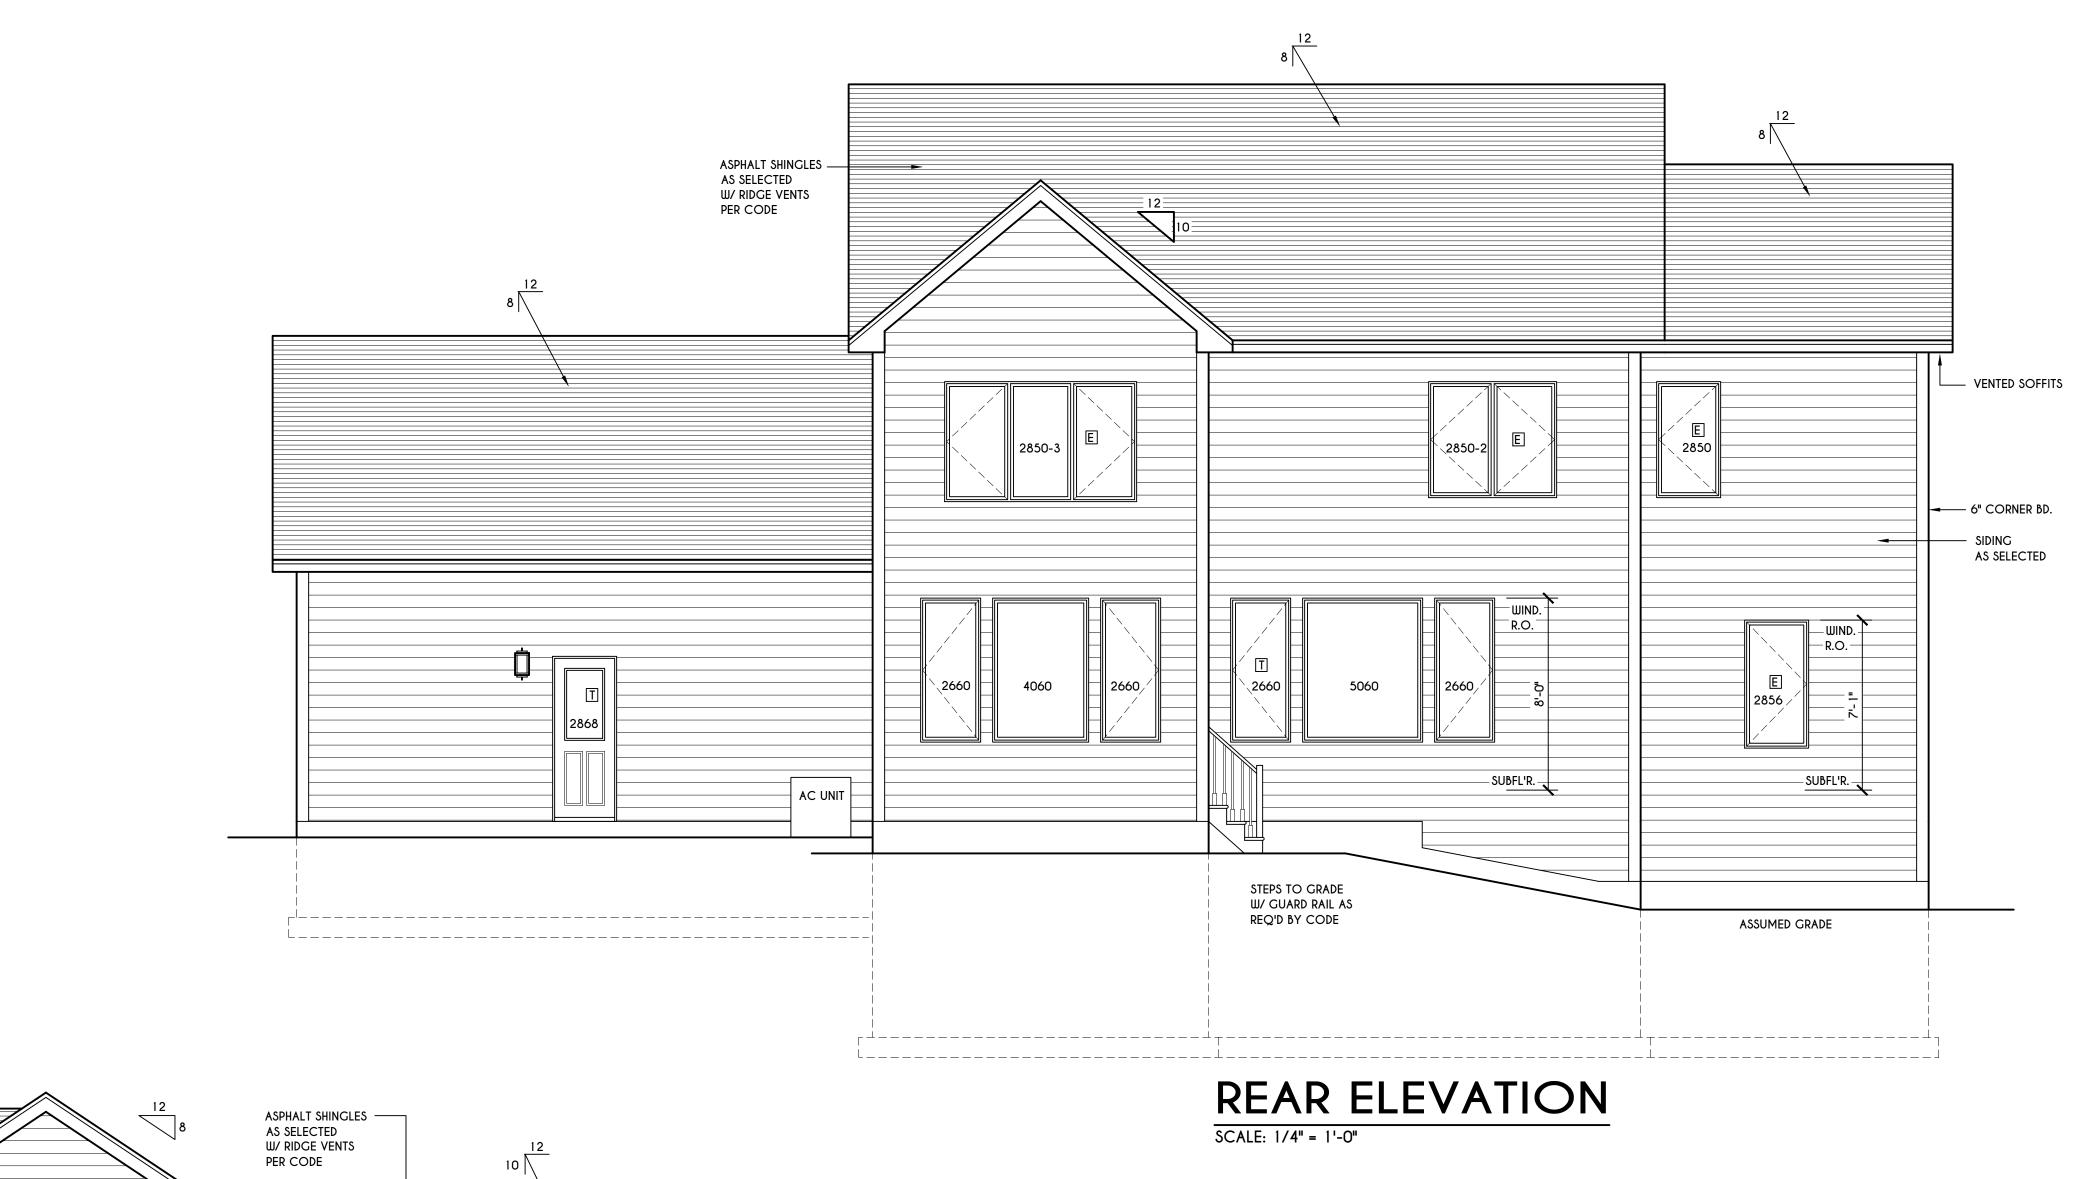
BUILDER:


**COVENTRY RIDGE** BUILDING CORP.

**ELEVATIONS** 

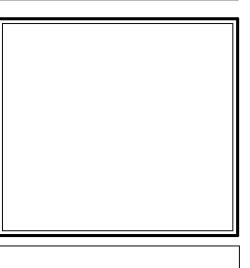GLA PLAN 2800

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RIGHT ELEVATION

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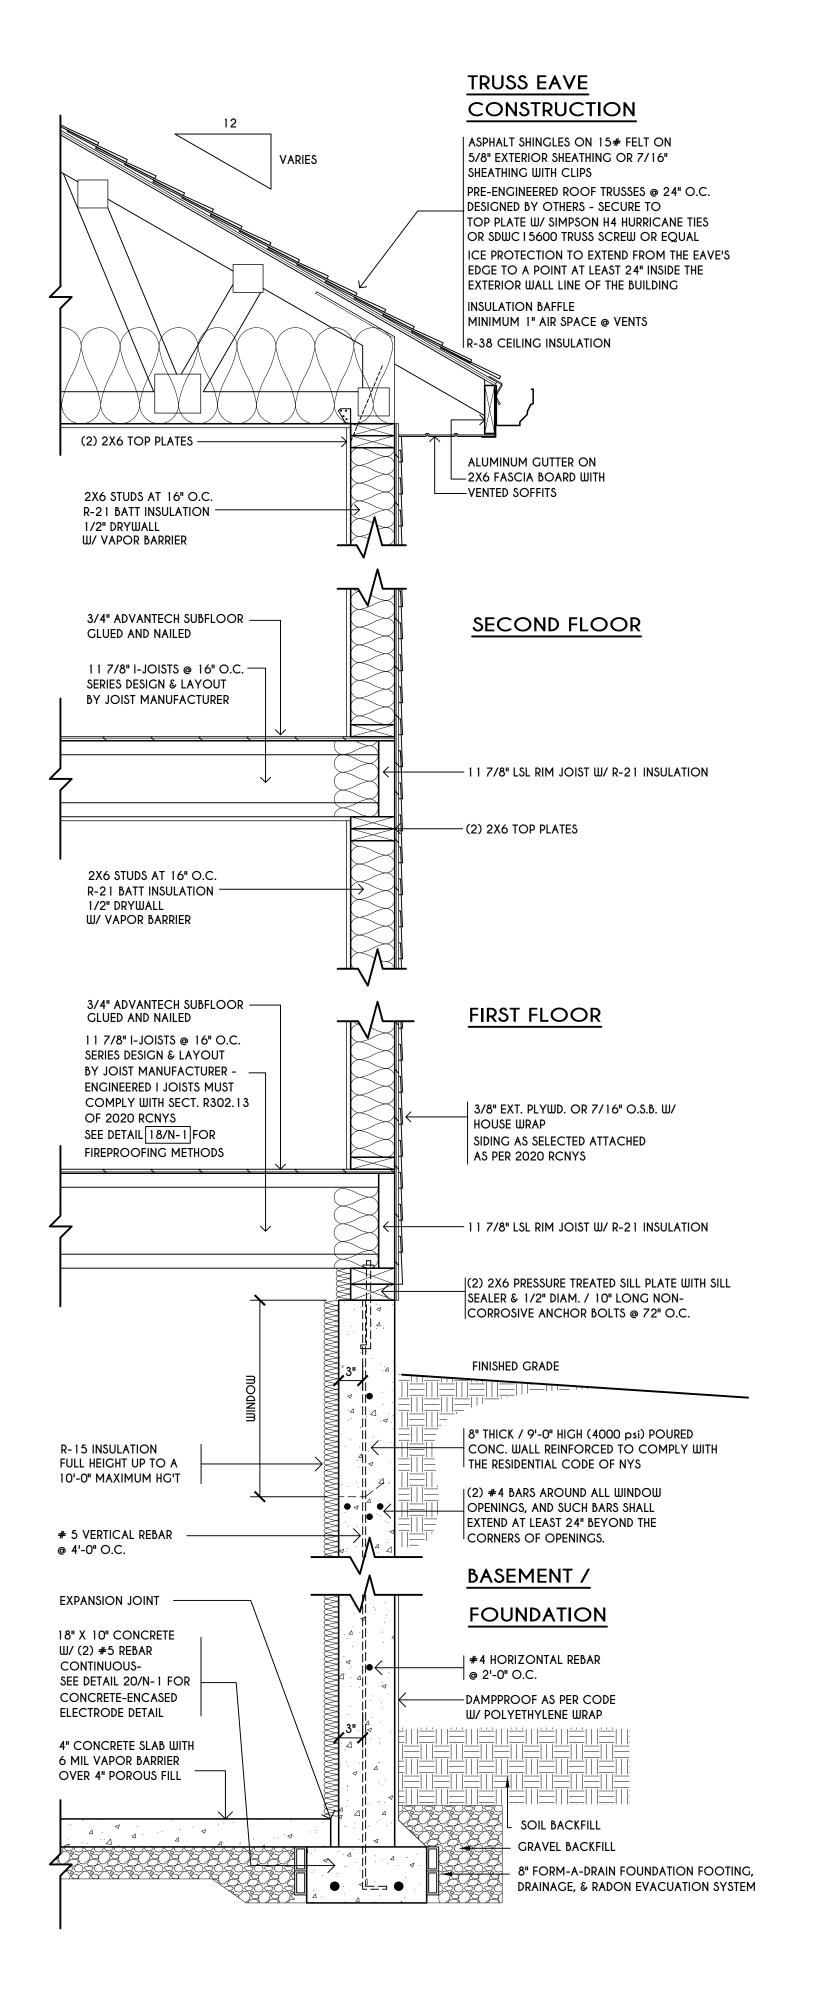
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PITTSFORD, NY

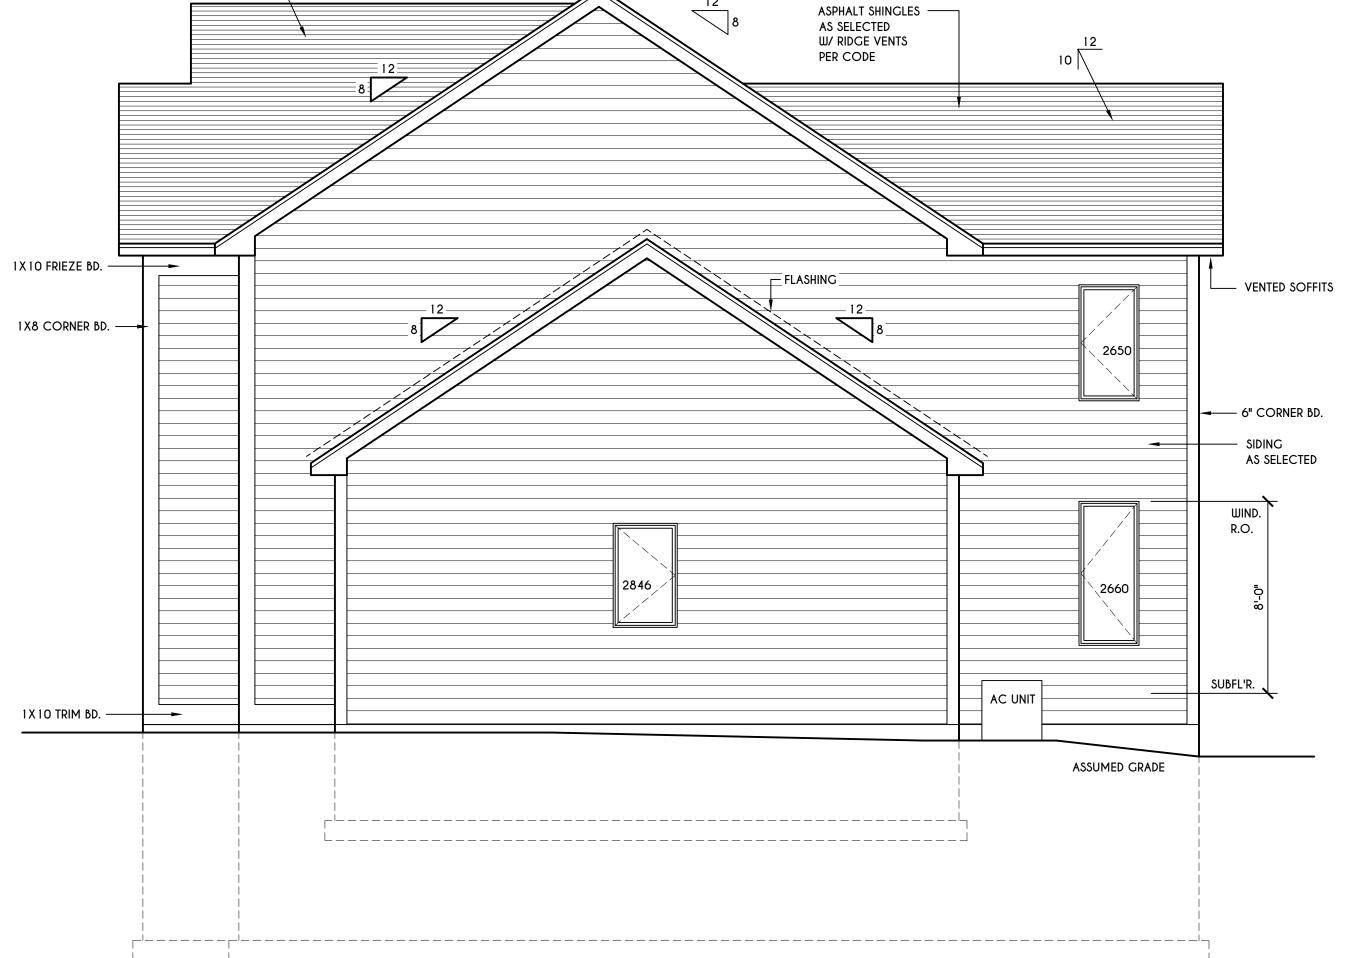BUILDER:


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BUILDING CORP.

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## TYPICAL WALL SECTION



## BASEMENT & FOUNDATION PLAN

SCALE: 1/4" = 1'-0"

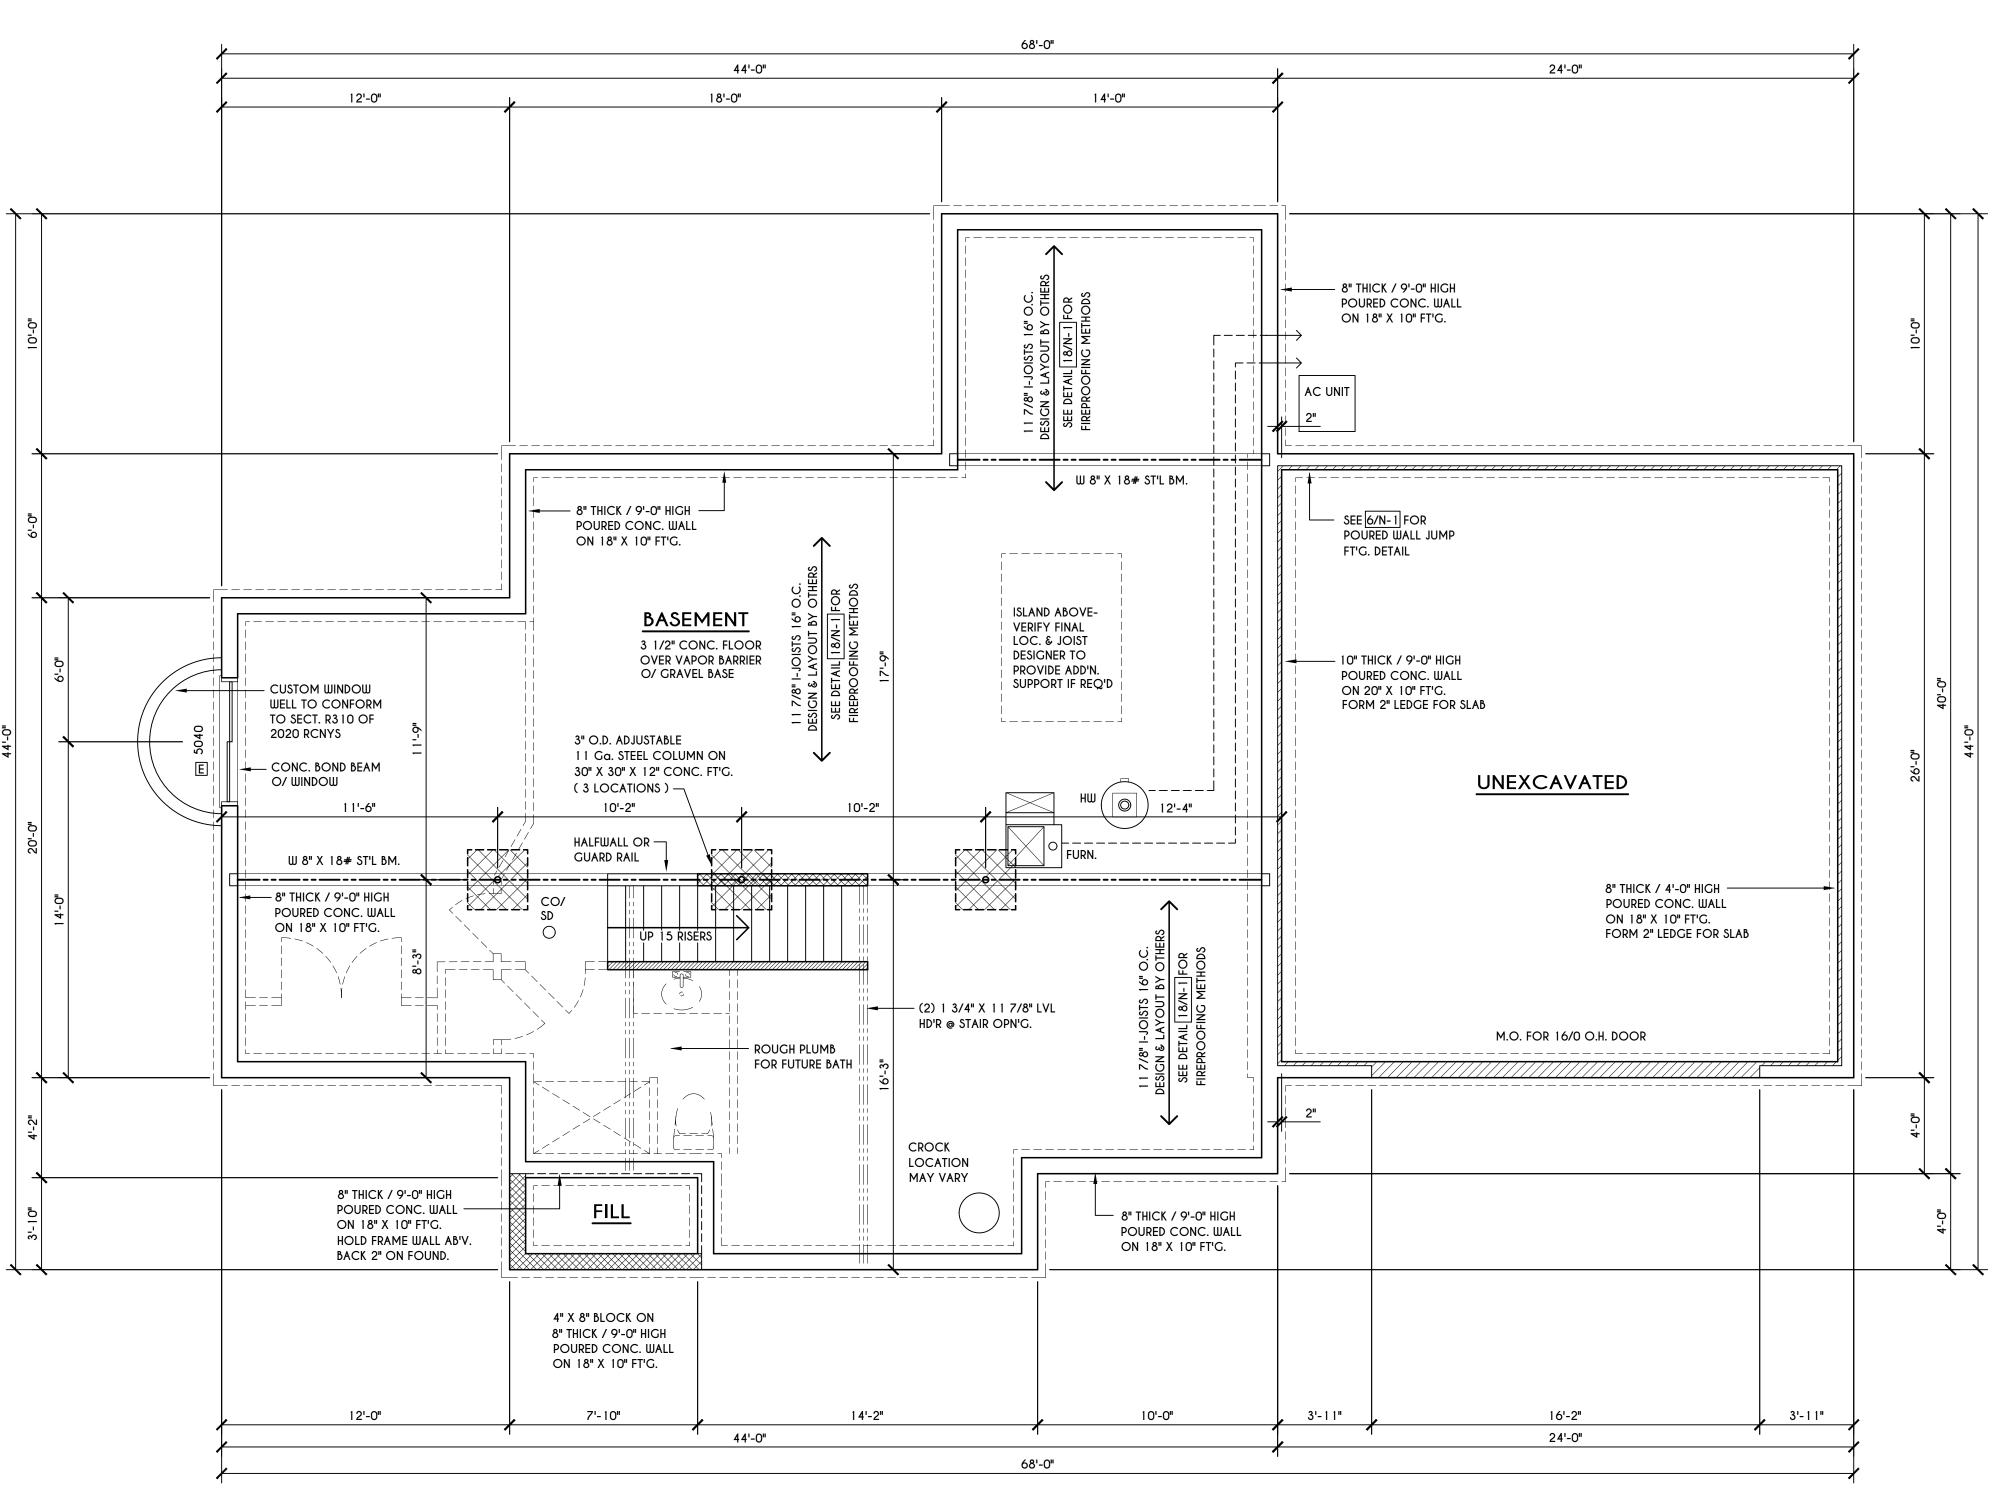ENGINEERED FL'R JOIST NOTE:

ALL ENGINEERED FLOOR JOISTS TO BE DESIGNED BY & LAYOUT TO BE DONE BY

ALL <u>LIVING AREA</u> JOISTS TO BE DESIGNED FOR 55 P.S.F. TOTAL LOAD

DESIGNED FOR 45 P.S.F. TOTAL LOAD

ENGINEERED I JOISTS MUST COMPLY WITH

SEE DETAIL 18/N-1 FOR FIREPROOFING METHODS

ALL <u>SLEEPING AREA</u> JOISTS TO BE

SECT. R302.13 OF 2020 RCNYS

FRAMING LEGEND:

\_\_\_\_ - DROPPED HEADER

- 2X4 STUDS @ 16" O.C.

- 2X6 STUDS @ 16" O.C.

≡≣≣ - FLUSH HEADER

- PROVIDE SOLID POSTING- GLUED & NAILED

EQUAL TO THE # OF HEADERS TO BE

SUPPORTED- UNLESS NOTED OTHERWISE

NOTES: CONTRACTOR TO CONTACT THIS OFFICE PRIOR TO CONSTRUCTION IF THE ASSUMED GRADE DEPICTED IS INACCURATE AND / OR WILL ALTER THE FOUNDATION DESIGN AND /OR STRUCTURE NOTED

ALL WINDOW R.O. HGT'S TO BE 6'-10 1/2" U.N.O.

PROVIDE SOLID BLOCKING UNDER ALL BEARING POINTS DOWN TO FOUNDATION WALL AND / OR BEAMS

PROVIDE DB'L JACK STUDS EA. SIDE OF LOAD BEARING OPENINGS > / = 4'-0"

ALL ANGLES TO BE 45 DEG. U.N.O.

ALL EXTERIOR WINDOW & DOOR HEADERS TO HAVE MIN. R-5 INSUL. & TO BE MIN. (2)2X8'S OR (3)2X6'S ( U.N.O. )

ALL APPLIANCES SHOWN TO BE BY OWNER OR AS PER CONTRACT BY BUILDER

SMOKE (SD) & CARBON MONOXIDE (CO) DETECTORS SHALL BE INSTALLED AS PER SECT. R314 OF 2020 RCNYS REINFORCE FOUNDATION WALLS AS PER 2020 RCNYS. SEE PG. N-2 FOR REINFORCING CHARTS

SEE CONCRETE-ENCASED ELECTRODE DETAIL 19/N-1

### WINDOW / DOOR LEGEND:

- E = MEETS OR EXCEEDS EGRESS REQUIREMENTS - CLEAR OPENING AREA OF 5.7 SQ.FT. - CLEAR OPENING WIDTH OF 20" - CLEAR OPENING HEIGHT OF 24" PER SECT. R310.2.1 OF 2020 RCNYS
- T = SPECIFIES THAT THIS FIXED OR OPERABLE UNIT REQUIRES SAFETY GLAZING PER SECT. R308.4 OF 2020 RCNYS
- FP = SPECIFIES THAT THIS OPERABLE WINDOW UNIT REQUIRES FACTORY APPLIED FALL PROTECTION PER SECT. R312.2 OF 2020 RCNYS

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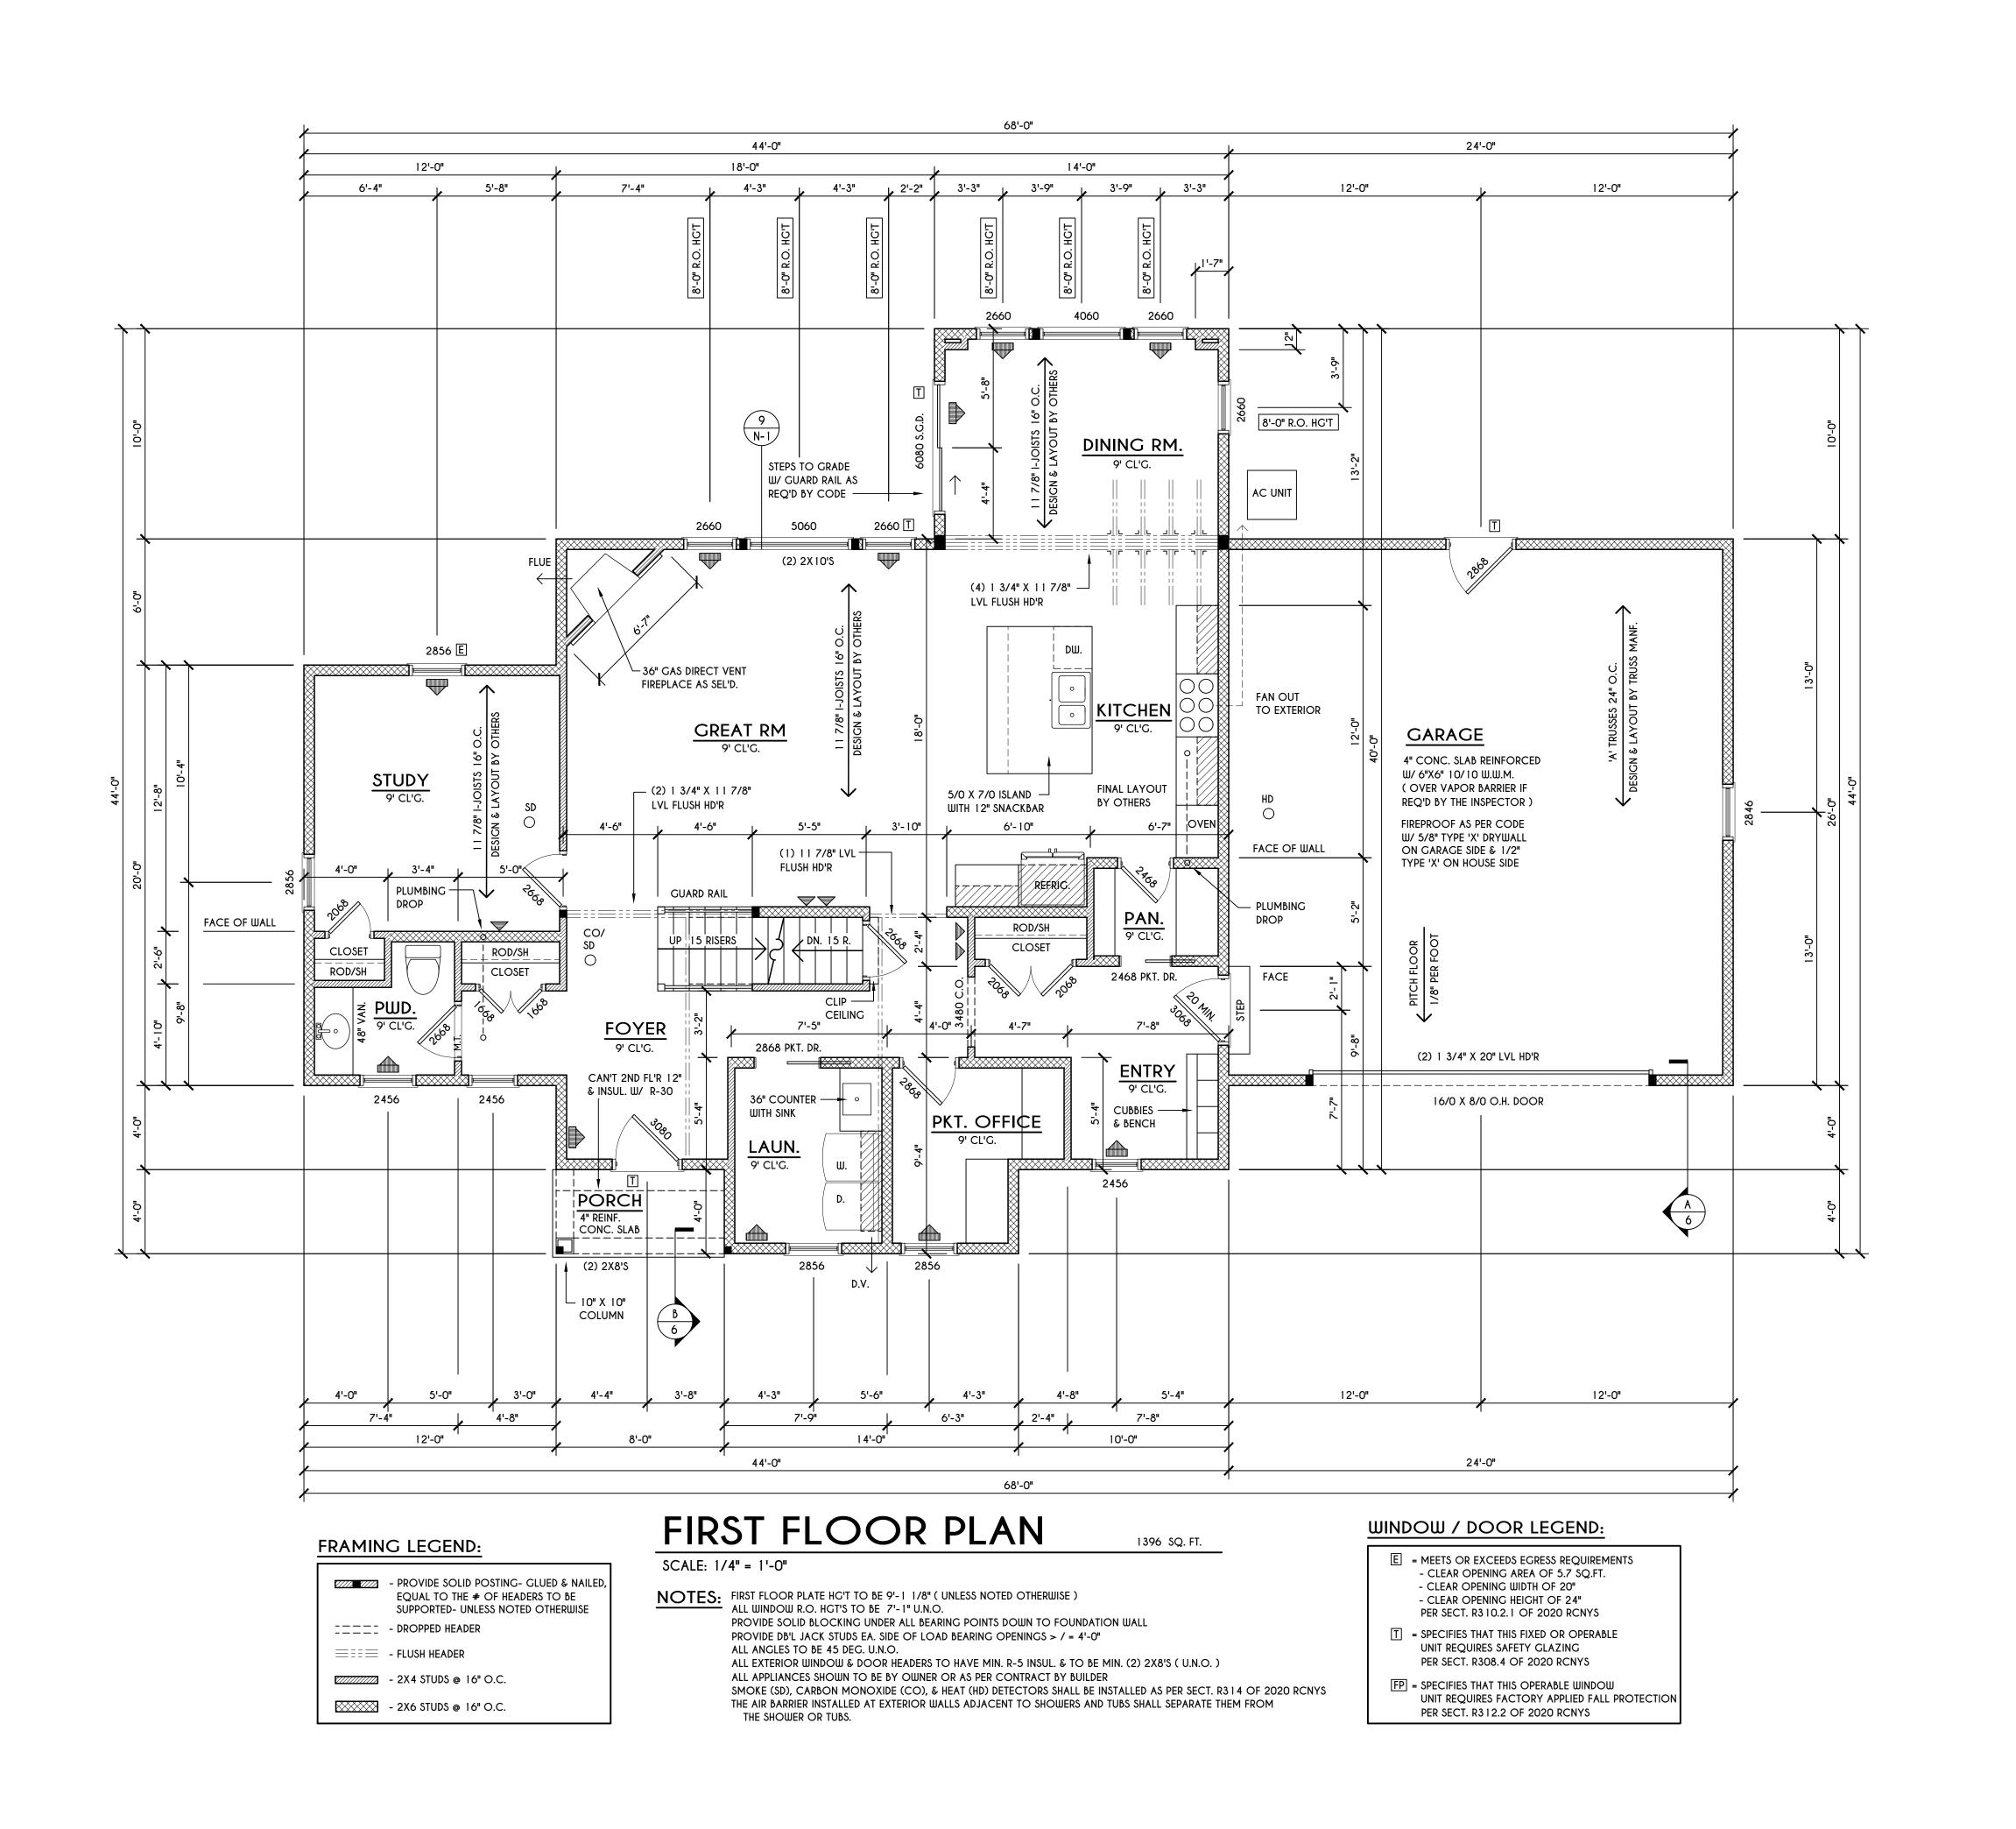
BUILDER:

COVENTRY RIDGE BUILDING CORP.

FOUNDATION PLAN

GLA PLAN 2800

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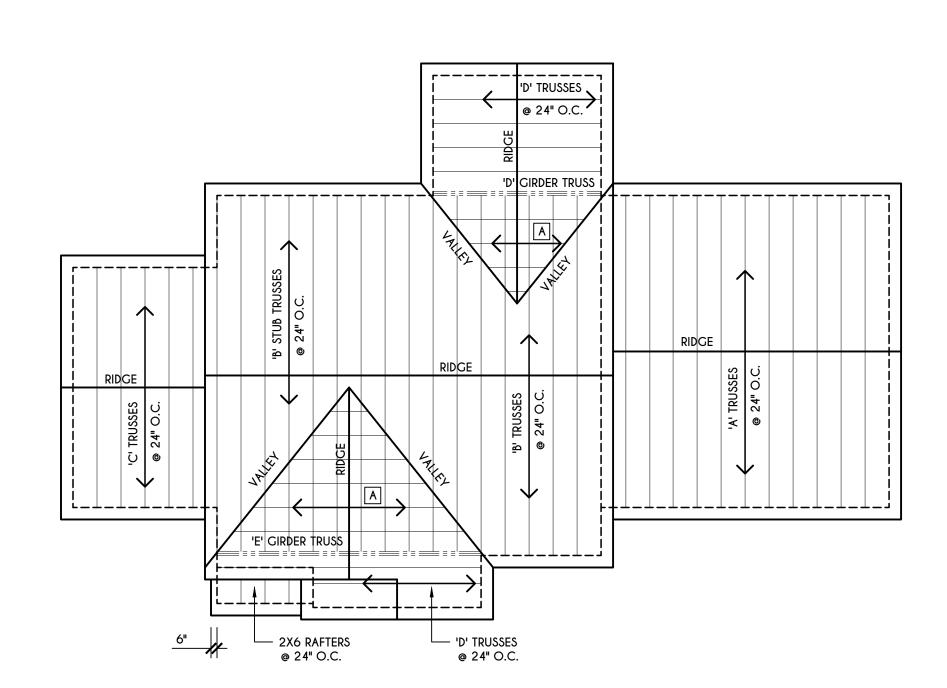
BUILDER:

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FIRST FLOOR PLAN

GLA PLAN 2800

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## ROOF PLAN


SCALE: 1/8" = 1'-0"

A - 2X8 LAYOVER RAFTERS 24" O.C.

ALL RAKES & OVERHANGS ARE TO BE 1'-0" UNLESS NOTED OTHERWISE

ALL NON-STRUCTURAL VALLEYS TO HAVE 2X12 SLEEPER ATTACHED TO PLYWOOD ROOF SHEATHING

THIS FRAMING DIAGRAM IS INTENDED TO BE SCHEMATIC AND POSITION OF MEMBERS MAY BE ALTERED TO SUIT ACTUAL FIELD CONDITIONS

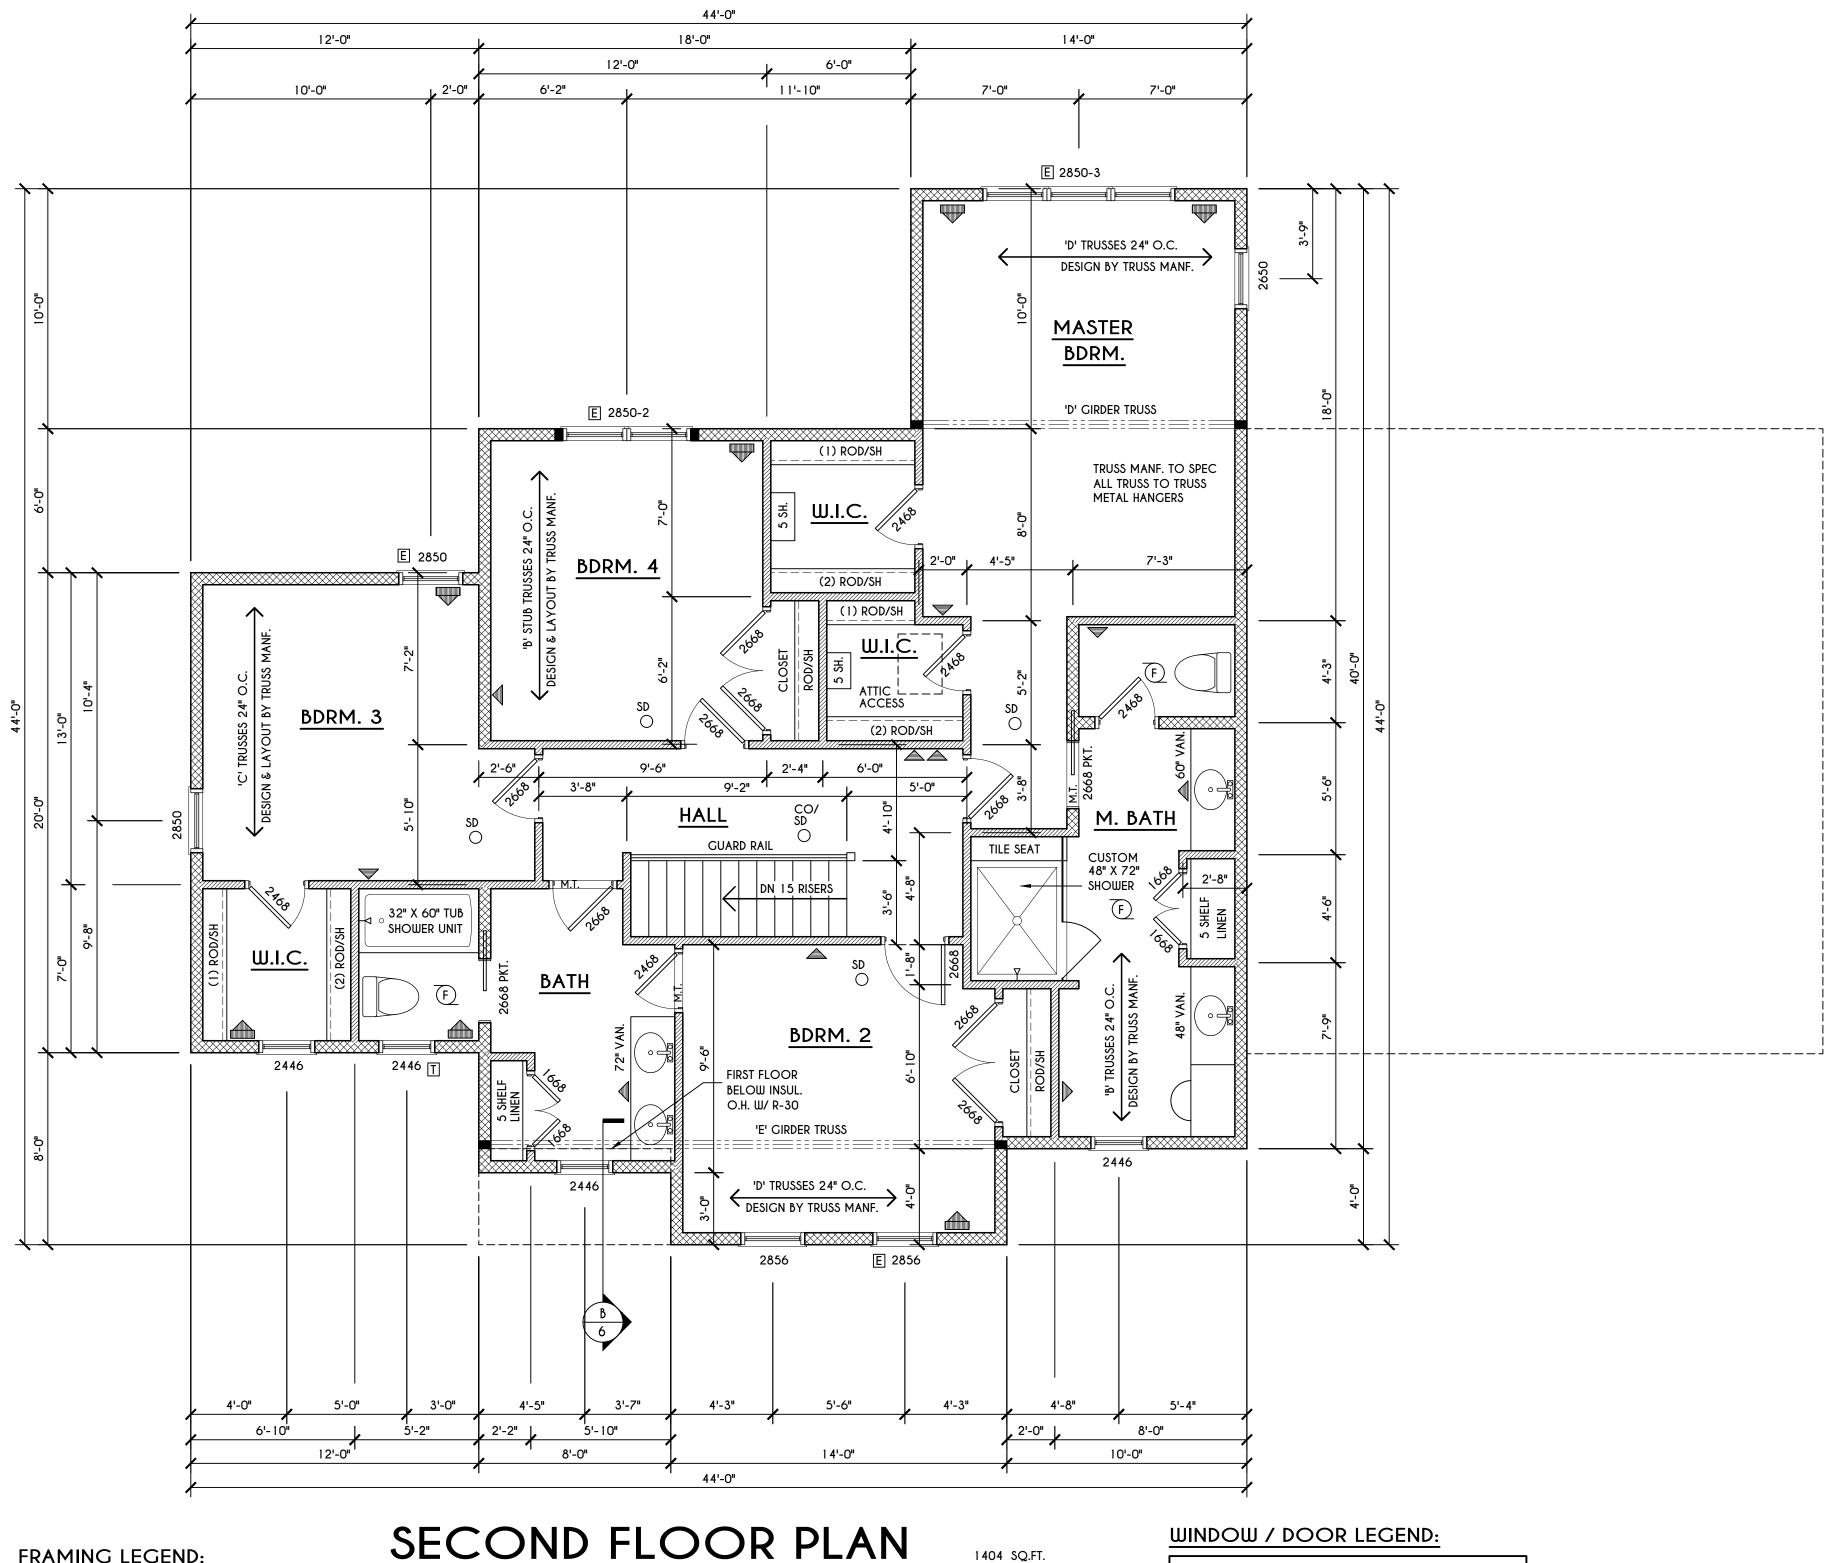

1404 SQ.FT.

### FRAMING LEGEND:

- PROVIDE SOLID POSTING- GLUED & NAILED, EQUAL TO THE # OF HEADERS TO BE SUPPORTED- UNLESS NOTED OTHERWISE \_\_\_\_ - DROPPED HEADER

≡≣≣ - FLUSH HEADER

- 2X4 STUDS @ 16" O.C. - 2X6 STUDS @ 16" O.C.

### SCALE: 1/4" = 1'-0"

NOTES: SECOND FLOOR PLATE HG'T TO BE 8'-1 1/8" (UNLESS NOTED OTHERWISE)

ALL WINDOW R.O. HGT'S TO BE 6'-10 1/2" U.N.O.

PROVIDE SOLID BLOCKING UNDER ALL BEARING POINTS DOWN TO FOUNDATION WALL

PROVIDE DB'L JACK STUDS EA. SIDE OF LOAD BEARING OPENINGS > / = 4'-0" ALL ANGLES TO BE 45 DEG. U.N.O.

ALL EXTERIOR WINDOW & DOOR HEADERS TO HAVE MIN. R-5 INSUL. & TO BE MIN. (2)2X8'S OR (3)2X6'S (U.N.O.) ALL APPLIANCES SHOWN TO BE BY OWNER OR AS PER CONTRACT BY BUILDER

SMOKE (SD) & CARBON MONOXIDE (CO) DETECTORS SHALL BE INSTALLED AS PER SECT. R314 OF 2020 RCNYS THE AIR BARRIER INSTALLED AT EXTERIOR WALLS ADJACENT TO SHOWERS AND TUBS SHALL SEPARATE THEM FROM THE SHOWER OR TUBS.

### WINDOW / DOOR LEGEND:

- E = MEETS OR EXCEEDS EGRESS REQUIREMENTS - CLEAR OPENING AREA OF 5.7 SQ.FT. - CLEAR OPENING WIDTH OF 20" - CLEAR OPENING HEIGHT OF 24" PER SECT. R3 10.2.1 OF 2020 RCNYS
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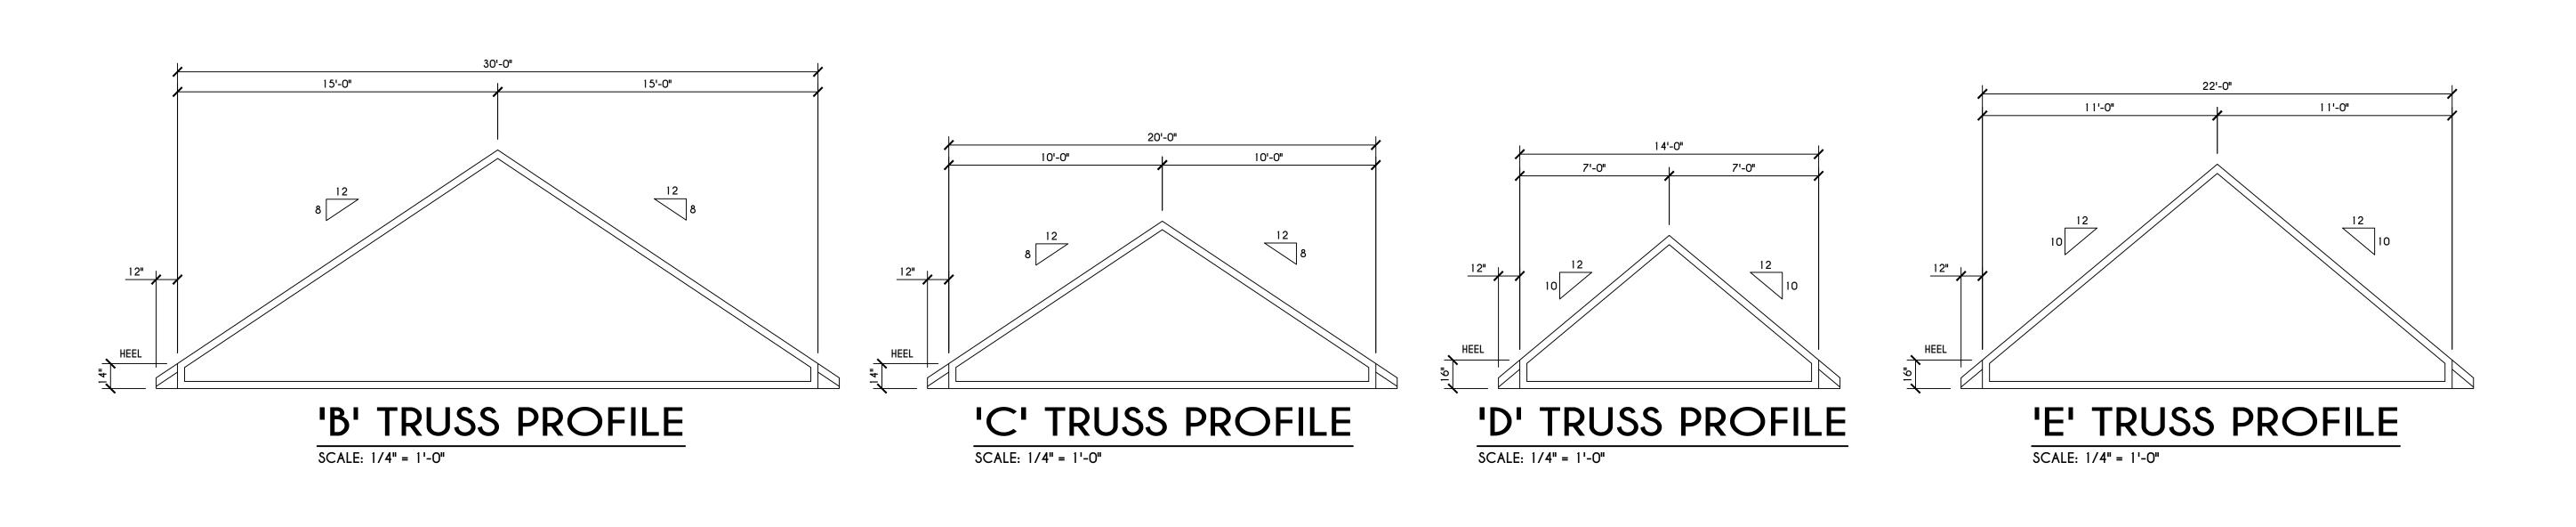
BUILDER:


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SECOND FLOOR PLAN

GLA PLAN	2800

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6 SCALE: 1/4" = 1'-0"

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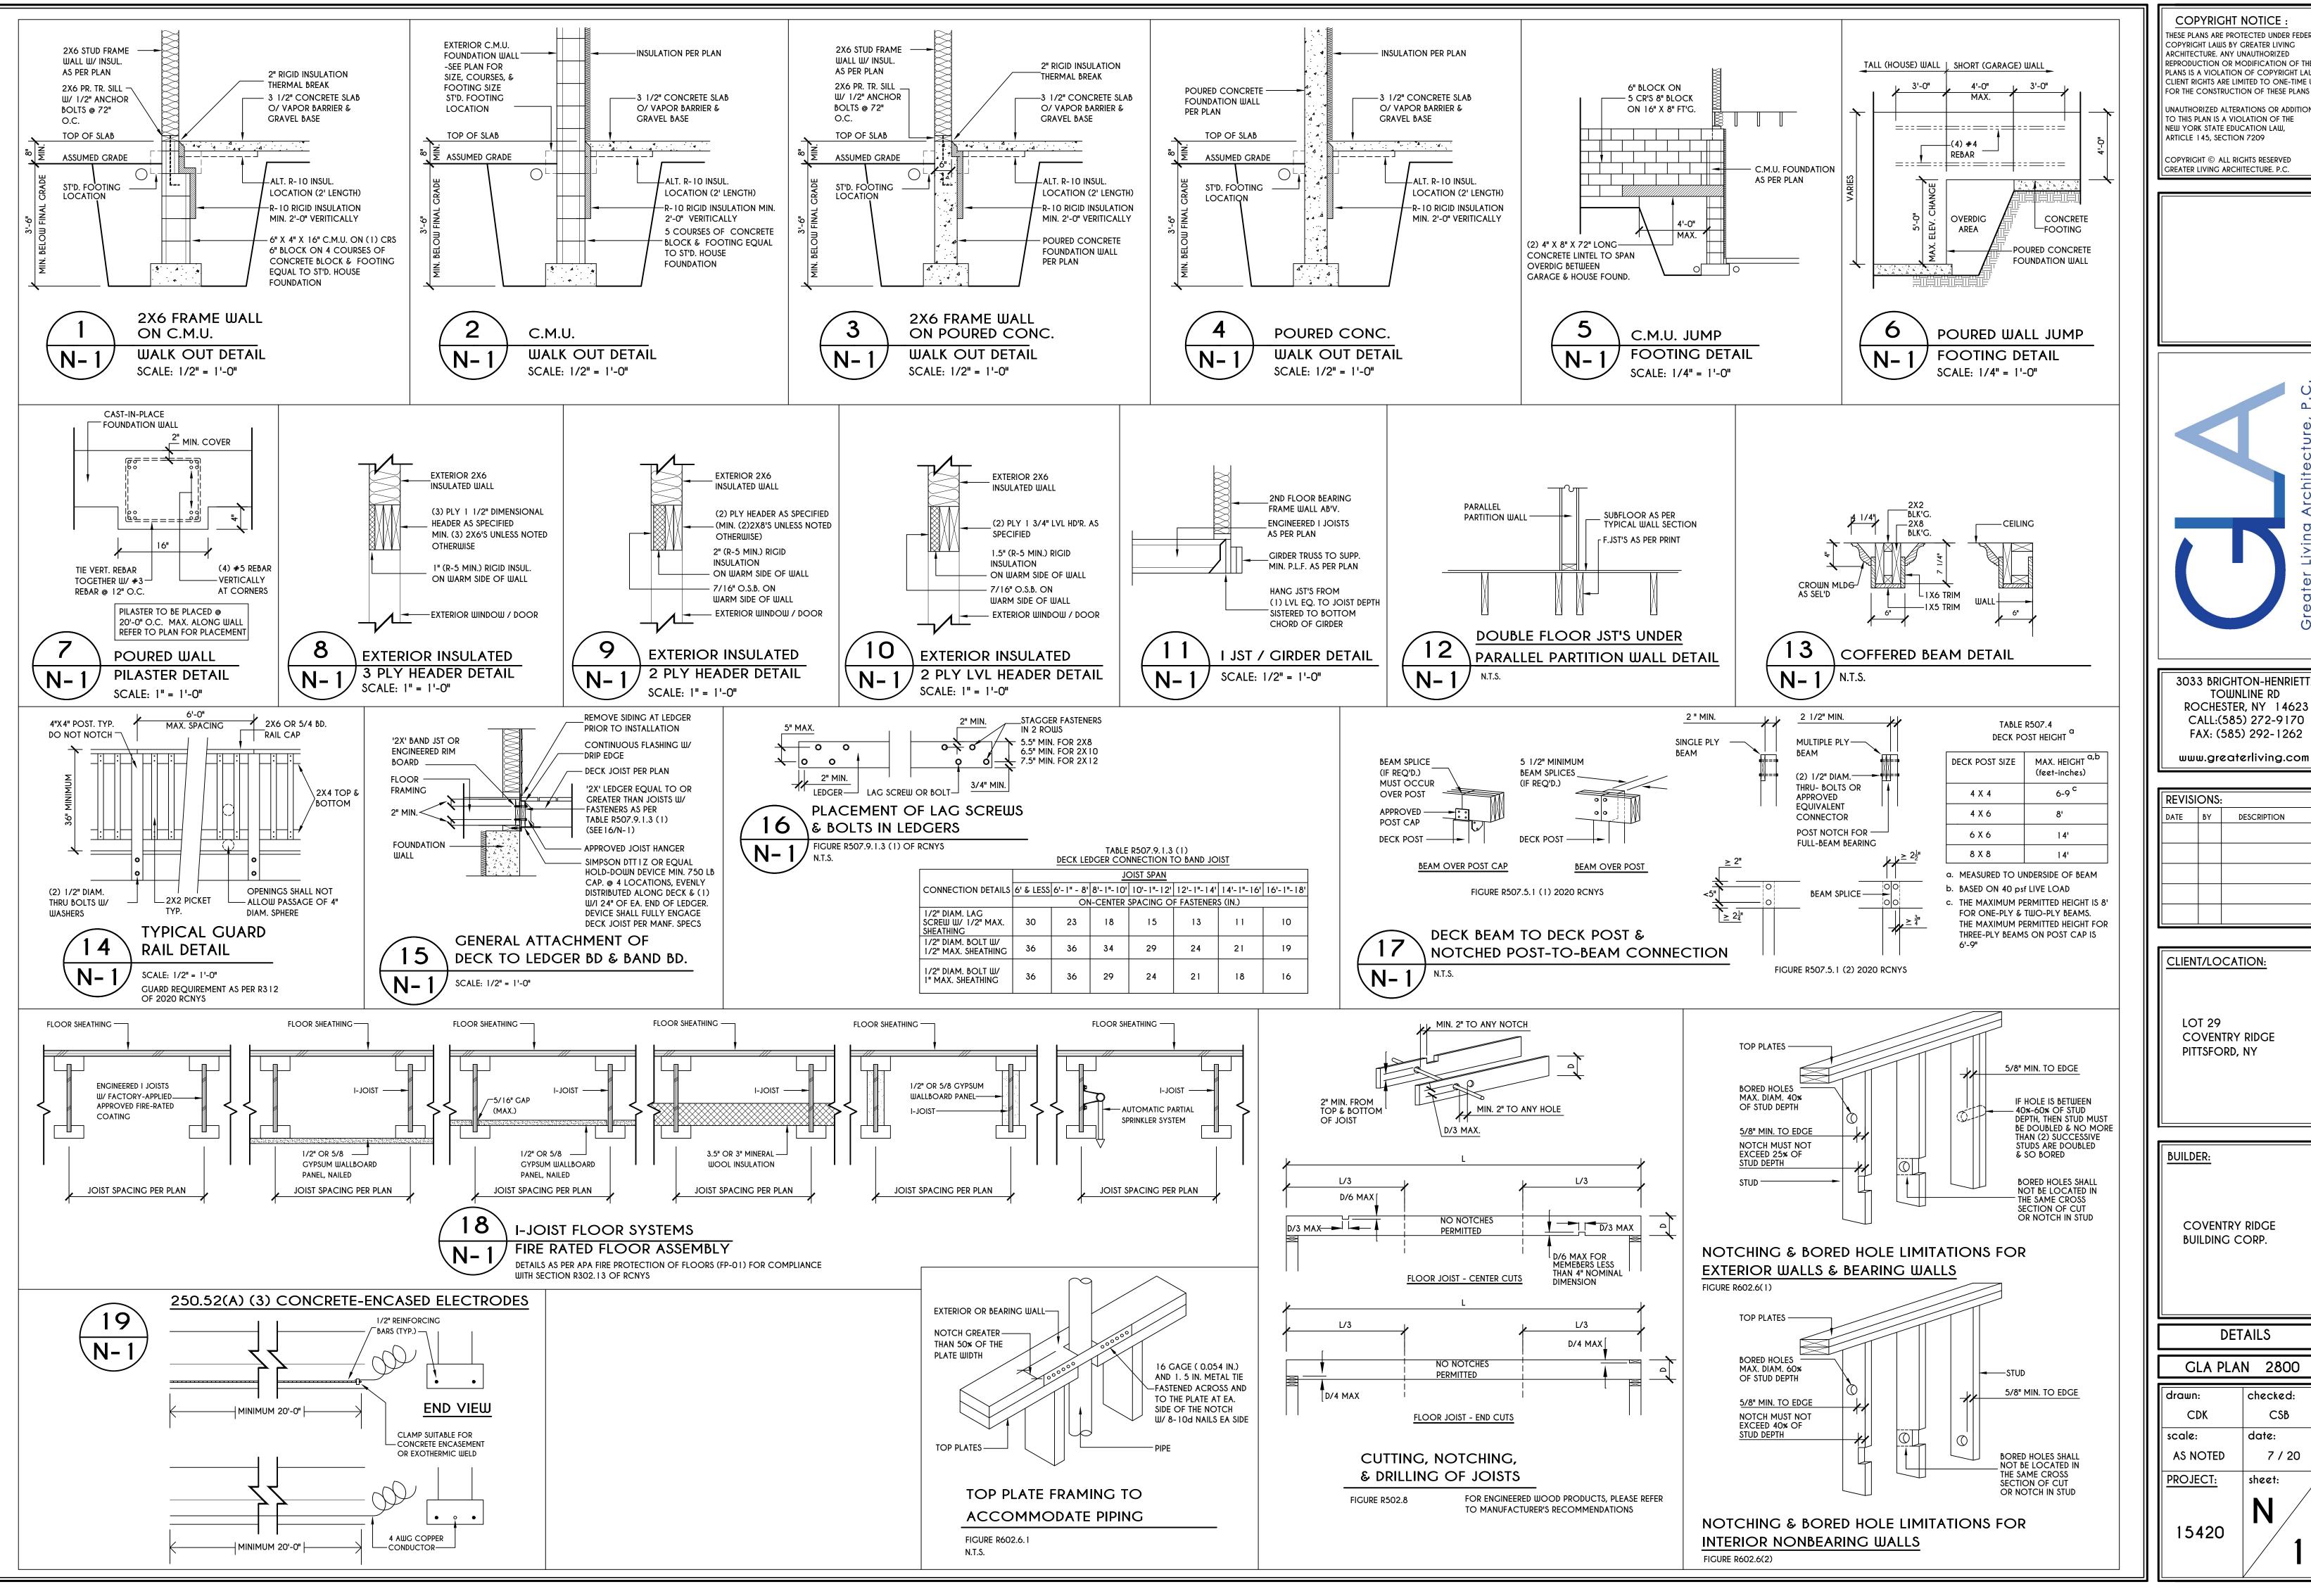
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PITTSFORD, NY

BUILDER:

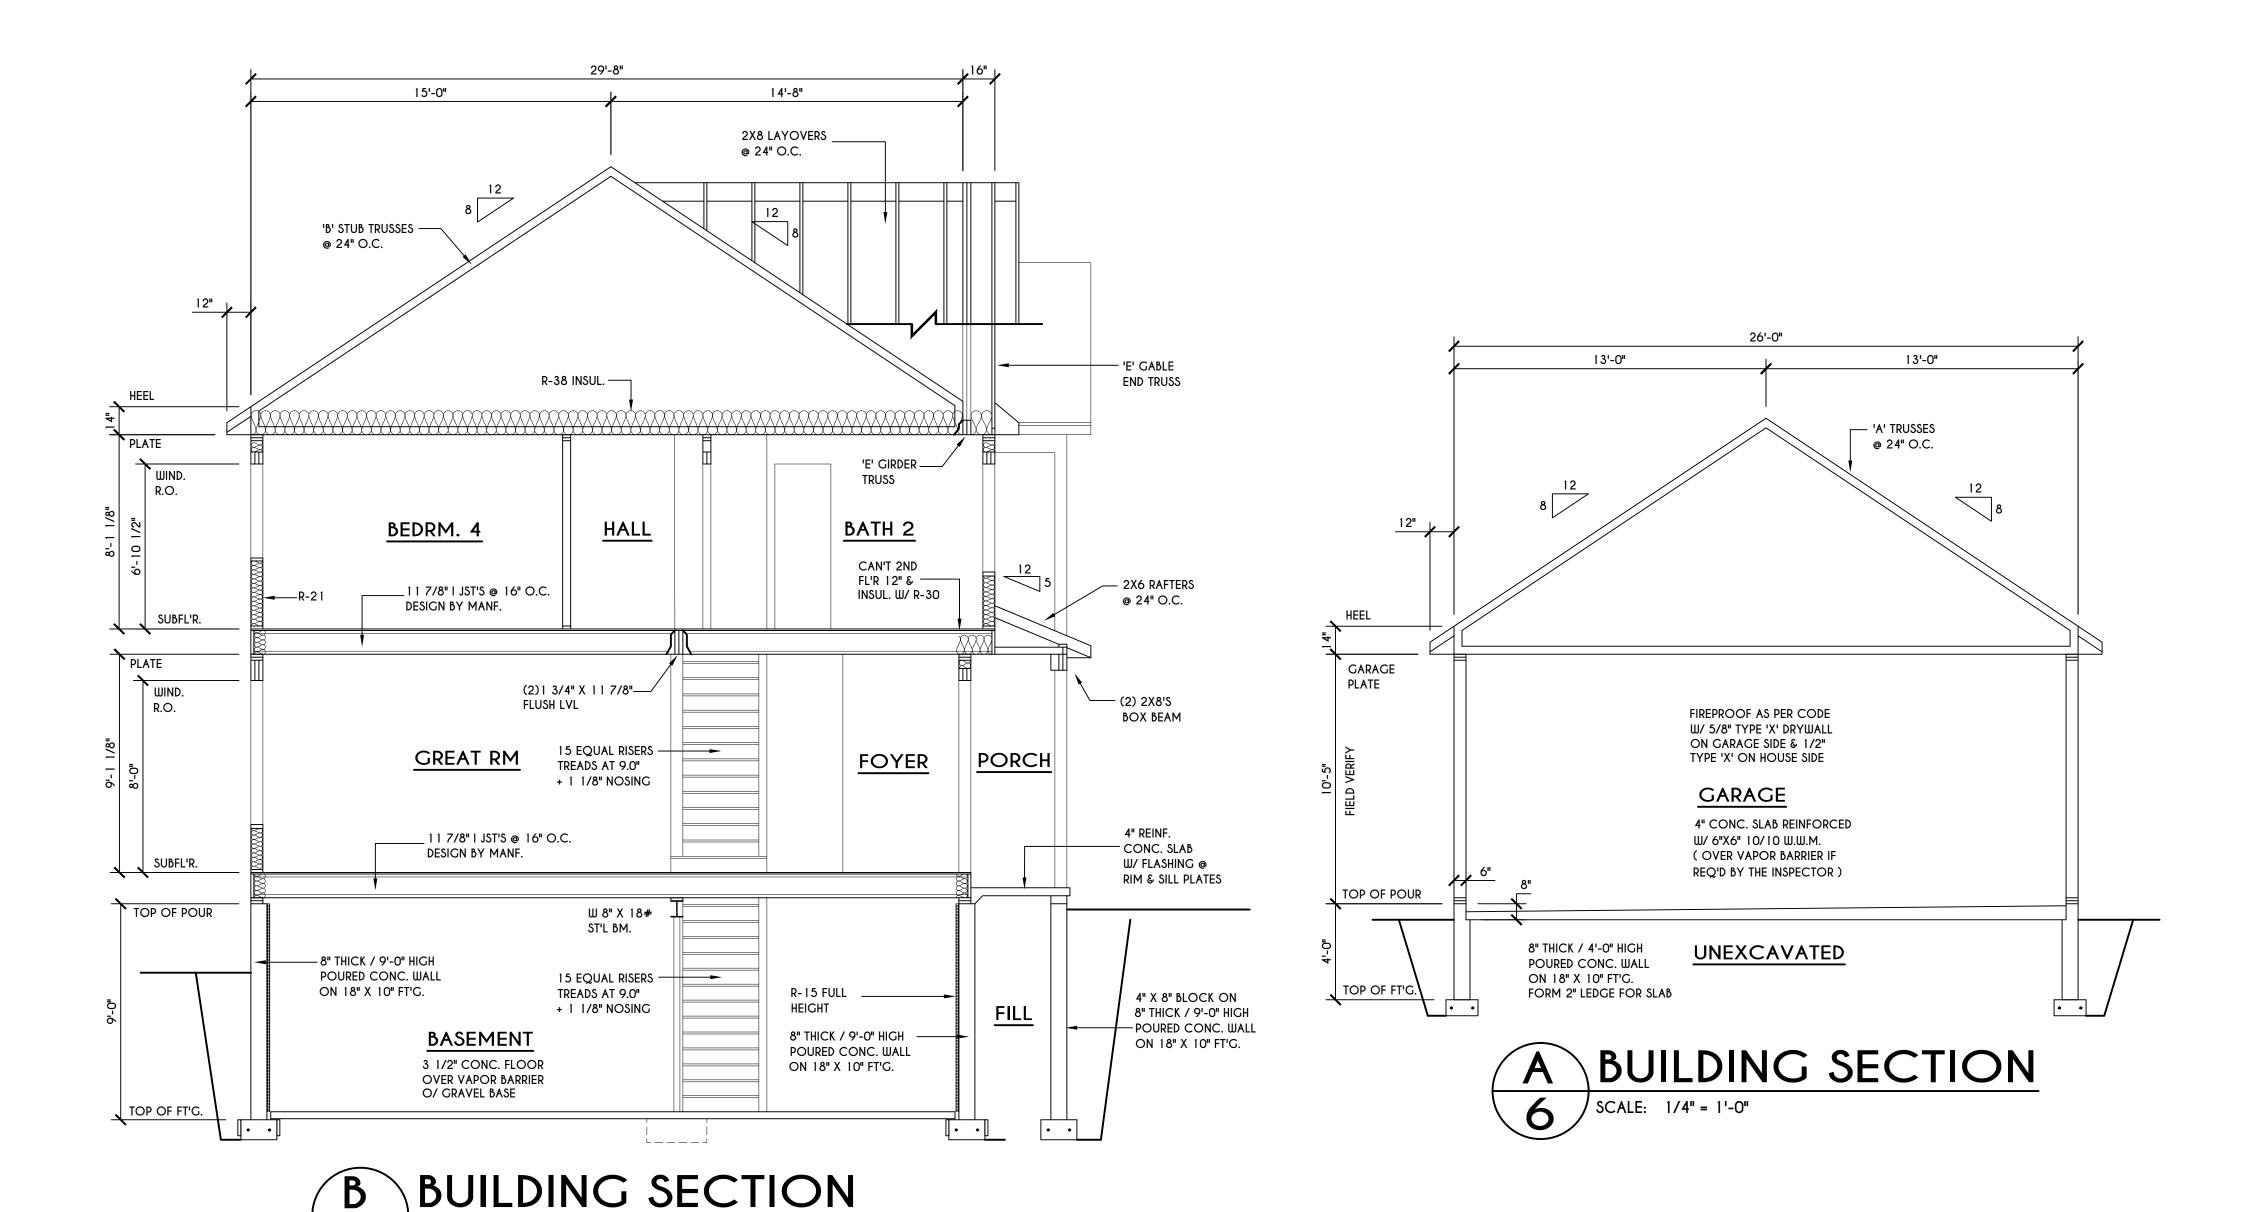COVENTRY RIDGE
BUILDING CORP.

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DESCRIPTION

**COVENTRY RIDGE** PITTSFORD, NY

**COVENTRY RIDGE** BUILDING CORP.

DETAILS

GLA PLAN 2800

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### TABLE R404.1.1(2)

8-INCH MASONRY FOUNDATION WALLS WITH REINFORCING WHERE d > 5 INCHES a, c, fMINIMUM VERTICAL REINFORCEMENT AND SPACING (INCHES) b, c SOIL CLASSES AND LATERAL SOIL LOAD d ( psf PER FOOT BELOW GRADE ) GW, GP, SW, AND SP SOILS GM, GS, SM-SC AND ML SOILS SC, MH, ML-CL AND INORGANIC CL SOILS WALL HEIGHT BACKFILL® #4 @ 48" O.C. 4' ( OR LESS ) #4 @ 48" O.C. 6'-8" #4 @ 48" O.0 #4 @ 48" O.0 #4 @ 48" O. 6'-8" #6 @ 48" O.C. #4 @ 48" O.C #5 @ 48" O.0 4' ( OR LESS #4 @ 48" O.C. #4 @ 48" O.C. #4 @ 48" O.C. #4 @ 48" O.C #4 @ 48" O.C #4 @ 48" O.C. 7'-4" #5 @ 48" O.C #5 @ 48" O.C #5 @ 48" O.C #6 @ 40" O.C. 4' ( OR LESS ) #4 @ 48" O.C. 8'-0" #4 @ 48" O.C. #5 @ 48" O.C. #5 @ 48" O.C. #5 @ 48" O.C. #6 @ 40" O.C. #6 @ 32" O.C. 4' ( OR LESS ) #4 @ 48" O.C #4 @ 48" O.C #4 @ 48" O.C. #5 @ 48" O.C. #4 @ 48" O.C #4 @ 48" O.C #4 @ 48" O.C #6 @ 48" O.C #5 @ 48" O.C #6 @ 48" O.C #6 @ 40" O.C. 8'-8" 4' ( OR LESS ) #4 @ 48" O.C #4 @ 48" O.C. #4 @ 48" O.C. #4 @ 48" O.C. #4 @ 48" O.C. #5 @ 48" O.C. #4 @ 48" O.C. #5 @ 48" O.C. #6 @ 48" O.C. 9'-4" #5 @ 48" O.C. #6 @ 48" O.C. #6 @ 40" O.C. #6 @ 48" O.C #6 @ 40" O.C #6 @ 24" O.C. #6 @ 16" O.C. 4' ( OR LESS #4 @ 48" O.C. #4 @ 48" O.C. #4 @ 48" O.C. #4 @ 48" O.C #5 @ 48" O.C. #4 @ 48" O.0 #5 @ 48" O.C #6 @ 48" O.0

a. MORTAR SHALL BE TYPE M OR S AND MASONRY SHALL BE LAID IN RUNNING BOND.

#5 @ 48" O.C

#6 @ 48" O.C

#6 @ 40" O.C.

#6 @ 32" O.

10'-0"

CONCRETE SLAB IS PERMITTED.

b. ALTERNATIVE REINFORCING BAR SIZES AND SPACING'S SHALL HAVE AN EQUIVALENT CROSS-SECTIONAL AREA OF REINFORCEMENT PER LINEAL FOOT OF WALL SHALL BE PERMITTED PROVIDED THE SPACING OF THE REINFORCEMENT DOES NOT EXCEED 72" IN SEISMIC DESIGN CATEGORIES A, B AND C, AND 48 INCHES IN SEISMIC DESIGN CATEGORIES DO, D1 AND D2 c. VERTICAL REINFORCEMENT SHALL BE GRADE 60 MINIMUM. THE DISTANCE FROM THE FACE OF THE SOIL SIDE OF THE WALL TO THE

#6 @ 48" O.C

#6 @ 32" O.C

#6 @ 24" O.C

#6 @ 16" O.C

#6 @ 32" O.C.

#6 @ 24" O.C.

#6 @ 16" O.C.

#6 @ 16" O.C

CENTER OF VERTICAL REINFORCEMENT SHALL BE NOT LESS THAN 5 INCHES. d. SOIL CLASSES ARE IN ACCORDANCE WITH THE UNIFIED SOIL CLASSIFICATION SYSTEM AND DESIGN LATERAL SOIL LOADS ARE FOR

MOIST CONDITIONS WITHOUT HYDROSTATIC PRESSURE. REFER TO TABLE R405.1. c. UNBALANCED BACKFILL HEIGHT IS THE DIFFERENCE IN HEIGHT BETWEEN THE EXTERIOR FINISH GROUND LEVEL AND THE LOWER OF THE TOP OF THE CONCRETE FOOTING THAT SUPPORTS THE FOUNDATION WALL OR THE INTERIOR FINISH GROUND LEVEL. WHERE AN INTERIOR CONCRETE SLAB-ON-GRADE IS PROVIDED AND IS IN CONTACT WITH THE INTERIOR SURFACE OF THE FOUNDATION WALL, MEASUREMENT OF THE UNBALANCED BACKFILL HEIGHT FROM THE EXTERIOR FINISH GROUND LEVEL TO THE TOP OF THE INTERIOR

f. THE USE OF THIS TABLE SHALL BE PROHIBITED FOR SOIL CLASSIFICATIONS NOT SHOWN.

### TABLE R404.1.1(3)

10-INCH MASONRY FOUNDATION WALLS WITH REINFORCING WHERE d > 6.75 INCHES <sup>Q, C, f</sup>									
	MINIMUM VERTICAL REINFORCEMENT AND SPACING ( INCHES ) b, c								
		SOIL CLASSES AND LATERAL SOIL LOAD d (psf PER FOOT BELOW GRADE )							
WALL HEIGHT	HEIGHT OF Unbalanced Backfill <sup>©</sup>			SC, MH, ML-CL AND INORGANIC CL SOILS 60					
6'-8"	4' ( OR LESS )	#4 @ 56" O.C.	#4 @ 56" O.C.	#4 @ 56" O.C.					
	5'	#4 @ 56" O.C.	#4 @ 56" O.C.	#4 @ 56" O.C.					
	6'-8"	#4 @ 56" O.C.	#5 @ 56" O.C.	#5 @ 56" O.C.					
7'-4"	4' ( OR LESS )	#4 @ 56" O.C.	#4 @ 56" O.C.	#4 @ 56" O.C.					
	5'	#4 @ 56" O.C.	#4 @ 56" O.C.	#4 @ 56" O.C.					
	6'	#4 @ 56" O.C.	#4 @ 56" O.C.	#5 @ 56" O.C.					
	7'-4"	#4 @ 56" O.C.	#5 @ 56" O.C.	#6 @ 56" O.C.					
8'-0"	4' ( OR LESS )	#4 @ 56" O.C.	#4 @ 56" O.C.	#4 @ 56" O.C.					
	5'	#4 @ 56" O.C.	#4 @ 56" O.C.	#4 @ 56" O.C.					
	6'	#4 @ 56" O.C.	#4 @ 56" O.C.	#5 @ 56" O.C.					
	7'	#4 @ 56" O.C.	#5 @ 56" O.C.	#6 @ 56" O.C.					
	8'	#5 @ 56" O.C.	#6 @ 56" O.C.	#6 @ 48" O.C.					
8'-8"	4' ( OR LESS )	#4 @ 56" O.C.	#4 @ 56" O.C.	#4 @ 56" O.C.					
	5'	#4 @ 56" O.C.	#4 @ 56" O.C.	#4 @ 56" O.C.					
	6'	#4 @ 56" O.C.	#4 @ 56" O.C.	#5 @ 56" O.C.					
	7'	#4 @ 56" O.C.	#5 @ 56" O.C.	#6 @ 56" O.C.					
	8'-8"	#5 @ 56" O.C.	#6 @ 56" O.C.	#6 @ 32" O.C.					
9'-4"	4' ( OR LESS )	#4 @ 56" O.C.	#4 @ 56" O.C.	#4 @ 56" O.C.					
	5'	#4 @ 56" O.C.	#4 @ 56" O.C.	#4 @ 56" O.C.					
	6'	#4 @ 56" O.C.	#5 @ 56" O.C.	#5 @ 56" O.C.					
	7'	#4 @ 56" O.C.	#5 @ 56" O.C.	#6 @ 56" O.C.					
	8'	#5 @ 56" O.C.	#6 @ 56" O.C.	#6 @ 40" O.C.					
	9'-4"	#6 @ 56" O.C.	#6 @ 40" O.C.	#6 @ 24" O.C.					
10'-0"	4' ( OR LESS )	#4 @ 56" O.C.	#4 @ 56" O.C.	#4 @ 56" O.C.					
	5'	#4 @ 56" O.C.	#4 @ 56" O.C.	#4 @ 56" O.C.					
	6'	#4 @ 56" O.C.	#5 @ 56" O.C.	#5 @ 56" O.C.					
	7'	#5 @ 56" O.C.	#6 @ 56" O.C.	#6 @ 48" O.C.					
	8'	#5 @ 56" O.C.	#6 @ 48" O.C.	#6 @ 40" O.C.					
	9'	#6 @ 56" O.C.	#6 @ 40" O.C.	#6 @ 24" O.C.					
	10'	#6 @ 48" O.C.	#6 @ 32" O.C.	#6 @ 24" O.C.					

a. MORTAR SHALL BE TYPE M OR S AND MASONRY SHALL BE LAID IN RUNNING BOND.

b. ALTERNATIVE REINFORCING BAR SIZES AND SPACINGS SHALL HAVE AN EQUIVALENT CROSS-SECTIONAL AREA OF REINFORCEMENT PER LINEAL FOOT OF WALL SHALL BE PERMITTED PROVIDED THE SPACING OF THE REINFORCEMENTDOES NOT EXCEED 72" IN SEISMIC DESIGN CATEGORIES A, B AND C, AND 48 INCHES IN SEISMIC DESIGN CATEGORIES DO, D1 AND D2.

c. VERTICAL REINFORCEMENT SHALL BE GRADE 60 MINIMUM. THE DISTANCE FROM THE FACE OF THE SOIL SIDE OF THE WALL TO THE CENTER OF VERTICAL REINFORCEMENT SHALL BE NOT LESS THAN 6.75 INCHES.

d. SOIL CLASSES ARE IN ACCORDANCE WITH THE UNIFIED SOIL CLASSIFICATION SYSTEM AND DESIGN LATERAL SOIL LOADS ARE FOR MOIST CONDITIONS WITHOUT HYDROSTATIC PRESSURE. REFER TO TABLE R405.1.

c. UNBALANCED BACKFILL HEIGHT IS THE DIFFERENCE IN HEIGHT BETWEEN THE EXTERIOR FINISH GROUND LEVEL AND THE LOWER OF THE TOP OF THE CONCRETE FOOTING THAT SUPPORTS THE FOUNDATION WALL OR THE INTERIOR FINISH GROUND LEVEL. WHERE AN INTERIOR CONCRETE SLAB-ON-GRADE IS PROVIDED AND IS IN CONTACT WITH THE INTERIOR SURFACE OF THE FOUNDATION WALL, MEASUREMENT OF THE UNBALANCED BACKFILL HEIGHT FROM THE EXTERIOR FINISH GROUND LEVEL TO THE TOP OF THE INTERIOR

f. THE USE OF THIS TABLE SHALL BE PROHIBITED FOR SOIL CLASSIFICATIONS NOT SHOWN.

### TABLE R404.1.1(4)

12-INCH MASONRY FOUNDATION WALLS WITH REINFORCING WHERE d > 8.75 INCHES a, c, f

MINIMUM VERTICAL REINFORCEMENT AND SPACING (INCHES) b, c

I		PHINIPOPT VERTICAL REINT ORCEPTENT AND SPACING (INCHES)						
		SOIL CLASSE	S AND LATERAL SOIL LOAD <sup>d</sup> ( psf PER FOOT BELOW GRADE )					
WALL HEIGHT	HEIGHT OF Unbalanced Backfill <sup>©</sup>			SC, MH, ML-CL AND INORGANIC CL SOILS 60				
6'-8"	4' ( OR LESS ) 5' 6'-8"	#4 @ 72" O.C. #4 @ 72" O.C. #4 @ 72" O.C.	#4 @ 72" O.C. #4 @ 72" O.C. #4 @ 72" O.C.	#4 @ 72" O.C. #4 @ 72" O.C. #5 @ 72" O.C.				
7'-4"	4' ( OR LESS ) 5' 6' 7'-4"	#4 @ 72" O.C. #4 @ 72" O.C. #4 @ 72" O.C. #4 @ 72" O.C.	#4 @ 72" O.C. #4 @ 72" O.C. #4 @ 72" O.C. #5 @ 72" O.C.	#4 @ 72" O.C. #4 @ 72" O.C. #5 @ 72" O.C. #6 @ 72" O.C.				
8'-0"	4' ( OR LESS ) 5' 6' 7' 8'	#4 @ 72" O.C. #4 @ 72" O.C. #4 @ 72" O.C. #4 @ 72" O.C. #5 @ 72" O.C.	#4 @ 72" O.C. #4 @ 72" O.C. #4 @ 72" O.C. #5 @ 72" O.C. #6 @ 72" O.C.	#4 @ 72" O.C. #4 @ 72" O.C. #5 @ 72" O.C. #6 @ 72" O.C. #6 @ 64" O.C.				
8'-8"	4' ( OR LESS ) 5' 6' 7' 8'-8"	#4 @ 72" O.C. #4 @ 72" O.C. #4 @ 72" O.C. #4 @ 72" O.C. #5 @ 72" O.C.	#4 @ 72" O.C. #4 @ 72" O.C. #4 @ 72" O.C. #5 @ 72" O.C. #7 @ 72" O.C.	#4 @ 72" O.C. #4 @ 72" O.C. #5 @ 72" O.C. #6 @ 72" O.C. #6 @ 48" O.C.				
9'-4"	4' ( OR LESS ) 5' 6' 7' 8' 9'-4"	#4 @ 72" O.C. #4 @ 72" O.C. #4 @ 72" O.C. #4 @ 72" O.C. #5 @ 72" O.C. #6 @ 72" O.C.	#4 @ 72" O.C. #4 @ 72" O.C. #5 @ 72" O.C. #5 @ 72" O.C. #6 @ 72" O.C. #6 @ 48" O.C.	#4 @ 72" O.C. #4 @ 72" O.C. #5 @ 72" O.C. #6 @ 72" O.C. #6 @ 56" O.C. #6 @ 40" O.C.				
10'-0"	4' ( OR LESS ) 5' 6' 7' 8' 9'	#4 @ 72" O.C. #4 @ 72" O.C. #4 @ 72" O.C. #4 @ 72" O.C. #5 @ 72" O.C. #6 @ 72" O.C. #6 @ 64" O.C.	#4 @ 72" O.C. #4 @ 72" O.C. #5 @ 72" O.C. #6 @ 72" O.C. #6 @ 72" O.C. #6 @ 56" O.C. #6 @ 40" O.C.	#4 @ 72" O.C. #4 @ 72" O.C. #5 @ 72" O.C. #6 @ 72" O.C. #6 @ 48" O.C. #6 @ 40" O.C. #6 @ 32" O.C.				

a. MORTAR SHALL BE TYPE M OR S AND MASONRY SHALL BE LAID IN RUNNING BOND. b. ALTERNATIVE REINFORCING BAR SIZES AND SPACINGS SHALL HAVE AN EQUIVALENT CROSS-SECTIONAL AREA OF REINFORCEMENT PER LINEAL FOOT OF WALL SHALL BE PERMITTED PROVIDED THE SPACING OF THE REINFORCEMENTDOES NOT EXCEED 72" IN SEISMIC DESIGN

CATEGORIES A, B AND C, AND 48 INCHES IN SEISMIC DESIGN CATEGORIES DO, D1 AND D2. c. VERTICAL REINFORCEMENT SHALL BE GRADE 60 MINIMUM. THE DISTANCE FROM THE FACE OF THE SOIL SIDE OF THE WALL TO THE CENTER OF VERTICAL REINFORCEMENT SHALL BE NOT LESS THAN 8.75 INCHES.

d. SOIL CLASSES ARE IN ACCORDANCE WITH THE UNIFIED SOIL CLASSIFICATION SYSTEM AND DESIGN LATERAL SOIL LOADS ARE FOR MOIST CONDITIONS WITHOUT HYDROSTATIC PRESSURE. REFER TO TABLE R405.1. g. UNBALANCED BACKFILL HEIGHT IS THE DIFFERENCE IN HEIGHT BETWEEN THE EXTERIOR FINISH GROUND LEVEL AND THE LOWER OF THE

TOP OF THE CONCRETE FOOTING THAT SUPPORTS THE FOUNDATION WALL OR THE INTERIOR FINISH GROUND LEVEL. WHERE AN INTERIOR CONCRETE SLAB-ON-GRADE IS PROVIDED AND IS IN CONTACT WITH THE INTERIOR SURFACE OF THE FOUNDATION WALL, MEASUREMENT OF THE UNBALANCED BACKFILL HEIGHT FROM THE EXTERIOR FINISH GROUND LEVEL TO THE TOP OF THE INTERIOR CONCRETE SLAB IS PERMITTED.

f. THE USE OF THIS TABLE SHALL BE PROHIBITED FOR SOIL CLASSIFICATIONS NOT SHOWN.

### TABLE R404.1.2(8)

			VERTICAL F						E. SDACII	NG (inches	. )		
						-		-			-		
		-	SOIL CLASSES AND DESIGN LATERAL SOIL ( psf PER FOOT OF DEPTH )										
	MAXIMUM UNBALANCED	Gl	IJ, GP, SW, <i>i</i>	AND SP		GM	, GS, SM-SC	C AND ML		sc, мн, м	L-CL AND II	NORGANIC	CL
MAXIMUM	BACKFILL		30		15 415 41	15.4 111.411. 71	45	INCHES >			60		
WALL HEIGHT	HEIGHT <sup>9</sup> (FEET)		_				IICKNESS (						T
(1221)		6	8	10	12	6	8	10	12	6	8	10	12
5	4	NR	NR	NR	NR	NR	NR	NR	NR	NR	NR	NR	NR
	5	NR	NR	NR	NR	NR	NR	NR	NR	NR	NR	NR	NR
6	4	NR	NR	NR	NR	NR	NR	NR	NR	NR	NR	NR	NR
	5	NR	NR	NR	NR	NR	NR <sup>1</sup>	NR	NR	#4@35"	NR <sup>1</sup>	NR	NR
	6	NR	NR	NR	NR	#5 @ 48"	NR	NR	NR	#5 @ 36"	NR	NR	NR
	4	NR	NR	NR	NR	NR	NR	NR	NR	NR	NR	NR	NR
7	5	NR	NR	NR	NR	NR	NR	NR	NR	#5 @ 47"	NR	NR	NR
	6	NR	NR	NR	NR	#5 @ 42"	NR	NR 1	NR		#5 @ 48"	NR <sup>1</sup>	NR
	7	#5 @ 46"	NR	NR	NR	#6 @ 42"	#5 @ 46"	NR I	NR	#6@34"		NR	NR
	4	NR	NR	NR	NR	NR	NR	NR	NR	NR	NR	NR	NR
	5	NR	NR	NR	NR	#4@38"	NR <sup>1</sup>	NR	NR	#5 @ 43"	NR	NR 1	NR
8	6	#4@37"	NR <sup>1</sup>	NR	NR	#5 @ 37"	NR	NR	NR	#6@37"		NR I	NR
	7	#5 @ 40"	NR	NR	NR	#6@37"	#5 @ 41"	NR I	NR		#6 @ 43"	NR	NR
	8	#6 @ 43"	#5 @ 47"	NR I	NR	#6@34"		NR 	NR	#6 @ 27"		#6 @ 44"	NR
-	4	NR	NR	NR	NR	NR	NR	NR	NR	NR	NR	NR	NR
}	5 6	NR #4 @ 34"	NR ND 1	NR	NR	#4 @ 35" #6 @ 48"	NR I	NR	NR	#5 @ 40"	NR #6 @ 39"	NR NR <sup>1</sup>	NR
9	7	#4 @ 34 #5 @ 36"	NR I	NR	NR		NR #5 @ 37"	NR	NR		#6 @ 38"		NR
}	8	#5 @ 38"	NR #5 @ 41"	NR NR	NR NR	#6@34		NR #5 @ 37"	NR NR 1		#6 @ 29"		NR #4 @
}	9	#6 @ 34"		NR NR	NR NR		#6 @ 30"	#6@41"	NR ·		#6 @ 23"		#6
	4	NR	#0 @ 40 NR	NR NR	NR NR	#0@20 NR	#0 @ 30 NR	NR	NR NR	NR	#0 @ 23 NR	NR	NR
•	5	NR NR	NR NR	NR NR	NR	#4 @ 33"	NR 1	NR NR	NR	#5 @ 38"	NR NR	NR NR	NR
10	6	#5 @ 48"	NR <sup>1</sup>	NR NR	NR	#4 @ 35 #6 @ 45"	NR ·	NR NR	NR	#6 @ 34"		NR NR	NR
10	7	#6 @ 47"	NR NR	NR NR	NR	#6 @ 34"	#6 @ 48"	NR NR	NR NR	#6 @ 30"			NR
ŀ	8	#6 @ 34"		NR NR	NR	#6 @ 30"	#6 @ 34"	#6 @ 47"	NR <sup>1</sup>		#6 @ 26"		#6
ł	9	#6 @ 34"	#6 @ 41"			#6 @ 23"	#6 @ 27"	#6 @ 35"					#6@
ŀ	10	#6 @ 28"		#6 @ 45"	NR	DR J	#6 @ 23"	#6 @ 29"		DR		#6 @ 22"	

- a. SOIL CLASSES ARE IN ACCORDANCE WITH THE UNIFIED SOIL CLASSIFICATION SYSTEM. REFER TO TABLE R405.1.
- b. TABLE VALUES ARE BASED ON REINFORCING BARS WITH A MINIMUM YEID STRENGTH OF 60,000 PSI
- c. VERTICAL REINFOREMENT WITH A YIELD STRENGTH OF LESS THAN 60,000 PSI AND / OR BARS OF A DIFFERENT SIZE THAN SPECIFIED IN THE TABLE ARE PERMITTED IN ACCORDANCE WITH SECTION R404.1.3.3.7.6 AND TABLE R404.1.2 (9)
- d. NR INDICATES NO VERTICAL WALL REINFORCEMENT IS REQUIRED, EXCEPT FOR 6-INCH NOMINAL WALLS FORMED WITH STAY-IN-PLACE FORMING SYSTEMS IN WHICH CASE VERTICAL REINFORCEMENT SHALL BE NO. 4 @ 48 INCHES ON CENTER.
- e. ALLOWABLE DEFLECTION CRITERION IS L/240, WHERE L IS THE UNSUPPORTED HEIGHT OF THE BASEMENT WALL IN INCHES.
- f. INTERPOLATION IS NOT PERMITTED.
- g. WHERE WALLS WIL REMAIN 4 FEET OR MORE OF UNBALANCED BACKFILL, THEY SHALL BE LATERALLY SUPPORTED AT THE TOP AND BOTTOM BEFORE BACKFILLING. h. VERTICAL REINFORCEMENT SHALL BE LOCATED TO PROVIDE A COVER OF 1 1/4 INCHES MEASURED FROM THE INSIDE FACE OF THE WALL. THE CENTER OF THE STEEL
- SHALL NOT VARY FROM THE SPECIFIED LOCATION BY MORE THAN THE GREATER OF 10 PERCENT OF THE WALL THICKNESS OR 3/8 INCH.
- I. CONCRETE COVER FOR THE REINFORCEMENT MEASURE FROM THE INSIDE FACE OF THE WALL SHALL BE NOT LESS THAN 3/4 INCH. CONCRETE COVER FOR REINFORCEMENT MEASURED FROM THE OUTSIDE FACE OF THE WALL SHALL BE NOT LESS THAN 1 1/2 INCHES FOR NO. 5 BARS AND SMALLER, AND NOT LESS THAN 2 INCHES FOR LARGER BARS.
- j. DR MEANS DESIGN IS REQUIRED IN ACCORDANCE WITH THE APPLICABLE BUILDING CODE, OR WHERE THERE IS NO CODE, IN ACCORDANCE WITH ACI 318.
- k. CONCRETE SHALL HAVE A SPECIFIED COMPRESSIVE STRENGTH, fc OF NOT LESS THAN 2,500 PSI AT 28 DAYS, UNLESS A HIGHER STRENGTH IS REQUIRED BY FOOTNOTE 1 OR m.
- I. THE MINIMUM THICKNESS IS PERMITTED TO BE REDUCED 2 INCHES, PROVIDED THE MINIMUM SPECIFIED COMPRESSIVE STRENGTH OF CONCRETE, fc IS 4,000 PSI.
- m. A PLAIN CONCRETE WALL WITH A MINIMUM NOMINAL THICKNESS OF 12 INCHES IS PERMITTED, PROVIDED MINIMUM SPECIFIED COMPRESSIVE STRENGTH OF CONCRETE, fc IS 3,500 PSI. n. SEE TABLE R608.3 FOR TOLERANCE FROM NOMINAL THICKNESS PERMITTED FOR FLAT WALLS.
- o. THE USE OF THIS TABLE SHALL BE PROHIBITED FOR SOIL CLASSIFICATIONS NOT SHOWN.

### TABLE R 402.4.1.1 AIR BARRIER AND INSULATION INSTALLATION

COMPONENT	AIR BARRIER CRITERIA	INSULATION INSTALLATION CRITERIA
	A CONTINUOUS AIR BARRIER SHALL BE INSTALLED IN THE BUILDING ENVELOPE.	
GENERAL REQUIREMENTS	THE EXTERIOR THERMAL ENVELOPE CONTAINS A CONTINUOUS AIR BARRIER.	AIR-PERMEABLE INSULATION SHALL NOT BE USED AS A SEALING MATERIAL.
	BREAKS OR JOINTS IN THE AIR BARRIER SHALL BE SEALED.	
CEILING / ATTIC	THE AIR BARRIER IN ANY DROPPED CEILING / SOFFIT SHALL BE ALIGNED WITH THE INSULATION AND ANY GAPS IN THE AIR BARRIER SHALL BE SEALED.	THE INSULATION IN ANY DROPPED CEILING / SOFFIT SHALL BE ALIGNED WITH THE AIR BARRIER.
CLILING / MITIC	ACCESS OPENINGS, DROP DOWN STAIRS, OR KNEE WALL DOORS TO UNCONDITIONED ATTIC SPACES SHALL BE SEALED.	SOTTH SHALL DE ALIGHED WITH THE AIR DARKIER.
	THE JUNCTION OF THE FOUNDATION AND SILL PLATE SHALL BE SEALED.	CAVITIES WITH CORNERS AND HEADERS OF FRAME WALLS SHALL BE INSULATED BY COMPLETELY FILLING THE CAVITY WITH A MATERIAL HAVING A THERMAL
WALLS	THE JUNCTION OF THE TOP PLATE AND THE TOP OF EXTERIOR WALLS SHE BE SEALED.	RESISTANCE OF R-3 PER INCH MINIMUM.  EXTERIOR THERMAL ENVELOPE INSULATION FOR FRAMED
	KNEE WALLS SHALL BE SEALED.	WALLS SHALL BE INSTALLED IN SUBSTANTIAL CONTACT AND CONTINUOUS ALIGNMENT WITH THE AIR BARRIER.
WINDOWS, SKYLIGHTS AND DOORS	THE SPACE BETWEEN WINDOW / DOOR JAMBS AND FRAMING, AND SKYLIGHTS AND FRAMING SHALL BE SEALED.	
RIM JOISTS	RIM JOISTS SHALL INCLUDE THE AIR BARRIER.	RIM JOISTS SHALL BE INSULATED.
FLOORS ( INCLUDING ABOVE GARAGE AND CANTILEVERED FLOORS )	THE AIR BARRIER SHALL BE INSTALLED AT ANY EXPOSED EDGE OF INSULATION.	FLOOR FRAMING CAVITY INSULATION SHALL BE INSTALLED TO MAINTAIN PERMANENT CONTACT WITH THE UNDERSIDE OF SUBFLOOR DECKING, OR FLOOR FRAMING CAVITY INSULATION SHALL BE PERMITTED TO BE IN CONTACT WITH THE TOP SIDE OF SHEATHING, OR CONTINUOUS INSULATION INSTALLED ON THE UNDERSIDE OF FLOOR FRAMING AND EXTENDS FROM THE BOTTOM TO THE TOP OF ALL PERIMETER FLOOR FRAMING MEMBERS.
CRAWL SPACE WALLS	EXPOSED EARTH IN UNVENTED CRAWL SPACES SHALL BE COVERED WITH A CLASS I VAPOR RETARDER WITH OVERLAPPING JOINTS TAPED.	WHERE PROVIDED INSTEAD OF FLOOR INSULATION, INSULATION SHALL BE PERMANENTLY ATTACHED TO THE CRAWLSPACE WALLS.
SHAFTS, PENETRATIONS	DUCT SHAFTS, UTILITY PENETRATIONS, AND FLUE SHAFTS OPENING THE EXTERIOR OR UNCONDITIONED SPACE SHALL BE SEALED.	
NARROW CAVITIES		BATTS IN NARROW CAVITIES SHALL BE CUT TO FIT, OR NARROW CAVITIES SHALL BE FILLED BY INSULATION THAT ON INSTALLATION READILY CONFORMS TO THE AVAILABLE CAVITY SPACE.
GARAGE SEPARATION	AIR SEALING SHALL BE PROVIDED BETWEEN THE GARAGE AND CONDITIONED SPACES.	
RECESSED LIGHTING	RECESSED LIGHT FIXTURES INSTALLED IN THE BUILDING THERMAL ENVELOPE SHALL BE SEALED TO THE DRYWALL.	RECESSED LIGHT FIXTURES INSTALLED IN THE BUILDING THERMAL ENVELOPE SHALL BE AIR TIGHT AND IC RATED.
PLUMBING AND WIRING		BATT INSULATION SHALL BE CUT NEATLY TO FIT AROUND WIRING AND PLUMBING IN EXTERIOR WALLS, OR INSULATION THAT ON INSTALLATION READILY CONFORMS TO AVAILABLE SPACE SHALL EXTEND BEHIND PIPING AND WIRING.
SHOWER / TUB ON EXTERIOR WALL	THE AIR BARRIER INSTALLED AT EXTERIOR WALLS ADJACENT TO SHOWERS AND TUBS SHALL SEPARATE THEM FROM THE SHOWERS AND TUBS.	EXTERIOR WALLS ADJACENT TO SHOWERS AND TUBS SHALL BE INSULATED.
ELECTRICAL / PHONE BOX ON EXTERIOR WALLS	THE AIR BARRIER SHALL BE INSTALLED BEHIND ELECTRICAL OR COMMUNICATION BOXES OR AIR-SEALED BOXES SHALL BE INSTALLED.	
HVAC REGISTER BOOTS	HVAC REGISTER BOOTS THAT PENETRATE BUILDING THERMAL ENVELOPE SHALL BE SEALED TO THE SUBFLOOR OR DRYWALL.	
CONCEALED SPRINKLERS	WHEN REQUIRED TO BE SEALED, CONCEALED FIRE SPRINKLERS SHALL ONLY BE SEALED IN A MANNER THAT IS RECOMMENDED BY THE MANUFACTURER. CAULKING OR OTHER ADHESIVE SEALANTS SHALL NOT BE USED TO FILL VOIDS BETWEEN FIRE SPRINKLER COVER PLATES AND WALL OR CEILINGS.	

a. IN ADDITION, INSPECTION OF LOG WALLS SHALL BE IN ACCORDANCE WITH THE PROVISIONS OF ICC-400.

WHERE QUANTIFIABLE DATA CREATED BY ACCEPTED SOIL SCIENCE METHODOLOGIES INDICATE EXPANSIVE, COMPESSIBLE, SHIFTING OR OTHER QUESTIONABLE SOIL CHARACTERISTICS ARE LIKELY TO BE PRESENT, THE BUILDING OFFICIAL SHALL DETERMINE WHETHER TO REQUIRE A SOIL TEST TO DETERMINE THE SOIL'S CHARACTERISTICS AT A

### R401.4.1 GEOTECHNICAL EVALUATION. IN LIEU OF A COMPLETE GEOTECHNICAL EVALUATION, THE LOAD-BEARING VALUES IN TABLE R401.4.1

TABLE R401.4.1 PRESUMPTIVE LOAD-BEARING VALUES OF FOUNDATION MATERIALS


CLASS OF MATERIALS	LOAD-BEARING PRESSURE ( pounds per square foot )
CRYSTALLINE BEDROCK	12,000
SEDIMENTARY & FOLIATED ROCK	4,000
SANDY GRAVEL AND/OR GRAVEL (GW & GP)	3,000
SAND, SILTY SAND, CLAYEY SAND, SILTY GRAVEL, AND CLAYEY GRAVEL (SW, SP, SM, SC, GM, & GC)	2,000
CLAY, SANDY CLAY, SILTY CLAY, CLAYEY SILT, SILT AND SANDY SILT (CL, ML, MH, & CH)	1,500 b

a. WHERE SOIL TESTS ARE REQUIRED BY SECTION R401.4, THE ALLOWABLE BEARING CAPACITIES OF THE SOIL SHALL BE PART OF THE RECOMMENDATIONS.

b. WHERE THE BUILDING OFFICIAL DETERMINES THAT IN-PLACE SOILS WITH AN ALLOWABLE BEARING CAPACITY OF LESS THAN 1,500 psf ARE LIKELY TO BE PRESENT AT THE SITE, THE ALLOWABLE BEARING CAPACITY SHALL BE DETERMINED BY A SOILS INVESTIGATION.

### UNIFIED SOIL CLASSIFICATION SYSTEM

UNIFIED SOIL CLASSIFICATION SYSTEM SYMBOL	
GW	WELL-GRADED GRAVELS, GRAVEL SAND MIXTURES, LITTLE OR NO FINES
GP	POORLY GRADED GRAVELS OR GRAVEL SAND, LITTLE OR NO FINES
SW	WELL-GRADED SANDS, GRAVELLY SANDS, LITTLE OR NO FINES
SP	POORLY GRADED SANDS OR GRAVELLY SANDS, LITTLE OR NO FINES
GM	SILTY GRAVELS, GRAVEL-SAND-SILT MIXTURES
SM	SILTY SAND, SAND-SILT MIXTURES
GC	CLAYEY GRAVELS, GRAVEL-SAND-CLAY MIXTURES
SC	CLAYEY SANDS, SAND-CLAY MIXTURE MIXTURES
ML	INORGANIC SILTS & VERY FINE SANDS, ROCK FLOUR, SILTY OR CLAYEY FINE SANDS OR CLAYEY SILTS WITH SLIGHT PLASTICITY
CL	INORGANIC CLAYS OF LOW TO MEDIUM PLASTICITY, GRAVELLY CLAYS, SANDY CLAYS, SILTY CLAYS, LEAN CLAYS
СН	INORGANIC CLAYS OF HIGH PLASTICITY, FAT CLAYS
МН	INORGANIC SILTS, MICACEOUS OR DIATOMACEOUS FINE SANDY OR SILTY SOILS, ELASTIC SILTS
OL	ORGANIC SILTS & ORGANIC SILTY CLAYS OF LOW PLASTICITY
ОН	ORGANIC CLAYS OF MEDIUM TO HIGH PLASTICITY, ORGANIC SILTS
PT	PEAT & OTHER HIGHLY ORGANIC SOILS

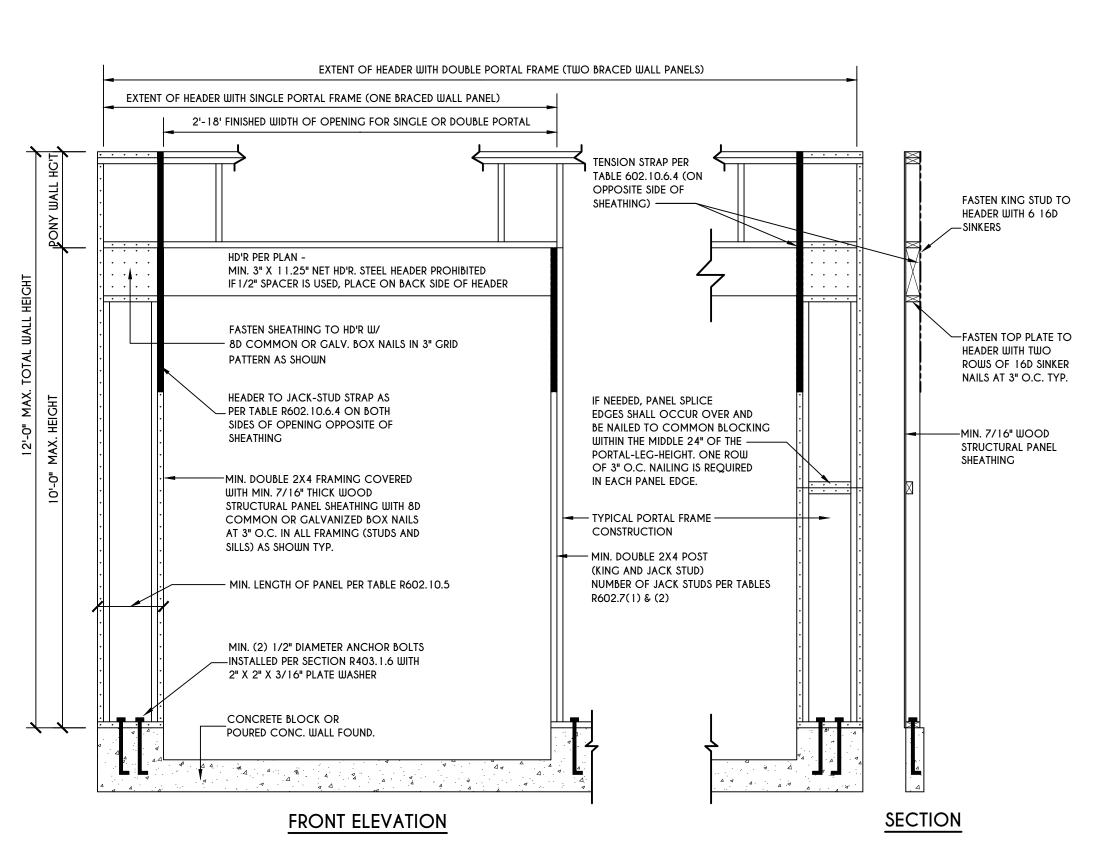

PORTAL FRAME AT GARAGE DOOR OPENINGS IN SEISMIC DESIGN CATEGORIES A, B, AND C SCALE: N.T.S.

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ARTICLE 145, SECTION 7209

3033 BRIGHTON-HENRIETTA TOWNLINE RD ROCHESTER, NY 14623 CALL:(585) 272-9170 FAX: (585) 292-1262

www.greaterliving.com

Ι,			
	REVISI	ONS:	
	DATE	BY	DESCRIPTION

CLIENT/LOCATION: LOT 29 **COVENTRY RIDGE** PITTSFORD, NY

**COVENTRY RIDGE** BUILDING CORP.

REINFORCING NOTES


GLA PLAN 2800

checked: drawn: CSB CDK scale: 7 / 20 AS NOTED PROJECT: sheet:







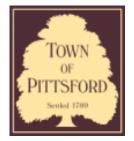

#### **Town of Pittsford**

Department of Public Works 11 South Main Street Pittsford, New York 14534

Permit # B20-00094

Phone: 585-248-6250 FAX: 585-248-6262

## DESIGN REVIEW AND HISTORIC PRESERVATION BOARD REFERRAL OF APPLICATION

Property Address: 4 San Rafael Drive ROCHESTER, NY 14618

**Tax ID Number:** 151.06-1-17

Zoning District: RN Residential Neighborhood

Owner: Krapf, Christian Applicant: Krapf, Christian


Application Type	Αp	ila	cati	on	Τv	pe	
------------------	----	-----	------	----	----	----	--

application Type:	
Residential Design Review §185-205 (B)	Build to Line Adjustment §185-17 (B) (2)
Commercial Design Review §185-205 (B)	Building Height Above 30 Feet §185-17 (M)
Signage §185-205 (C)	Corner Lot Orientation §185-17 (K) (3)
Certificate of Appropriateness §185-197	Flag Lot Building Line Location §185-17 (L) (1) (c)
Landmark Designation §185-195 (2)	Undeveloped Flag Lot Requirements §185-17 (L) (2)
Informal Review	

**Project Description:** Applicant is requesting design and review for the construction of a new single family home. The home will be approximately 6440 sq. ft. of livable space and will be located on a vacant lot in the San Rafael Drive neighborhood.


Meeting Date: July 23, 2020

### RN Residential Neighborhood Zoning

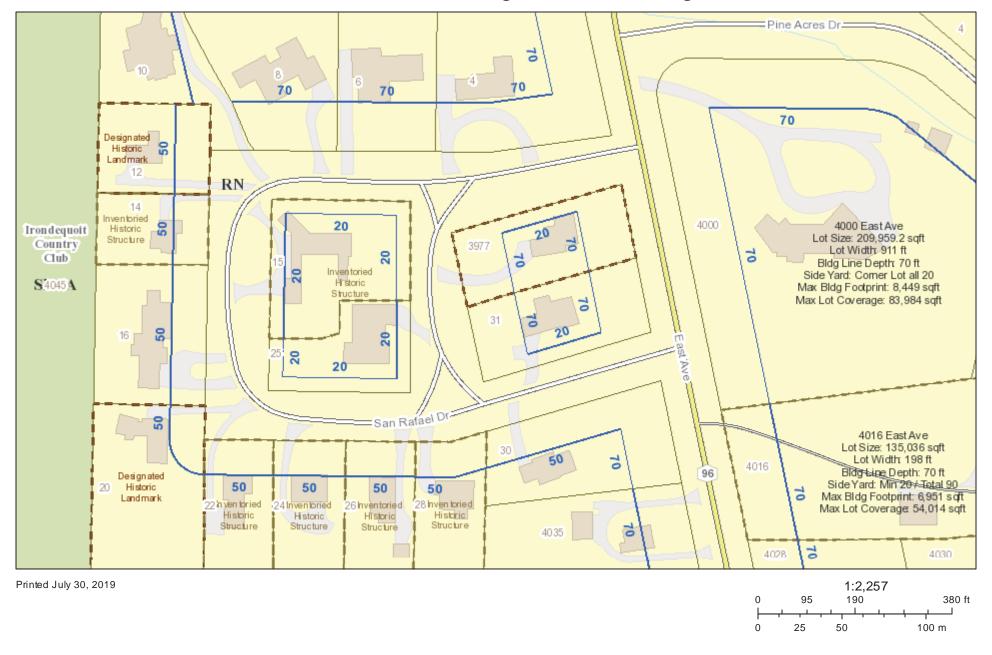

Town of Pittsford GIS

The information depicted on this map is representational and should be used for general reference purposes only. No warranties, expressed or implied, are provided for the data or its use or interpretation.

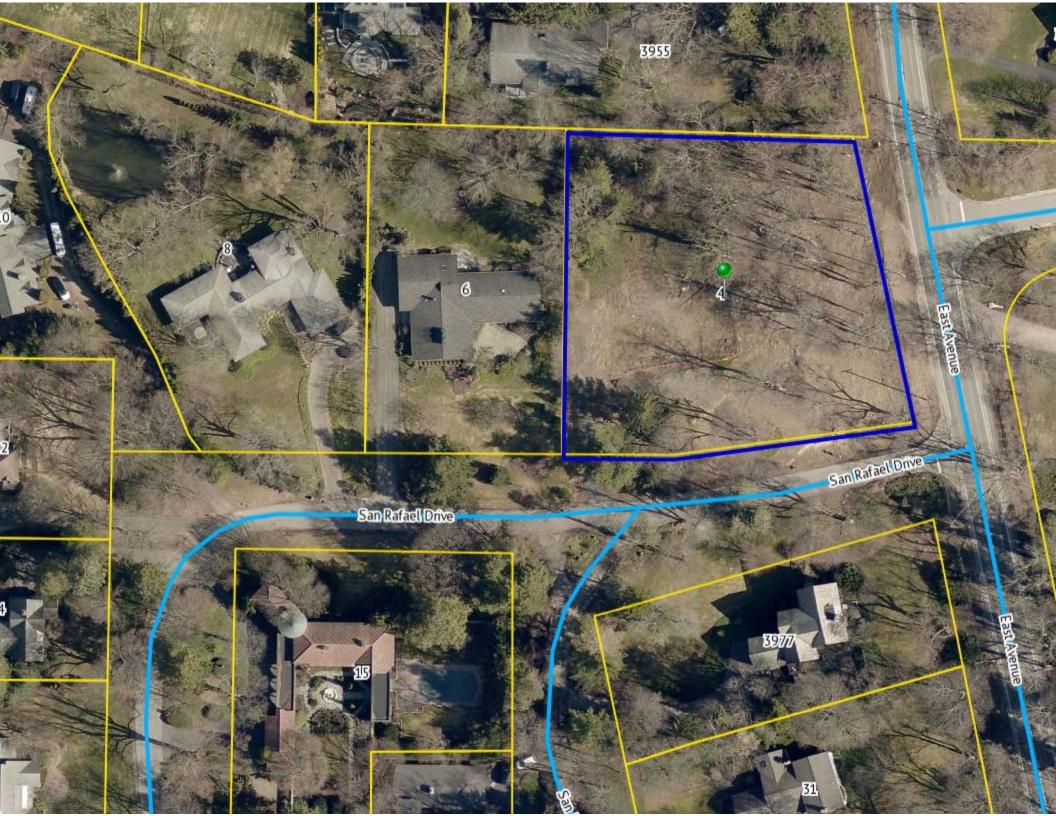

## C CHRISTOPHER

ARCHITECTURE & INTERIORS

KRAPF RESIDENCE

Photos of Construction Site June 12, 2020



VIEW FROM SOUTH EASTERN CORNER



VIEW FROM NORTH EASTERN CORNER



VIEW FROM SOUTH WESTERN CORNER



VIEW DOWN SAN RAFAEL DRIVE



VIEW DOWN EAST AVENUE



# Krapf Residence

Design Review and Historic Preservation Set

Issue: 06/12/2020

4 San Rafael Drive Rochester, New York 14618

## Drawing Index

#### **COVER SHEET** A0.0

A1.0 SITE PLAN

A2.1 FIRST FLOOR PLAN

**ELEVATIONS** 

**ELEVATIONS** 

A2.2 BASEMENT & SECOND FLOOR PLANS

A3.1 **ELEVATIONS** A3.2 A3.3 **ELEVATIONS** 

SECTIONS A4.1

A3.4

## Project Information

### Owner: Christian & Christina Krapf

Architect: Christopher Architecture & Interiors Contact: Chris Reebals

Ria Neill Interior Designer: Christopher Architecture & Interiors Contact: Joanna Goodman

> 2601 Highland Avenue Birmingham, Alabama 35205 (205)-413-8531

Square Footages


Heated/Cooled Total: 6,440sf 900 sf Basement Level: 5,183 sf Ground Level: 357 sf Upper Level: 1,133 sf **Unconditioned Total:** Patios: 644 sf Trellis: 402sf 98sf Spa: Total Design SF: 7,574sf

Applicable Codes: 2017 International Residential Code







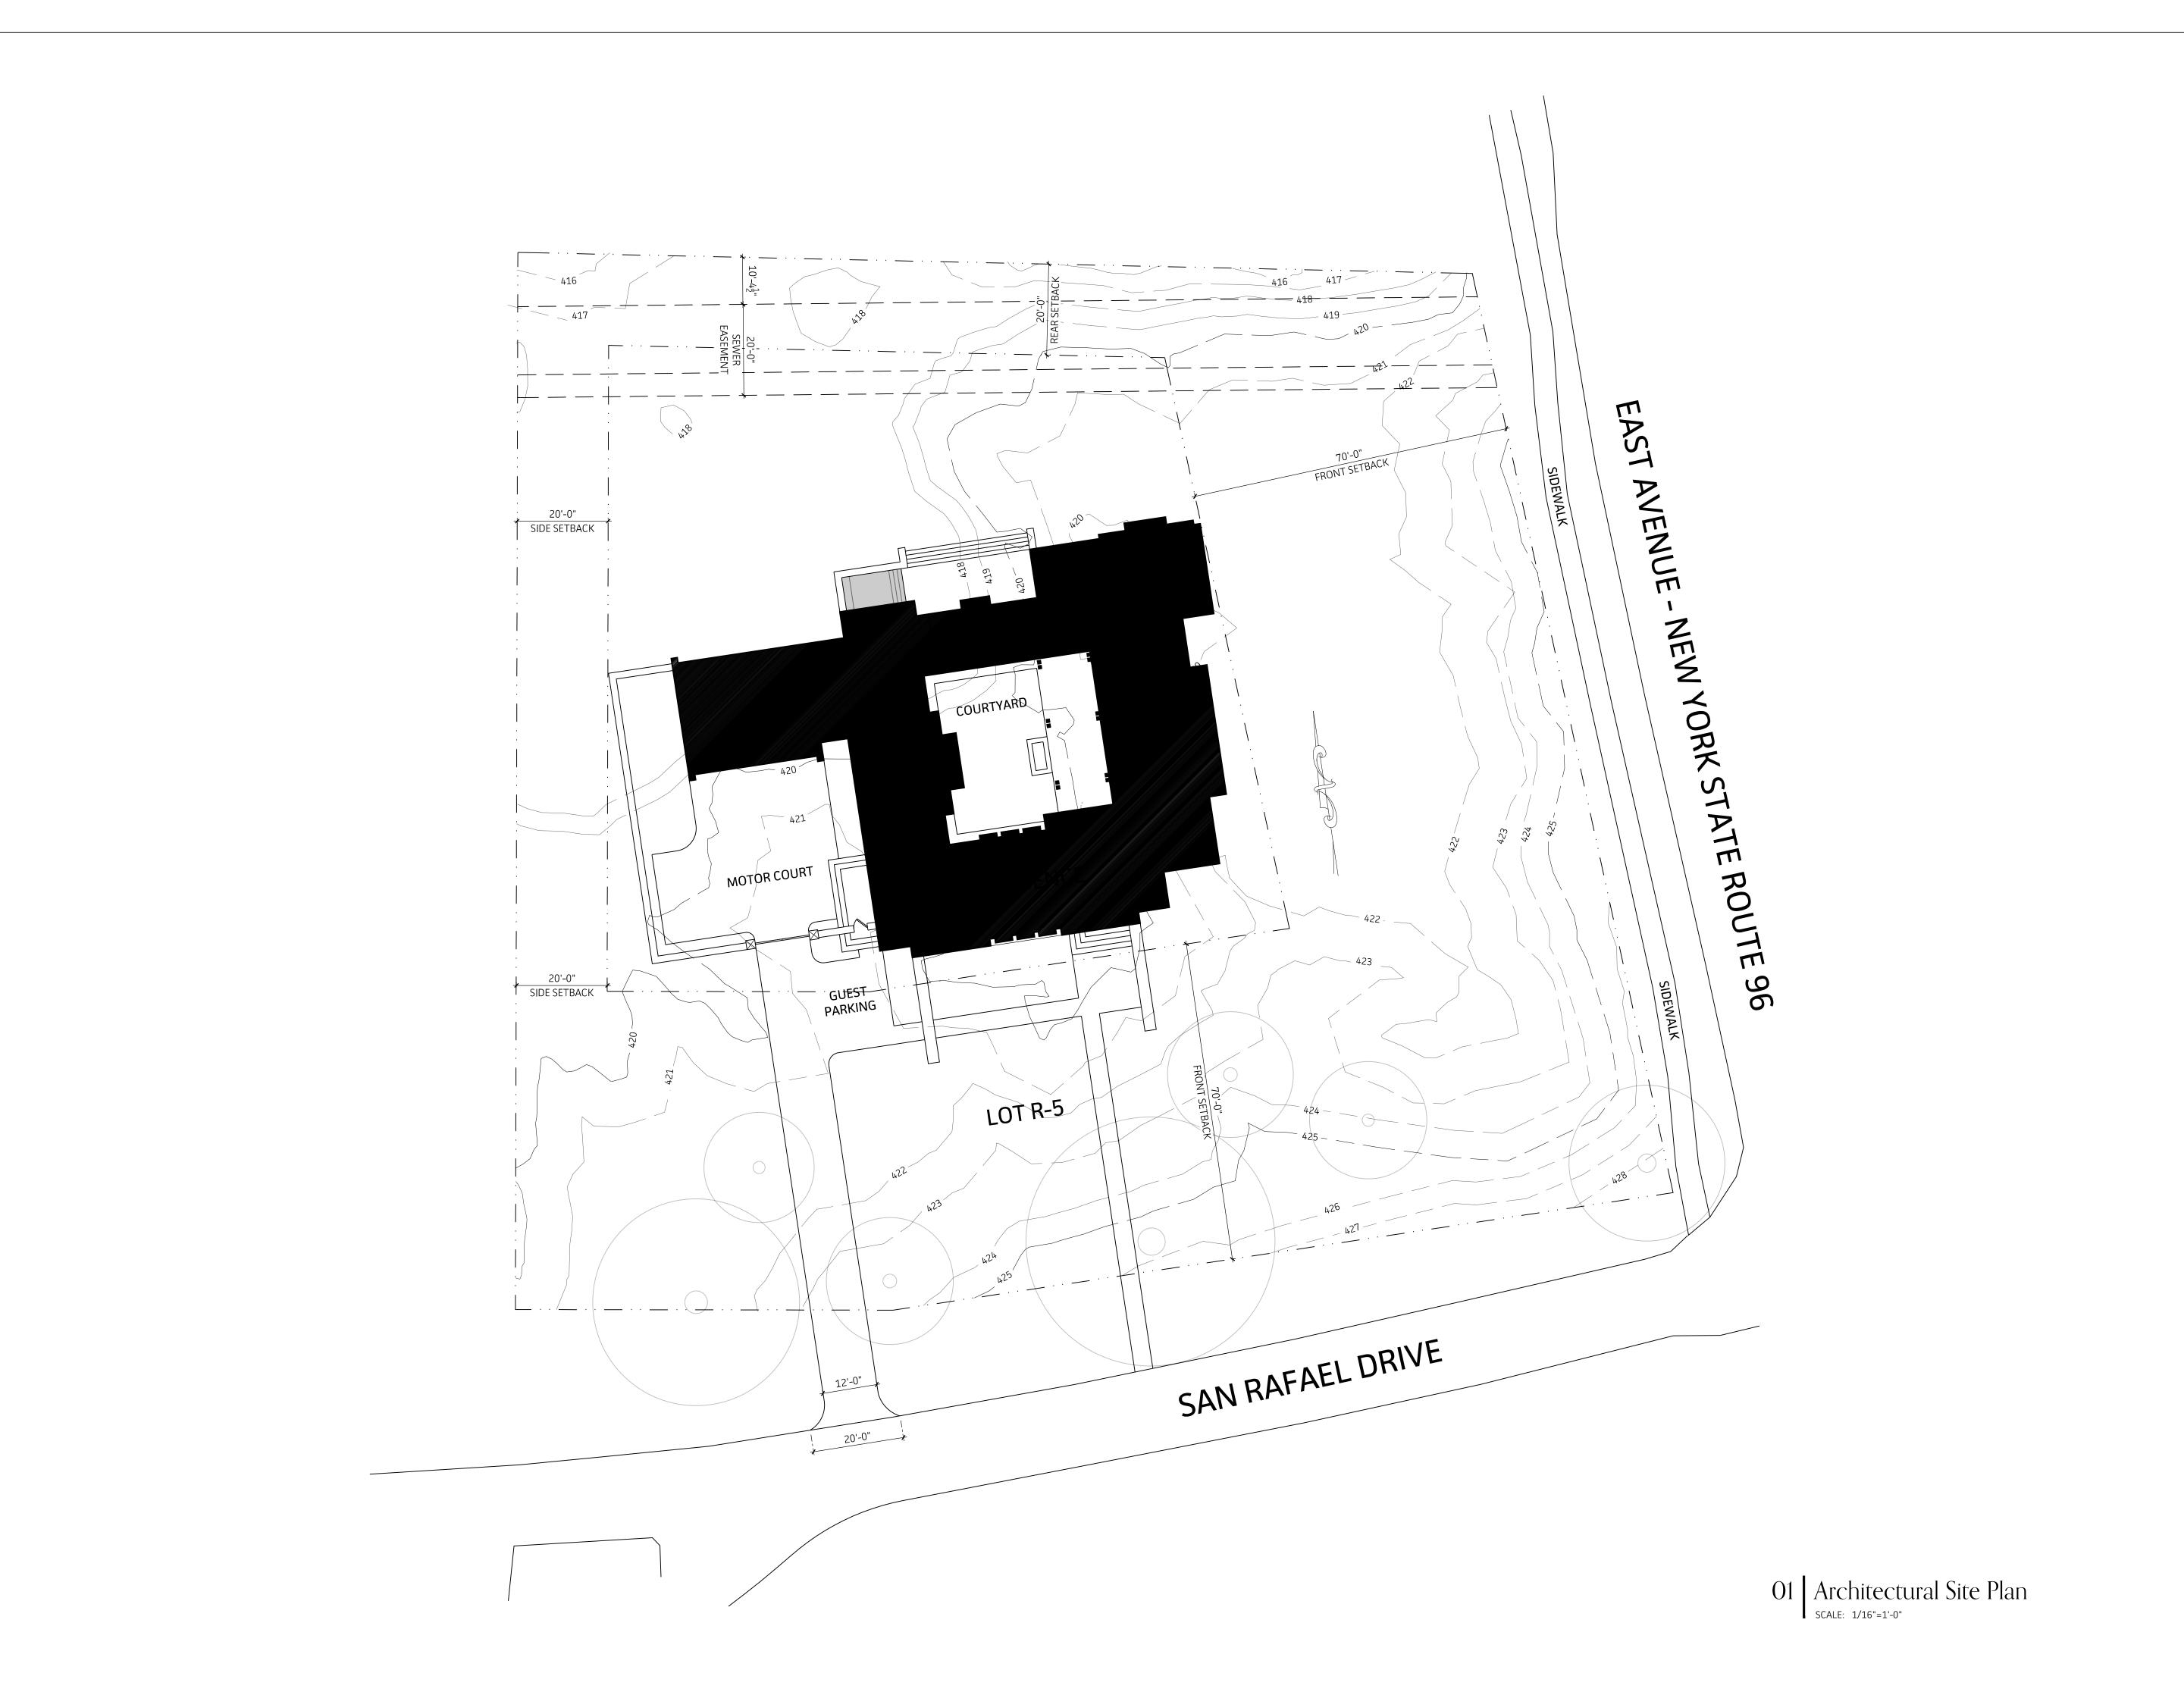

NOT FOR CONSTRUCTION


Krapf Residence


4 San Rafael Drive Rochester, New York 14618


DATE O6/12/2020 RN SHECKED BY CR/JG

SHEET TITLE
SITE PLAN

A1.0

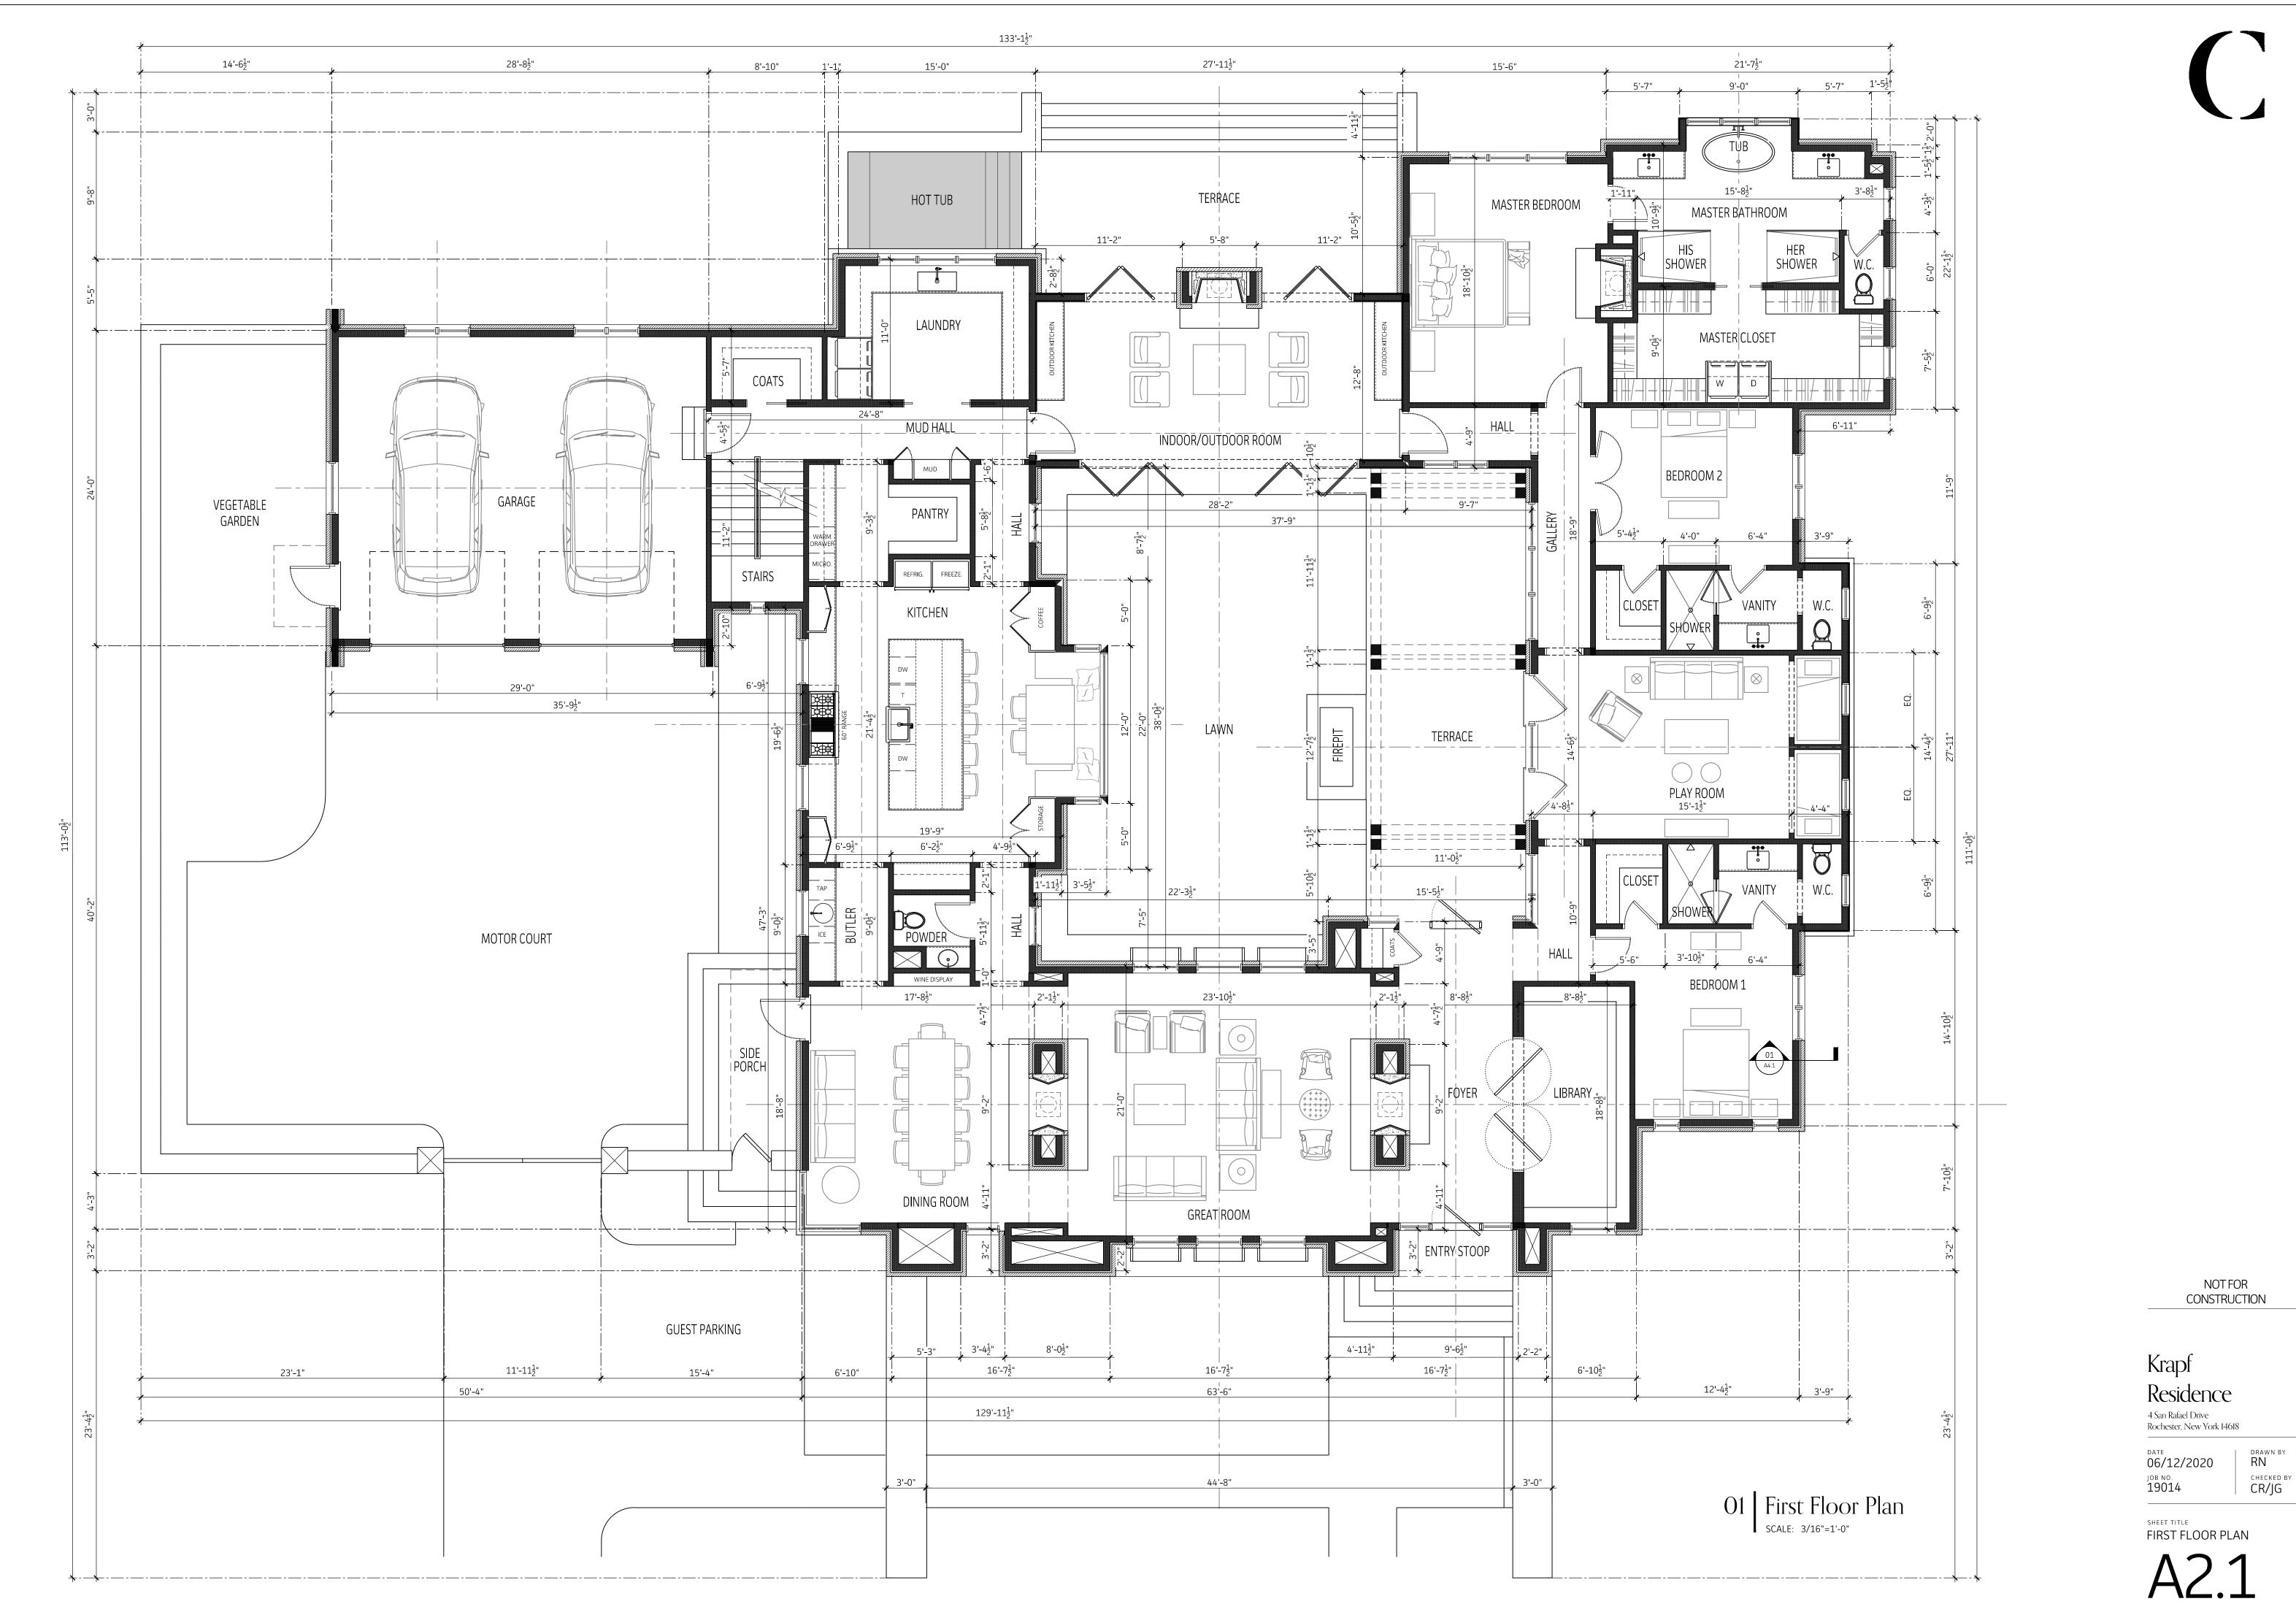

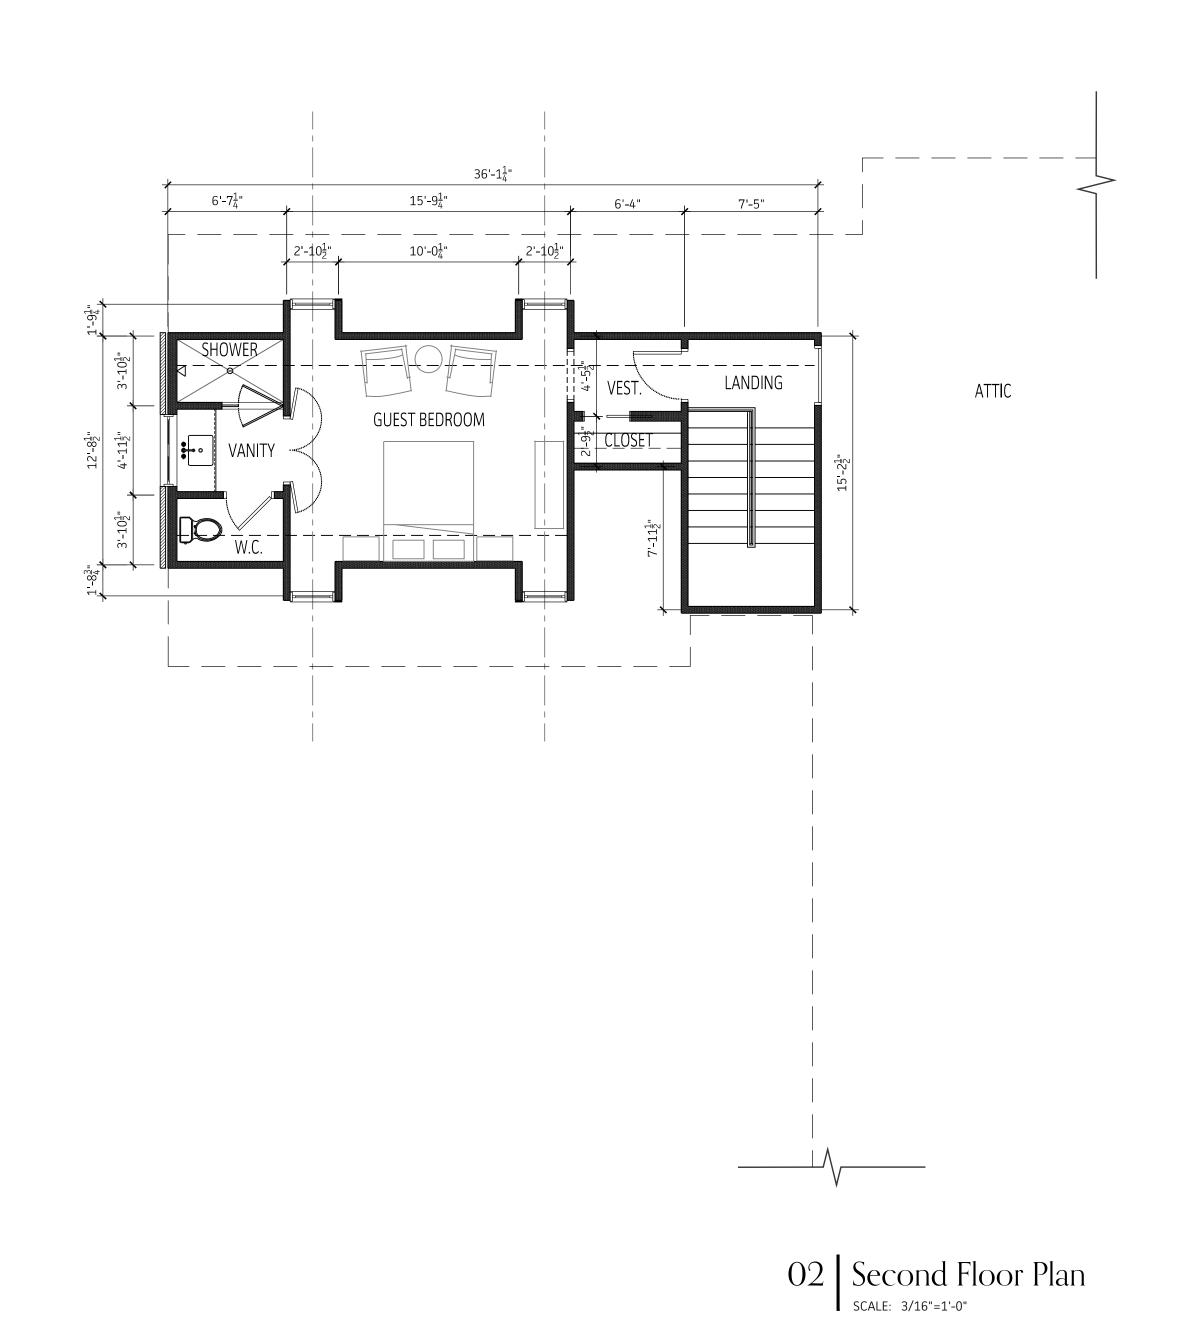

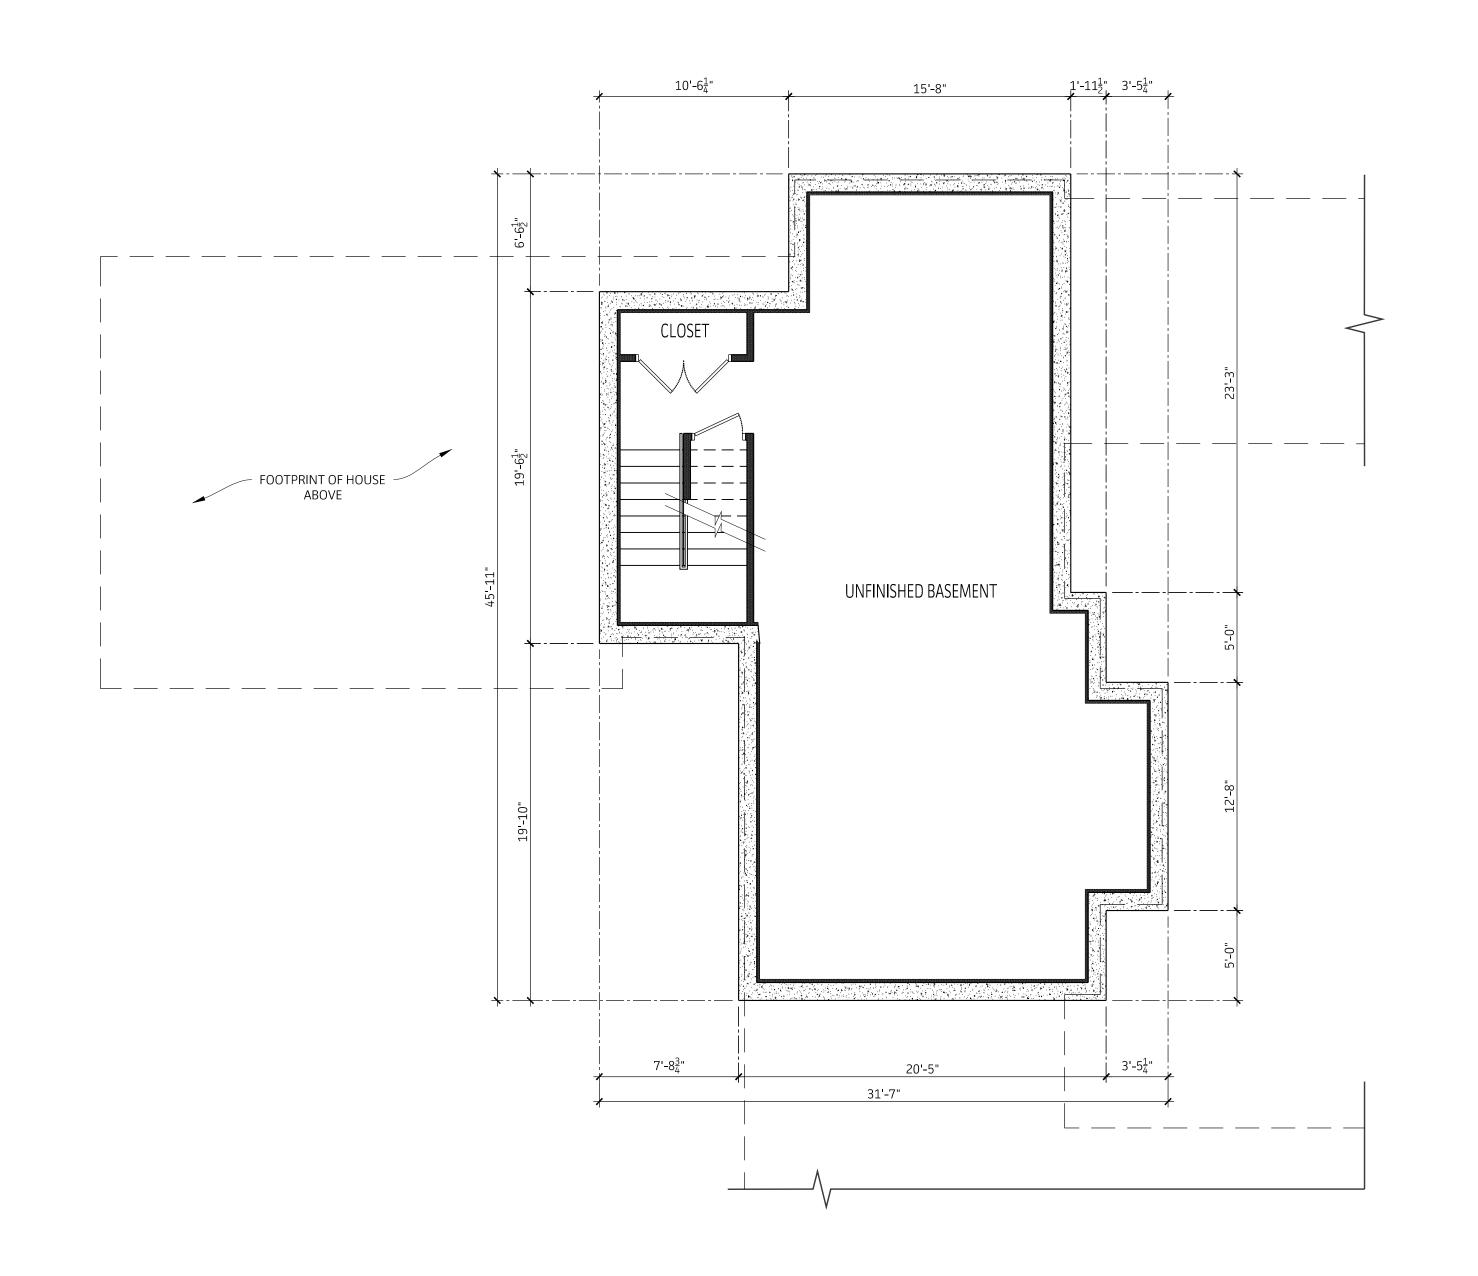

O1 Basement Floor Plan
SCALE: 3/16"=1'-0"

NOT FOR CONSTRUCTION

Krapf Residence 4 San Rafael Drive Rochester, New York 14618

DATE 06/12/2020 JOB NO. 19014

DRAWN BY
RN
CHECKED BY
CR/JG

BASEMENT & SECOND FLOOR PLAN





SLOPED LIMESTONE SILL

COPPER STEP FLASHING

STONE VENEER

BRICK SURROUND -

STONE VENEER —

ALUMINUM CLAD WINDOWS -

LIMESTONE LINTEL

STONE VENEER -

ALUMINUM CLAD WINDOWS

CONSTRUCTION

CR/JG

# Krapf Residence

REF. ELEV. 0'-0"

FIRST FLOOR F.F.E

FLAT SEAM COPPER ROOFING

O1 Front Elevation
SCALE: 3/16"=1'-0"

BRICK ARCH

STONE STEPS

STEEL AND GLASS DOOR

4 San Rafael Drive Rochester, New York 14618


DATE 06/12/2020 јов NO. **19014** 


SHEET TITLE
ELEVATIONS


STONE VENEER —


FLAT SEAM COPPER ROOFING —

WOOD VEHICLE GATE; STAINED

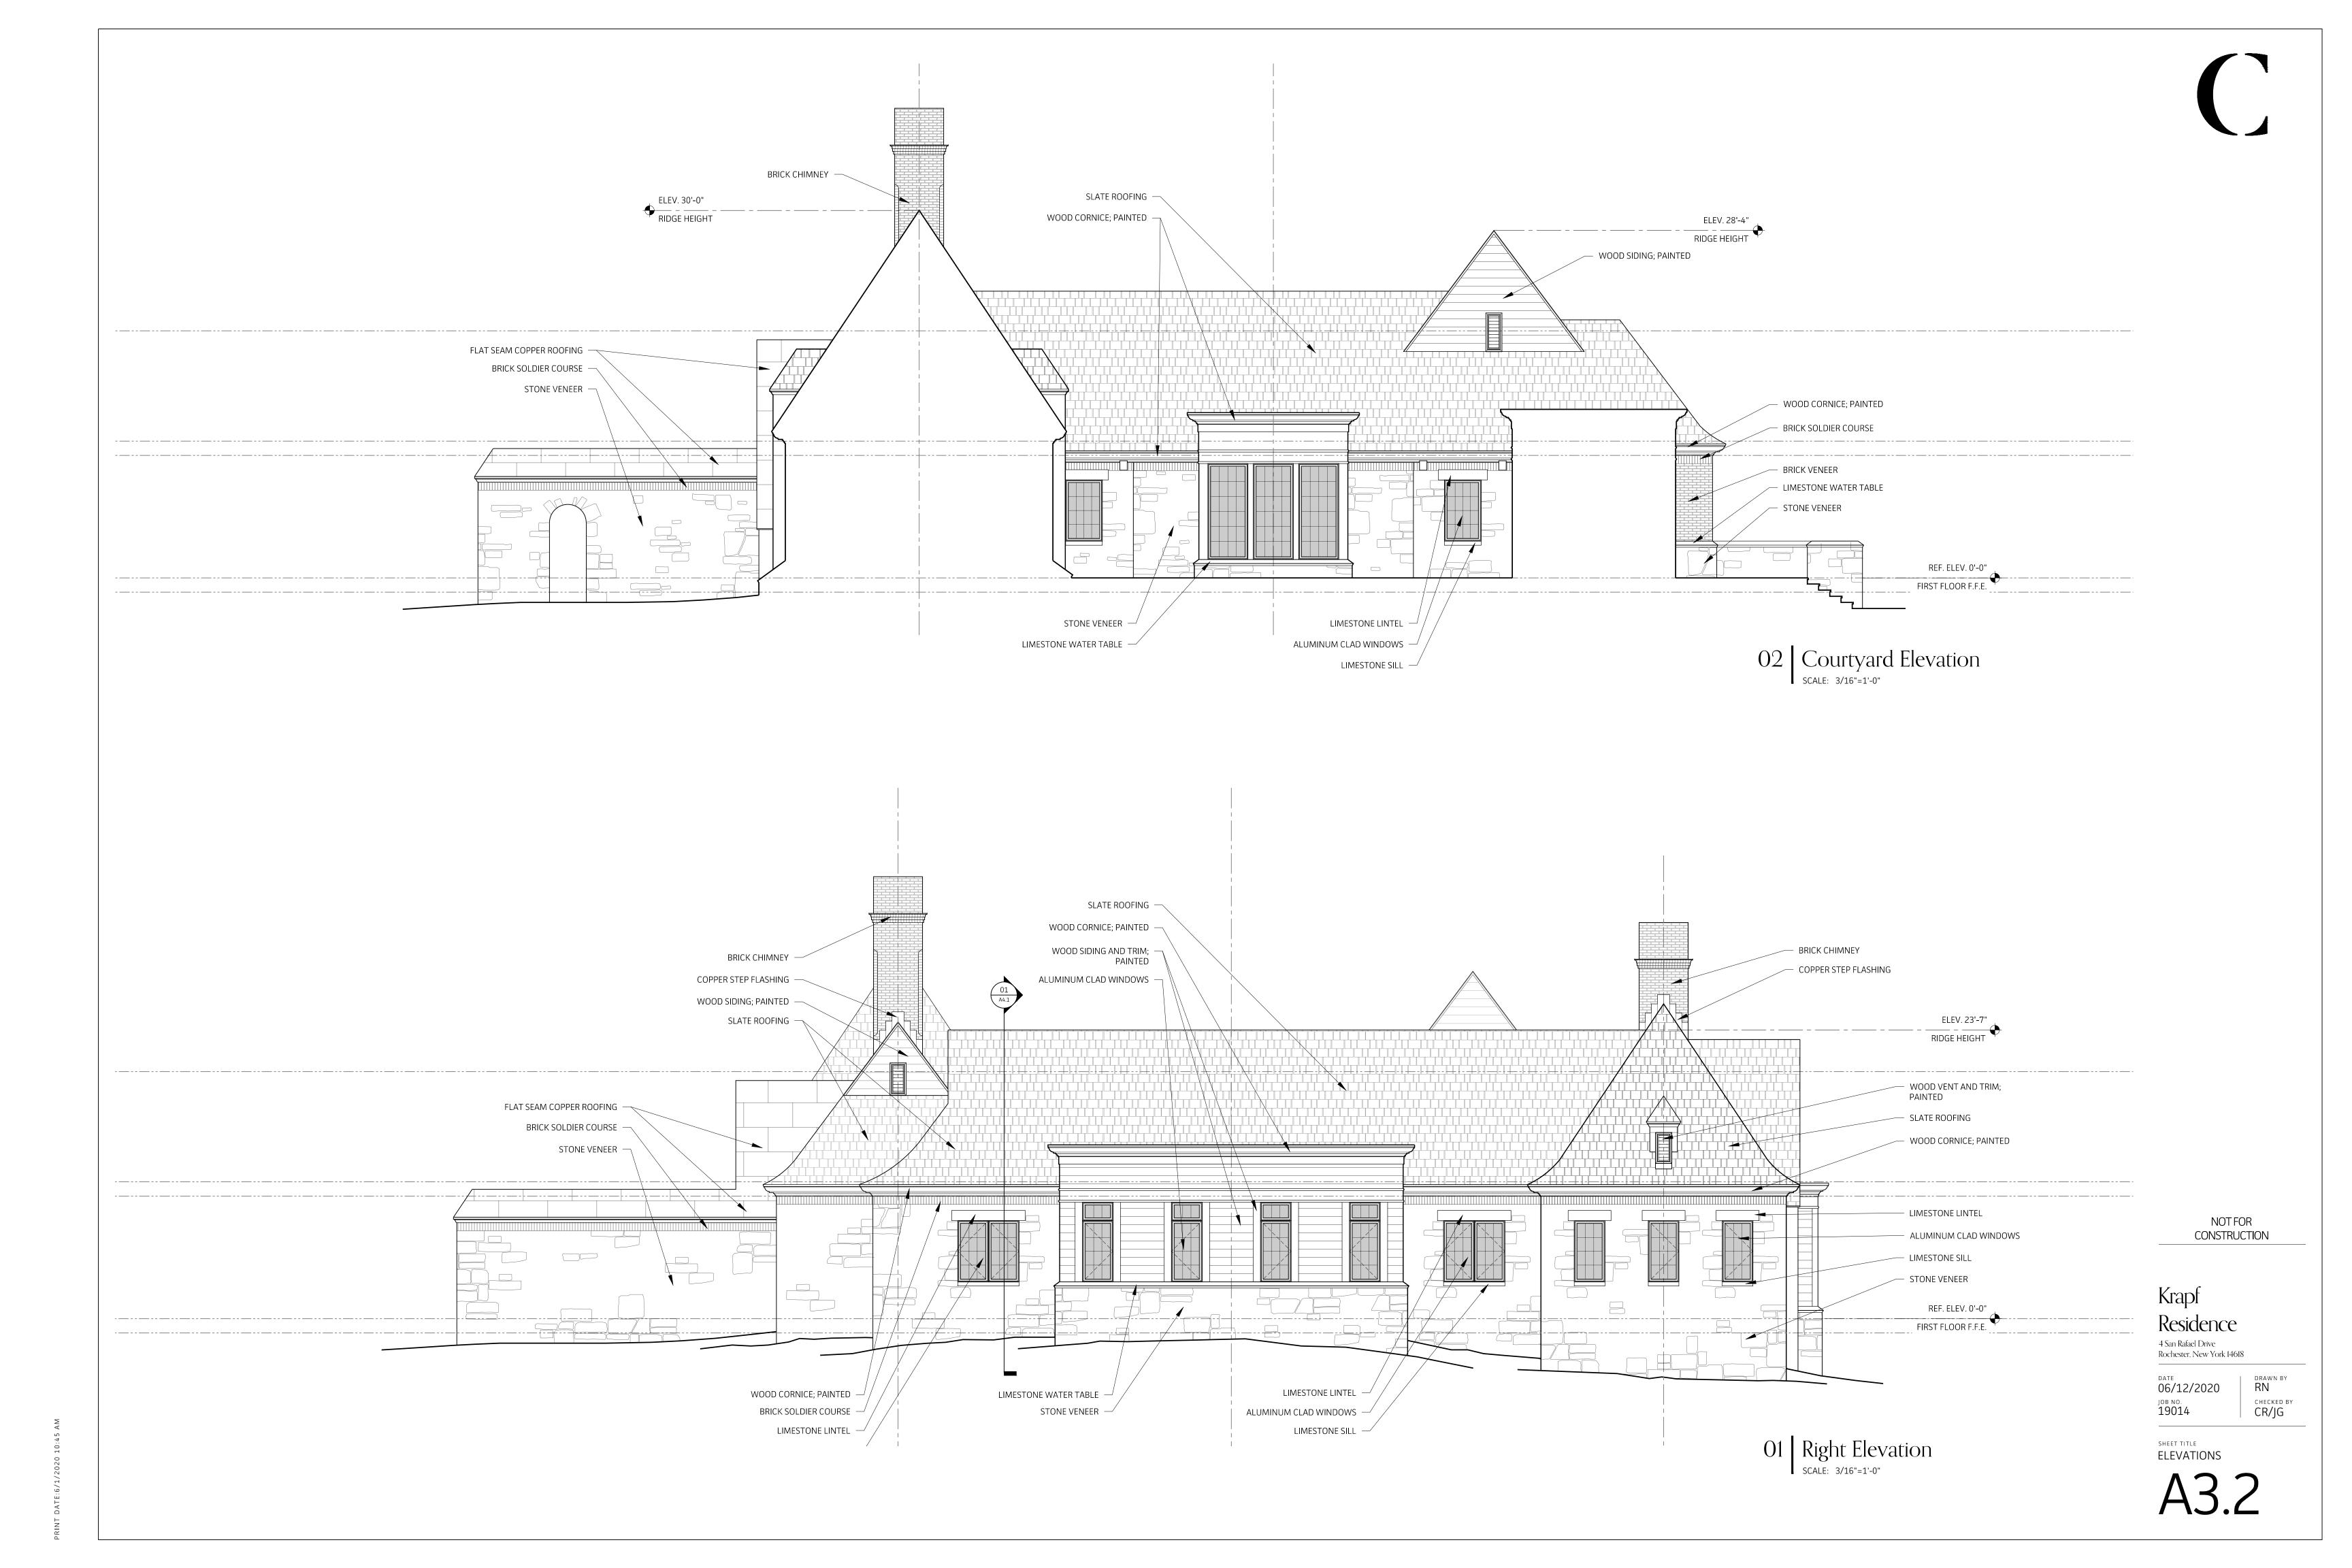

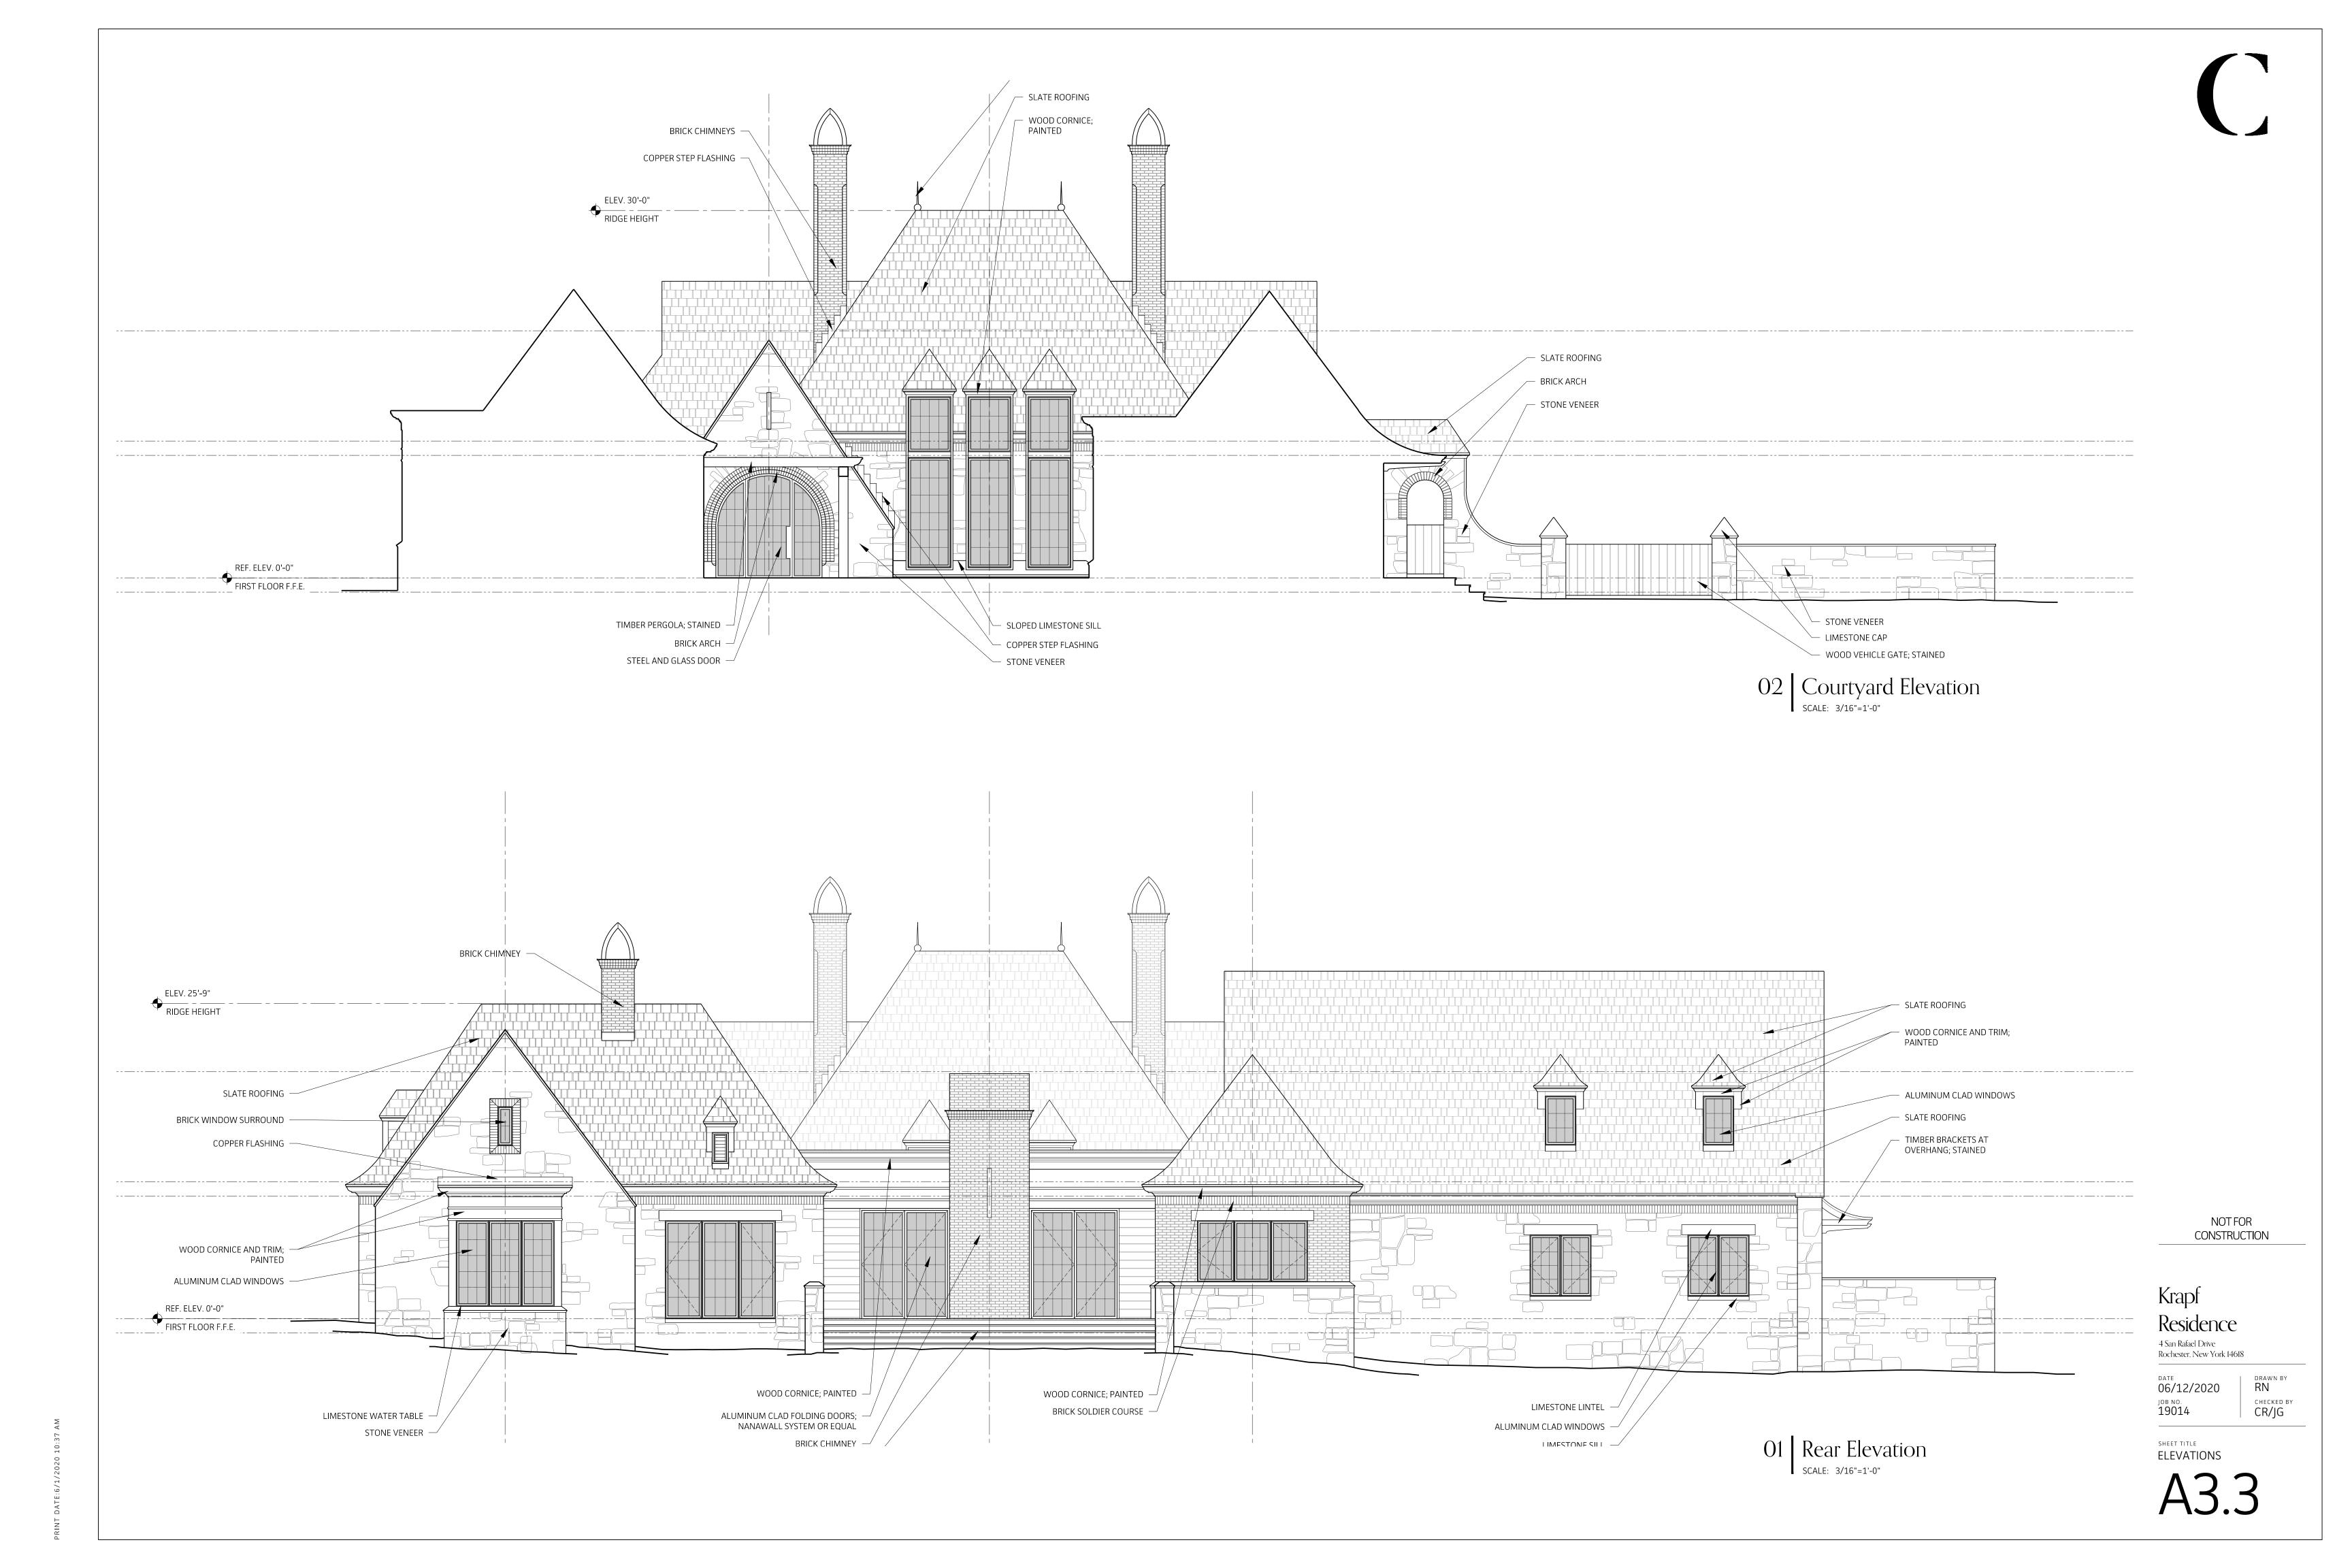

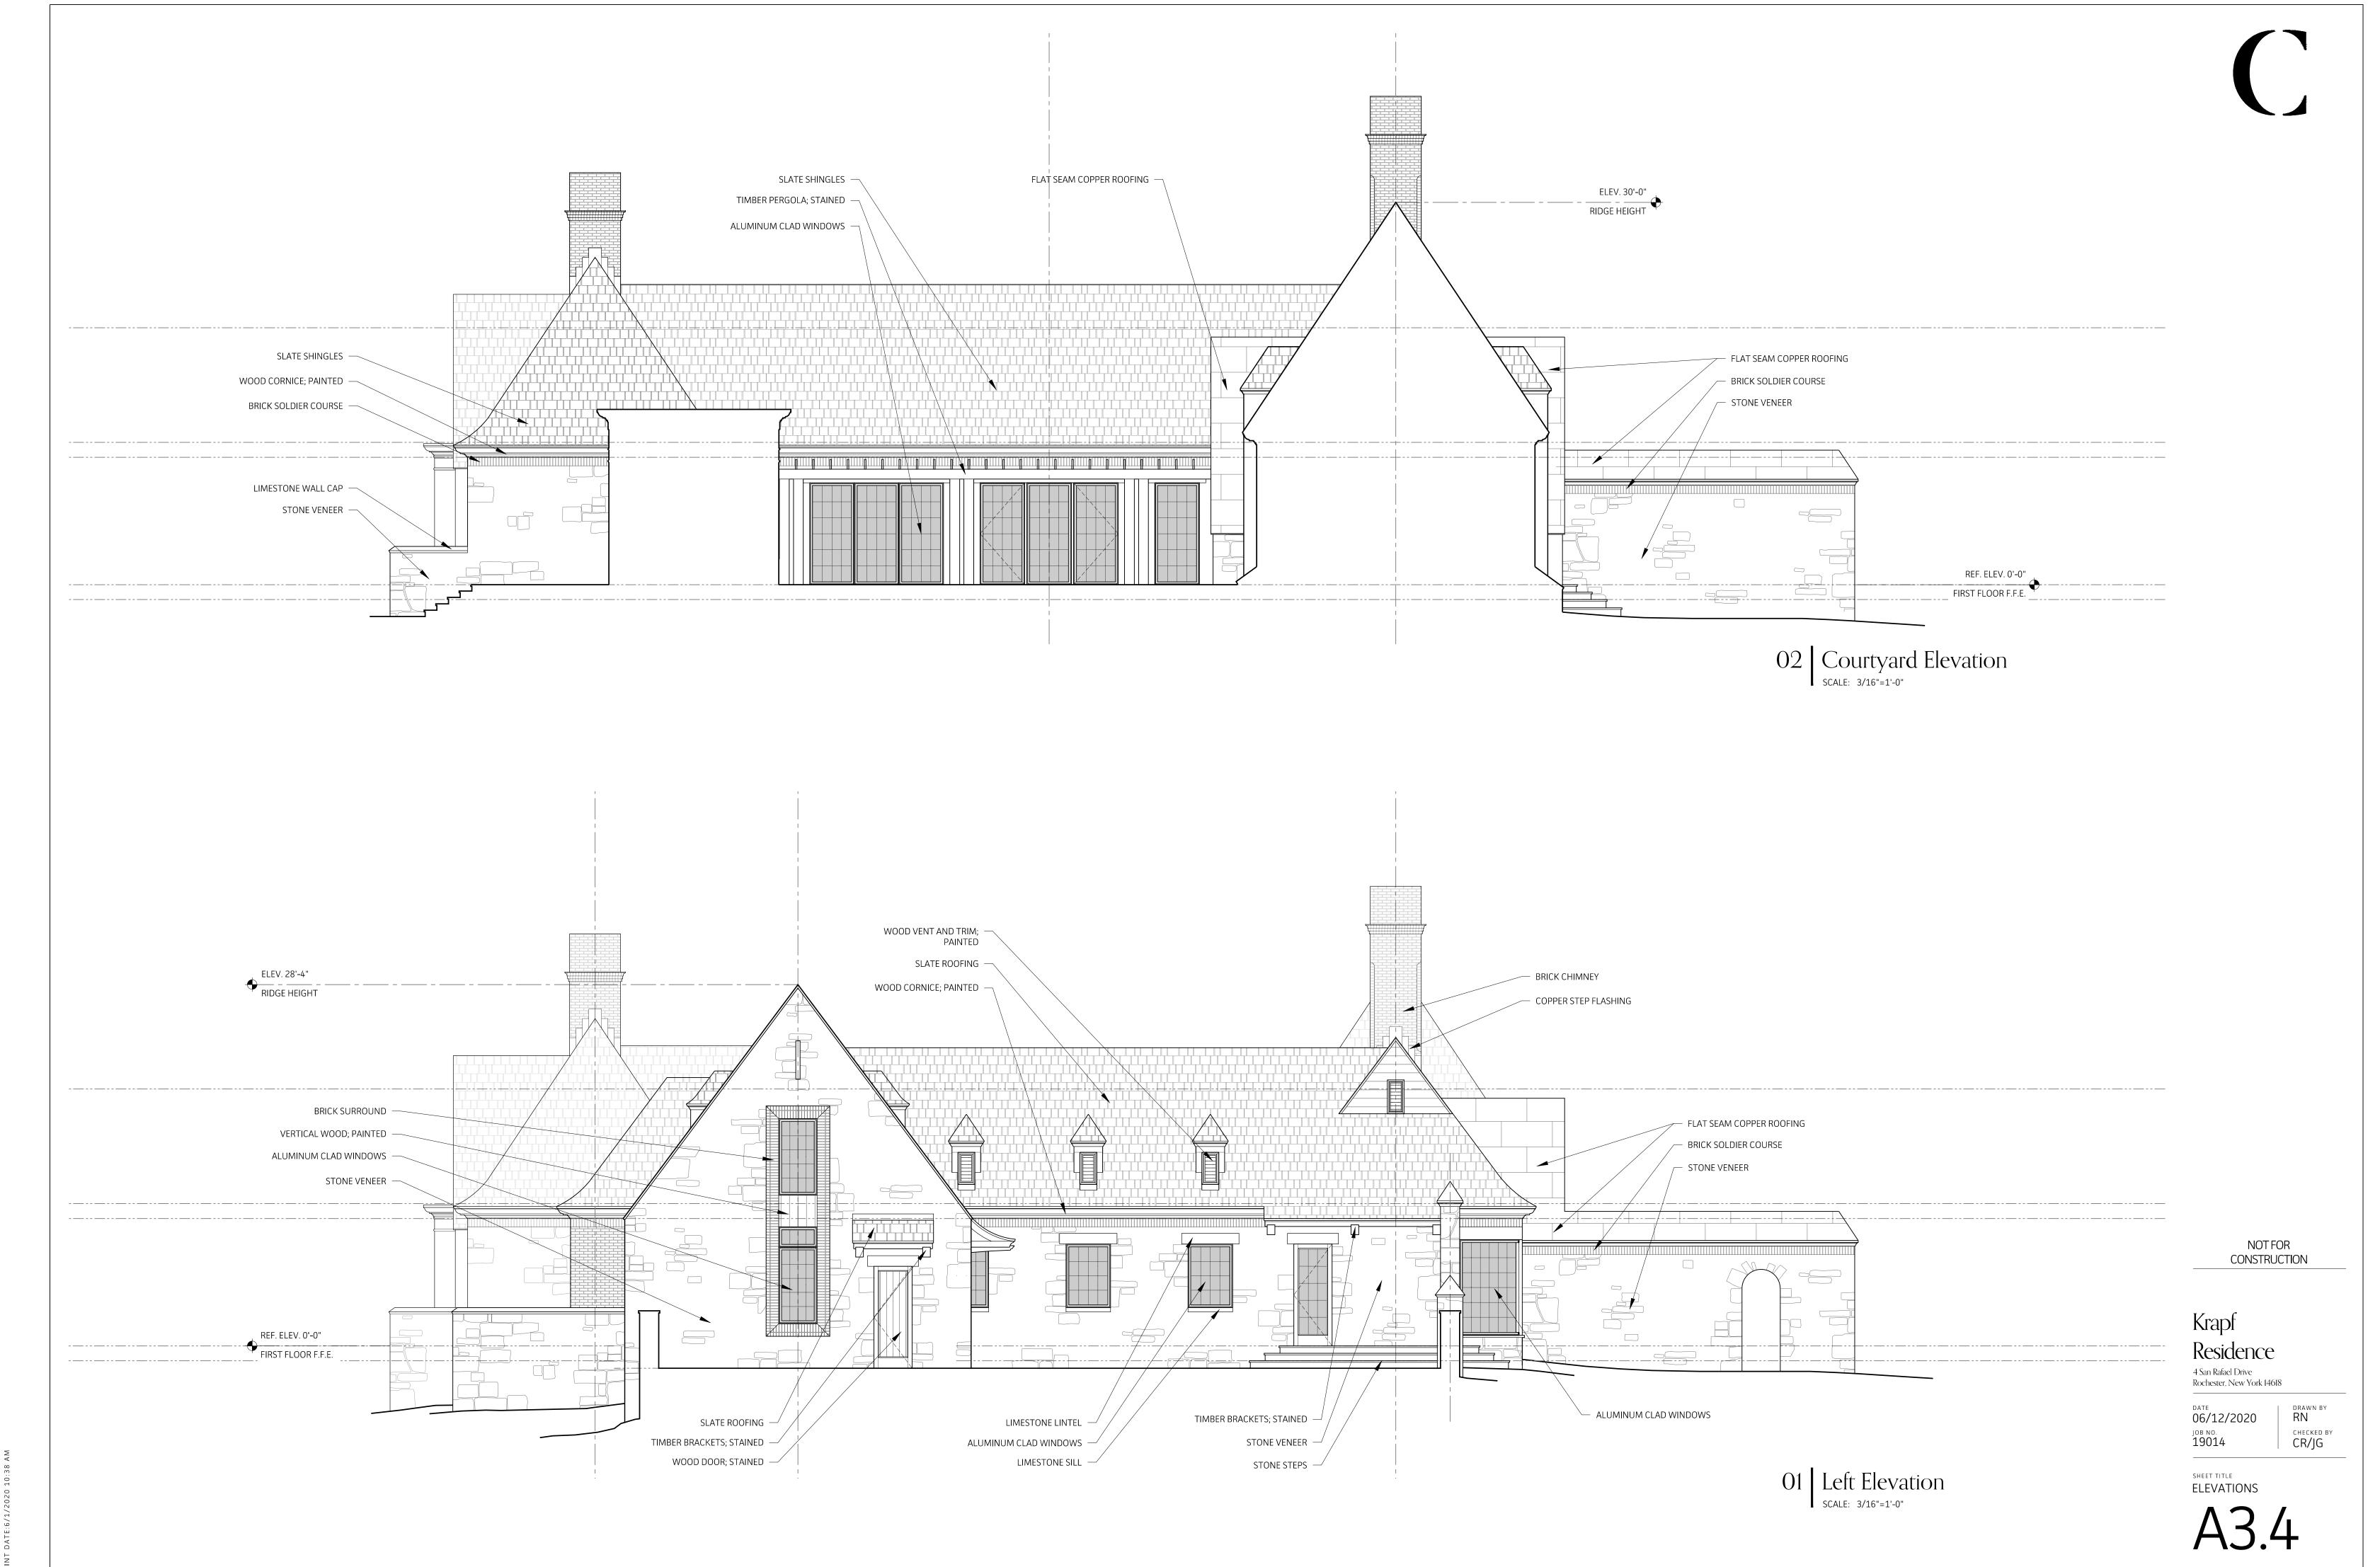

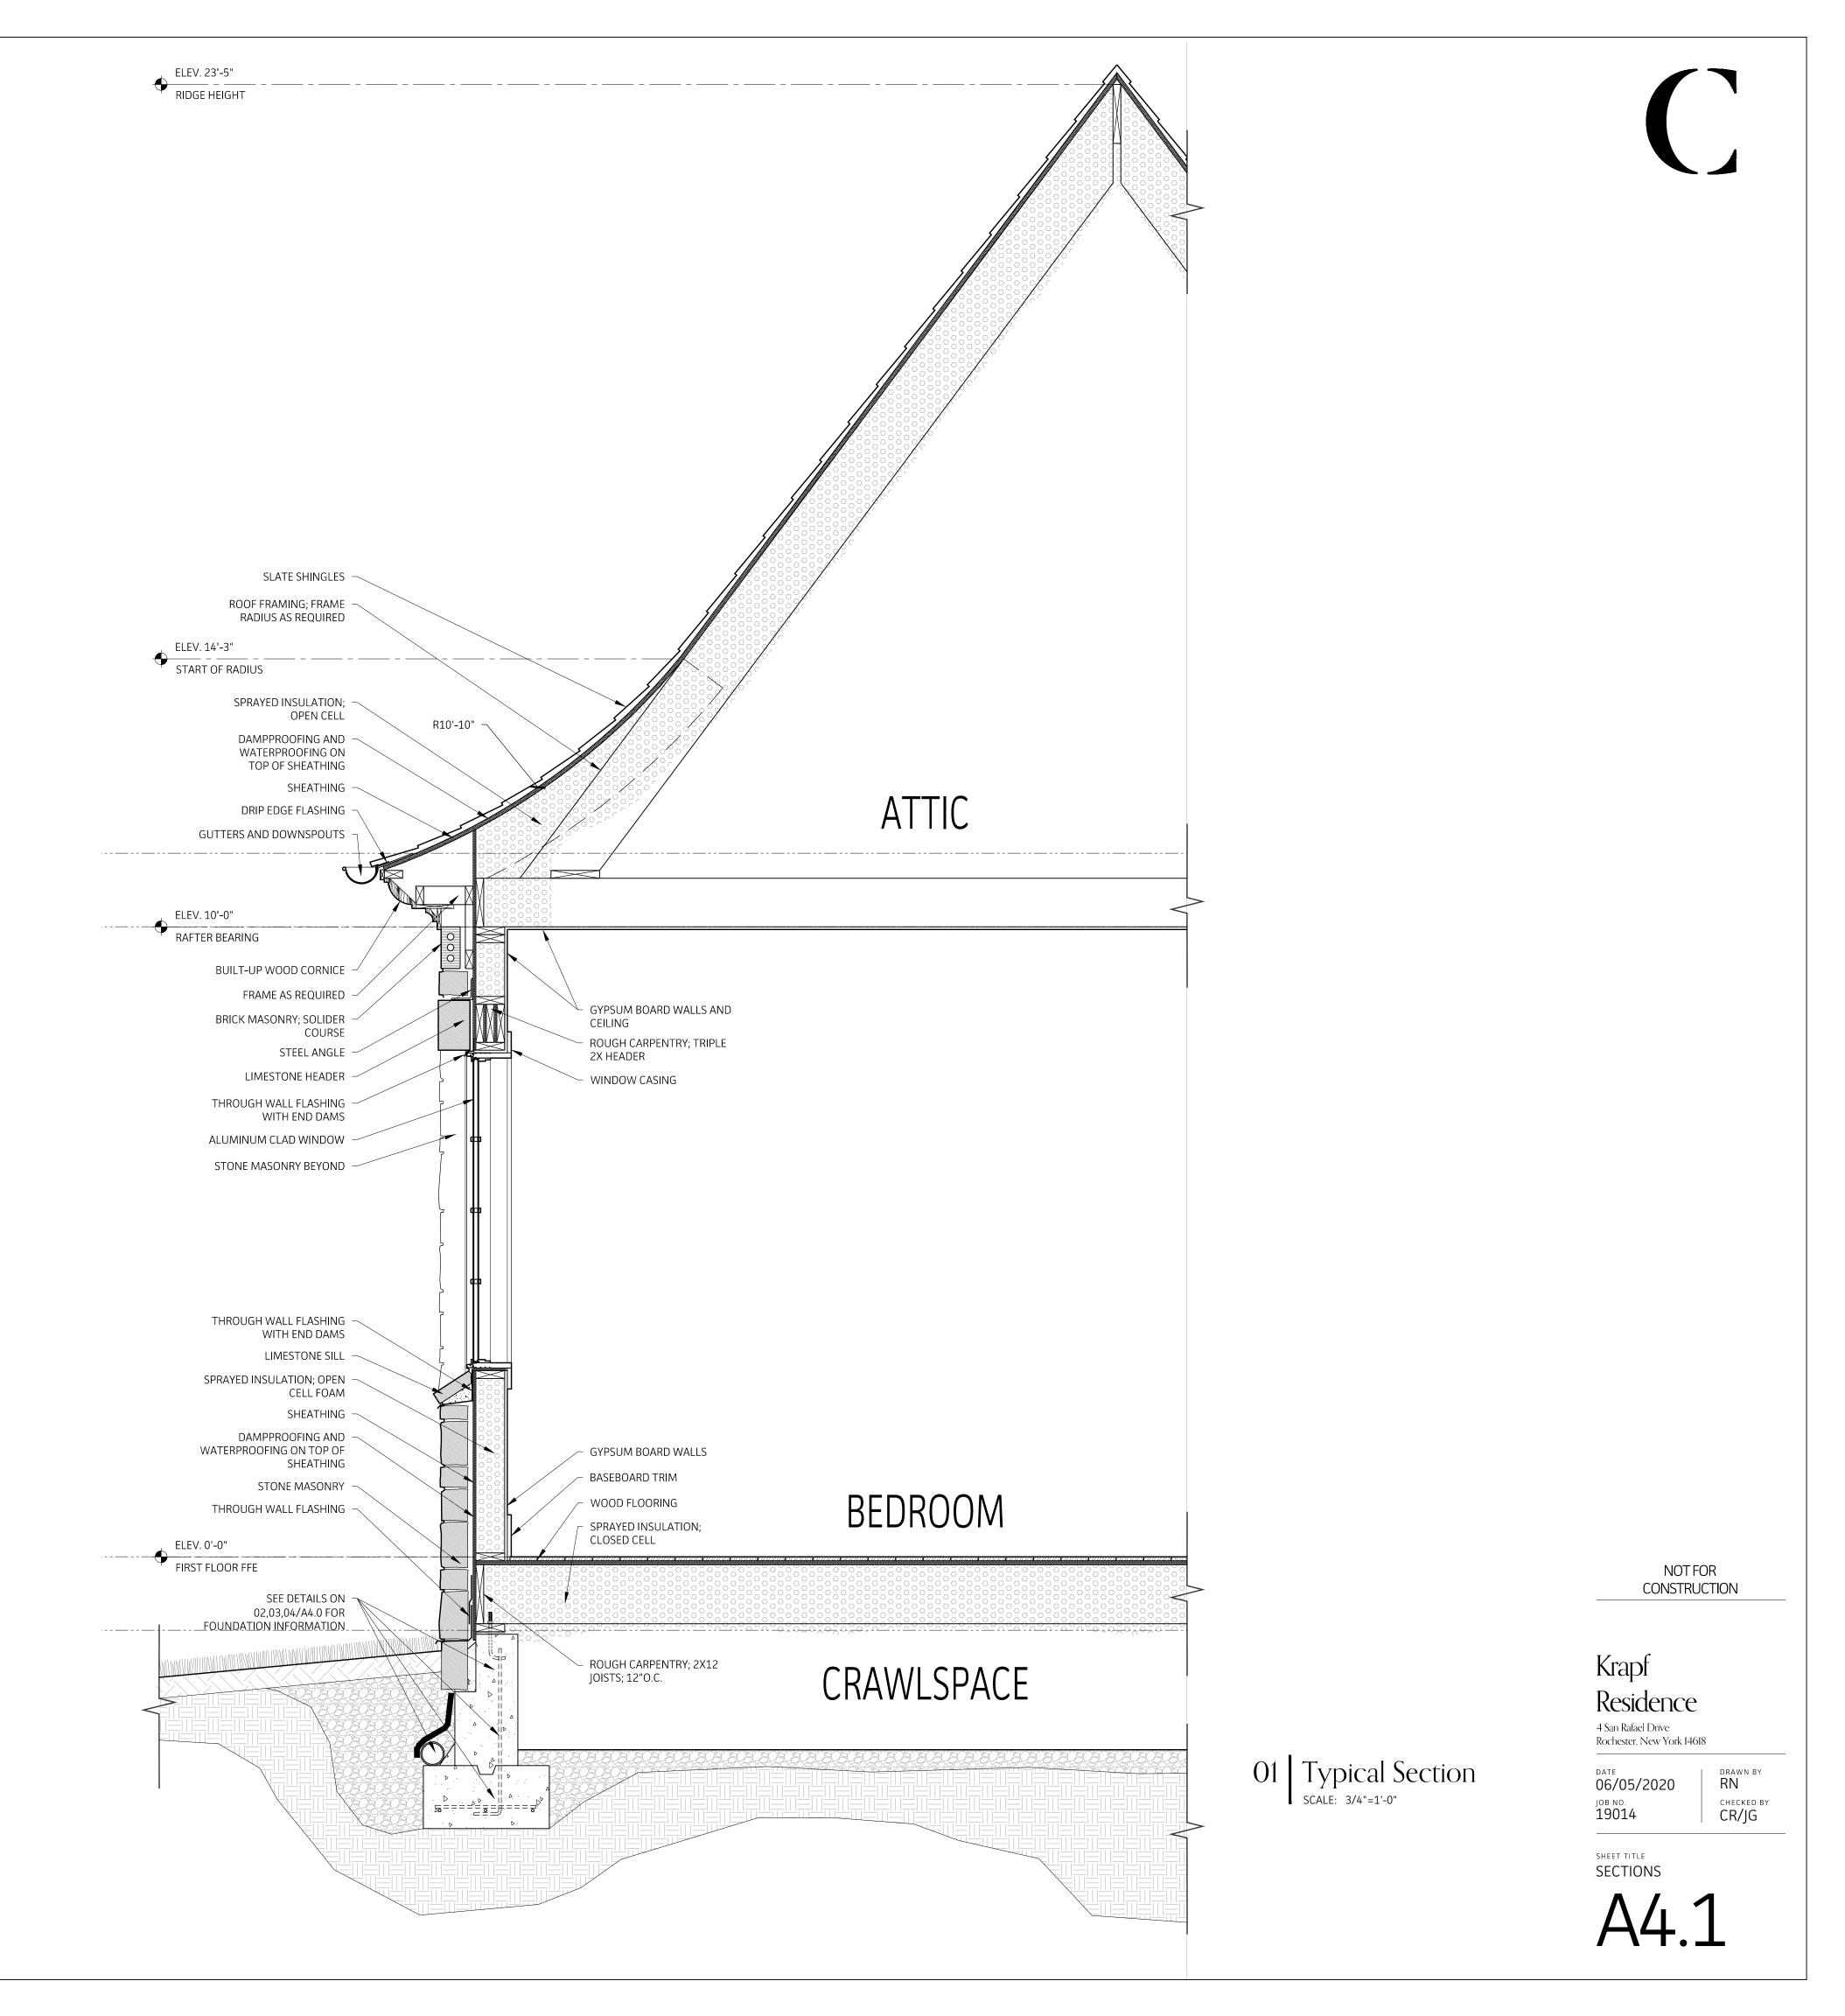

CRAWLSPACE OR

SEE SECTIONS

FINISH GRADE

SEE 05/A4.0 FOR

CONCRETE; REINFORCING AS

(3) #4 BARS;

CRAWLSPACE OR BASEMENT STEM -WALL; SEE SECTIONS

WATERPROOFING; CONTINUOUS

CONCRETE; FOUNDATION WALL

DAMPPROOFING &

CONCRETE OR NON DEGRADABLE CANT

FILTER FABRIC

FROM BUILDING

O3 | Foundation Drainage

- ROUGH CARPENTRY; EXTERIOR WALL FRAMING

ROUGH CARPENTRY OR

**PRODUCTS**; SEE SECTIONS

ENGINEERED WOOD

TERMITE SHIELD

- ENCAPSULATE

CRAWLSPACE

O2 | Masonry Ledge

FLOOR WITH SAND

- GROUT FILL COLLAR
JOINT WHERE
MASONRY IS BELOW
GRADE

MASONRY IS BELOW
GRADE

EXCAVATION AND FILL;

GRAVEL BACKFILL

CONCRETE; 4" PERFORATED

FOUNDATION DRAIN; SLOPE AWAY

EXCAVATION AND FILL; VIRGIN OR COMPACT SOIL; DEPTH WILL VARY DEPENDING ON SITE CONDITIONS

STONE MASONRY; STONE TIES -

FLASHING AND SHEET METAL; -THRU WALL FLASHING TO WEEPS; WEEPS AT 244

8" MIN

STONE VENEER BELOW GRADE

EXTEND FOOTING AND PROVIDE ADDITIONAL CMU FOR TAPERED VENEER AS NEEDED

SEE DETAILS 04,05/A4.0

STONE MASONRY

WATERPROOFING

MORTAR NET

DAMPPROOFING AND

BEHIND DRAINAGE MAT

DRAINAGE; DRAINAGE MAT

CONTINUOUS

REQUIRED; MINIMUM

DRAINAGE

BASEMENT STEM WALL;

CONCRETE; REINFORCING

AS REQUIRED; MINIMUM

#4 BAR AT 48" O.C. WITH STANDARD HOOK

CONCRETE;

REINFORCING AS REQUIRED; MINIMUM #4 TIES AT 24" O.C.

FOOTING WIDTH MAY

PLANS

O4 Typical Footing

SCALE: 3/4"=1'-0"

VARY BY LOCATION; SEE


INTERIOR OR

CRAWLSPACE







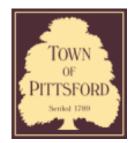

### **Town of Pittsford**

Department of Public Works 11 South Main Street Pittsford, New York 14534

Permit # B20-00086

Phone: 585-248-6250 FAX: 585-248-6262

# DESIGN REVIEW AND HISTORIC PRESERVATION BOARD REFERRAL OF APPLICATION

Property Address: 23 & 25 Skylight Trail Pittsford, NY 14534

**Tax ID Number:** 192.06-1-18, 192.06-1-17

**Zoning District:** 

Owner: S&J Morrell Builders Inc.

Applicant: S&J Morrell Builders Inc.

Application Type	n Tvpe:	lication	aaA
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<b>1</b> PP	iication Type.	
<b>✓</b>	Residential Design Review	Build to Line Adjustment
	§185-205 (B)	§185-17 (B) (2)
	Commercial Design Review §185-205 (B)	Building Height Above 30 Feet §185-17 (M)
	Signage	Corner Lot Orientation
	§185-205 (C)	§185-17 (K) (3)
	Certificate of Appropriateness	Flag Lot Building Line Location
	§185-197	§185-17 (L) (1) (c)
	Landmark Designation	Undeveloped Flag Lot Requirements
	§185-195 (2)	§185-17 (L) (2)
	Informal Review	


**Project Description:** Applicant is returning to request design review for the proposed construction of a new town home dwelling. The proposed building will consist of 2 attached single family dwellings sharing a common wall. Lot 40 (23 Skylight Trail) will be approximately 2013 sq. ft. and Lot 39 (25 Skylight Trail) will be 2000 sq. ft. The town homes will be located in the new Alpine Ridge development.

Meeting Date: July 23, 2020

## RN Residential Neighborhood Zoning




, . .

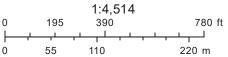

Town of Pittsford GIS

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## X= Proposed X= Built

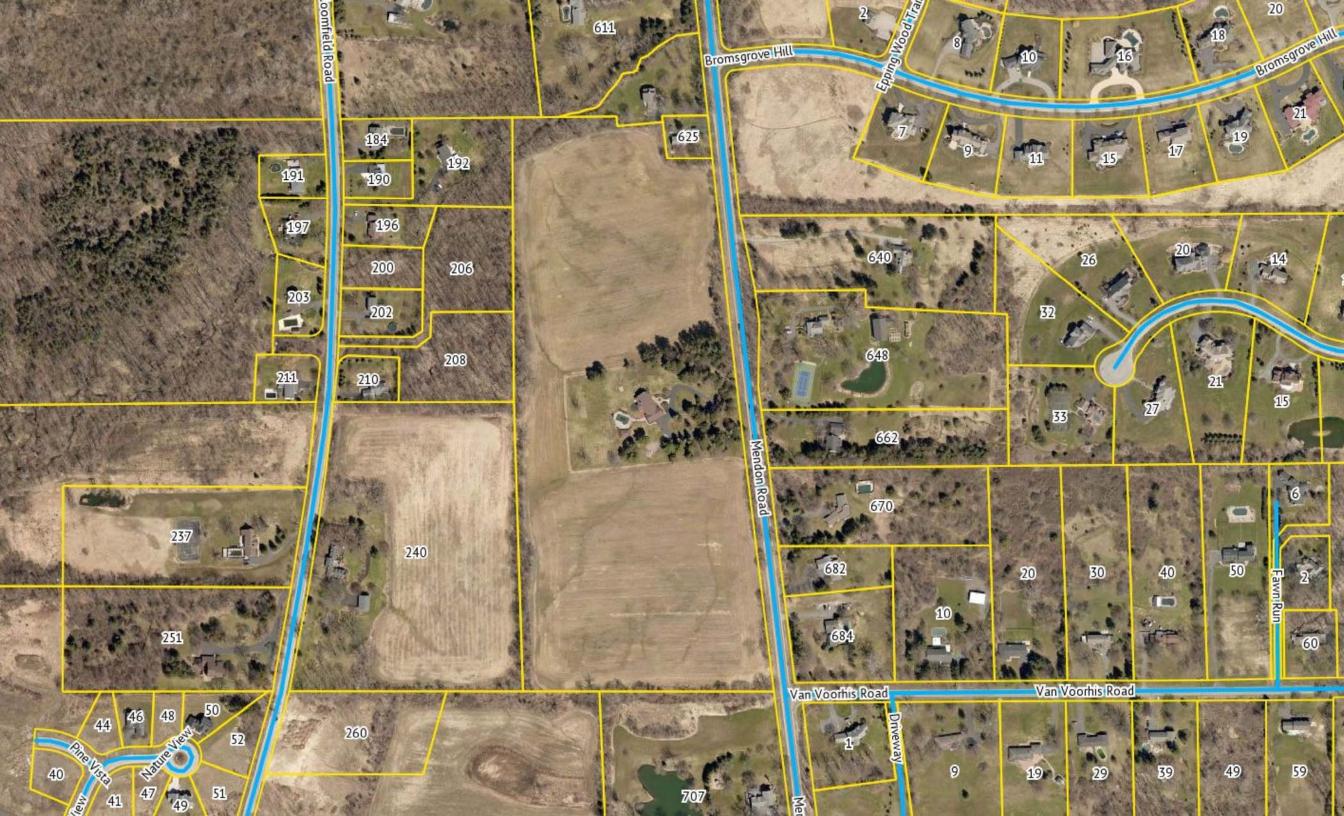


		Cobblestone	Light Mist	Navajo Beige	Khaki Brown	Booth Bay Blue
= Side Load Garage	Color	8	8	×	8	8
J/#!\$aXTg[V[`YZSeefa`W	Building Step	×				

"X" MARKS LOCATION OF LOTS 39 & 40 ALPINERIDGE Walking Trails A MORRELL COMMUNITY Section One nmunity Home & Park Walking Trails MENDON ROAD (STATE RTE 64)



#### PLOT PLAN

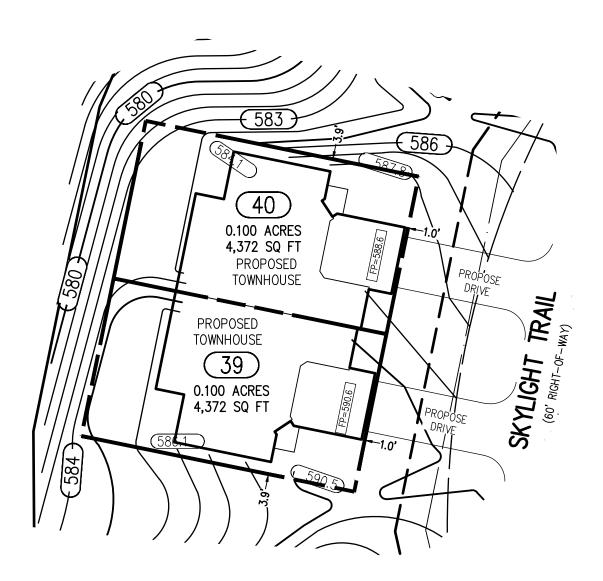

#### REFERENCES:

- A PLAN ENTITLED "ALPINE RIDGE SUBDIVISION, SECTION 1, BEING A RE-SUBDIVISION OF THE KEVIN RYAN SUBDIVISION, AS FILED 4/15/2019 IN M.C.C.O. AS LIBER 358 OF MAPS, PAGE 41," PREPARED BY DOUGLAS W. MAGDE, L.S. HAVING DRAWING NUMBER SV1.0 AND LAST REVISED JUNE 27, 2019.
- 2. AN ABSTRACT OF TITLE WAS NOT PROVIDED FOR THE COMPLETION OF THIS SURVEY.

#### NOTES:

- 1. THE BEARING BASE SHOWN HEREON WAS TAKEN FROM REFERENCE 1.
- 2. SETBACK REQUIREMENTS:

FRONT 0' (LOT) 25' (R.O.W.)

SIDE 0'

REAR C

- 3. UTILITY EASEMENT TO THE TOWN OF PITTSFORD PER REFERENCE 1.
- 4. GRADING SHOW HEREON WAS TAKEN FROM A PLAN ENTITLED "FINAL SECTION 1 PLANS FOR ALPINE RIDGE SUBDIVISION, GRADING PLAN (SHEET 1 OF 2), PREPARED BY MARATHON ENGINEERING, HAVING JOB NUMBER 0891-17, DRAWING NUMBER C4.0 AND LAST REVISED JUNE 27, 2019.

"CERTIFICATIONS INDICATED HEREON SHALL RUN ONLY TO THE PERSON FOR WHOM THE SURVEY IS PREPARED, AND ON HIS BEHALF TO THE TITLE COMPANY, GOVERNMENTAL AGENCY AND LENDING INSTITUTION. LISTED HEREON, AND TO THE ASSIGNEES OF THE LENDING INSTITUTION. CERTIFICATIONS ARE NOT TRANSFERABLE TO ADDITIONAL INSTITUTIONS OR SUBSEQUENT OWNERS." THIS MAP AND THE INFORMATION SHOWN HEREON IS NOT TO BE USED WITH AN "AFFIDANT OF NO CHANGE." BME ASSOCIATES ASSUMES NO LIABILITY TO THE PARTIES NOTED HEREON OR TO ANY FUTURE OWNER, TITLE COMPANY, GOVERNMENTAL AGENCY, ATTORNEY, OR LENDING INSTITUTION IN THE EVENT THAT THIS MAP IS USED WITH AN "AFFIDANT OF NO CHANGE," OR SIMILAR INSTITUMENT.

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"UNAUTHORIZED ALTERATION OR ADDITION TO THIS SURVEY MAP IS A VIOLATION OF SECTION 7209, OF THE NEW YORK STATE EDUCATION LAW."

BME ASSOCIATES

Engineers • Surveyors • Landscape Architects

10 LIFT BRIDGE LANE EAST FAIRPORT, NEW YORK 14450 PHONE 585-377-7360 FAX 585-377-7309


COPYRIGHT © 2020 BME Associates


# LOTS 39 & 40 ALPINE RIDGE SUBDIVISION SECTION 1 TOWN OF PITTSFORD MONROE COUNTY NEW YORK



DRAWN BY: GDB DATE: 7-2-20 SCALE: 1"=30' DWG NO: 2688-04




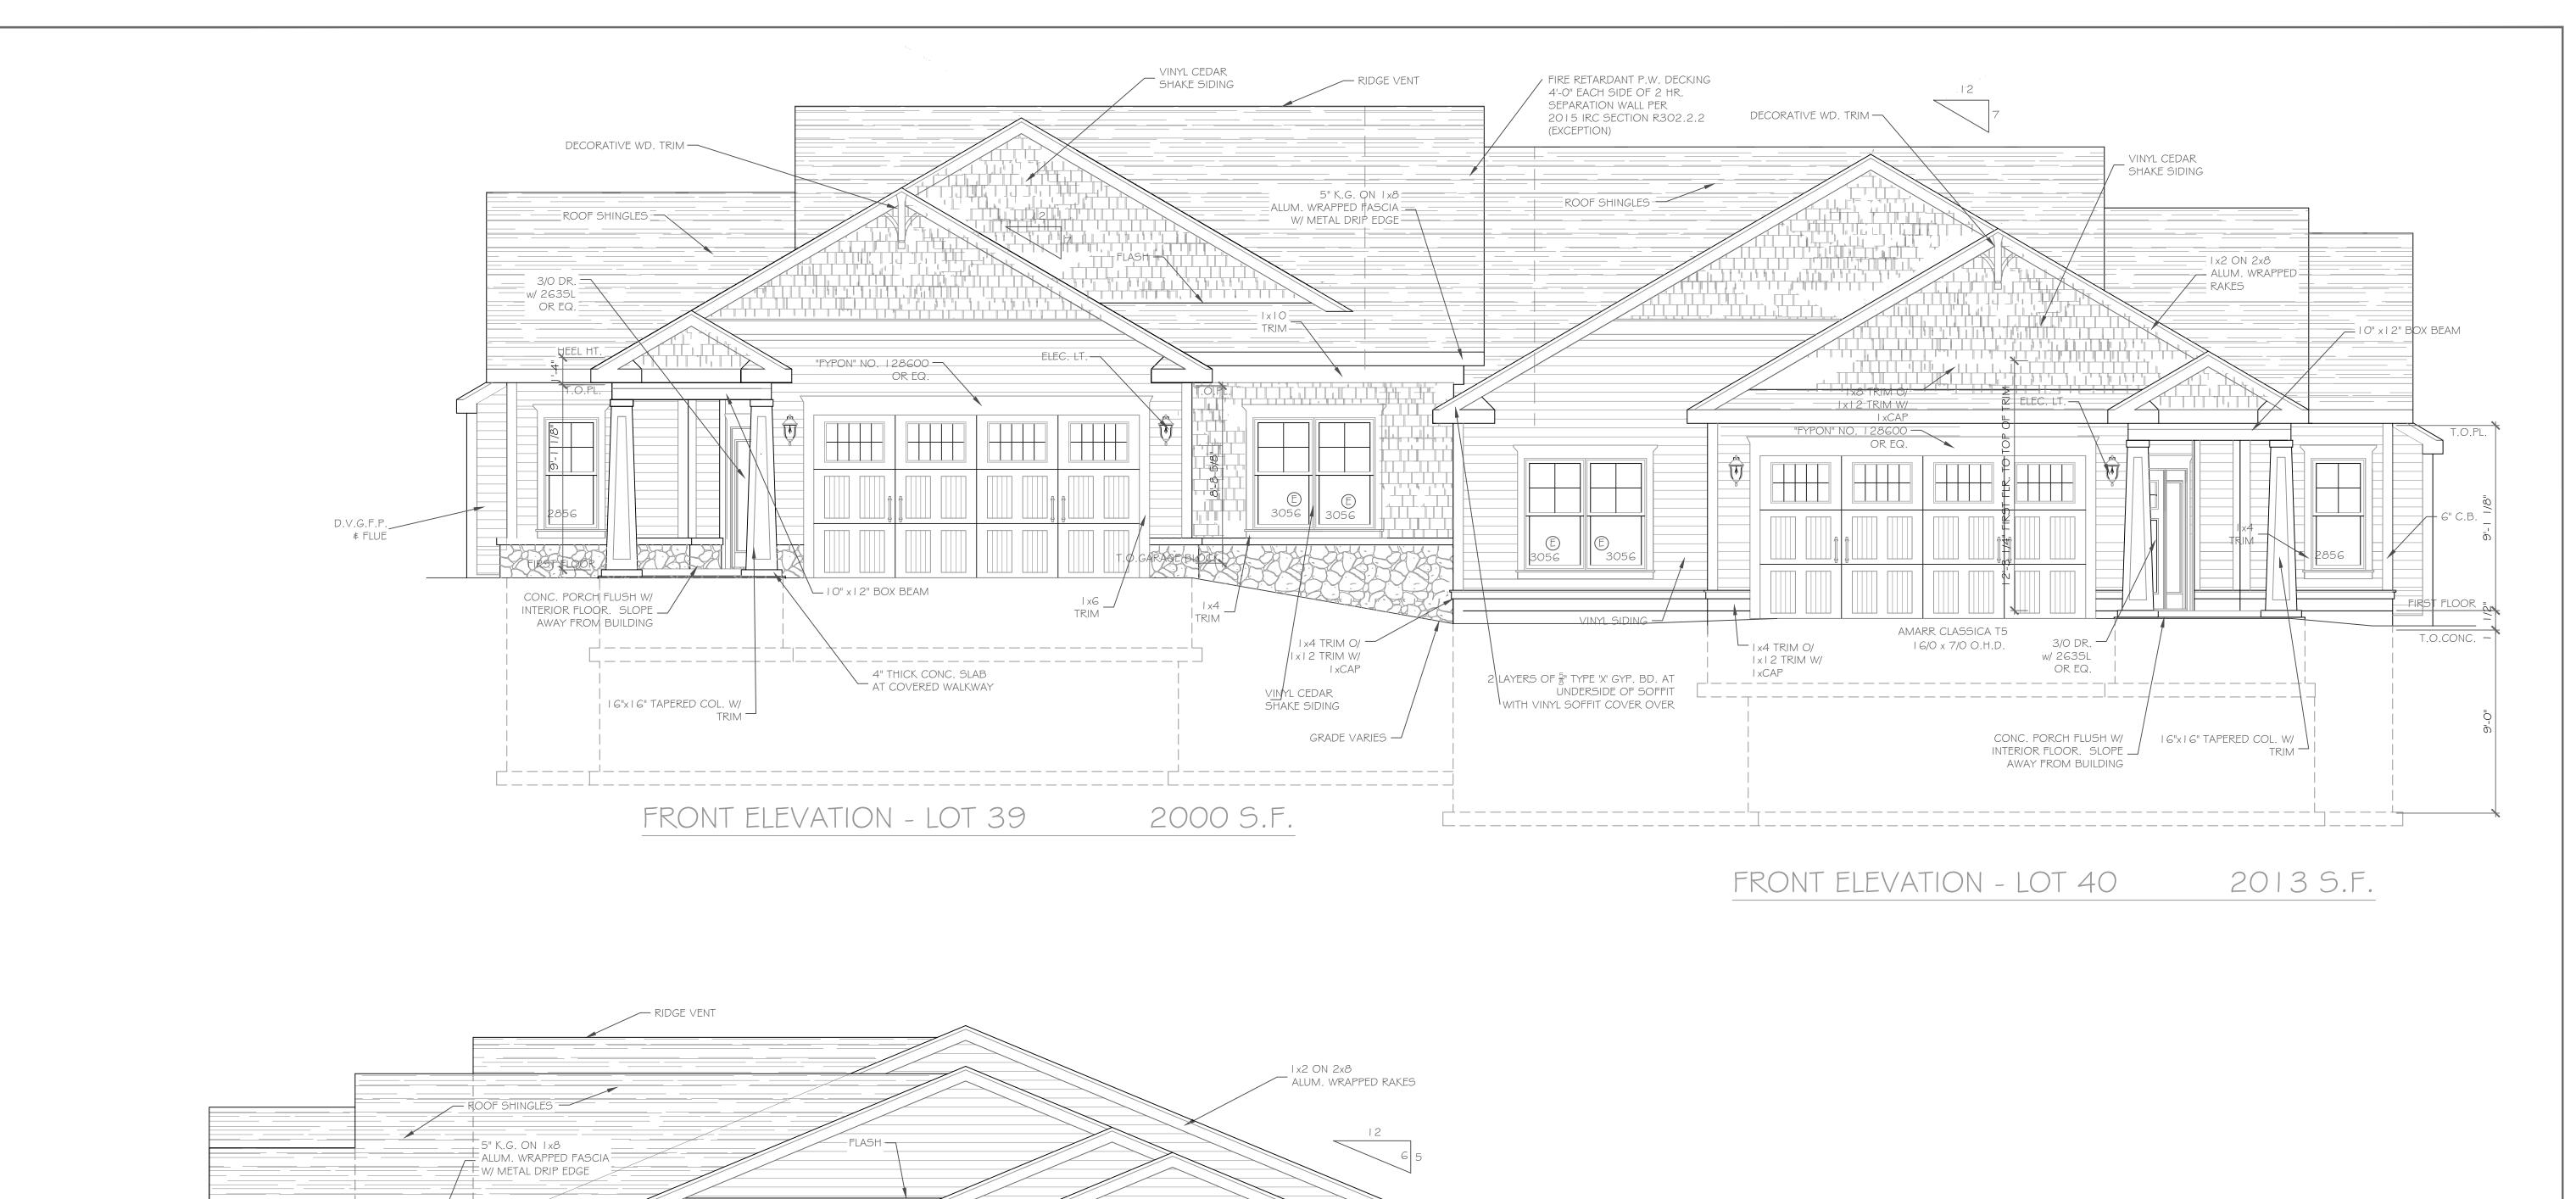


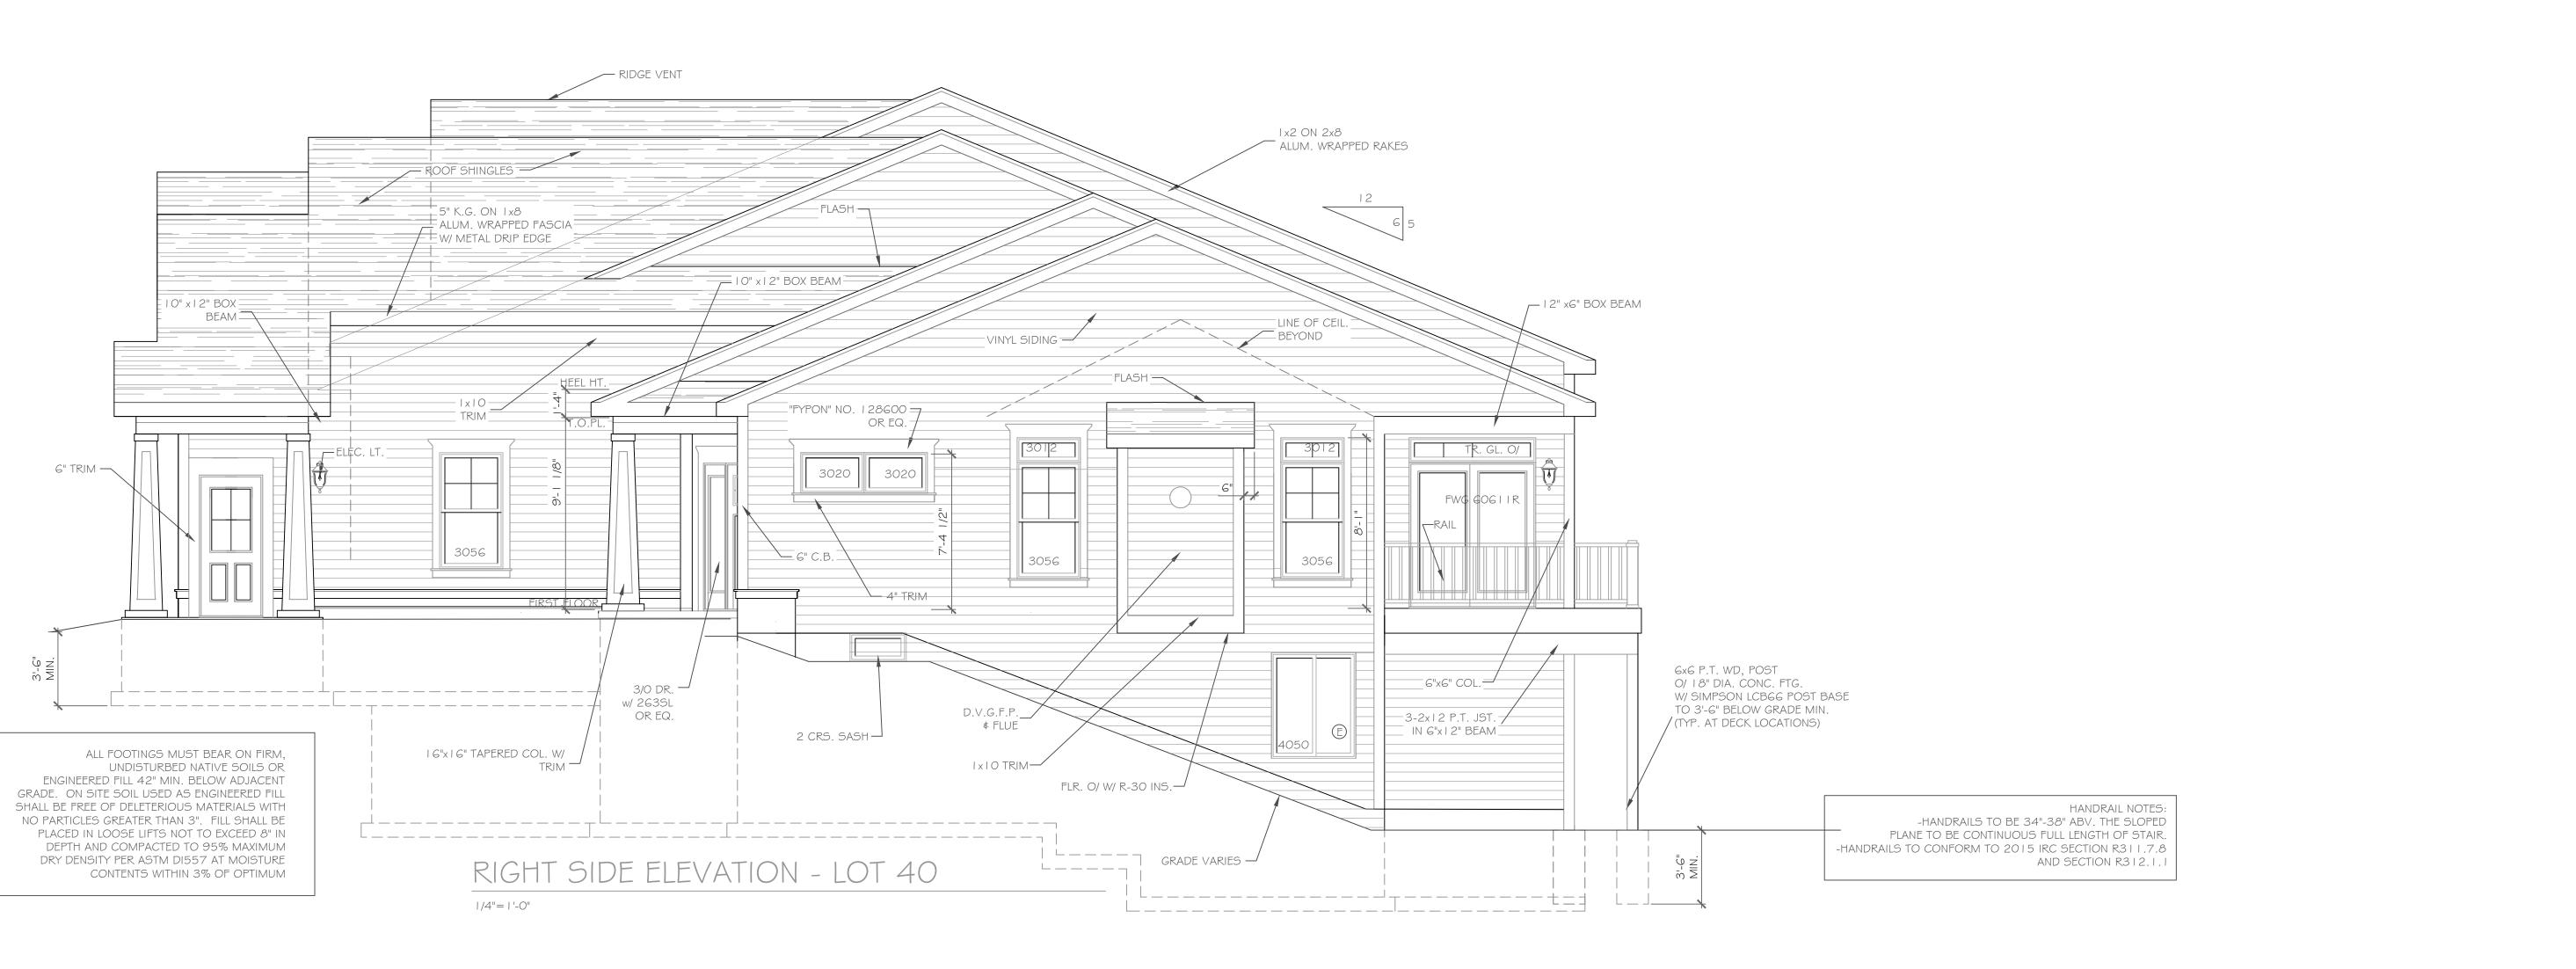





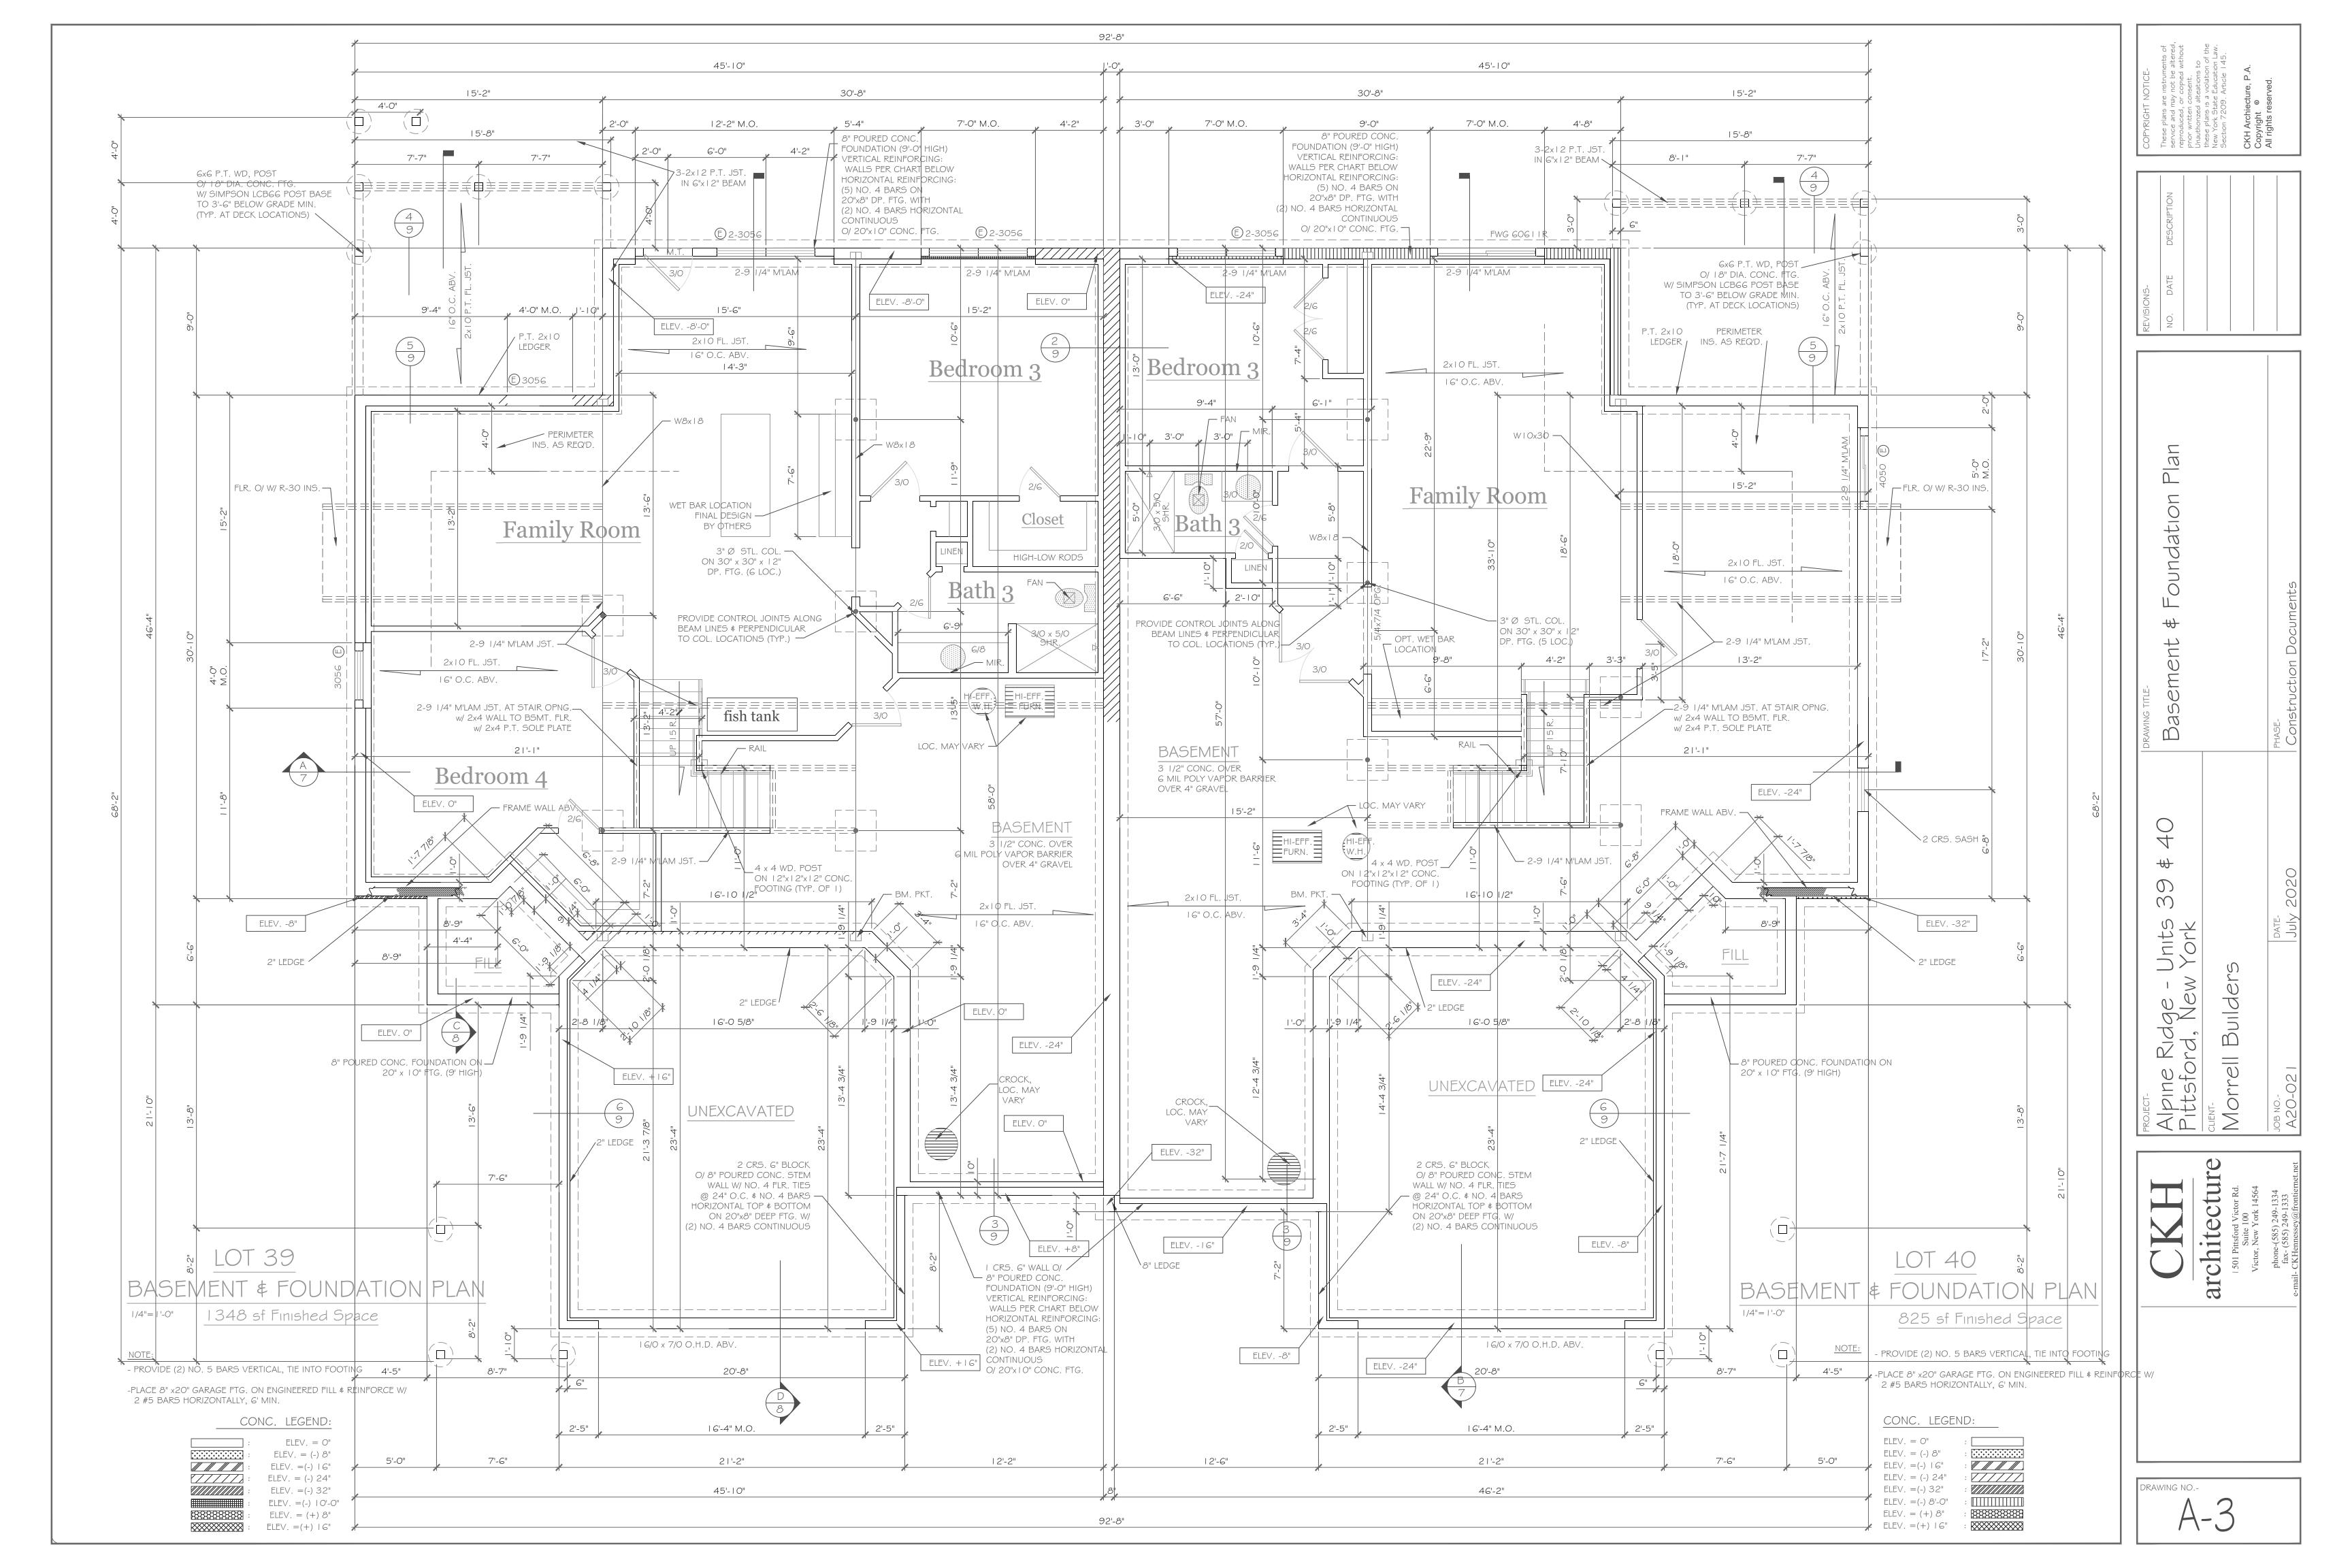

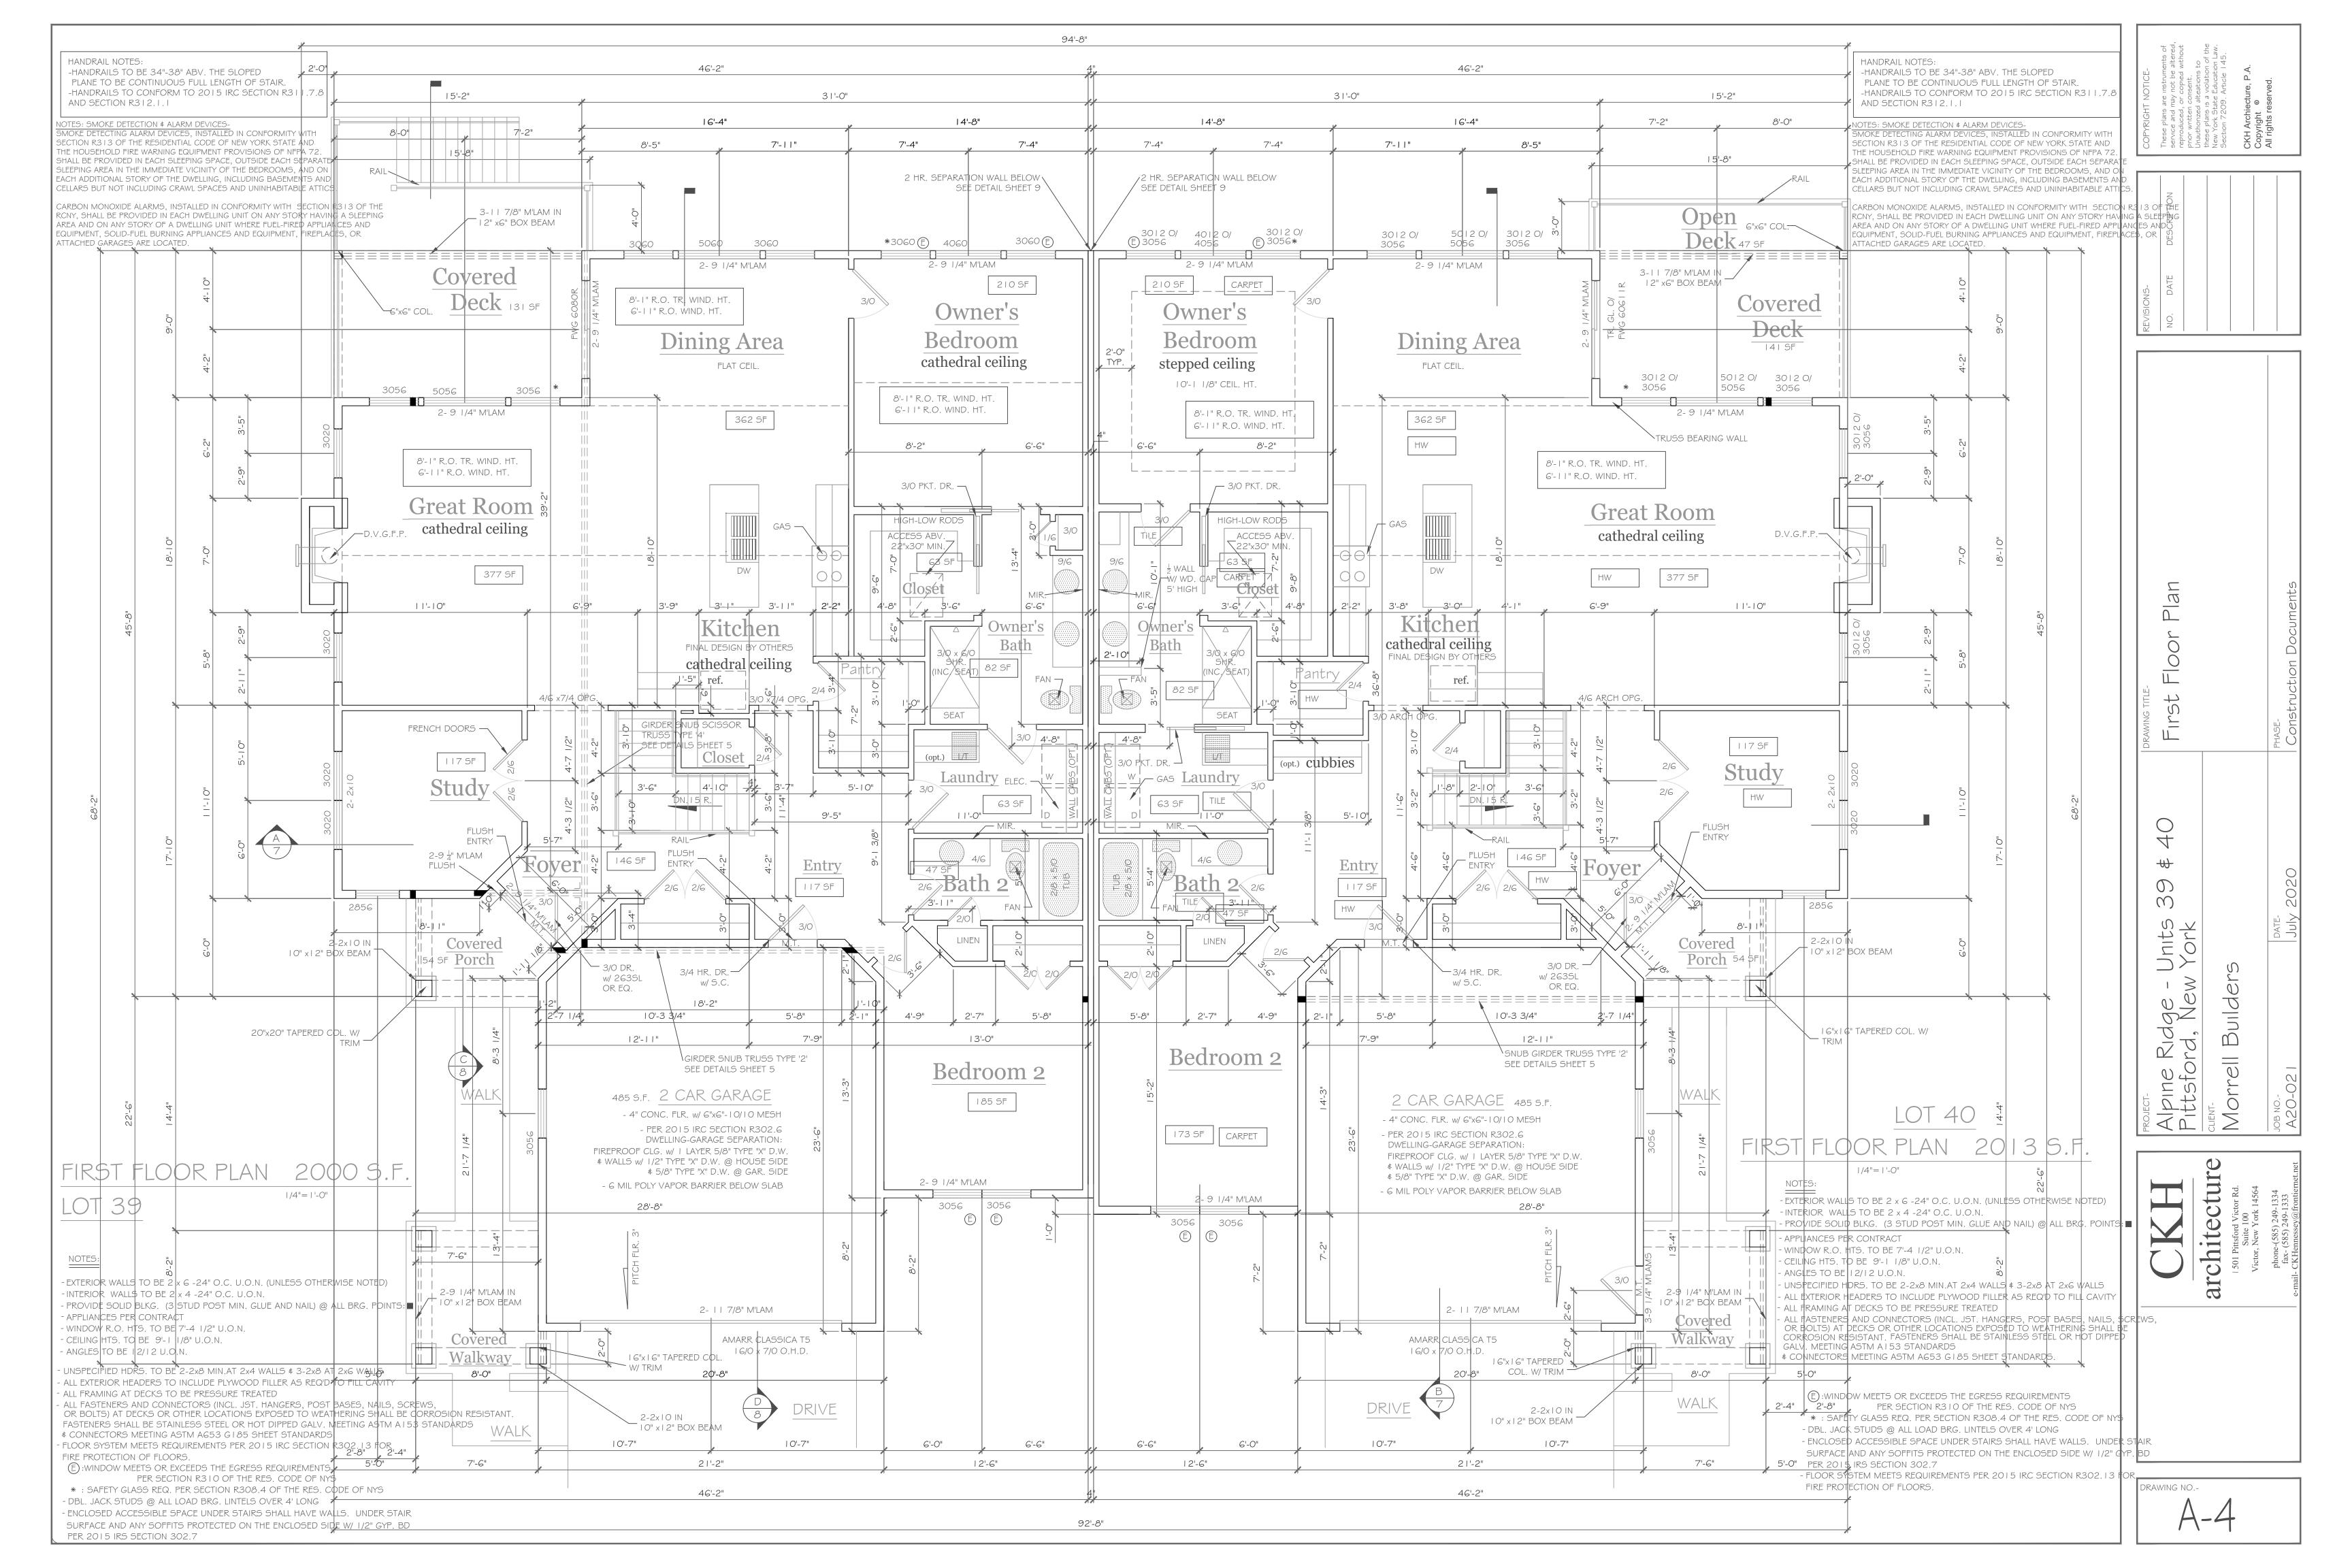


This rendering used to show color only.



## THIS RENDERING USED TO SHOW GARAGE ORIENTATION ONLY



#### **DIFFERENCES BETWEEN PROPOSED AND APPROVED UNITS**

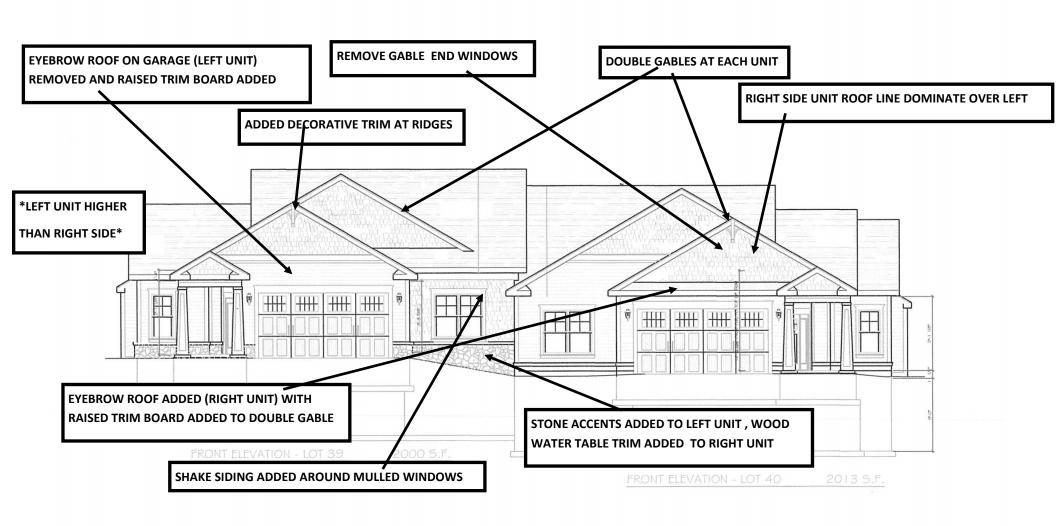

Front Elevation # 2

### **CONSTRUCTED**

## 4&6 Skylight Trail



Front Elevation # 1

### **APPROVED & UNDER CONSTRUCTION**

## 9&11 Skylight Trail




FRONT ELEVATION - LOT 46

1987 S.F.

FRONT ELEVATION - LOT 45

2000 S.F.

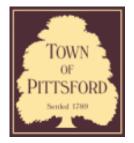

### **Town of Pittsford**

Department of Public Works 11 South Main Street Pittsford, New York 14534

Permit # B20-00095

Phone: 585-248-6250 FAX: 585-248-6262

# DESIGN REVIEW AND HISTORIC PRESERVATION BOARD REFERRAL OF APPLICATION

Property Address: 40 Skylight Trail Pittsford, NY 14534

Tax ID Number: 192.06-1-99

**Zoning District:** 


Owner: S & J Morrell Builders
Applicant: S & J Morrell Builders

#### **Application Type:**

<b>~</b>	Residential Design Review §185-205 (B)	Build to Line Adjustment §185-17 (B) (2)
	Commercial Design Review §185-205 (B)	Building Height Above 30 Feet §185-17 (M)
	Signage §185-205 (C)	Corner Lot Orientation §185-17 (K) (3)
	Certificate of Appropriateness §185-197	Flag Lot Building Line Location §185-17 (L) (1) (c)
	Landmark Designation §185-195 (2)	Undeveloped Flag Lot Requirements §185-17 (L) (2)
	Informal Review	


**Project Description:** Applicant is requesting design review for the construction of a community building. The building will be approximately 820 sq. ft. and will be located in the Alpine Ridge Subdivision.

Meeting Date: July 23, 2020

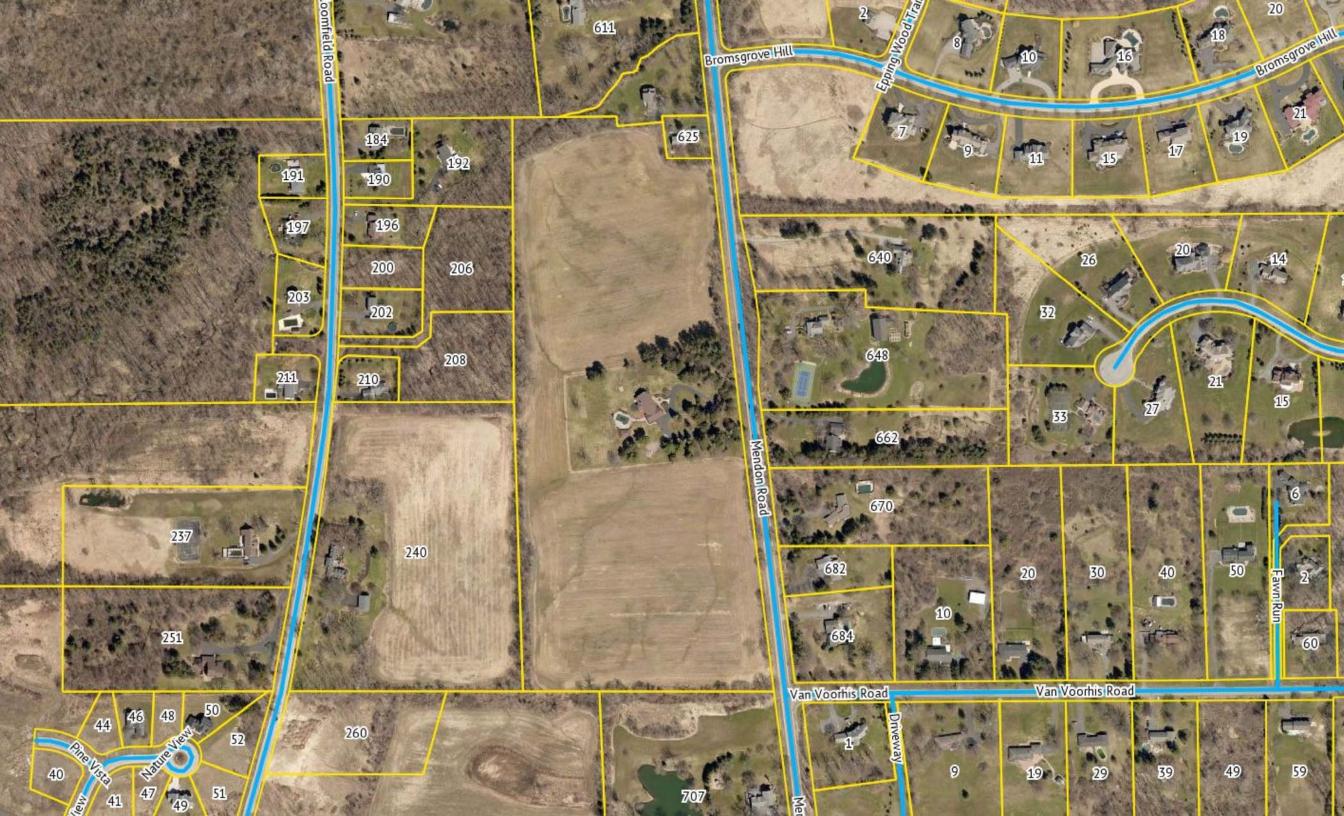



		Copplestone	Light Mist	Navajo Beige	Knaki Brown	booth bay blue
= Side Load Garage	Color	8	8	×	8	8
J/#!\$aXTg[V[`YZSeefa`W	Building Step	×				

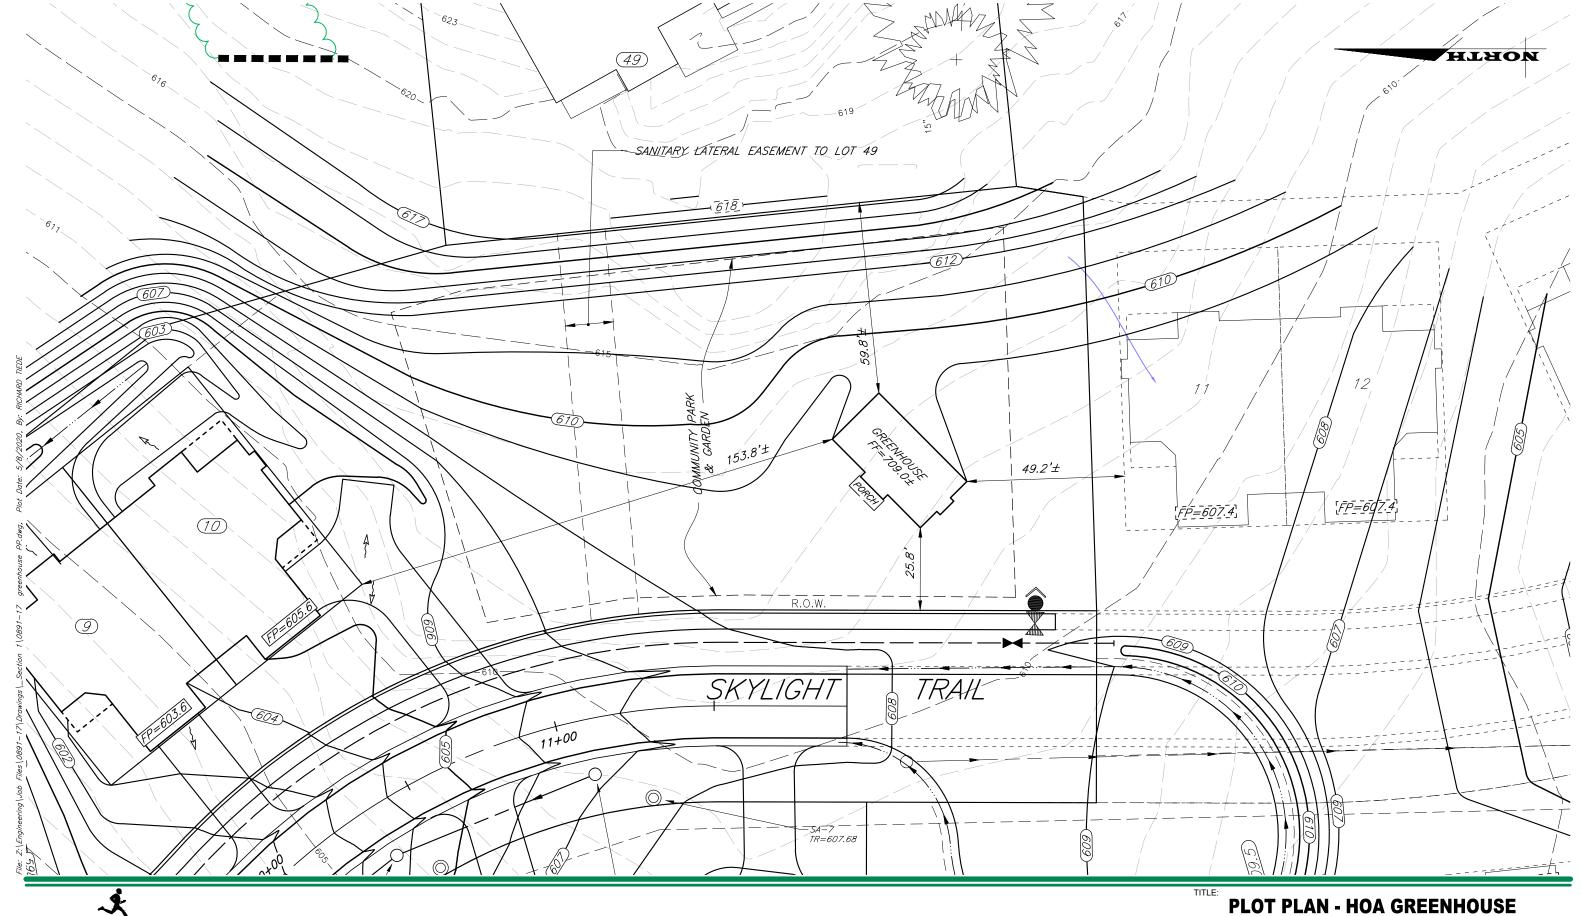

ROCHESTER LOCATION

39 CASCADE DRIVE
ROCHESTER, NY 14614
585-458-7770

ITHACA LOCATION

840 HANSHAW RD, STE 12
ITHACA, NY 14850
607-241-2917
www.marathoneng.com

JOB NO: 0891-18

SCALE: 1" = 30'

DRAWN: RJT


DESIGNED: RJT


DATE: 5/8/20


SETBACK REQUIRED PROVIDED
FRONT 25' 25.8'


**ALPINE RIDGE - SECTION 1** 



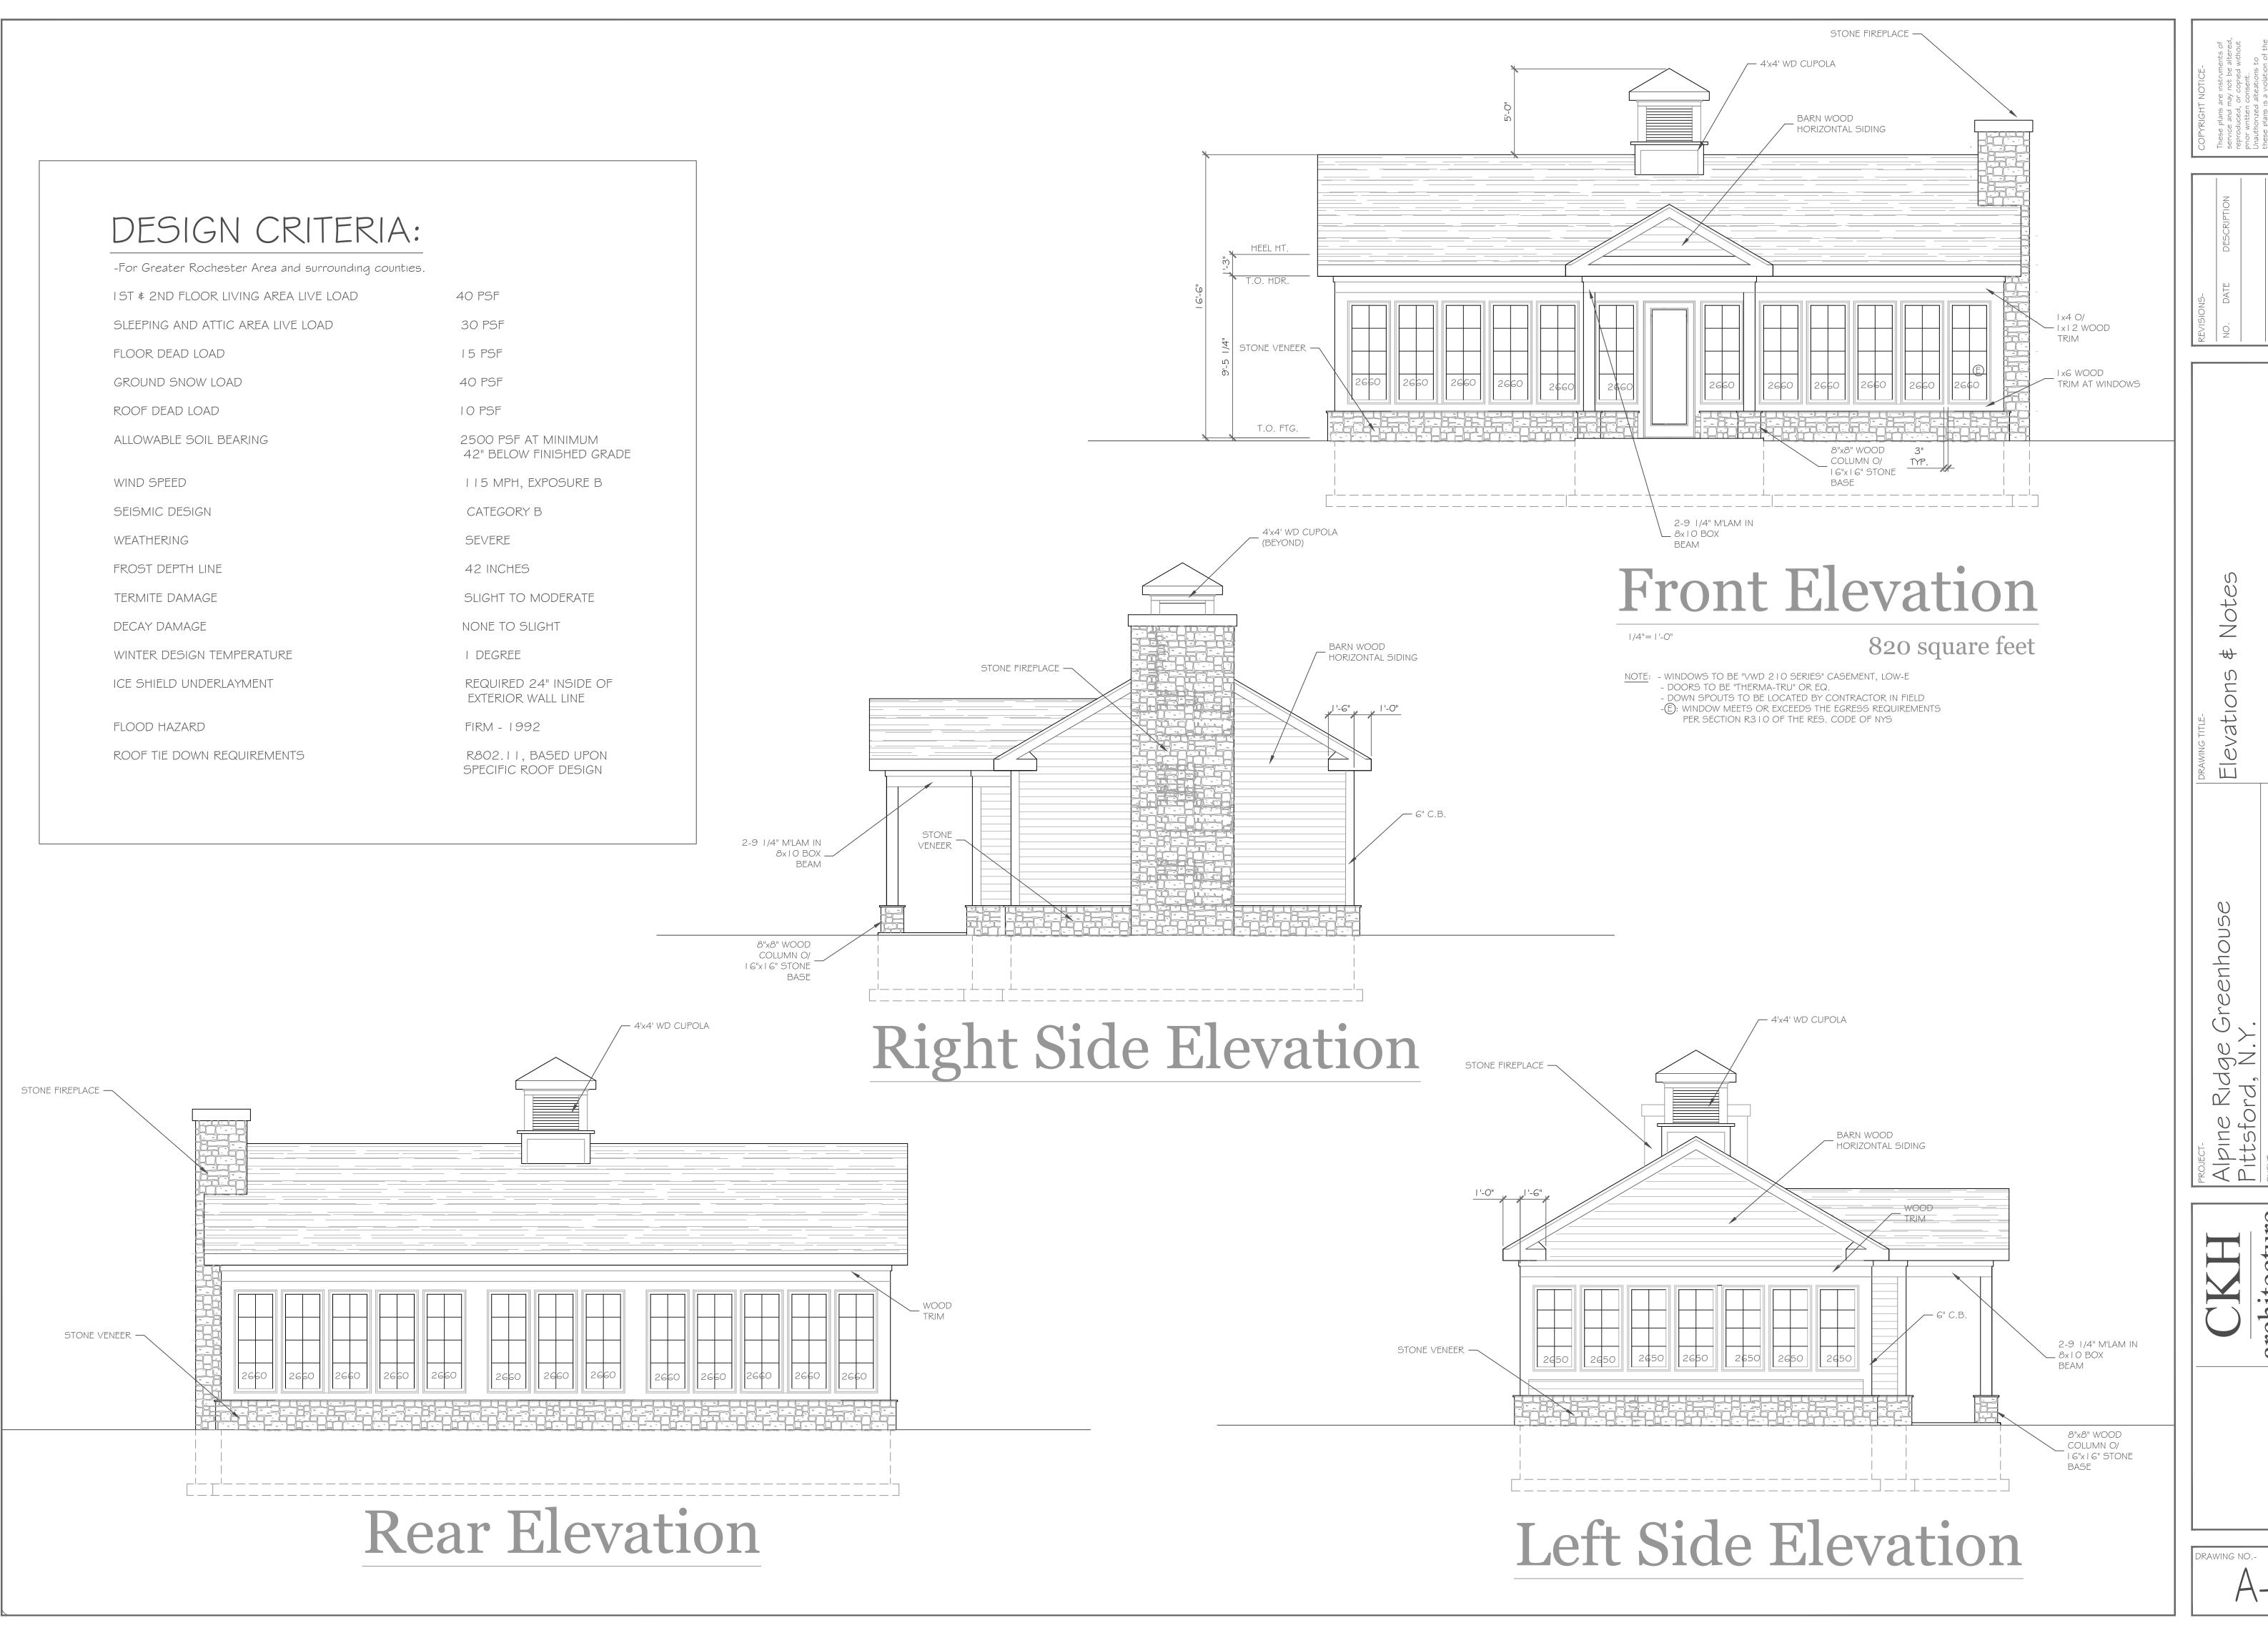

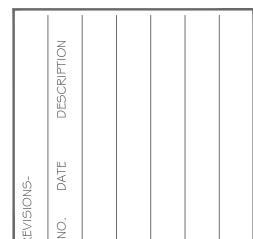

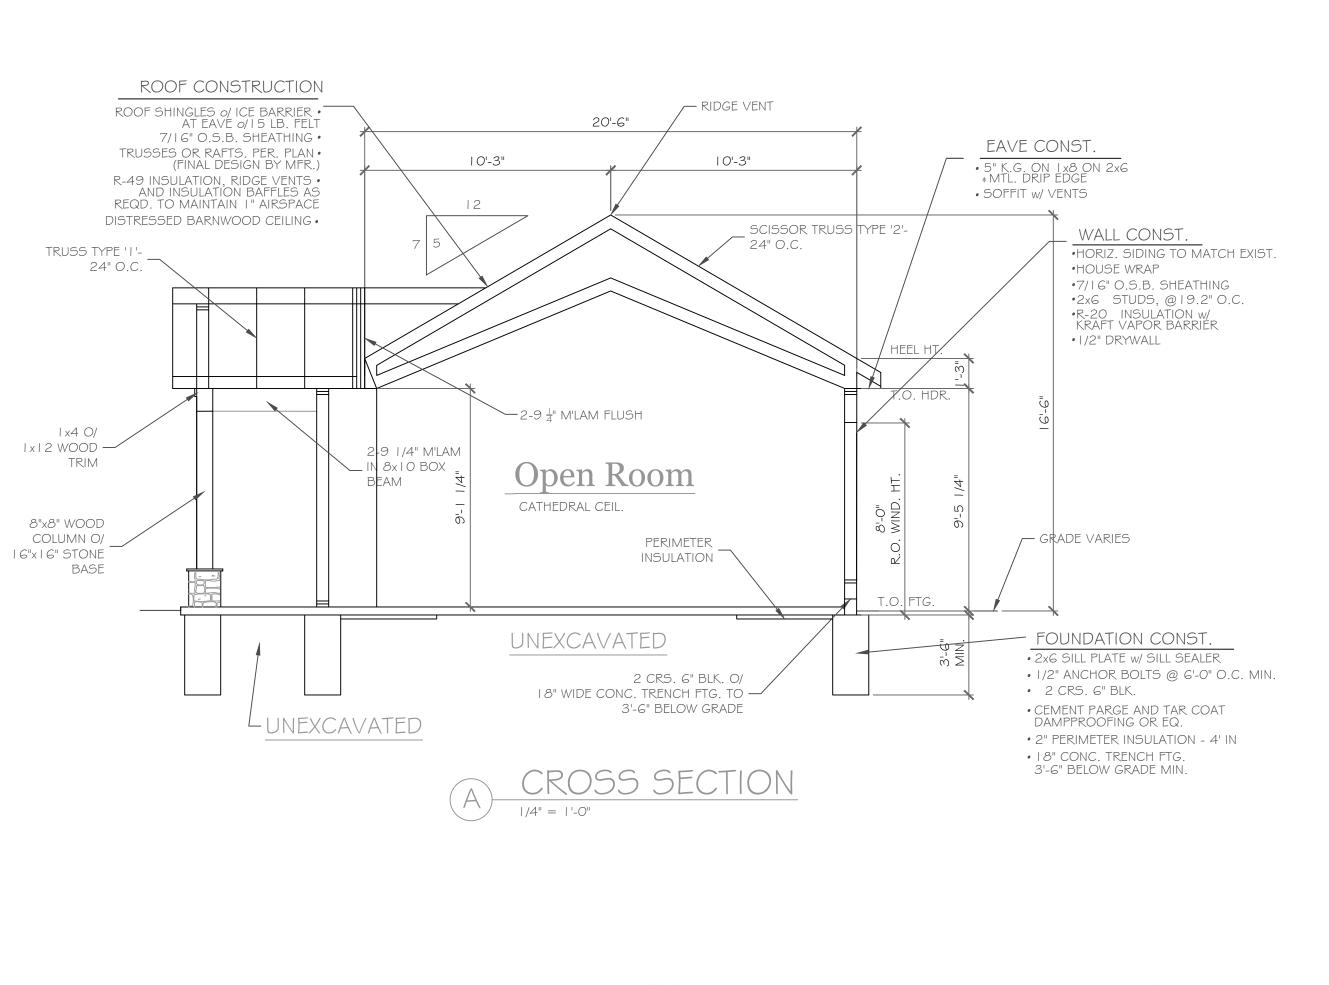

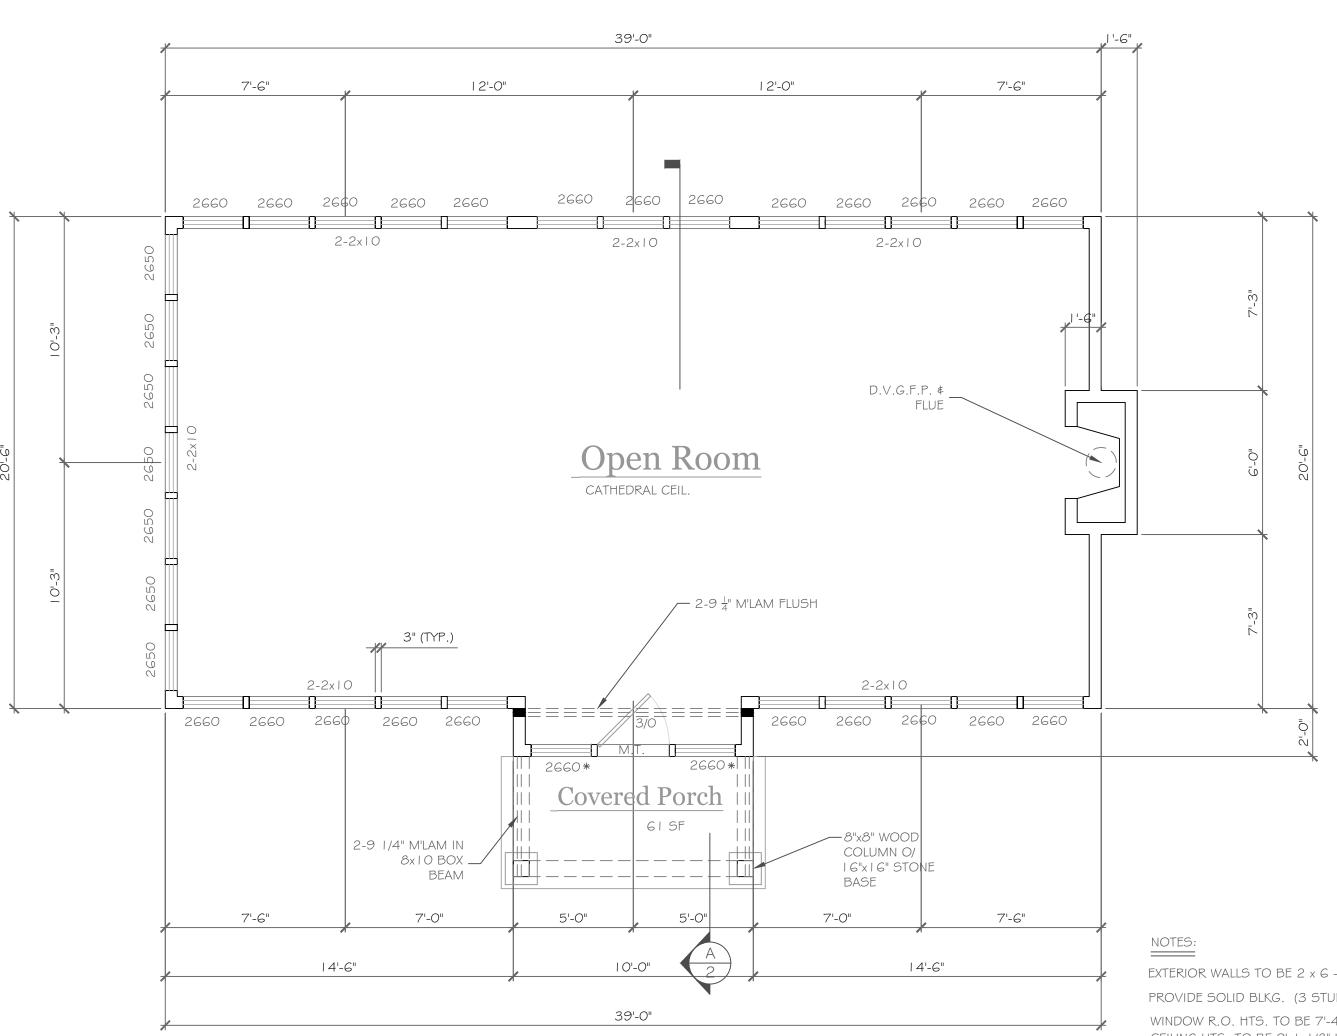


First Floor Plan

820 square feet

## EXTERIOR WALLS TO BE 2 x 6 - I 6" O.C. U.O.N. (UNLESS OTHERWISE NOTED) PROVIDE SOLID BLKG. (3 STUD POST MIN. GLUE AND NAIL) @ ALL BRG. POINTS: $\blacksquare$ WINDOW R.O. HTS. TO BE 7'-4 1/2" U.O.N. CEILING HTS. TO BE 9'-1 1/8" U.O.N. UNSPECIFIED HDRS. TO BE 2-2x8 MIN. (E):WINDOW MEETS OR EXCEEDS THE EGRESS REQUIREMENTS

PER SECTION R3 I O OF THE RES. CODE OF NYS \* : SAFETY GLASS REQ. PER SECTION R308.4 OF THE RES. CODE OF NYS DBL. JACK STUDS @ ALL LOAD BRG. LINTELS OVER 4' LONG

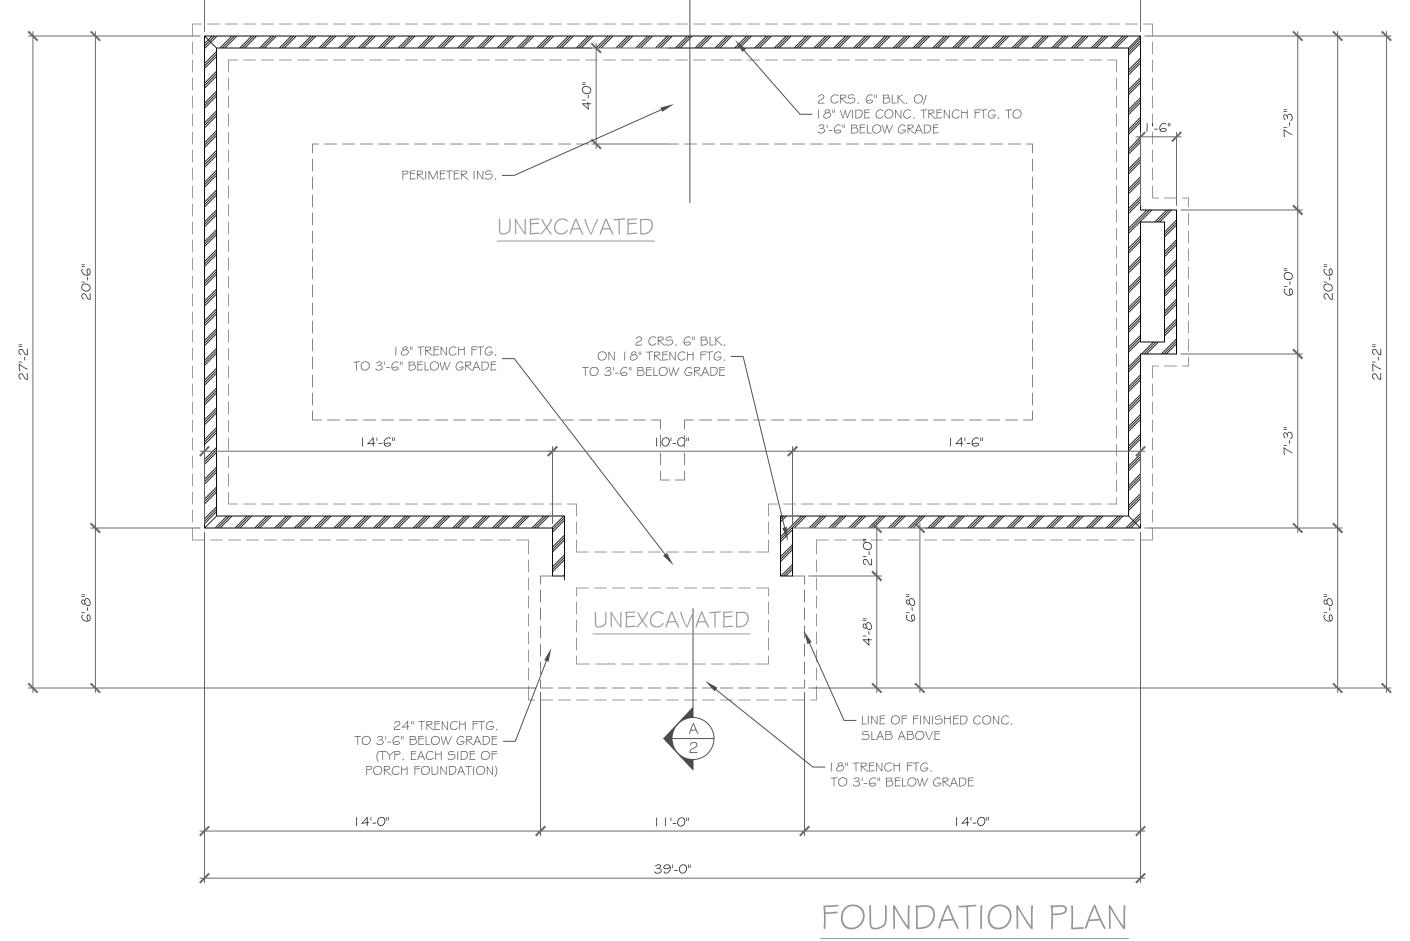


39'-0"

1/4"= 1'-0"

NOTE: - PROVIDE (2) NO. 5 BARS VERTICAL, TIE INTO FOOTING \$ GROUT BLOCK CORES SOLID FULL HEIGHT AT ALL BEAM BEARINGS -PROVIDE SOLID BLKG. TO BLK. @ ALL BRG. POINTS: ■


ELEV. = (+) 8"

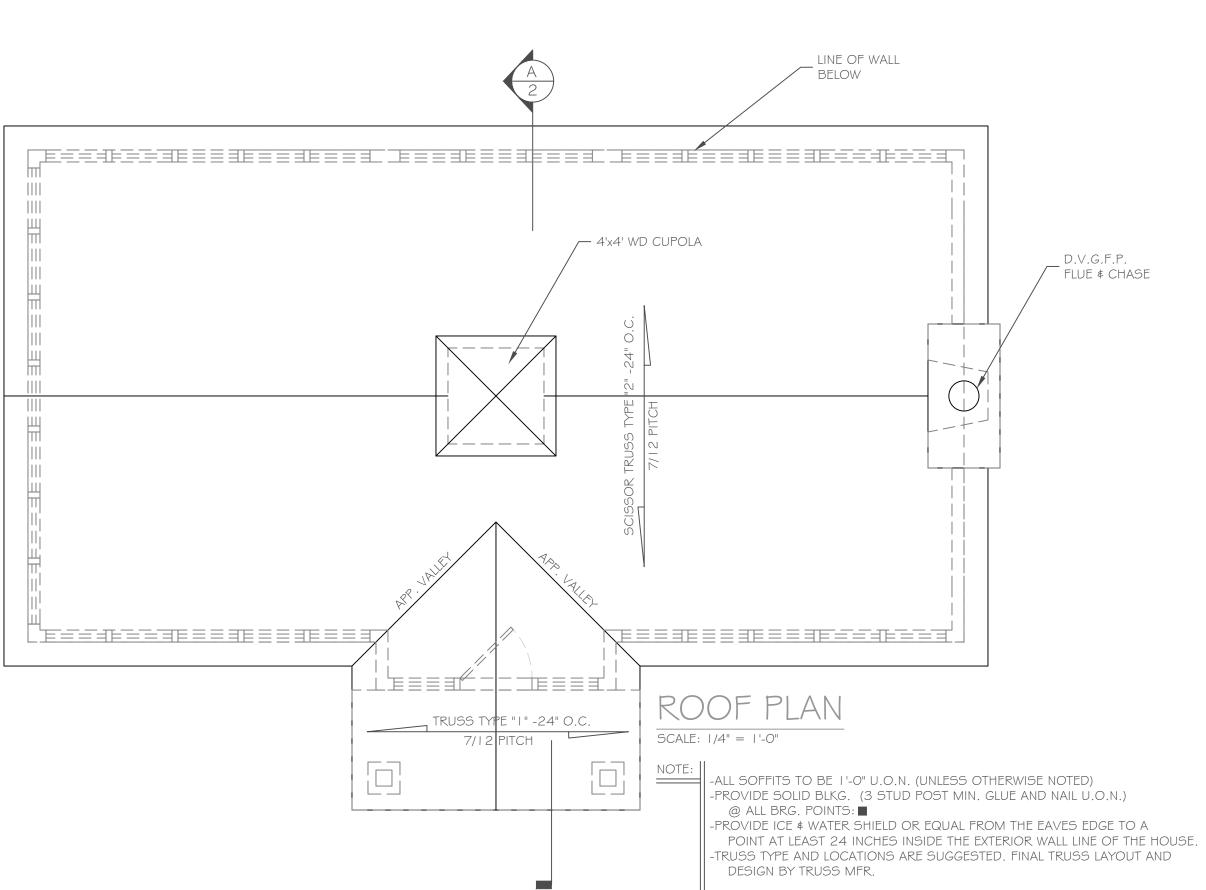

an G G G 150 187 P P COUNC enha

DRAWING NO.-



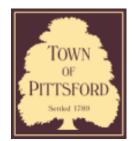

#### **Town of Pittsford**

Department of Public Works 11 South Main Street Pittsford, New York 14534

Permit # RA20-000113

Phone: 585-248-6250 FAX: 585-248-6262

### DESIGN REVIEW AND HISTORIC PRESERVATION BOARD REFERRAL OF APPLICATION

Property Address: 25 Parker Drive PITTSFORD, NY 14534

**Tax ID Number:** 164.10-2-67

**Zoning District:** RN Residential Neighborhood

Owner: Hamilton, Justin K Applicant: Hamilton Stern


App	lica	tion	Type:		

<b>~</b>	Residential Design Review	Build to Line Adjustment
	§185-205 (B)	□ §185-17 (B) (2)
	Commercial Design Review	<ul> <li>Building Height Above 30 Feet</li> </ul>
	§185-205 (B)	<sup>└</sup> §185-17 (M)
$\Box$	Signage	<ul> <li>Corner Lot Orientation</li> </ul>
	§185-205 (C)	<sup>□</sup> §185-17 (K) (3)
	Certificate of Appropriateness	<ul> <li>Flag Lot Building Line Location</li> </ul>
	§185-197	<sup>└</sup> §185-17 (L) (1) (c)
	Landmark Designation	<ul> <li>Undeveloped Flag Lot Requirements</li> </ul>
	§185-195 (2)	<sup>└</sup> §185-17 (L) (2)
	Informal Review	


**Project Description:** The applicant is requesting Design Review for the Proposed construction of an addition and an oversized accessory structure. The proposed construction is a 2 story 1,007 Sq. Ft. addition and a 468 Sq. Ft. workshop/Storage structure. The addition will create living space and a new garage. The Zoning Board of Appeals has heard these applications on July 20, 2020.

Meeting Date: July 23, 2020


### RN Residential Neighborhood Zoning

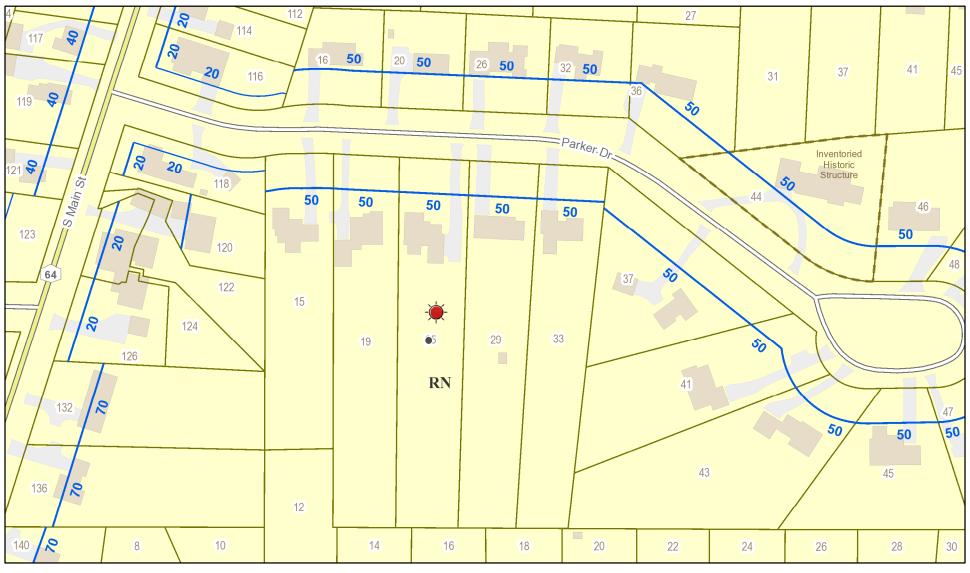


Printed June 19, 2020

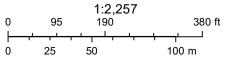


Town of Pittsford GIS

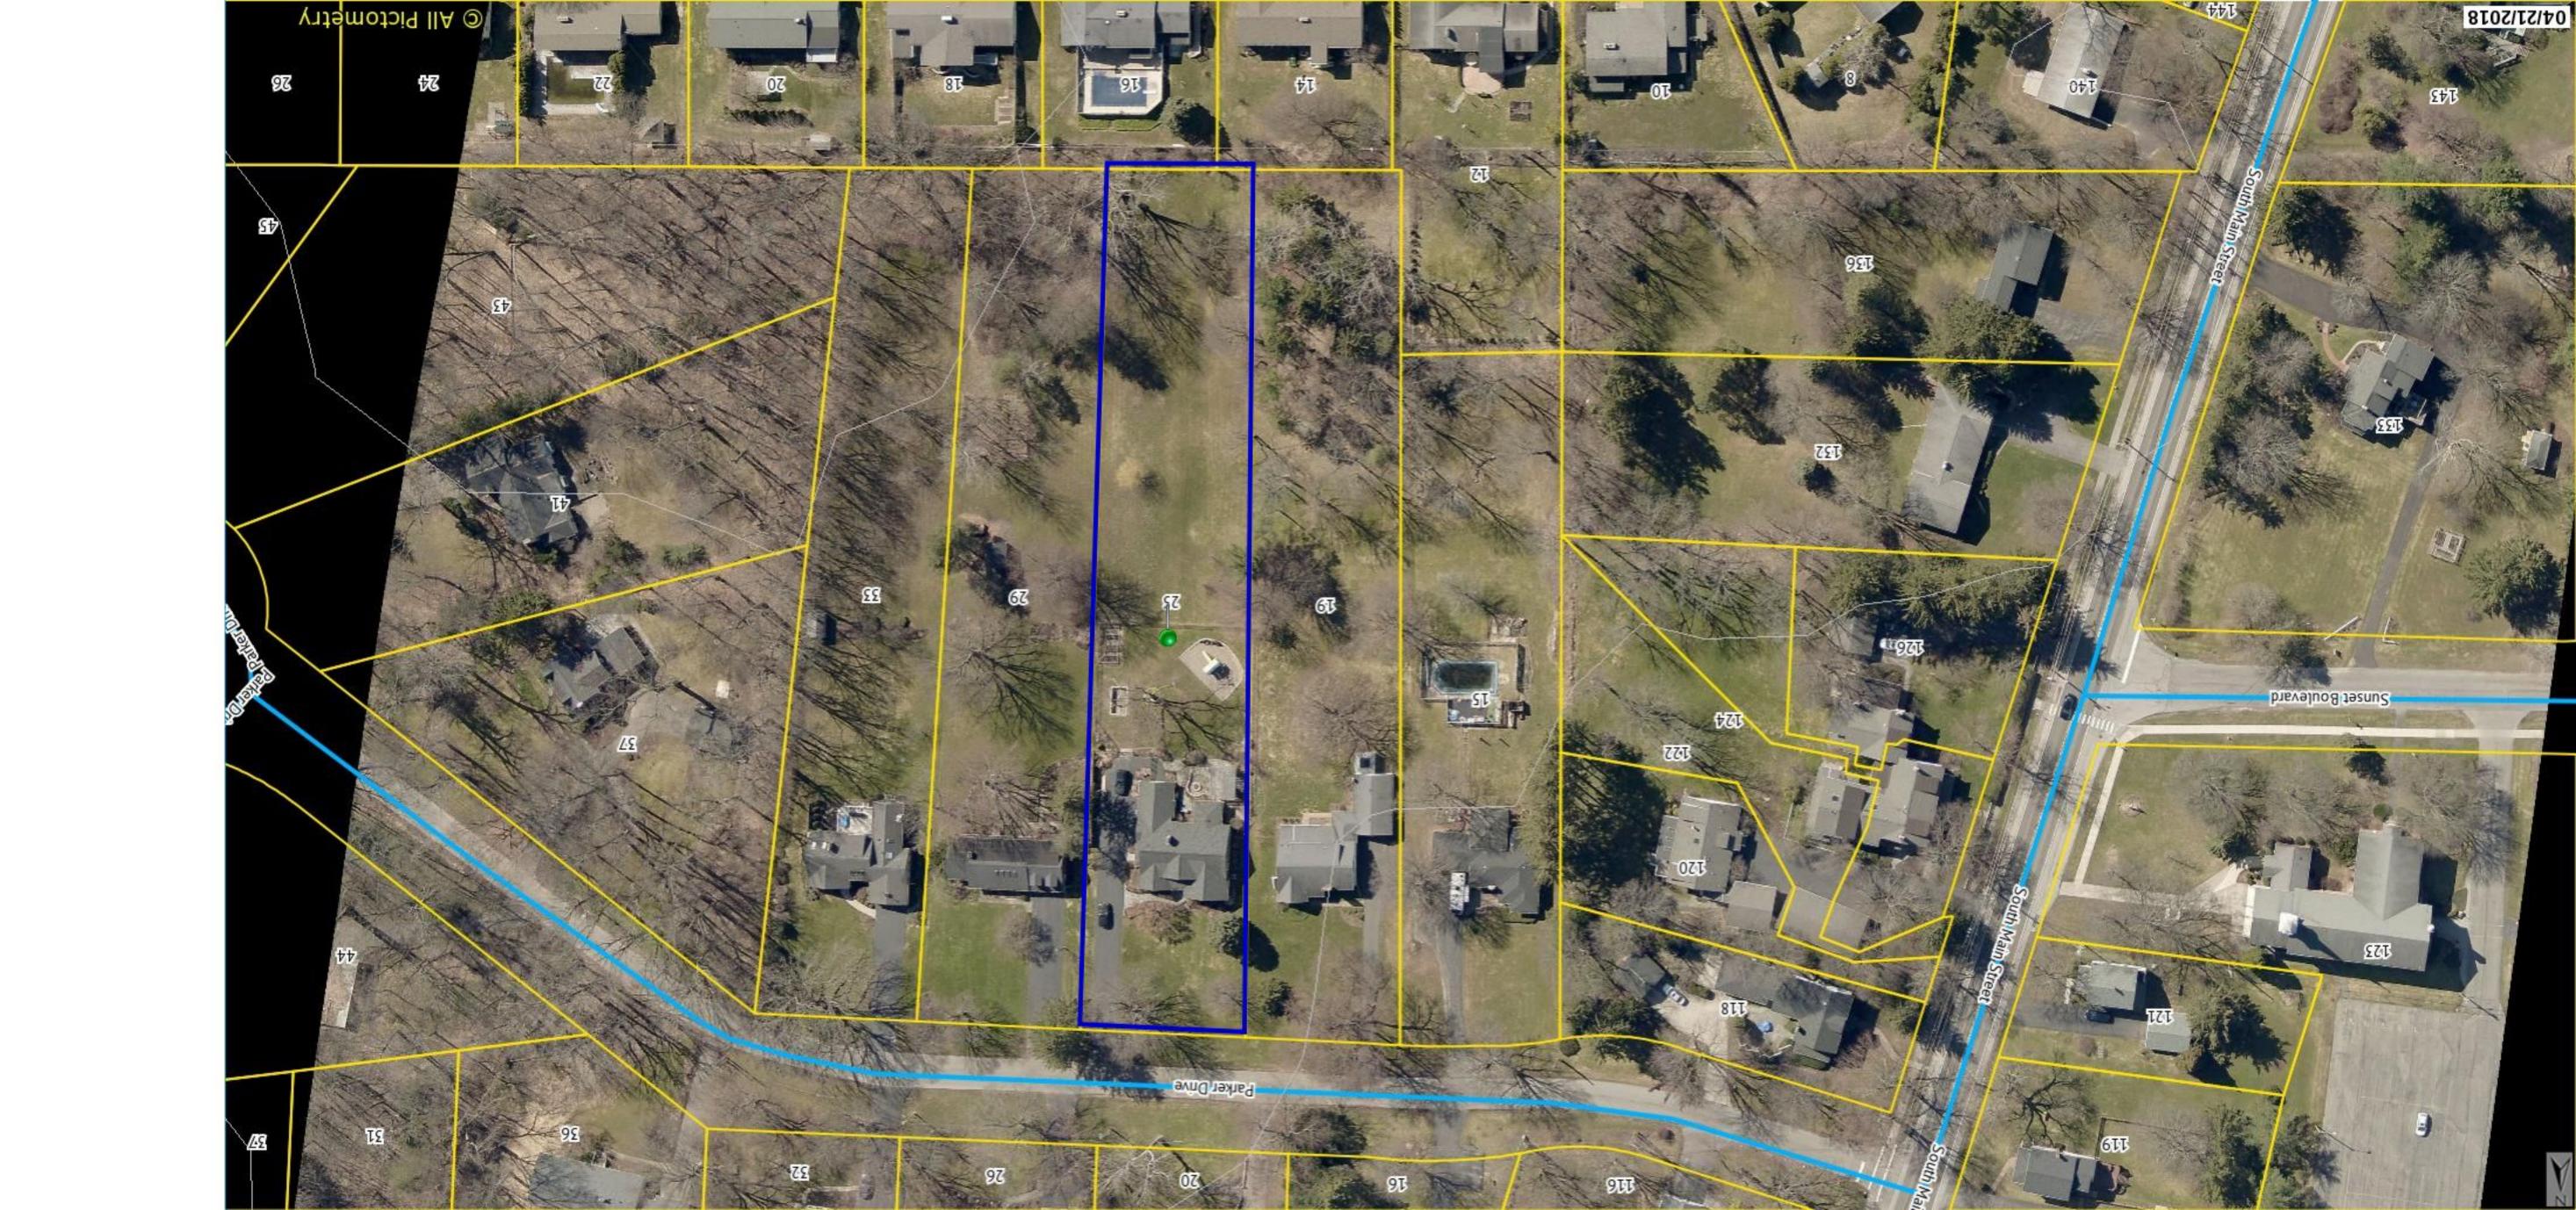



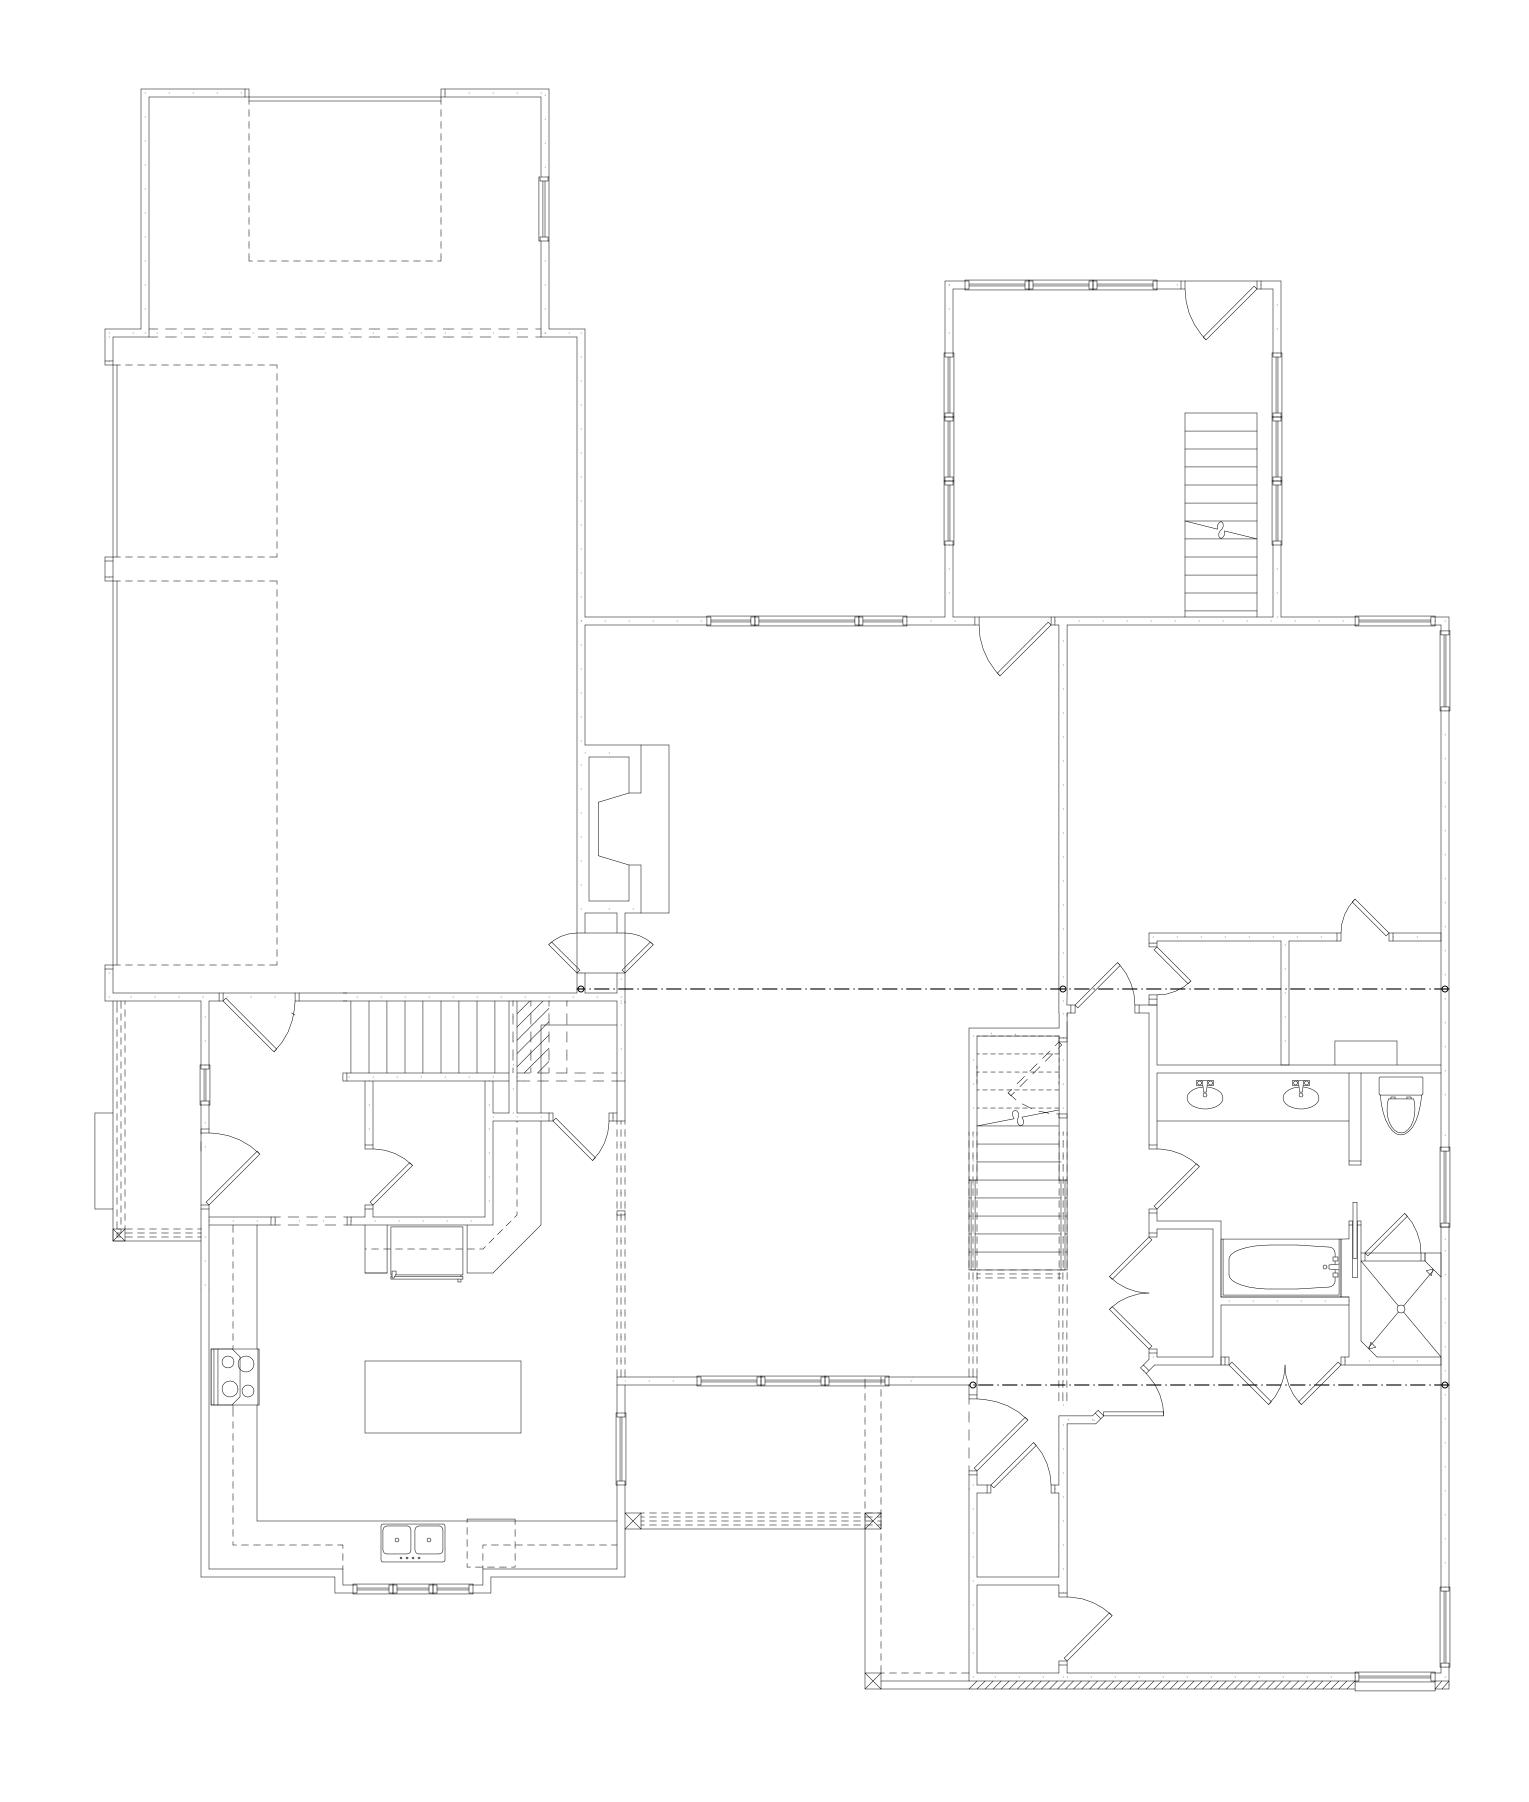

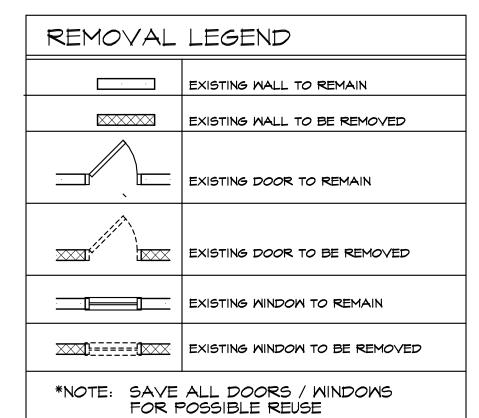

FIRST FLOOR PLAN/ EXISTING

EXISTING AREA: 1596 SQ FT

PATRICK J. **MORABITO** A.I.A. **ARCHITECT** P.C.

55 Sully's Trail Pittsford, NY 14534

(585) 264-1330 (585) 264-1333 Fax

www.pjmarchitect.com

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PATRICK J. MORABITO, A.I.A. ARCHITECT P.C.

PROJECT:
ADDITION TO
HAMILTON RESIDENCE
25 PARKER DRIVE

HAMILTON/ STERN BUILDERS

DRAWING: FIRST FLOOR PLAN EXISTING


> CHECKED: ML9

MAY 2020

1/4"=1'-0"

JOB NO.: 2020HAMILTON



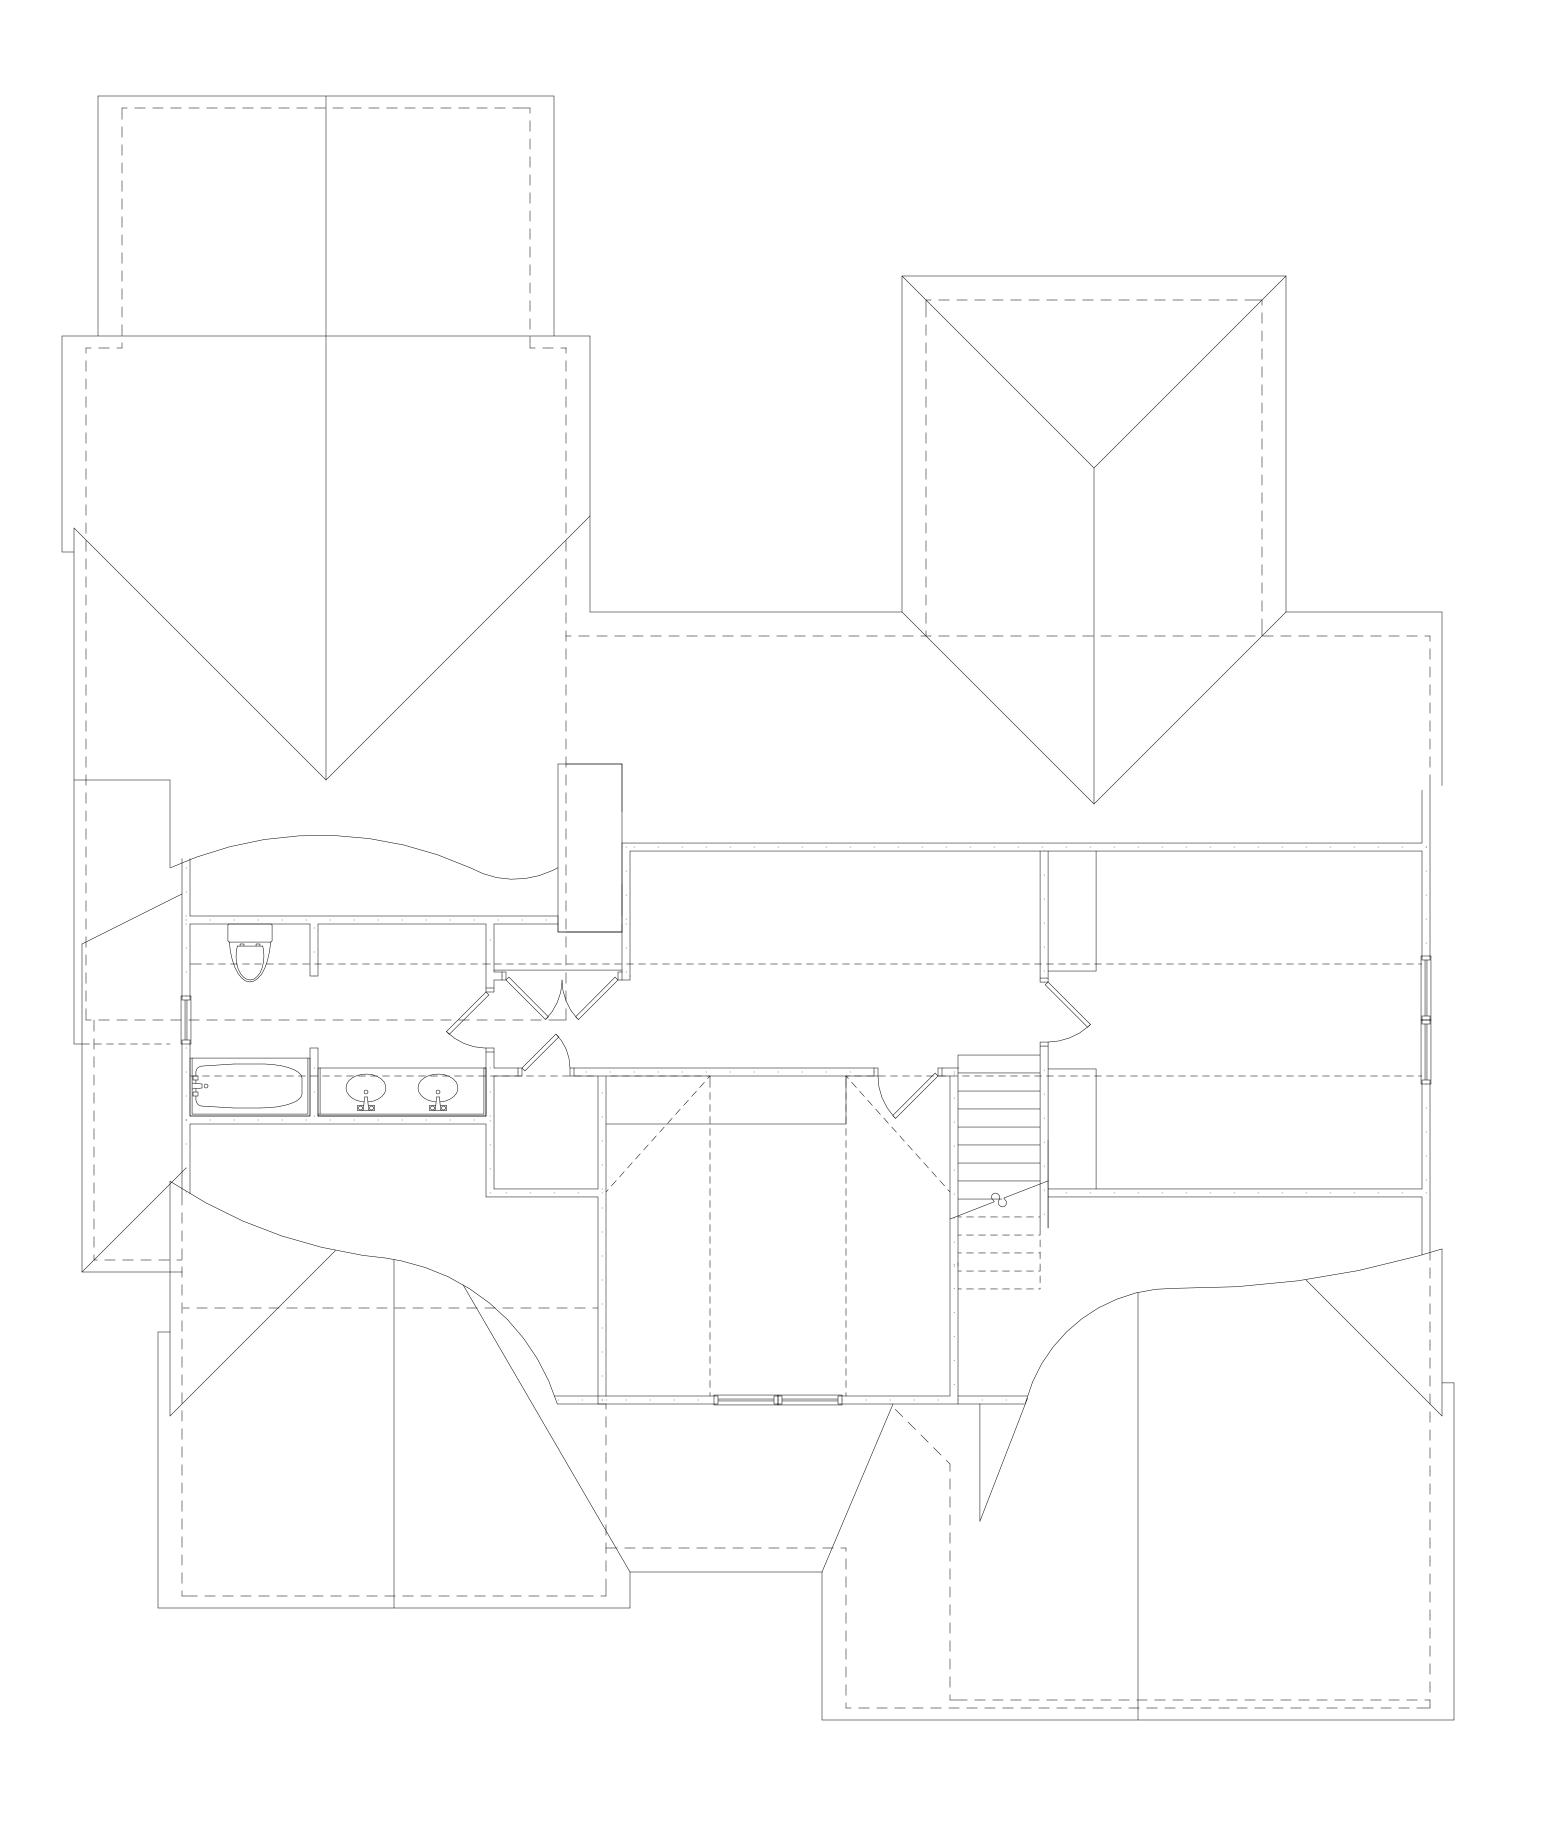

SECOND FLOOR PLAN/ EXISTING

PROPOSED AREA: 795 SQ FT

PATRICK J. MORABITO A.I.A. **ARCHITECT** P.C.

55 Sully's Trail Pittsford, NY 14534

(585) 264-1330 (585) 264-1333 Fax

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PROJECT:
ADDITION TO
HAMILTON RESIDENCE
25 PARKER DRIVE

SECOND FLOOR PLAN EXISTING

CHECKED:

2020HAMILTON






## FRONT ELEVATION/ PROPOSED

EXISTING AREA: 1596 SQ FT PROPOSED ADDITION:

2ND FLR:

215 SQ FT 795 SQ FT

TOTAL PROPOSED AREA: 2606 SQ FT

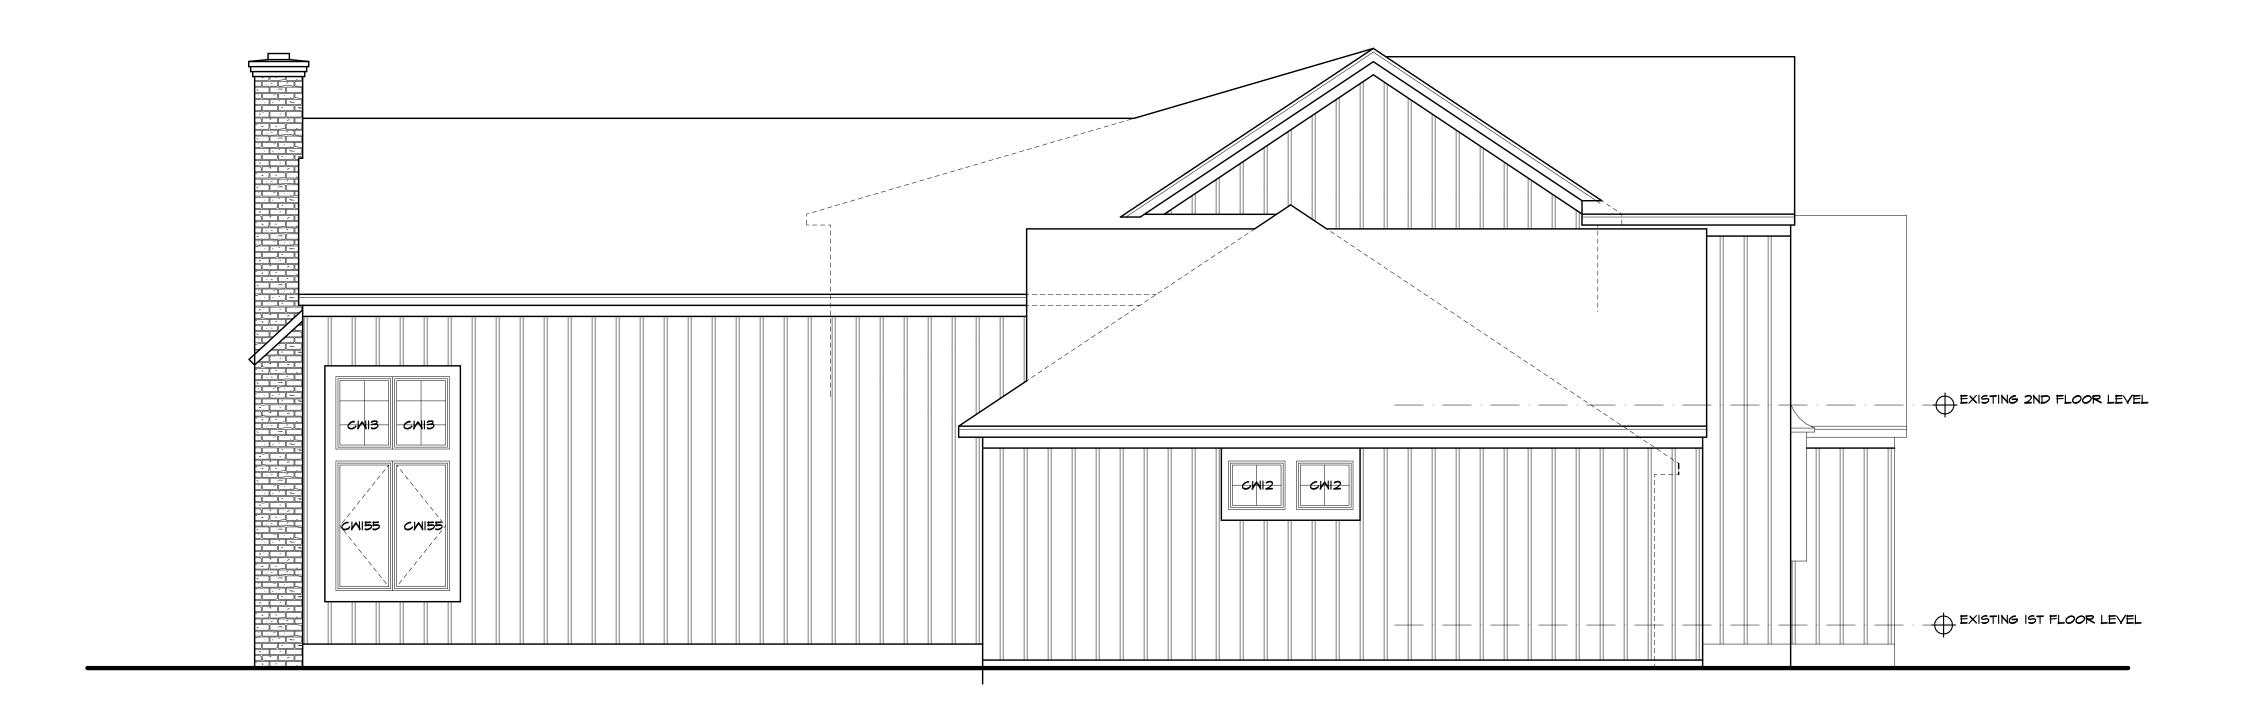

LEFT SIDE ELEVATION/ PROPOSED

PROPOSED

### PATRICK J. **MORABITO** A.I.A. **ARCHITECT** P.C.

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PROJECT:
ADDITION TO
HAMILTON RESIDENCE
25 PARKER DRIVE

CLIENT: HAMILTON/ STERN BUILDERS

**DRAWING:** ELEVATIONS - PROPOSED


> CHECKED: ML9

2020HAMILTON





## REAR ELEVATION/ PROPOSED

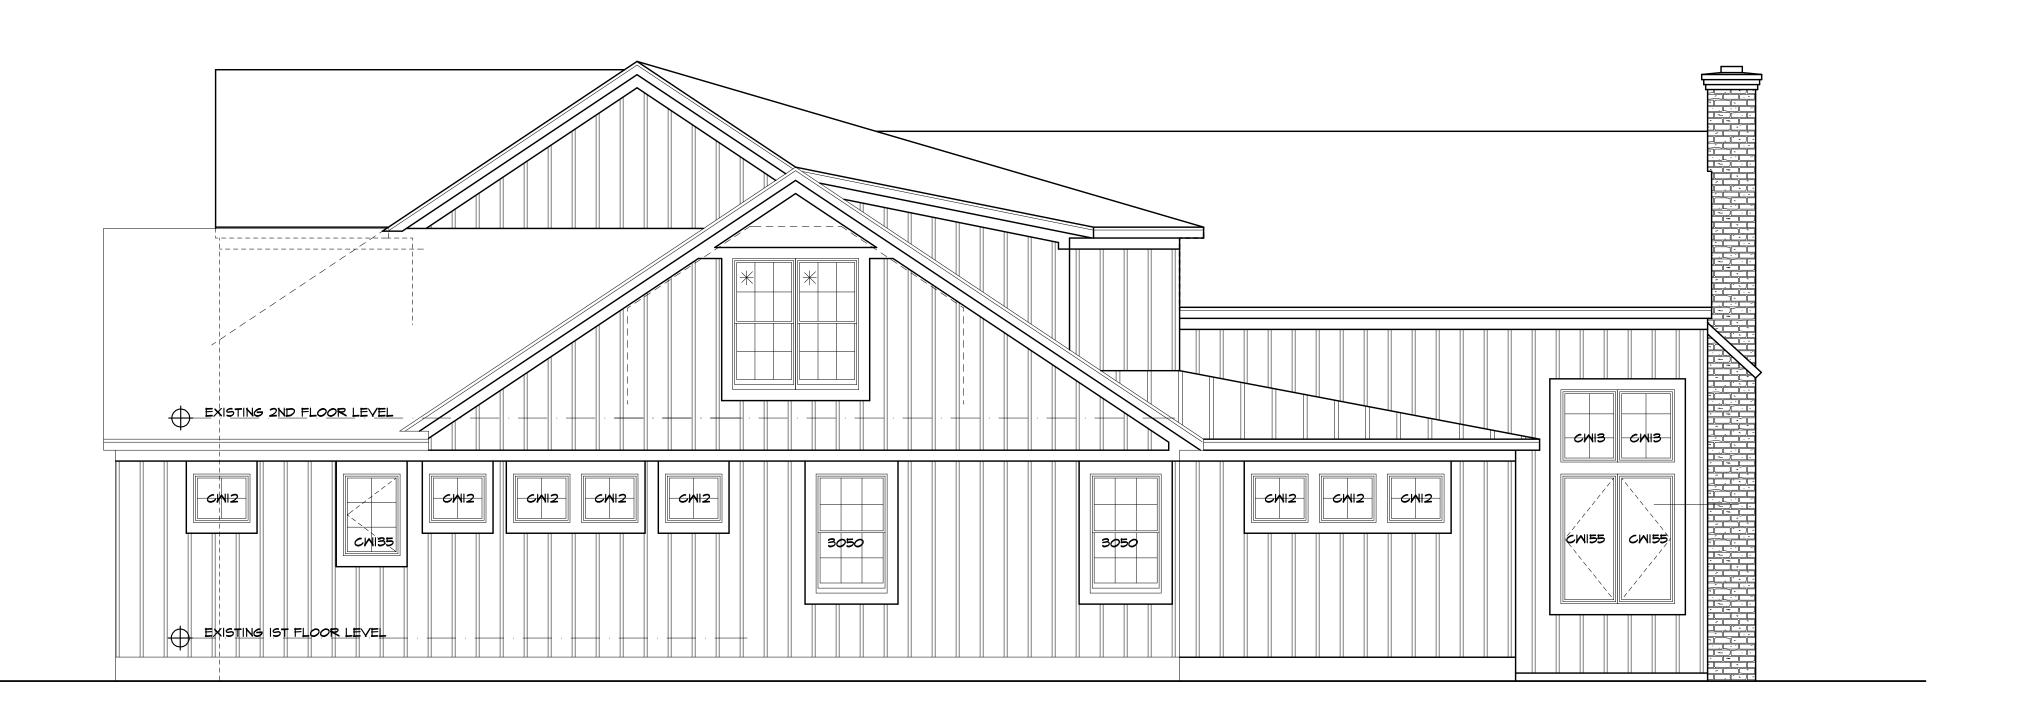

PATRICK J.
MORABITO
A.I.A.
ARCHITECT
P.C.

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PROJECT: ADDITION TO HAMILTON RESIDENCE 25 PARKER DRIVE

25 PARKER DRI

CLIENT: HAMILTON/ STERN BUILDERS

DRAWING: ELEVATIONS - PROPOSED

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DATE:

SCALE:

JOB NO.: 2020HAMILTON


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**A-**2

CHECKED:

ML9



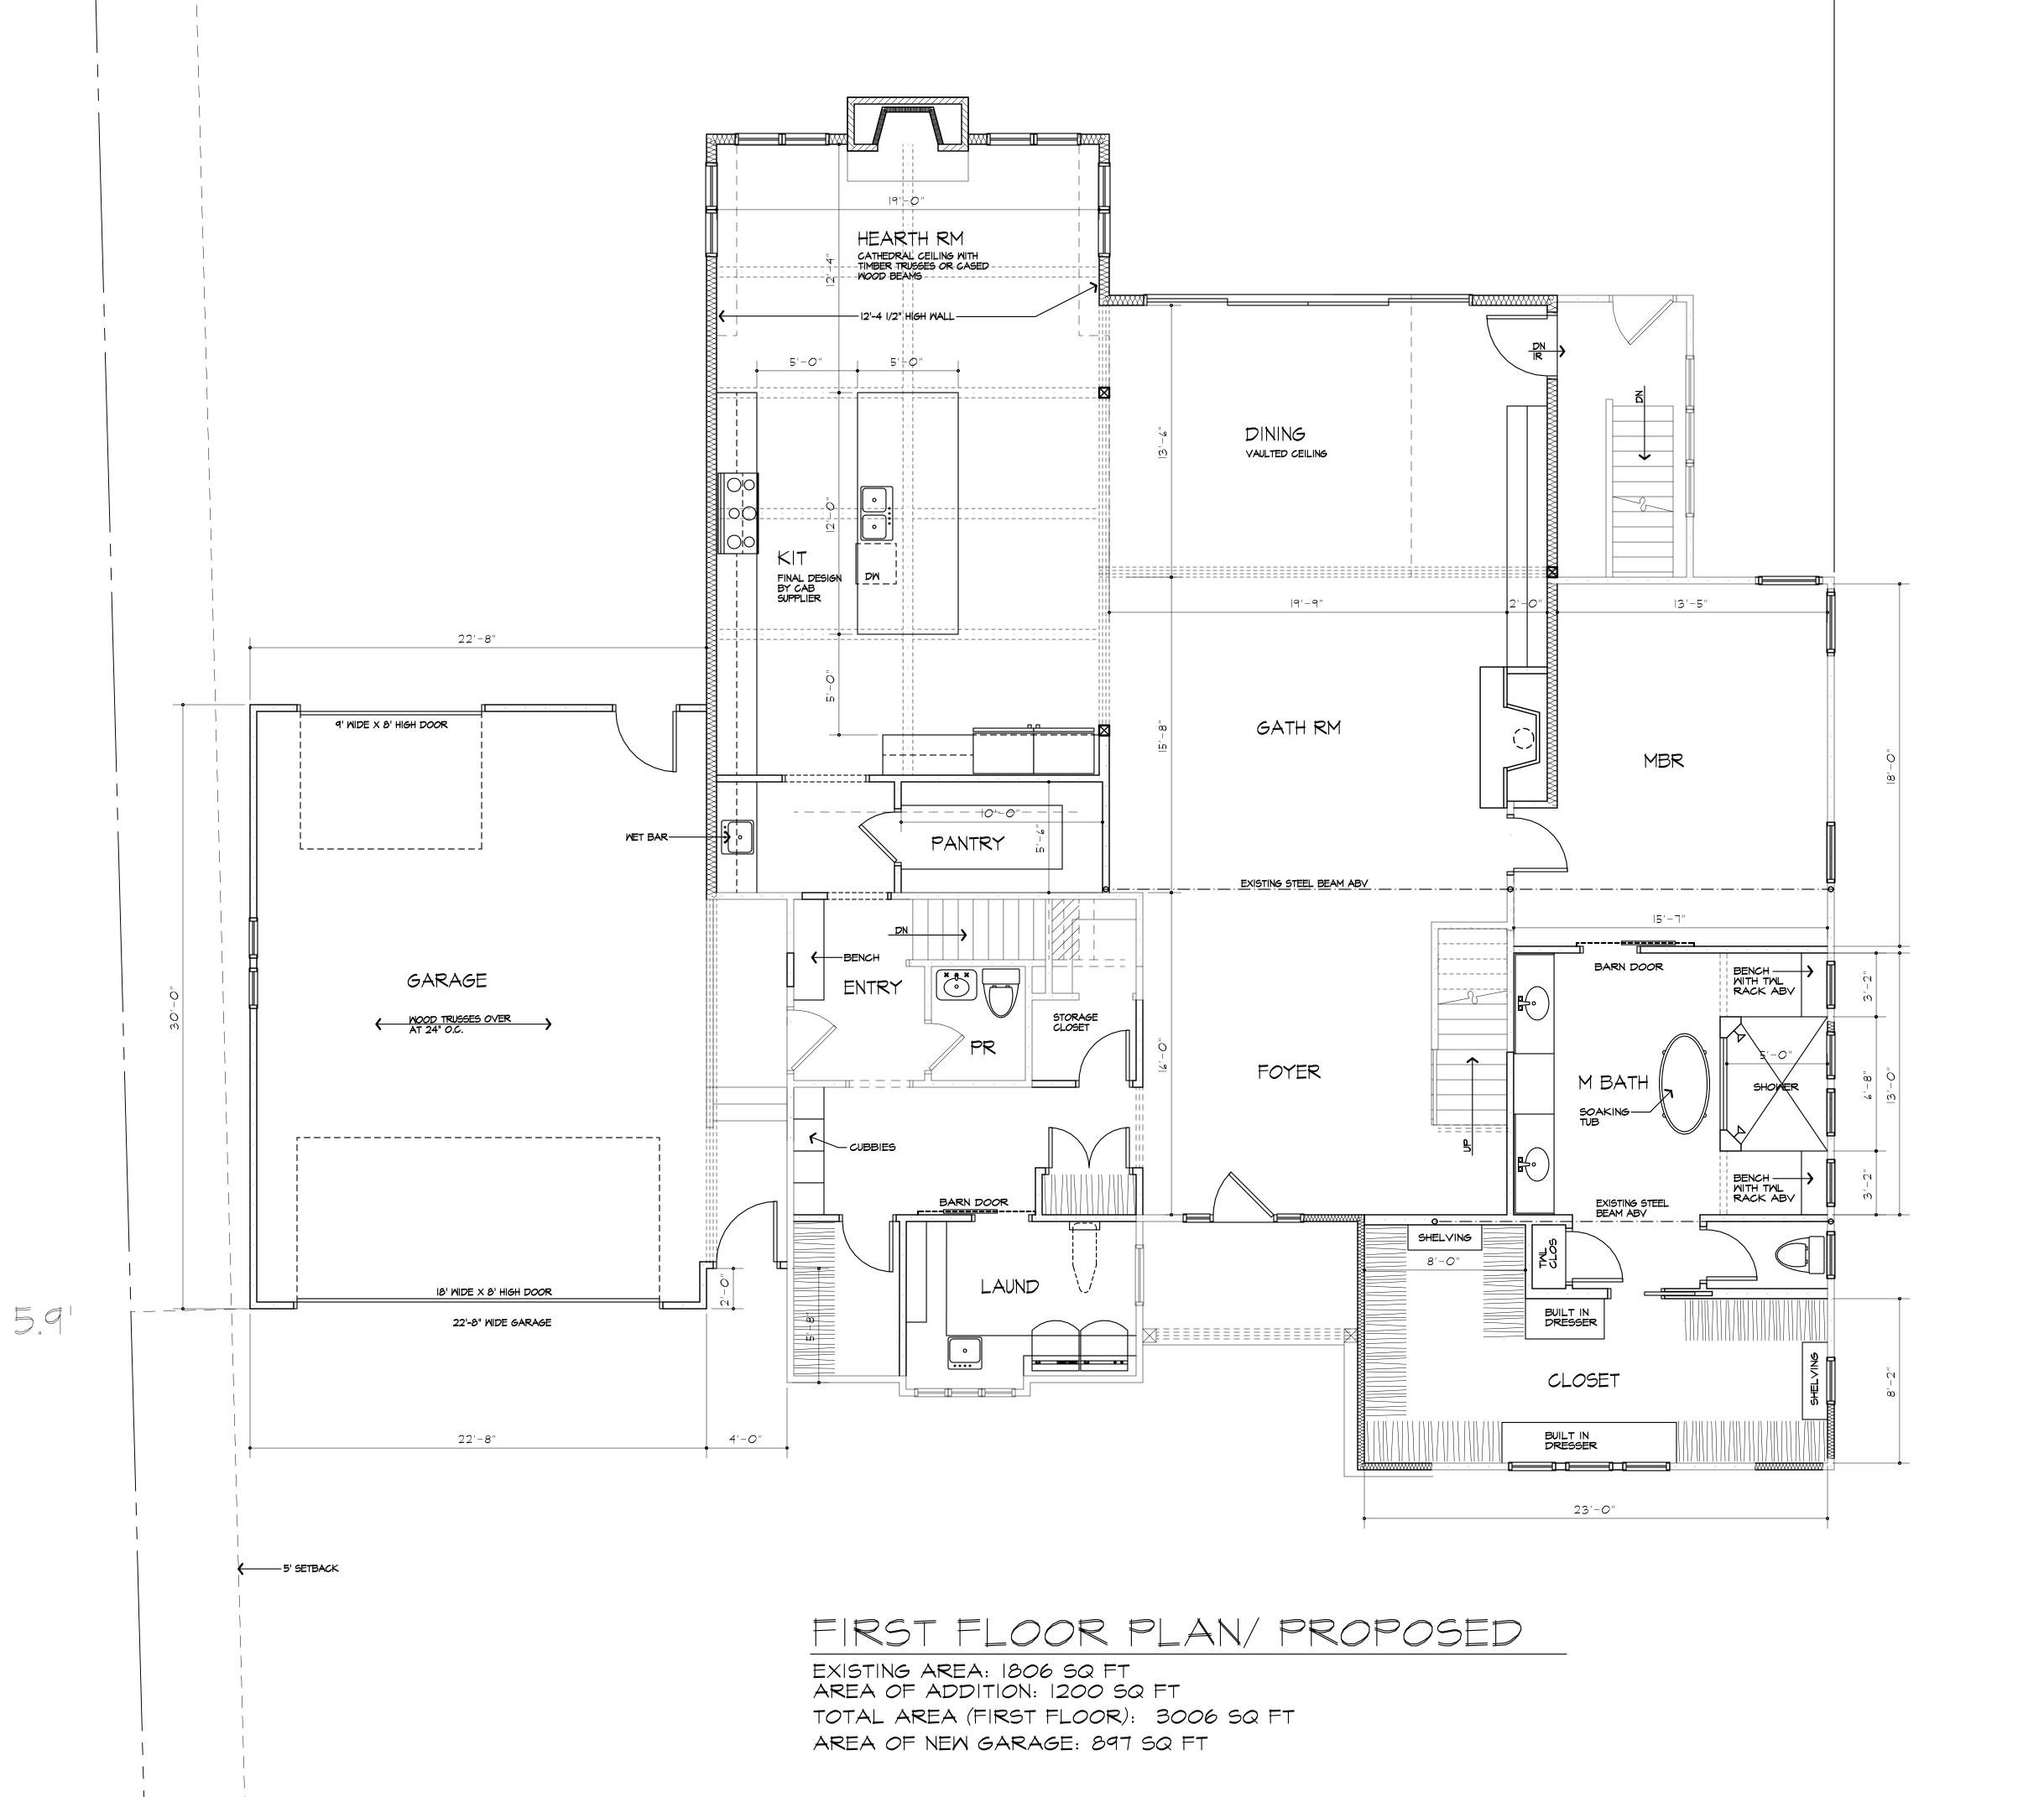

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PROJECT: ADDITION TO HAMILTON RESIDENCE 25 PARKER DRIVE

CLIENT: HAMILTON/ STERN BUILDERS

**DRAWING:** IST FLOOR PLAN PROPOSED

CHECKED:

ML9

MAY 2020 1/4"=1'-0"

JOB NO.: 2020HAMILTON

**A-3** 





## SECOND FLOOR PLAN/ PROPOSED

EXISTING AREA: 787 SQ FT AREA OF NEW ADDITION: 583 SQ FT TOTAL AREA: 1370 SQ FT

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PROJECT:
ADDITION TO
HAMILTON RESIDENCE
25 PARKER DRIVE

HAMILTON/ STERN BUILDERS

2ND FLOOR PLAN PROPOSED


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1/4"=1'-0"

2020HAMILTON





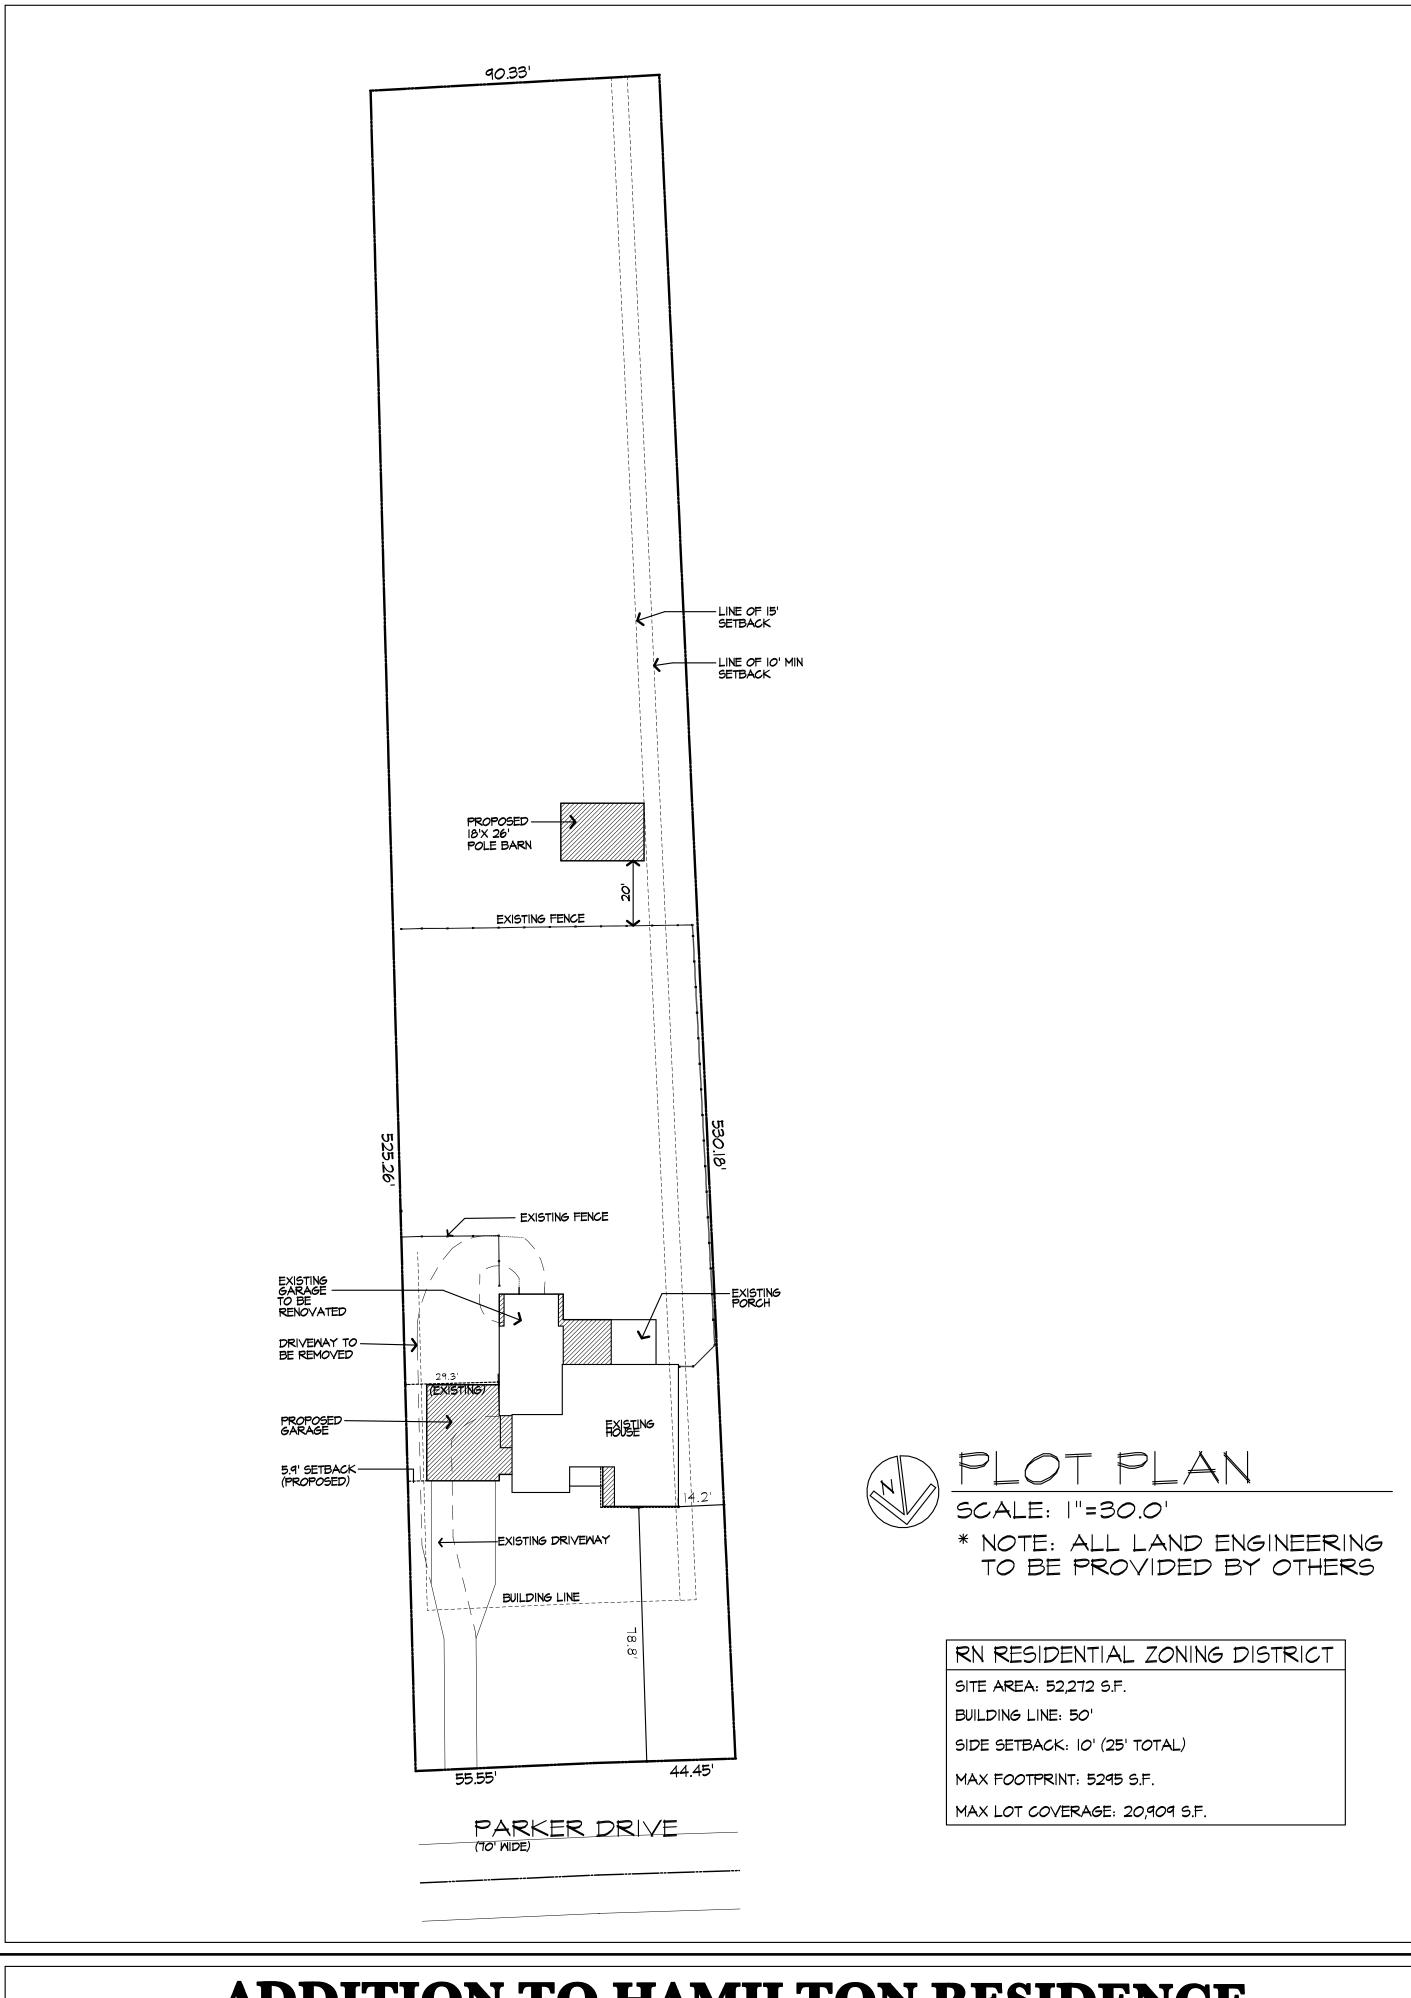

# ADDITION TO HAMILTON RESIDENCE 25 PARKER DR - PITTSFORD, NY HAMILTON/ STERN/ BUILDER

### **DRAWING INDEX**

	TITLE PAGE
	<b>ELEVATIONS - EXISTING</b>
	1ST FLR PLAN - EXISTING
	ROOF PLAN - EXISTING
	F/L ELEVATIONS - PROPOSED
	BSMT/FOUND PLAN - PROPOSED
	1ST FLOOR PLAN - PROPOSED
	2ND FLOOR PLAN - PROPOSED
	ROOF PLAN - PROPOSED
·	<b>BUILDING SECTIONS</b>

### DRAWING REFERENCE

THE FOLLOWING RESOURCES WERE USED BY THE ARCHITECT IN THE PREPARATION OF THESE DOCUMENTS:

- ARCHITECTURAL DRAWINGS FOR THE RESIDENCE, LABELED "EASTMAN KODAK CO. DEVELOPMENT DEPARTMENT" UNKNOWN DATE
- 2. FIELD MEASUREMENTS, OBSERVATION, AND DIGITAL PHOTOGRAPHY PROVIDED BY THE OWNER

3. SEVERAL ASSUMPTIONS WERE MADE BY THE ARCHITECT WITH REGARD TO THE CONSTRUCTION OF THE EXISTING STRUCTURE AND THE SIZE OF STRUCTURAL MEMBERS NOT EXPOSED TO VIEW. THEREFORE, THE CONTRACTOR IS REQUIRED TO VERIFY ALL EXISTING CONDITIONS AND REPORT ANY DISCREPENCIES TO THE ARCHITECT FOR CLARIFICATION/ ADJUSTMENTS NEEDED

### BASIC DESIGN CRITERIA

- WIND SPEED 90 MPH, EXPOSURE B R301.2 (4)

- ENERGY COMPLIANCE PATH RESCHEK

ROOF TIE DOWN REQUIREMENTS

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ADDITION TO HAMILTON RESIDENCE 25 PARKER DRIVE

HAMILTON/ STERN BUILDERS

### **DRAWING:** TITLE PAGE

DRAWN:		CHECKED:
MGM		M
DATE:	MA	Y 2020

2020HAMILTON





### FRONT ELEVATION/ EXISTING WITH REMOVALS SHOWN



LEFT SIDE ELEVATION/ EXISTING

WITH REMOVALS SHOWN

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ELEVATIONS - EXISTING

CHECKED:


2020HAMILTON





## REAR ELEVATION/ EXISTING

WITH REMOVALS SHOWN

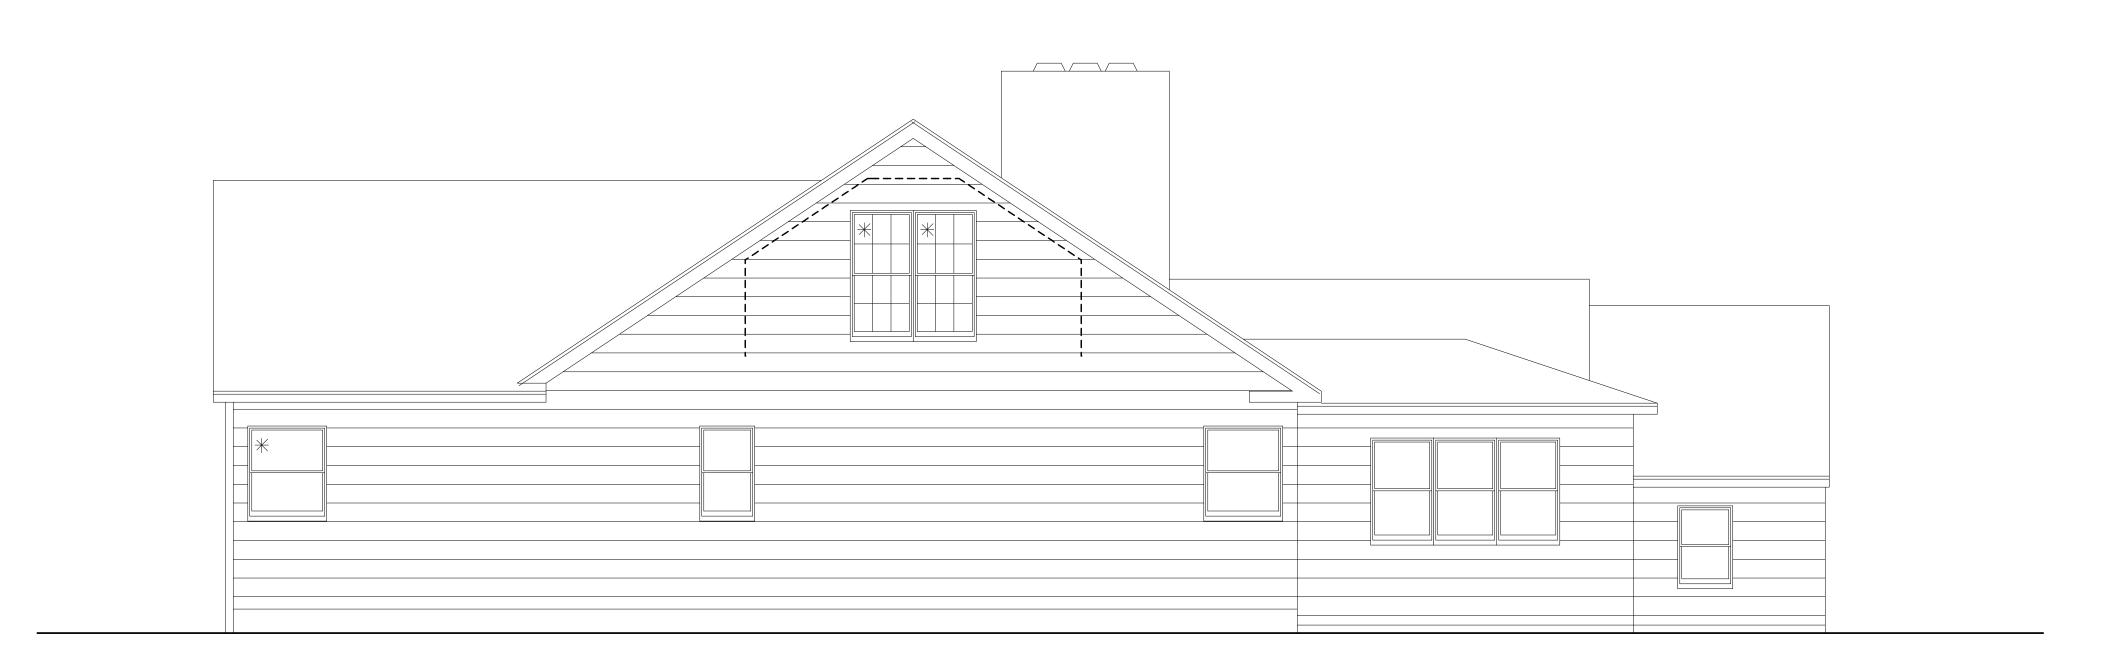

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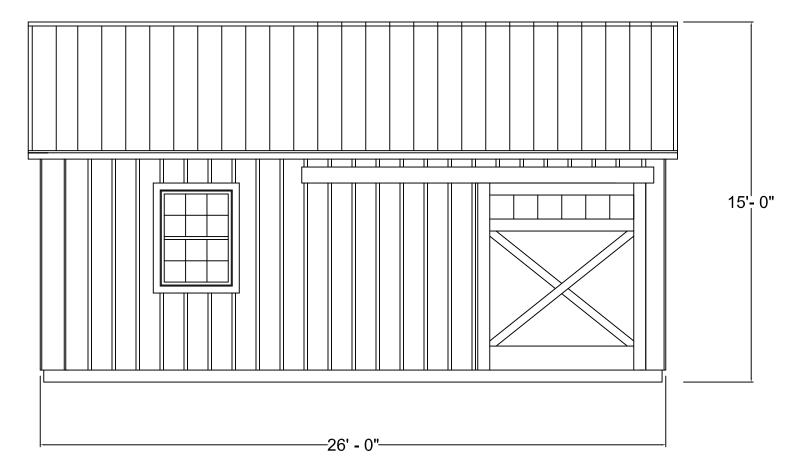
PATRICK J. MORABITO, A.I.A. ARCHITECT P.C.

CLIENT: HAMILTON/ STERN BUILDERS

ELEVATIONS/ EXISTING WITH REMOVALS SHOWN

JOB NO.: 2020HAMILTON





### **NORTH Elevation**

Scale  $-\frac{1}{4}$ " = 1'-0"



PHONE: (585)-586-8101 FAX: (585)-586-8101

> HAMILTON RESIDENCE 25 PARKER DRIVE PITTSFORD, NY 14534

PARTNERING FIRM: ARCHITECT OR CONTACT: PHONE: EMAIL:

HAMILTON STERN CONSTRUCTION, LLC. PROJECT CONTACT:


PHONE: EMA**I**L:

MARK.         DATE.         DESCRIPTION.           AD DOOR INTO OFFICE, CLIENT SEA	DRAWIN	DRAWING REVISIONS:	
2/12/19	MARK:		DESCRIPTION:
	$\triangleleft$	2/12/19	ADD DOOR INTO OFFICE, CLIENT SEATING AREA

DATE: 6/25/20 DRAWN BY:

SHEET TIT

NORTH ELEVATION

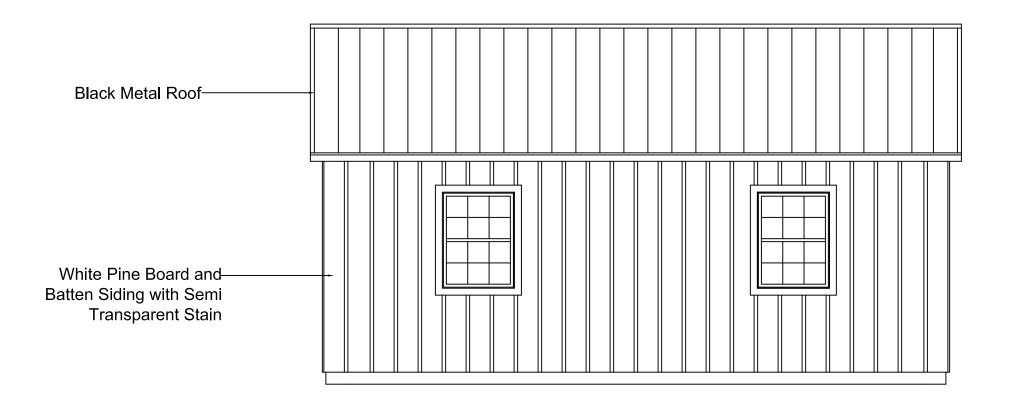

#### **SOUTH Elevation**

Scale  $-\frac{1}{4}$ " = 1'-0"



# HAMILTON RESIDENCE 25 PARKER DRIVE PITTSFORD, NY 14534

PARTNERING FIRM: ARCHITECT OR CONTACT: PHONE: EMAIL:

HAMILTON STERN CONSTRUCTION, LLC
PROJECT CONTACT:


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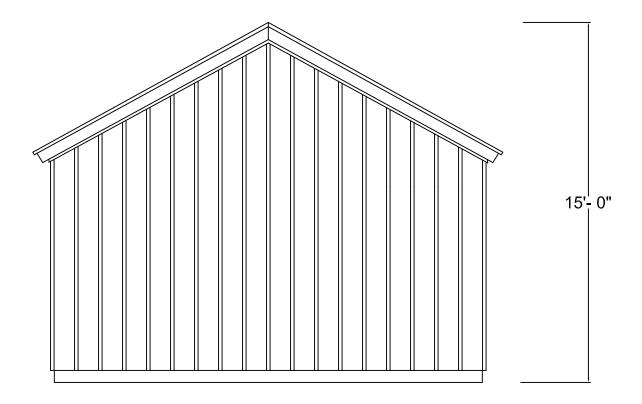
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⊲	2/12/19	ADD DOOR INTO OFFICE, CLIENT SEATING AREA

DATE: 6/25/20

SHEET TITLE:

SOUTH ELEVATION



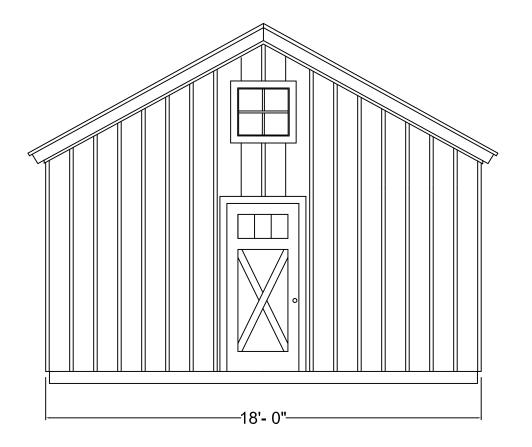

### **EAST Elevation**

Scale  $-\frac{1}{4}$ " = 1'-0"

### **WEST Elevation**

Scale  $-\frac{1}{4}$ " = 1'-0"



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# HAMILTON RESIDENCE 25 PARKER DRIVE PITTSFORD, NY 14534

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HAMILTON STERN CONSTRUCTION, LLC. PROJECT CONTACT:


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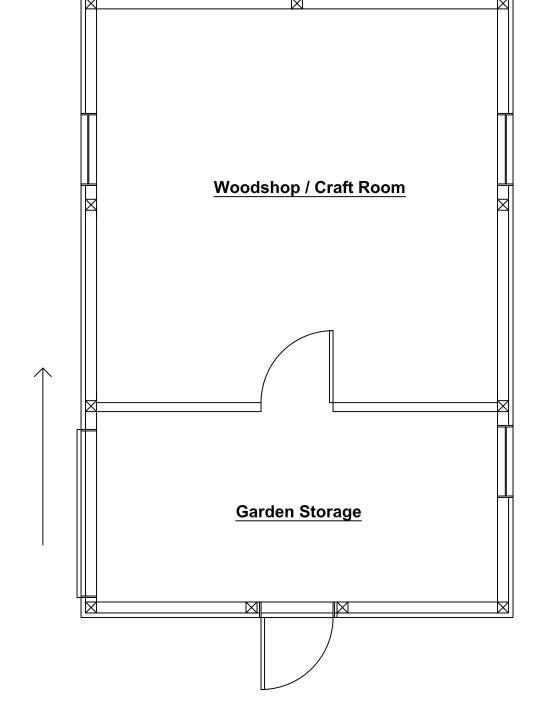
		SEATING AREA			
	DESCRIPTION:	ADD DOOR INTO OFFICE, CLIENT SEATING AREA			
DRAWING REVISIONS:	DATE:	2/12/19			
DRAWING	MARK:	$\triangleleft$			

DATE: 6/25/2 DRAWN BY:

SHEET .

EAST/WEST ELEVATION



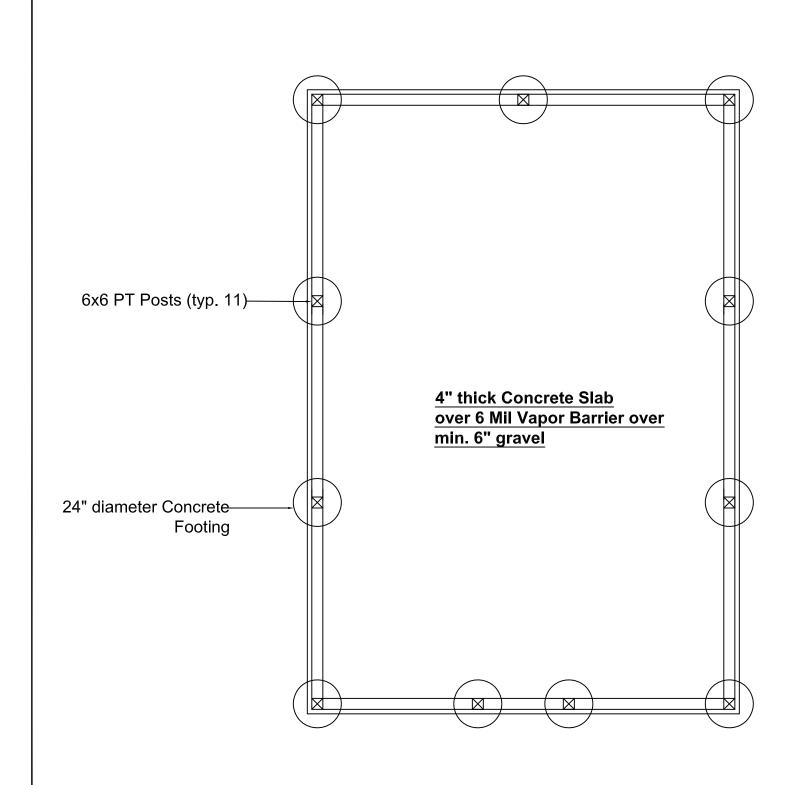

### **Foundation Plan**

Scale  $-\frac{1}{4}$ " = 1'-0"

#### Floor Plan

Scale - ½" = 1'-0"



ILTON STERN CONSTRUCTION, I 3850 MONROE AVENUE PITTSFORD, NY 14534

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HAMILTON STERN CONSTRUCTION, LLC. PROJECT CONTACT: PHONE:

ING REVISIONS:

2/12/19 ADD DOOR INTO OFFICE, CLIENT SEATING AREA

PATE: 6/25/ PRAWN BY:


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FOUNDATION AND FLOOR PLAN







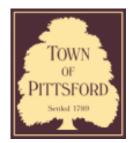

#### **Town of Pittsford**

Department of Public Works 11 South Main Street Pittsford, New York 14534

Permit # S20-000012

Phone: 585-248-6250 FAX: 585-248-6262

### DESIGN REVIEW AND HISTORIC PRESERVATION BOARD REFERRAL OF APPLICATION

Property Address: 3001 Monroe Avenue ROCHESTER, NY 14618

Tax ID Number: 150.08-1-71.1 Zoning District: C Commercial

Owner: Monroe Clover Plaza LLC (Blonsky Family Chiropractic)

**Applicant:** Mcallister Signs LLC


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	Residential Design Review		Build to Line Adjustment
	§185-205 (B)		§185-17 (B) (2)
	Commercial Design Review		Building Height Above 30 Feet
	§185-205 (B)		§185-17 (M)
<b>✓</b>	Signage		Corner Lot Orientation
<u> </u>	§185-205 (C)	$\cup$	§185-17 (K) (3)
	Certificate of Appropriateness		Flag Lot Building Line Location
	§185-197	$\cup$	§185-17 (L) (1) (c)
	Landmark Designation		Undeveloped Flag Lot Requirements
	§185-195 (2)	$\cup$	§185-17 (L) (2)
	Informal Review		


**Project Description:** Applicant is requesting design review for the addition of a business identification sign. The sign will be approximately 10.5 sq. ft. and will identify "Blonsky Family Chiropractic".

Meeting Date: July 23, 2020

### RN Residential Neighborhood Zoning

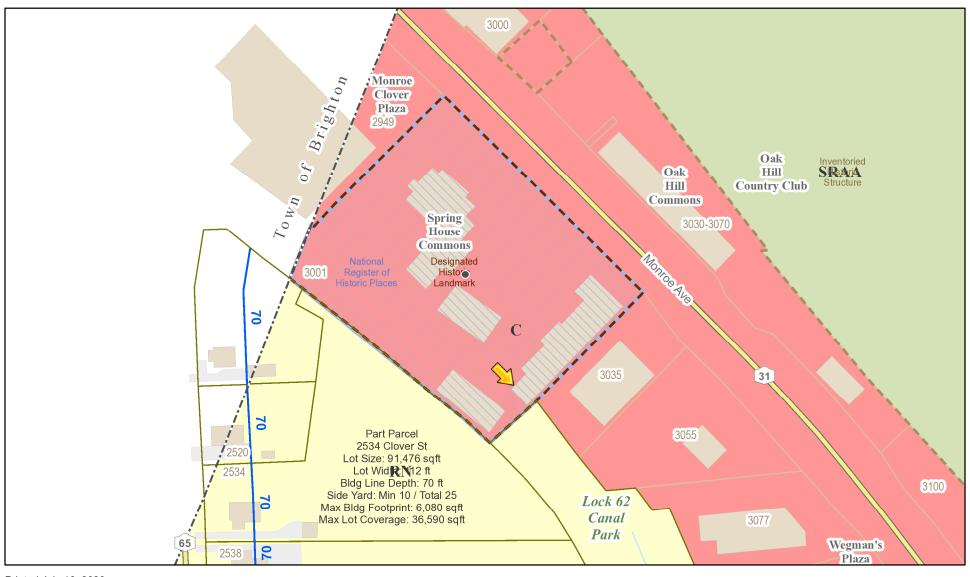


Printed July 16, 2020

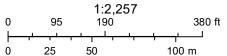

Town of Pittsford GIS

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Dimensional Exterior

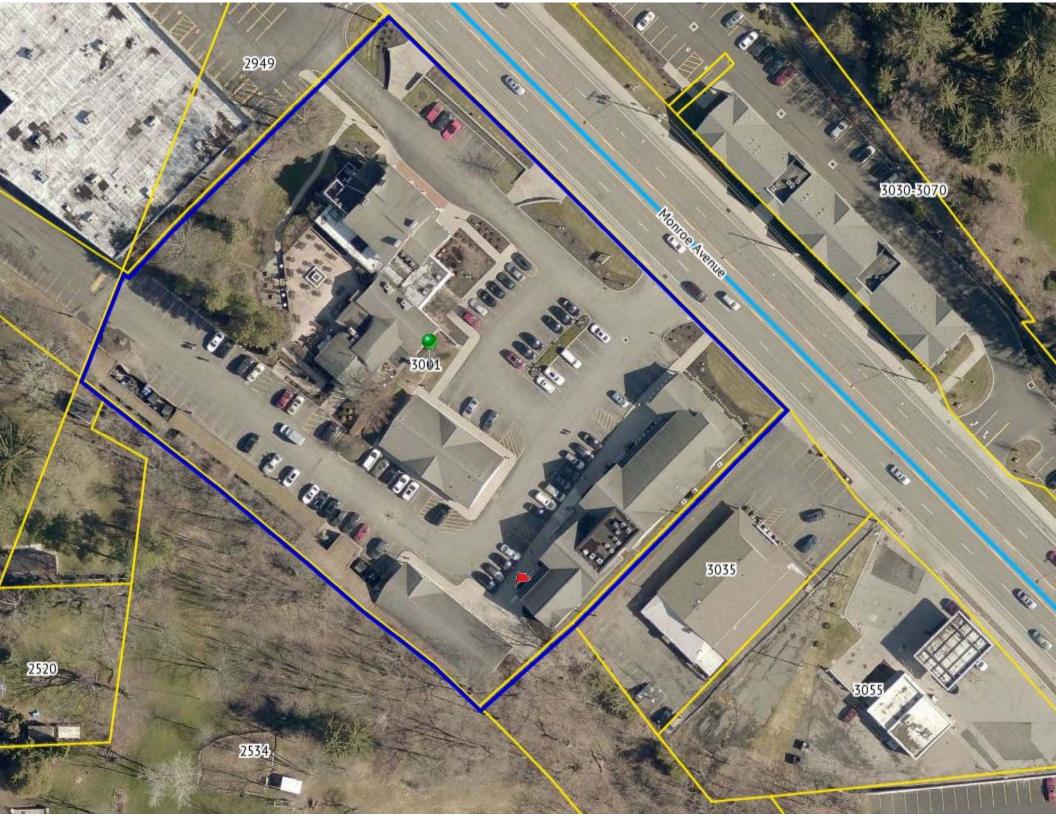