Design Review & Historic Preservation Board Agenda March 11, 2021

HISTORIC PRESERVATION DISCUSSION

RESIDENTIAL APPLICATION FOR REVIEW

• 11 Cedarwood Circle

The Applicant is requesting design review for the addition of a mudroom. The existing covered porch will become the new mudroom and will be approximately 21 square feet located on the front of the home.

21 Brookwood Road

The Applicant is requesting design review for the addition of a screened porch. The porch will be approximately 400 square feet and will be located to the rear of the home.

• 6 Canal Park Place

The Applicant is requesting design review for the covered deck addition and oversized gazebo. The covered deck will be approximately 684 square feet and gazebo will be 450 square feet. The applicant appeared before the Zoning Board of Appeals and was granted a variance for side setback and oversized accessory structure.

RESIDENTIAL APPLICATION FOR REVIEW - NEW HOME

• 180 Kilbourn Road

The Applicant is requesting design review for the construction of a new two story home. The home will be approximately 3924 square feet of living space and will be located in the Kilbourn neighborhood. The previous home has been demolished. The applicant did appear before the Zoning Board of Appeals on February 15th and was granted variances for setbacks.

19 Black Wood Circle

The Applicant is requesting design review for the construction of a one story single family home. The home will be approximately 2371 square feet in the Wilshire Hills subdivision.

• 22 Lexton Way

The Applicant is requesting design review for the construction of a two story single family home. The home will be approximately 1296 square feet on the first floor and 1414 square feet on the second floor. This home will be located in the Wilshire Hills subdivision.

COMMERCIAL APPLICATION FOR REVIEW - SIGNAGE

• 3349 Monroe Avenue

The Applicant is requesting design review for the addition of two business identification signs. The front sign will be approximately 73.3 square feet and the sign on the side of the building will be approximately 48.3 square feet. Both signs will identify the "Adelita's Mexican Cocina & Tequila" Restaurant.

OTHER - REVIEW OF 2/25/2020 MINUTES

DRHPB Meeting Agenda March 11, 2021 Page 2 of 2

How to view the meeting:

1. Zoom

- In your web browser, go to
- https://townofpittsford.zoom.us/j/85740907443?pwd=SkJnRDIXcjJVOVBiTFc2ZW9jbEF5UT09
- You will be connected to the meeting.

2. Telephone

• You can access the meeting by phone. Use any of the phone numbers below, then enter the meeting ID when prompted. The Meeting ID is 857 4090 7443. No password is necessary.

(929) 205-6099	(312) 626-6799
(253) 215-8782	(301) 715-8592
(346) 248-7799	(669) 900-6833

Draft

Design Review and Historic Preservation Board Minutes February 25, 2021

PRESENT

Dirk Schneider, Chairman; Paul Whitbeck, John Mitchell, Kathleen Cristman, Bonnie Salem, Leticia Fornataro

ALSO PRESENT

Robert Koegel, Town Attorney; Allen Reitz, Assistant Building Inspector; Susan Donnelly, Secretary to the Board

ABSENT

David Wigg

Proceedings of a regular meeting of the Pittsford Design Review and Historic Preservation Board were held on Thursday, February 25 at 6:00 P.M. local time. The meeting took place with Board members and applicants participating remotely using Zoom.

Dirk Schneider, Chairman opened the meeting at 6:00 pm.

HISTORIC PRESERVATION DISCUSSION

There was no historic preservation discussion.

RESIDENTIAL APPLICATION FOR REVIEW - RETURNING

11 Old Landmark Drive

The Applicant is returning for design review for the addition of a screened porch. The screened porch will be approximately 225 square feet and will be located to the rear of the property.

Mike Heiler of Homes by Design Woodworking was present to discuss the application with the Board.

Mr. Heiler stated that the construction of a screened porch will feature brick and trim which will match the original structure. An arch feature is added to blend with current trim elements on the home. Board members commented on the visibility of the line of the screen window is hidden behind the arch.

Bonnie Salem moved to accept the application as submitted with the recommendation that the line of the screen be hidden behind the arch.

John Mitchell seconded.

All Aves

RESIDENTIAL APPLICATION FOR REVIEW - NEW

9 Northstone Rise

The Applicant is requesting design review for the addition of a three-season room. The addition will be approximately 556 square feet and will be located to the rear of the home. This application was approved for a side setback variance on 2/15/2021.

Dominick Caroselli was present to discuss the application with the Board.

Mr. Caroselli discussed that this addition had received a variance for a rear setback from the Zoning Board of Appeals. He said that the split rock stone would be in a color palette that is complementary to the siding. The timbers will be stained in a similar color palette. The roofing will be consistent with what is existing.

Paul Whitbeck moved to approve the application as submitted.

Leticia Fornataro seconded.

All Ayes.

RESIDENTIAL APPLICATION FOR REVIEW - NEW HOME

4 Rockdale Meadows

The Applicant is requesting design review for the construction of a one story single family home. The home will be approximately 2302 sq. ft. and will be located in the Coventry Ridge Subdivision.

Steve Maynard of Spall Homes was present.

Mr. Maynard stated that this was the 18th patio home to be built in this subdivision. The home is sold and the color palette has been chosen. The home will feature three textures but the horizontal shingles and shakes will be the same color – a medium gray color. The roof will be black.

Paul Whitbeck pointed out the use of three textures and Mr. Maynard stated that 2/3 of the homes in this development feature three textures.

Kathleen Cristman moved to accept the application as submitted.

John Mitchell seconded.

All Ayes.

APPLICATION FOR LANDMARK DESIGNATION

East Street Burying Ground

The Applicant is requesting design review to designate the East Street Burying Ground as a Historic Landmark in accordance with Article XXX, Section 185-195.3 of the Pittsford Town Code. The property is zoned RN (Residential Neighborhood).

Dirk Schneider opened the public hearing.

Bonnie Salem introduced the nominated property. She stated that this burial ground is historically significant as it is the final resting place of Simon Stone, one of the co-founders of the Town of Northfield later Pittsford. Mr. Stone set aside part of his property to serve as a burial ground for the early settlers of the area. Forty-five burials took place between 1814 – 1879.

Bonnie thanked Town Historian Audrey Johnson for her efforts in researching the history of the Burying Ground and the Town Board for agreeing to go forward with permission for the designation.

Margaret Carrabares-Brizee offered public comment. She noted that she supports the designation of the burying ground and the Historic Pittsford organization of which she is a member of "fully endorses" it as well.

Paul Whitbeck moved to close the public hearing.

John Mitchell seconded.

Whitbeck Aye
Salem Aye
Schneider Aye
Cristman Aye
Fornataro Aye
Mitchell Aye

Dirk Schneider closed the Public Hearing.

A resolution was moved by Board member Bonnie Salem, seconded by Board member Leticia Fornataro and was voted upon my members of the Board as follows:

David Wigg Absent
Dirk Schneider Aye
Bonnie Salem Aye
Kathleen Cristman Aye
Leticia Fornataro Aye
Paul Whitbeck Aye
John Mitchell Aye

The burial ground and entire parcel were granted Landmark Designation 2021-02.

OTHER - REVIEW OF 2/11/2021 MINUTES

John Mitchell moved to approve the minutes of February 11, 2021 as written.

Bonnie Salem seconded.

All Ayes.

ADJOURNMENT


Dirk Schneider moved to close the meeting at 6:40 pm.

All Ayes.

Respectfully submitted,

Susan Donnelly

Secretary to the Design Review and Historic Preservation Board

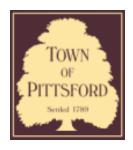

Town of Pittsford

Department of Public Works 11 South Main Street Pittsford, New York 14534

Permit # B21-000036

Phone: 585-248-6250 FAX: 585-248-6262

DESIGN REVIEW AND HISTORIC PRESERVATION BOARD REFERRAL OF APPLICATION

Property Address: 11 Cedarwood Circle PITTSFORD, NY 14534

Tax ID Number: 178.11-2-21

Zoning District: RN Residential Neighborhood

Owner: Sherwood, Robert G Applicant: John Carson

Application Type:


✓	Residential Design Review		Bulla to Line Adjustment
	§185-205 (B)		§185-17 (B) (2)
	Commercial Design Review		Building Height Above 30 Feet
	§185-205 (B)		§185-17 (M)
	Signage	Corner Lot Orientation §185-17 (K) (3)	Corner Lot Orientation
	§185-205 (C)		§185-17 (K) (3)
	Certificate of Appropriateness	 Flag Lot Building Line Location 	
	§185-197		§185-17 (L) (1) (c)
	Landmark Designation		Undeveloped Flag Lot Requirements
	§185-195 (2)		§185-17 (L) (2)
	Informal Review		

Project Description: Applicant is requesting design review for the addition of a mudroom. The existing covered porch will become the new mudroom and will be approximately 21 square feet located on the front of the home.

Meeting Date: March 11, 2021



RN Residential Neighborhood Zoning

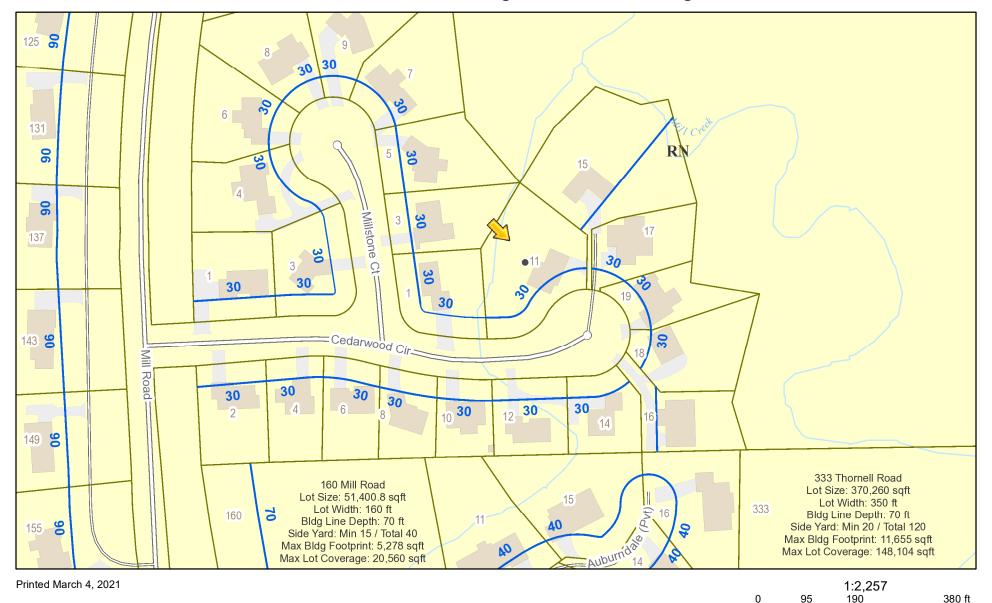


Town of Pittsford GIS

25

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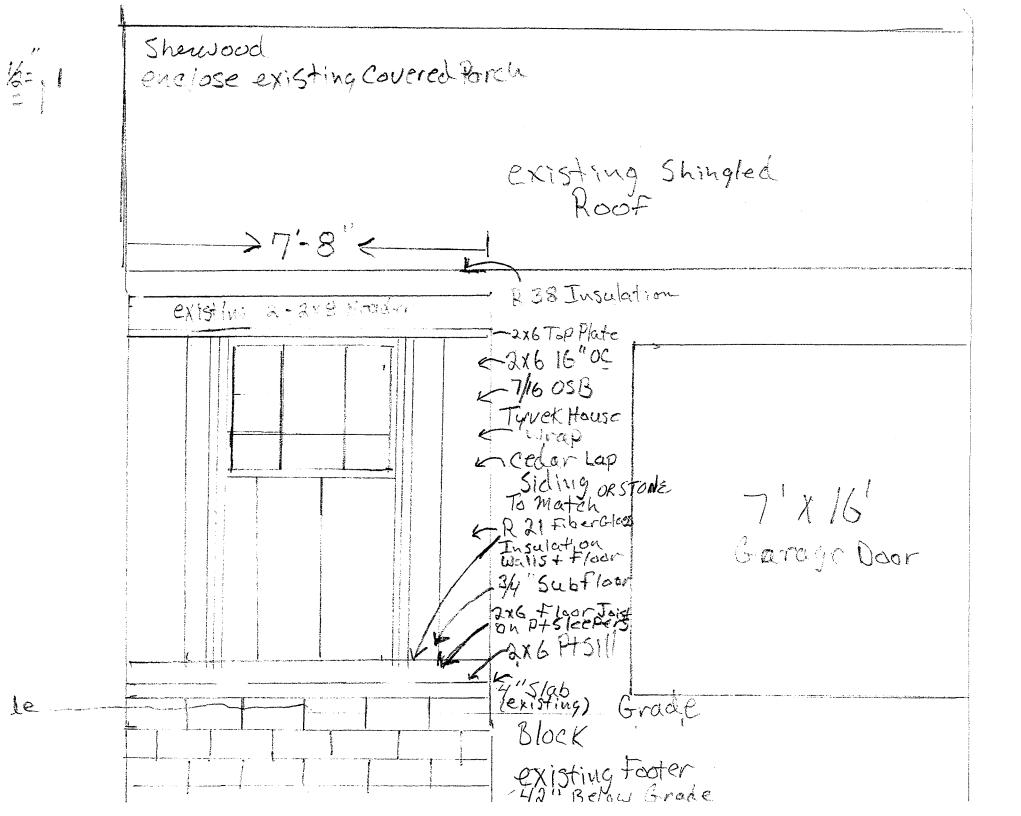
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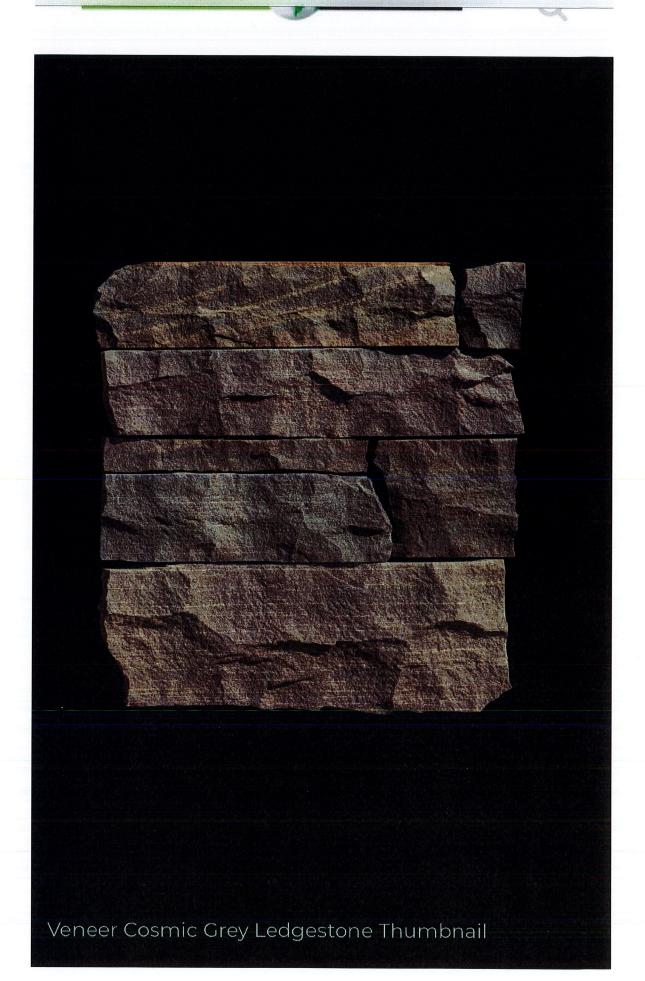




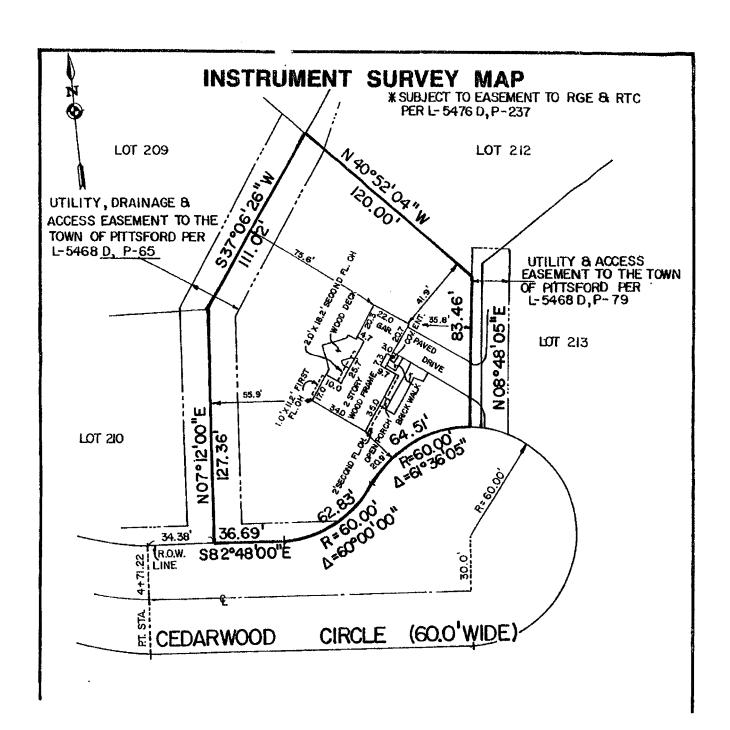

22'x 22' gxisting Garage Remove existing Wall Covered Porch Frame New Wall + Window existing Header 7-8"___ は"=1"














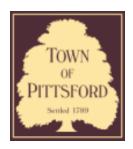

Town of Pittsford

Department of Public Works 11 South Main Street Pittsford, New York 14534

Permit # B21-000037

Phone: 585-248-6250 FAX: 585-248-6262

DESIGN REVIEW AND HISTORIC PRESERVATION BOARD REFERRAL OF APPLICATION

Property Address: 21 Brookwood Road PITTSFORD, NY 14534

Tax ID Number: 164.09-2-67

Zoning District: RN Residential Neighborhood

Owner: Di Pasquale, Christopher **Applicant:** Di Pasquale, Christopher

Application Type:


✓	Residential Design Review		Build to Line Adjustment
	§185-205 (B)		§185-17 (B) (2)
	Commercial Design Review		Building Height Above 30 Feet
	§185-205 (B)		§185-17 (M)
	Signage		Corner Lot Orientation
	§185-205 (C)	□ §185-17 (K) (3)	§185-17 (K) (3)
	Certificate of Appropriateness	 Flag Lot Building Line Locatio 	
	§185-197		§185-17 (L) (1) (c)
	Landmark Designation		Undeveloped Flag Lot Requirements
	§185-195 (2)		§185-17 (L) (2)
	Informal Review		

Project Description: Applicant is requesting design review for the addition of a screened porch. The porch will be approximately 400 square feet and will be located to the rear of the home.

Meeting Date: March 11, 2021



RN Residential Neighborhood Zoning

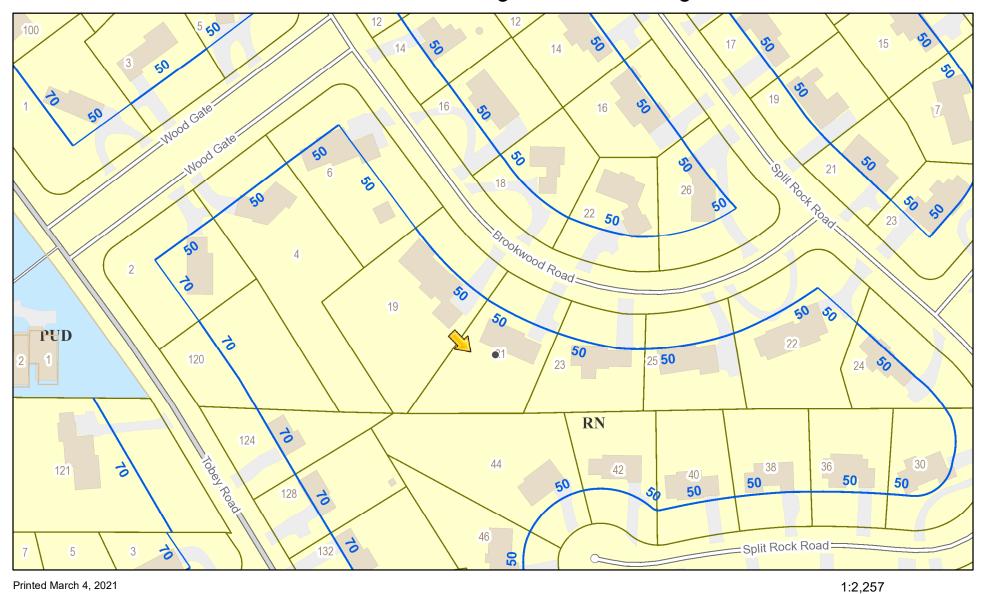

The information depicted on this map is representational and should be used for general reference purposes only. No warranties, expressed or implied, are provided for the data or its use or interpretation.

190

50

380 ft

100 m

95

25

Town of Pittsford GIS



DiPasquale Residence

Renovations and Addition 21 Brookwood Road, Pittsford New York 14534

ABBF	REVIATIONS					CODE AND GENERAL N	NOTES
AB	ANCHOR BOLT	FIN	FINISHED	REINF	REINFORCED	STRUCTURAL DESIGN LOADS:	
4/C	AIR CONDITIONER	FLR	FLOOR	REF	REFRIGERATOR	ALL LIVING SPACE 40 PSF ALL BEDROOM SPACE 30 PSF	23. N1103.9 LIGHTING EQUIPMENT. A MINIMUM OF 50 PERCENT OF T
CT	ACOUSTICAL CEILING TILE	FLUOR	FLUORESCENT	R & SH	ROD AND SHELF	ALL OTHER SPACE: 40 PSF	LAMPS IN PERMANENTLY INSTALLED LIGHTING FIXTURES SHALI HIGH-EFFICACY LAMPS.
DD'N	ADDITION	FP	FIRE PLACE	REV.	REVISION	ATTIC STORAGE 20 PSF	
ΟJ	ADJUSTABLE	FTG	FOOTING	REQ'D	REQUIRED	2. SOIL BEARING MIN. 2000 PSF.	24. N1102.4.5 RECESSED LIGHTING. RECESSED LUMINARIES IN THE BUILDING THERMAL ENVELOPE SHALL BE SEALED TO LIMIT AIR
F	ABOVE FINISHED FLOOR			RFTR	RAFTER	3. JOISTS, HEADERS, & BEAMS SHALL BE EASTERN HEM FIR no 2 OR	LEAKAGE BETWEEN CONDITIONED AND UNCONDITIONED SPACE
UM	ALUMINUM	GALV	GALVANIZED	RM	ROOM	BETTER UNLESS NOTED OTHERWISE.	
	ACCESS PANEL	GYP	GYPSUM	RV	ROOF VENT	HF: Fb = 850 PSI, FV =150 PSI, E = 1,300,000 LVL: Fb = 2600 PSI, FV =285 PSI, E = 1,900,000	25. ENERGY STANDARDS CERTIFICATE. A PERMANENT CERTIFICAT SHALL BE POSTED ON OR IN THE ELECTRICAL DISTRIBUTION PA
OD	ANODIZED						THE CERTIFICATE SHALL NOT COVER OR OBSTRUCT VISIBILITY
Р	APPROXIMATE	HDR	HEADER	SB	SINK BASE	 CONCRETE SUBJECT TO FREEZE THAW CYCLES SHALL HAVE A MIN. COMPRESSIVE STRENGTH OF 3.500 PSI AND AIR ENTRAINED PER 	CIRCUIT DIRECTORY LABEL, SERVICE DISCONNECT LABEL OR C REQUIRED LABELS. THE CERTIFICATE SHALL COMPLETED BY THE
′G	AVERAGE	HR	HOUR	SEL'D	SELECTED	TABLE R402.2 OF THE RESIDENTIAL CODE OF N.Y.S	BUILDER OR REGISTERED DESIGN PROFESSIONAL. THE CERTIF
		HGT	HEIGHT	SF	SQUARE FOOT	5. BEAMS TO FOUNDATION POCKETS SHALL HAVE 1/2" CLEARANCE FROM	SHALL LIST THE PREDOMINANT R-VALUES OF INSULATION INST. IN OR ON CEILING/ROOF, WALLS, FOUNDATION (SLAB, BASEMEN
RG	BEARING	HW	HARDWOOD	SHS	SHELVES	MASONRY - (1/2" AIRSPACE (3) SIDES W/ 1/2" P.T. PLATE UNDER W/	WALL, CRAWLSPACE WALL AND / OR FLOOR) AND DUCTS OUTS
M	BEAM			SH	SHOWER HEAD	SOLID CMU CORES).	CONDITIONED SPACES; U-FACTORS OF FENESTRATION; AND, W REQUIREMENTS APPLY, DUCT LEAKAGE AND WHOLE-HOUSE AI
KSH	BOOK SHELF	IB	IRONING BOARD	SL	SIDE LITE	6. DOUBLE FLOOR JOISTS AT FLOOR OPENINGS AND AT BUILDING ENDS.	INFILTRATION. WHERE THERE IS MORE THAN ONE VALUE FOR E
	BROOM CLOSET	INC.	INCLUDE / INCLUDING	SSR	SINGLE STUD RETURN	7. WINDOW AND EXTERIOR DOOR HEADERS AS NOTED ON PLANS.	COMPONENT, THE CERTIFICATE SHALL LIST THE TYPE AND EFFICIENCY OF HEATING, COOLING AND SERVICE WATER HEAT
C	BOARD						EQUIPMENT.
BD	-	IN.	INCH	SKY'LT	SKYLIGHT	 PROVIDE DOUBLE STUDS (MIN.) UNDER BEAMS W/ SOLID BLKING. TO FNDN. (W/ SOLID CMU CORES AT POINT LOAD), COL. OR BEAM FOR 	26. ALL WORK SHALL COMPLY WITH APPLICABLE FEDERAL. LOCAL
LDG	BUILDING	I.D.	INSIDE DIAMETER	SH	SHELF	PROPER SUPPORT AND LOAD TRANSFER.	MUNICIPAL BUILDING CODES, AS WELL AS ANY AND ALL REGUL
BLKG	BLOCKING	INSUL	INSULATION	STD	STANDARD		AGENCIES, INCLUDING, BUT NOT LIMITED TO THE BUILDING CONEW YORK STATE 2015 FOR OCCUPANCY CATEGORY OF 11. A
BOTT	BOTTOM			STOR	STORAGE	 ALL PRE-ENGINEERED ROOF AND FLOOR SYSTEMS AND OTHER BLOCKING / BRACING TO BE CERTIFIED BY THE MANUFACTURER. 	OSHA, ETC. GENERAL NOTES SHALL APPLY TO ALL DRAWINGS.
BSMT	BASEMENT			STL	STEEL	2203 2. S. C.	07 ALL MODICOLLA CONTROL STATE OF THE STATE O
		JST	JOIST	SQ.	SQUARE	10. PROVIDE REQUIRED FLASHING TO MEET OR EXCEED ACCEPTABLE	 ALL WORK SHALL CONFORM WITH THE REQUIREMENTS OF THI ZONING CODES, NATIONAL ELECTRIC CODES, N.F.P.A.
CLG	CEILING	JNT	JOINT			COMMON BUILDING PRACTICE WHERE REQ'D AND AT ROOF CHANGES, HORIZ. ABUTMENTS (FOR DECKS) PROJECTIONS, VALLEYS ,AND	RECOMMENDATIONS, OSHA, A.D.A. AND ALL OTHER APPLICABL
;	CARPET			Т	TREAD	OPENINGS	CODES; RULES AND REGULATIONS ALL IN THEIR LATEST EDITION ALL AUTHORITIES HAVING JURISDICTION OVER WORK OF THIS
ANT'LR	CANTILEVER	LAM	LAMINATE(D)	T.O.F.	TOP OF FOOTER	11. PROVIDE WOOD BLOCKING, OR OTHER SOLID ATTACHMENT MATERIAL.	7.22 7.6 7.7.6 1.1.1.26 1.1.7.1.1.1.6 GOT 10.516 7.1.6 T. 1.1.1.6
AB	CABINET	LAV	LAVATORY	T.O.S.	TOP OF SLAB	FOR ATTACHMENT OF ALL FIXTURES, FITTINGS, MILLWORK AND AS	28. THE TERMS "CONSTRUCTION CONTRACTOR", "GENERAL CONTR G.C., CONSTRUCTION MANAGER / MANAGEMENT" AND "CONTR
В	CORNER BOARDS	LB	POUND	T.O.W.	TOP OF WALL	REQUIRED FOR ANY OTHER ACCESSORIES.	SHALL BE UNDERSTOOD TO BE THE SAME UNLESS SPECIFICAL
;J	CEILING JOIST	LD	LOAD	T.O.S.F.	TOP OF SUB FLOOR	12. ALL FASTENERS INTO PRESSURE TREATED LUMBER ARE TO BE HOT	NOTED OTHERWISE.
CMU	CONCRETE MASONRY	LF	LINEAR FOOT	TBD	TO BE DETERMINED	DIPPED GALVANIZED OR STAINLESS STEEL AS RECOMMENDED BY	29. DRAWINGS ARE NOT TO BE SCALED; WRITTEN DIMENSIONS GO
S.O.	CASED OPENING	LL	LIVE LOAD	THK	THICK	MANUFACTURER.	20. DIVIVINGO / IKE NOT TO BE GOVILED, WITH TEN BINIENCIONO GO
D.O. CT		LIN	LINEN	TYP	TYPICAL	13. PROVIDE RUST-INHIBITAVE PAINT, TO STEEL COLUMNS EXCEPT FOR	30. ALL WORK IS TO CONFORM TO ARCHITECT'S DRAWINGS AND
	CERAMIC TILE					CORROSION RESISTANT OR TREATED STEEL PER SECTION R407 OF THE RESIDENTIAL CODE OF N.Y.S	SPECIFICATIONS AND SHALL BE NEW AND BEST QUALITY OF T KINDS SPECIFIED.
CL 	CLOSET	LOC	LOCATION	TC	TOILET CLOSET	THE RESIDENTIAL CODE OF N.T.S	
CNTR	COUNTER			T&G	TONGUE AND GROOVE	14. ALL AREAS OF HABITABLE SPACE WILL BE PROVIDED WITH OPENINGS	31. ALL SUBCONTRACTORS' SHOP DRAWINGS SHALL BE SUBMITTE THE ARCHITECT FOR APPROVAL THROUGH THE GENERAL
CTR	CENTER	MC	MEDICINE CABINET			FOR EMERGENCY EGRESS OF 5 SQ.FT. AT FIRST FLOOR AND 5.7 SQ. FT. AT SECOND FLOOR, SILL WITHIN 42" OF FLOOR, WITH MINIMUM	CONTRACTOR PRIOR TO WORK BEING PERFORMED, UNLESS
COL	COLUMN	MAT'L	MATERIAL	U/	UNDER	DIMENSION OF 2'-0".	OTHERWISE NOTED.
CONC	CONCRETE	MAS	MASONRY	UTIL	UTILITY	15. FIRE BLOCKING SHALL BE INSTALLED PER SECTIONS R314.8, R602,	32. ALL WORK, AS EITHER IMPLIED OR REASONABLY INFERABLE F
CONSTR	CONSTRUCTION	M.L.	MICRO-LAM	UNEX.	UNEXCAVATED	R1001.16 OF THE RESIDENTIAL CODE OF N.Y.S FIRE BLOCKING SHALL	THE CONTRACT DOCUMENTS, DRAWINGS AND SPECIFICATION
CONT	CONTINOUS	M.O.	MASONRY OPENING			BE PROVIDED IN CONCEALED WALL AND STAIR SPACES AT THE FLOOR AND CEILING (ALSO 1/2" GWB ON UNDERSIDE OF STAIRS IN ENCLOSED	SHALL BE THE RESPONSIBILITY OF THE CONTRACTOR UNLESS OTHERWISE NOTED IN WRITING. ALL DRAWINGS AND SPECIFIC
CONTR	CONTRACTOR	MT	MARBLE THRESHOLD	VAN	VANITY	ACCESSIBLE SPACES), HORIZ. FURRED SPACES AT INTERVALS NOT	ARE DIRECTED TO THE ATTENTION OF THE CONTRACTOR AND
CRS	COURSES	MFR	MANUFACTURER	V.I.F.	VERIFY IN FIELD	EXCEEDING 10 FT., CONCEALED JOIST SPACES AT BEAMS AND BEARING WALLS.	INCLUSION OF ANY WORK BY MENTION, NOTE, DETAIL, ITEMIZA OR IMPLICATION, HOWEVER BRIEF, MEANS THAT THE CONTRA
		MAX.	MAXIMUM	VERT	VERTICAL	BLANING WALLS.	SHALL INCLUDE ALL APPURTENANCES AND APPARATUS NORM DEEMED TO BE A PART OF A COMPLETED PACKAGE WITH IN THE
)	DRYER	MECH	MECHANICAL	VEST	VESTIBULE	16. SMOKE DETECTING ALARM DEVICES SHALL BE DIRECT WIRED AND	DEFINITIONS OF NORMAL INDUSTRY STANDARDS.
OC .	DOWNSPOUT COLLECTOR	MTL	METAL			CONFORM TO SECTION R313 OF THE RESIDENTIAL CODE OF N.Y.S.	
).V.	DIRECT VENT	MIN.	MINIMUM	W	WASHER	17. CARBON MONOXIDE DETECTORS (DIRECT WIRED) SHALL BE	 THE CONTRACTOR SHALL FAMILIARIZE THEMSELVES WITH THE PROJECT THROUGH INSPECTION OF THE SITE, DRAWINGS, AN
DW .	DISH WASHER	MISC.	MISCELLANEOUS	WC	WATER CLOSET	INSTALLED ON EACH STORY CONTAINING A SLEEPING AREA (SUCH DEVICE BEING LOCATED WITHIN 15 FEET OF THE SLEEPING AREA) AND	SPECIFICATIONS, SO AS TO THOROUGHLY UNDERSTAND THE
DIA	DIAMETER	ee.		WD	WOOD	ON EACH STORY THAT CONTAINS A CARBON MONOXIDE SOURCE.	ANY AND ALL DISCREPANCIES AND OMISSIONS SHALL BE REP TO THE ARCHITECT PRIOR TO COMMENCEMENT OF ANY WORI
)H	DOUBLE HUNG	N.I.C.	NOT IN CONTRACT	WH	WATER HEATER	R313.4.2	THE RESPONSIBILITY OF THE CONTRACTOR TO INSURE THAT
						18. EQUIPMENT AND APPLIANCES HAVING AN IGNITION SOURCE SHALL BE	DISCREPANCIES OR OMISSIONS ARE REPORTED AND CLARIFIC OBTAINED FROM THE ARCHITECT PRIOR TO WORK BEING DON
OBL	DOUBLE	NTS	NOT TO SCALE	W/	WITH	ELEVATED SUCH THAT THE IGNITION IS NOT LESS THAN 18 INCHES	WORK THAT PROCEEDS OTHERWISE SHALL BE, IF INCORRECT
DET	DETAIL	NOM	NOMINAL	W.I.C.	WALK IN CLOSET	ABOVE THE FLOOR IN HAZARDOUS LOCATIONS AND PRIVATE GARAGES. APPLIANCES LOCATED IN PRIVATE GARAGES SHALL BE	PERFORMED, REPLACED OR REPAIRED WITH THE COST FOR S BEING BORNE BY THE CONTRACTOR. CONTRACTOR SHALL VI
DEMO	DEMOLITION			WGT	WEIGHT	INSTALLED WITH A MINIMUM CLEARANCE OF 6' FEET ABOVE THE	ALL DIMENSIONS FOR ACCURACY & COORDINATION PRIOR TO
)F	DRINKING FOUNTAIN	0/	OVER	W/O	WITH OUT	FLOOR OR PROVIDE PROTECTION FROM MOTOR VEHICLE IMPACT. PER SECTION G2408 (305) OF THE RESIDENTIAL CODE OF N.Y.S.	COMMENCING WORK.
N	DOWN	O.C.	ON CENTER	W.W.M.	WIRE MELDED MESH		34. THE CONTRACTOR SHALL NOTIFY THE ARCHITECT OF ANY AN
)R	DOOR	OPT.	OPTIONAL			19. PROVIDE 22" x 30" MINIMUM SCUTTLE OPENING WITH 30" MIN.HEAD ROOM TO ROOF CAVITIES THAT EXCEED 30 SF WITH OPENING	DISCREPANCIES BETWEEN FIELD CONDITIONS AND THE CONT DOCUMENTS BEFORE PROCEEDING WITH THAT PORTION OF T
)WG	DRAWING	OHD	OVERHEAD DOOR			LOCATED IN ACCESSIBLE AREA PER SECTION R807.	WORK. FAILURE TO NOTIFY THE ARCHITECT OF DISCREPANCII
DIM	DIMENSION	O.D.	OUT SIDE DIAMETER				NOT RELIEVE THE CONTRACTOR OF RESPONSIBILITY TO COMI
		OPNG	OPENING			 GLAZING TO BE TEMPERED WHERE SILL IS BELOW 18" ABOVE THE ADJACENT FLOOR. 	WITH THE DOCUMENTS. THE CONTRACTOR SHALL CORRECT A ALL WORK ARISING FROM SUCH FAILURE AND COORDINATE
LECT	ELECTRIC						DISCREPANCIES TO THE SATISFACTION OF ARCHITECT WITHO
ELEV	ELEVATOR	PLT	PLATE			21. PORCHES, BALCONIES, AND RAISED FLOORS GREATER THAN 30" ABOVE FLOOR OR GRADE SHALL HAVE A HALF WALL OR RAILING	ADDITIONAL COST TO THE OWNER.
EQ	EQUAL	PWDR	POWDER ROOM			ABOVE FLOOR OR GRADE SHALL HAVE A HALF WALL OR RAILING GUARD 36" MIN. HEIGHT. (R315)	35. IF ANY CONFLICTS OCCUR BETWEEN THE NOTES, SPECIFICAT
EQUIP	EQUIPMENT	PLUMB	PLUMBING				AND DETAILS, THE CONTRACTOR SHALL NOTIFY THE ARCHITE REQUEST CLARIFICATION.
ST	ESTIMATE	PLUMB	PAINT			STAIRWAYS PER R311.5 - CLOSED RISERS UNLESS NOTED OTHER WISE.	ALGOLO, OD WAI TOTATION.
			PAINT POINT LOAD			- CLOSED RISERS UNLESS NOTED OTHER WISE. - 6'-8" MIN. HEAD ROOM ABOVE NOSING.	36. DETAILS AND SECTIONS SHOWN ON DRAWINGS ARE TYPICAL
EXC	EXCAVATE	PT. LD.				- 7 ¾" MAXIMUM RISER HEIGHT.	APPLY TO LOCATIONS OTHER THAN WHERE SPECIFICALLY MA ON THE PLANS. IF SECTIONS OR DETAILS DO NOT REPRESENT
EXIST	EXISTING	PLWD	PLYWOOD			- 10" MINIMUM TREAD DEPTH. PROVIDE HANDRAILS FOR (2) OR MORE RISERS 1 1/4", 2" DIA WITH	REQUIRED CONDITIONS, THE ARCHITECT SHALL BE CONTACTE
EXP	EXPANSION	PR	PAIR			 PROVIDE HANDRAILS FOR (2) OR MORE RISERS, 1 1/4" - 2" DIA. WITH ONE SIDE CONTINUOUS FROM TOP TO BOTTOM RISER, RETURN TO 	CLARIFICATION BY THE GENERAL CONTRACTOR.
EXT	EXTERIOR	PSF	POUNDS PER SQ. FT.			WALL OR NEWEL POST. 34" - 38" IN HEIGHT ABOVE NOSING W/ 1 1/2"	37. MECHANICAL, ELECTRICAL AND PLUMBING DESIGN SHALL BE
		PSI	POUNDS PER SQ. IN.			CLEARANCE TO WALL OR OBSTRUCTION OPEN SIDES OF STAIRS GREATER THAN 30" OF HEIGHT SHALL HAVE	DETERMINED BY THE GENERAL CONTRACTOR ON A "DESIGN B BASIS. THEREFORE, IT IS THE GENERAL CONTRACTOR'S
F.F.W.	FROM FRAME WALL					GUARDS 34" MIN. HT. ABOVE NOSING.	RESPONSIBILITY TO COORDINATE THE ROUTING OF THESE TR
FD	FLOOR DRAIN	QT	QUARRY TILE			22. DAILINGS OF BISED OFFNINGS SHALL NOT BERNITTHE BASSING OF	TO ASSURE THAT THESE SYSTEMS DO NOT CONFLICT WITH THE ARCHITECTURAL AND STRUCTURAL ELEMENTS OF THE BUILD
-DN	FOUNDATION	QTY	QUANTITY			22. RAILINGS OR RISER OPENINGS SHALL NOT PERMIT THE PASSING OF A 4" SPHERE & 6" OPENING IS PERMITTED AT TRIANGULAR OPENING AT	ANOTHER TOTAL AND STRUCTURAL ELEMENTS OF THE BUILD
FF	FINISH FLOOR					RISER, TREAD AND BOTTOM RAIL (R311.5.6.& R312).	
=L	FLUSH	R	RISER				- I woon I I
- ⁻ .J.	FLOOR JOIST	RAD	RADIUS				CLIMATE FENESTRATION SKYLIGHT FENESTRATION U-FACTOR U-FAC
						SNOW Speed DESIGN WEATHERING FROST LINE TERMITE DECAY UNDERLAYMENT HAZARDS DEPTH DEPTH	ZONE U-FACTOR U-FACTOR SHGC R-VALUE R-VALUE R-VALUE
						40 00 B SEVERE 42" SLIGHT TO NONE TO VES NO	20 OR 13/17

LIST OF DRAWINGS

COVER SHEET SITE PLAN

FOUNDATION FLOOR PLAN

FIRST FLOOR PLAN

SECOND FLOOR & SCREENED PORCH ROOF PLAN

EXTERIOR ELEVATIONS


BUILDING SECTIONS

Residence Brookwood Road sford, New York DiPasquale

o. Revisions/Submissions **PERMIT SET**

SITE PLAN

BROOKWOOD ROAD

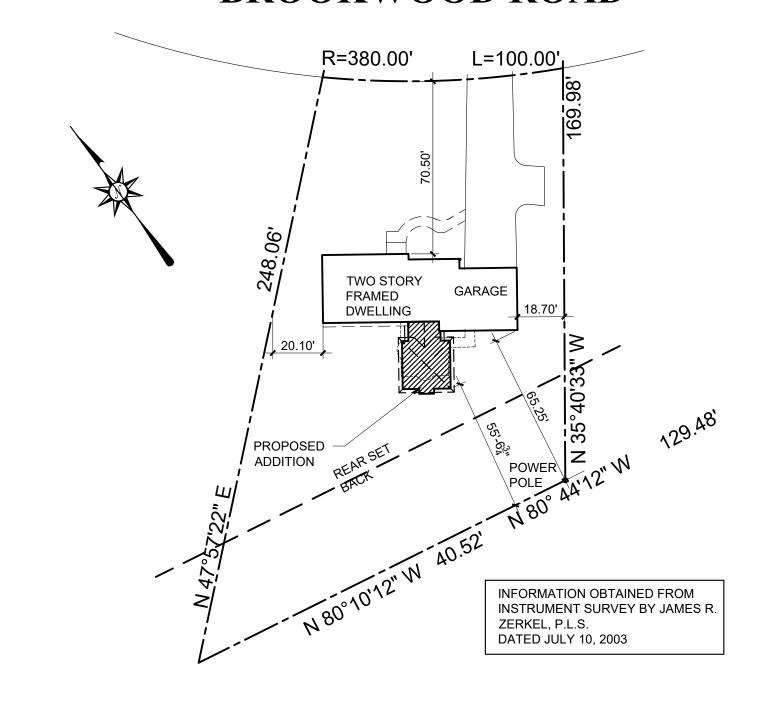

HB CORNERSTONE

99 Garnsey Road, Suite 100 Pittsford, NY 14534 585.419.8800 P + 585.419.8814 F

DJC ARCHITECTURE 99 Garnsey Road, Suite 101

Pittsford, NY 14534 585.419.8800 P + 585.419.8814 F

WARNING
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Drawing Title

COVER SHEET

Project No:


Scale: AS NOTES

Date: 2-27-21

Drawing No. G001

Sheet # of #

BROOKWOOD ROAD

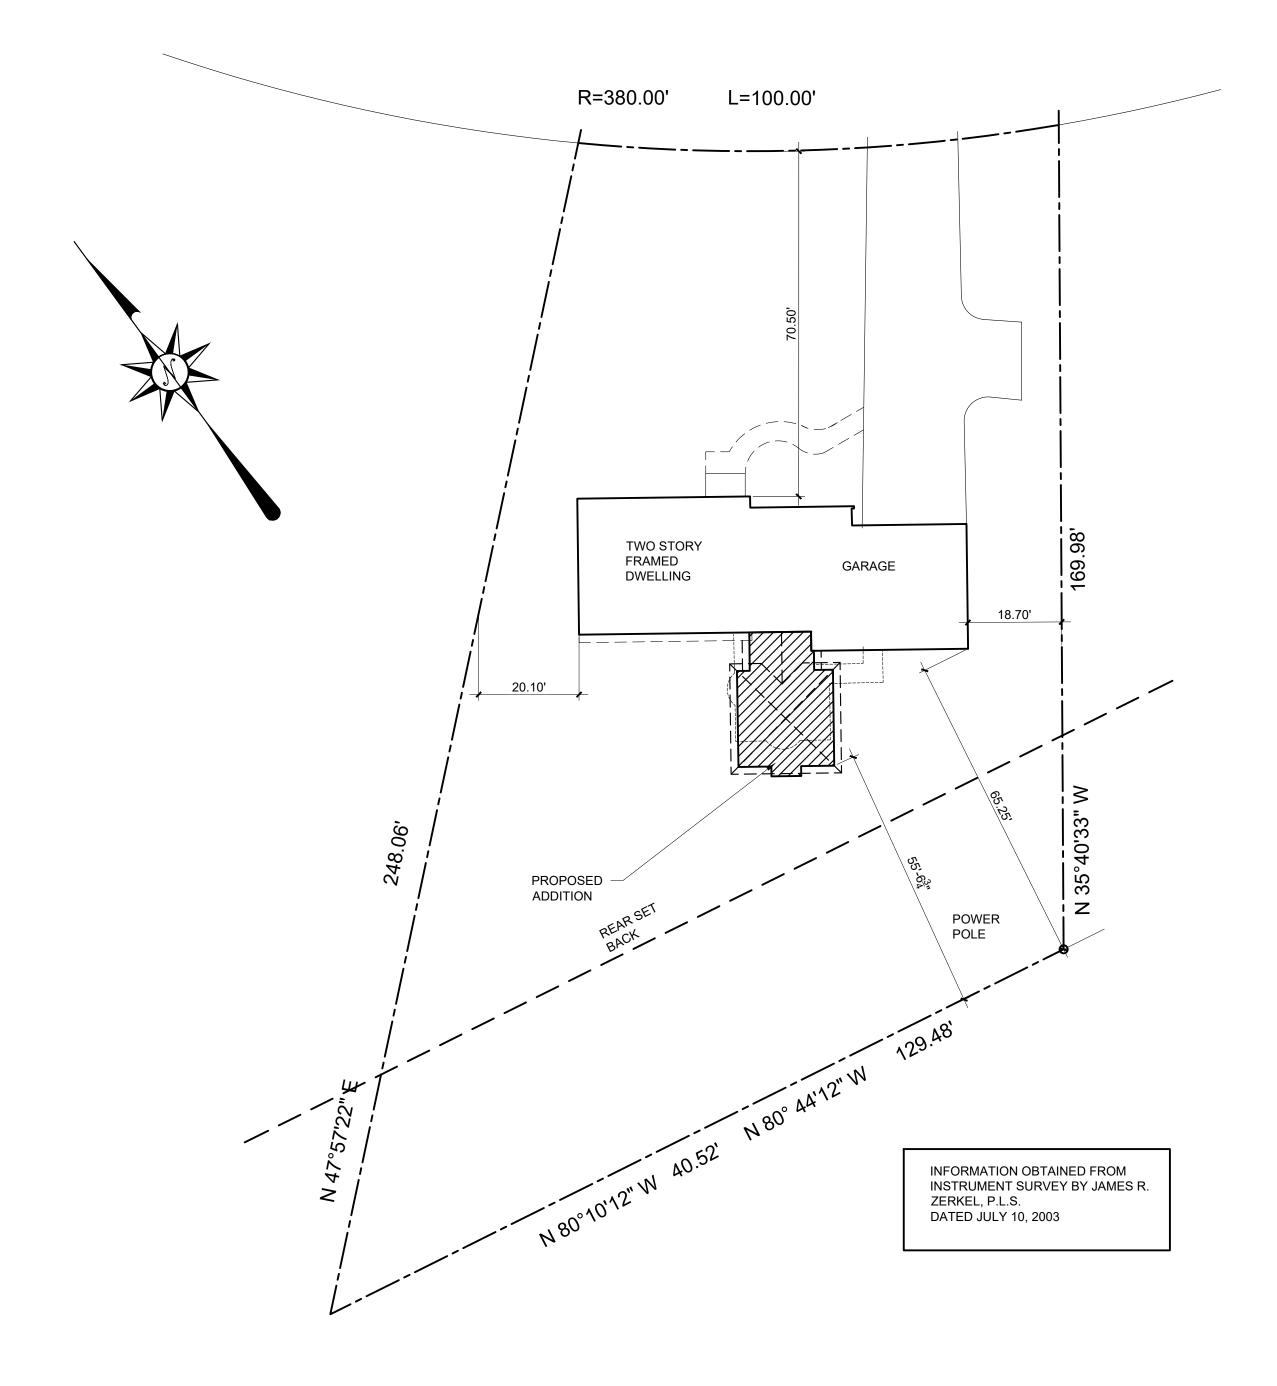

1 SITE PLAN
G002 Scale: 1" = 20'-0"

DiPasquale Residence

isions/Submissions Date

PERMIT SET _-_-21

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REPRODUCE THESE DRAWINGS IN

Drawing Title

Site Plan

Project No:


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G002

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Residen

21 Brook Pittsford,

lo. Revisions/Submissions PERMIT SET

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FOUNDATION PLAN

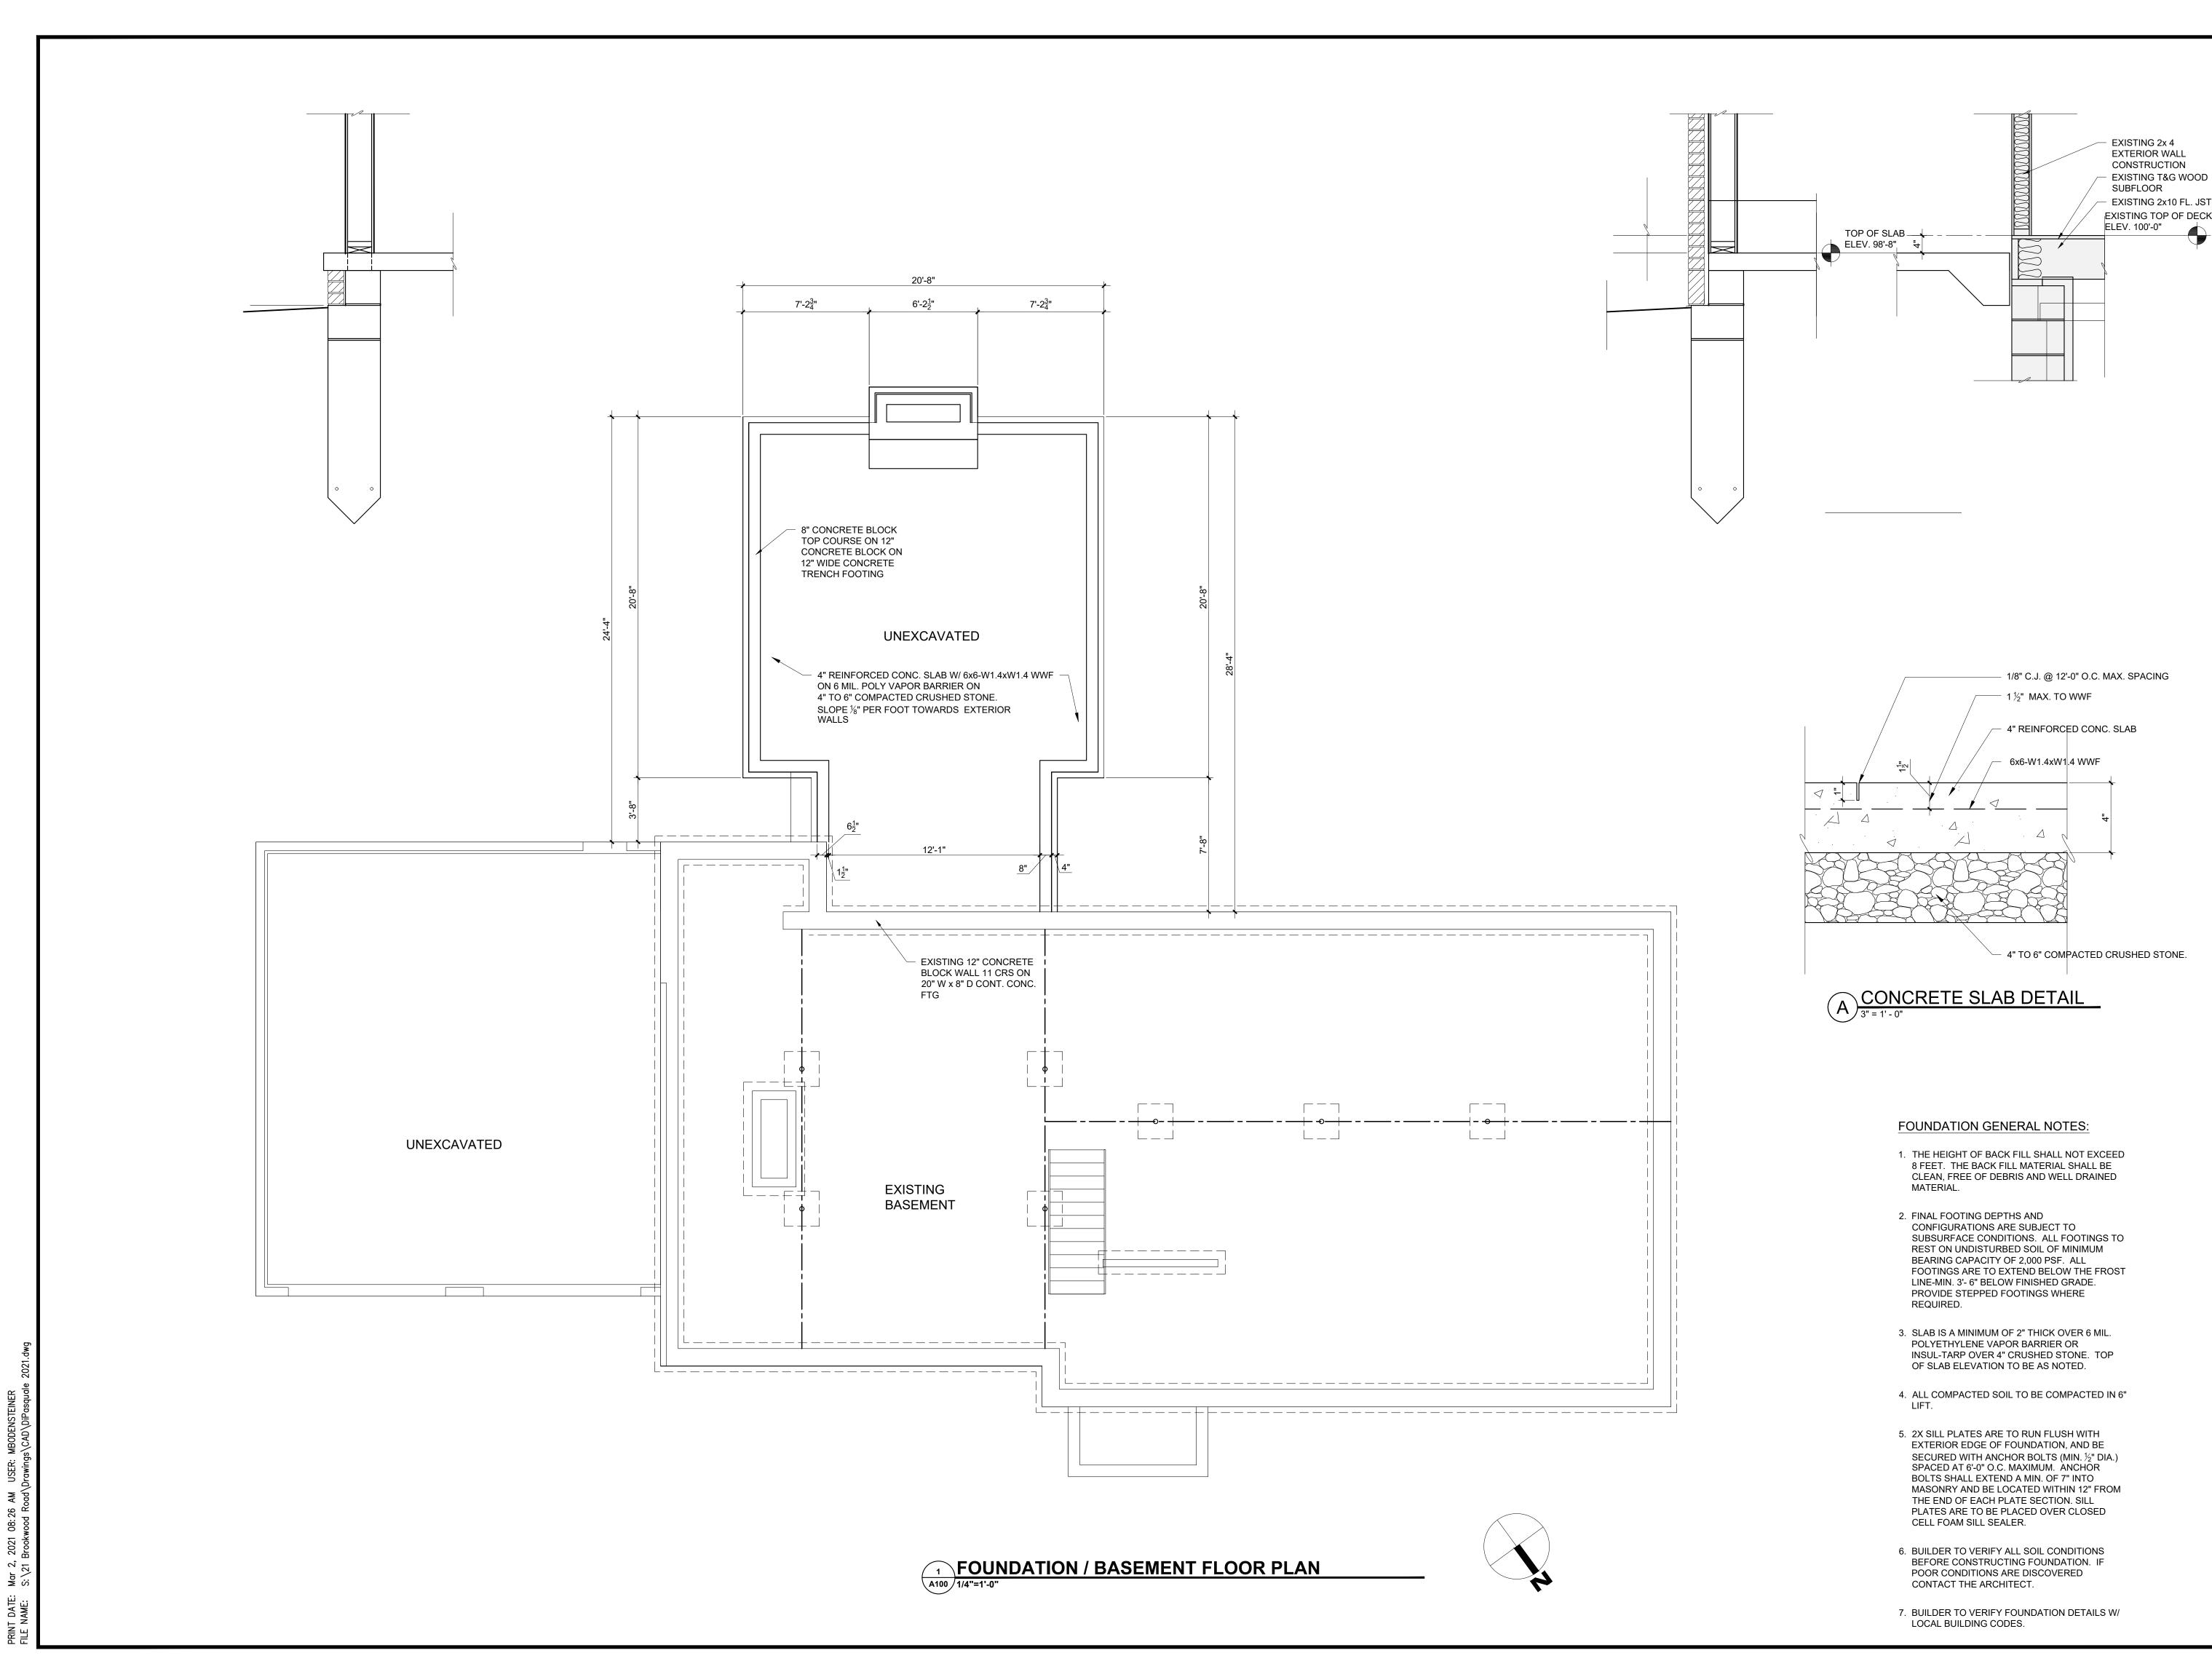Project No:


Drawing Title


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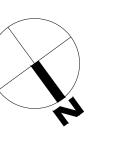
Date: 2-27-21

Drawing No.

Sheet # of #



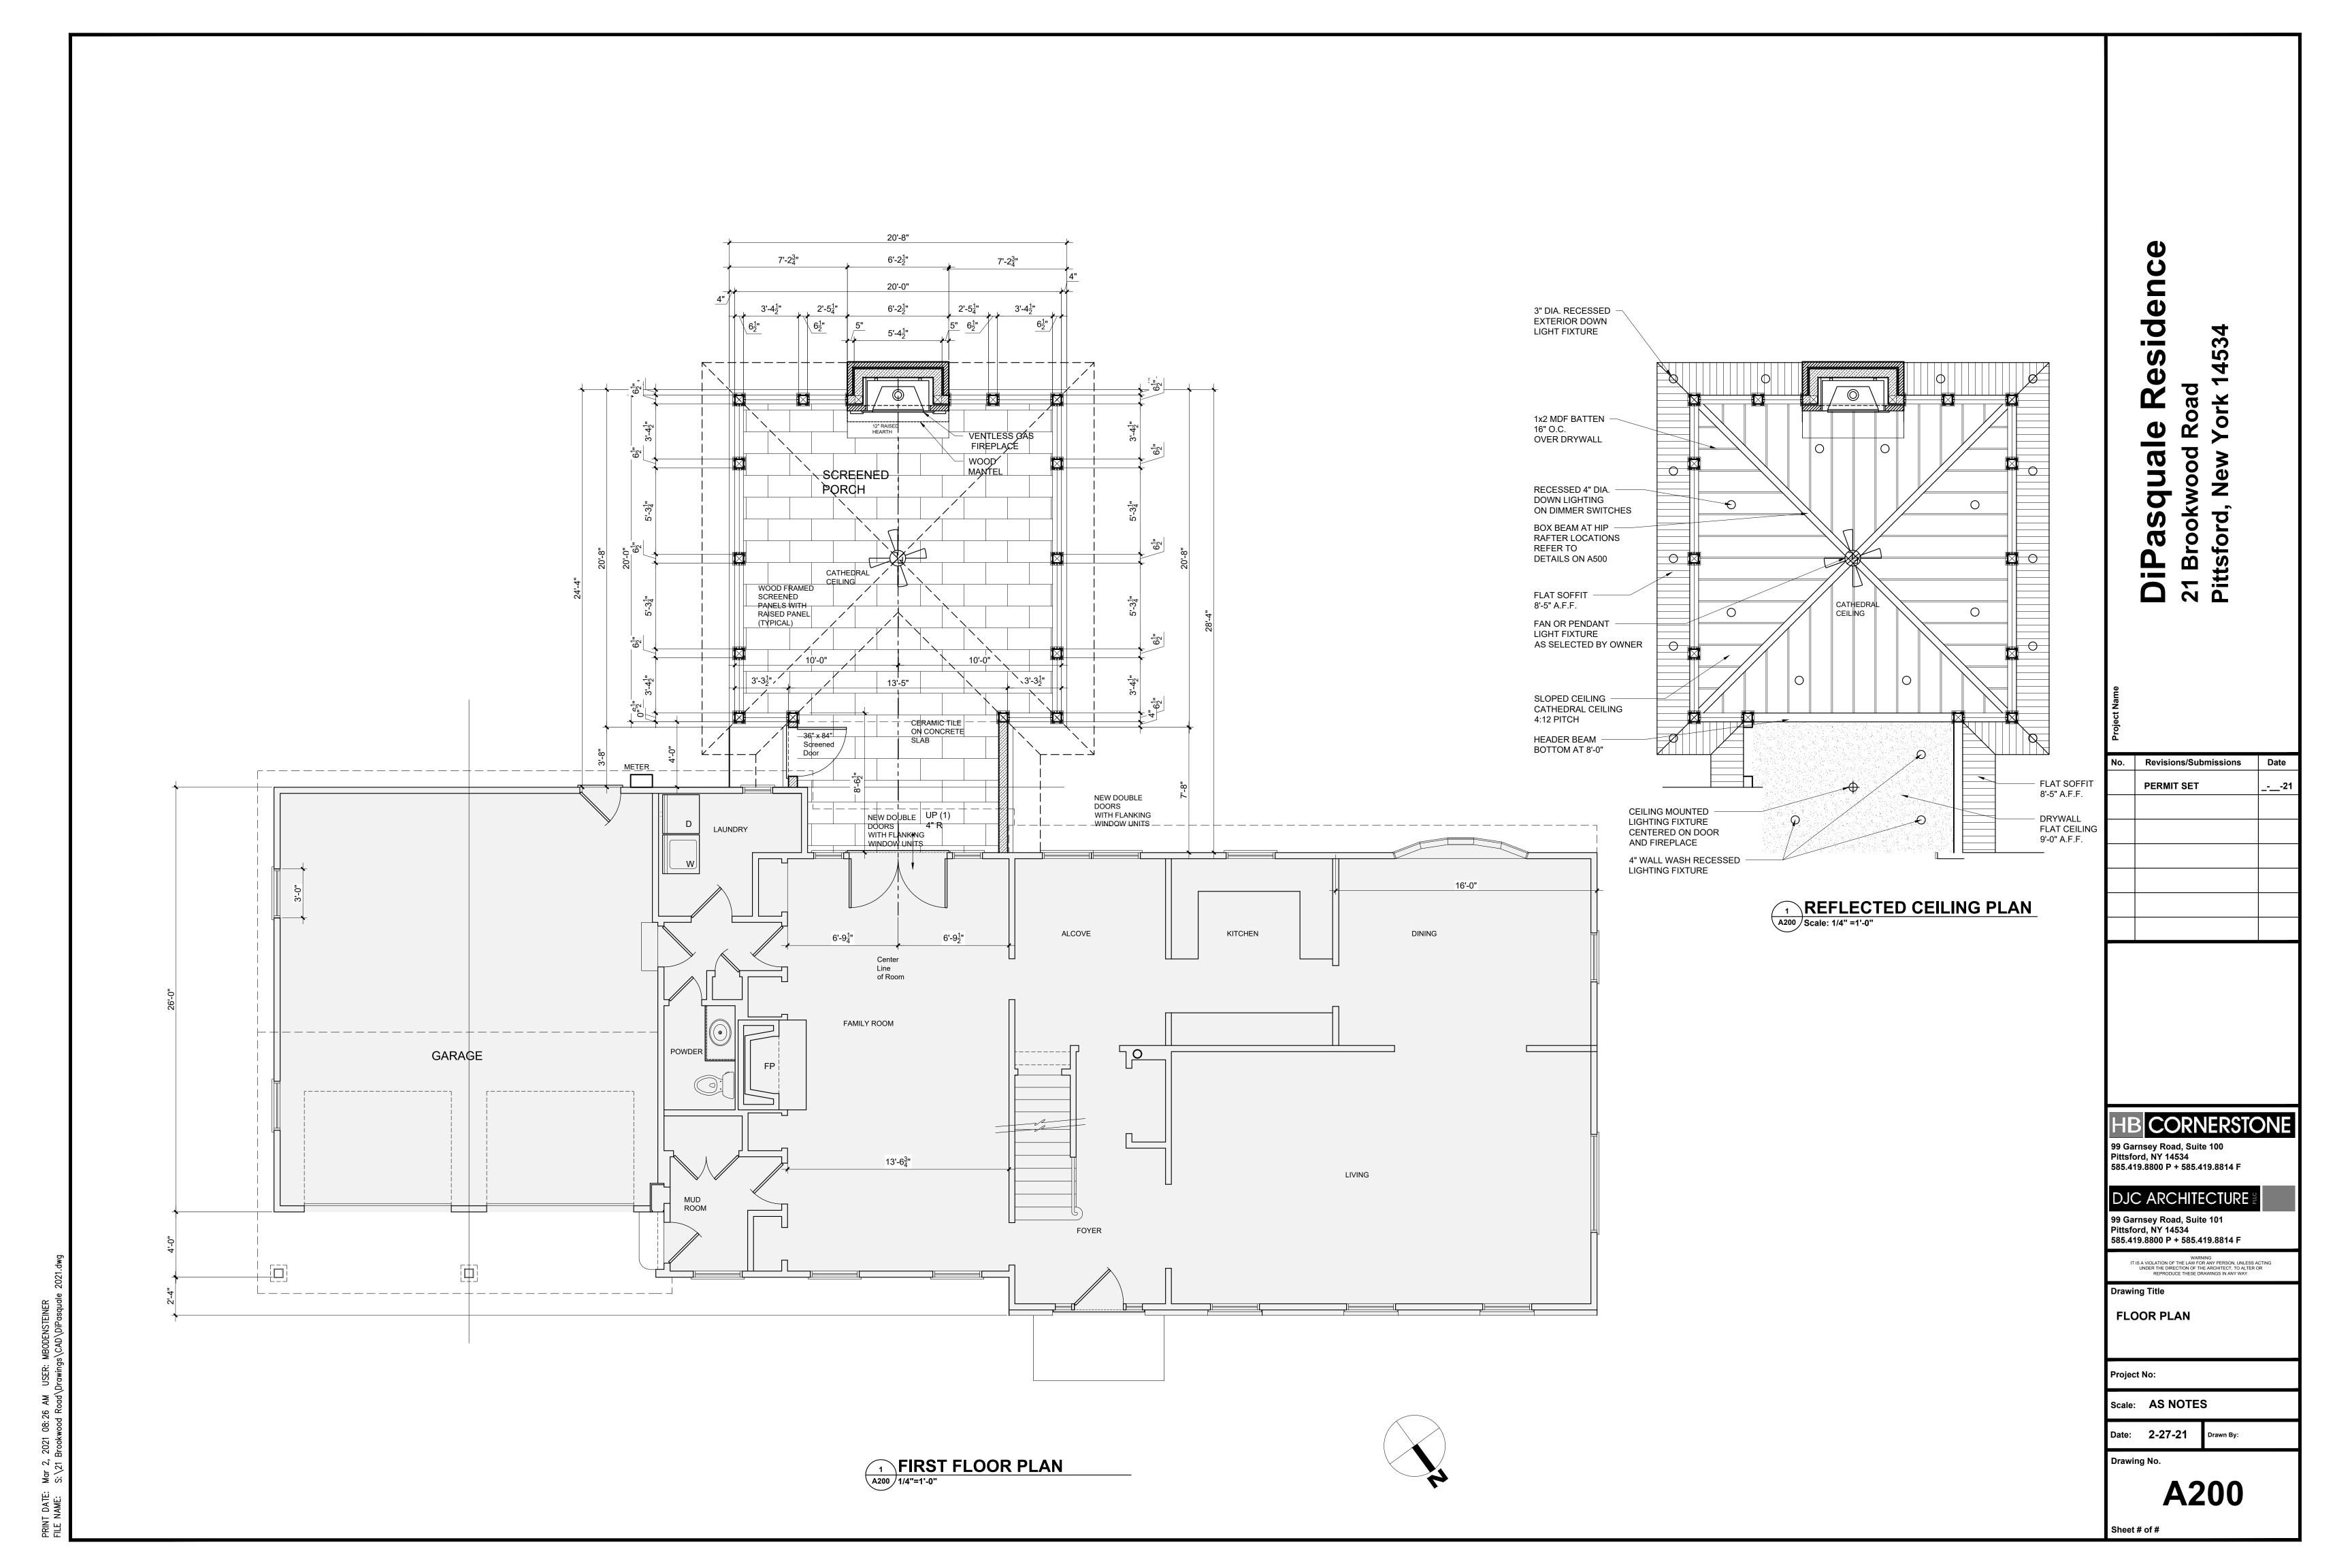

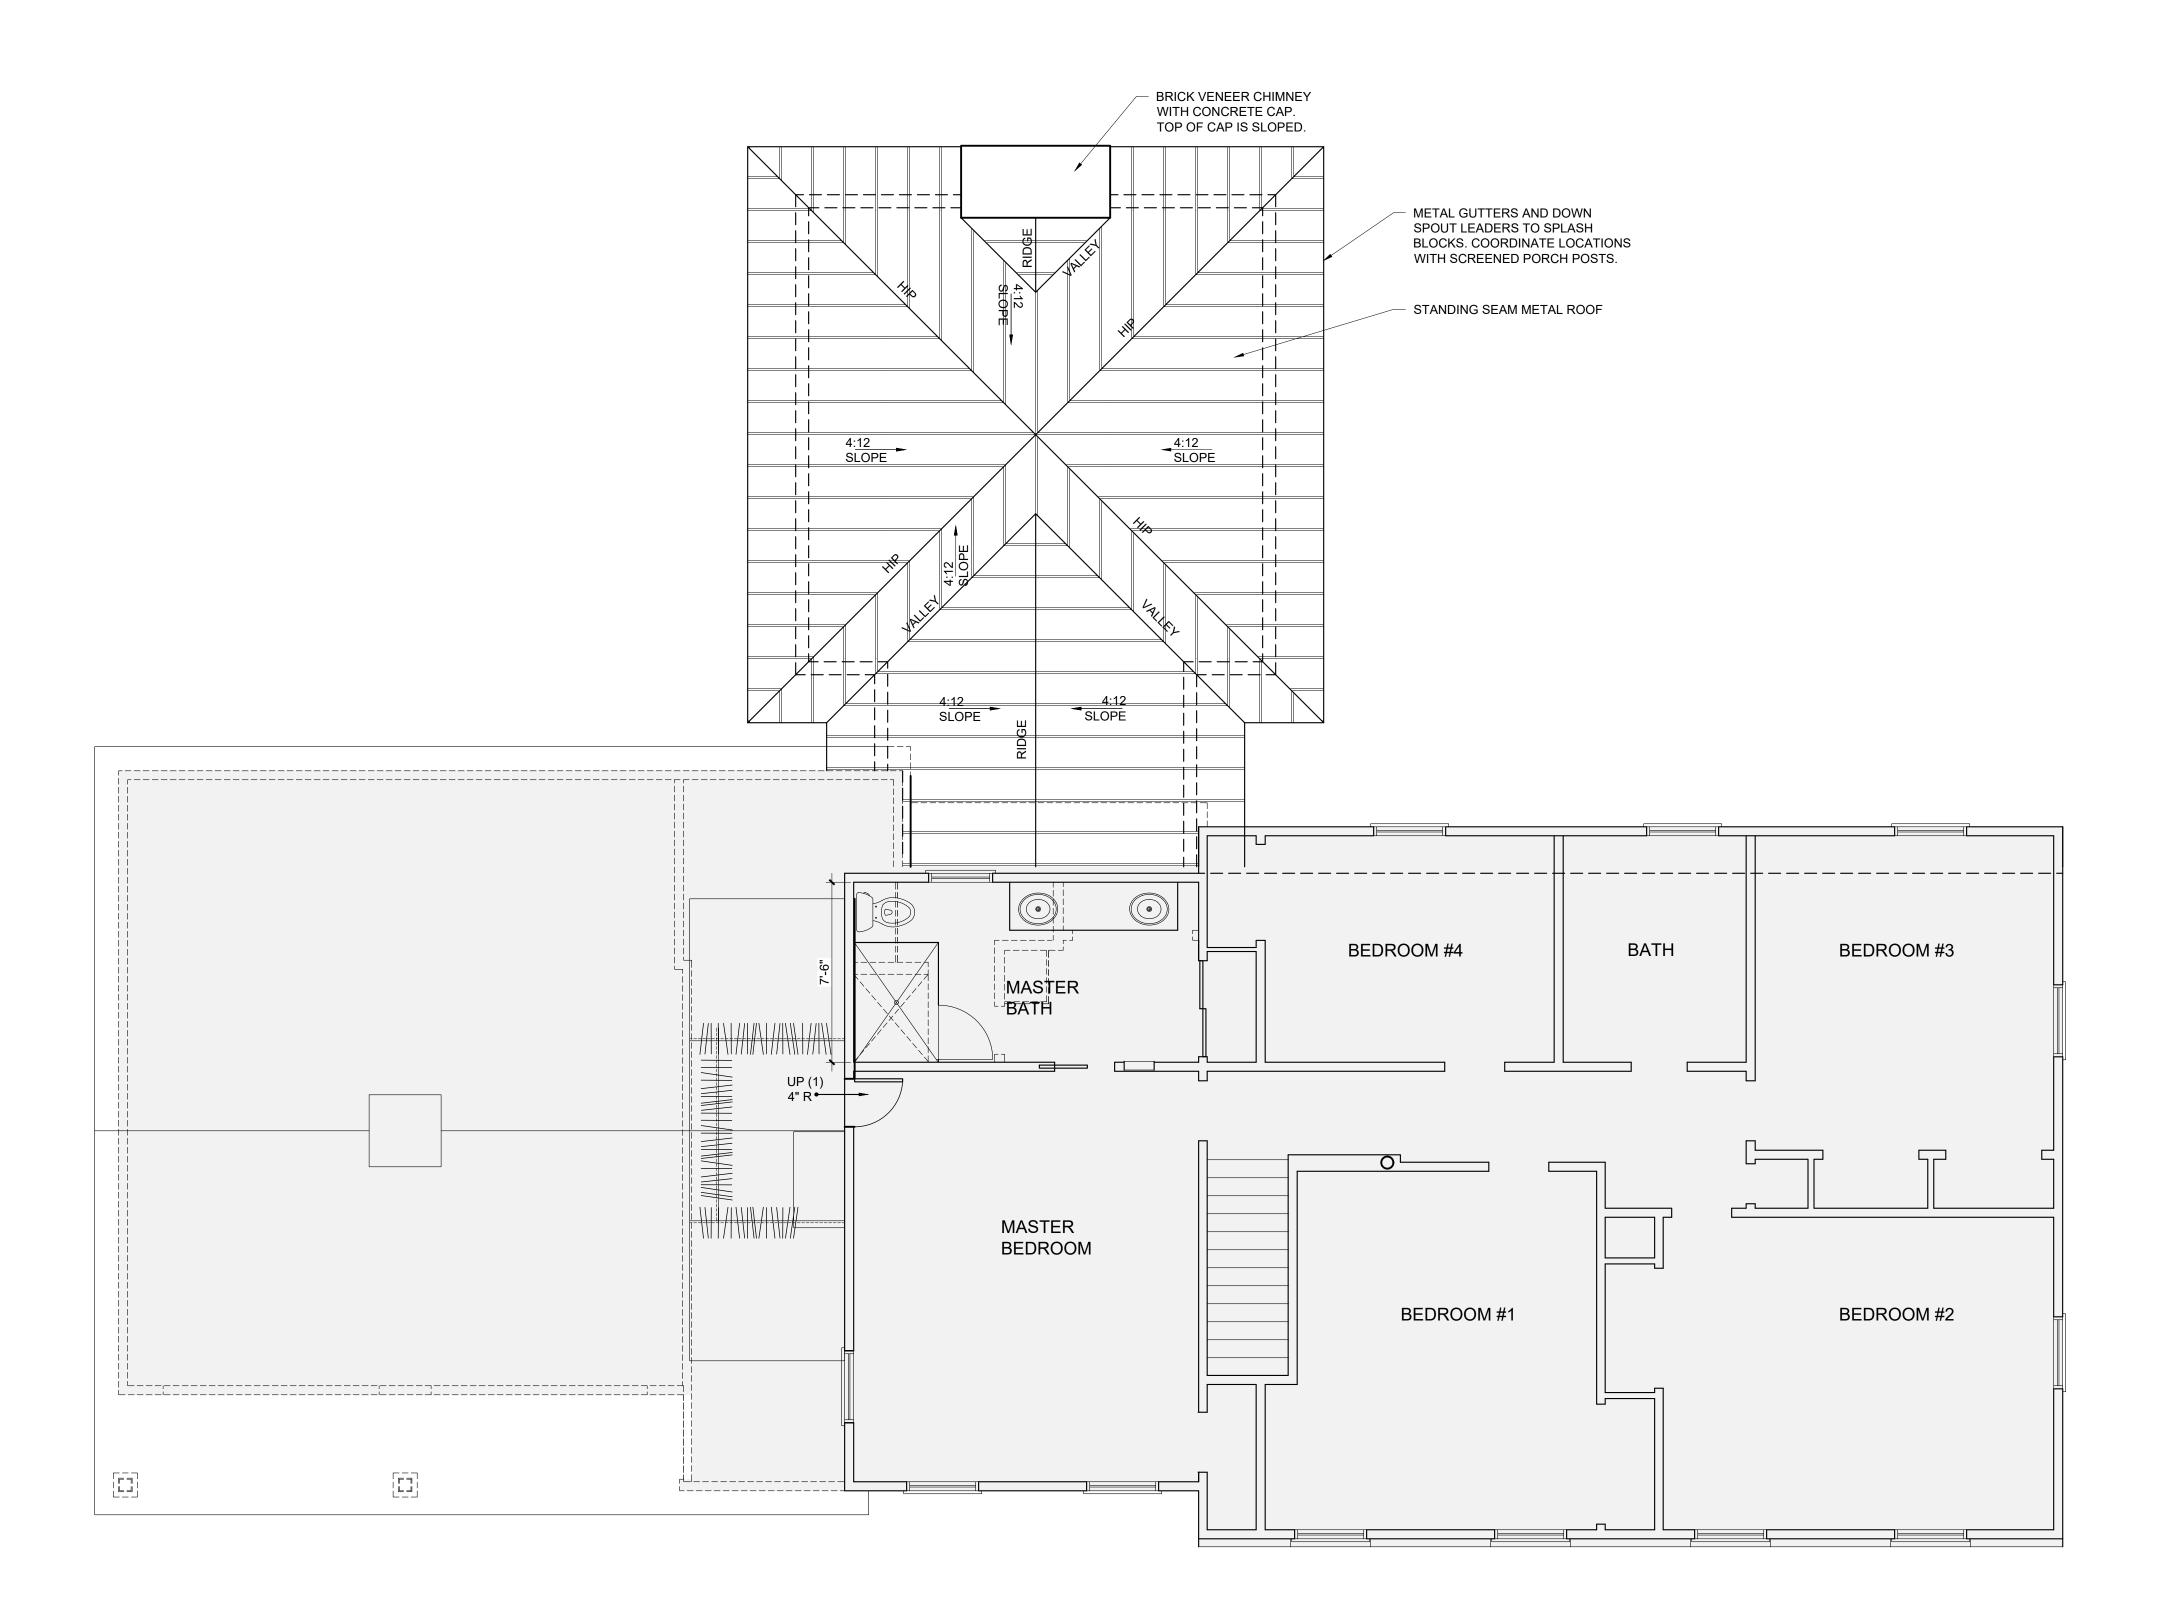

DiPasquale Residence
21 Brookwood Road
Pittsford, New York 14534

No. Revisions/Submissions Date

PERMIT SET _-_-21

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Pittsford, NY 14534
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REPRODUCE THESE DRAWINGS IN ANY WAY.

Drawing Title

SECOND FLOOR PLAN & SCREENED PORCH ROOF PLAN

Project No:

Scale: AS NOTES


Date: 2-27-21 Drawn By

Drawing No.

A300

Sheet # of #


SECOND FLOOR PLAN
A300 1/4"=1'-0"

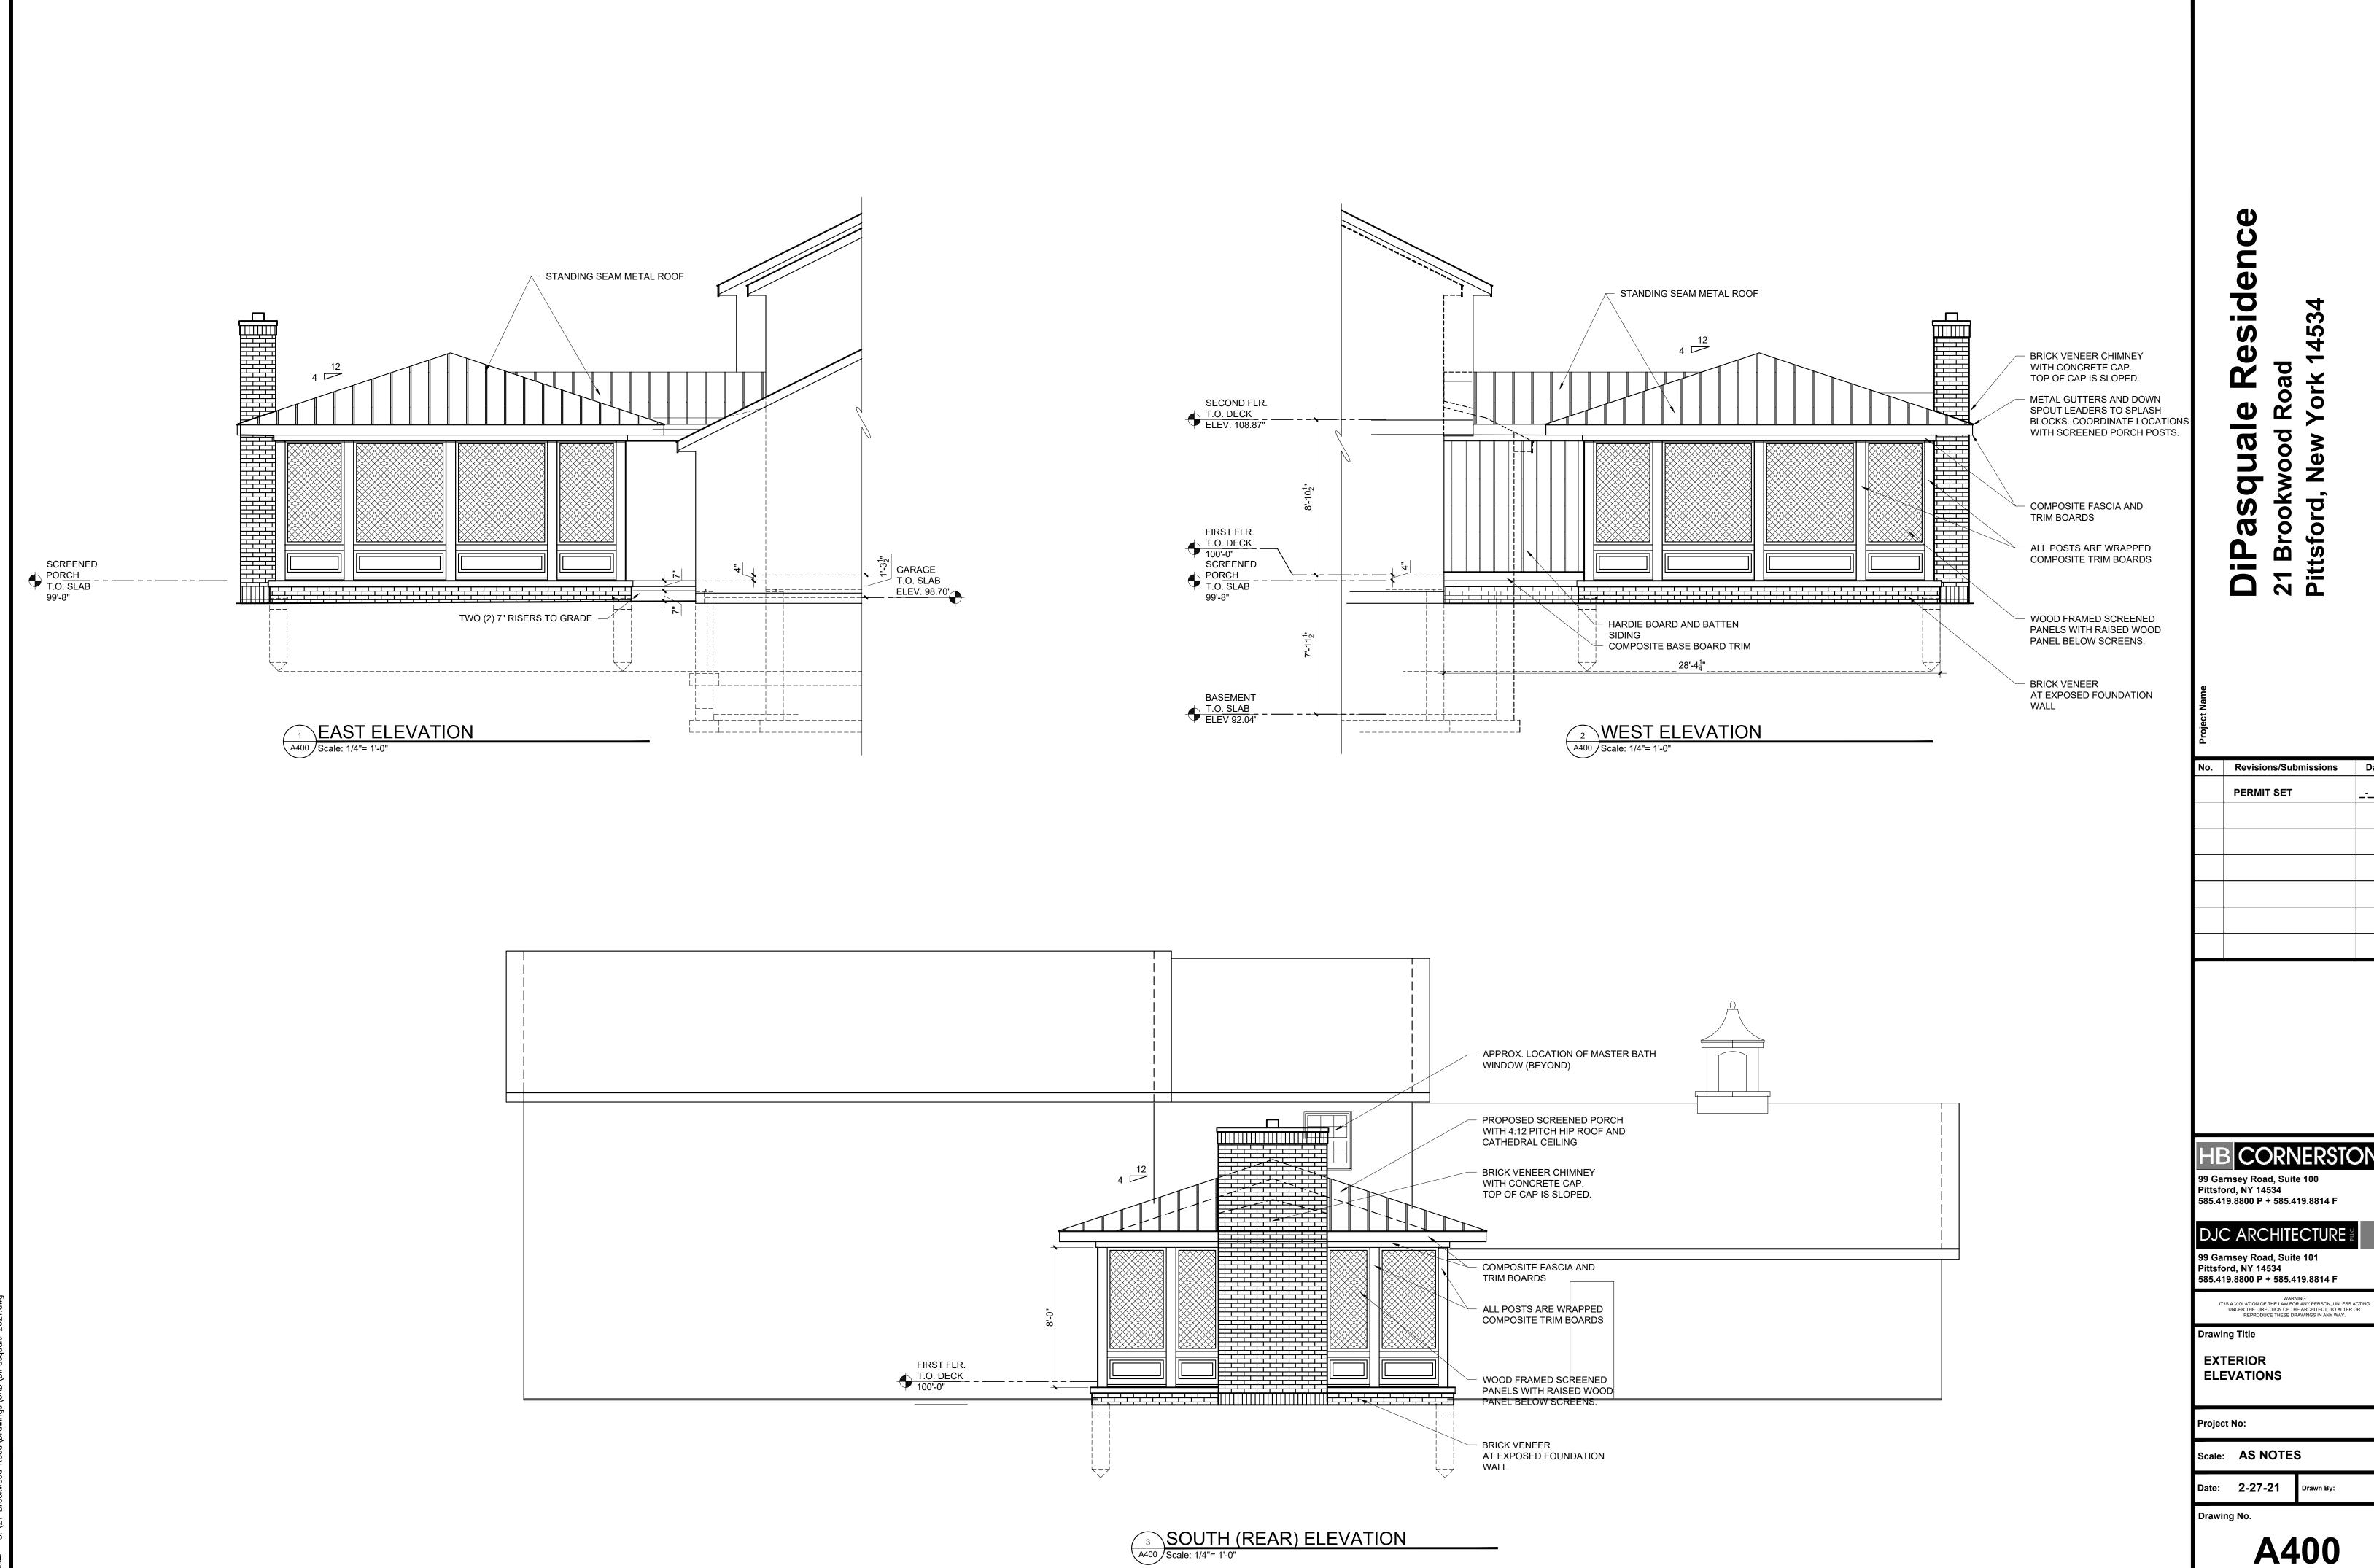

HB CORNERSTONE

A400


Sheet # of #

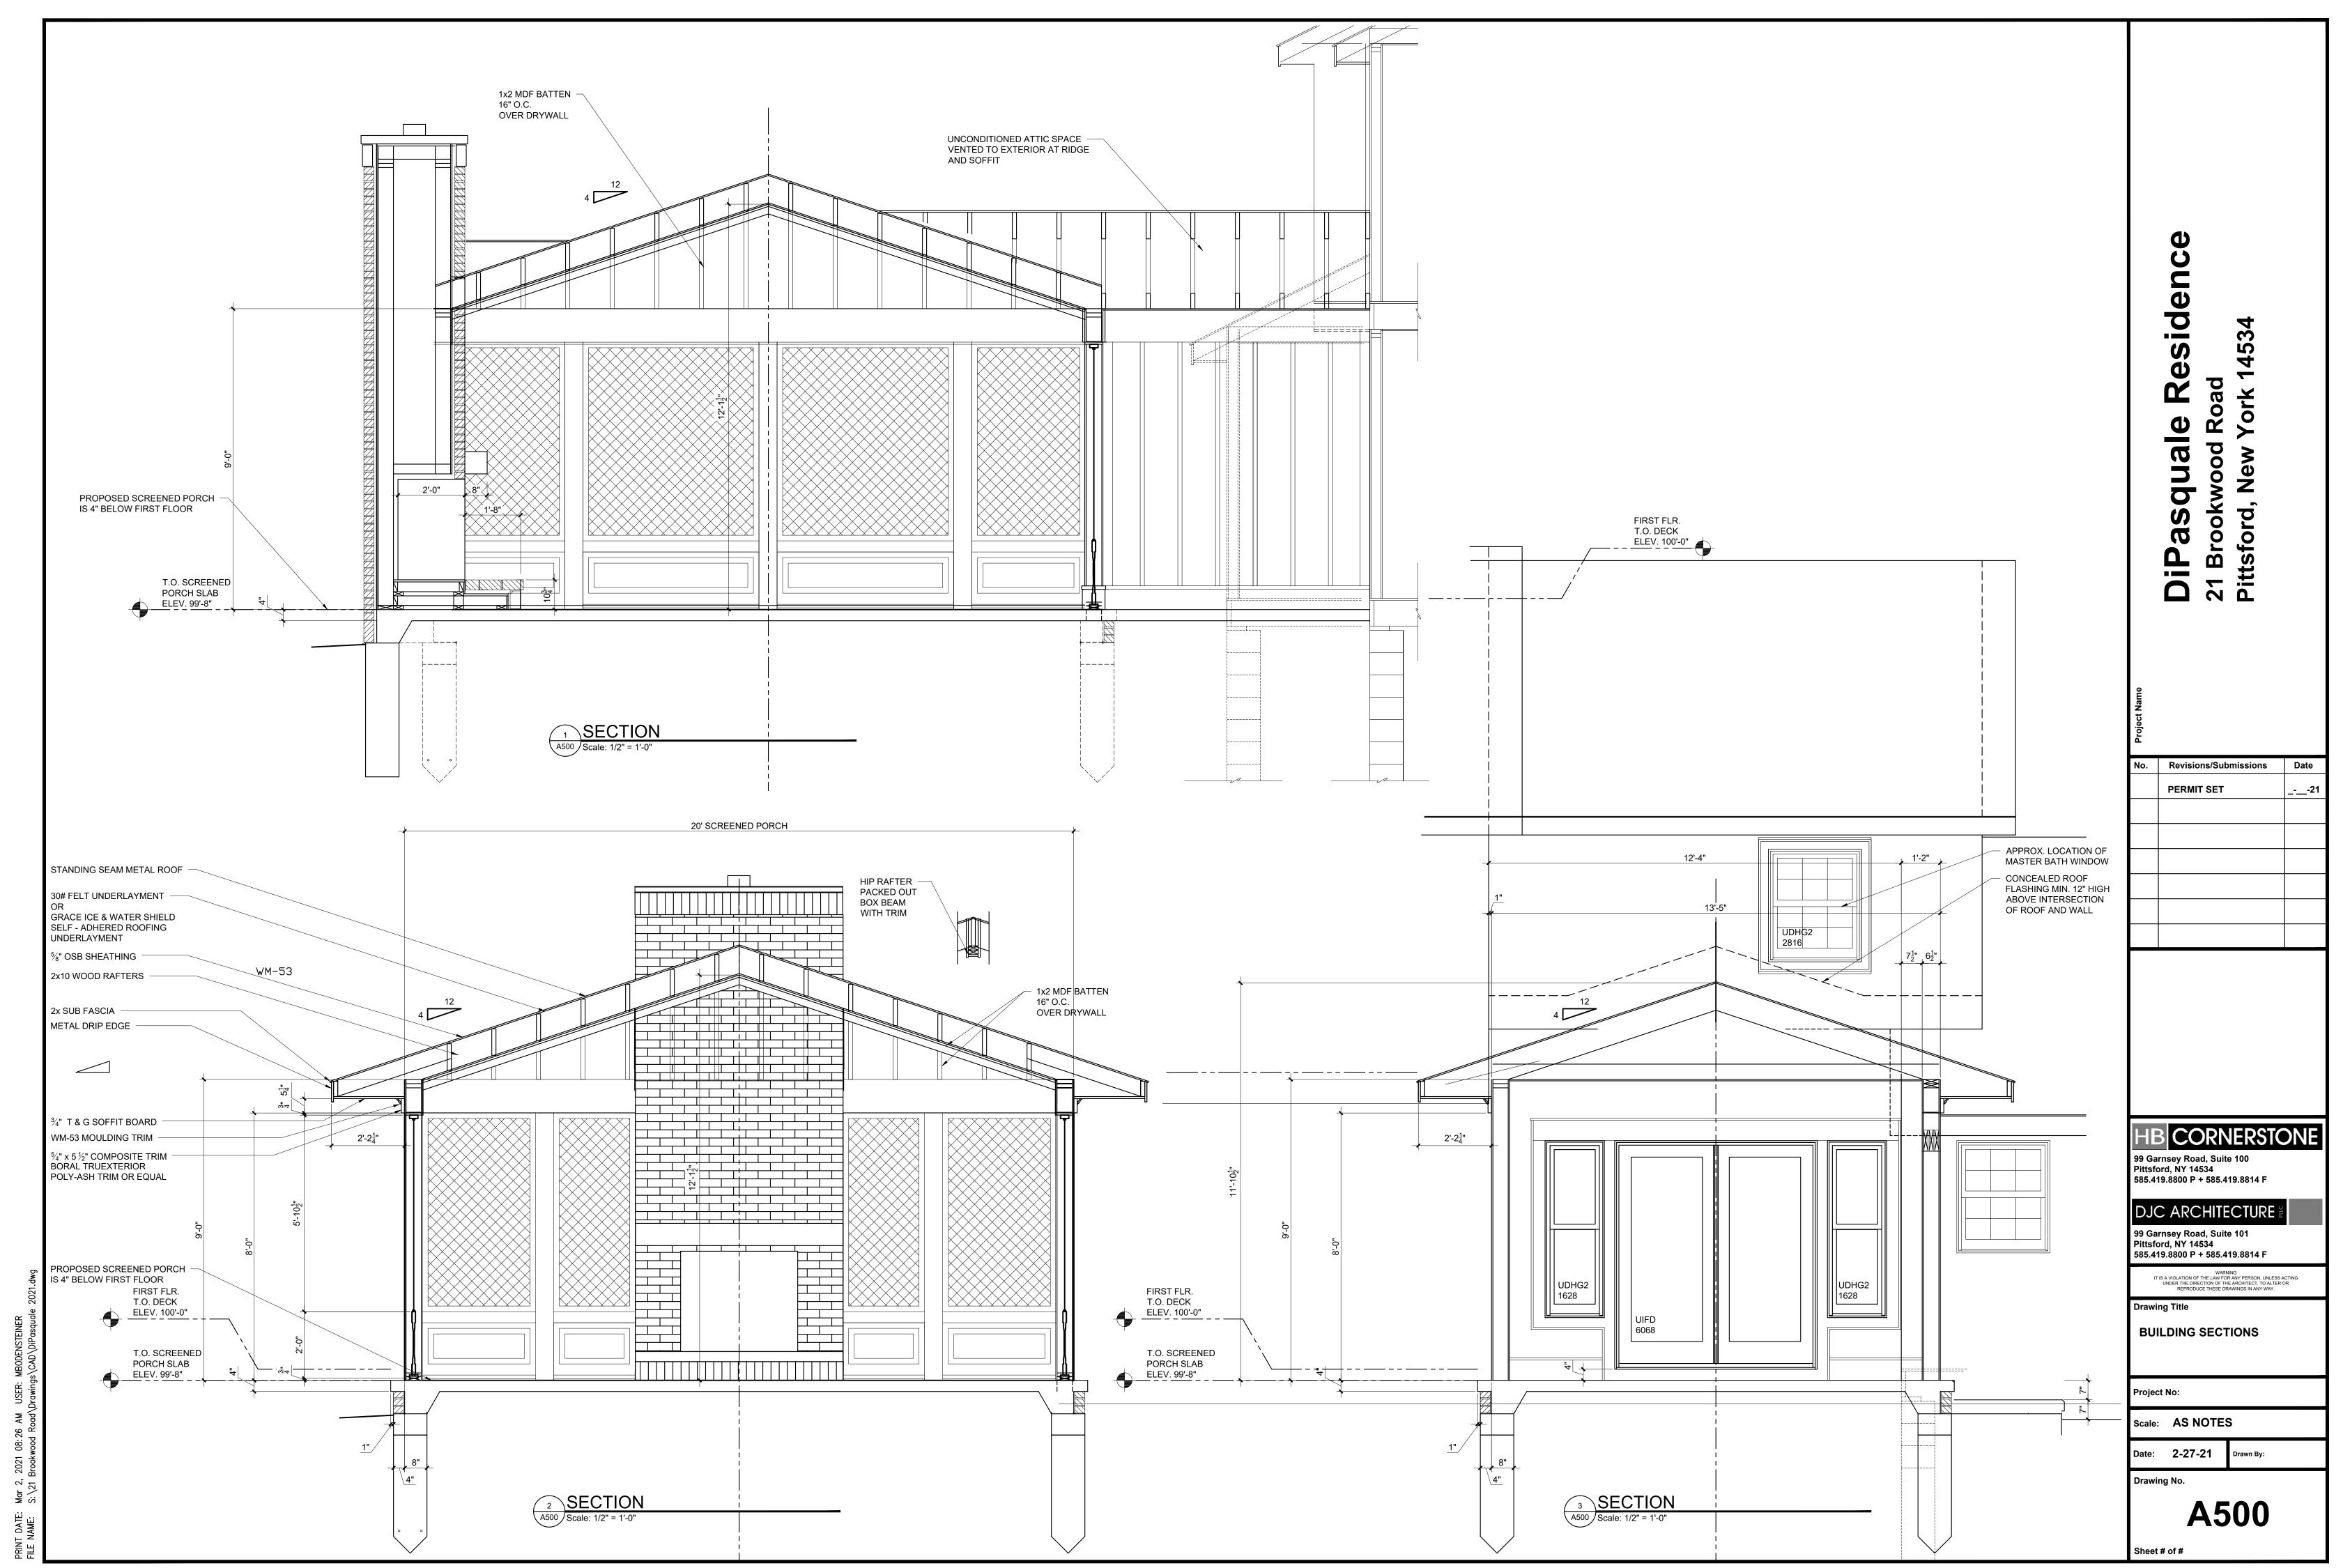







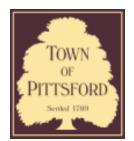

Town of Pittsford

Department of Public Works 11 South Main Street Pittsford, New York 14534

Permit # B21-000039

Phone: 585-248-6250 FAX: 585-248-6262

DESIGN REVIEW AND HISTORIC PRESERVATION BOARD REFERRAL OF APPLICATION

Property Address: 6 Canal Park Place PITTSFORD, NY 14534

Tax ID Number: 150.19-1-5.71

Zoning District: RN Residential Neighborhood

Owner: Cooper, Scott D

Applicant: Josh Lawn Care & Landscaping Co.

App	lication	Type:
		<i>,</i>


✓	Residential Design Review		Build to Line Adjustment
	§185-205 (B)	Ш	§185-17 (B) (2)
	Commercial Design Review		Building Height Above 30 Feet
	§185-205 (B)		§185-17 (M)
	Signage	(Corner Lot Orientation
	§185-205 (C)	Ш	§185-17 (K) (3)
	Certificate of Appropriateness		Flag Lot Building Line Location
	§185-197	Ш	§185-17 (L) (1) (c)
	Landmark Designation		Undeveloped Flag Lot Requirements
	§185-195 (2)	Ш	§185-17 (L) (2)
	Informal Review		

Project Description: Applicant is requesting design review for the covered deck addition and oversized gazebo. The covered deck will be approximately 684 square feet and gazebo will be 450 square feet. The applicant appeared before the Zoning board of appeals and was granted a variance for side setback and oversized accessory structure.

Meeting Date: March 11, 2021



RN Residential Neighborhood Zoning

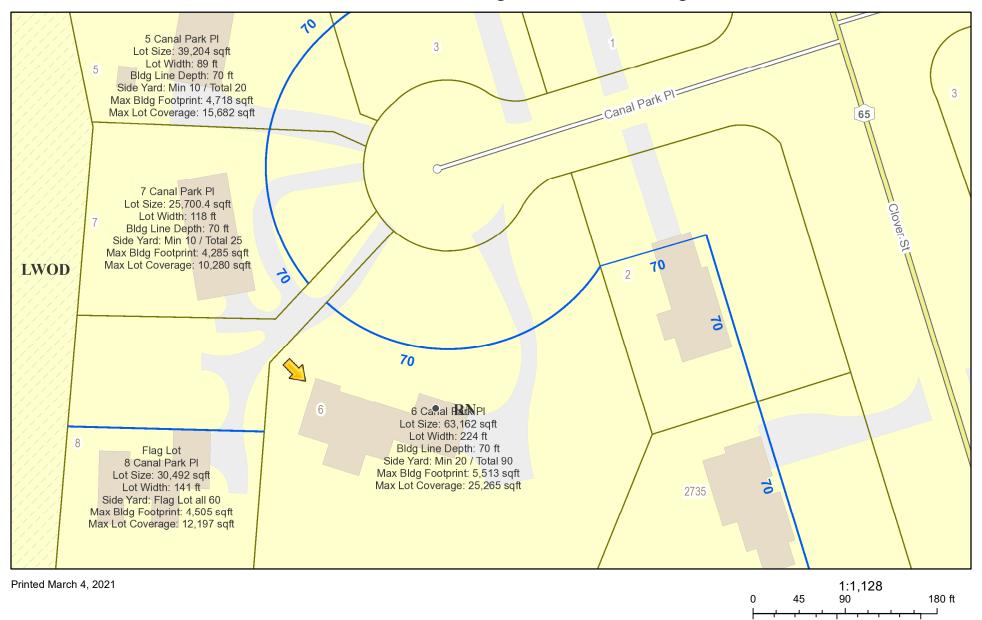


Town of Pittsford GIS

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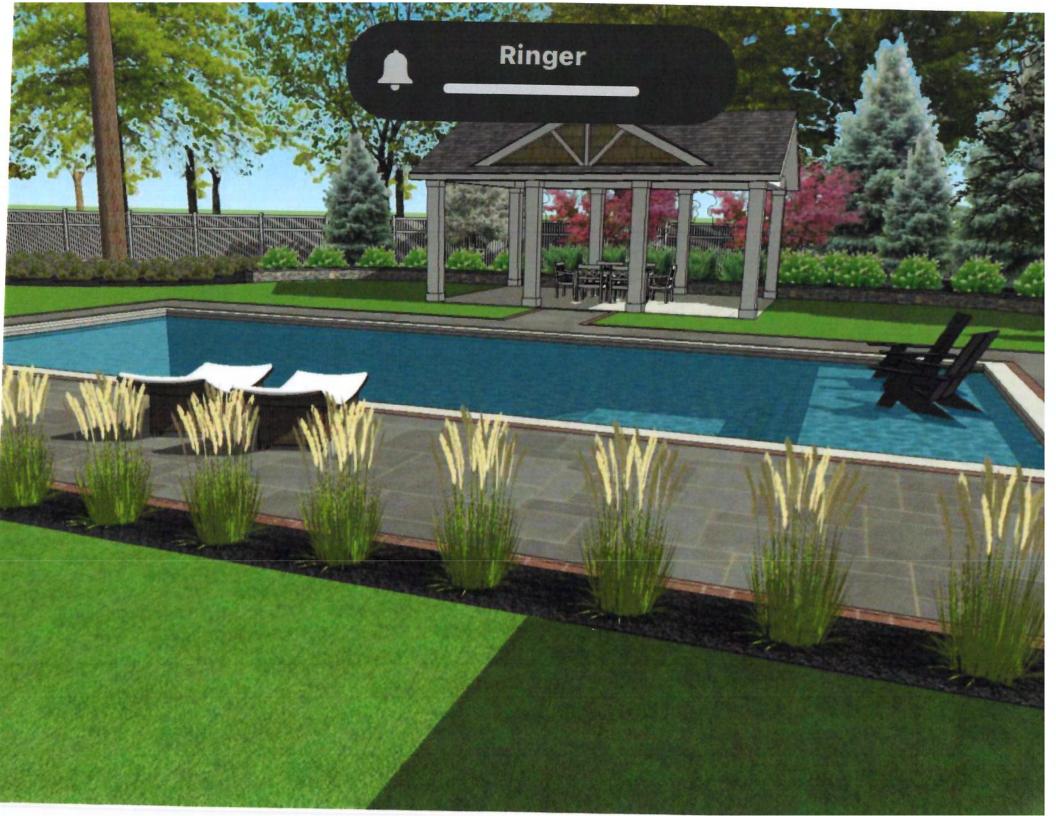








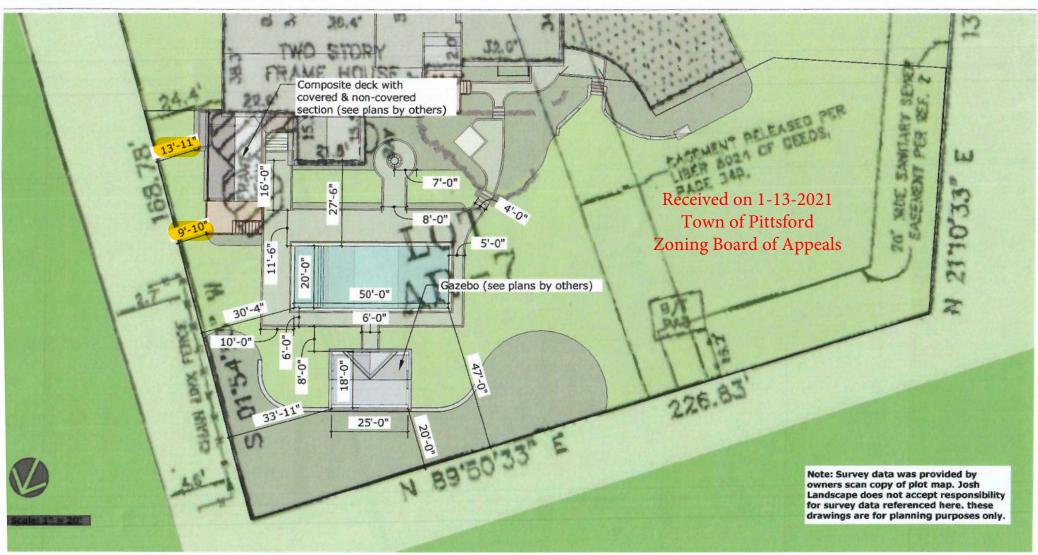



${\sf NOTES}$ (general notes to be applied as needed to this remodeling project)

- (I.) BUILDING IS CLASSIFIED AS A ONE FAMILY DWELLING. THE 2020 CODE SHALL PREVAIL AND BUILDING CONTRACTOR IS RESPONSIBLE FOR COMPLIANCE REGARDLESS OF ANY MISSING OR INCOMPLETE DETAILS OR NOTES ON THE DRAWINGS.
- THE 2020 ENERGY CONSERVATION CODE SHALL PREVAIL AND BUILDING CONTRACTOR IS RESPONSIBLE FOR COMPLIANCE REGARDLESS OF ANY MISSING OR INCOMPLETE DETAILS OR NOTES
- (4.) BUILDING CONTRACTOR AND HIS SUBCONTRACTORS SHALL CONFORM TO LOCAL CONSTRUCTION ORDINANCES AND SHALL VERIFY ALL DIMENSIONS AND CONDITIONS BEFORE PROCEEDING
- (6.) NOTED DIMENSIONS TAKE PRECEDENCE OVER SCALED DIMENSIONS.
- THESE DRAWINGS HAVE BEEN PREPARED FOR DESIGN AND STRUCTURAL REFERENCE ONLY. ELECTRICAL, MECHANICAL, PLUMBING, AND OTHER BUILDING SYSTEMS IF ANY, ARE TO BE PREPARED BY AND ARE THE RESPONSIBILITY OF OTHERS.
- POURED CONC. SHALL BE PROTECTED FROM FREEZE/THAW DURING CONST-RUCTION, OR AIR ENTRAINED CONC. MUST BE USED. (TABLE R402.2, NOTE 2.) B.) STRUCTURAL STEEL TO BE ASTM - A36
- C.) WOOD JOISTS, BEAMS, HEADERS, AND RAFTERS SHALL HAVE AN EXTREME FIBER STRESS IN BENDING (FB) WITH REPETITIVE MEMBER USE OF 1150 P.S.I. (HEM FIR #2 OR BETTER.)

WALL SECTION NO.

DIRECTION THAT

SHEET ON WHICH

SECTION IS TAKEN

SECTION IS DRAWN

- WALL SECTION NO.

DIRECTION THAT SECTION IS TAKEN

SHEET ON WHICH

A DETAIL NO.

SECTION IS DRAWN

SHEET ON WHICH

ELEVATION NO.

DIRECTION THAT

SHEET ON WHICH

ELEVATION IS TAKEN

ELEVATION IS DRAWN

FT (')

FTG

FDN

GYP

HGT

HDR

IN (")

INCL

INFO

INSUL

IECC

JSTS

LT

MFR

MAX

MECH

MTL

MIN

NTS

MISC

D

HND'CP

-F00T

-FOOTING

-GYPSUM

-HEIGHT

-HEADER

-INCLUDE

-INFORMATION

-INSULATION

-INTERIOR

-JOINT

-LIGHT

-JOISTS

-LIVE LOAD

-MECHANICAL

-MAXIMUM

-METAL

-MINIMUM

-NORTH

-NUMBER

-MANUFACTURER

-MISCELLANEOUS

-NOT TO SCALE

-INSIDE DIAMETER

-INTERNATIONAL ENERGY

CONSERVATION CODE

-INTERNATIONAL RESIDENTIAL CODE

-INCH

-HANDICAP

-HOT WATER

-FOUNDATION

DETAIL IS DRAWN

CONTROLLED HGT.

<u>ROOMS</u>

<u>DOORS</u>

<u> MINDOMS</u>

<u>REVISIONS</u>

(12.) THE CONTRACTOR SHALL INSTALL 4" HIGH NUMBERS ON THE FRONT OF THIS BUILDING TO IDENTIFY THE SITE ADDRESS. (SEE SECTION R319.)

SYMBOLS

MALL SECTIONS

CROSS SECTIONS

DETAILS

ELEVATIONS

APPROX

BLK

BD

BLDG

BTR

CLG

COL

CONC

CONT

COMM

CRS

DL

DIA

DBL

DMG

DIM

ELEC

EXP

EXT

FT (')

FIN

FLR

I ST

FLUOR

DN

ABBREVIATIONS

-AND

-BEAM

-BLOCK

-BOARD

-BUILDING

-BETTER

-CEILING

-COLUMN

-CONCRETE

-COURSES

-DIAMETER

-DOUBLE

-DRAWING

-DIMENSION

-ELECTRIC

-EXTERIOR

-FEET

-FINISH

-FLOOR

-FIRST

-FLUORESCENT

-EXPANSION

-DOWN

-CONTINUOUS

-COMMERCIAL

-DEAD LOAD

-CENTERLINE

-AT

-APPROXIMATE

- (13.) GLAZING IN DOORS, STORM DOORS, SIDELIGHTS, SHOWER SPACES, AND TUB ENCLOSURES IS DEEMED TO BE HAZARDOUS PER SECTION R308.4 OF THE 2020 CODE AND SHALL BE IDENTIFIED AS SUCH IN COMPLIANCE WITH SECTION R 308.1. DECORATIVE GLASS IS EXEMPT IN SWINGING DOORS AND SIDELIGHTS (SEE SECTION R308.4 FOR ADDITIONAL HAZARDOUS LOCATIONS).
- (14.) DESIGN CRITERIA:
 - ROOMS OTHER THAN SLEEPING = 40 PSF LIVE LOAD SLEEPING ROOMS = 30 PSF LIVE LOAD GROUND SNOW LOAD = 40 PSF (FIG R301.2(6)) WIND SPEED - 90 MPH, EXPOSURE B
 - FROST LINE DEPTH 42" TERMITE DAMAGE - CONTACT LOCAL JURISDICTION
 - DECAY DAMAGE NONE TO SLIGHT
 - WINTER DESIGN TEMPERATURE (I) DEGREE ICE BARRIER IS REQUIRED
 - ROOF TIE-DOWN REQUIREMENTS R802.II (BASED UPON SPECIFIC ROOF DESIGN) M.) ENERGY COMPLIANCE DETAILS AND PATH - NIIOI.IS
- (15.) FOOTINGS TO BEAR ON FIRM, LEVEL, UNDISTURBED NATURAL SOIL, FREE FROM FROST OR LOOSE MATERIAL
- DRAWING ALTERATION: THE FOLLOWING IS AN EXCERPT FROM THE N.Y.S. EDUCATION LAW ARTICLE 145. SECTION 7209 AND APPLIES TO THESE DRAWINGS. "IT IS A VIOLATION OF THIS LAW FOR ANY PERSON, UNLESS HE IS ACTING UNDER THE DIRECT SUPERVISION OF A LICENSED PROFESSIONAL ENGINEER OR ARCHITECT TO ALTER AN ITEM IN ANY WAY. IF AN OR ARCHIECT TO ALTER AN ITEM IN ANY WAY. IF AN ITEM BEARING THE SEAL OF AN ENGINEER OR ARCHITECT IS ALTERED, THE ALTERING ENGINEER OR ARCHITECT SHALL AFFIX TO THE ITEM HIS SEAL AND THE NOTATION "ALTERED BY" FOLLOWED BY HIS SIGNATURE AND THE DATE OF SUCH ALTERATION AND A SPECIFIC DESCRIPTION OF THE ALTERATION." OF THE ALTERATION."
- (IT.) WHERE LOCAL EXHAUST OR WHOLE-HOUSE MECHANICAL VENTILATION IS PROVIDED, THE EQUIPMENT SHELL BE DESIGNED IN ACCORDANCE WITH SECTION MISOT OF THE
- (18.) "CODE" SHALL MEAN THE 2020 RESIDENTIAL CODE OF NEW YORK STATE. "ENERGY CONSERVATION CODE" OR "ENERGY CODE" SHALL MEAN CHAPTER II OF THE CODE.
- (19.) TO THE BEST OF MY KNOWLEDGE, BELIEF AND PROFESSIONAL JUDGEMENT, THESE PLANS ARE IN COMPLIANCE WITH THE ENERGY CONSERVATION CODE.

ROOM NO. (SEE ROOM

HARDWARE GROUP (SEE

FINISH SCHEDULE)

DOOR SCHEDULE)

WINDOW NO. (SEE

REVISION NO.

ON THIS SHEET)

O/A

0/

OPT

P.D.R

PSF

P.T.

RM

RES

R'S

RD & SH

SKY'LT

SH'S

STL

SUSF

SYN

T'S

(TYP)

T\$G

W/O

STOR

PLY'WD

REQ'D

0.H.D

O/ HANG

MINDOM SCHEDULE)

POINTS TO ITEM REVISED

-OPENING

-OVERALL

-OVERHANG

-OPTIONAL

-PLYWOOD

-REQUIRED

-RESIDENTIAL

-ROD & SHELF

-ROOM

-RISERS

-SOUTH

-SHELF

-STEEL

-SKYLIGHT

-SHELVES

-STORAGE

-SUSPENDED

-TONGUE & GROOVE

-SYNTHETIC

-TREADS

-TYPICAL

-WITHOUT

-MITH

-POWDER ROOM

-POUNDS PER SQ. FT.

-POUNDS PER SQ. IN.

-PRESSURE TREATED

-OVER

-OVERHEAD DOOR

(SEE REVISION CHART

DOOR NO.

ENERGY CONSERVATION, CHAPTER II, ENERGY EFFICIENCY

- A MINIMUM OF 90 PERCENT OF THE LAMPS IN PERMANENTLY INSTALLED LIGHTING FIXTURES SHALL BE HIGH-EFFICACY LAMPS PER
- RECESSED LUMINARIES INSTALLED IN THE BUILDING THERMAL ENVELOPE SHALL BE SEALED WITH A GASKET OR CAULK BETWEEN THE HOUSING AND THE INTERLICON WALL OF CEILING COVERING TO LIMIT AIR LEAKAGE BETWEEN CONDITIONED AND UNCONDITIONED SPACES PER SECTION NIIO2.4.5
- CONTRACTOR TO PROVIDE A PROGRAMMABLE THERMOSTAT TO CONTROL THE HVAC SYSTEM PER SECTION NIIO3.I.I
- 4. ALL DUCTS, AIR HANDLERS, FILTER BOXES SHALL BE SEALED PER SECTION NIIO3.3.2.
- ALL CIRCULATING SERVICE HOT WATER PIPING SHALL BE INSULATED TO AT LEAST R-3. CIRCULATING HOT WATER SYSTEMS SHALL INCLUDE AN AUTOMATIC OR READILY ACCESSIBLE MANUAL SMITCH THAT CAN TURN OFF THE HOT WATER CIRCULATING PUMP WHEN THE SYSTEM IS NOT IN USE. PER SECTION NIIO3.5
- ATTIC ACCESS SHALL BE INSULATED WITH THE SAME R-VALUE AS THE ATTIC, WEATHER-STRIPPED AND LATCHED PER SECTION NIIO2.2.4
- AIR TIGHTNESS AND INSULATION INSTALLATION SHALL BE PER MANUFACTURERS INSTRUCTIONS AND CRITERIA LISTED IN SECTIONS NIIO2.4.1 THROUGH NIIO2.4.6.
- THE STRUCTURE SHALL BE TESTED AND VERIFIED AS HAVING AN AIR LEAKAGE RATE NOT EXCEEDING 3 AIR CHANGES PER HOUR. CONDUCT TEST ACCORDING TO ASTM E719 OR ASTM E1827 OR NET/ICC 380 AND REPORTED AT A PRESSURE OF 0.2 INCH W.G. COMPLY WITH NIIO2.4.1.2.
- THE CONTRACTORS AND SUB-CONTRACTORS SHALL BE FAMILIAR WITH THE ENERGY CODE AND EXPERIENCED IN PERFORMING WORK THAT COMPLIES WITH ALL ASPECTS OF THE ENERGY CODE. THESE NOTES ARE NOT INTENDED TO BE ALL INCLUSIVE.

AIR BARRIER CRITERIA

DECK ADDITION

6 CANAL PARK PLACE, PITTSFORD, NEW YORK

MR & MRS SCOTT COOPER, HOMEOWNERS

ENERGY CODE COMPLIANCE PATH: (EXISTING CONSTRUCTION) THE ENTIRE BUILDING IS NOT REQUIRED TO COMPLY WITH THE CURRENT ENERGY CODE. THE ALTERATIONS SHALL CONFORM TO ENERGY CODE. NEW FENESTRATION SHALL COMPLY WITH ENERGY CODE.

CAVITIES IN THE ENVELOPE (CEILING, WALL OR FLOOR) EXPOSED DURING CONSTRUCTION SHALL BE FILLED WITH (MINIMUM) FIBER GLASS INSULATION WITH VAPOR BARRIER. NEW LIGHT FIXTURES SHALL HAVE HIGH EFFICIENCY LAMPS.

GENERAL NOTES

- CONTRACTOR SHALL COMPLY WITH ALL STATE AND LOCAL CODES WHICH PERTAIN TO THE CONSTRUCTION OF THIS STRUCTURE
- CONTRACTOR SHALL VERIFY EXISTING STRUCTURAL CONDITIONS AND DIMENSIONS PRIOR TO DEMOLITION AND / OR CONSTRUCTION
- CONTRACTOR SHALL PROVIDE ANY NECESSARY BRACING, TEMPORARY FRAMING SUPPORTS (SHORING), AND UNDER-PINNING OF EXISTING STRUCTURE AS REQUIRED
- CONTRACTOR SHALL CO-ORDINATE THE INSTALLATION OF NEW AND / OR USE OF RELOCATED DOORS, AND
- CONTRACTOR SHALL (WHERE POSSIBLE) MATCH PLATE HEIGHTS, SUBFLOORS, AND WINDOW ROUGH OPENING HEIGHTS TO MAINTAIN CONTINUITY
- WHERE POSSIBLE MATCH CONCRETE BLOCK COURSES AT NEW AND EXISTING FOUNDATION WALLS
- MINIMUM GRADE COVER AT ALL CONCRETE FOOTINGS
- INFILL EXISTING EXPOSED EXTERIOR FRAMING CAVITIES FULL WITH INSULATION
- MINIMUM R MAXIMUM U VALUES **FENESTRATION** MAX U VALUE = 0.30

INSULATION INSTALLATION CRITERIA

Concealed sprinklers the manufacturer. Caulking or other adhesive sealants shall not

be used to fill voids between fire sprinkler cover plates and

a. In addition, inspection of log walls shall be in accordance with the provisions of ICC 400.

TABLE N1102.4.1.1 (402.4.1.1) AIR BARRIER AND INSULATION INSTALLATION COMPONENT

COMI ONLIN	AIR BARRIER CRITERIA	INSOLATION INSTALLATION CRITERIA
General requirements	A continuous air barrier shall be installed in the building envelope. The exterior thermal envelope contains a continuous air barrier. Breaks or joints in the air barrier shall be sealed.	Air-permeable insulation shall not be used as a sealing material.
Ceiling/attic	The air barrier in any dropped ceiling/soffit shall be aligned with the insulation and any gaps in the air barrier sealed. Access openings, drop down stairs or knee wall doors to unconditioned attic spaces shall be sealed.	The insulation in any dropped ceiling/soffit shall be aligned with the air barrier.
Walls	The junction of the foundation and sill plate shall be sealed. The junction of the top plate and the top of exterior walls shall be sealed. Knee walls shall be sealed.	Cavities within corners and headers of frame walls shall be insulated by completely filling the cavity with a material having a thermal resistance of R-3 per inch minimum. Exterior thermal envelope insulation for framed walls shall be installed in substantial contact and continuous alignment with the air barrier.
Windows, skylights and doors	The space between window/door jambs and framing, and skylights and framing shall be sealed.	
Rim joists	Rim joists shall include the air barrier.	Rim joists shall be insulated.
Floors (including above garage and cantilevered floors)	The air barrier shall be installed at any exposed edge of insulation.	Floor framing cavity insulation shall be installed to maintain permanent contact with the underside of subfloor decking, or floor framing cavity insulation shall be permitted to be in contact with the top side of sheathing, or continuous insulation installed on the underside of floor framing; and extends from the bottom to the top of all perimeter floor framing members.
Crawl space walls	Exposed earth in unvented crawl spaces shall be covered with a Class I vapor retarder with overlapping joints taped.	Where provided instead of floor insulation, insulation shall be permanently attached to the crawl space walls.
Shafts, penetrations	Duct shafts, utility penetrations, and flue shafts opening to exterior or unconditioned space shall be sealed.	
Narrow cavities		Batts in narrow cavities shall be cut to fit, or narrow cavities shall be filled by insulation that on installation readily conforms to the available cavity space.
Garage separation	Air sealing shall be provided between the garage and conditioned spaces.	
Recessed lighting	Recessed light fixtures installed in the building thermal envelope shall be sealed to the drywall.	Recessed light fixtures installed in the building thermal envelope shall be air tight and IC rated.
Plumbing and wiring		Batt insulation shall be cut neatly to fit around wiring and plumbing in exterior walls, or insulation that on installation readily conforms to available space shall extend behind piping and wiring.
Shower/tub on exterior wall	The air barrier installed at exterior walls adjacent to showers and tubs shall separate them from the showers and tubs.	Exterior walls adjacent to showers and tubs shall be insulated.
Electrical/phone box on exterior walls	The air barrier shall be installed behind electrical or communication boxes or air-sealed boxes shall be installed.	
HVAC register boots	HVAC register boots that penetrate building thermal envelope shall be sealed to the subfloor or drywall.	
	When required to be sealed, concealed fire sprinklers shall only be sealed in a manner that is recommended by	



STEVEN L. CARINI, P.E.

1387 FAIRPORT ROAD FAIRPORT, NY 14450-2002 PH. (585) 223-6420

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SCOTT & MANDY COOPER

DECK ADDITION

6 CANAL PARK PLACE PITTSFORD, NEW YORK

Drawing Title:

Job Location:

COVER SHEET & NOTES


Checked By DECEMBER, 2020

38398

Of

SEISMIC DESIGN CATEGORY - A OR B - R301.2(2) (5.) ROOF TRUSS ENGINEERING AND SIZES DETERMINED BY AND ARE THE SOLE RESPONSIBILITY OF THE MANUFACTURER. (MFR.) WEATHERING - SEVERE

- BEARING CAPACITY OF SOIL IS ASSUMED AT 2000 P.S.F. AND CONTRACTOR SHALL VERIFY PRIOR TO PLACEMENT OF FOOTINGS.
- (9.) ALLOWABLE STRESSES OF MATERIALS: (THE MEATHERING POTENTIAL FOR CONCRETE IS ASSUMED TO BE SEVERE. SEE (16.)
 - A.) CONCRETE (R402.2) MIN. COMPRESSIVE STRENGTH @ 28 DAYS PSI = FOOTINGS: 2500 PSI
 BASEMENT SLAB: 2500 PSI (W/ FIBER REINF. ADDITIVE, OPTIONAL)
 GARAGE & PORCH SLABS: 3500 PSI (AIR-ENTRAINED)
 BASEMENT MALLS: 3000 PSI (AIR-ENTRAINED WHERE EXPOSED TO WEATHER)
- IO.) FIREPLACES SHALL HAVE AN OUTSIDE AIR SOURCE FOR COMBUSTION WITH A DUCT, DAMPER ETC. \$ SHALL COMPLY WITH CODE SECTION RIOOI-RIO66 AS APPLICABLE.
- SETTING THE BUILDING ELEVATION IS THE RESPONSIBILITY OF THE GENERAL CONTRACTOR AND SHALL COMPLY WITH R403.1.7.3 OF THE 2020 RESIDENTIAL CODE OF NEW YORK STATE

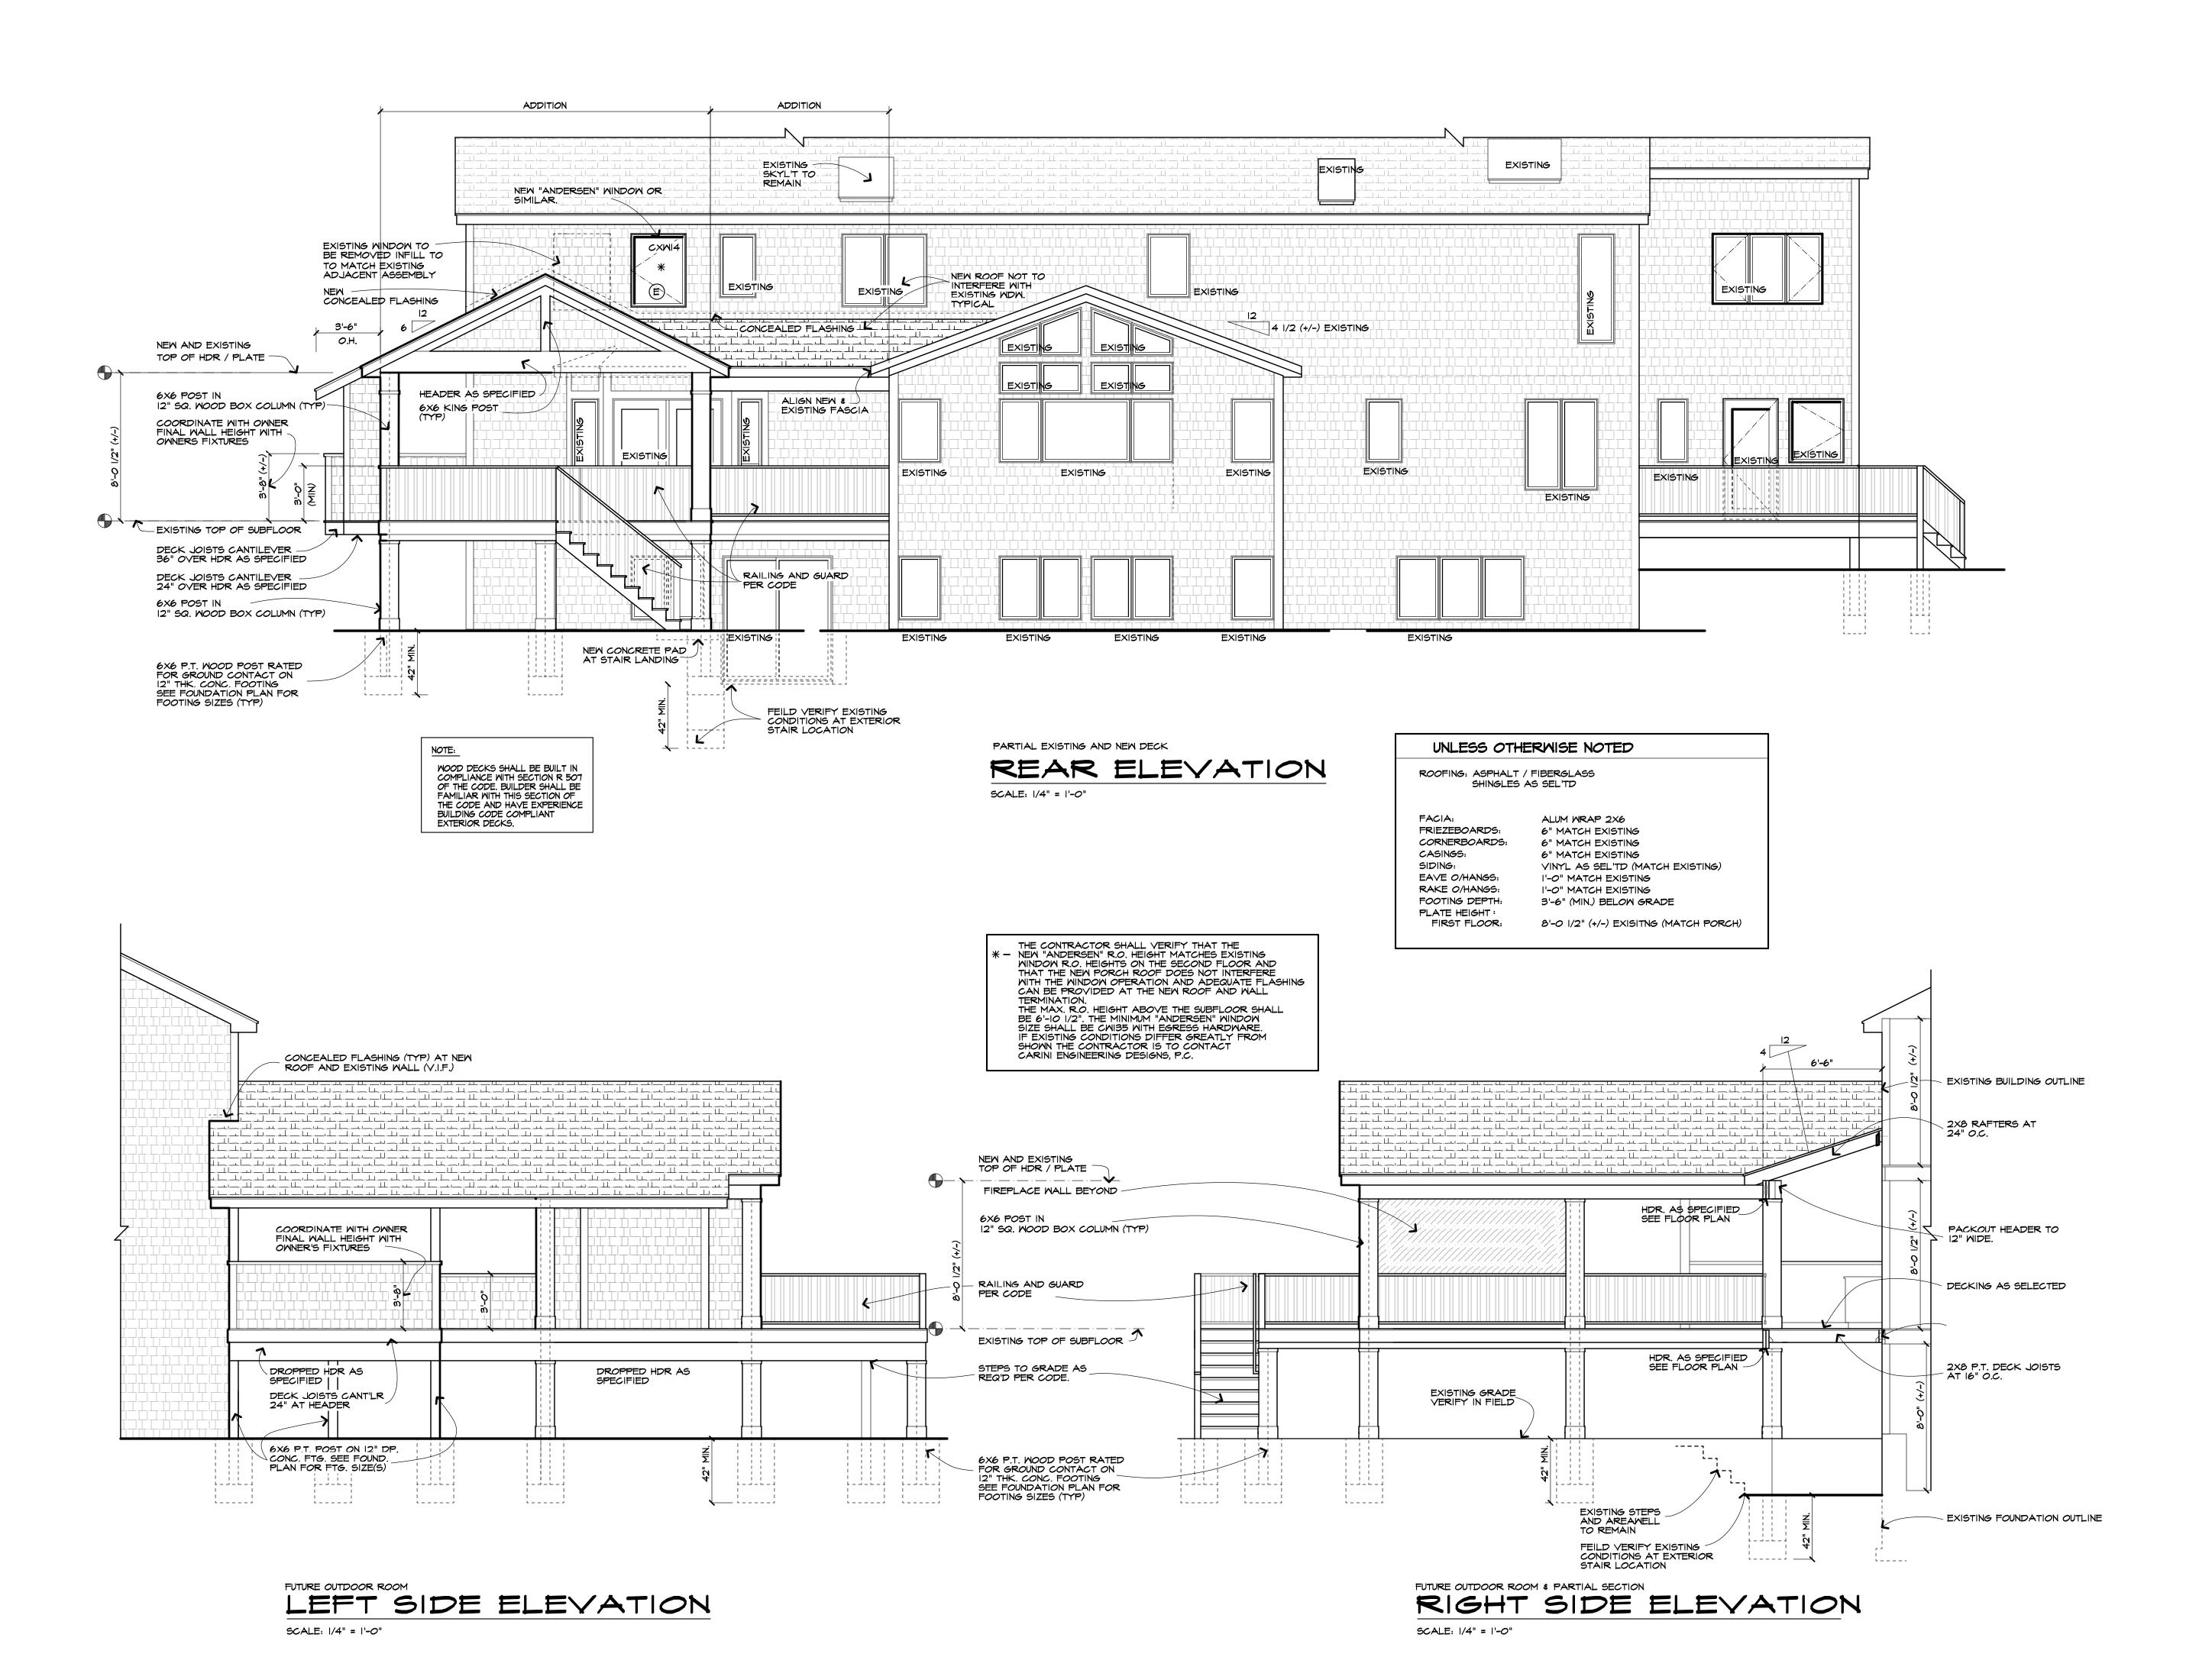



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It is a violation of Section 7209 (2) of the

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Rev

DECK ADDITION

Client:

SCOTT # MANDY COOPER

Job Location:

6 CANAL PARK PLACE PITTSFORD, NEW YORK

ELEVATIONS

Drawing Title:

Drawn Checked


SMK SLC

Date

DECEMBER, 2020

Job No. 38398

Of

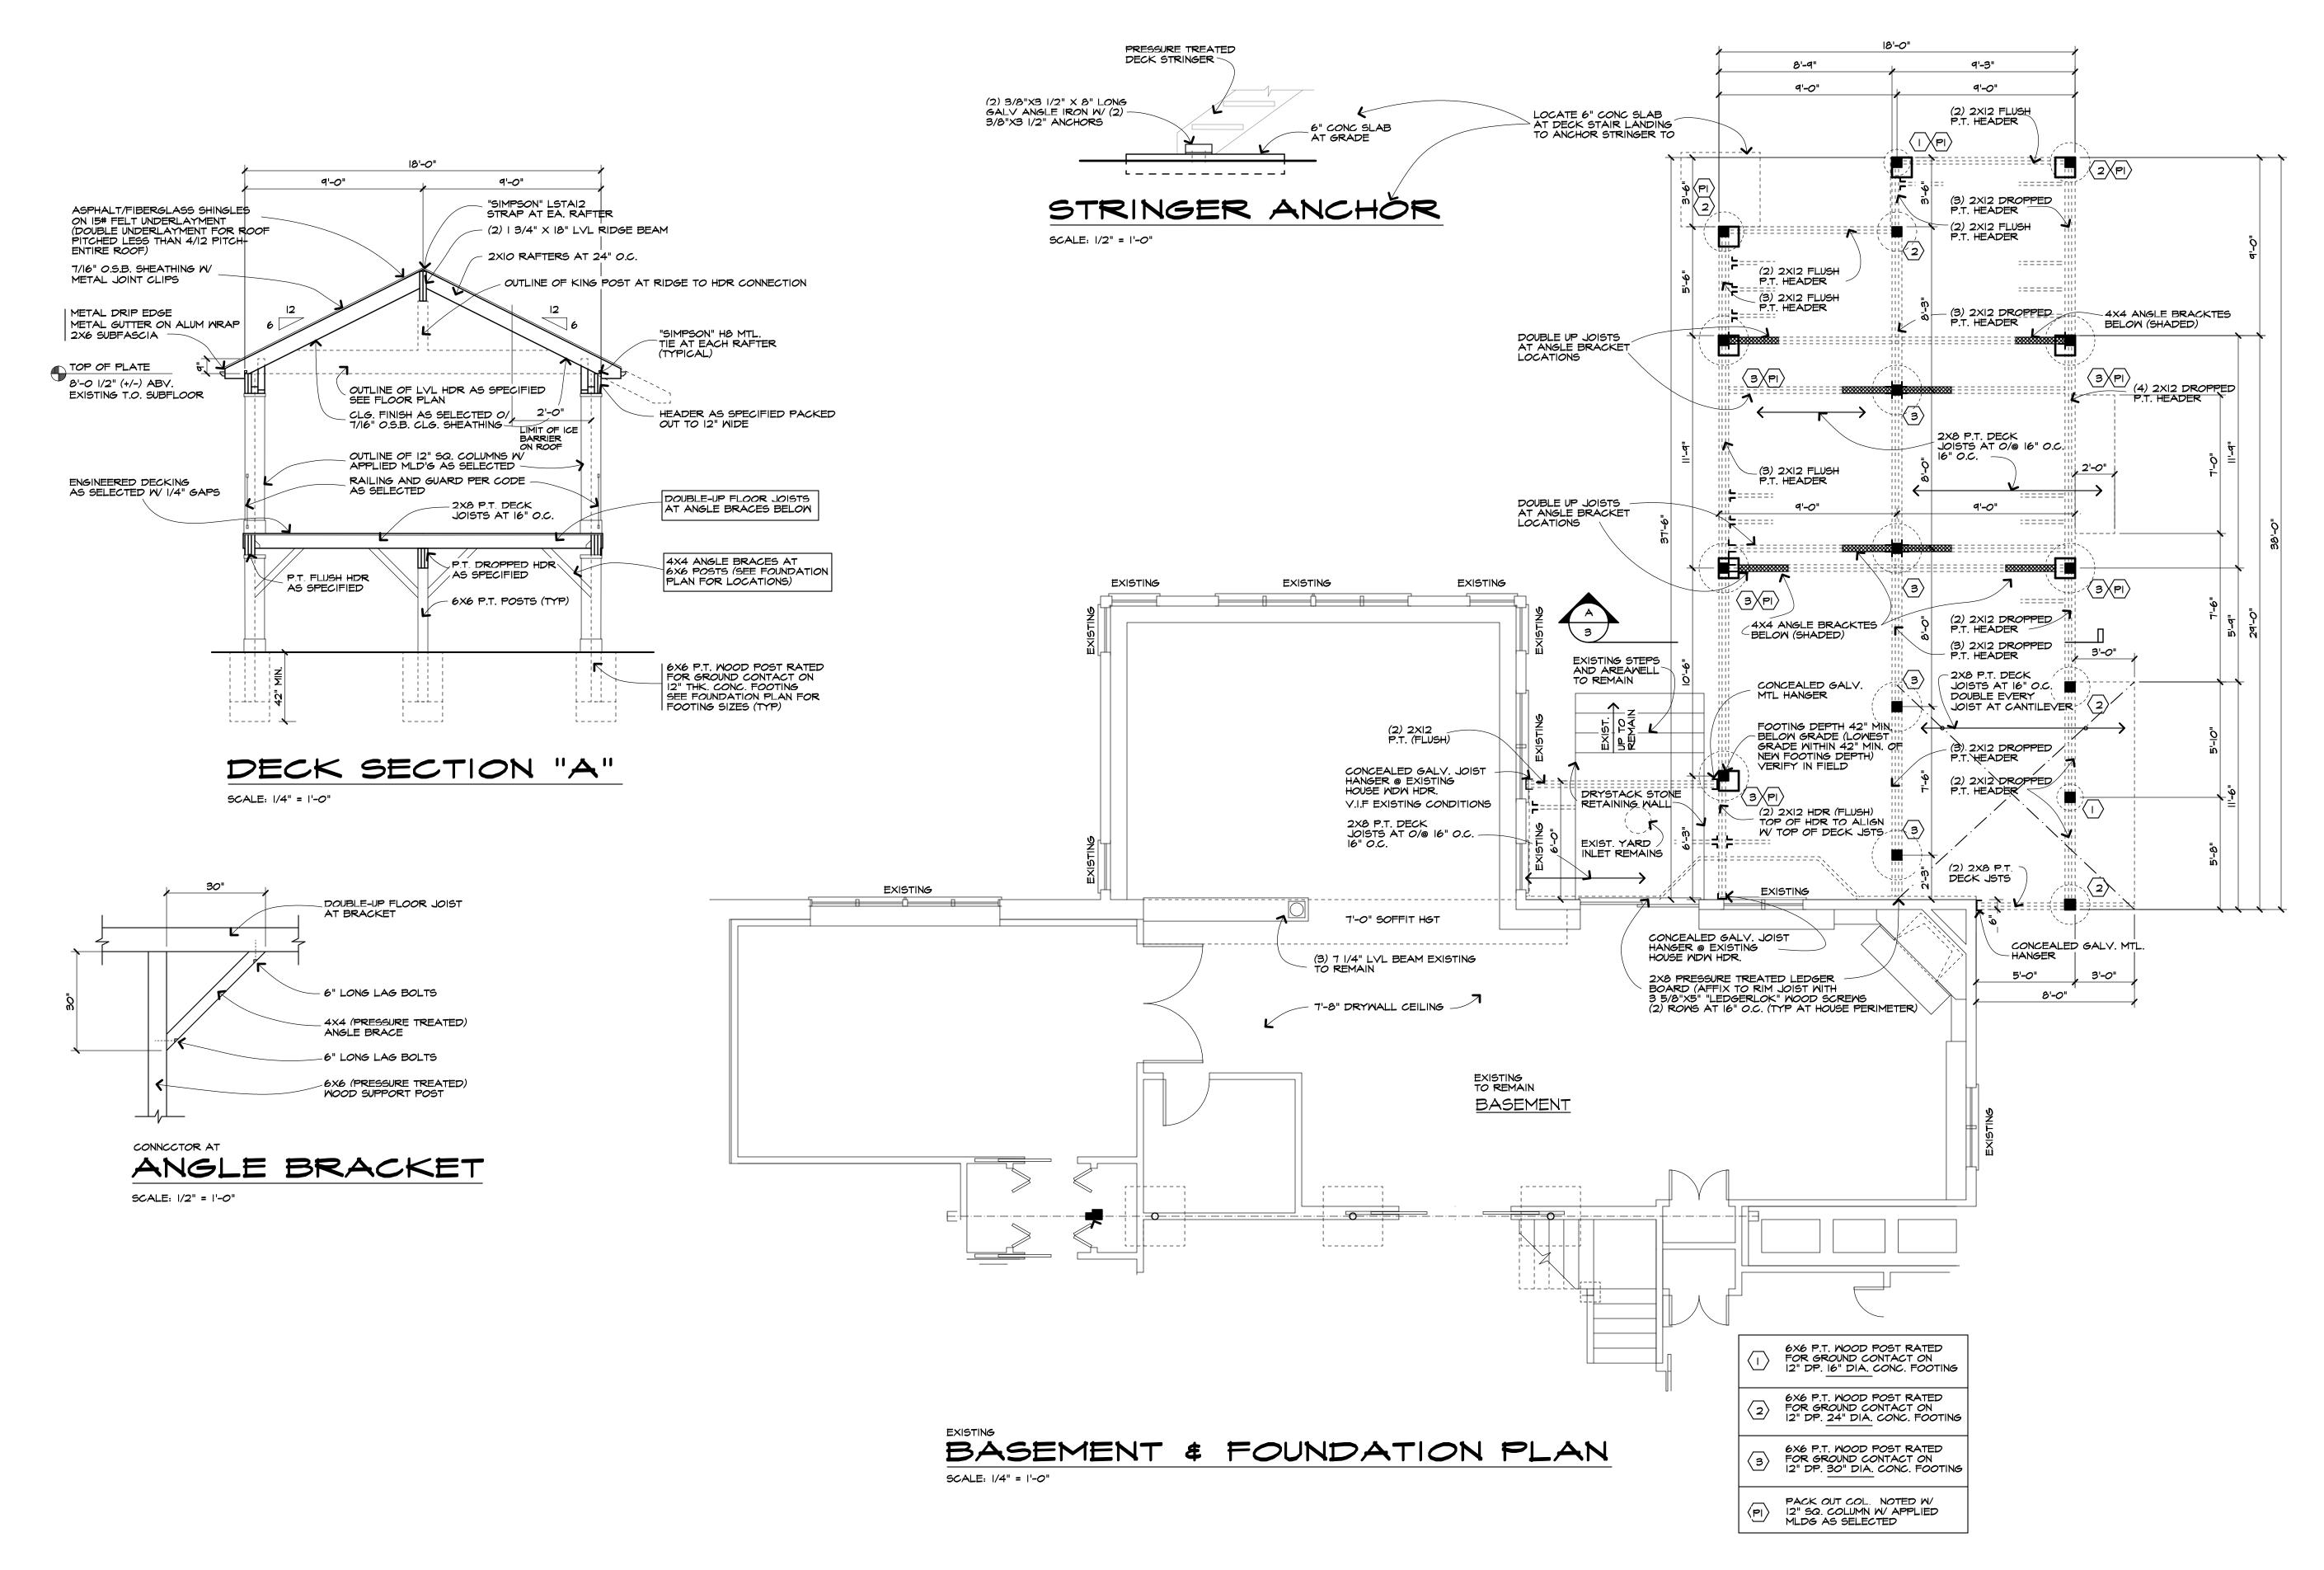



1387 FAIRPORT ROAD SUITE #560 FAIRPORT, NY 14450-2002 PH. (585) 223-6420

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Revision

DECK ADDITION

Client:

SCOTT & MANDY COOPER

lob Location:

6 CANAL PARK PLACE PITTSFORD, NEW YORK

Drawing Title:


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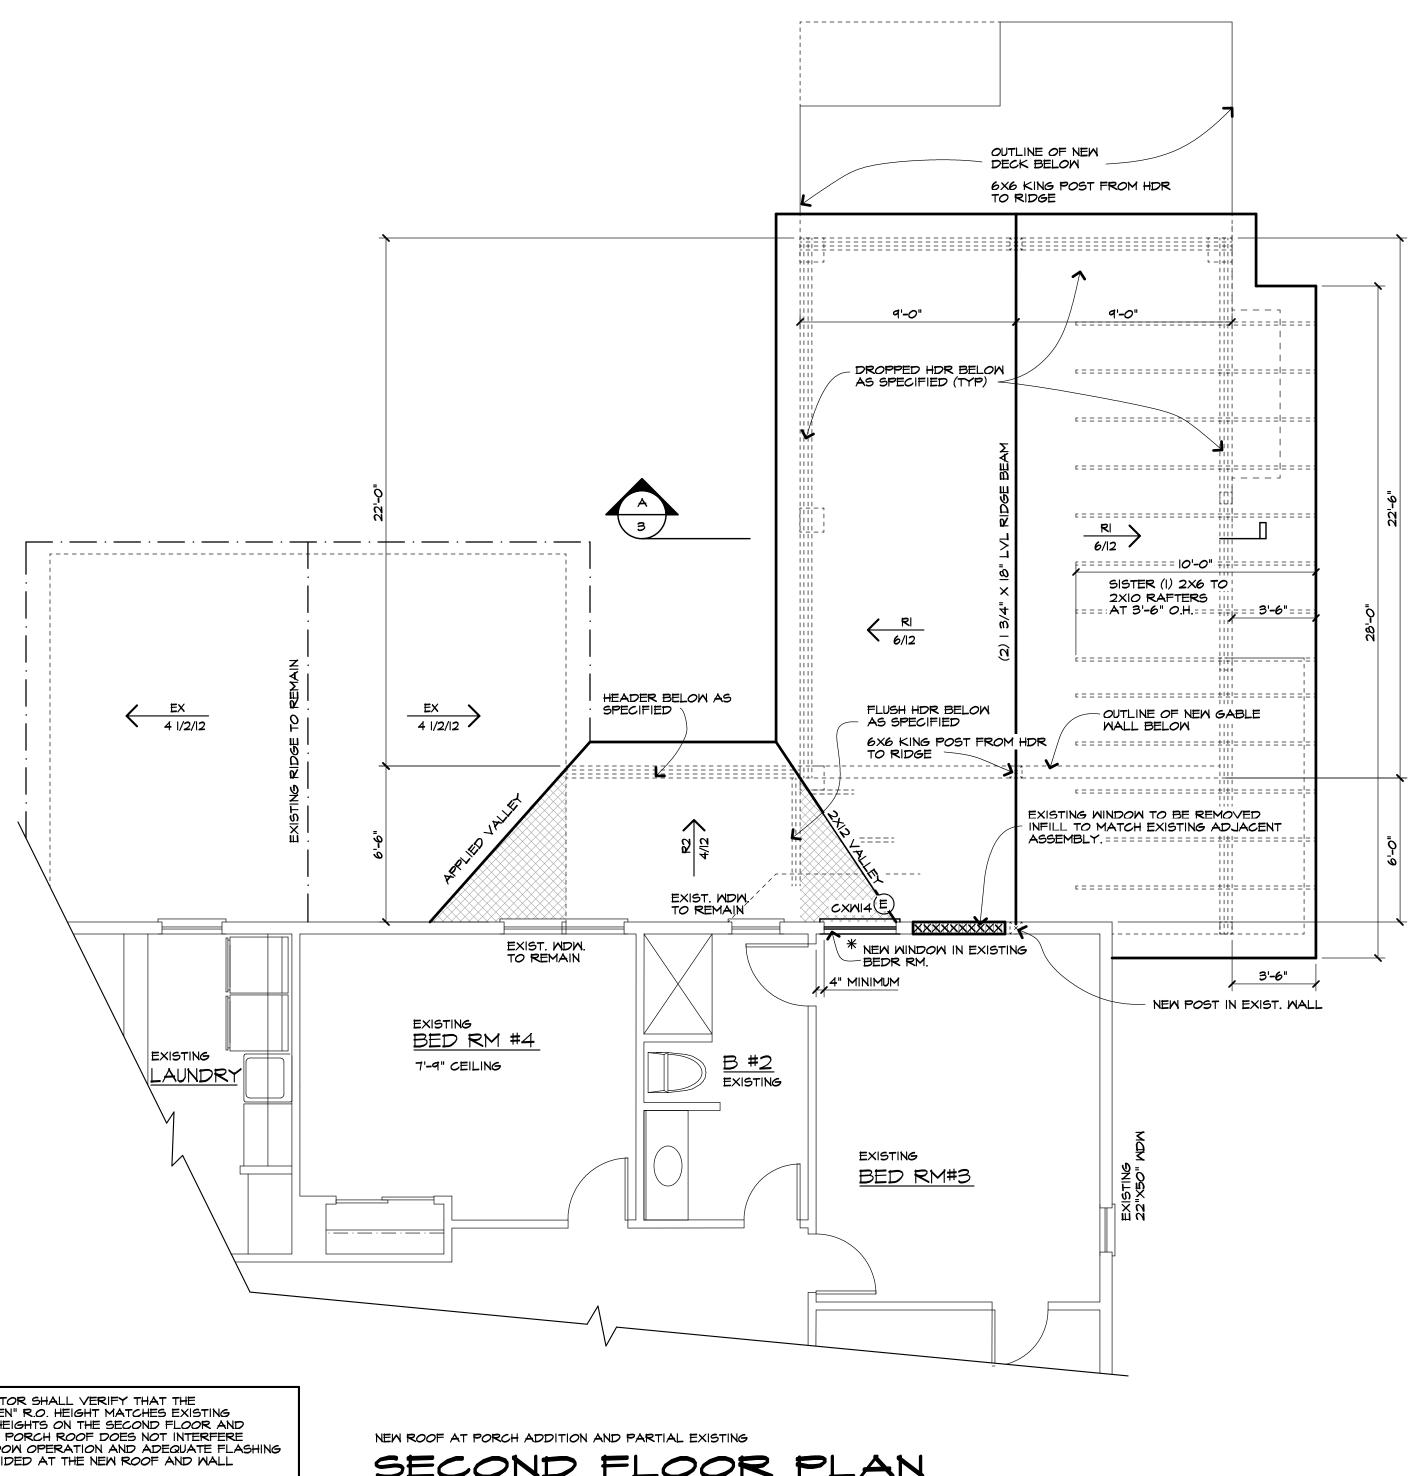
DECEMBER, 2020

BASEMENT PLAN


38398

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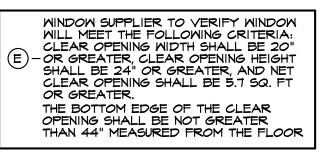


THE CONTRACTOR SHALL VERIFY THAT THE * - NEW "ANDERSEN" R.O. HEIGHT MATCHES EXISTING WINDOW R.O. HEIGHTS ON THE SECOND FLOOR AND THAT THE NEW PORCH ROOF DOES NOT INTERFERE WITH THE WINDOW OPERATION AND ADEQUATE FLASHING CAN BE PROVIDED AT THE NEW ROOF AND WALL TERMINATION.
THE MAX. R.O. HEIGHT ABOVE THE SUBFLOOR SHALL
BE 6'-10 1/2". THE MINIMUM "ANDERSEN" MINDOM SIZE SHALL BE CWISS WITH EGRESS HARDWARE.
IF EXISTING CONDITIONS DIFFER GREATLY FROM
SHOWN THE CONTRACTOR IS TO CONTACT
CARINI ENGINEERING DESIGNS, P.C.

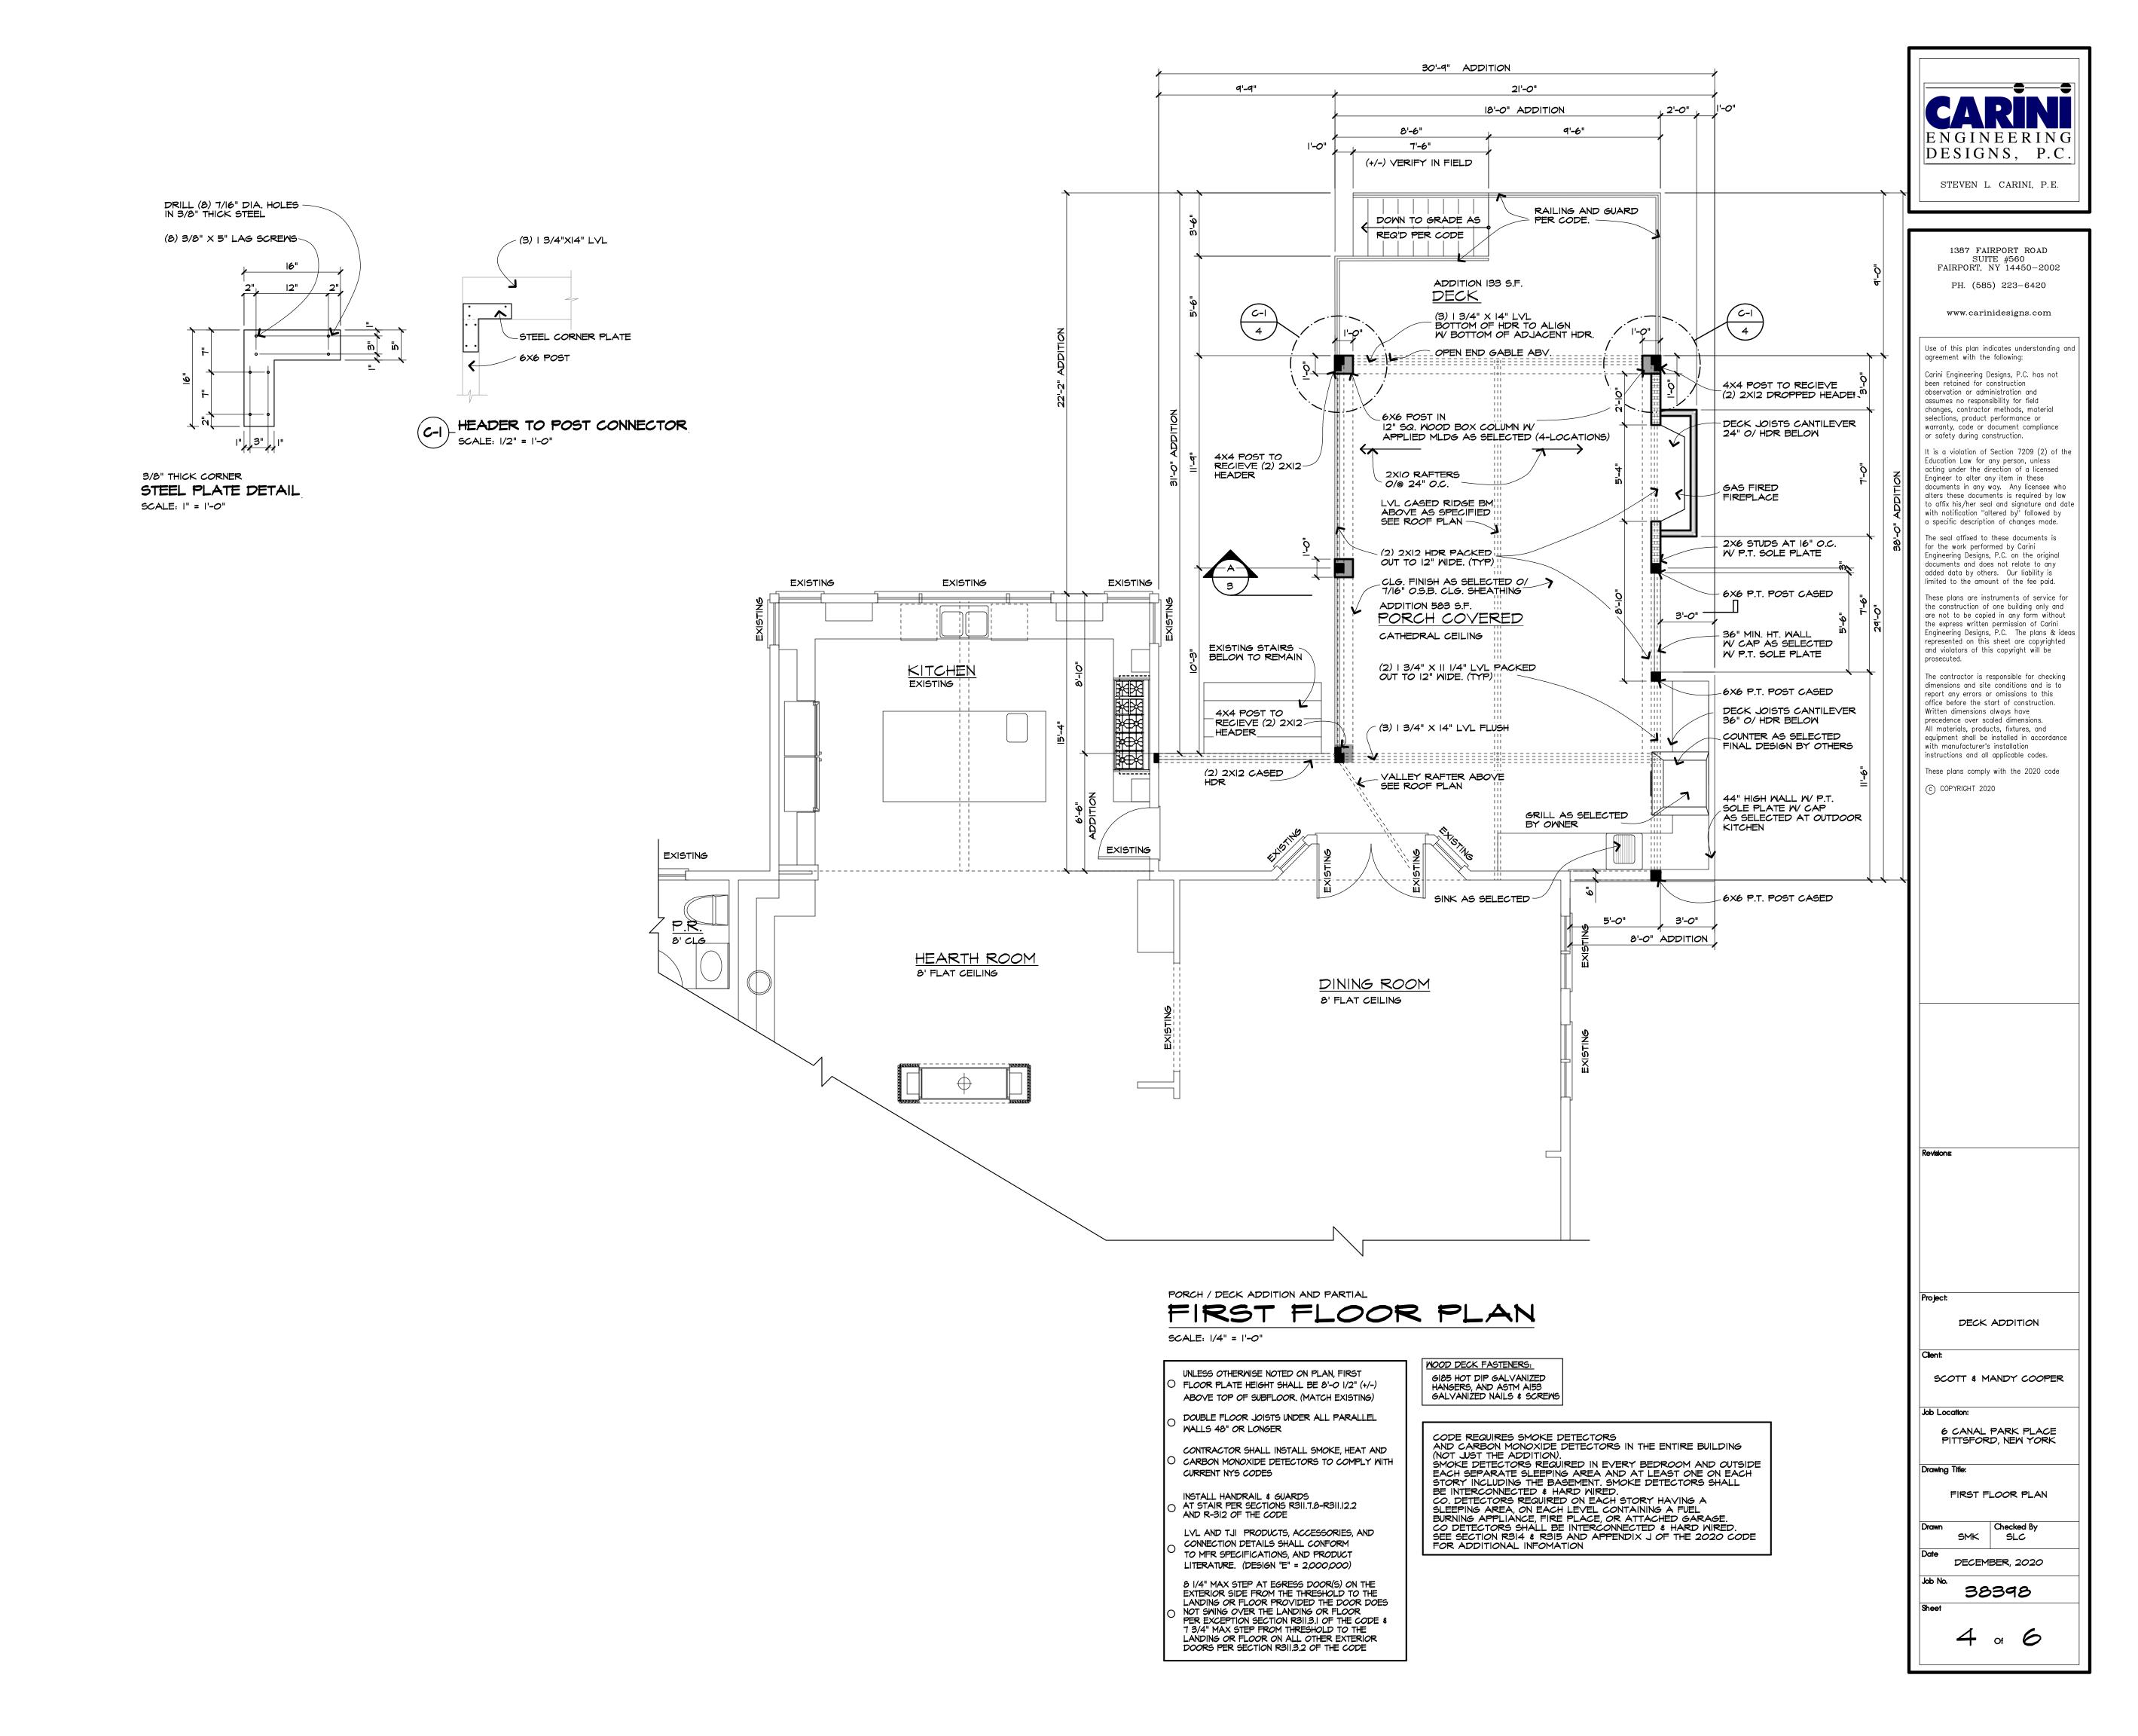

SECOND FLOOR PLAN

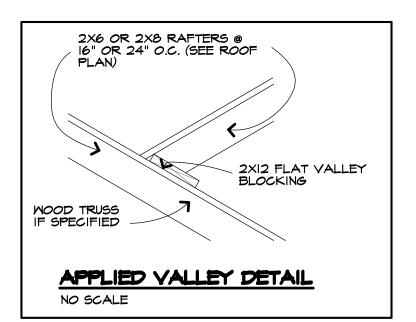SCALE: 1/4" = 1'-0"



HEADER SCHEDULE UNLESS OTHERWISE NOTED 2X6 WALL

UP TO 5'-0 (3) 2×8 (2) 2X8 WALL LEGEND -EXISTING WALLS TO REMAIN XXXXXXXXXXXX -INFILL EXISTING OPENINGS TO MATCH EXISTING ADJACENT ASSEMBLY (VERIFY IN FIELD)

UNLESS OTHERWISE NOTED ON PLAN, SECOND FLOOR PLATE HEIGHT SHALL BE 7'-9" (+/-) V.I.F. CONTRACTOR SHALL INSTALL SMOKE, HEAT AND

CURRENT NYS CODES LVL AND TJI PRODUCTS, ACCESSORIES, AND CONNECTION DETAILS SHALL CONFORM TO MFR SPECIFICATIONS, AND PRODUCT LITERATURE. (DESIGN "E" = 2,000,000)

CARBON MONOXIDE DETECTORS TO COMPLY WITH

PER R312 WINDOW FALL PROTECTION SHALL BE PROVIDED IN ACCORDANCE WITH SECTIONS R312.2.1 AND R312.2.2. WINDOW MANUFACTURER/SUPPLIER & CONTRACTOR SHALL BE RESPONSIBLE FOR CONFORMITY

UNLESS NOTED OTHERWISE

RI 2XIO RAFTERS @ 24" O.C. WITH PITCH NOTED

2X6 RAFTERS AT 24" O.C. WITH PITCH NOTED EXISTING ROOF TO REMAIN W PITCH NOTED

EAVE OVERHANGS SHALL BE I'-O"

RAKE OVERHANGS SHALL BE 1'-O" INSTALL ICE BARRIER ON ROOF TO COMPLY WITH SECTION R905.1.2 OF THE CODE

CODE REQUIRES SMOKE DETECTORS
AND CARBON MONOXIDE DETECTORS IN THE ENTIRE BUILDING
(NOT JUST THE ADDITION).
SMOKE DETECTORS REQUIRED IN EVERY BEDROOM AND OUTSIDE
EACH SEPARATE SLEEPING AREA AND AT LEAST ONE ON EACH
STORY INCLUDING THE BASEMENT. SMOKE DETECTORS SHALL
BE INTERCONNECTED & HARD WIRED.
CO. DETECTORS REQUIRED ON EACH STORY HAVING A
SLEEPING AREA, ON EACH LEVEL CONTAINING A FUEL
BURNING APPLIANCE, FIRE PLACE, OR ATTACHED GARAGE.
CO DETECTORS SHALL BE INTERCONNECTED & HARD WIRED.
SEE SECTION R314 & R315 AND APPENDIX J OF THE 2020 CODE
FOR ADDITIONAL INFOMATION



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DECK ADDITION

SCOTT & MANDY COOPER


6 CANAL PARK PLACE PITTSFORD, NEW YORK

Drawing Title: SECOND FLOOR PLAN \$

ROOF FRAMING PLAN Checked By

SLC

DECEMBER, 2020 38398

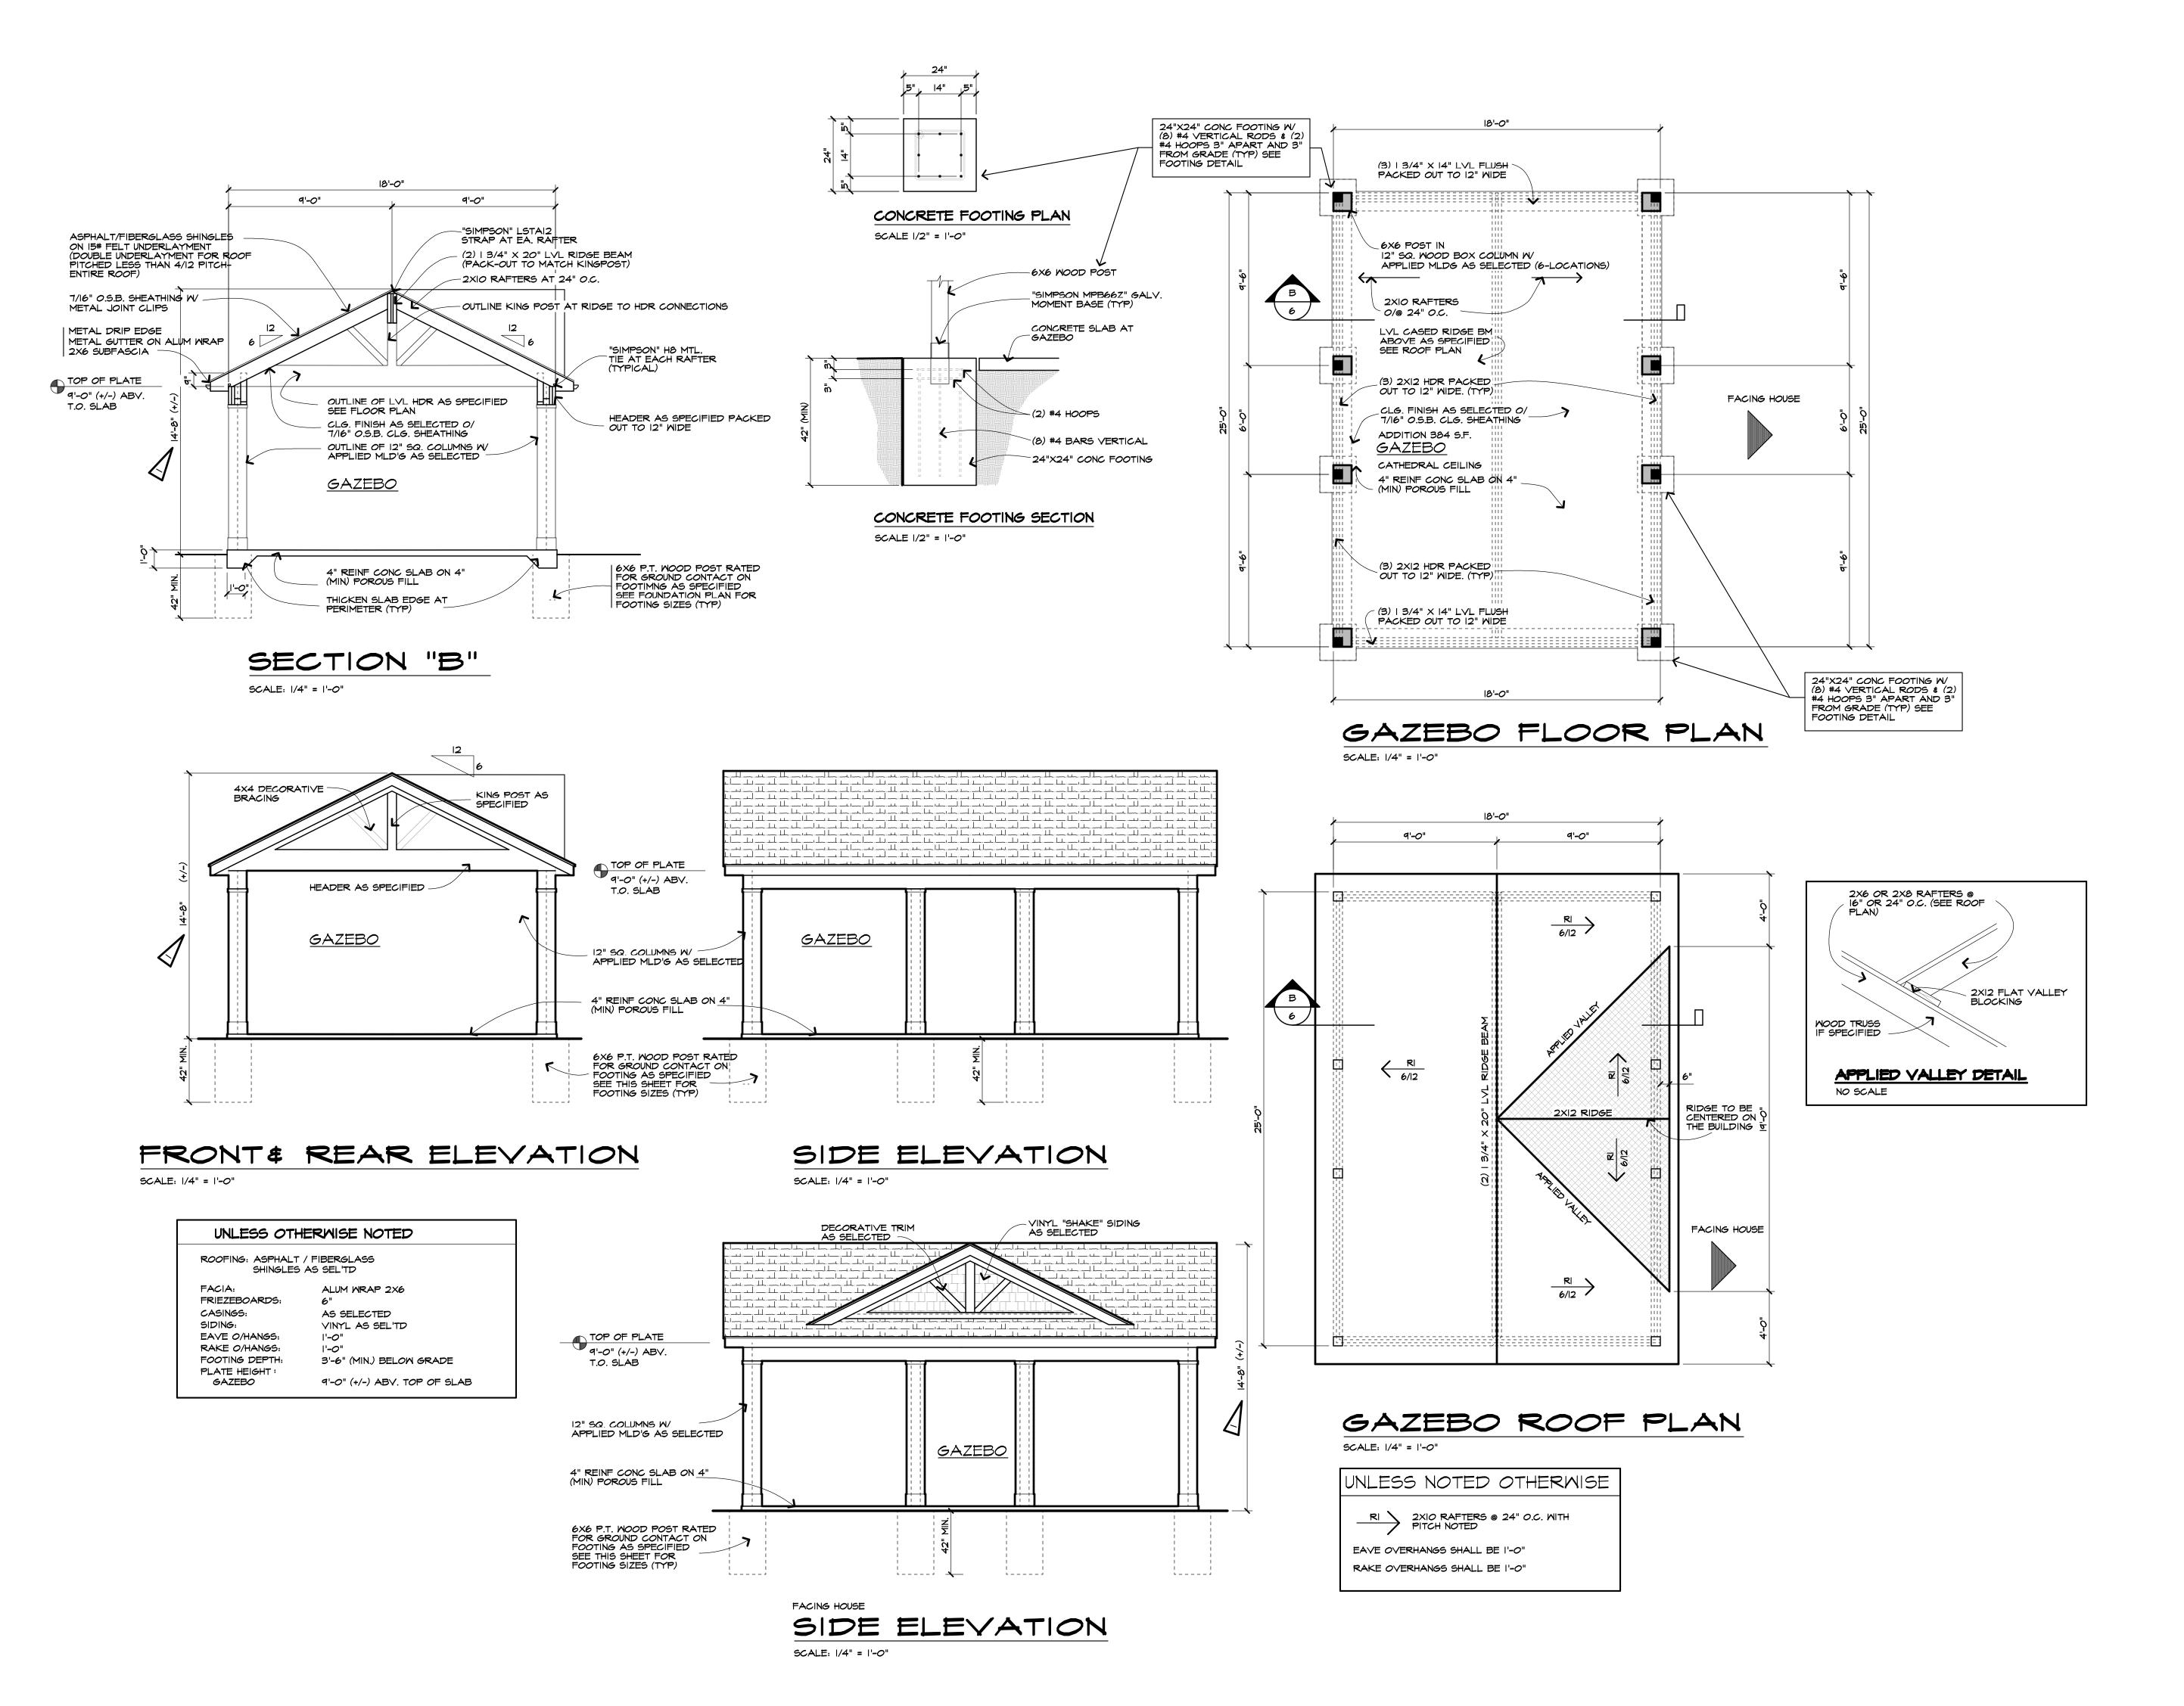

CARINE ENGINEERING DESIGNS, P.C.

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I-II-2021 - SMK GAZEBO HEIGHT

DECK ADDITION

SCOTT & MANDY COOPER

Job Location:

6 CANAL PARK PLACE PITTSFORD, NEW YORK

Drawing Title:

GAZEBO PLAN

Checked B

SMK SLC

DECEMBER, 2020

Job No.


38398

6 of 6







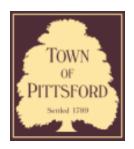

Town of Pittsford

Department of Public Works 11 South Main Street Pittsford, New York 14534

Permit # B21-000041

Phone: 585-248-6250 FAX: 585-248-6262

DESIGN REVIEW AND HISTORIC PRESERVATION BOARD REFERRAL OF APPLICATION

Property Address: 180 Kilbourn Road ROCHESTER, NY 14618

Tax ID Number: 138.17-1-27

Zoning District: RN Residential Neighborhood

Owner: Billitier, Ron

Applicant: Morbito Architects

Application Type:

✓	Residential Design Review	Build to Line Adjustment
	§185-205 (B)	§185-17 (B) (2)
	Commercial Design Review	Building Height Above 30 Feet
	§185-205 (B)	§185-17 (M)
	Signage	Corner Lot Orientation
	§185-205 (C)	§185-17 (K) (3)
	Certificate of Appropriateness	Flag Lot Building Line Location
	§185-197	§185-17 (L) (1) (c)
	Landmark Designation	Undeveloped Flag Lot Requirements
	§185-195 (2)	§185-17 (L) (2)
	Informal Review	


Project Description: Applicant is requesting design review for the construction of a new two story home. The home will be approximately 3924 square feet of living space and will be located in the Kilbourn neighborhood. The previous home has been demolished. The applicant did appear before the Zoning Board of Appeals on the 15th of February and was granted variances for setbacks.

Meeting Date: March 11, 2021


RN Residential Neighborhood Zoning



Printed October 15, 2020

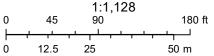

Town of Pittsford GIS

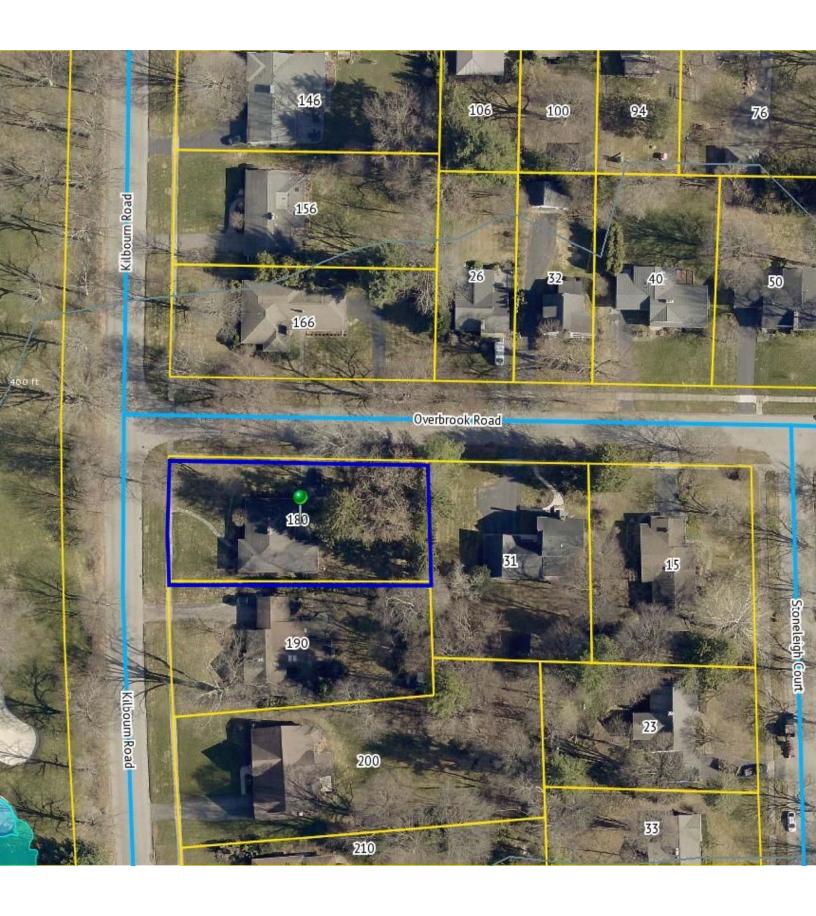

GENERAL NOTES:

- BACKFILL MATERIALS SHALL BE NATIVE SOIL.
 FOR FILL UNDER THE GARAGE FLOOR OR BASEMENT FLOOR, PROVIDE SAND/ GRAVEL FILL FOR COMPACTION AS NEEDED

- CONCRETE BLOCK SHALL CONFORM TO ASTM C40 N-1, MALL REINFORCING ASTM A82.
 ALL MORTAR SHALL CONFORM TO ASTM C210, TYPE 3 I PART PORTLAND CEMENT, I/4 PART LIME, S PARTS SAND.
- STRUCTURAL STEEL SHALL CONFORM TO ASTM AS6, SHOP-PRIME PAINT TT-P-20, TT-P-SIC TT-P-86, FABRICATION AND INSTALLATION PER THE LATEST EDITION OF THE AISC MANUAL AND SPECIFICATIONS.
- MINIMM FIBER STRESS IN BENDING (FB) FOR ALL FRAMING LIMBER TO BE IIBO PSI \$2 HEM-FIR OR BETTER, PROVIDE DOUBLE FRAMING MEMBERS UNDER PARTITIONS RUNNING IN SAME DIRECTION.
- (O. CONTRACTOR SHALL PAY STRICT ADHERENCE TO MICROLAM MANUFACTURER'S WRITTEN DIRECTIONS FOR CUTTING, DRILLING, NOTCHING, JOINING AND GENERAL INSTALLATION OF THEIR PRODUCTS.
- II. MOOD TRUSSES SHALL BE DESIGNED BY MANUFACTURER. SUPPLIER SHALL BE RESPONSIBLE FOR INSTALLATION DETAILS AND REQUIRED DRUGSING-SPACING.
- PLYMOOD SHALL CONFORM TO U.S. PRODUCT STANDARD PS I, THICKNESS AS SHOWN, APA RATED SHEATHING EXP-I. NAILING AND SPACING PER APA RECOMMENDATIONS FOR LOCATIONS INTENDED.
- 15. CONTRACTOR SHALL VERIFY ALL NOTES AND DIMENSIONS PRIOR TO CONSTRUCTION. THESE DRAWINGS ARE NOT TO BE SCALED USE DIMENSIONS GIVEN.
- 16. CONTRACTOR SHALL BE RESPONSIBLE FOR ALL CONSTRUCTION MEANS, METHODS, TECHNIQUES SEQUENCES AND SAFETY PRECAUTIONS IN CONNECTION WITH THE WORK
- THESE DRAMINGS HAVE BEEN PREPARED FOR STRUCTURAL INTENT ONLY. ELECTRICAL, MECHANICAL AND OTHER BUILDING SYSTEMS, AS REQUIRED ARE TO BE DESIGNED BY OTHERS. 18. THE FOLLOWING DESIGN LOADS HAVE BEEN USED IN THE STRUCTURES DESIGN IN ACCORDANCE WITH THE PRINTED SPAN TABLES IN THE RESIDENTIAL CODE OF NEW YORK STATE (2020).
- FLOOR LOADS (LIVING AREAS-IST FLOOR)

 9. EEPING AREAS (2ND FLOOR)


 9. PSF
 EXTERIOR DECKS

 40 PSF [4] ALL WORK, MATERIALS, METHODS, EQUIPMENT, ETC. SHALL BE IN STRICT ACCORDANCE WITH THE CONTRACT DOCUMENTS. ALL MATERIALS SHALL BE NEW, UNLESS NOTED OTHERWISE.
- 20. WORK SEQUENCE AND SCHEDULE SHALL BE MITUALLY AGREED UPON BY BOTH THE OWNER AND THE CONTRACTOR.
- 21. IT IS ASSUMED THAT THE SUBSURFACE CONDITIONS WILL BE EARTH OR SOIL, IF BEDROCK IS ENCOUNTERED, REMOVAL WILL BE CONSIDERED AN ADDITION TO CONTRACT. 22. ANY DEMOLITION WORK SHALL BE DONE CAREFULLY, ALL DISTURBED SURFACES TO BE REPAIRED APPROPRIATELY, ALL SALVASEABLE ITEMS SHALL BE TURNED OVER TO THE OWNER.
- 23. EXAMINATION OF THE SITE SHOULD BE MADE BY ALL CONTRACTORS CONCERNED TO FULLY CONSIDER ALL SITE CONDITIONS MINICH MAY HAVE A BEARING ON THE MORK OF THE ENTIRE FROLECT, SUBMISSION OF A BID IS PRESUMFITIVE SYDENCE THAT THE BIDDER IS CONVERSANT WITH LOCAL JURISDICTIONS AND HAS MADE DUE ALLOWANCES IN HIS BID FOR ALL CONTINGENCIES, THE OWNER RESERVES THE RIGHT TO RELECT ANY OR ALL BIDS.

- 26. THE CONTRACTOR SHALL FURNISH A CERTIFICATE OF INSURANCE INDICATING THE TYPE AND AMOUNTS OF COVERAGE AS REQUIRED BY NEW YORK STATE AND THE LOCAL MUNICIPALITY.
- 27. THE CONTRACTOR SHALL REMOVE ALL RUBBISH AND LEAVE THE COMPLETED PROJECT IN A CLEAN STATE, SATISFACTORY TO THE OWNER.
- 28. THE CONTRACTOR SHALL GUARANTEE HIS WORK AND HIS SUBCONTRACTOR'S WORK AGAINST FAULTY MATERIALS AND WORKMANSHIP IN ACCORDANCE WITH NEW YORK STATE GENERAL BUSINESS LAW.
- 29. ONLY COPIES FROM THE ORIGINALS OF THESE DRAWINGS MARKED WITH AN ORIGINAL OF THE ARCHITECT'S WET SEAL SHALL BE CONSIDERED TO BE VALID TRUE COPIES.
- 30. BUILDING IS CLASSIFIED AS A ONE FAMILY DWELLING 3]. SMOKE-DETECTING ALARM DEVICES SHALL BE INSTALLED IN COMPLIANCE WITH SECTION RSIS.I OF THE RESIDENTIAL CODE OF NEW YORK STATE (2020)
- 32. PROVIDE A MIN. 9/4 HR. FIRE SEPARATION PER SECTION RSC4.2 OF THE RESIDENTIAL CODE OF NEW YORK STATE (2020) ALL WALLS AND FLOORS DEMISING RESIDENCE FROM AN ATTACHED GARAGE

33. ALL MATERIALS USED IN THIS PROJECT SHALL BE NON-ASBESTOS AND NON-LEAD CONTAINING.

CARBON MONOXIDE ALARM DEVICES SHALL BE INSTALLED IN COMPLIANCE WITH SECTION RSIS.4 OF THE BUILDING CODE OF NEW YORK STATE (2020)

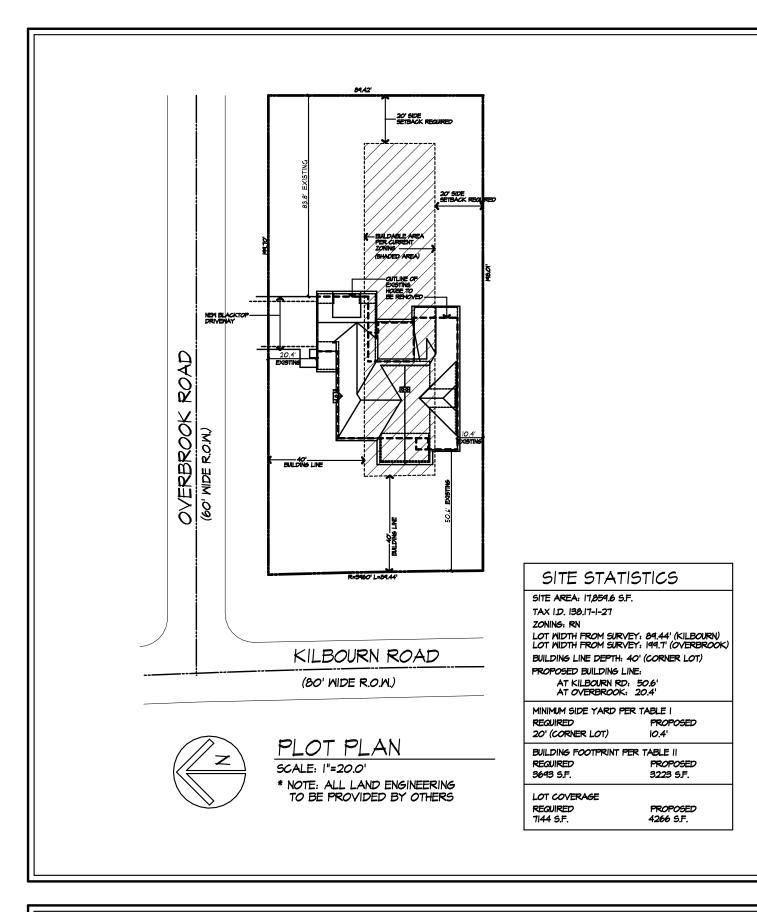

PROPOSED RESIDENCE

180 KILBOURN ROAD

TOWN OF PITTSFORD, NEW YORK

DDAW/ING INDEX

DRAWING INDEX			
1	TITLE PAGE		
2	FRONT / LEFT SIDE ELEVATIONS		
3	REAR / RIGHT SIDE ELEVATIONS		
4	PROPOSED FOUNDATION PLAN		
5	PROPOSED 1ST FLOOR PLAN		
6	PROPOSED 2ND FLOOR PLAN		
7	PROPOSED ROOF PLAN		

BUILDING SECTIONS BUILDING SECTIONS

TYPICAL DETAILS

ENERGY COMPLIANCE DETAILS & PATH MEETS OR EXCEEDS PRESCRIPTIVE REQUIREMENTS (2020 BUILDING CODE OF NEW YORK STATE) CLIMATE ZONE - 5			
COMPONENT	REGUIRED	PROVIDED	
I. FENESTRATION U-FACTOR	.92	.92	
2. CEILING R-FACTOR	49	49	
9. WOOD FRAME WALL R-VALUE	20 OR 1945	HIGH DENSITY 21 21/BAND JSTS	
4. FLOOR R-FACTOR	R-30	R-80	
5. SLAB R-FACTOR	R-10e24" R-5 SLAB EDGE	R-IO024" R-5 SLAB EDGE	

2020 INTERNATIONAL ENERGY CONSERVATION CODE (IECC) COMPLIANCE PATH

I. A MINIMAM OF 15th OF THE LAMPS IN FERWARKILY INSTALLED LIGHTING FIXTURES SHALL SE HIGH-EFFICIENCY LAMPS FER SECTION (IO4.) 2. RECEISED LIMINARIES INSTALLED IN THE BILLDING THERMAL ENVELOTE SHALL BE SEALED INTH A SMIKET OR CAULK BETHERN THE HOUSING AND THE INTERIOR HALL OR CELLING COVERING TO LIMIT ARE LEXAGE BETHERN CONDITIONED AND INCODDITIONED SPACES, FER SECTION 102AS 3. CONTRACTOR TO PROVIDE A PROGRAMMABLE THERMOSTAT TO CONTROL THE HVAC SYSTEM PER SECTION ICOLI

4. ALL CIRCLATING SERVICE HOT PATER PIPING SHALL BE INSULATED TO AT LEAST R.2. CIRCLATION HOT PAYER SYSTEMS SHALL INCLIDE AN AUTOMATIC OR READILY ACCESSED HAMILL SYSTEM THAT CAN TIMN OFF THE HOT PATER CIRCLATING PLAY PREN THE SYSTEM HOT IN USE PER SECTION HOUSE.

5. AR LEAKAGE TEST TO BE CONDUCTED & PERFORMED BY A THIRD PARTY IN COMPLIANCE MITH 102.4.1.2, AIR LEAKAGE RATE MAY NOT EXCEED 5 ACH (CLIMATE 20NE 5) 6. ATTIC ACCESS SHALL BE INSULATED WITH THE SAME R-VALUE AS THE ATTIC, MEATHER STRIPPED AND LATCHED PER SECTION 102225

 DUCTPORK ON EXTERIOR MALLS IF REQUIRED SHALL BE INSULATED TO A MINIMUM OF RAF FER 11:08.2.1 8. MECHANICAL VENTILATION PER SECTION NIIOSA TO SE MET MITH CONTINUCIS USE EMANUST PANS AND MAKE-UP AIR CONTROLS, PER SECTION MISTORS & EMGRIMMENT 4. MECHANICAL VENTILATION FAN EFFICACY SHALL MEET MINIMAM REGUIRE-48115 FER SECTION NICOLAL

BASIC DESIGN CRITERIA

- 2. MIND SPEED 115 MPH, EXPOSURE B REGIL21
- 8. SEISHIC DESIGN CATESORY A RSOL2 (2)

IO. HEATING AND COOLING EQUIPMENT SHALL SE SIZED IN ACCORDANCE WITH SECTION NICO,T REGULER-MENTS.

- 4. MEATHERING SEVERE 5. FROST LINE DEPTH - 48"
- 6. TERMITE DAMAGE NONE TO SLIGHT 7. DECAY DAMAGE - NONE TO SLIGHT
- 6. MINTER DESIGN TEMPERATURE I 4. KE SHELD UNDERLAYHENT REGUIRED - YES
- IO. FLOOD HAZARD FIRM 1442 II. ROOF TIE DOWN REGUIREMENTS RECZ.II.J



121 Sully's Trail Pittsford, NY 14534

(585) 264-1330 (585) 264-1333 Fax

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PROPOSED RESIDENCE IBO KILBOURN RD TOWN OF PITTSFORD, NEW YORK


RON BILLITIER DRAWING: TITLE PAGE

FEBRUARY 2021

SCALE: **1/4"=1'-0"** JOB NO.: ISO KILBOURN

OF 10 SHEETS

TOTAL FOOTPRINT: 3223 SQ FT

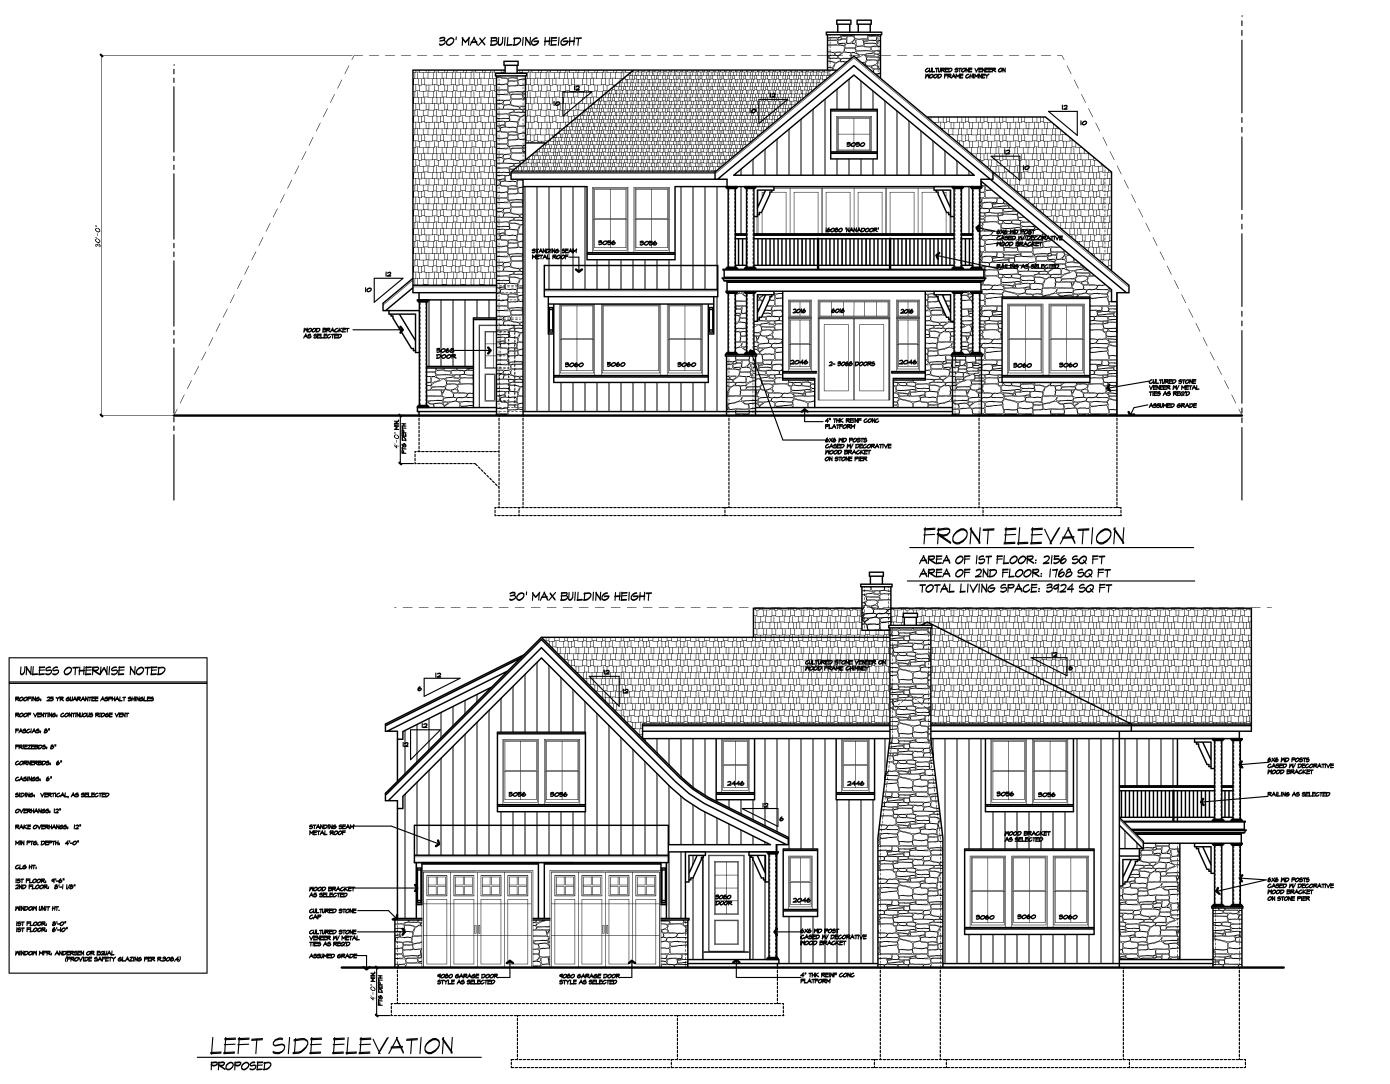



PROJECT:
PROPOSED RESIDENCE
ISO KILBOURN RD
TOWN OF PITTSFORD, NEW YORK


DATE: FEBRUARY 2021


SCALE: 1/4"=1"-0"

JOB NO.: ISO KILBOURN

OF 10 SHEETS

CLIENT: RON BILLITIER

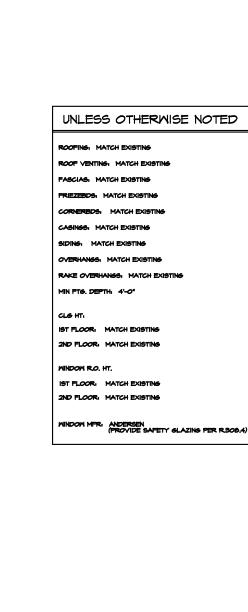

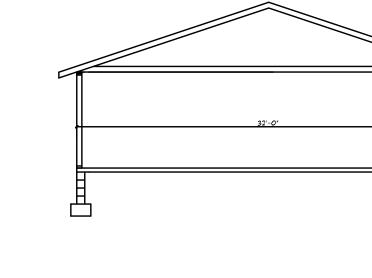

UNLESS OTHERWISE NOTED

ROOFING, 25 YR GUARANTEE ASPHALT SHINGLES
ROOF VENTING, CONTINUOUS RIDGE VENT
FASCIAG, 8°

FRIEZZEDG, 8°

CASINGS, 6°

SIDING, HORIZ, AS SELECTED

OVERHANGS, I'-4°

RAKE OVERHANGS, IZ°

MIN FTG, DEPTH, 4'-0°

CLG HT.


IST FLOOR, 4'-6°


2ND FLOOR, 8'-1 I-6°


MINDOW MITH, ANDERSEN OR EGUAL


(FROVIDE SAFETY GLAZING FER RIGGS.4)

REAR ELEVATION PROPOSED

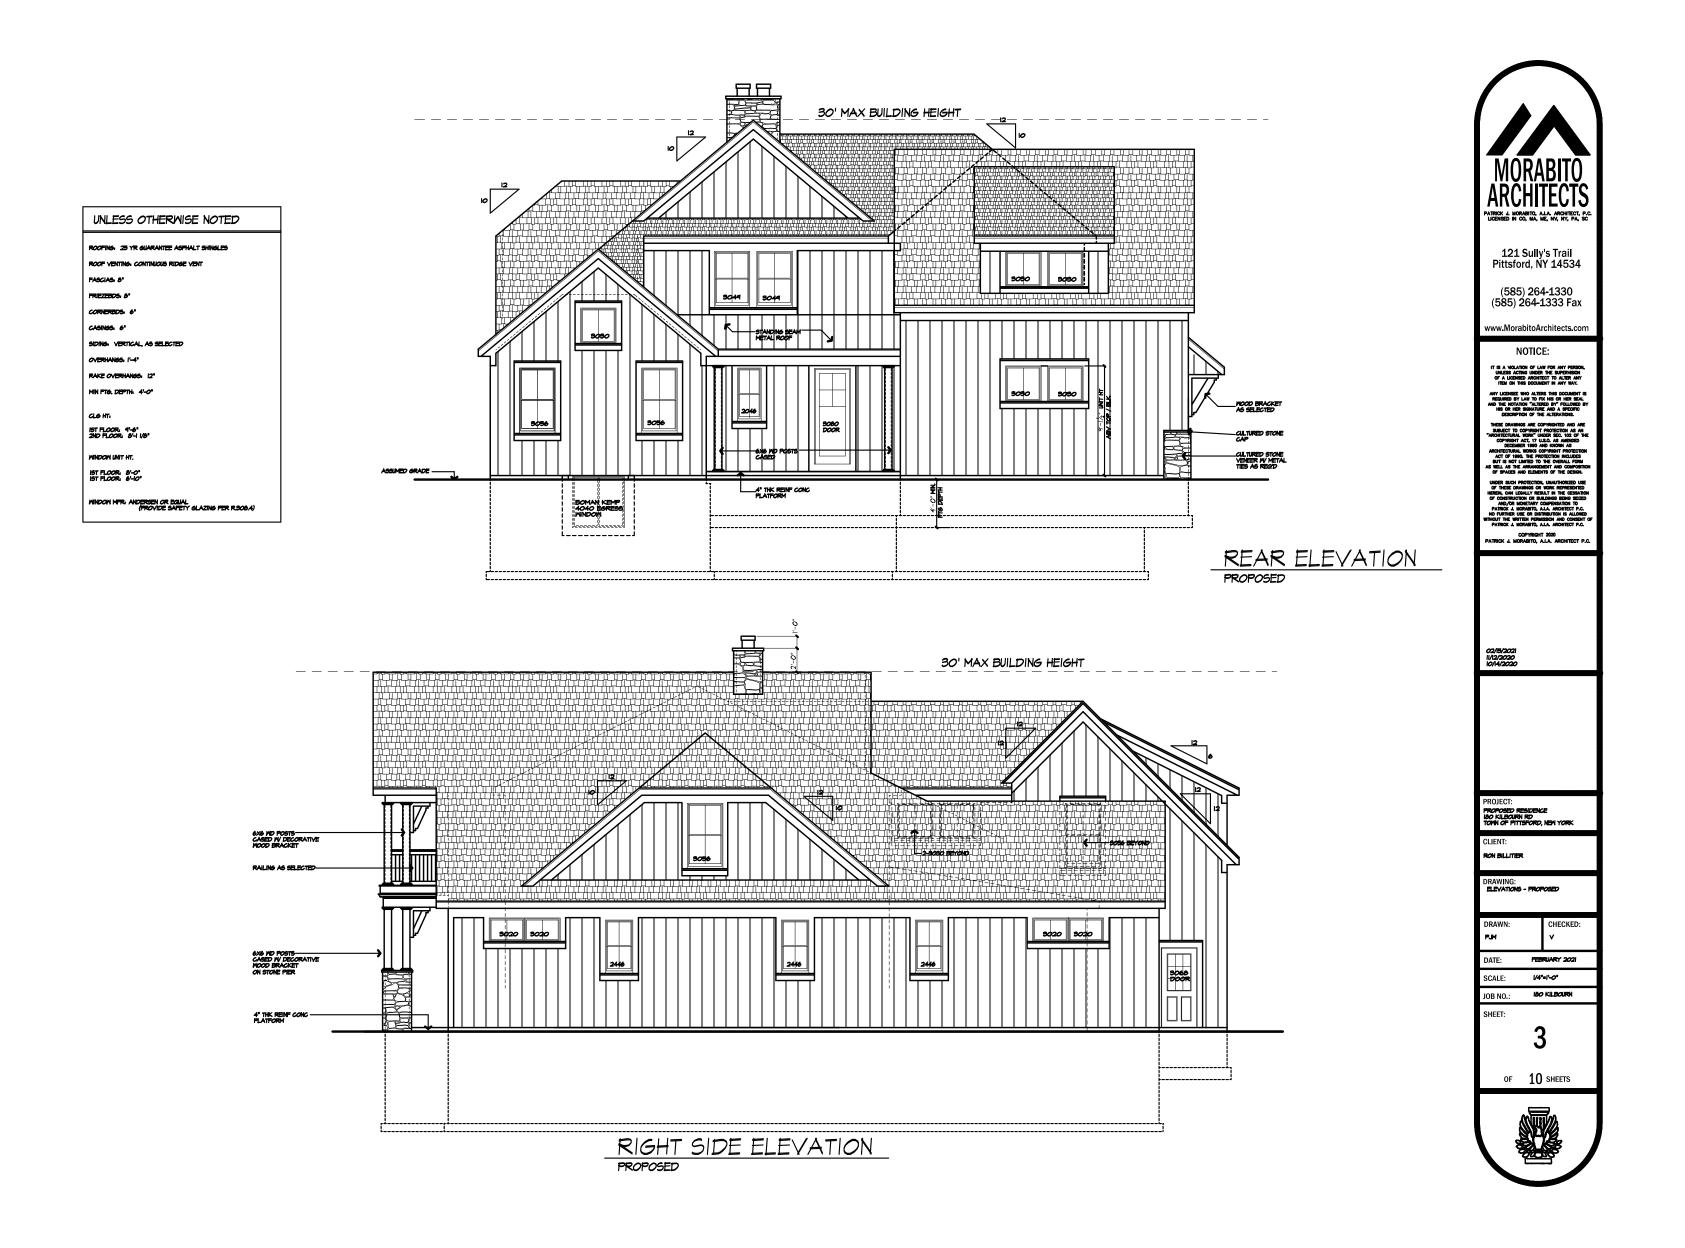

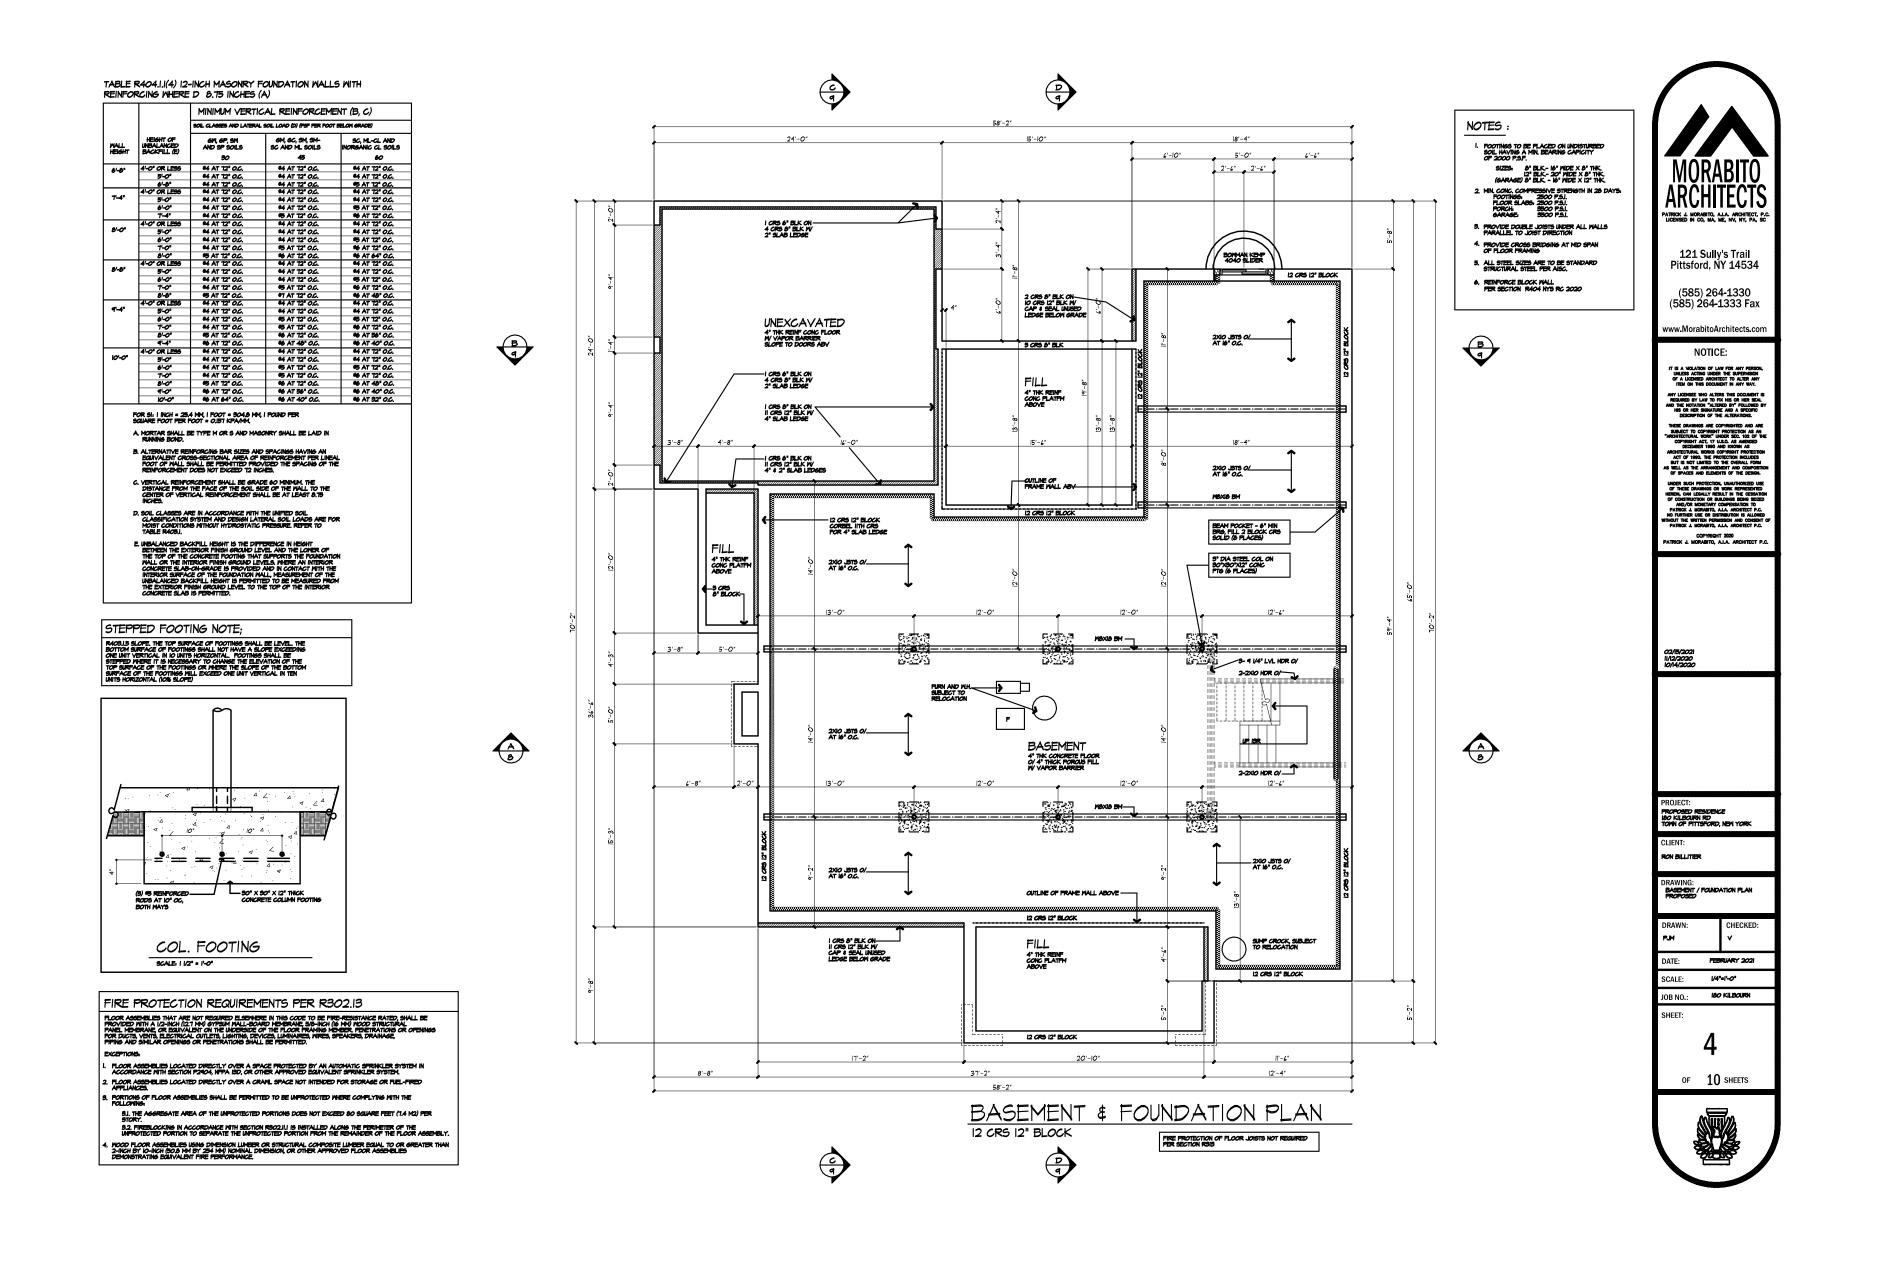


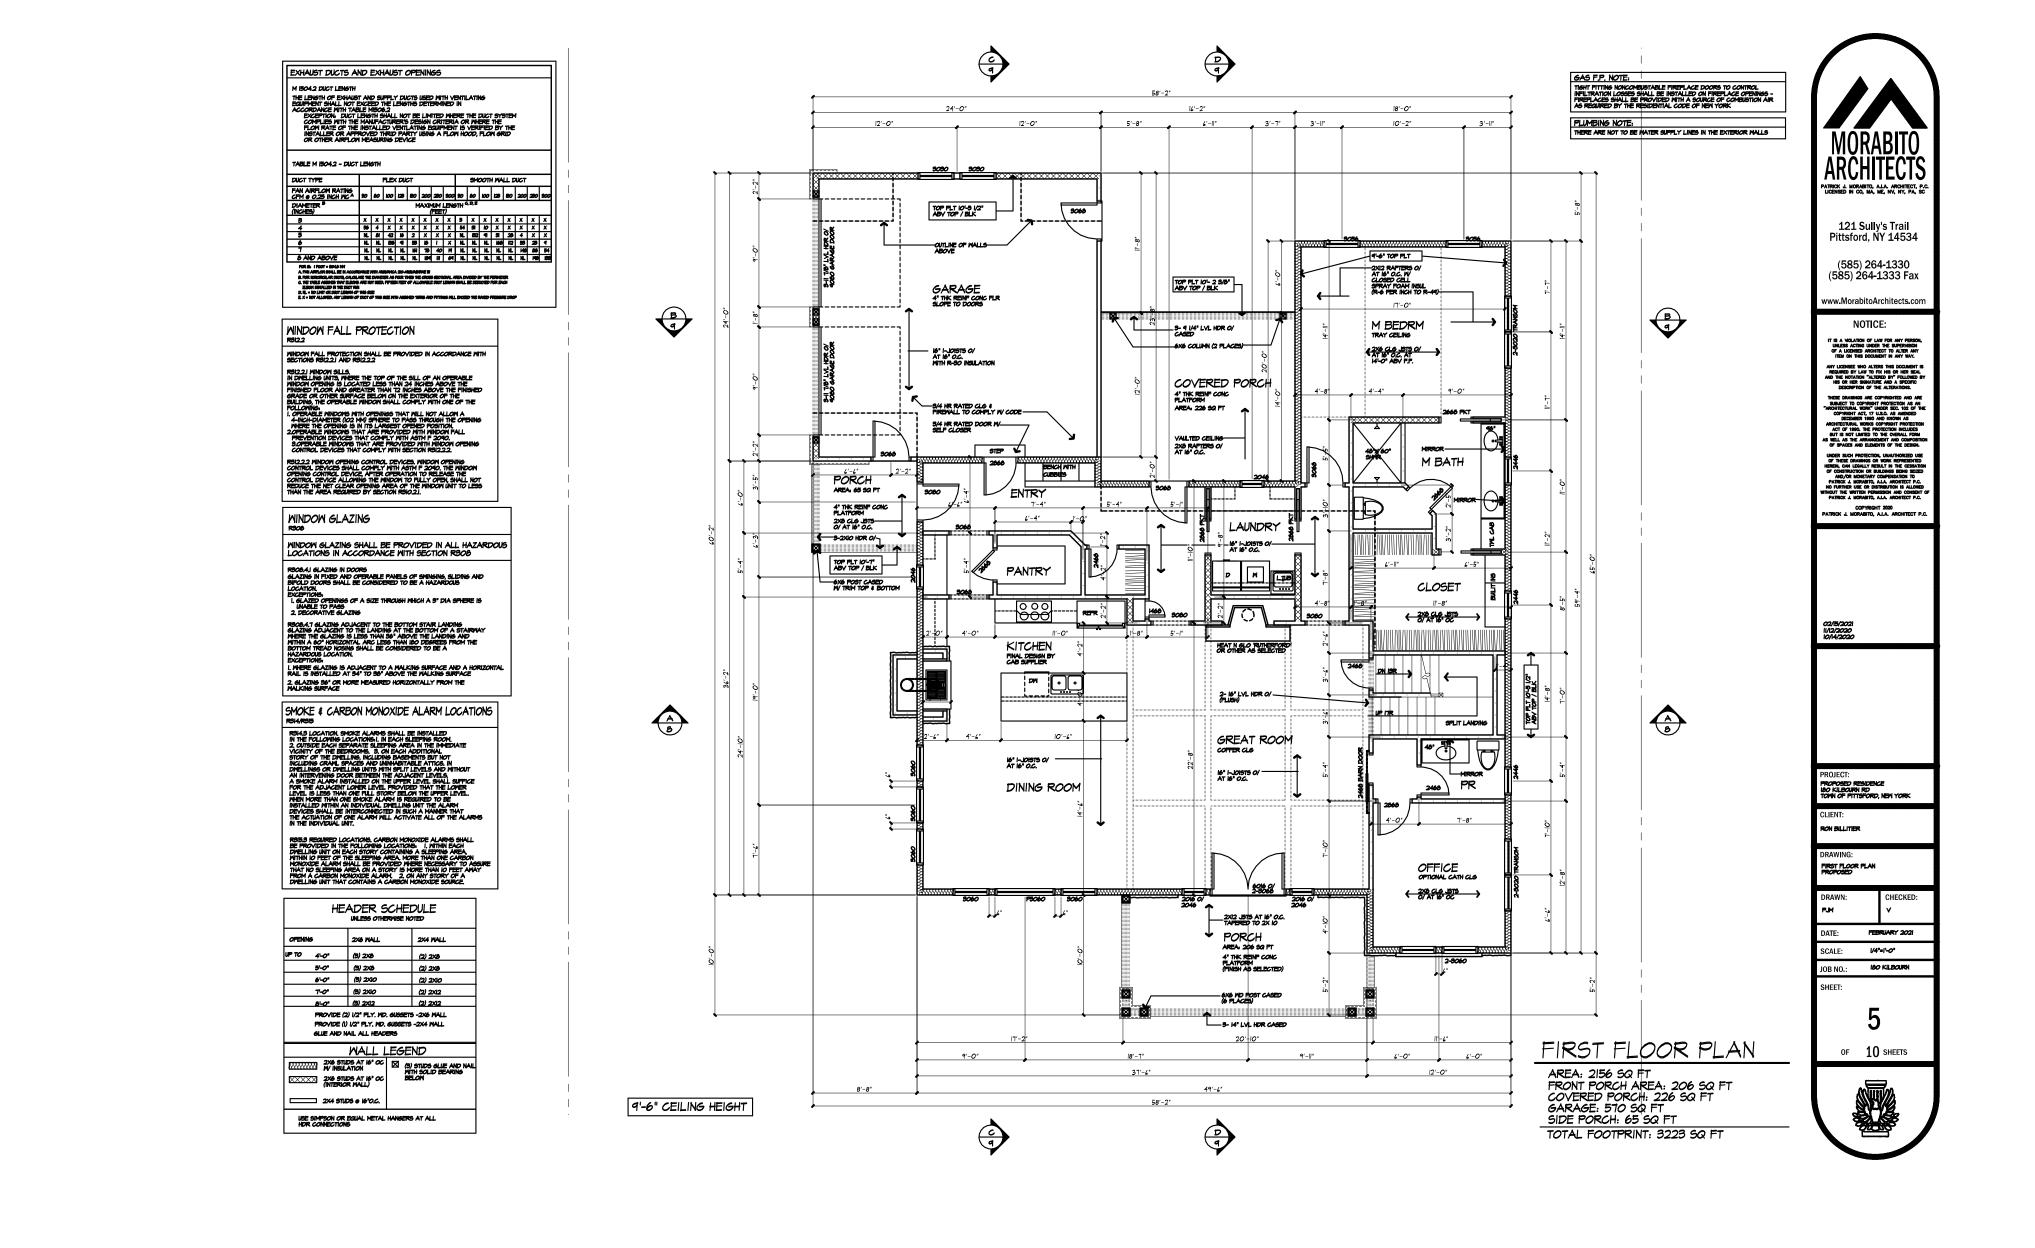


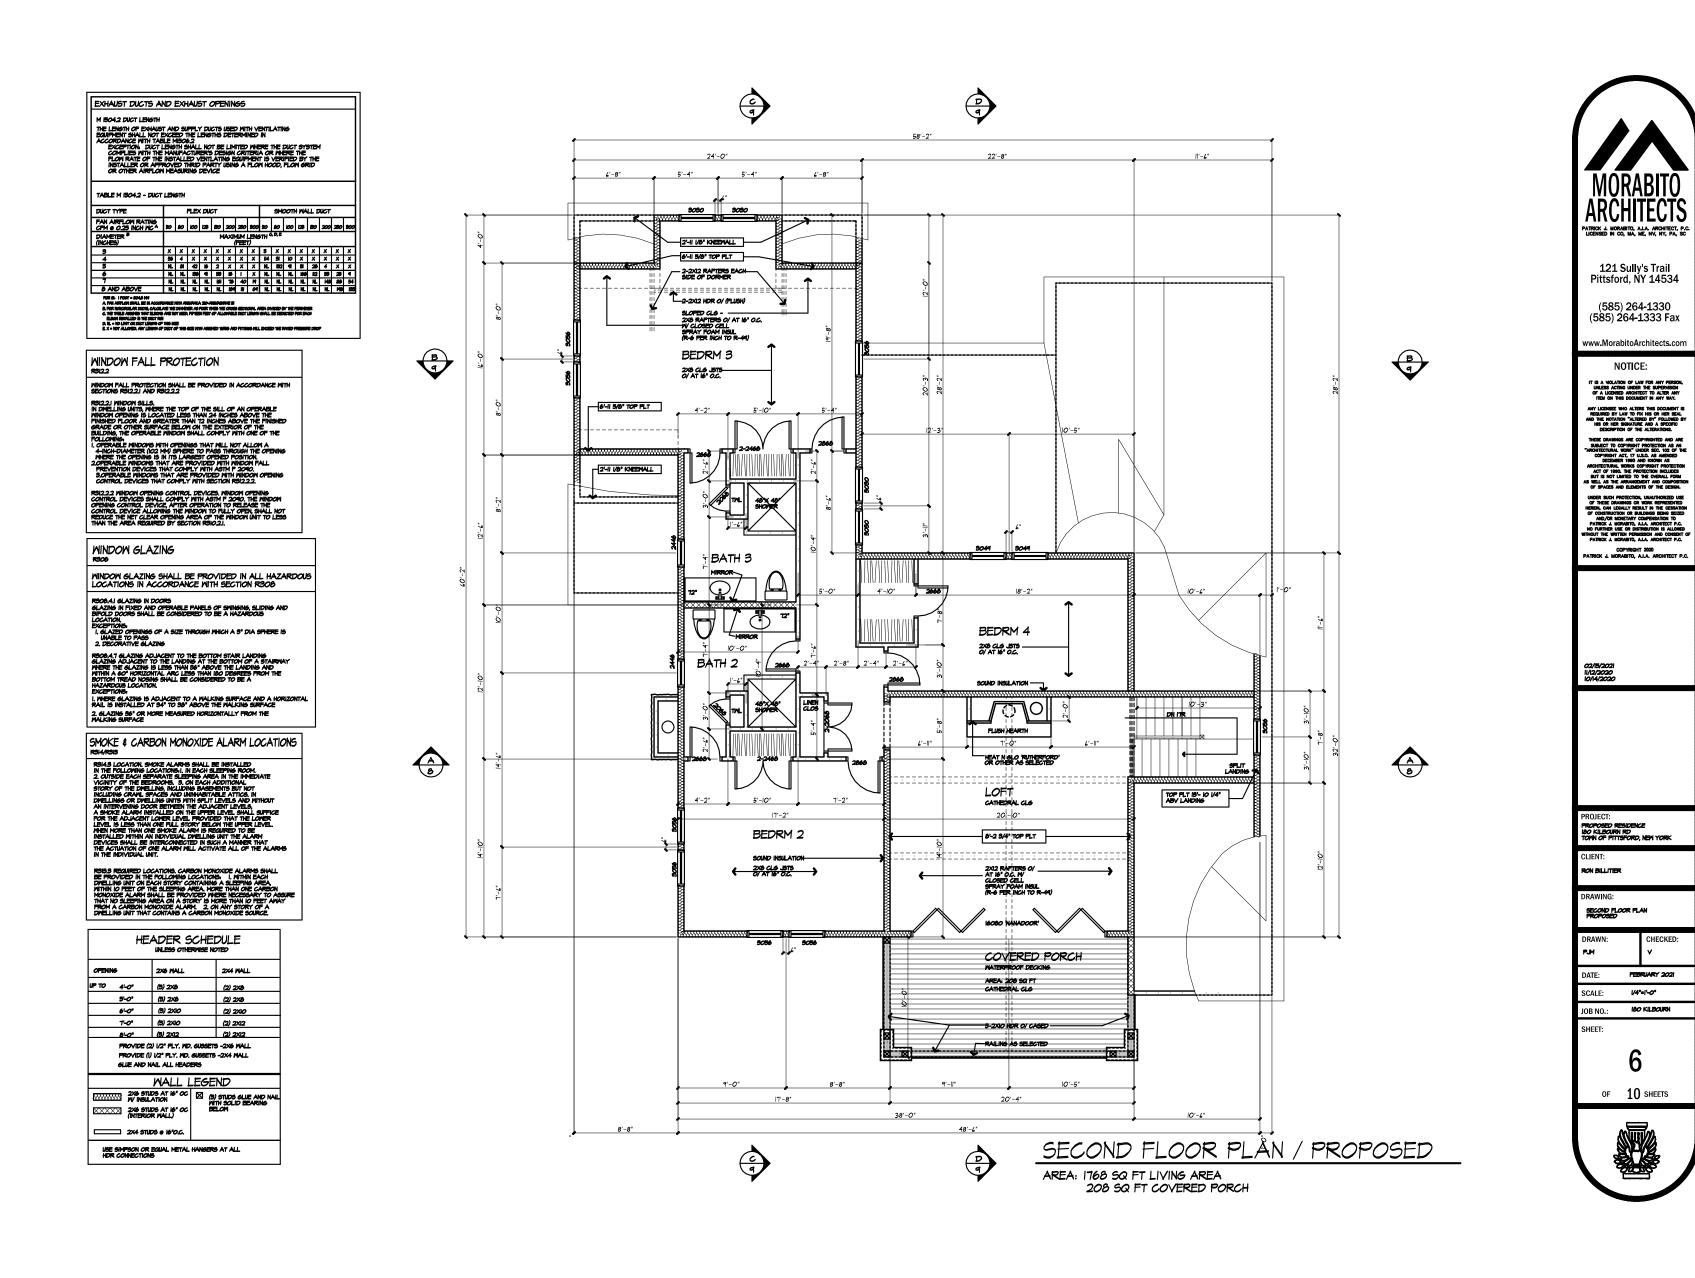



B 7


ROOF PLAN

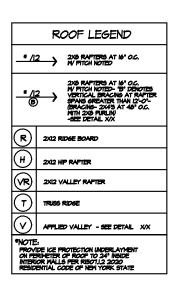

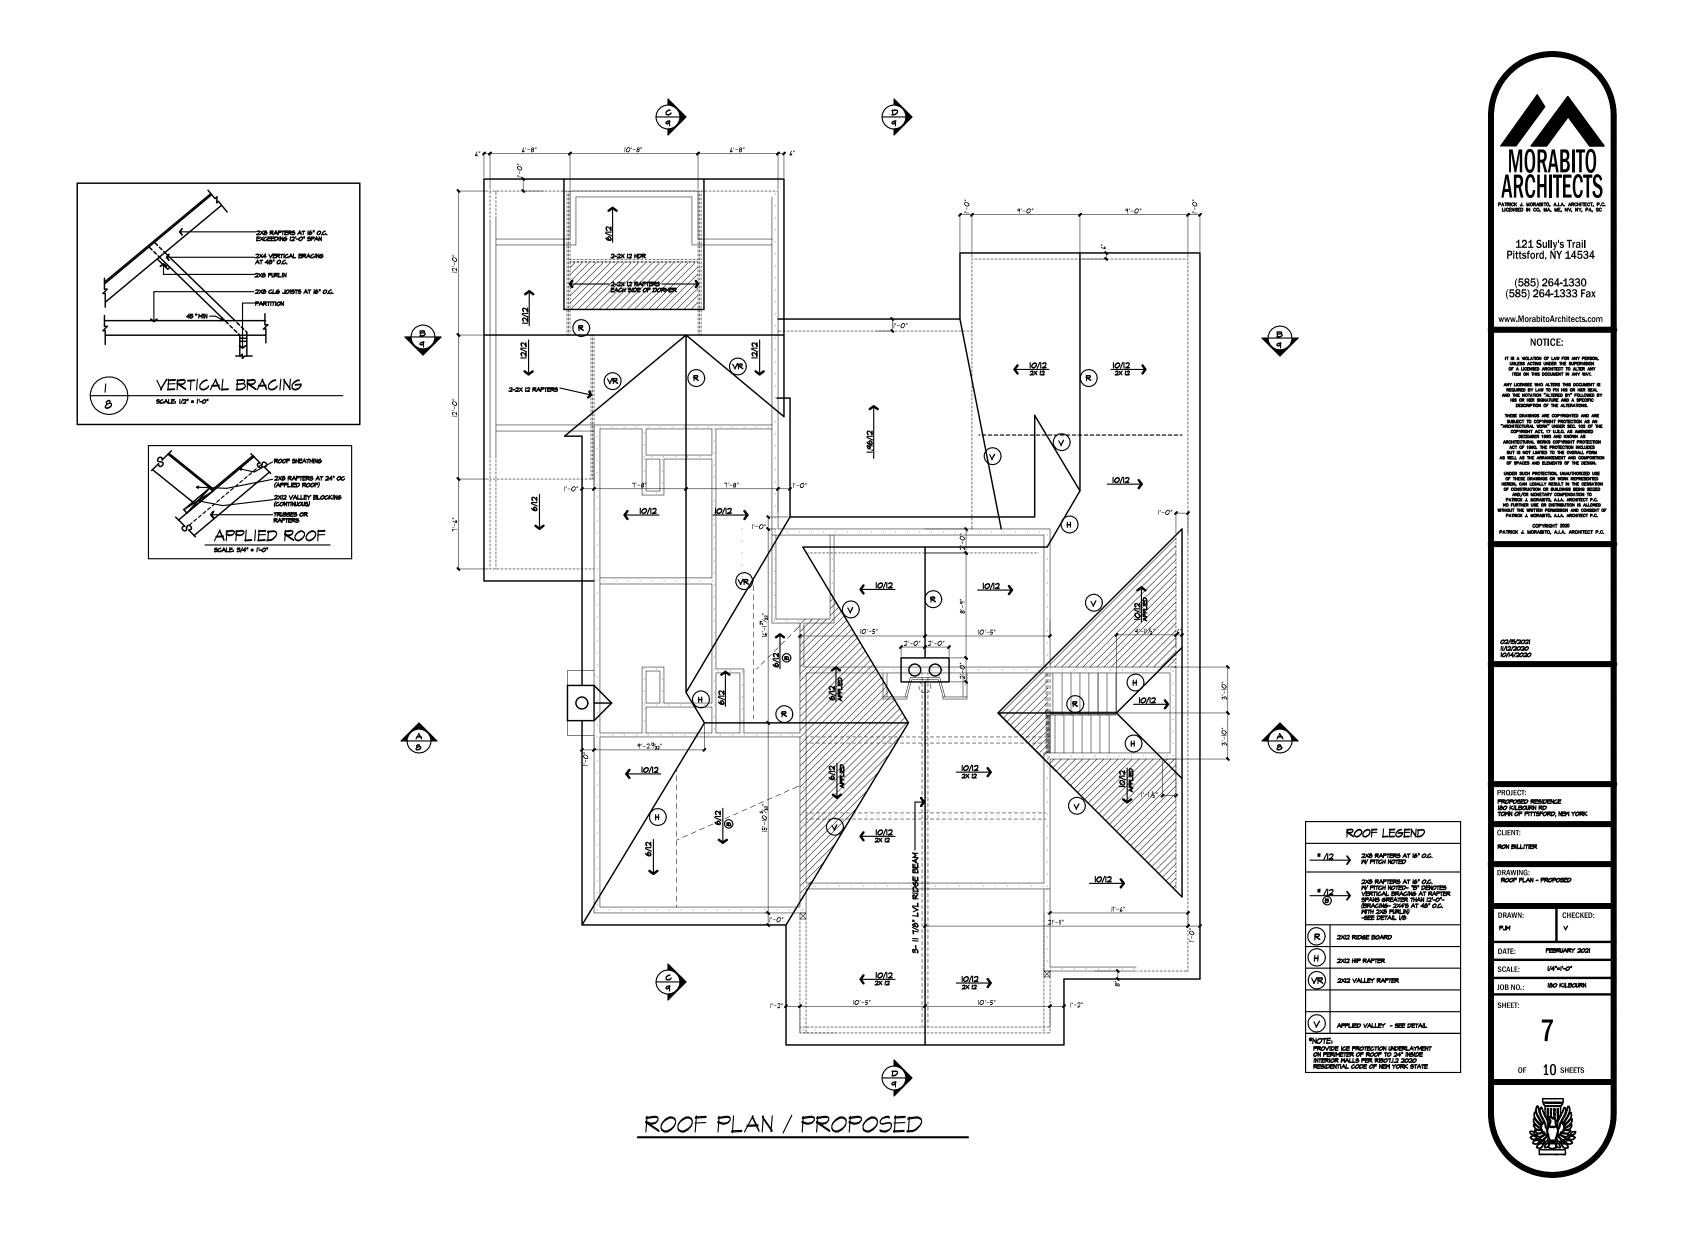

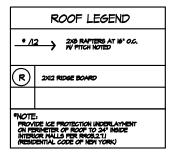

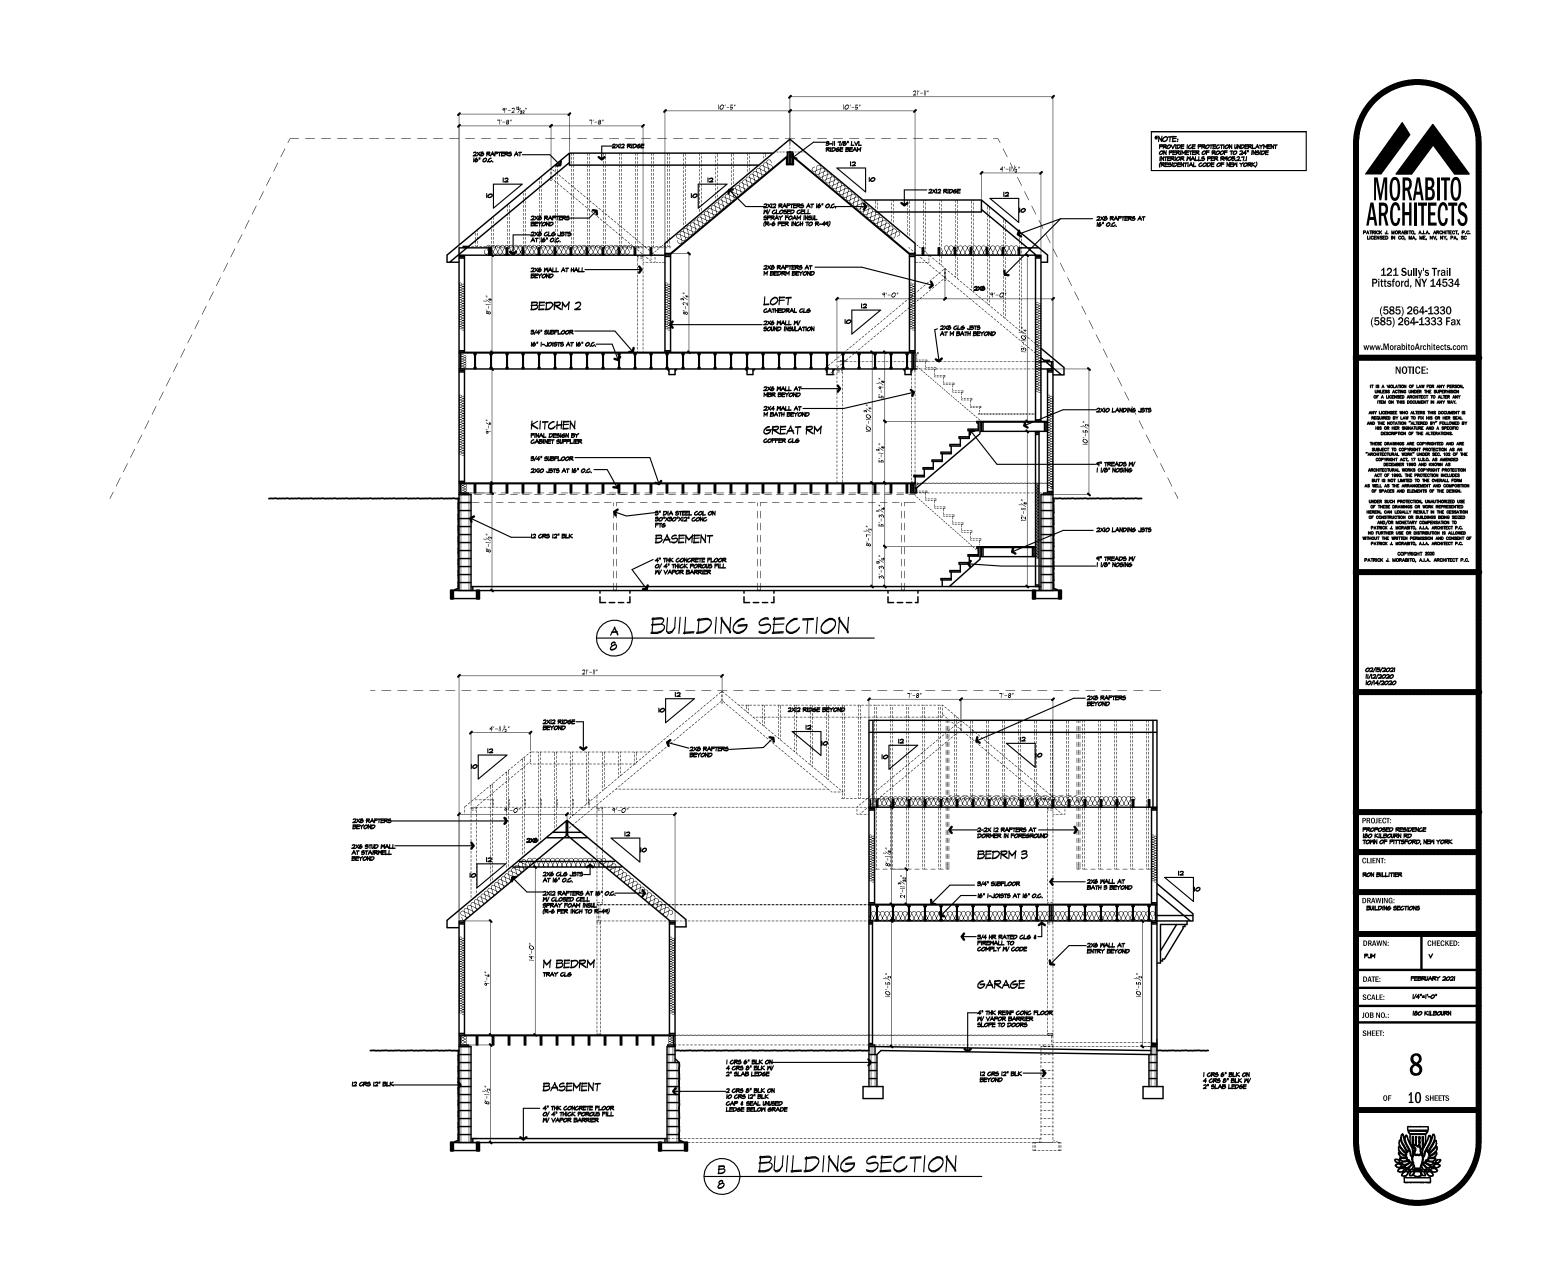

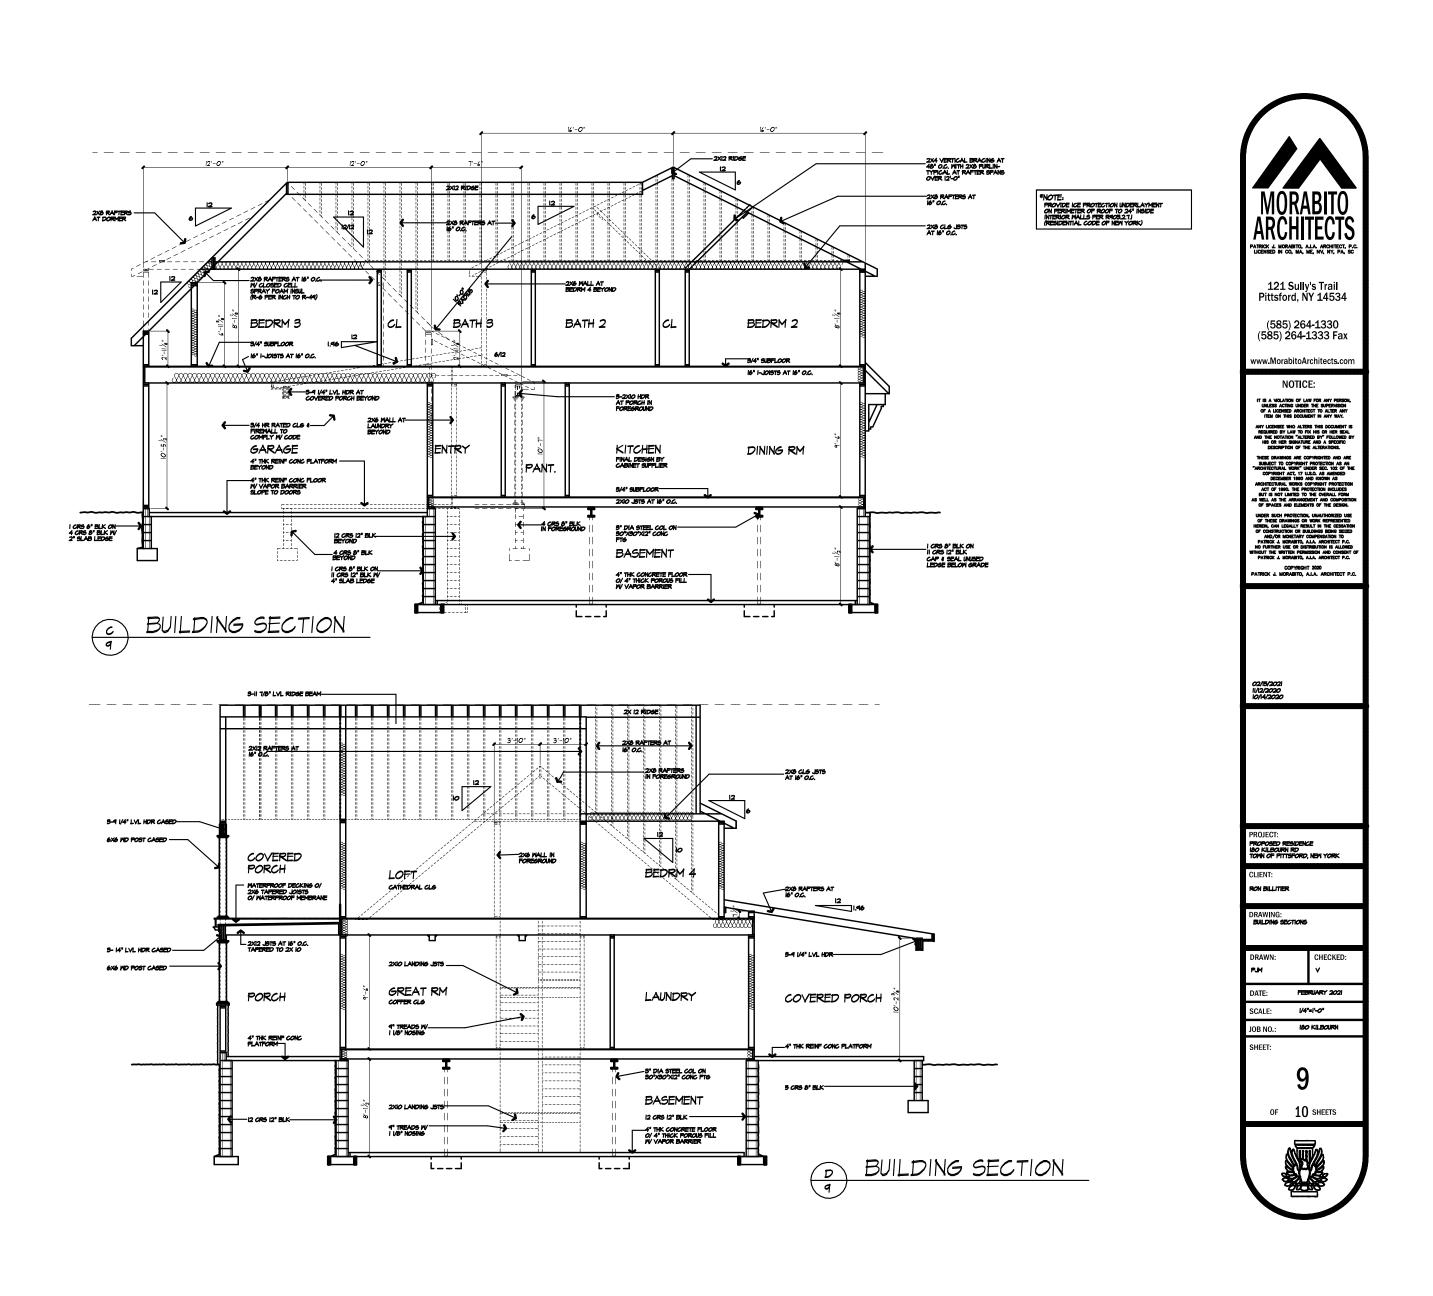


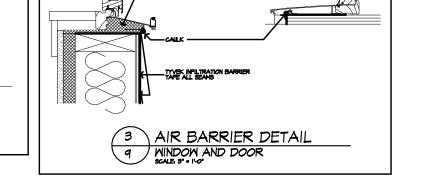


TABLE NIIO2.4.2 AIR BARRIER AND INSULATION INSPECTION COMPONENT CRITERIA


COMPONENT CRITERIA	
COMPONENT	CRITERIA
ALBACEUR AND	EXTERIOR THERMAL ENVELOPE INSULATION FOR PRACTICE OF INSULATION OF THE PRACTICE OF THE PRACTIC
	BREAKS OR JOINTS IN THE AIR BARRIER ARE FILLED OR REPAIRED
	AIR PERMEABLE INSULATION IS NOT USED AS A SEALING MATERIAL
	AIR PERMEABLE INSULATION IS INSIDE OF AN AIR BARRIER
CEILINS/ATTIC	AS BASSASSAS AND ESTABLISHED AND ASSET
MALLS	CORNERS AND HEADERS ARE INSULATED
	JINCTION OF FOUNDATION AND SILL PLATE IS SEALED
MINDOMS AND DOORS	SPACE BETTYEEN WINDOW AND DOOR JAMS AND FRAMING IS SEALED
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NARROW CAVITIES	BATTS IN NATION CAST FILES BY SHIZA TELOCOM INCLUSION
GARAGE SEPARATION	AIR SEALING IS PROVIDED BETHEEN GARAGE AND
RECESSED LIGHTING	N CANATA OF STATE SEAS JUST LANGE TO.
PLUMBING AND MIRING	INSULATION IS PLACED BETWEEN OUTSIDE AND PIPES
SHOWER OR THE ON EXTERIOR WALL	THE COME WITH COME STATE
BOX ON EXTERIOR WALLS	AR BARRIER EXTENDS BEHIND BOXES OR AIR STALLED THE BOXES ARE INSTALLED
	COMPONENT THEN ALE BANKER CELING/ATTIC MALLS WINDOWS AND DOORS SHAPTS PENETRATIONS NARROW CAVITIES GARAGE SEPARATION RECESSED LIGHTING PLIABING AND PIRING SHOULD OR THE CH





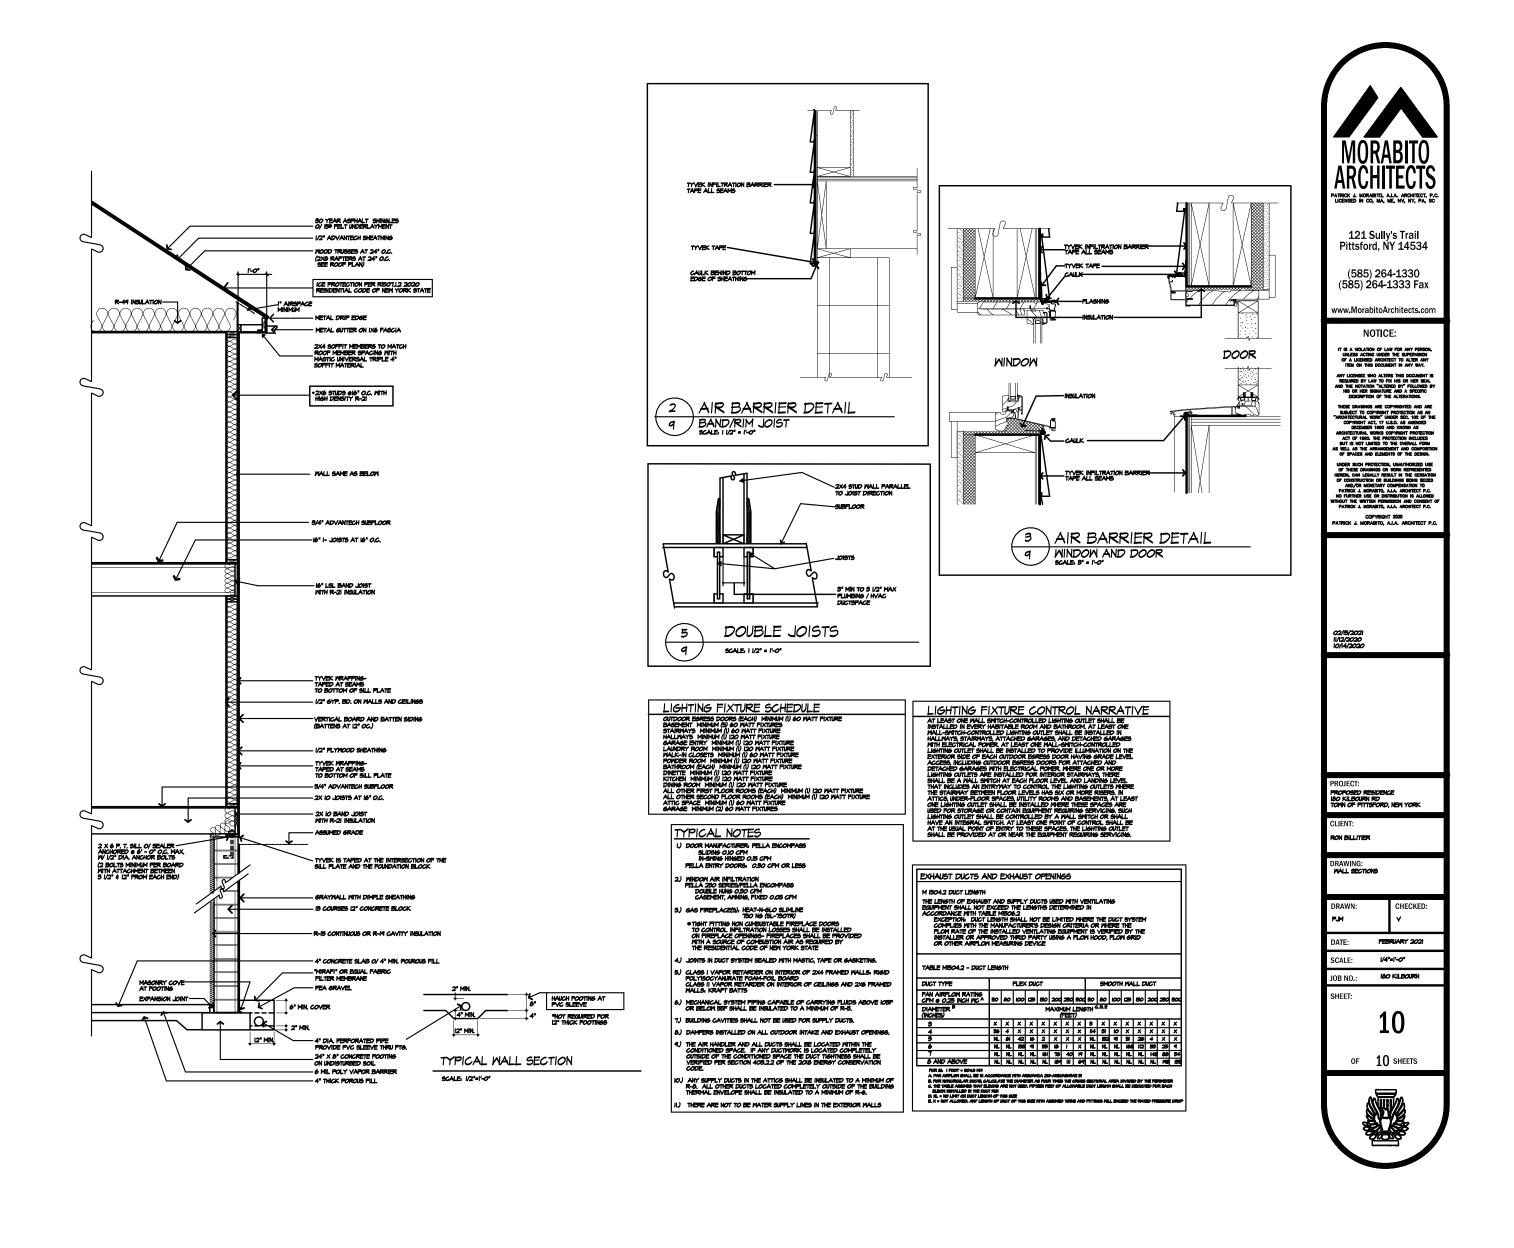



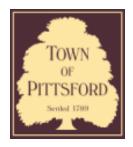

Town of Pittsford

Department of Public Works 11 South Main Street Pittsford, New York 14534

Permit # B21-000042

Phone: 585-248-6250 FAX: 585-248-6262

DESIGN REVIEW AND HISTORIC PRESERVATION BOARD REFERRAL OF APPLICATION

Property Address: 19 Black Wood Circle PITTSFORD, NY 14534

Tax ID Number: 178.03-5-35

Zoning District: IZ Incentive Zoning

Owner: Wilshire Hill LLC Applicant: Wilshire Hill LLC


Application Type:

. #	Residential Design Review	Build to Line Adjustment
✓	§185-205 (B)	§185-17 (B) (2)
	Commercial Design Review	Building Height Above 30 Feet
	§185-205 (B)	§185-17 (M)
	Signage	Corner Lot Orientation
	§185-205 (C)	§185-17 (K) (3)
	Certificate of Appropriateness	Flag Lot Building Line Location
	§185-197	§185-17 (L) (1) (c)
	Landmark Designation	Undeveloped Flag Lot Requirements
	§185-195 (2)	§185-17 (L) (2)
	Informal Review	


Project Description: Applicant is requesting design review for the construction of a one story single family home. The home will be approximately 2371 square feet in the Wilshire Hills Subdivision.

Meeting Date: March 11, 2021

RN Residential Neighborhood Zoning

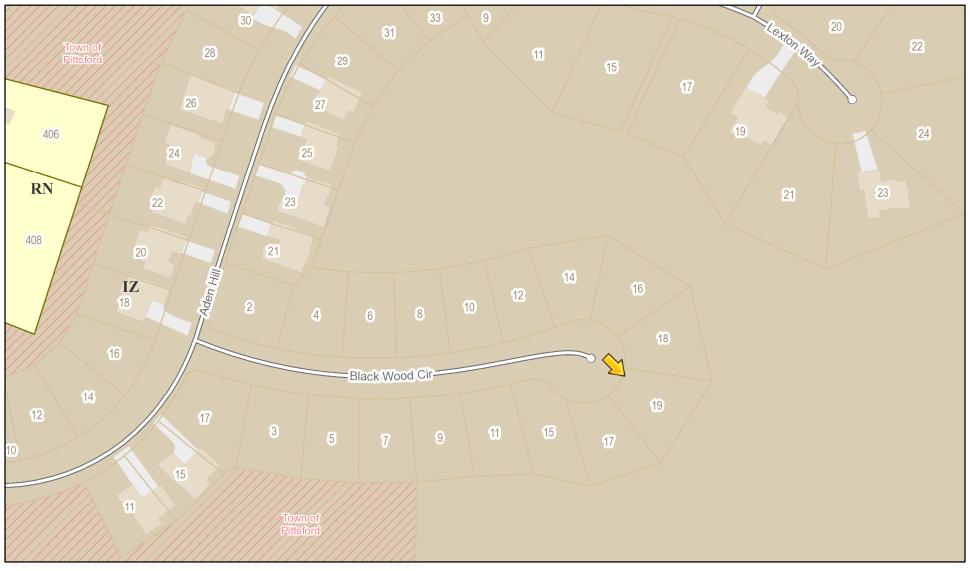


Printed March 4, 2021

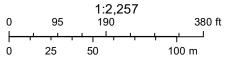

Town of Pittsford GIS

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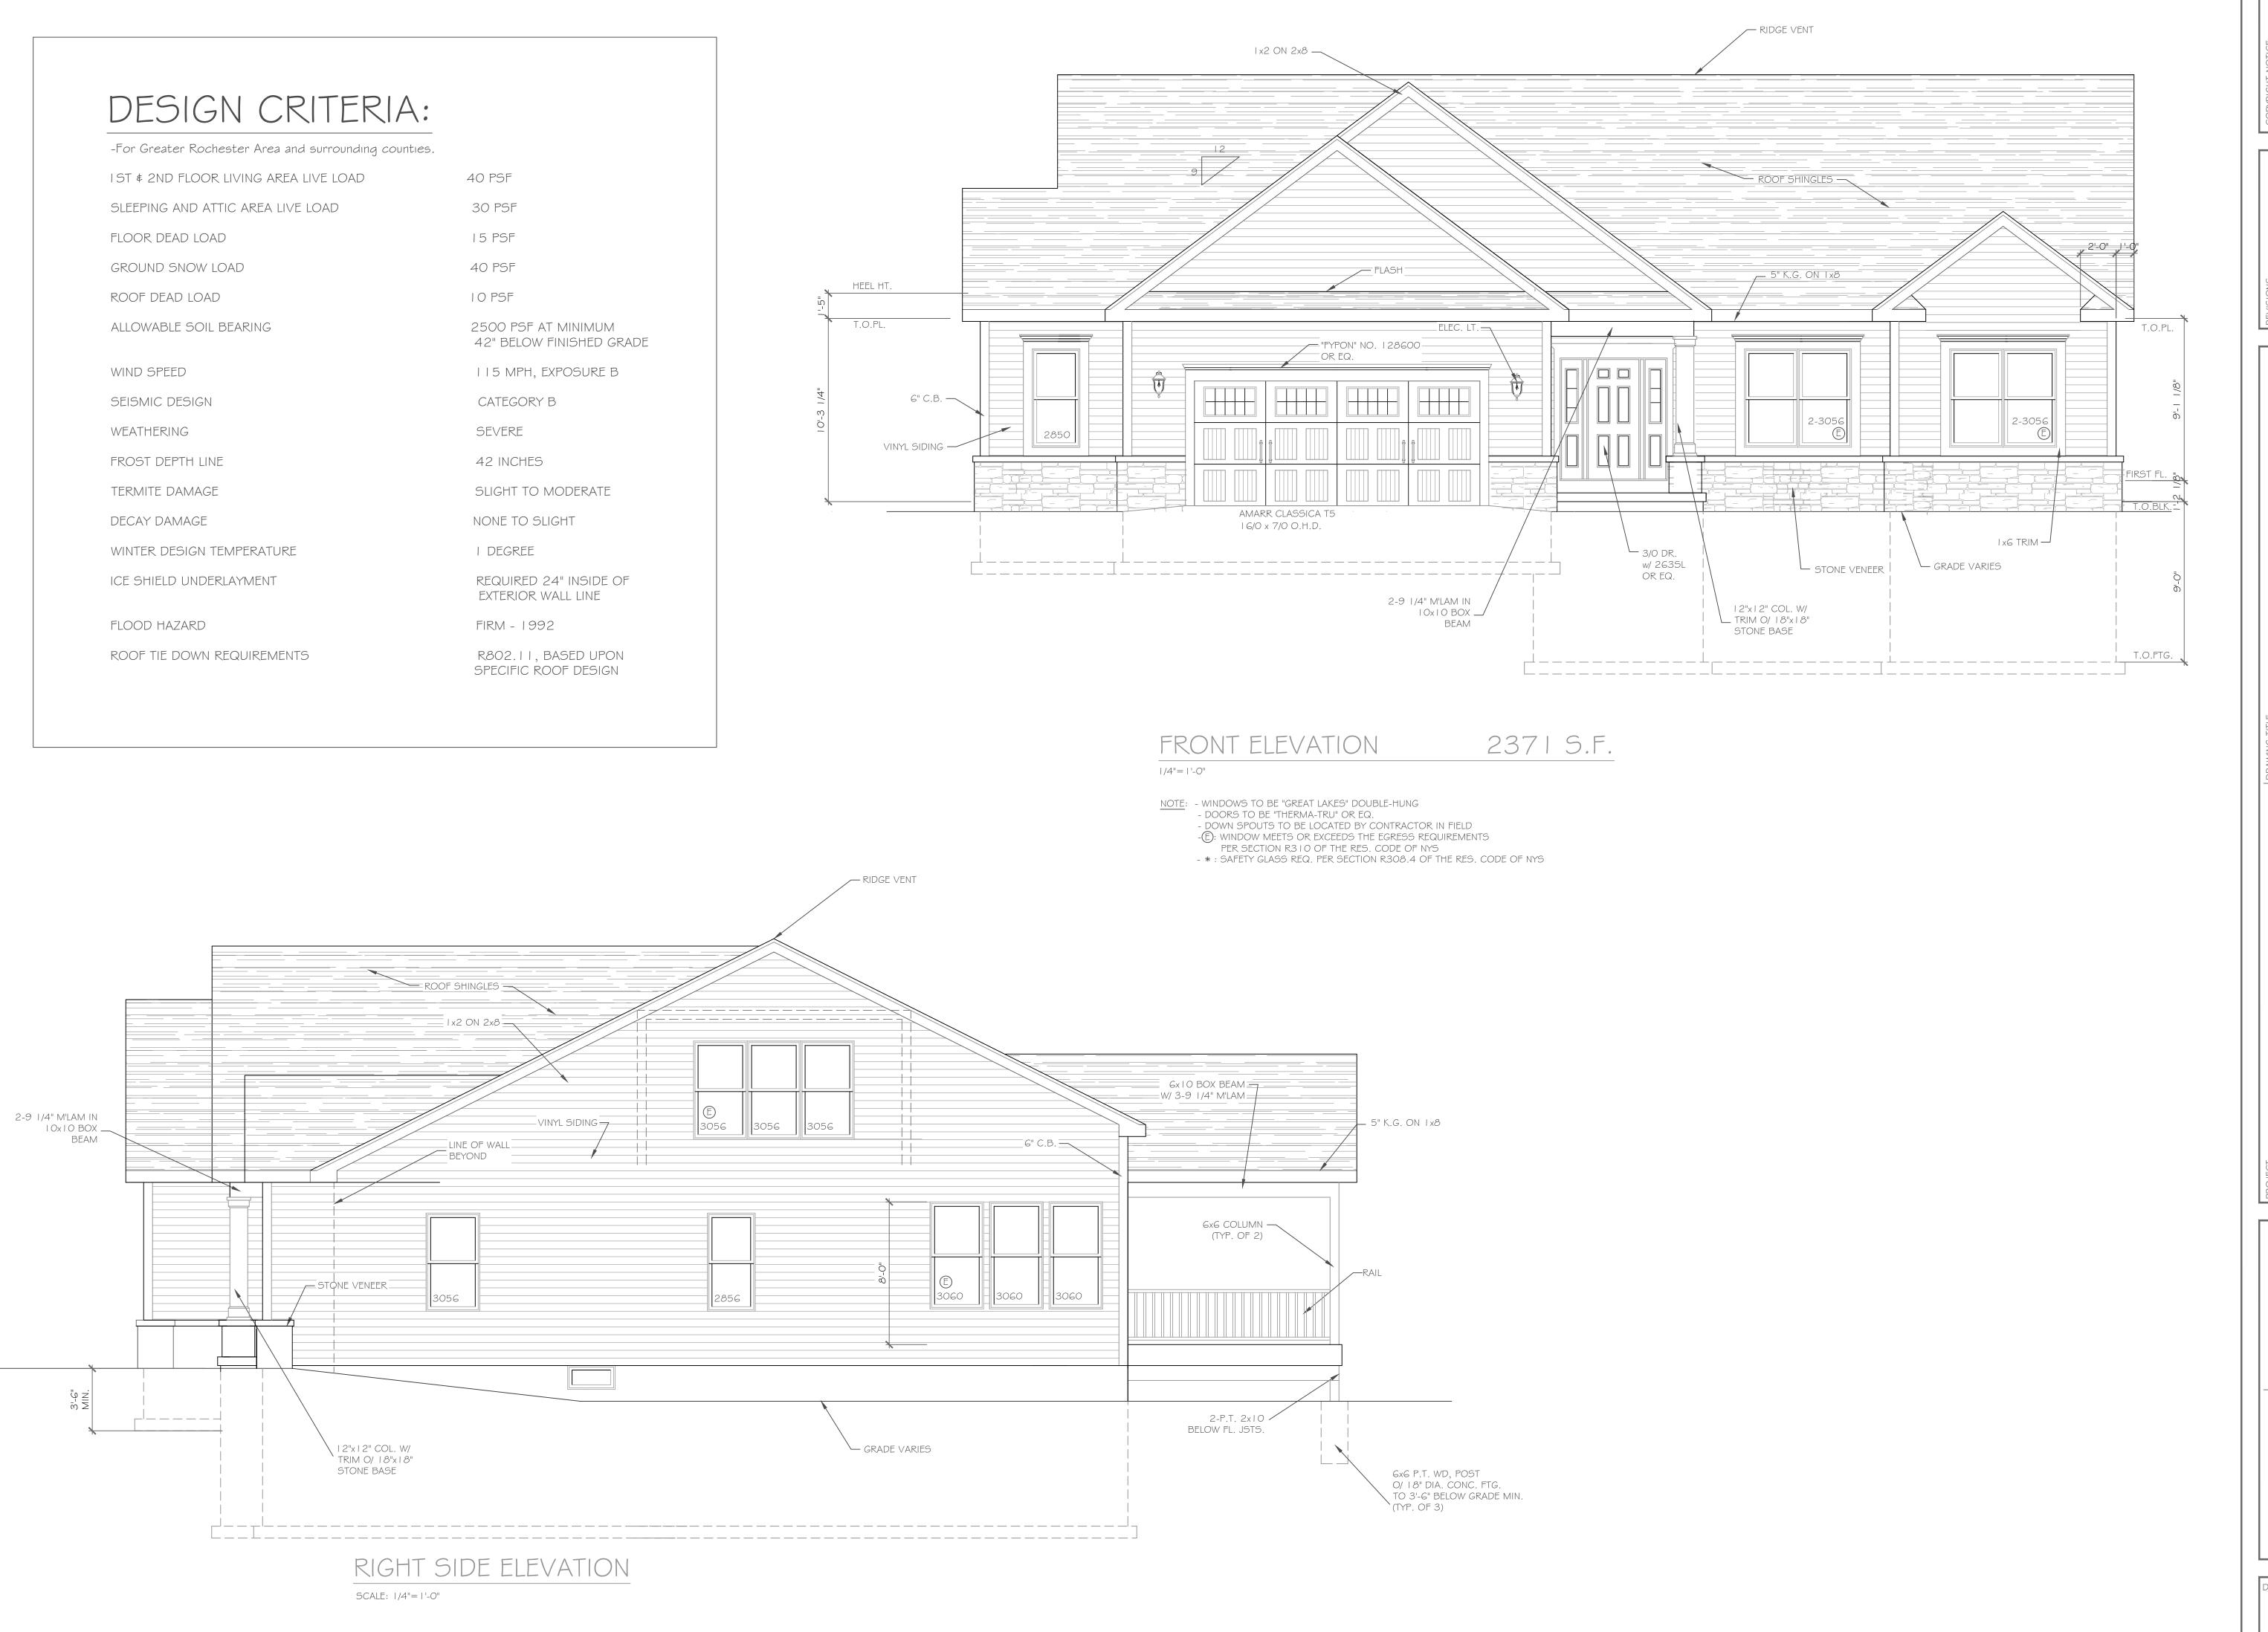
ROCHESTER LOCATION

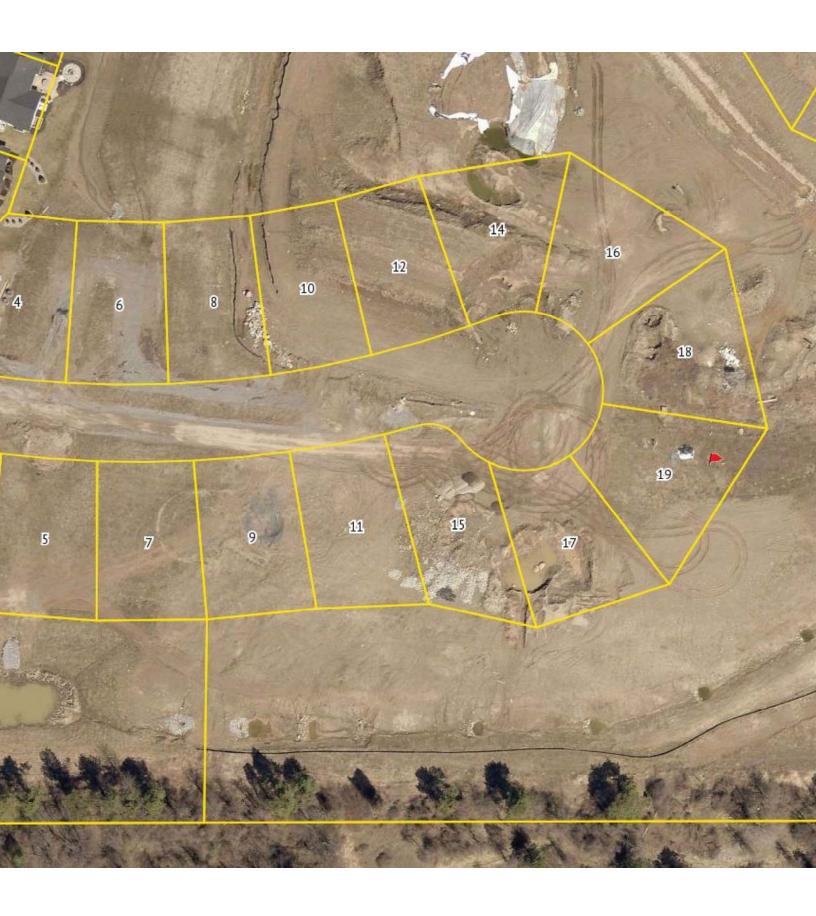3 9 CASCADE DRIVE
ROCHESTER, NY 14614
5 8 5 - 4 5 8 - 7 7 0
HIHACA LOCATION
840 HANSHAW RD, STE 12
ITH A CA, NY 14850
6 0 7 - 2 4 1 - 2 9 1 7
www.marathoneng.com

JOB NO: 0423-17 SCALE: 1" = 20' DRAWN: RJT DESIGNED: RJT DATE: 2/1/21

PLOT PLAN - LOT C34


WILSHIRE HILL - SECTION 3



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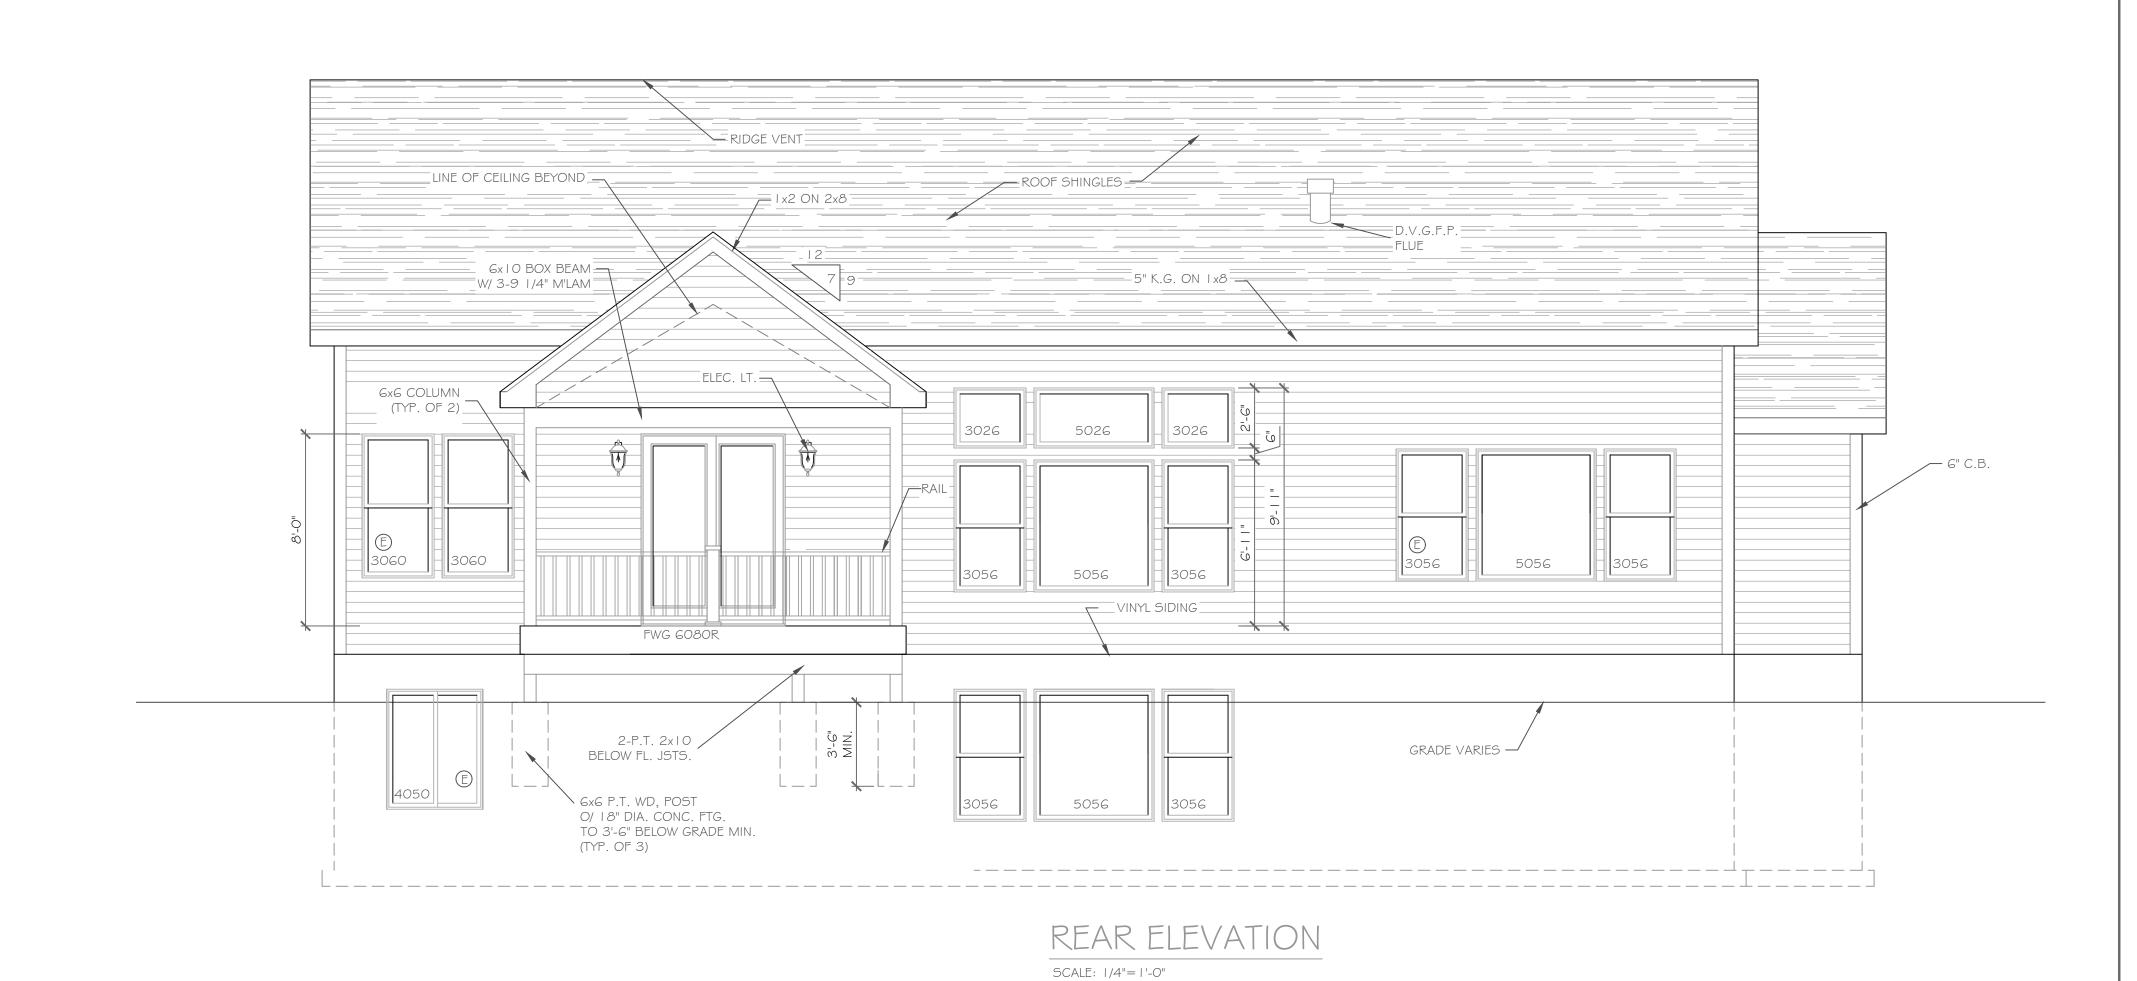
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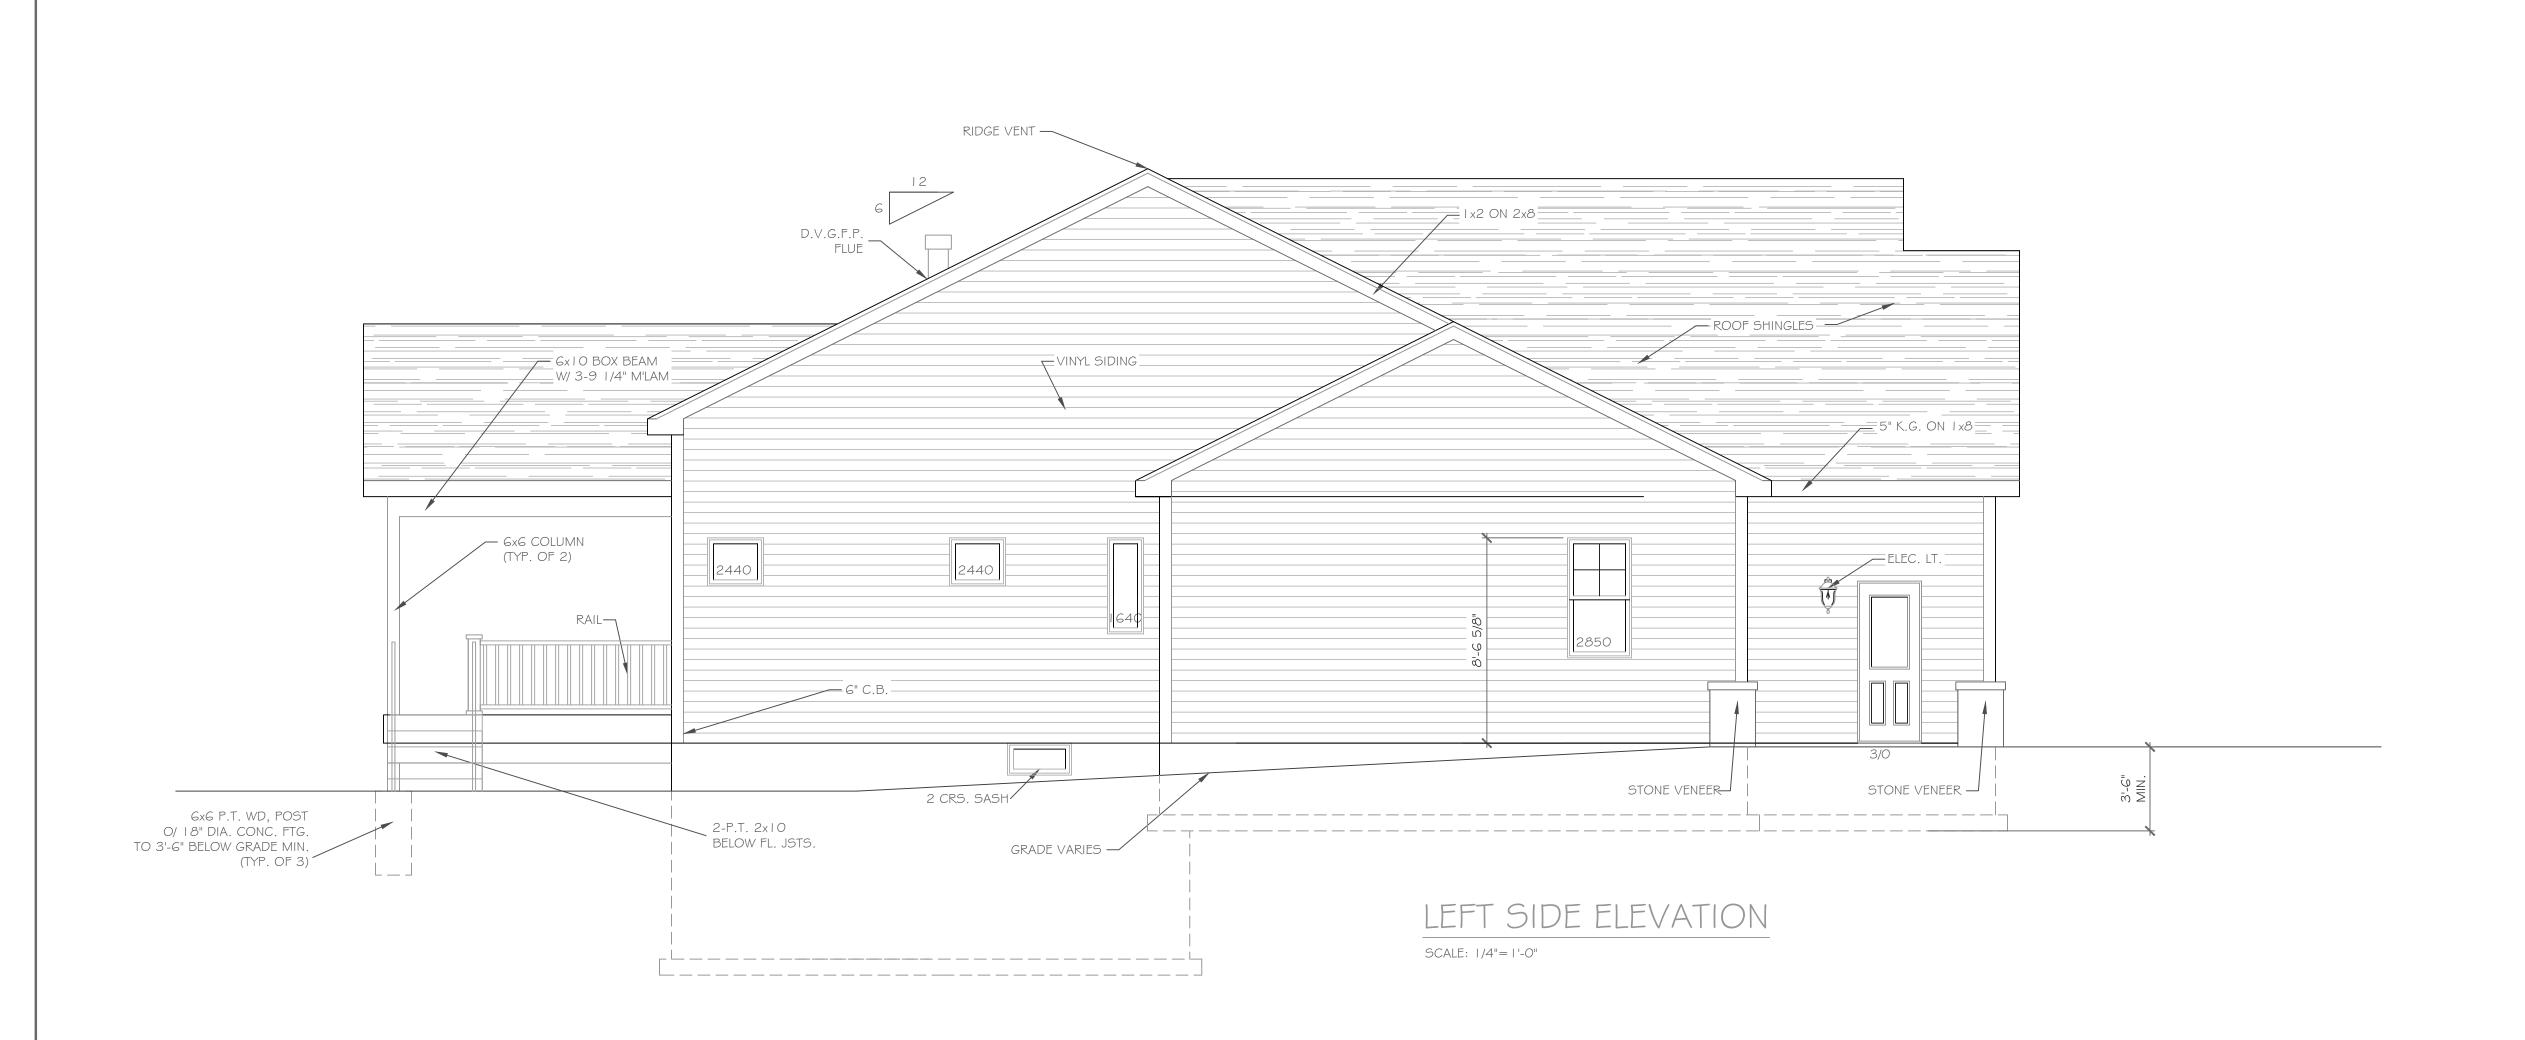



34C, Wilshire Hill sford, New York rell Builders	□ \ \ \ \ \ \ \ \ \ \ \ \ \ \ \ \ \ \ \	Elevations
47	DATE- February 2021	PHASE- Construction Documents




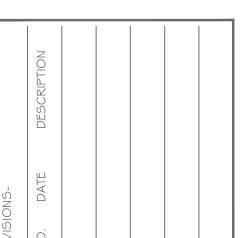






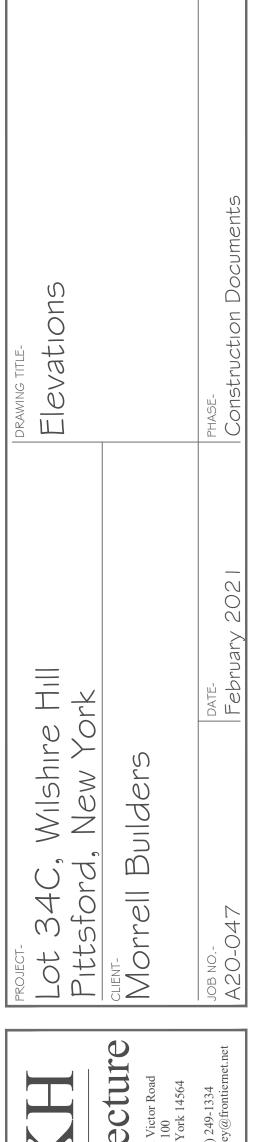

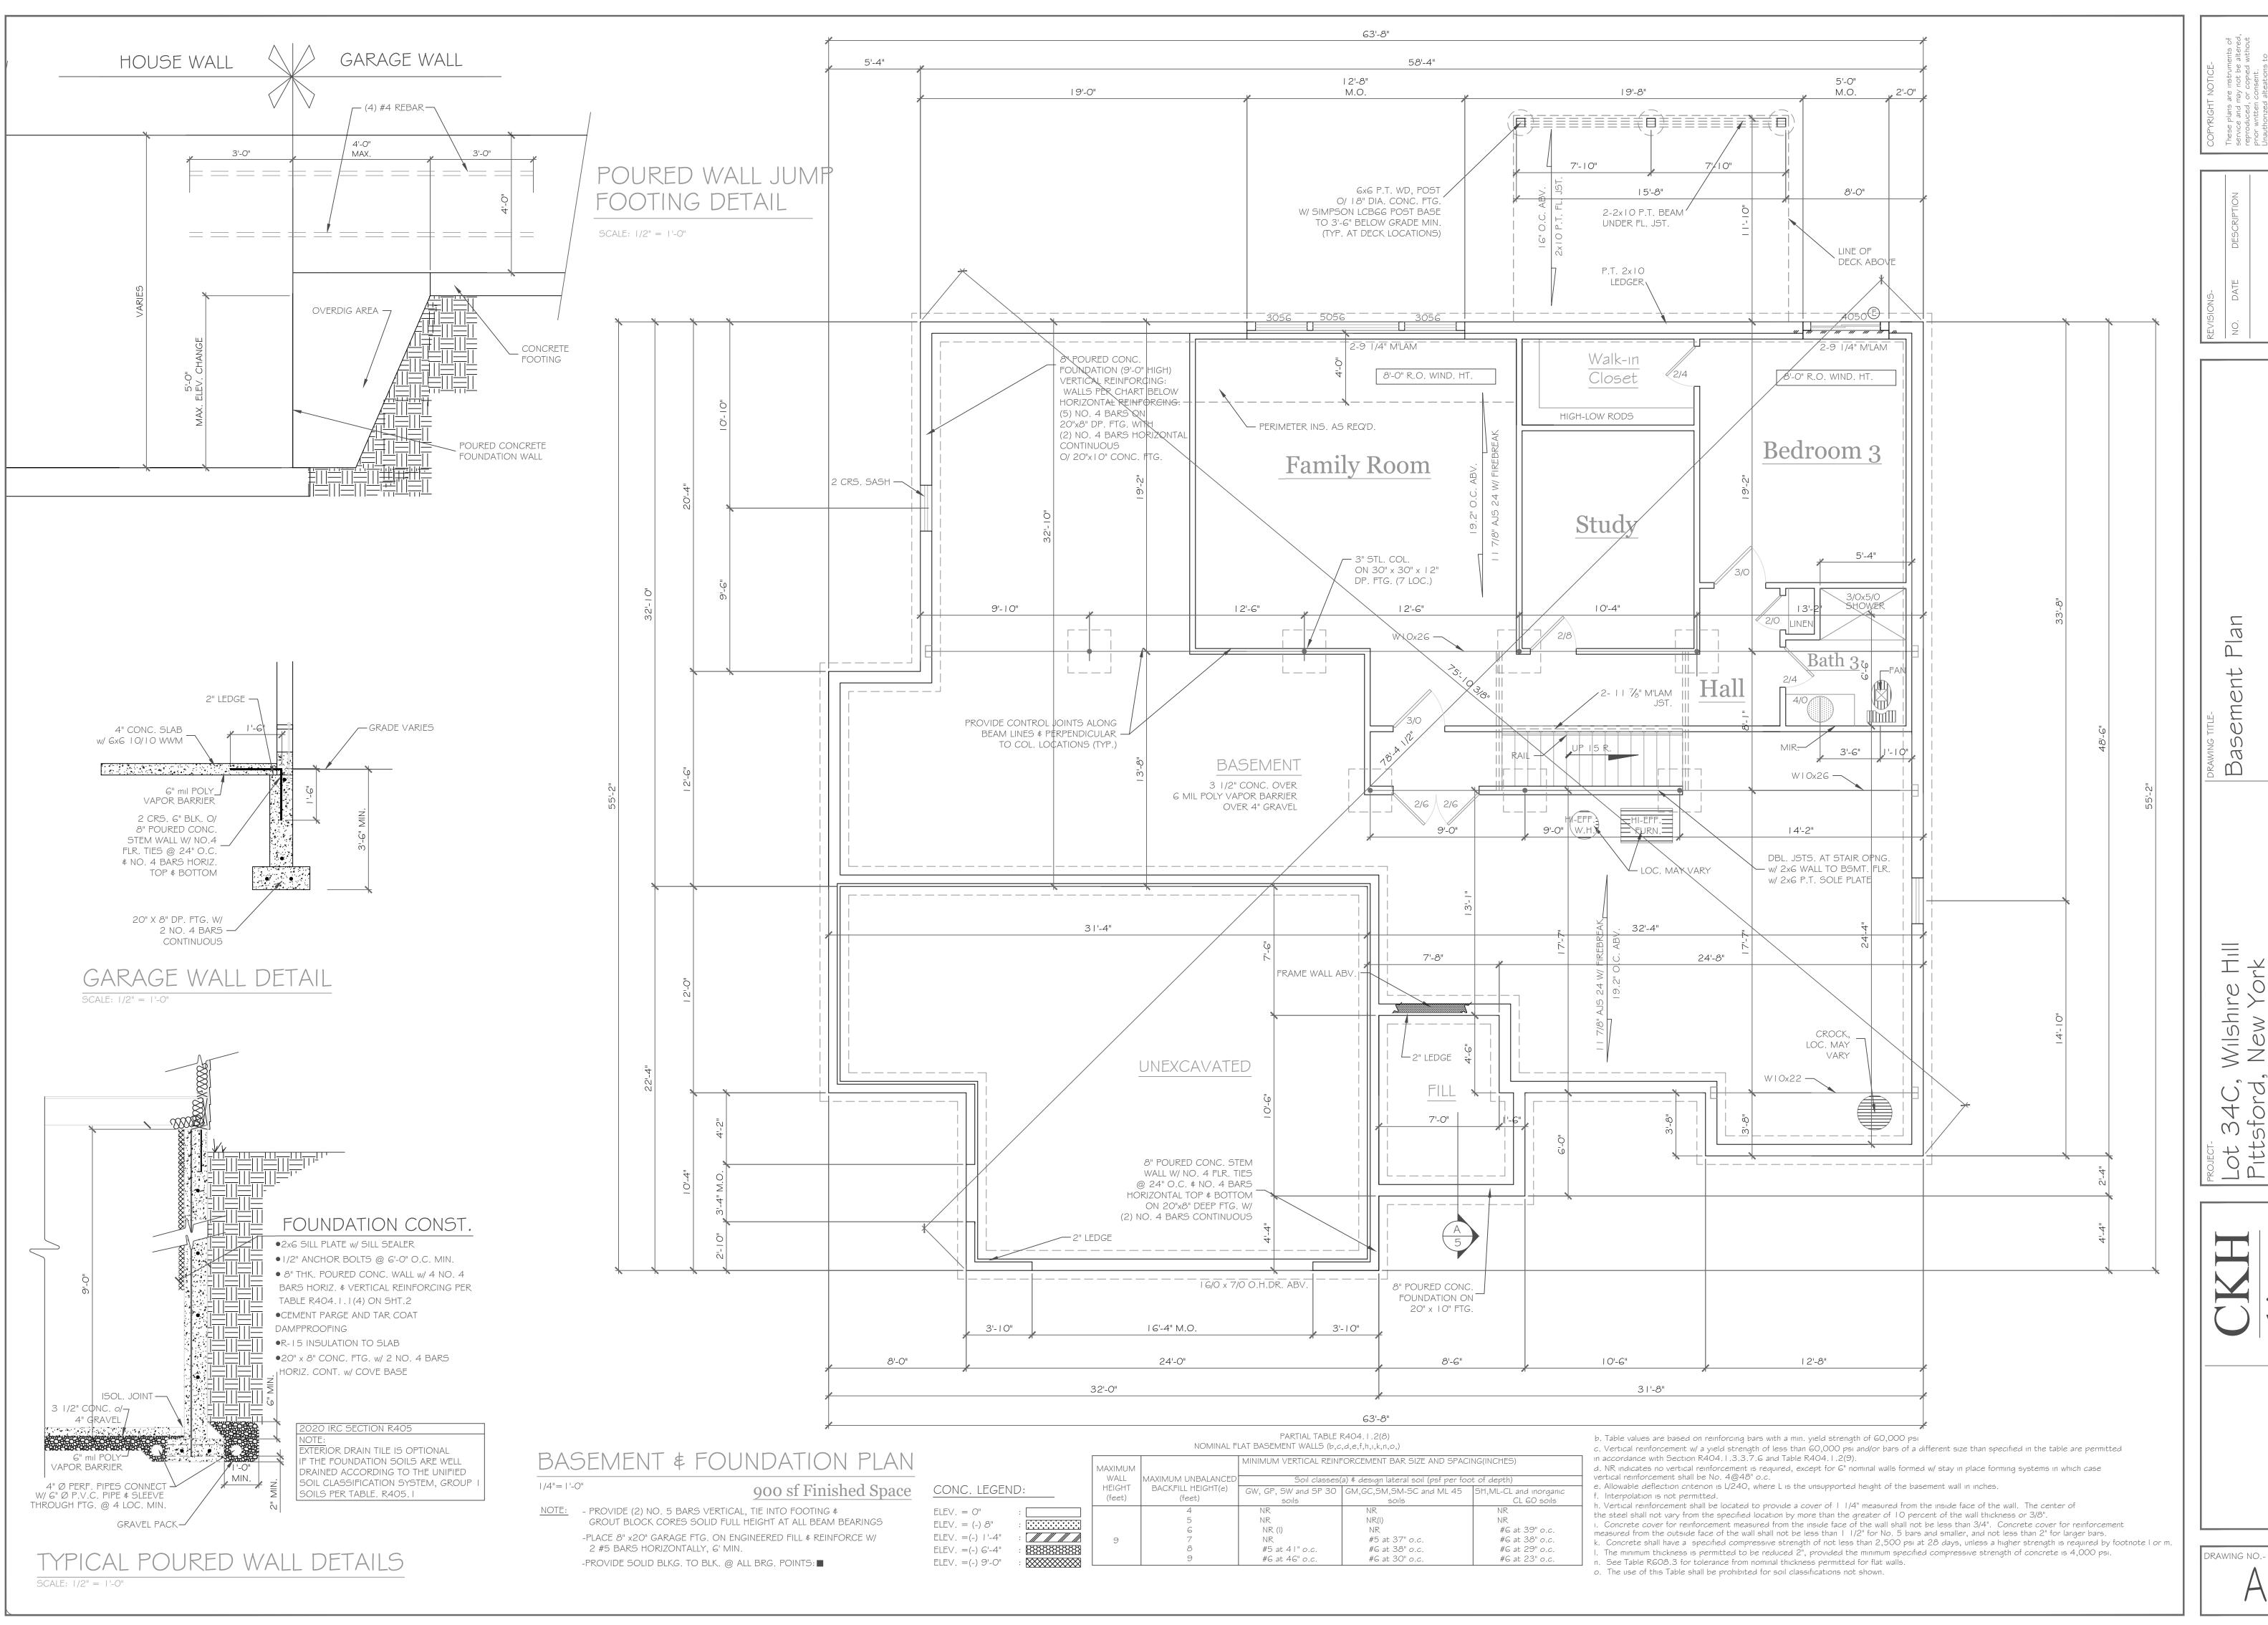

Wilshire Hill New York

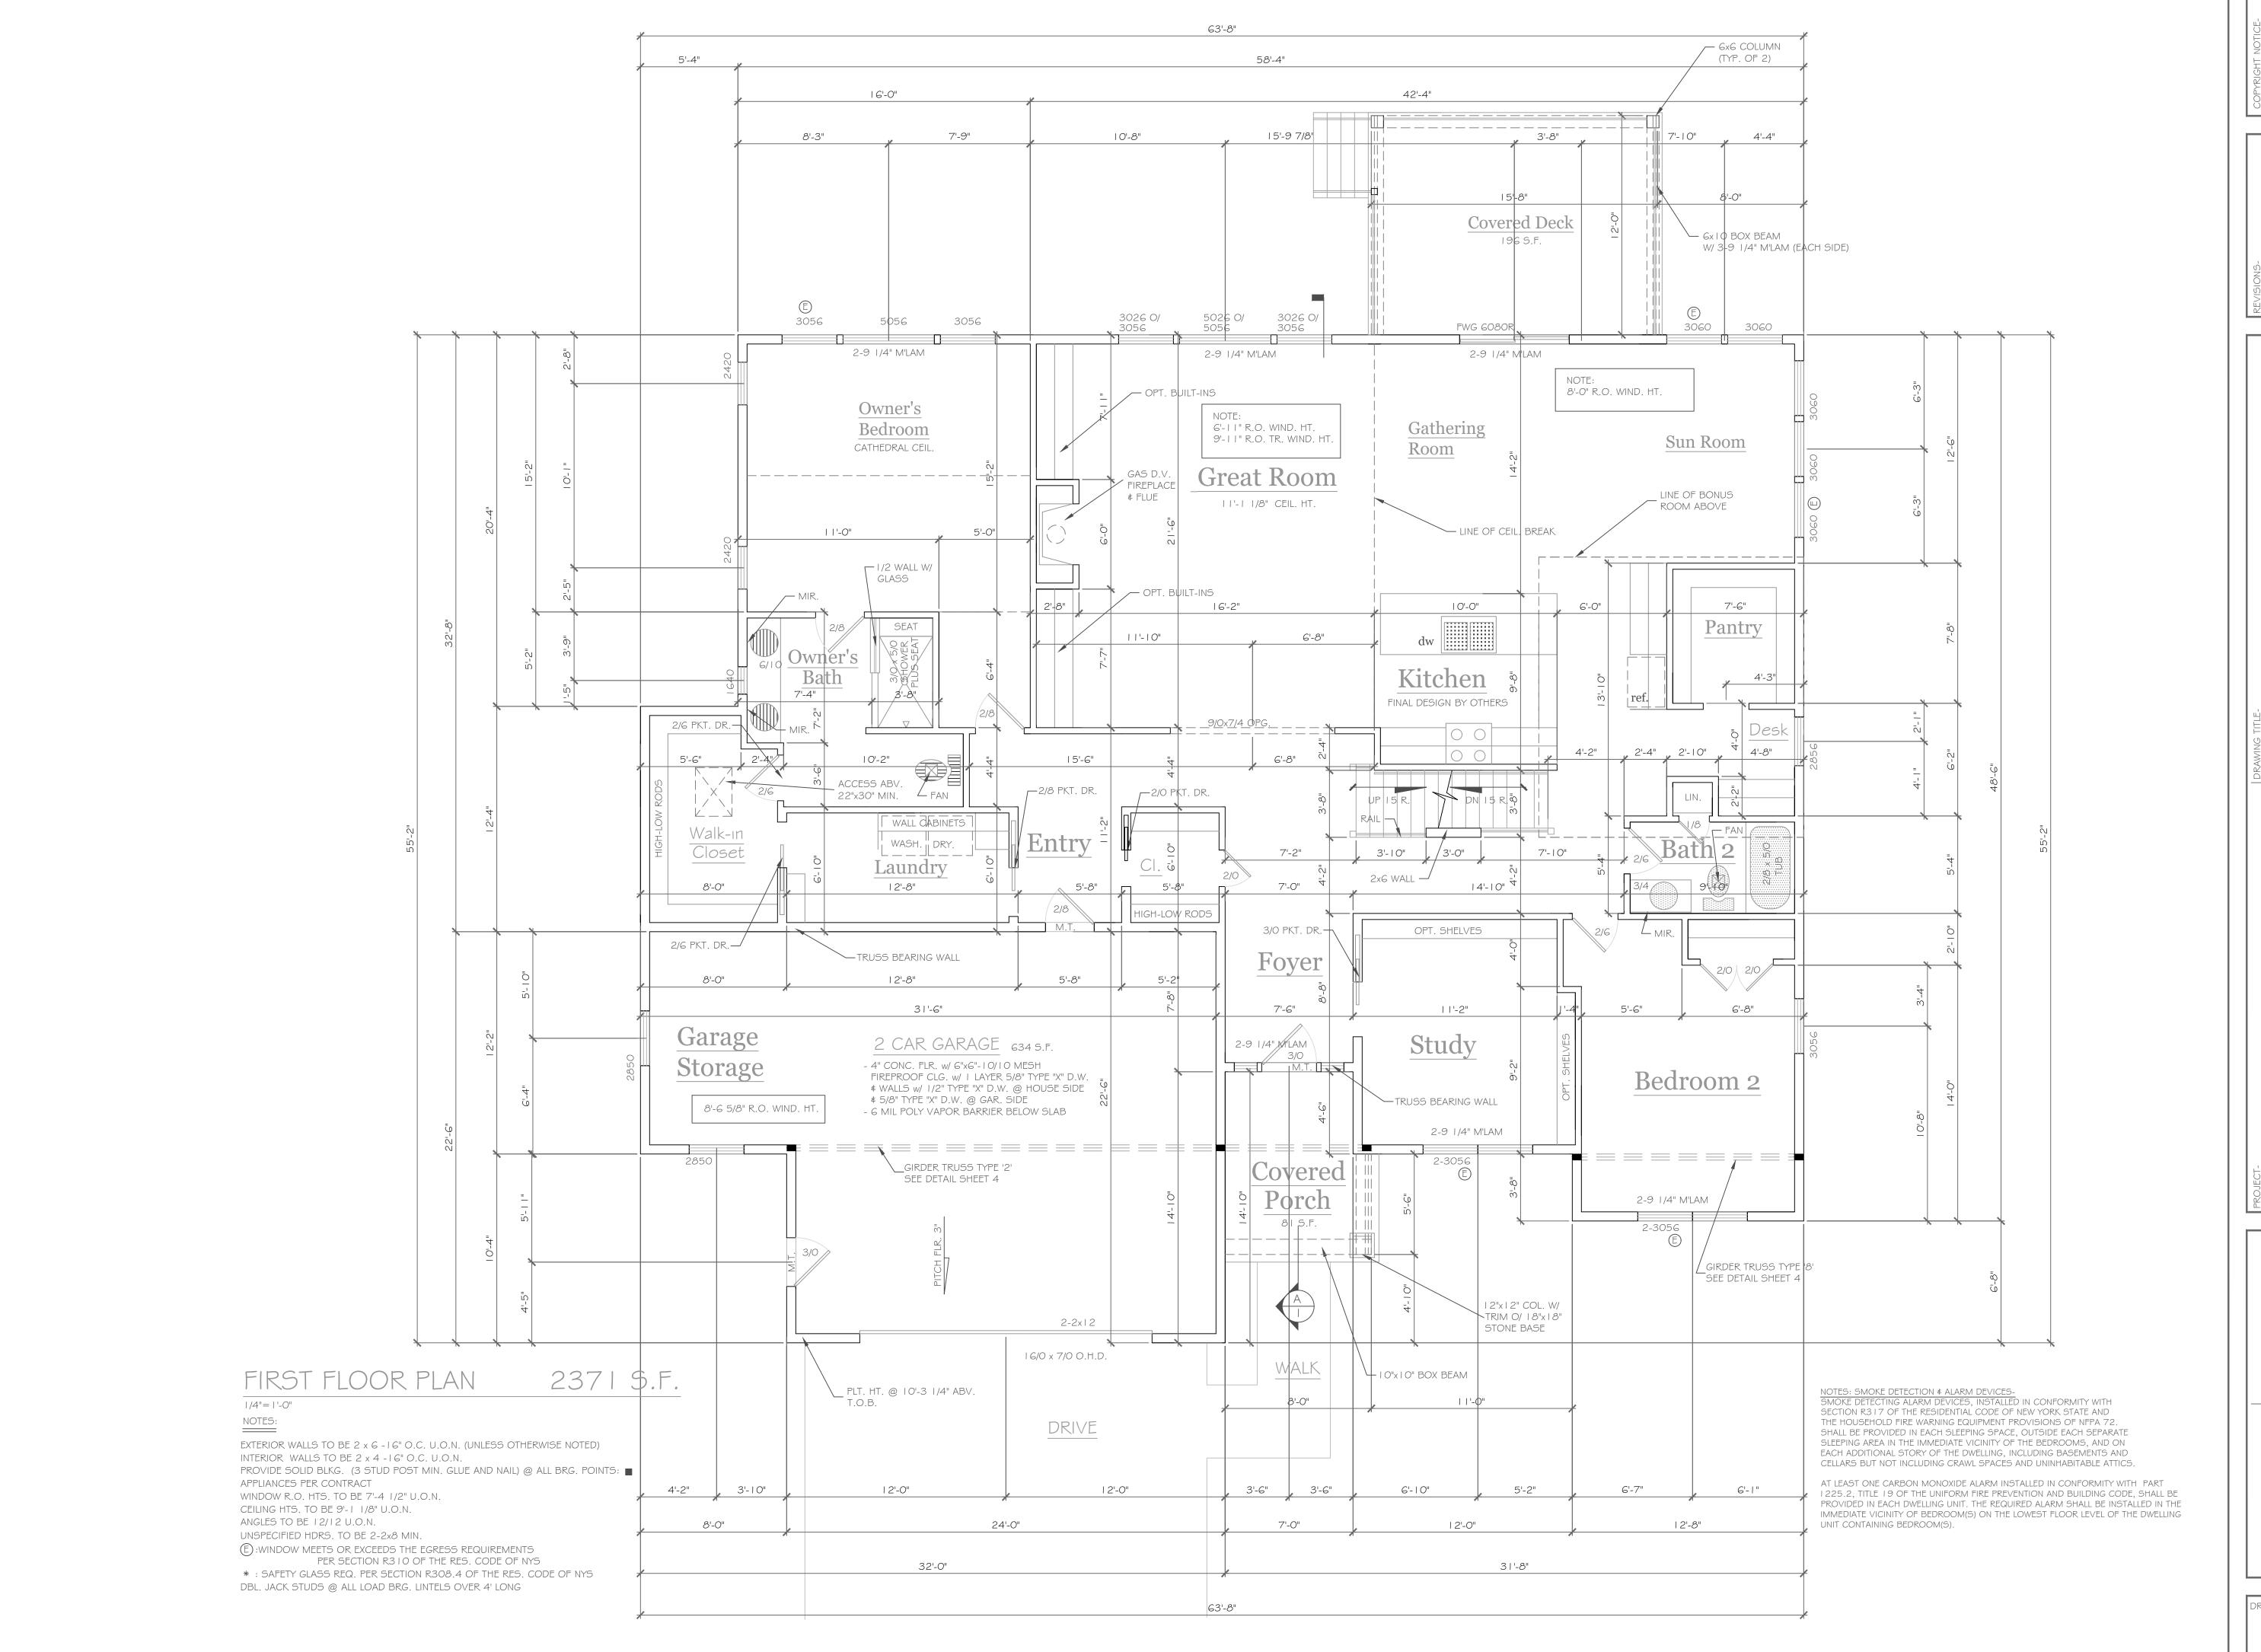

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Section 7209. Article 145.

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REVISIONSNO. DATE DESCRIPTION

34C, Wilshire Hill
Sford, New York

rrell Builders

| Pare | Pare | Pare | Construction Documents |

architecture
| 501 Pittsford Victor Road
| Suite 100
| Victor, New York 14564
| phone-(585) 249-1334


arch

| 1501 |
| Vict







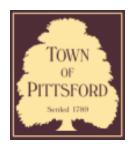

Town of Pittsford

Department of Public Works 11 South Main Street Pittsford, New York 14534

Permit # B21-000043

Phone: 585-248-6250 FAX: 585-248-6262

DESIGN REVIEW AND HISTORIC PRESERVATION BOARD REFERRAL OF APPLICATION

Property Address: 22 Lexton Way PITTSFORD, NY 14534

Tax ID Number: 178.03-5-10

Zoning District: IZ Incentive Zoning

Owner: Wilshire Hill LLC Applicant: Wilshire Hill LLC


Application Type:

. #	Residential Design Review	Build to Line Adjustment
✓	§185-205 (B)	§185-17 (B) (2)
	Commercial Design Review	Building Height Above 30 Feet
	§185-205 (B)	§185-17 (M)
	Signage	Corner Lot Orientation
	§185-205 (C)	§185-17 (K) (3)
	Certificate of Appropriateness	Flag Lot Building Line Location
	§185-197	§185-17 (L) (1) (c)
	Landmark Designation	Undeveloped Flag Lot Requirements
	§185-195 (2)	§185-17 (L) (2)
	Informal Review	

Project Description: Applicant is requesting design review for the construction of a two story single family home. The home will be approximately 1296 square feet on the first floor and 1414 square feet on the second floor. This home will be located in the Wilshire Hills Subdivision.

Meeting Date: March 11, 2021

RN Residential Neighborhood Zoning

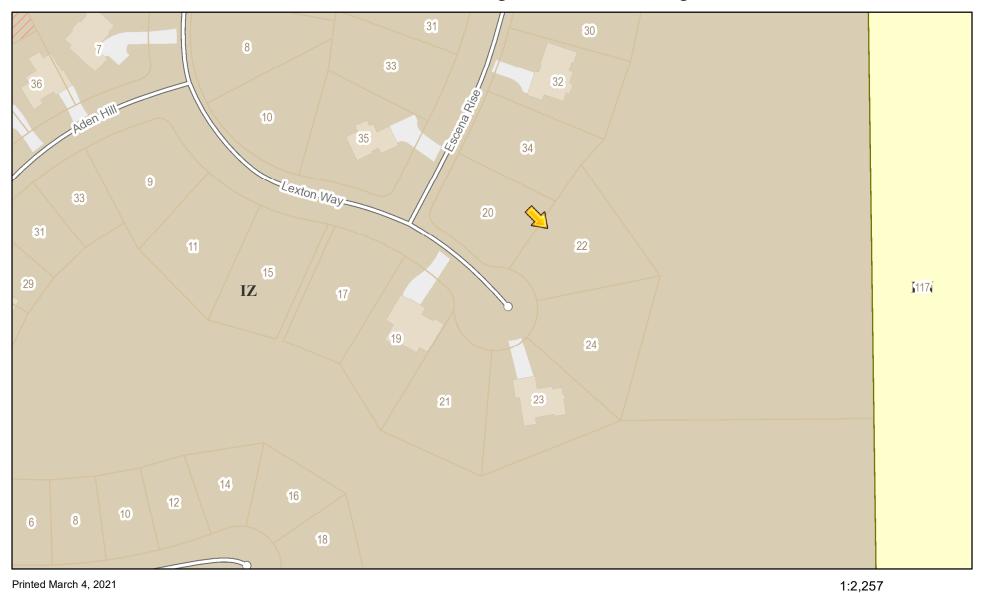

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190

50

380 ft

100 m

95

25

Town of Pittsford GIS





MARATHON

39 CASCADE DRIVE ROCHESTER, NY 14614 PHONE 585-458-7770 www.marathoneng.com

JOB NO: 0423-13 SCALE: DRAWN: DESIGNED: DATE: 2/26/21

SETBACK	REQUIRED	PROVIDED
FRONT	40'	41.0'
SIDE	10'	18.0'
REAR	10'	65.4' ±


PLOT PLAN - LOT P16

WILSHIRE HILL - SECTION 3

TITLE:





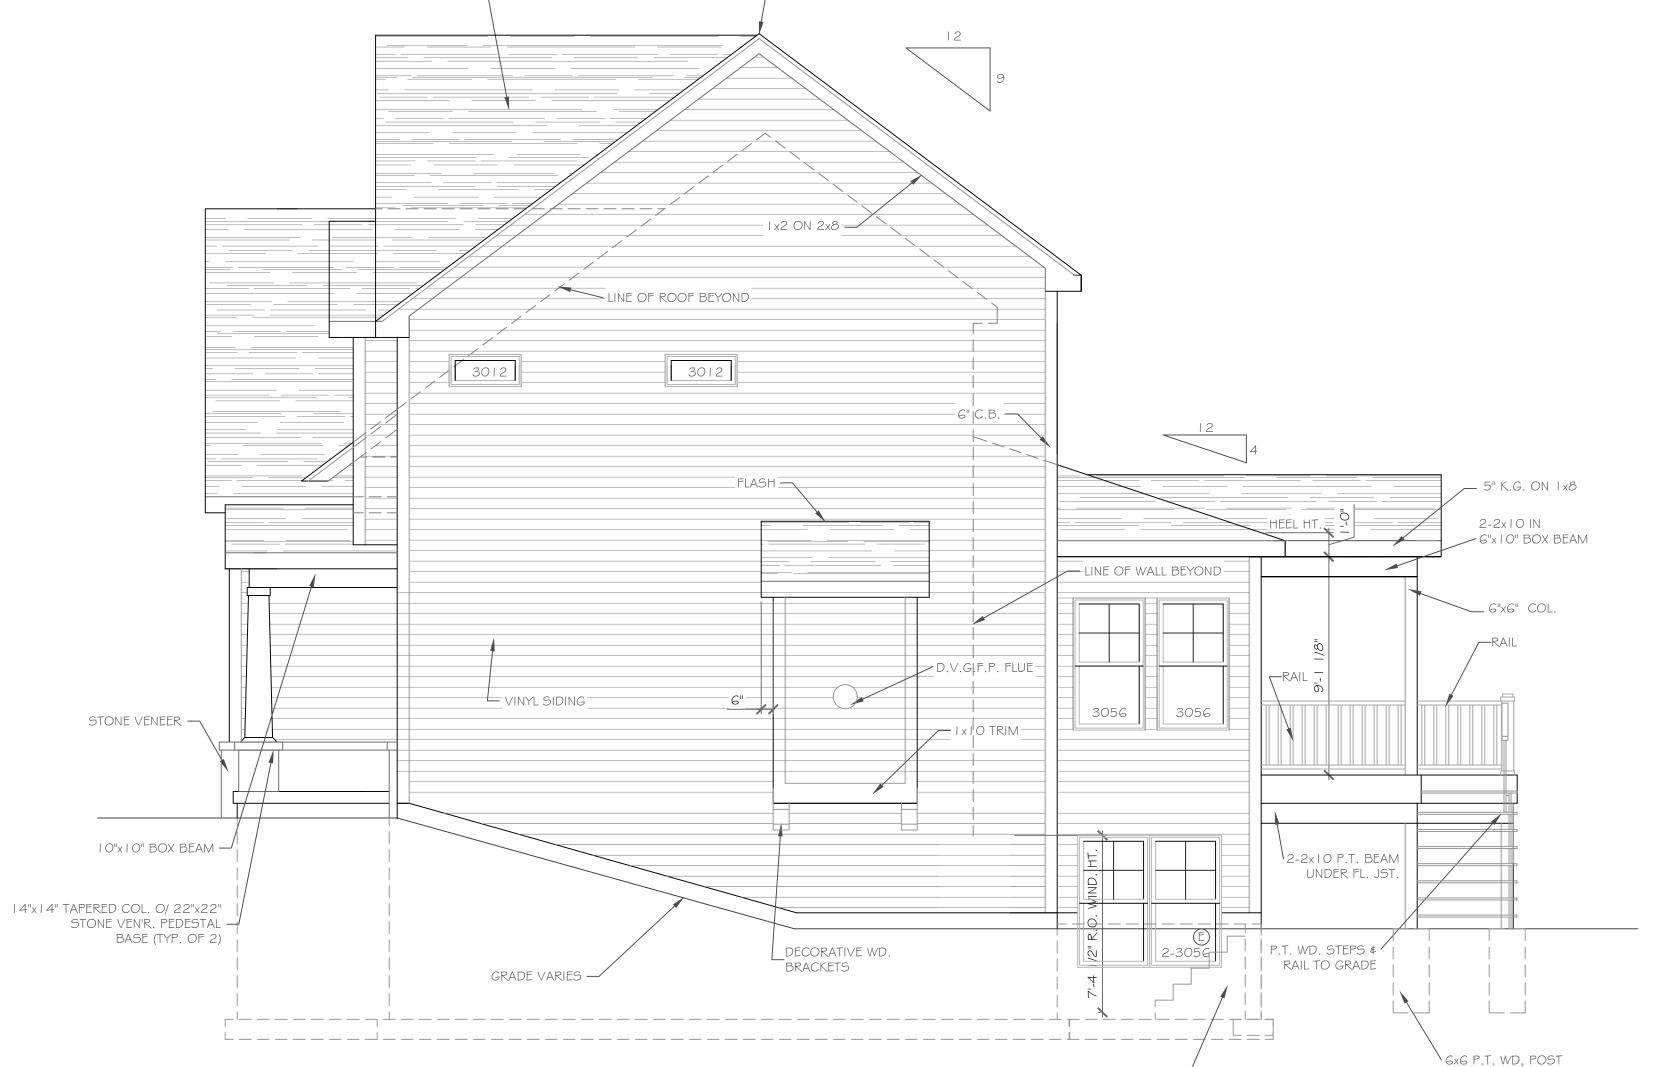

1/4"= | '-0"

TIMBER WINDOW WELLS

AS REQUIRED WITH GRADE

O/ 18" DIA. CONC. FTG.

(TYP. OF 8)

TO 3'-6" BELOW GRADE MIN.

FRONT ELEVATION

2710 S.F

NOTE: - WINDOWS TO BE "GREAT LAKES" DOUBLE-HUNG, LOW-E
- DOORS TO BE "THERMA-TRU" OR EQ.
- DOWN SPOUTS TO BE LOCATED BY CONTRACTOR IN FIELD
- E: WINDOW MEETS OR EXCEEDS THE EGRESS REQUIREMENTS
PER SECTION R3 I O OF THE RES. CODE OF NYS

- : SAFETY GLASS REQ. PER SECTION R308.4 OF THE RES. CODE OF MYS


ford, New York

Mark Homes


| Phase | Phase | Construction Documents |

architectur
| 501 Pittsford Victor Road Suite 100 Victor, New York 14564 |
| phone-(585) 249-1334 |
| e-mail- CKHennessey@frontiernet.



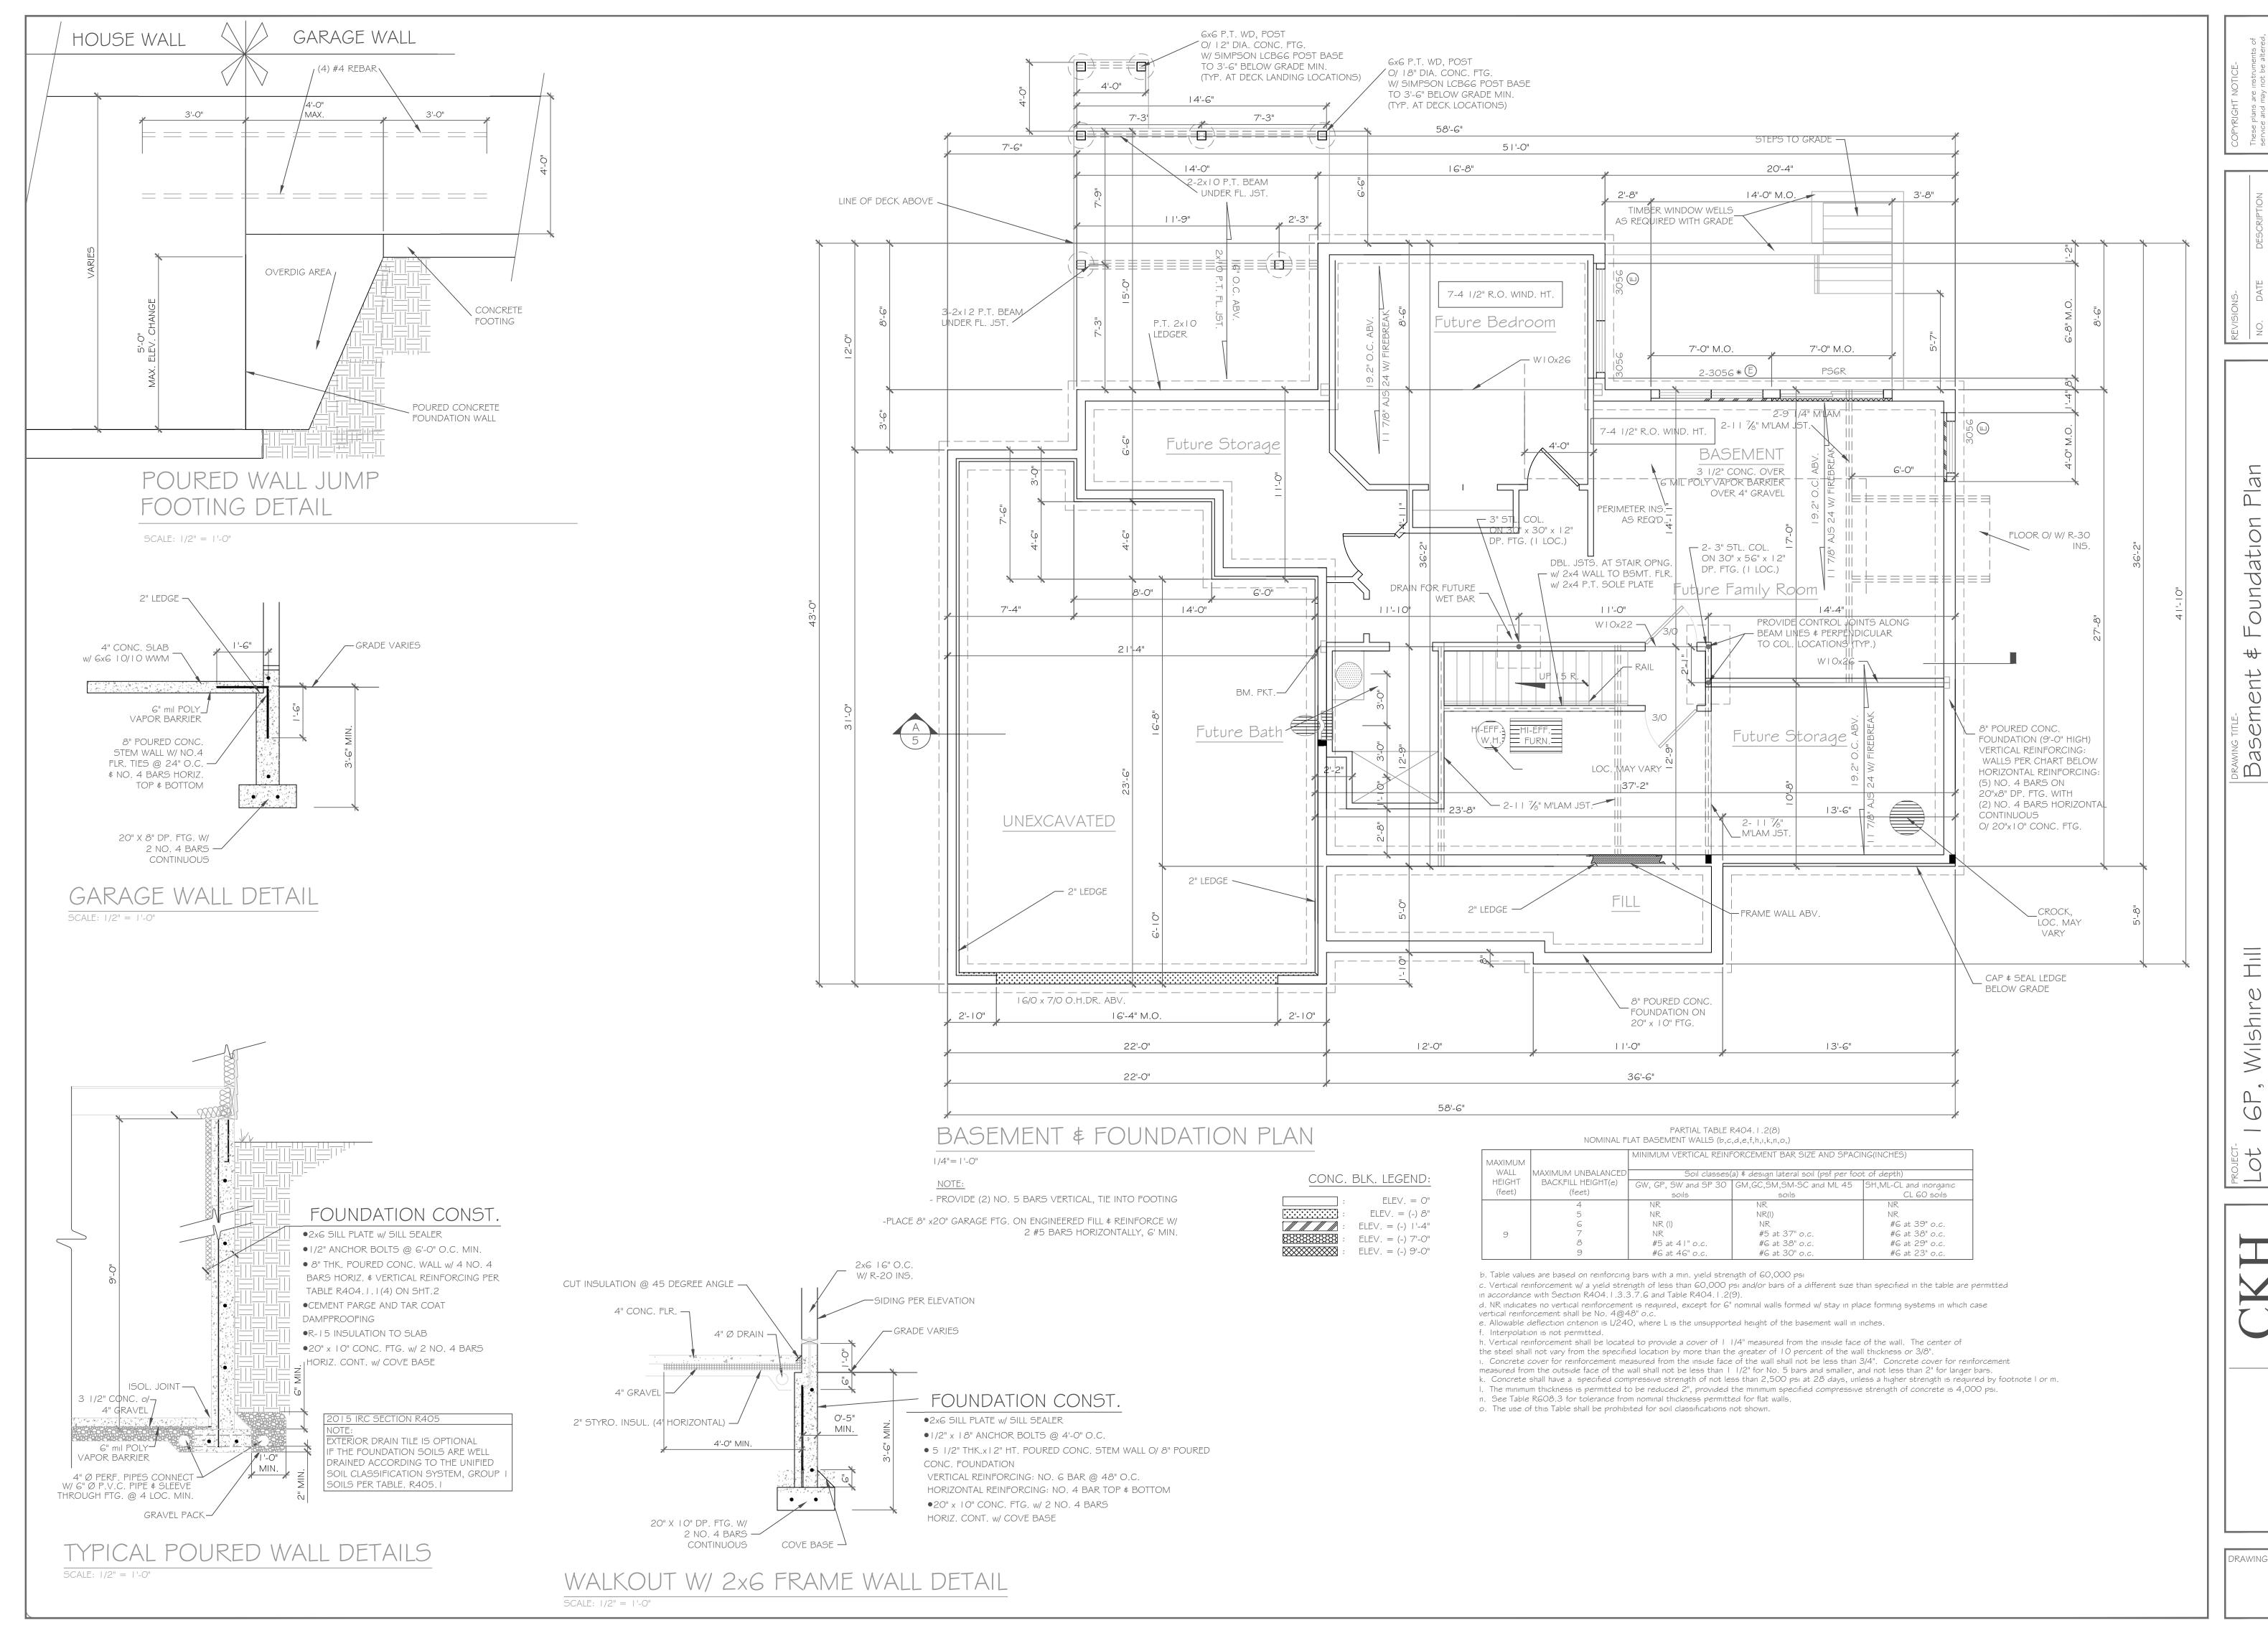


Wilshire Hill New York ome

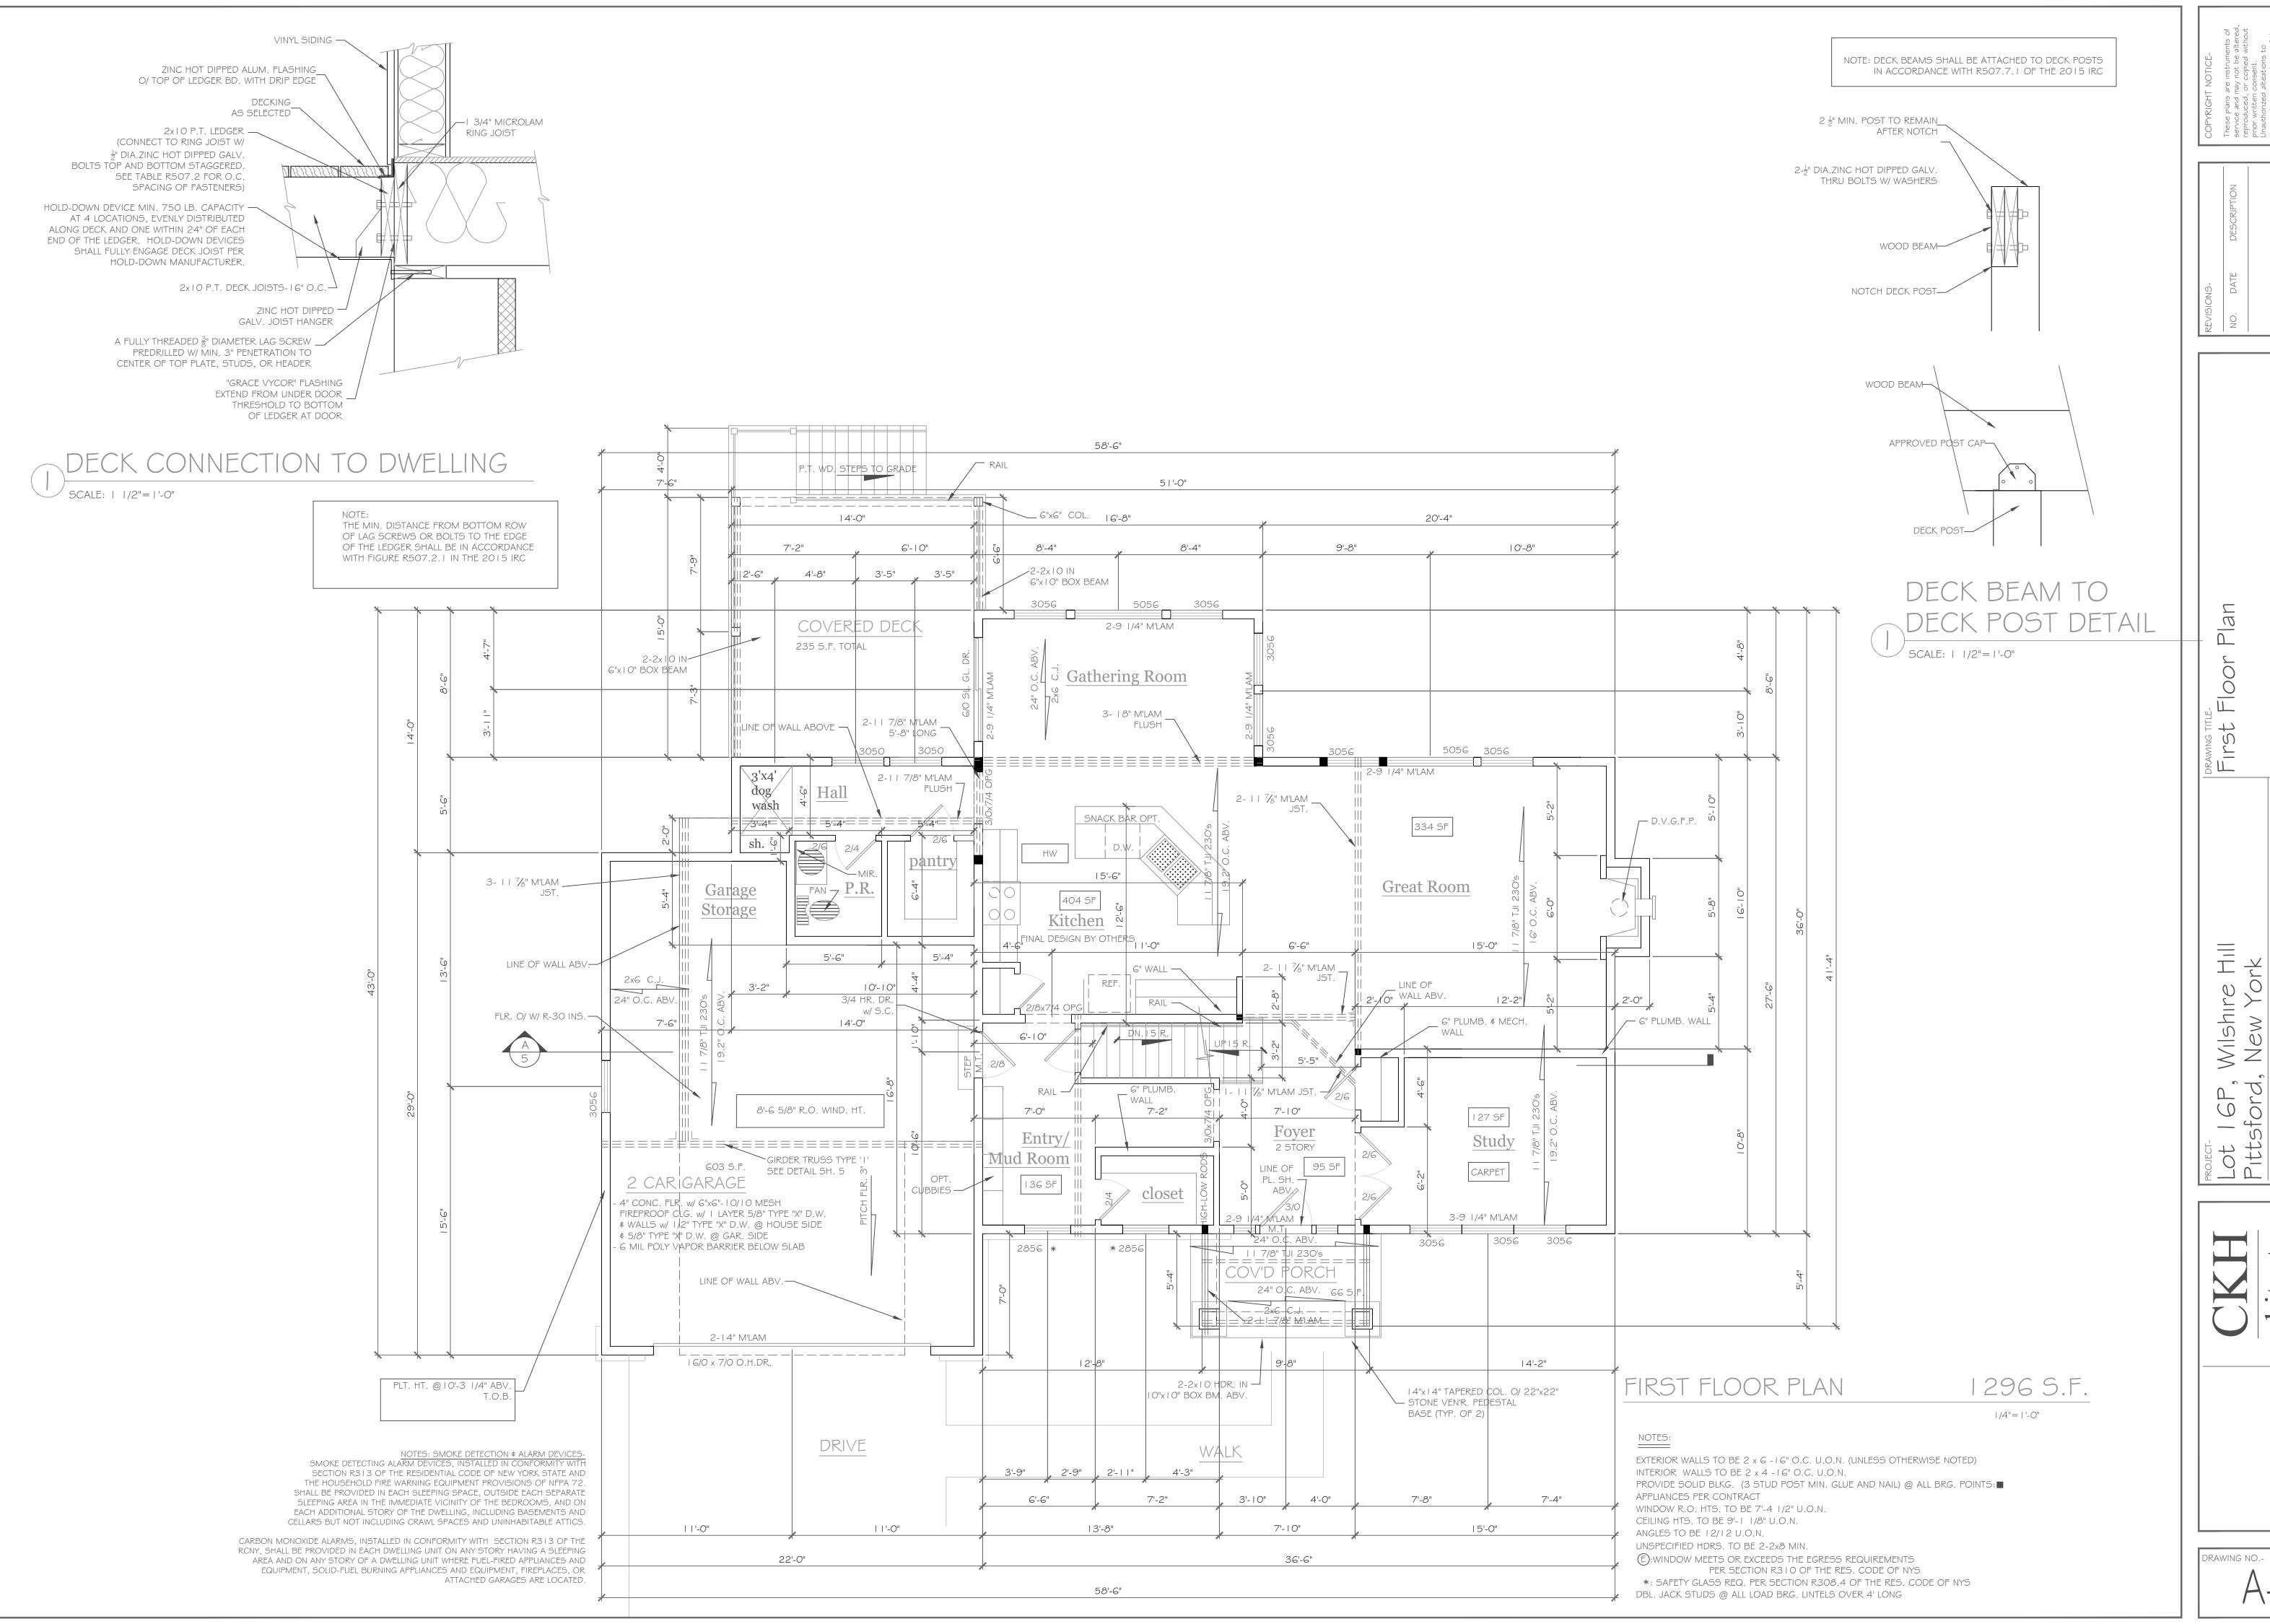

architectu

ome

 ω

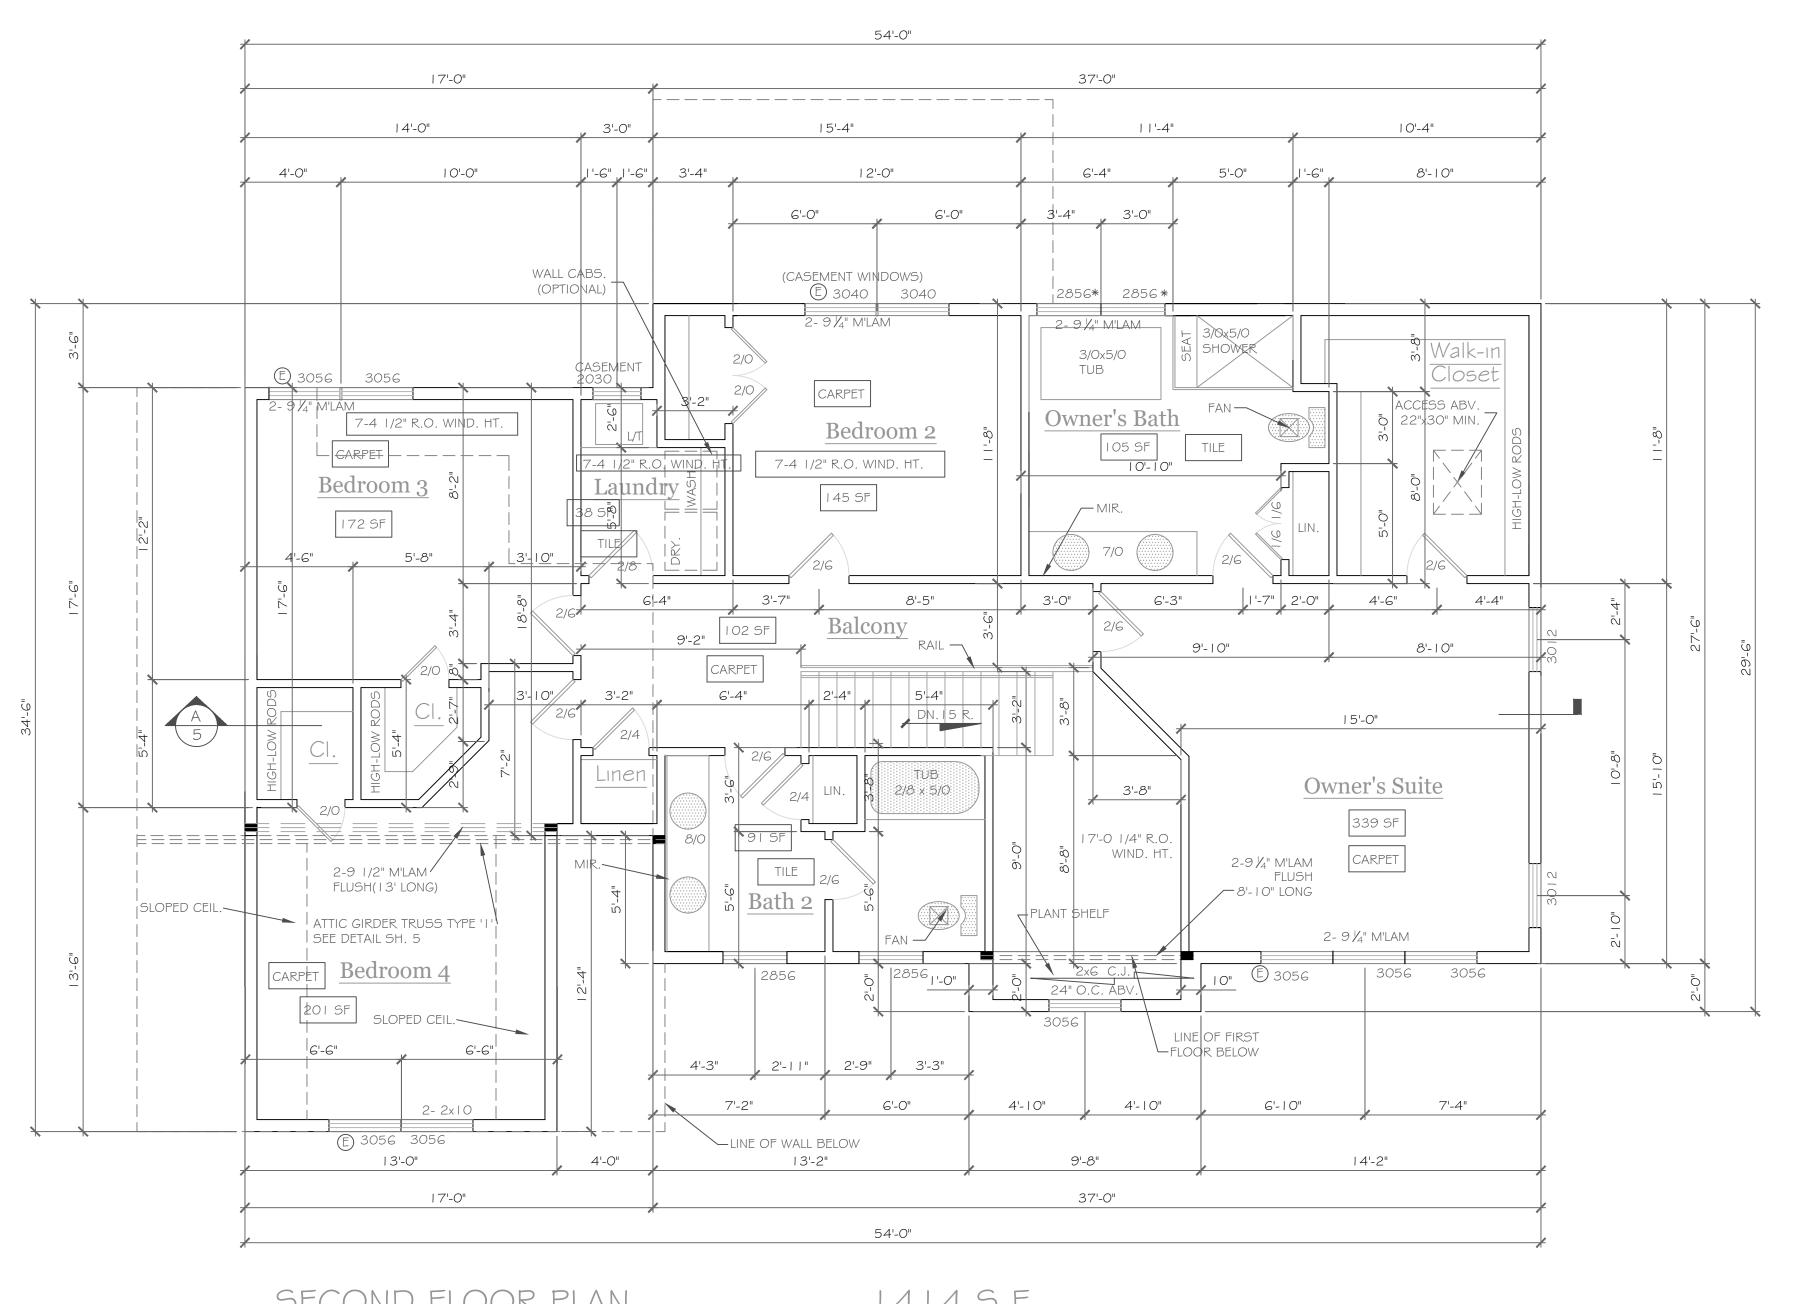

SECOND FLOOR PLAN 1/4"=1'-0"

1414 S.F.

EXTERIOR WALLS TO BE 2 x 6 - I 6" O.C. U.O.N. (UNLESS OTHERWISE NOTED) INTERIOR WALLS TO BE 2 x 4 - 16" O.C. U.O.N.

□PROVIDE SOLID BLKG. (3 STUD POST MIN. GLUE AND NAIL) @ ALL BRG. POINTS:■ APPLIANCES PER CONTRACT

WINDOW R.O. HTS. TO BE 6'-10 1/2" U.O.N. CEILING HTS. TO BE 8'-1 1/8" U.O.N. ANGLES TO BE 12/12 U.O.N.

UNSPECIFIED HDRS. TO BE 2-2x8 MIN. (E):WINDOW MEETS OR EXCEEDS THE EGRESS REQUIREMENTS PER SECTION R3 I O OF THE RES. CODE OF NYS

*: SAFETY GLASS REQ. PER SECTION R308.4 OF THE RES. CODE OF NYS DBL. JACK STUDS @ ALL LOAD BRG. LINTELS OVER 4' LONG

NOTES: SMOKE DETECTION & ALARM DEVICES-SMOKE DETECTING ALARM DEVICES, INSTALLED IN CONFORMITY WITH SECTION R3 | 3 OF THE RESIDENTIAL CODE OF NEW YORK STATE AND THE HOUSEHOLD FIRE WARNING EQUIPMENT PROVISIONS OF NFPA 72. SHALL BE PROVIDED IN EACH SLEEPING SPACE, OUTSIDE EACH SEPARATE SLEEPING AREA IN THE IMMEDIATE VICINITY OF THE BEDROOMS, AND ON EACH ADDITIONAL STORY OF THE DWELLING, INCLUDING BASEMENTS AND CELLARS BUT NOT INCLUDING CRAWL SPACES AND UNINHABITABLE ATTICS.

CARBON MONOXIDE ALARMS, INSTALLED IN CONFORMITY WITH SECTION R3 | 3 OF THE RCNY, SHALL BE PROVIDED IN EACH DWELLING UNIT ON ANY STORY HAVING A SLEEPING AREA AND ON ANY STORY OF A DWELLING UNIT WHERE FUEL-FIRED APPLIANCES AND EQUIPMENT, SOLID-FUEL BURNING APPLIANCES AND EQUIPMENT, FIREPLACES, OR ATTACHED GARAGES ARE LOCATED.


Wilshire Hill New York оте Mark

architectur







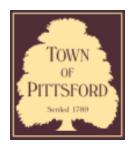

Town of Pittsford

Department of Public Works 11 South Main Street Pittsford, New York 14534

Permit # S21-000003

Phone: 585-248-6250 FAX: 585-248-6262

DESIGN REVIEW AND HISTORIC PRESERVATION BOARD REFERRAL OF APPLICATION

Property Address: 3349 Monroe Avenue ROCHESTER, NY 14618

Tax ID Number: 150.12-1-18

Zoning District: C Commercial / MATZ Monroe Avenue Transitional Zone **Owner:** Pittsford Plaza SPE, LLC (Adelita's Mexican Cocina & Tequila)

Applicant: Vital Signs


Application Type:

	Residential Design Review	Build to Line Adjustment
	§185-205 (B)	§185-17 (B) (2)
	Commercial Design Review	Building Height Above 30 Feet
	§185-205 (B)	§185-17 (M)
. #	Signage	Corner Lot Orientation
~	§185-205 (C)	§185-17 (K) (3)
	Certificate of Appropriateness	Flag Lot Building Line Location
	§185-197	§185-17 (L) (1) (c)
	Landmark Designation	Undeveloped Flag Lot Requirements
Ш	§185-195 (2)	§185-17 (L) (2)
	Informal Review	

Project Description: Applicant is requesting design review for the addition of two business identification signs. The front sign will be approximately 73.3 square feet and the sign on the side of the building will be approximately 48.3 square feet. Both signs will identify the "Adelita's Mexican Cocina & Tequila" Restaurant.

Meeting Date: March 11, 2021

RN Residential Neighborhood Zoning

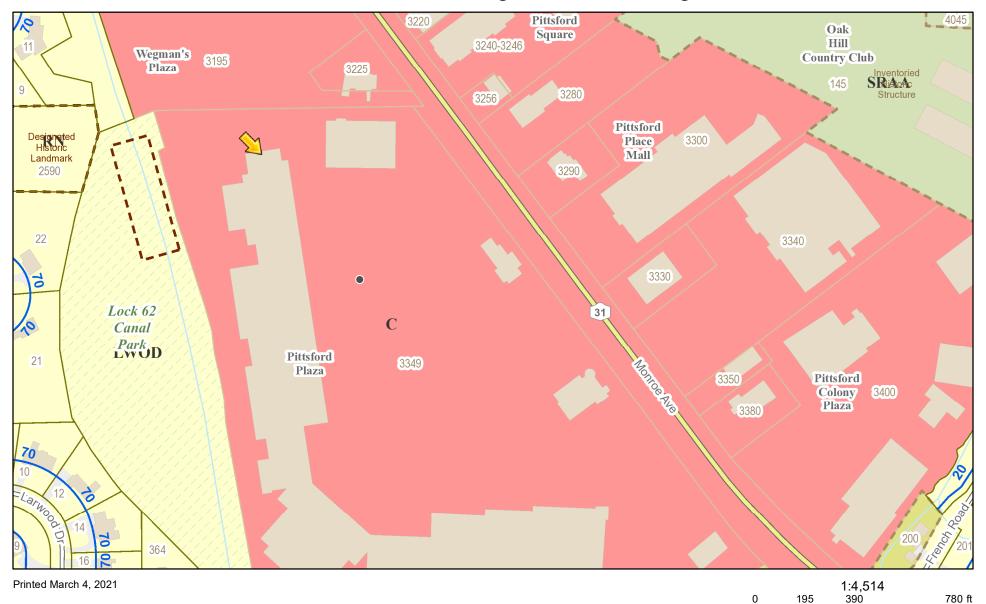

Town of Pittsford GIS

55

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110

220 m



North Elevation_Exterior Illuminated Chanel Letters_Proof V.5_Revised 2/25/2021


This custom artwork is for representational purposes only. Colors will not exactly match the paint or materials to be used.


ALL ELECTRICAL SIGNS REQUIRE 120V ELECTRIC. UNLESS OTHERWISE STATED



Standard channel letters mounted to raceway. Red Translucent faces, black trim cap, black returns to Medium Grey raceway. White LED Illumination

104"X9" ILLUMINATED CABINET OR NON-ILLUMINATED SIGN PANEL

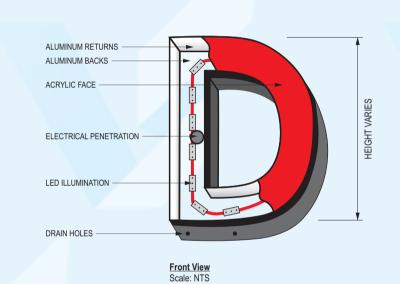

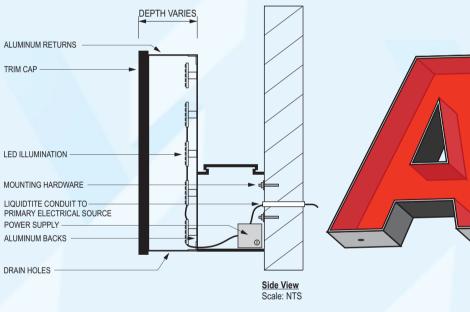

SAMPLES FABRICATED AND INSTALLED BY VITAL SIGNS.





764 Ridge Rd Webster, New York 14580 Phone: 585-787-4256 Fax: 585-347-4290 **Client:**

146.00"

Caesar / Adelits Mexican Cocina

Location: **3349 Monroe Avenue** **Start Date:**

Revisions:

Job#:

Page:

Drawing#:

For proofing only. Colors and content are for proofing only and are representations of the actual finished product. Graphic locations may need to be adjusted to fit actual; **Store front / Vehicle / Existing Sign Faces / Commercial Properties.**

Please proof thoroughly for spelling, colors, content and placement. If revisions are required please note and fax back. If APPROVED PLEASE SIGN BELOW.

CLIENT APPROVAL - SIGNATURE REQUIRED

Sales Rep:

Designer:

West Elevation_Exterior Illuminated Chanel Letters_Proof V.4_Revised 2/25/2021

This custom artwork is for representational purposes only. Colors will not exactly match the paint or materials to be used.

ALL ELECTRICAL SIGNS
REQUIRE 120V ELECTRIC.
UNLESS OTHERWISE STATED



Standard channel letters mounted to raceway.

Red Translucent faces, black trim cap, black returns to match black receway.

White LED Illumination

104"X9" ILLUMINATED CABINET OR NON-ILLUMINATED SIGN PANEL




ALUMINUM RETURNS
ALUMINUM BACKS

ACRYLIC FACE

ELECTRICAL PENETRATION

DRAIN HOLES

Front View
Cold NTS

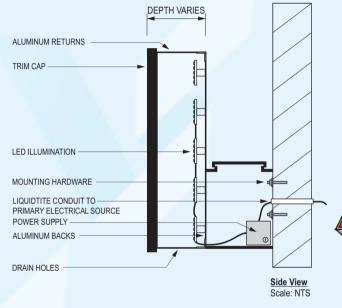



SAMPLES FABRICATED AND INSTALLED BY VITAL SIGNS.







764 Ridge Rd Webster, New York 14580 Phone: 585-787-4256 Fax: 585-347-4290 Client:

Caesar / Adelits Mexican Cocina

Location: 3349 Monroe Avenue

Start Date:

Revisions:

Job#:

Drawing#:

Page:

For proofing only. Colors and content are for proofing only and are representations of the actual finished product.

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Store front / Vehicle / Existing Sign Faces / Commercial Properties.

Please proof thoroughly for spelling, colors, content and placement. If revisions are required please note and fax back. If APPROVED PLEASE SIGN BELOW.

CLIENT APPROVAL - SIGNATURE REQUIRED

Sales Rep:

AC

Designer:

RD