Design Review & Historic Preservation Board Agenda January 10, 2019

HISTORIC PRESERVATION DISCUSSION

RESIDENTIAL APPLICATIONS FOR REVIEW

55 Mahogany Run

The Applicant is requesting design review for the addition of a 270 sq. ft. sunroom located to the rear of the home.

• 4 Saddle Brook

The Applicant is requesting design review for the addition of a 169 sq. ft. sunroom and a 588 sq. ft. second floor addition.

COMMERCIAL APPLICATIONS FOR REVIEW

• 100 Hahnemann Trail

The Applicant is requesting design review for three projects; a 150 sq. ft. addition on one of the cottages, a covered shed adjacent to the service area and a prefabricated storage shed adjacent to the cottages.

790 Linden Avenue

The Applicant is requesting design review for exterior modifications to convert space from a professional office to a dental office.

• 3350 Monroe Avenue

The Applicant is requesting design review for a 62.6 sq. ft. business identification sign.

COMMENTS ON MONROE GOLF CLUB PROJECT

DISCUSSION ON HISTORIC HOME DESIGNATION

OTHER - REVIEW OF 12/13/2018 MINUTES

Draft

Design Review and Historic Preservation Board Minutes December 13, 2018

PRESENT

Bonnie Salem, Paul Whitbeck, David Wigg, John Mitchell, Kathleen Cristman

ALSO PRESENT

Stephanie Townsend, Town Board liaison; Robert Koegel, Town Attorney; Allen Reitz, Assistant Building Inspector; Susan Donnelly, Secretary to the Board

ABSENT

Dirk Schneider, Chairman; Leticia Fornataro

David Wigg, Vice Chairman, opened the meeting at 6:55 pm.

HISTORIC PRESERVATION DISCUSSION

An update on the demolition legislation was given; no vote has been taken on the matter. Bonnie Salem and Paul Whitbeck attended the Town Board meeting and reported on the progress. A discussion was held on which Board Planning or Design Review should have approval on whether a home is demolished. The Town Board is now reviewing the legislation and a Public Hearing on the final draft will be held. Any further comments should be directed to the Town Board. Board members feel the legislation to be drafted should benefit the Town as opposed to being made easier for potential developers.

RESIDENTIAL APPLICATIONS FOR REVIEW

15 Windmill Road

The Applicant is requesting design review for the addition of a 607 sq. ft. second floor master suite.

The architect Arthur Renauto, representing the homeowners Mr. and Mrs. Moynihan, was present.

He explained that materials (siding, roofing and windows) will match the existing. The porch columns will be thickened to 10" x 10" to give a more contemporary style. A front entryway and and second story gable will be added.

The Board felt that this upgrade is appropriate to the neighborhood and complementary to the style of the home.

David Wigg moved to accept the application as submitted. Paul Whitbeck seconded.

All Ayes.

31 Aden Hill

The Applicant is requesting design review for the construction of a 1796 sq. ft. new single story home.

Jeff Brokaw representing Morrell Builders was present.

Board members commented on the number of architectural elements on the front elevation. They felt two elements would be more attractive than three.

David Wigg moved to approved the application with the recommendation that two elements be on the front elevation. John Mitchell seconded.

All Ayes.

• 12 Ravenna Crescent

The Applicant is requesting design review for the construction of a 3562 sq. ft. two story new dwelling.

Jim Connaughton of Coventry Ridge Development Corporation was present to discuss the application with the Board. Mr. Connaughton indicated that the colors would be neutral.

The Board noted that this design fits nicely into the existing neighborhood.

Bonnie Salem moved to accept the application as submitted. Kathleen Cristman seconded.

All Ayes.

OTHER

The Board discussed outreach to owners of designated homes and agreed to put this item on the January agenda.

REVIEW OF 11/08/2018 MINUTES


Bonnie Salem moved to accept the minutes with one correction. Paul Whitbeck seconded.

All Ayes.

The meeting adjourned at 7:40 pm.

Respectfully submitted,

Susan Donnelly Secretary to the Board

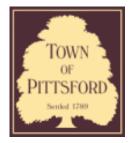

Town of Pittsford

Department of Public Works 11 South Main Street Pittsford, New York 14534

Permit # B18-000213

Phone: 585-248-6250 FAX: 585-248-6262

DESIGN REVIEW AND HISTORIC PRESERVATION BOARD REFERRAL OF APPLICATION

Property Address: 55 Mahogany PITTSFORD, NY 14534

Tax ID Number: 177.04-2-12

Zoning District: RN Residential Neighborhood

Owner: Walter, Kevin A

Applicant: Woodstone Custom Homes Inc.

Application Type:

Residential Design Review

§185-205 (B)

- Commercial Design Review
 - §185-205 (B)
- Signage
 - §185-205 (C)
- Certificate of Appropriateness
- §185-197
- Landmark Designation
 - §185-195 (2)
- Informal Review


- Build to Line Adjustment
 - §185-17 (B) (2)
- Building Height Above 30 Feet
 - §185-17 (M)
- Corner Lot Orientation
 - §185-17 (K) (3)
- Flag Lot Building Line Location
 - §185-17 (L) (1) (c)
- Undeveloped Flag Lot Requirements
 - §185-17 (L) (2)

Project Description: Applicant is requesting design review for the addition of a sun room. The sun room will be located to the rear of the home and will be approximately 270 sq. ft. Siding will match existing the existing home.

Meeting Date: January 10, 2019



RN Residential Neighborhood Zoning

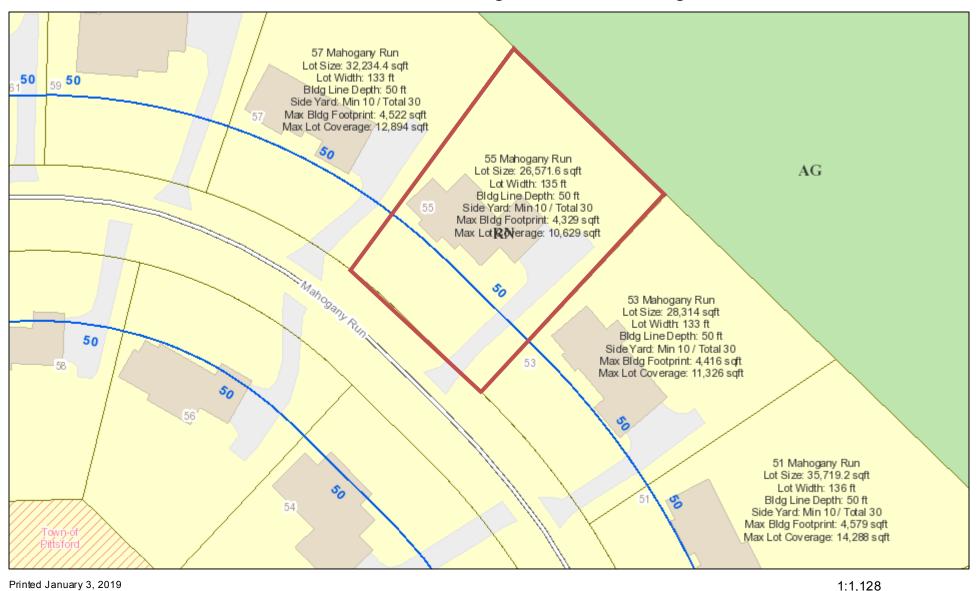

Town of Pittsford GIS

45

12.5

90

25


180 ft

50 m



GENERAL NOTES:

- THESE PLANS HAVE BEEN PREPARED TO THE BEST OF THE ARCHITECT'S KNOWLEDGE, BELIEF, AND PROFESSIONAL JUDGMENT IN ACCORDANCE WITH THE INTERNATIONAL RESIDENTIAL CODE (2015 IRC) AND ENERGY CONSERVATION CODE REQUIREMENTS. THE CONTRACTOR SHALL BE RESPONSIBLE FOR ADAPTING THESE PLANS, IF REQUIRED, TO SUIT THE NEEDS OF THE BUILDING ON THE SITE. PROVIDED THAT THE ALTERATIONS DO NOT VIOLATE THE CODE OR ALTER THE STRUCTURAL INTEGRITY OF THE BUILDING.
- THE CONTRACTOR SHALL BE RESPONSIBLE FOR COMPLIANCE WITH ALL APPLICABLE BUILDING/ELECTRICAL/MECHANICAL/SANITARY AND ENERGY CODES; STATE OR LOCAL. THE CONTRACTOR SHALL BE RESPONSIBLE FOR COMPLIANCE WITH THE ENERGY CONSERVATION CODE FOR ALL HVAC EQUIPMENT, HVAC CONTROLS, WATER HEATING EQUIPMENT, PIPE AND DUCT INSULATION, AND FLUORESCENT LAMPS AND BALLASTS.
- THE CONTRACTOR SHALL BE RESPONSIBLE SO THAT BRANDS OF WINDOWS AND DOORS INSTALLED MEET THE NEW YORK STATE ENERGY CONSERVATION CODE REQUIREMENTS. WINDOWS AND / OR DOORS SHOWN ARE INDICATED FOR SIZING ONLY.
- ALL FOOTINGS SHALL REST ON UNDISTURBED VIRGIN SOIL. THE FOOTING/FOUNDATION DESIGN ASSUMES MINIMUM SOIL BEARING PRESSURE TO BE 2000 PSF. CONTRACTOR SHALL BE RESPONSIBLE FOR ALL SUBGRADE CONDITIONS. IF REQUIRED, THE OWNER AND / OR CONTRACTOR SHALL BE RESPONSIBLE FOR HIRING A SOILS ENGINEER TO VERIFY SUBGRADE CONDITIONS AND SUBSTANTIATE ACTUAL BEARING CAPACITY.
- BACKFILL MATERIALS SHALL BE NATIVE SOIL. FOR FILL UNDER THE GARAGE FLOOR OR BASEMENT FLOOR, PROVIDE SAND/ GRAVEL FILL FOR COMPACTION AS NEEDED
- MINIMUM CONCRETE COMPRESSIVE STRENGTH: 2500 PSI FOOTINGS
- 2500 PSI FLOOR SLABS 3500 PSI GARAGE
- CONCRETE BLOCK SHALL CONFORM TO ASTM C90 N-I, WALL REINFORCING ASTM A82. ALL MORTAR SHALL CONFORM TO ASTM C270, TYPE S - I PART PORTLAND CEMENT, I/4 PART
- STRUCTURAL STEEL SHALL CONFORM TO ASTM A36. SHOP-PRIME PAINT TT-P-20, TT-P-31C, TT-P-8G. FABRICATION AND INSTALLATION PER THE LATEST EDITION OF THE AISC
- MINIMUM FIBER STRESS IN BENDING (FB) FOR ALL FRAMING LUMBER TO BE 1150 PSI #2 HEM-FIR OR BETTER. PROVIDE DOUBLE FRAMING MEMBERS UNDER PARTITIONS RUNNING IN
- CONTRACTOR SHALL PAY STRICT ADHERENCE TO MICROLAM MANUFACTURER'S WRITTEN DIRECTIONS FOR CUTTING, DRILLING, NOTCHING, JOINING AND GENERAL INSTALLATION OF THEIR PRODUCTS.
- WOOD TRUSSES SHALL BE DESIGNED BY MANUFACTURER.
 SUPPLIER SHALL BE RESPONSIBLE FOR INSTALLATION DETAILS
- PLYWOOD SHALL CONFORM TO U.S. PRODUCT STANDARD PS I, THICKNESS AS SHOWN, APA RATED SHEATHING EXP-I. NAILING AND SPACING PER APA RECOMMENDATIONS FOR
- ALL WOOD IN CONTACT WITH CONCRETE OR MASONRY SHALL BE FULLY WOOD PRESERVATIVE-TREATED WITH OSMOSALTS OR WOLMAN SALTS.
- ALL OPENINGS IN THE BUILDING ENVELOPE (DOORS, WINDOWS, UTILITIES) SHALL BE CAULKED, WEATHER-STRIPPED, OR OTHERWISE SEALED. CORROSION RESISTIVE FLASHING SHALL BE PROVIDED AT THE LOCATIONS ON THE EXTERIOR WALL ENVELOPE PER R 703.8 OF THE RESIDENTIAL CODE OF NEW YORK (2015)
- CONTRACTOR SHALL VERIFY ALL NOTES AND DIMENSIONS PRIOR TO CONSTRUCTION. THESE DRAWINGS ARE NOT TO BE SCALED USE DIMENSIONS GIVEN.
- CONTRACTOR SHALL BE RESPONSIBLE FOR ALL CONSTRUCTION MEANS, METHODS, TECHNIQUES, SEQUENCES AND SAFETY PRECAUTIONS IN CONNECTION WITH THE WORK
- THESE DRAWINGS HAVE BEEN PREPARED FOR STRUCTURAL INTENT ONLY. ELECTRICAL, MECHANICAL AND OTHER BUILDING SYSTEMS, AS REQUIRED ARE TO BE DESIGNED BY OTHERS.
- THE FOLLOWING DESIGN LOADS HAVE BEEN USED IN THE STRUCTURES DESIGN IN ACCORDANCE WITH THE PRINTED SPAN TABLES IN THE RESIDENTIAL CODE OF NEW YORK STATE (2015).
 - FLOOR LOADS (LIVING AREAS-IST FLOOR) SLEEPING AREAS (2ND FLOOR)
- ALL WORK, MATERIALS, METHODS, EQUIPMENT, ETC. SHALL BE IN STRICT ACCORDANCE WITH THE CONTRACT DOCUMENTS. ALL MATERIALS SHALL BE NEW, UNLESS NOTED OTHERWISE.
- WORK SEQUENCE AND SCHEDULE SHALL BE MUTUALLY AGREED UPON BY BOTH THE OWNER AND THE
- IT IS ASSUMED THAT THE SUBSURFACE CONDITIONS WILL BE EARTH OR SOIL. IF BEDROCK IS ENCOUNTERED, REMOVAL WILL BE CONSIDERED AN ADDITION TO CONTRACT.
- ANY DEMOLITION WORK SHALL BE DONE CAREFULLY. ALL DISTURBED SURFACES TO BE REPAIRED APPROPRIATELY. ALL SALVAGEABLE ITEMS SHALL BE TURNED OVER TO THE OWNER.
- EXAMINATION OF THE SITE SHOULD BE MADE BY ALL CONTRACTORS CONCERNED TO FULLY CONSIDER ALL SITE CONDITIONS WHICH MAY HAVE A BEARING ON THE WORK OF THE ENTIRE PROJECT. SUBMISSION OF A BID IS PRESUMPTIVE EVIDENCE THAT THE BIDDER IS CONVERSANT WITH LOCAL JURISDICTIONS AND HAS MADE DUE ALLOWANCES IN HIS BID FOR ALL CONTINGENCIES. THE OWNER RESERVES THE RIGHT TO REJECT ANY OR ALL BIDS.
- IT IS THE RESPONSIBILITY OF THE CONTRACTOR TO NOTIFY THE ARCHITECT IN CASE OF ANY OR ALL DEVIATIONS FROM THESE DRAWINGS. THE ARCHITECT SHALL BE HELD HARMLESS AS A RESULT OF ANY UNAUTHORIZED CHANGES TO THESE PLANS. ADDITIONAL FEES MAY OCCUR FOR "AS BUILT" DOCUMENTATION DUE TO CIRCUMSTANCES BEYOND THE ARCHITECT'S CONTROL, OR OWNER / CONTRACTOR CHANGES
- THE CONTRACTOR SHALL OBTAIN AND PAY FOR ALL PERMITS AND APPROVALS REQUIRED BY THE LOCAL ZONING AND BUILDING DEPARTMENTS AND ANY OTHER GOVERNMENTAL AGENCY HAVING JURISDICTION OVER THE WORK. ALL APPLICABLE REGULATIONS SHALL BE ADHERED TO AND CARRIED OUT BY ALL INDIVIDUALS
- THE CONTRACTOR SHALL FURNISH A CERTIFICATE OF INSURANCE INDICATING THE TYPE AND AMOUNTS OF COVERAGE AS REQUIRED BY NEW YORK STATE AND THE LOCAL MUNICIPALITY.
- THE CONTRACTOR SHALL REMOVE ALL RUBBISH AND LEAVE THE COMPLETED PROJECT IN A CLEAN STATE, SATISFACTORY TO THE OWNER.
- THE CONTRACTOR SHALL GUARANTEE HIS WORK AND HIS SUBCONTRACTOR'S WORK AGAINST FAULTY MATERIALS AND WORKMANSHIP IN ACCORDANCE WITH NEW YORK STATE GENERAL BUSINESS LAW.
- ONLY COPIES FROM THE ORIGINALS OF THESE DRAWINGS MARKED WITH AN ORIGINAL OF THE ARCHITECT'S EMBOSSED SEAL SHALL BE CONSIDERED TO BE VALID TRUE COPIES.
- BUILDING IS CLASSIFIED AS A ONE FAMILY DWELLING
- SMOKE-DETECTING ALARM DEVICES SHALL BE INSTALLED IN COMPLIANCE WITH SECTION R3I3.I OF THE RESIDENTIAL CODE OF NEW YORK STATE (2015) CARBON MONOXIDE ALARM DEVICES SHALL BE INSTALLED IN COMPLIANCE WITH SECTION R313.4 OF THE RESIDENTIAL CODE OF NEW YORK STATE (2015)
- PROVIDE A MIN. 3/4 HR. FIRE SEPARATION PER SECTION R309.2 OF THE RESIDENTIAL CODE OF NEW YORK STATE (2015) ALL WALLS AND FLOORS DEMISING RESIDENCE FROM AN ATTACHED GARAGE
- ALL MATERIALS USED IN THIS PROJECT SHALL BE NON-ASBESTOS AND NON-LEAD CONTAINING.

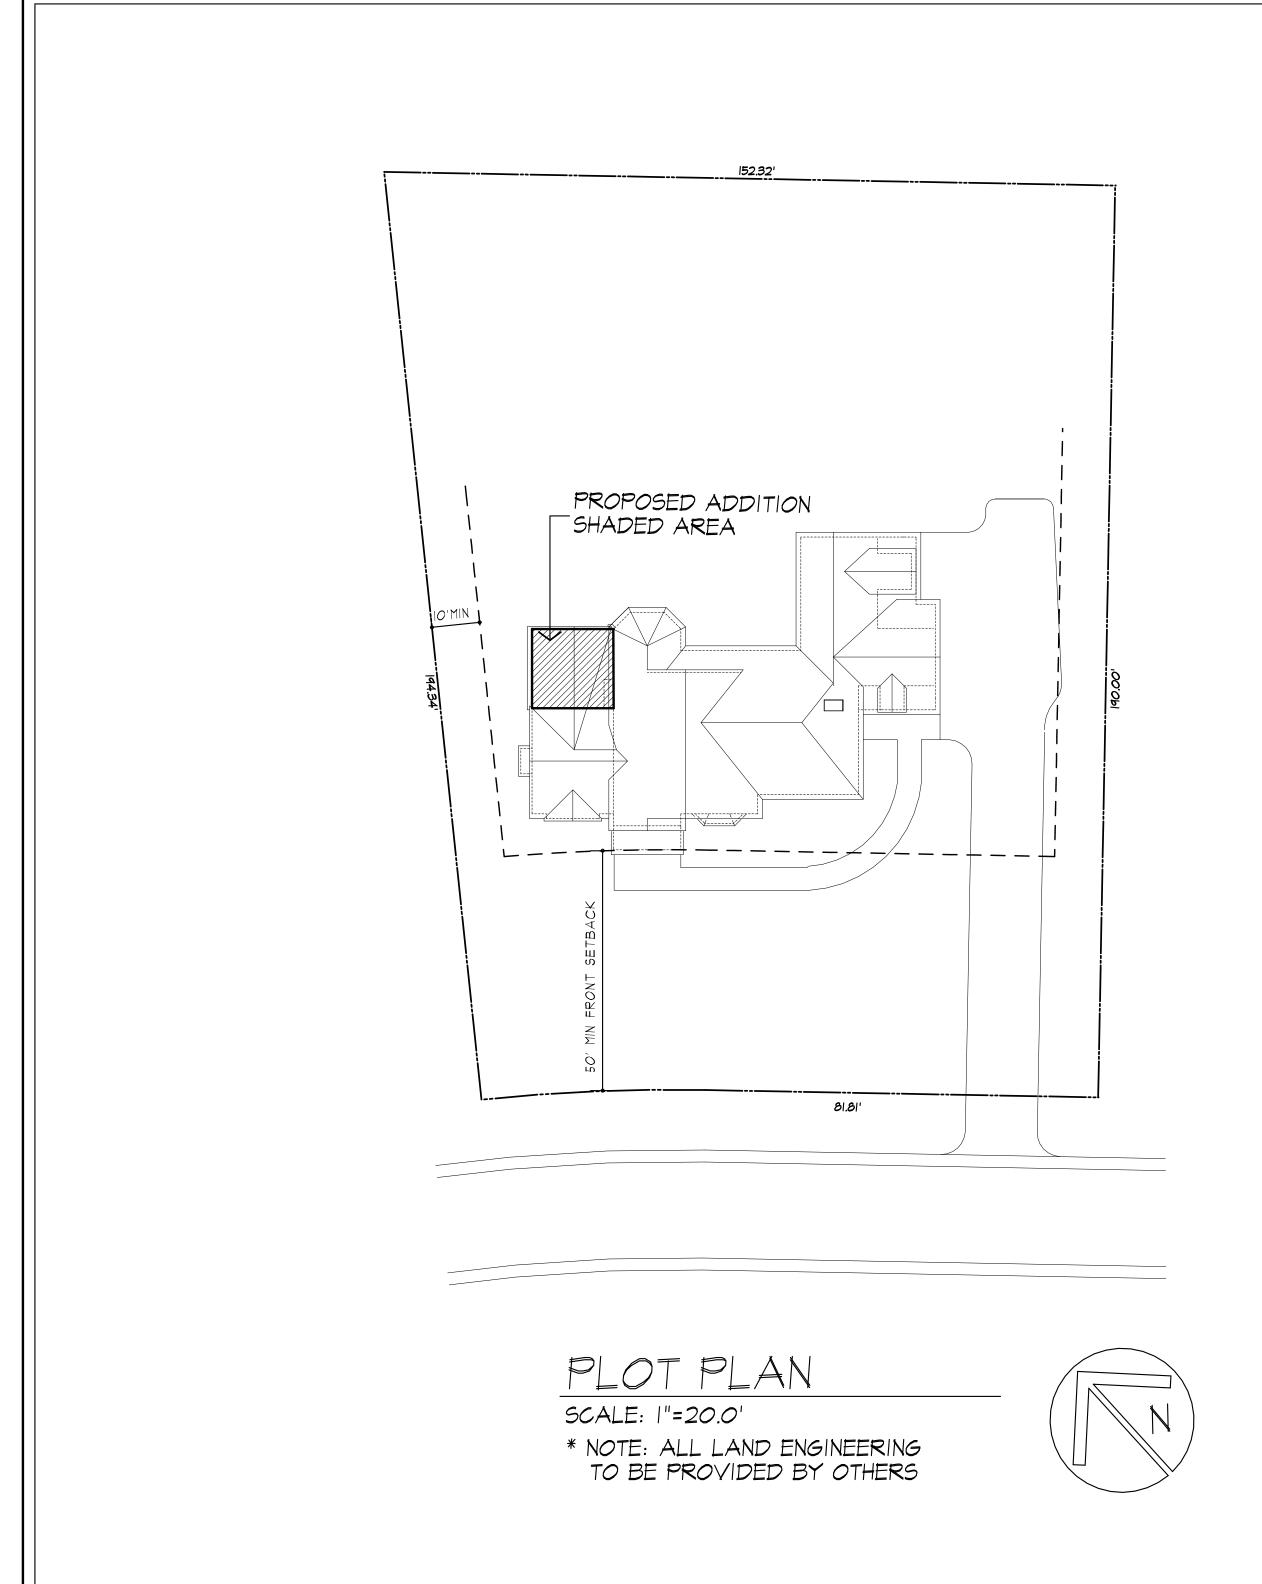

ADDITION TO WALTER RESIDENCE

55 MAHOGANY RUN PITTSFORD, NY

WOODSTONE CUSTOM HOMES

DRAWING INDEX

TITLE PAGE

ELEVATIONS/TYP NOTES

BSMT PLAN/BLDG SECTIONS/TYP NOTES

FLOOR PLAN/ROOF PLAN/TYP NOTES

ENERGY COMPLIANCE DETAILS & PATH

MEETS OR EXCEEDS PRESCRIPTIVE REQUIREMENTS PER INTERNATIONAL RESIDENTIAL CODE (2015 IRC) CLIMATE ZONE - 5

COMPONENT	REQUIRED	PROVIDED
I. FENESTRATION U-FACTOR	.32	.32
2. CEILING R-FACTOR	49	49
3. IST \$ 2ND FLOOR WOOD FRAMED WALL R-VALUE	20 OR 13+5	HIGH DENSITY 21 21/BAND JSTS
4. BASEMENT CONCRETE WALL R-VALUE	15 CONTINUOUS OR 19 CAVITY FULL HEIGHT	R-15 CONTINUOUS FULL HEIGHT

2015 INTERNATIONAL ENERGY CONSERVATION CODE (IECC) COMPLIANCE PATH

- I. A MINIMUM OF 75% OF THE LAMPS IN PERMANENTLY INSTALLED LIGHTING FIXTURES SHALL BE HIGH-EFFICIENCY LAMPS PER SECTION 1104.1
- 2. RECESSED LUMINARIES INSTALLED IN THE BUILDING THERMAL ENVELOPE SHALL BE SEALED WITH A GASKET OR CAULK BETWEEN THE HOUSING AND THE INTERIOR WALL OR CEILING COVERING TO LIMIT AIR LEAKAGE BETWEEN CONDITIONED AND UNCONDITIONED SPACES. PER SECTION 1102.4.5
- 3. CONTRACTOR TO PROVIDE A PROGRAMMABLE THERMOSTAT TO CONTROL THE HVAC SYSTEM PER SECTION 1103.1.1
- 4. ALL CIRCULATING SERVICE HOT WATER PIPING SHALL BE INSULATED TO AT LEAST R-2. CIRCULATION HOT WATER SYSTEMS SHALL INCULDE AN AUTOMATIC OR READILY ACCESSIBLE MANUAL SWITCH THAT CAN TURN OFF THE HOT WATER CIRCULATING PUMP WHEN THE SYSTEM IS NOT IN USE. PER SECTION 1103.3.4
- 5. AIR LEAKAGE TEST TO BE CONDUCTED & PERFORMED BY A THIRD PARTY IN COMPLIANCE WITH 1102.4.1.2. AIR LEAKAGE RATE MAY NOT EXCEED 3 ACH (CLIMATE ZONE 5)
- 6. ATTIC ACCESS SHALL BE INSULATED WITH THE SAME R-VALUE AS THE ATTIC, WEATHER STRIPPED AND LATCHED PER SECTION 1102.2.3
- 1. DUCTWORK ON EXTERIOR WALLS IF REQUIRED SHALL BE INSULATED TO A MINUMUM
- 8. MECHANICAL VENTILATION PER SECTION NIIO3.6 TO BE MET WITH CONTINUOUS USE EXHAUST FANS AND MAKE-UP AIR CONTROLS, PER
- 9. MECHANICAL VENTILATION FAN EFFICACY SHALL MEET MINIMUM REQUIREMENTS PER SECTION NIIO3.6.1.
- IO. HEATING AND COOLING EQUIPMENT SHALL BE SIZED IN ACCORDANCE WITH SECTION NIIO3.7 REQUIREMENTS.

BASIC DESIGN CRITERIA

- I. GROUND SNOW LOAD 40 PSF R301.2 (5)
- 2. WIND SPEED 115 MPH, EXPOSURE B R301.2.1
- 3. SEISMIC DESIGN CATEGORY A R301.2 (2)
- 4. WEATHERING SEVERE
- 5. FROST LINE DEPTH 48"
- 6. TERMITE DAMAGE NONE TO SLIGHT
- 7. DECAY DAMAGE NONE TO SLIGHT
- 8. WINTER DESIGN TEMPERATURE 1
- 9. ICE SHIELD UNDERLAYMENT REQUIRED YES
- 10. FLOOD HAZARD FIRM 1992
- II. ROOF TIE DOWN REQUIREMENTS R802.II.I

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PATRICK J. MORABITO, A.I.A. ARCHITECT P.C.

CLIENT: WOODSTONE CUSTOM HOMES

DRAWING:

TITLE PAGE

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55 MAHOGANY RUN PITTSFORD, NY

DATE: DECEMBER 2018

1/4"=1'-0" JOB NO.: 18M3791

SHEET:

OF 4 SHEETS



TABLE NIIO2.4.I.I AIR BARRIER AND INSULATION INSTALLATION

COMPONENT	CRITERIA
GENERAL	A CONTINUOUS AIR BARRIER SHALL BE INSTALLED IN THE BUILDING ENVELOPE
	BREAKS OR JOINTS IN THE AIR BARRIER ARE SEALED
	AIR PERMEABLE INSULATION SHALL NOT BE USED AS A SEALING MATERIAL
	THE EXTERIOR THERMAL ENVELOPE CONTAINS A CONTINUOUS AIR BARRIER
CEILING/ATTIC	AIR BARRIER IN ANY DROPPED CEILING OR SOFFIT IS SUBSTANTIALLY ALIGNED WITH INSULATION AND ANY GAPS ARE SEALED
WALLS	CORNERS AND HEADERS ARE INSULATED (R-3 PER INCH MIN)
	JUNCTION OF FOUNDATION AND SILL PLATE IS SEALED
WINDOWS AND DOORS	SPACE BETWEEN WINDOW AND DOOR JAMBS AND FRAMING IS SEALED
RIM JOISTS	RIM JOISTS ARE INSULATED AND INCLUDE AN AIR BARRIER
FLOORS - INCLUDING ABOVE GARAGE AND CANTILEVERED FLOORS	INSULATION IS INSTALLED TO MAINTAIN PERMANENT CONTACT WITH UNDERSIDE OF SUBFLOOR DECKING
OANTILL VERED TEOORS	AIR BARRIER IS INSTALLED AT ANY EXPOSED EDGE OF INSULATION
SHAFTS PENETRATIONS	DUCT SHAFTS, UTILITY PENETRATIONS, KNEE WALLS AND FLUE SHAFTS OPENING TO EXTERIOR OR UNCONDITIONED SPACE ARE SEALED
NARROW CAVITIES	BATTS IN NARROW CAVITIES ARE CUT TO FIT, OR NARROW CAVITIES ARE FILLED BY SPRAYED/BLOWN INSULATION
GARAGE SEPARATION	AIR SEALING IS PROVIDED BETWEEN GARAGE AND CONDITIONED SPACES
RECESSED LIGHTING	RECESSED LIGHT FIXTURES ARE AIR TIGHT, IC RATED, AND SEALED TO DRYWALL. EXCEPTION; FIXTURES IN CONDITIONED SPACE
PLUMBING AND WIRING	INSULATION IS PLACED BETWEEN OUTSIDE AND PIPES
	BATT INSULATION IS CUT TO FIT AROUND WIRING AND PLUMBING, OR SPRAYED/BLOWN INSULATION EXTENDS BEHIND PIPING AND WIRING
SHOWER OR TUB ON EXTERIOR WALL	SHOWERS AND TUBS ON EXTERIOR WALLS HAVE INSULATION AND AN AIR BARRIER SEPARATING THEM FROM THE EXTERIOR WALL
ELECTRICAL OR PHONE BOX ON EXTERIOR WALLS	AIR BARRIER EXTENDS BEHIND BOXES OR AIR SEALED-TYPE BOXES ARE INSTALLED
HVAC REGISTER BOOTS	HVAC REGISTER BOOTS THAT PENETRATE BUILDING ENVELOPE ARE SEALED TO SUBFLOOR OR DRYWALL
FIREPLACE	FIREPLACE WALLS INCLUDE AN AIR BARRIER

TYPICAL NOTES

I.) DOOR MANUFACTURER: PELLA ENCOMPASS SLIDING 0.10 CFM IN-SWING HINGED 0.15 CFM PELLA ENTRY DOORS: 0.30 CFM OR LESS

2.) WINDOW AIR INFILTRATION
PELLA 250 SERIES/PELLA ENCOMPASS
DOUBLE HUNG 0.30 CFM
CASEMENT, AWNING, FIXED 0.05 CFM

3.) N/A

- 4.) JOINTS IN DUCT SYSTEM SEALED WITH MASTIC, TAPE OR GASKETING.
- 5.) CLASS I VAPOR RETARDER ON INTERIOR OF 2X4 FRAMED WALLS: RIGID POLYISOCYANURATE FOAM-FOIL BOARD CLASS II VAPOR RETARDER ON INTERIOR OF CEILINGS AND 2X6 FRAMED WALLS: KRAFT BATTS
- 6.) MECHANICAL SYSTEM PIPING CAPABLE OF CARRYING FLUIDS ABOVE 105F OR BELOW 55F SHALL BE INSULATED TO A MINIMUM OF R-3.
- 7.) BUILDING CAVITIES SHALL NOT BE USED FOR SUPPLY DUCTS.
- 8.) N/A
- 9.) THE AIR HANDLER AND ALL DUCTS SHALL BE LOCATED WITHIN THE CONDITIONED SPACE. IF ANY DUCTWORK IS LOCATED COMPLETELY OUTSIDE OF THE CONDITIONED SPACE THE DUCT TIGHTNESS SHALL BE VERIFIED PER SECTION 403.2.2 OF THE 2015 ENERGY CONSERVATION CODE.
- IO.) ANY SUPPLY DUCTS IN THE ATTICS SHALL BE INSULATED TO A MINIMUM OF R-8. ALL OTHER DUCTS LOCATED COMPLETELY OUTSIDE OF THE BUILDING THERMAL ENVELOPE SHALL BE INSULATED TO A MINIMUM OF R-6.



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PROJECT: SUNROOM ADDITION M/M WALTER 55 MAHOGANY RUN PITTSFORD, NY

CLIENT: WOODSTONE CUSTOM HOMES

DRAWING:

ELEVATIONS

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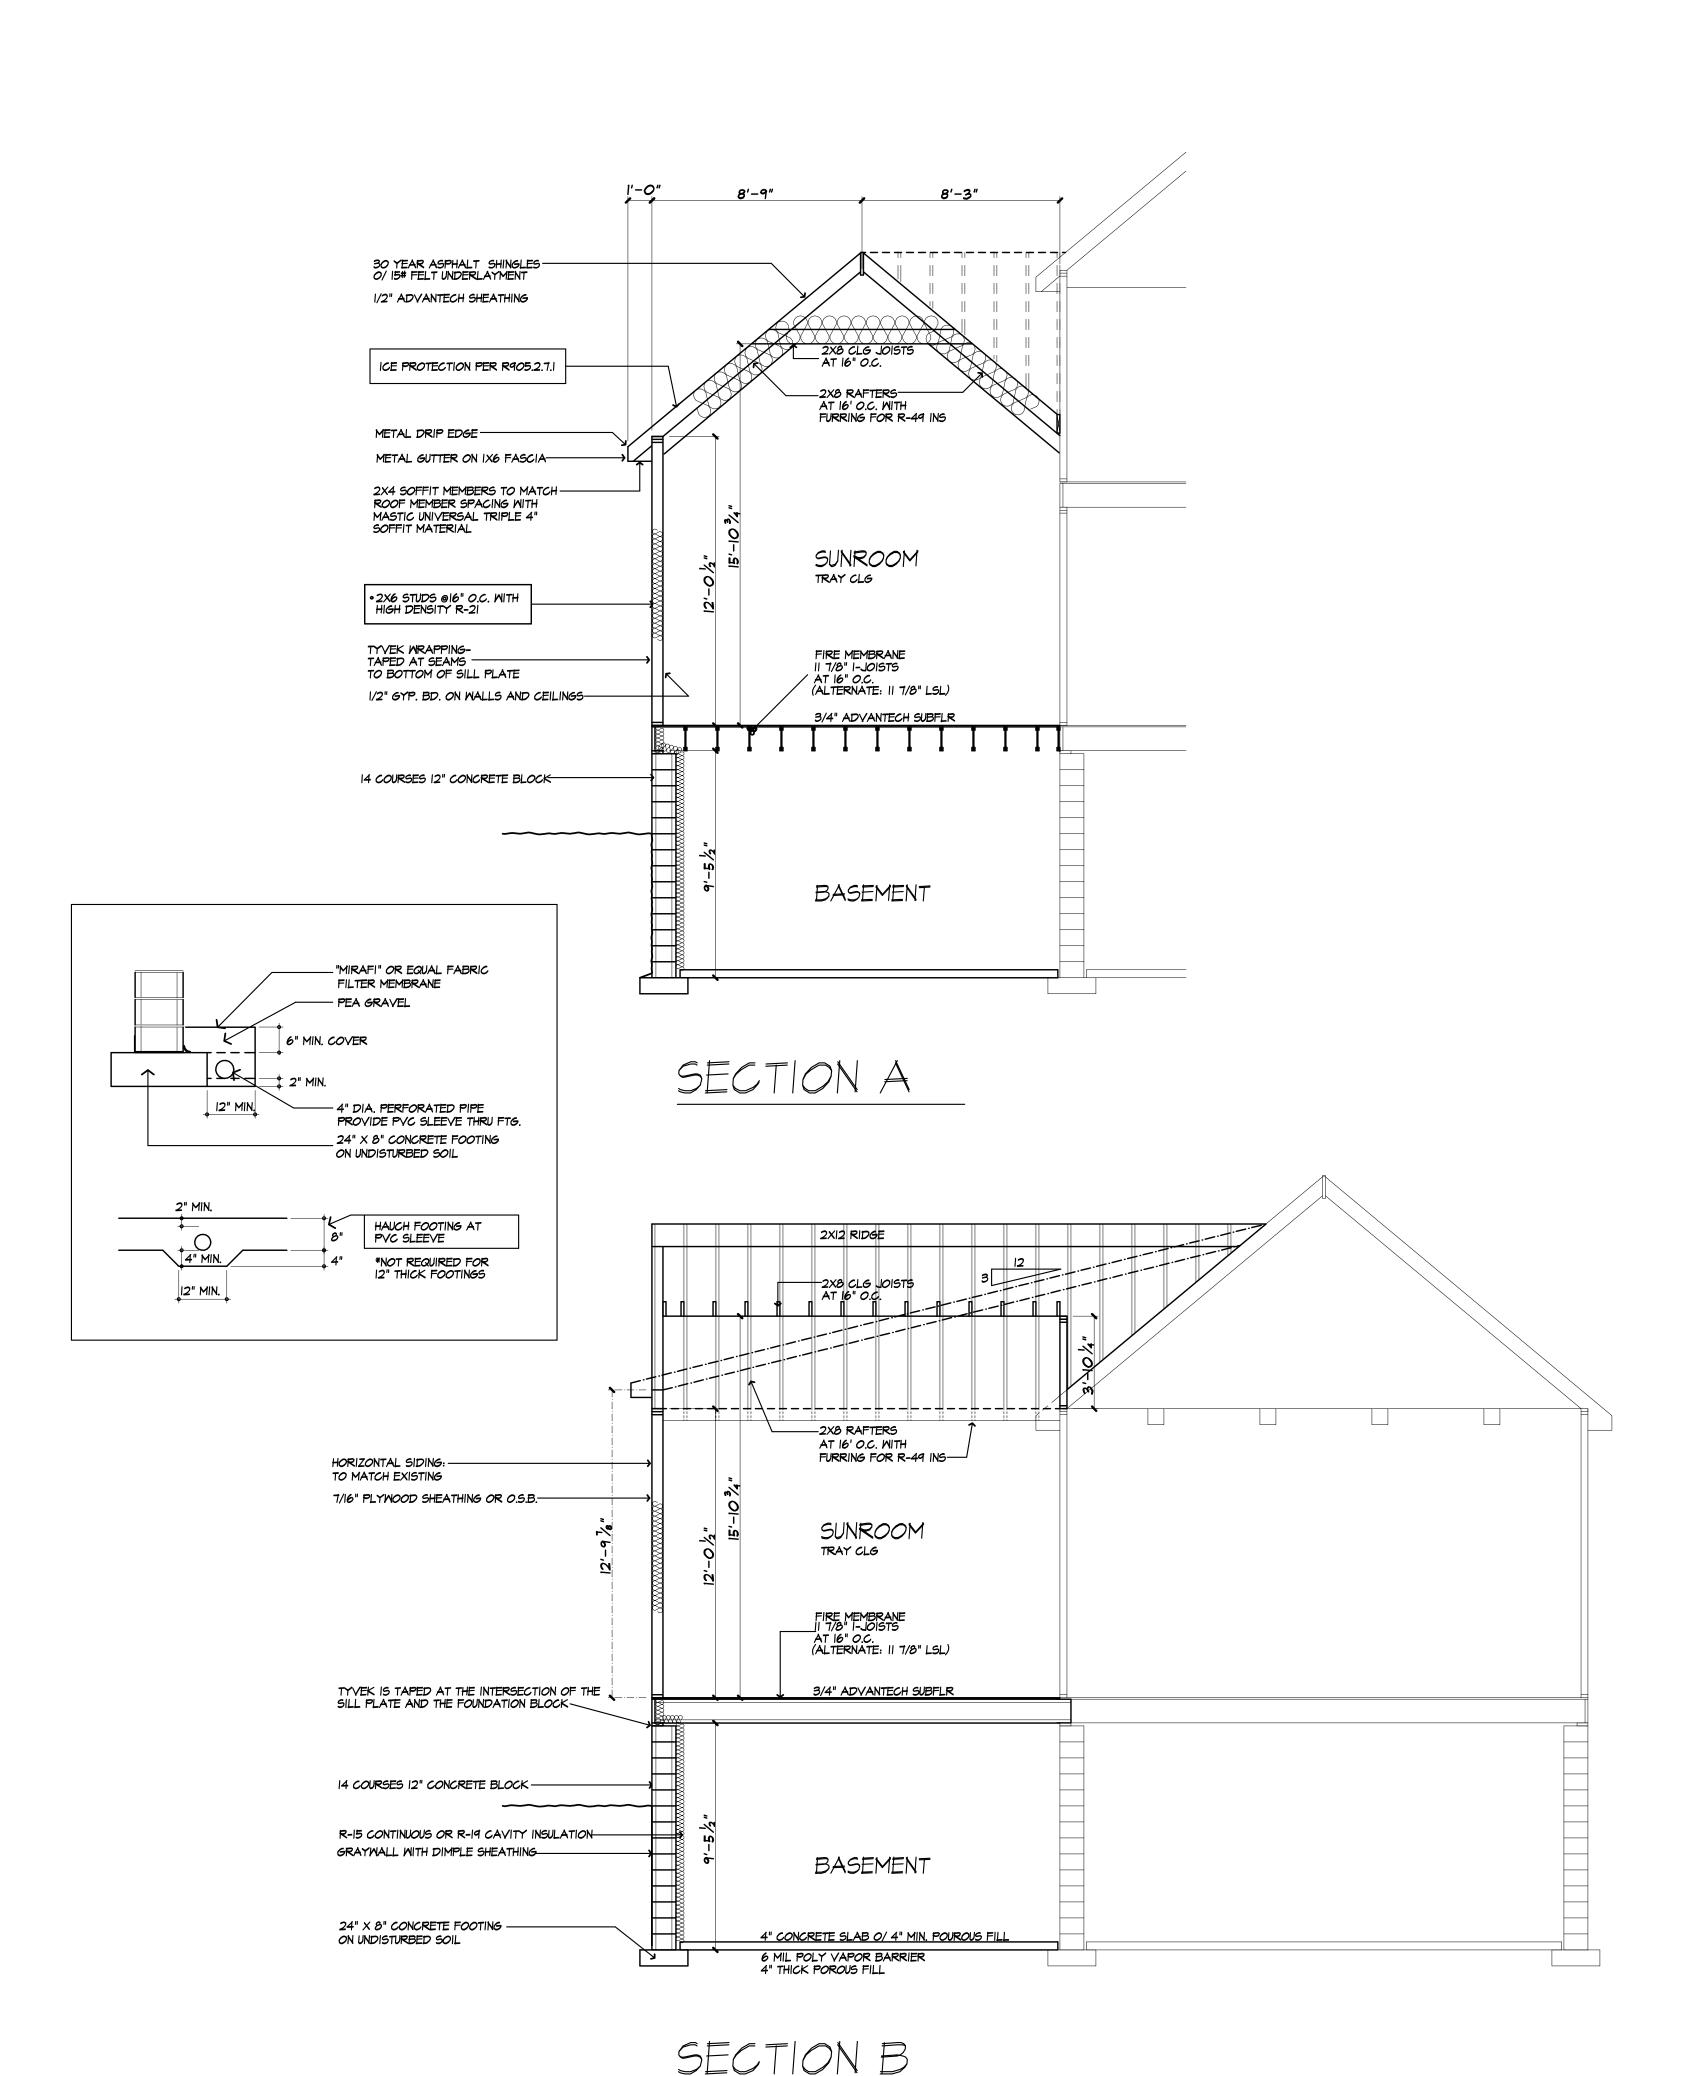
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SCALE: 1/4"=1'-0" JOB NO.: 18M3791


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OF **4** SHEETS





FIRE PROTECTION PERFORMANCE. I. FOOTINGS TO BE PLACED ON UNDISTURBED SOIL HAVING A MIN. BEARING CAPICITY OF 2000 P.S.F.
12" BLK.- 24" WIDE X 8" THK. 2. MIN. CONC. COMPRESSIVE STRENGTH IN 28 DAYS: FOOTINGS: 2500 P.S.I. FLOOR SLABS: 2500 P.S.I. 3: PROVIDE CROSS BRIDGING AT MID SPAN OF FLOOR FRAMING

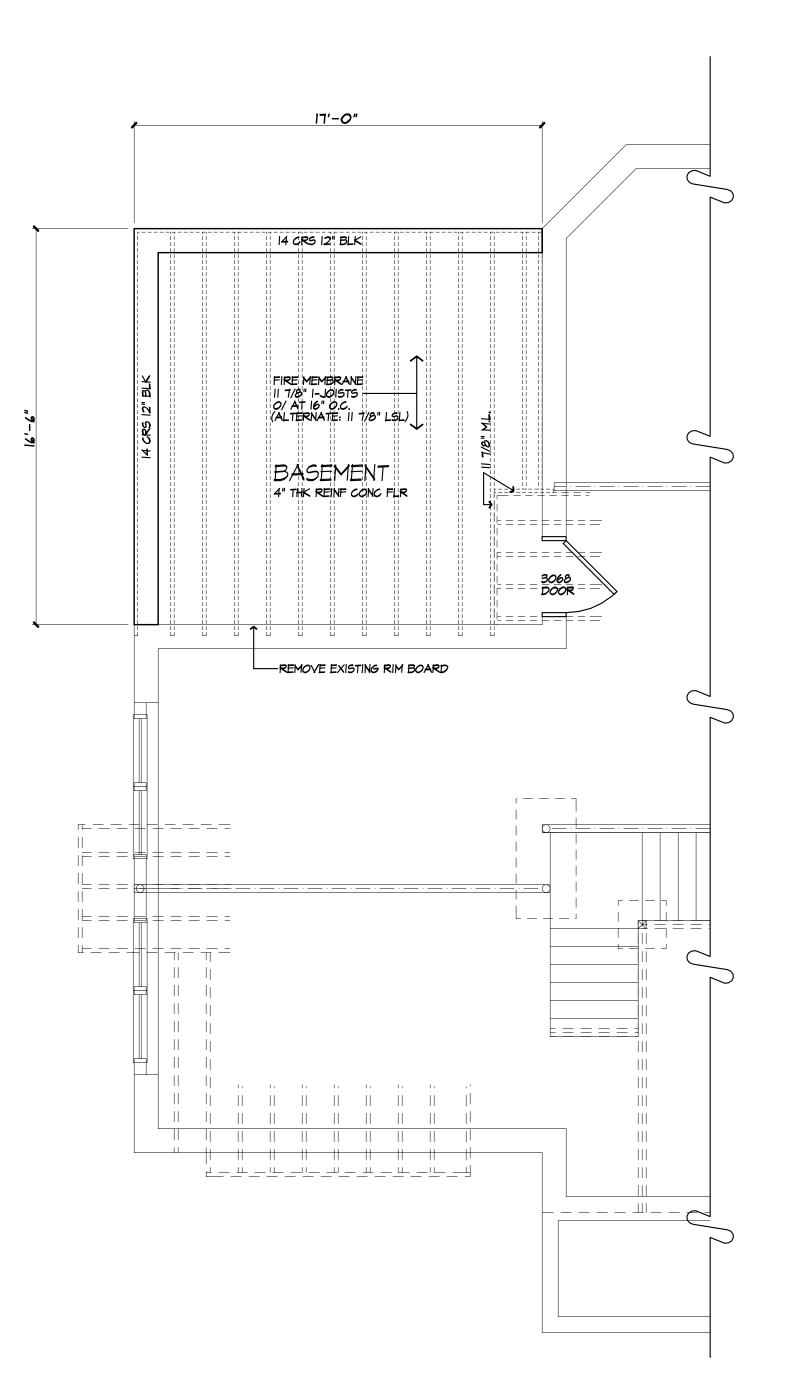

BASEMENT & FOUNDATION PLAN

14 CRS 12" BLOCK

FIRE PROTECTION REQUIREMENTS PER R302.13 1/2" GYPSUM BOARD OR 5/8" THK STRUCTURAL PANEL APPLIED TO BOTTOM OF 1-JOISTS. PENETRATIONS FOR DUCTWORK, PLUMBING OR ELECTRICAL OR OTHER SIMILAR PENETRATIONS ARE PERMITTED BY THIS CODE SECTION. APPLIED OVER ENGINEERED FLOOR JOISTS (1-JOISTS) EXCEPTIONS:

. FLOOR ASSEMBLIES LOCATED OVER BASEMENT PROTECTED BY AN APPROVED AUTOMATIC SPRINKLER SYSTEM INSTALLED IN COMPLIANCE WITH SECTION 2904 (2015 IRC) OR NFPA ISD 2. FLOOR ASSEMBLY IS DIMENSIONAL LUMBER OR STRUCTURAL COMPOSITE LUMBER EQUAL TO OR GREATER THAN NOMINAL 2X 10 SIZE. ALTERNATE FIRST FLOOR JOISTS: 2X 12 AT 16"O.C.

1 3/4" X 11 7/8" LSL AT 16" O.C. 3. I JOISTS ARE PROVIDED WITH AN APPROVED COATING THAT DEMONSTRATES EQUIVILENT

WINDOW FALL PROTECTION

WINDOW FALL PROTECTION SHALL BE PROVIDED IN ACCORDANCE WITH SECTIONS R312.2.1 AND R312.2.2

R312.2.1 WINDOW SILLS.
IN DWELLING UNITS, WHERE THE TOP OF THE SILL OF AN OPERABLE
WINDOW OPENING IS LOCATED LESS THAN 24 INCHES ABOVE THE
FINISHED FLOOR AND GREATER THAN 72 INCHES ABOVE THE FINISHED
GRADE OR OTHER SURFACE BELOW ON THE EXTENDED OF THE BUILDING, THE OPERABLE WINDOW SHALL COMPLY WITH ONE OF THE

OPERABLE WINDOWS WITH OPENINGS THAT WILL NOT ALLOW A 4-INCH-DIAMETER (102 MM) SPHERE TO PASS THROUGH THE OPENING WHERE THE OPENING IS IN ITS LARGEST OPENED POSITION. 2.0PERABLE WINDOWS THAT ARE PROVIDED WITH WINDOW FALL PREVENTION DEVICES THAT COMPLY WITH ASTM F 2090. 3.0PERABLE WINDOWS THAT ARE PROVIDED WITH WINDOW OPENING CONTROL DEVICES THAT COMPLY WITH SECTION R312.2.2.

R312.2.2 WINDOW OPENING CONTROL DEVICES. WINDOW OPENING CONTROL DEVICES SHALL COMPLY MITH ASTM F 2090. THE MINDOW OPENING CONTROL DEVICE, AFTER OPERATION TO RELEASE THE CONTROL DEVICE ALLOWING THE WINDOW TO FULLY OPEN, SHALL NOT REDUCE THE NET CLEAR OPENING AREA OF THE WINDOW UNIT TO LESS THAN THE AREA REQUIRED BY SECTION R310.2.1.

WINDOW GLAZING

WINDOW GLAZING SHALL BE PROVIDED IN ALL HAZARDOUS LOCATIONS IN ACCORDANCE WITH SECTION R308

R308.4.1 GLAZING IN DOORS GLAZING IN FIXED AND OPERABLE PANELS OF SWINGING, SLIDING AND BIFOLD DOORS SHALL BE CONSIDERED TO BE A HAZARDOUS

I. GLAZED OPENINGS OF A SIZE THROUGH WHICH A 3" DIA SPHERE IS UNABLE TO PASS 2. DECORATIVE GLAZING

R308.4.7 GLAZING ADJACENT TO THE BOTTOM STAIR LANDING GLAZING ADJACENT TO THE LANDING AT THE BOTTOM OF A STAIRWAY WHERE THE GLAZING IS LESS THAN 36" ABOVE THE LANDING AND WITHIN A 60" HORIZONTAL ARC LESS THAN 180 DEGREES FROM THE BOTTOM TREAD NOSING SHALL BE CONSIDERED TO BE A HAZARDOUS LOCATION.

EXCEPTION: THE GLAZING IS PROTECTED BY A GUARD COMPLYING WITH SECTION R312 AND THE PLANE OF THE GLASS IS MORE THAN 18" FROM THE GUARD

SMOKE & CARBON MONOXIDE ALARM LOCATIONS

PER R314.3 - LOCATION SMOKE ALARMS SHALL BE INSTALLED IN THE FOLLOWING LOCATIONS: I. IN EACH SLEEPING ROOM.

2. OUTSIDE EACH SEPARATE SLEEPING AREA IN THE IMMEDIATE VICINITY OF THE BEDROOMS 3. ON EACH ADDITIONAL STORY OF THE DWELILING, INCLUDING BASEMENTS, BUT NOT INCLUDING CRAWL SPACES AND UNINHABITABLE ATTICS. IN DWELLINGS OR DWELLING UNITS WITH SPLIT LEVELS AND WITHOUT AN INTERVENING DOOR BETWEEN THE ADJACENT LEVELS, A SMOKE ALARM INSTALLED ON THE UPPER LEVEL SHALL SUFFICE FOR THE ADJACENT LOWER LEVEL PROVIDED THAT THE LOWER PROVIDED THAT THE LOWER LEVEL IS LESS THAN ONE FULL STORY BELOW THE UPPER LEVEL.

4. SMOKE ALARMS SHALL BE INSTALLED NOT LESS THAT 3 FT HORIZONTALLY FROM THE DOOR OR OPENING OF A BATHROOM THAT CONTAINS A BATHUB OR SHOWER

PER R314.4 - WHEN MORE THAN ONE SMOKE ALARM IS REQUIRED TO BE INSTALLED WITHIN AN INDIVIDUAL DMELLING UNIT THE ALARM DEVICES SHALL BE INTERCONNECTED IN SUCH A MANNER THAT THE ACTUATION OF ONE ALARM WILL ACTIVATE ALL OF THE ALARMS IN THE INDIVIDUAL UNIT.

PER F915.2.3.1.1.1 - REQUIRED LOCATIONS CARBON MONOXIDE ALARMS SHALL BE PROVIDED IN THE FOLLOWING LOCATIONS: 1. WITHIN EACH DWELLING UNIT ON EACH STORY CONTAINING A SLEEPING AREA, WITHIN 15 FEET OF THE SLEEPING AREA. MORE THAN ONE CARBON MONOXIDE ALARM SHALL BE PROVIDED WHERE NECESSARY TO ASSURE THAT NO SLEEPING AREA ON A STORY IS MORE THAN 15 FEET AWAY FROM A CARBON MONOXIDE ALARM. 2. ON ANY STORY OF A DWELLING UNIT THAT CONTAINS A CARBON MONOXIDE SOURCE.

TABLE R404.1.1(4) 12-INCH MASONRY FOUNDATION WALLS WITH REINFORCING WHERE d ≥ 8.75 INCHESa, c, f

	HEIGHT OF UNBALANCED BACKFILL®	MINIMUM VERTICAL REINFORCEMENT AND SPACING (INCHES) ^{b, c} Soil classes and lateral soil load ^d (psf per foot below grade)		
WALL HEIGHT				
		GW, GP, SW and SP soils 30	GM, GC, SM, SM-SC and ML soils 45	SC, ML-CL and inorganic CL soils 60
	4 feet (or less)	#4 at 72	#4 at 72	#4 at 72
	5 feet	#4 at 72	#4 at 72	#4 at 72
8 feet 8 inches	6 feet	#4 at 72	#4 at 72	#5 at 72
lilicites	7 feet	#4 at 72	#5 at 72	#6 at 72
	8 feet 8 inches	#5 at 72	#7 at 72	#6 at 48
	4 feet (or less)	#4 at 72	#4 at 72	#4 at 72
	5 feet	#4 at 72	#4 at 72	#4 at 72
9 feet 4	6 feet	#4 at 72	#5 at 72	#5 at 72
inches	7 feet	#4 at 72	#5 at 72	#6 at 72
	8 feet	#5 at 72	#6 at 72	#6 at 56
	9 feet 4 inches	#6 at 72	#6 at 48	#6 at 40
10 feet	4 feet (or less)	#4 at 72	#4 at 72	#4 at 72
	5 feet	#4 at 72	#4 at 72	#4 at 72
	6 feet	#4 at 72	#5 at 72	#5 at 72
	7 feet	#4 at 72	#6 at 72	#6 at 72
	8 feet	#5 at 72	#6 at 72	#6 at 48
	9 feet	#6 at 72	#6 at 56	#6 at 40
	10 feet	#6 at 64	#6 at 40	#6 at 32

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PROJECT: SUNROOM ADDITION M/M WALTER 55 MAHOGANY RUN PITTSFORD, NY

CLIENT: WOODSTONE CUSTOM HOMES

DRAWING: BASEMENT / FOUNDATION PLAN BUILDING SECTIONS / TYP NOTES

DRAWN: CHECKED: DATE: DECEMBER 2018


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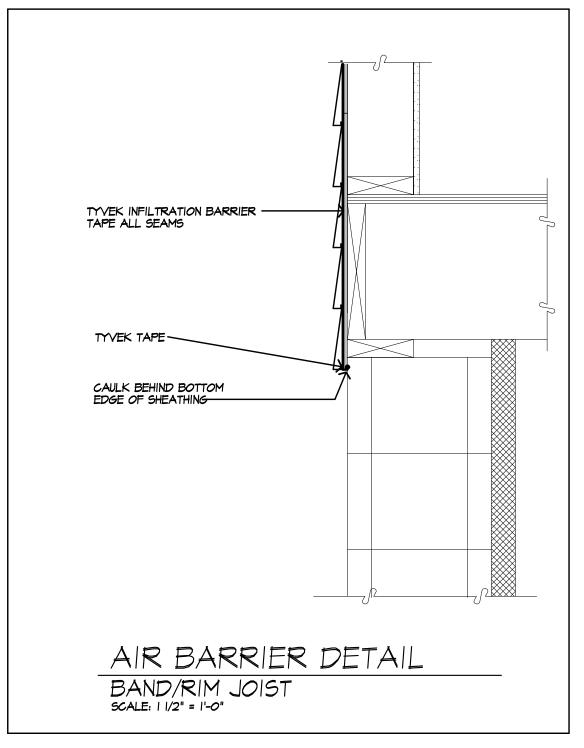
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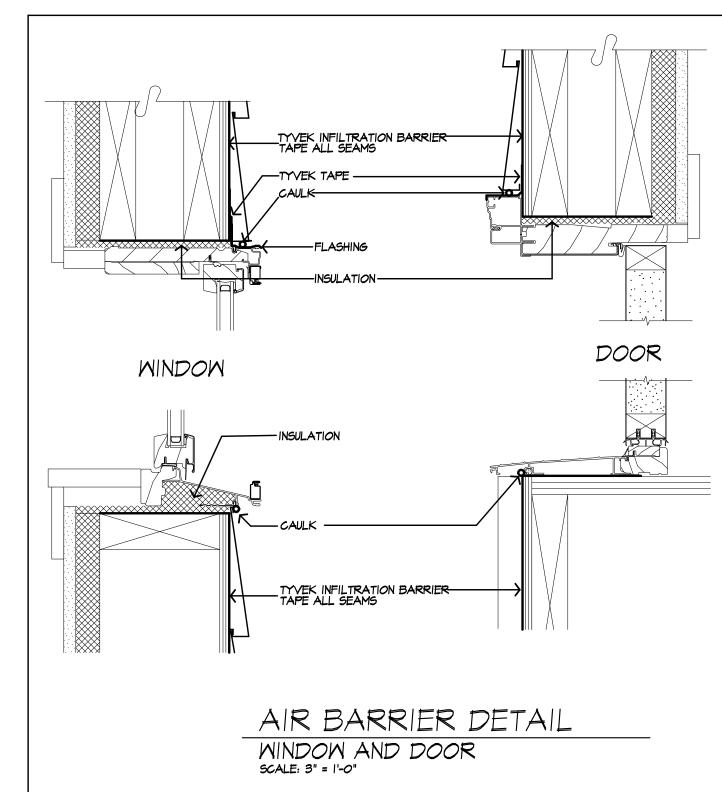
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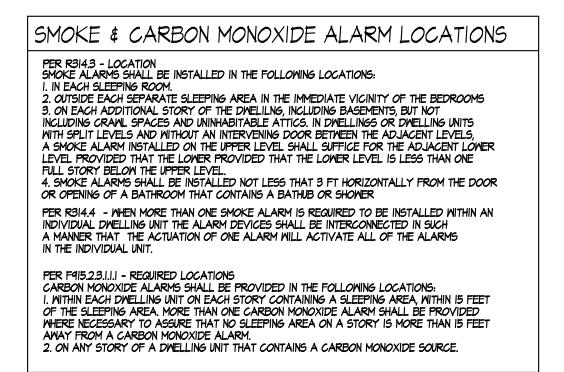
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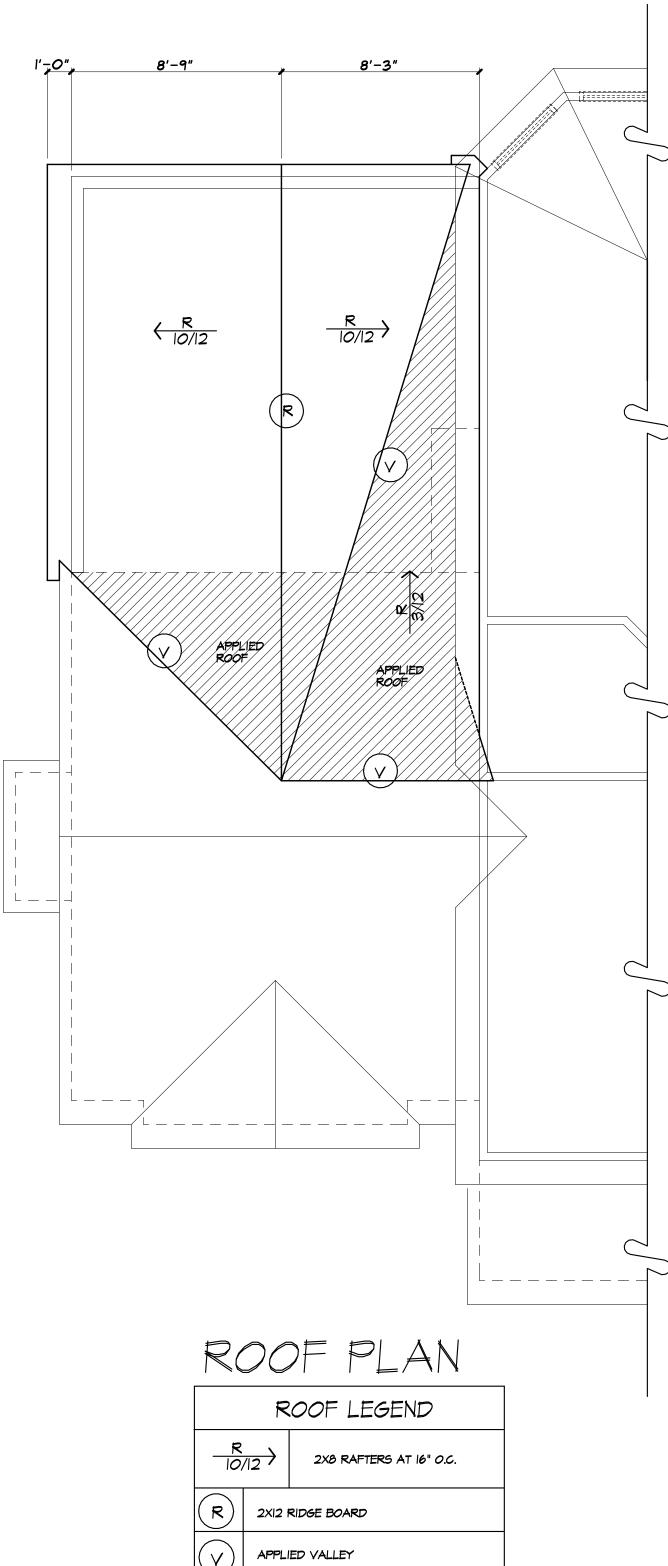












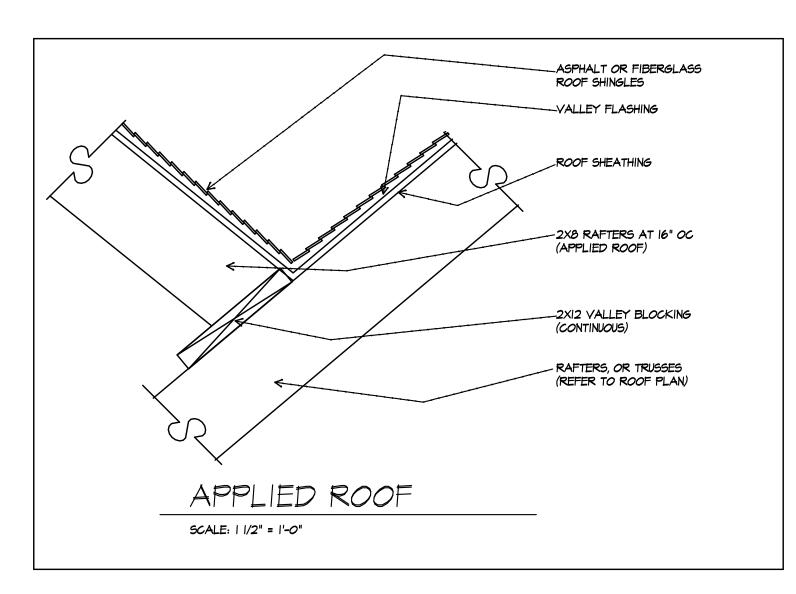

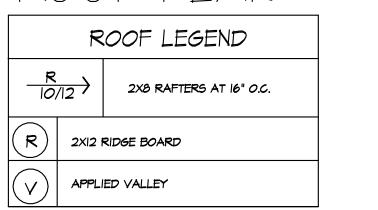

*NOTE: PROVIDE ICE PROTECTION UNDERLAYMENT ON PERIMETER OF ROOF TO 24" INSIDE INTERIOR WALLS PER R905.2.7.1 (RESIDENTIAL CODE OF NEW YORK STATE)

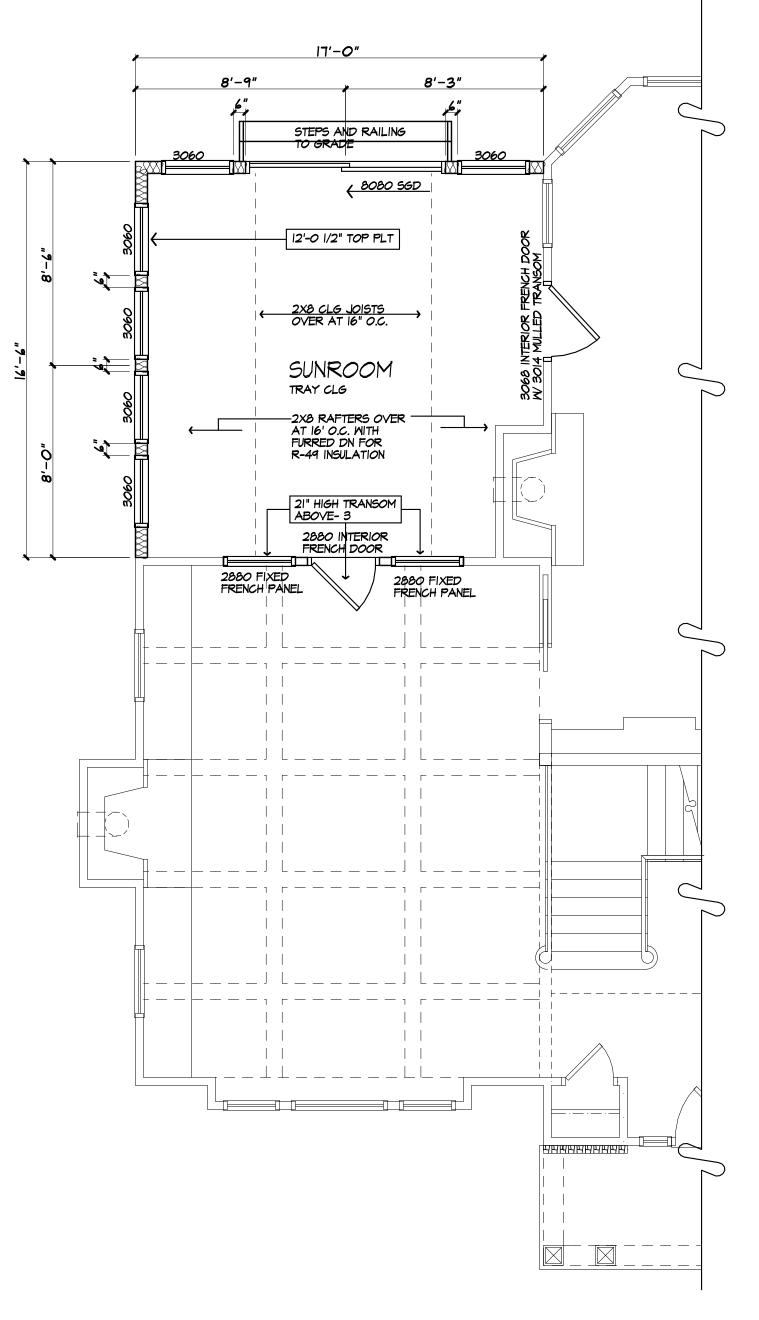

FIRST FLOOR PLAN

AREA: 270 SQ FT

	П	EADER SCI UNLESS OTHERWI	
OPENII	NG	2X6 WALL	2X4 WALL
UP TO	4'-0"	(3) 2X8	(2) 2×8
	8'-0"	(3) 2XI2	(2) 2XI2
	PROVIDE GLUE AND	NAIL ALL HEADERS	
		• • • • • • • • • • • • • • • • • • • •	
	GLUE AND	NAIL ALL HEADERS	
	GLUE AND 2X6 S W INS	NAIL ALL HEADERS WALL LE TUDS AT 16" OC	

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PROJECT: SUNROOM ADDITION M/M WALTER 55 MAHOGANY RUN PITTSFORD, NY

CLIENT: WOODSTONE CUSTOM HOMES

DRAWING: BASEMENT PLAN FIRST FLOOR PLAN ROOF PLAN

> CHECKED: **DRAWN:**

DATE: DECEMBER 2018

SCALE: 1/4"=1'-0" JOB NO.: 18M3791

SHEET:




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Town of Pittsford

Department of Public Works 11 South Main Street Pittsford, New York 14534

Permit # B19-000001

Phone: 585-248-6250 FAX: 585-248-6262

DESIGN REVIEW AND HISTORIC PRESERVATION BOARD REFERRAL OF APPLICATION

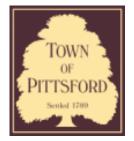Property Address: 4 Saddle Brook PITTSFORD, NY 14534

Tax ID Number: 164.03-1-42

Zoning District: RN Residential Neighborhood

Owner: Kumar, Prem Applicant: Kumar, Prem

Application Type:

- Residential Design Review
 - §185-205 (B)
- Commercial Design Review
 - §185-205 (B)
- Signage
 - §185-205 (C)
- Certificate of Appropriateness
- §185-197
- Landmark Designation
 - §185-195 (2)
- Informal Review

- Build to Line Adjustment
 - §185-17 (B) (2)
- Building Height Above 30 Feet
 - §185-17 (M)
- Corner Lot Orientation
 - §185-17 (K) (3)
- Flag Lot Building Line Location
 - §185-17 (L) (1) (c)
- Undeveloped Flag Lot Requirements
 - §185-17 (L) (2)

Project Description: Applicant is requesting design review for the addition of a sun room and 2nd floor addition. The sun room will be approximately 169 Sq. Ft. located to the rear of the property. The second floor addition will be approximately 588 Sq. Ft. and will be located above the garage. New siding and trim will be installed.

Meeting Date: January 10, 2019






RN Residential Neighborhood Zoning



Printed January 3, 2019

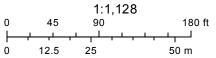

Town of Pittsford GIS




GENERAL NOTES:

- THESE PLANS HAVE BEEN PREPARED TO THE BEST OF THE ARCHITECT'S KNOWLEDGE, BELIEF, AND PROFESSIONAL JUDGMENT IN ACCORDANCE WITH THE INTERNATIONAL RESIDENTIAL CODE (2015 IRC) AND ENERGY CONSERVATION CODE REQUIREMENTS. THE CONTRACTOR SHALL BE RESPONSIBLE FOR ADAPTING THESE PLANS, IF REQUIRED, TO SUIT THE NEEDS OF THE BUILDING ON THE SITE. PROVIDED THAT THE ALTERATIONS DO NOT VIOLATE THE CODE OR ALTER THE STRUCTURAL INTEGRITY OF THE BUILDING.
- THE CONTRACTOR SHALL BE RESPONSIBLE FOR COMPLIANCE WITH ALL APPLICABLE BUILDING/ELECTRICAL/MECHANICAL/SANITARY AND ENERGY CODES; STATE OR LOCAL. THE CONTRACTOR SHALL BE RESPONSIBLE FOR COMPLIANCE WITH THE ENERGY CONSERVATION CODE FOR ALL HVAC EQUIPMENT, HVAC CONTROLS, WATER HEATING EQUIPMENT, PIPE AND DUCT INSULATION, AND FLUORESCENT LAMPS AND BALLASTS.
- THE CONTRACTOR SHALL BE RESPONSIBLE SO THAT BRANDS OF WINDOWS AND DOORS INSTALLED MEET THE NEW YORK STATE ENERGY CONSERVATION CODE REQUIREMENTS. WINDOWS AND / OR DOORS SHOWN ARE INDICATED FOR SIZING ONLY.
- ALL FOOTINGS SHALL REST ON UNDISTURBED VIRGIN SOIL. THE FOOTING/FOUNDATION DESIGN ASSUMES MINIMUM SOIL BEARING PRESSURE TO BE 2000 PSF. CONTRACTOR SHALL BE RESPONSIBLE FOR ALL SUBGRADE CONDITIONS. IF REQUIRED, THE OWNER AND / OR CONTRACTOR SHALL BE RESPONSIBLE FOR HIRING A SOILS ENGINEER TO VERIFY SUBGRADE CONDITIONS AND SUBSTANTIATE ACTUAL BEARING CAPACITY.
- BACKFILL MATERIALS SHALL BE NATIVE SOIL.
- FOR FILL UNDER THE GARAGE FLOOR OR BASEMENT FLOOR, PROVIDE SAND/ GRAVEL FILL FOR COMPACTION AS NEEDED
- MINIMUM CONCRETE COMPRESSIVE STRENGTH: 2500 PSI FOOTINGS
- 2500 PSI FLOOR SLABS 3500 PSI PORCH
- 3500 PSI GARAGE
- CONCRETE BLOCK SHALL CONFORM TO ASTM C90 N-1, WALL REINFORCING ASTM A82. ALL MORTAR SHALL CONFORM TO ASTM C270, TYPE S - I PART PORTLAND CEMENT, I/4 PART
- STRUCTURAL STEEL SHALL CONFORM TO ASTM A36. SHOP-PRIME PAINT TT-P-20, TT-P-3IC, TT-P-86. FABRICATION AND INSTALLATION PER THE LATEST EDITION OF THE AISC
- MINIMUM FIBER STRESS IN BENDING (FB) FOR ALL FRAMING LUMBER TO BE 1150 PSI #2 HEM-FIR OR BETTER. PROVIDE DOUBLE FRAMING MEMBERS UNDER PARTITIONS RUNNING IN
- CONTRACTOR SHALL PAY STRICT ADHERENCE TO MICROLAM MANUFACTURER'S WRITTEN DIRECTIONS FOR CUTTING, DRILLING, NOTCHING, JOINING AND GENERAL INSTALLATION OF
- WOOD TRUSSES SHALL BE DESIGNED BY MANUFACTURER. SUPPLIER SHALL BE RESPONSIBLE FOR INSTALLATION DETAILS
- PLYWOOD SHALL CONFORM TO U.S. PRODUCT STANDARD PS I, THICKNESS AS SHOWN, APA RATED SHEATHING EXP-I. NAILING AND SPACING PER APA RECOMMENDATIONS FOR
- ALL WOOD IN CONTACT WITH CONCRETE OR MASONRY SHALL BE FULLY WOOD PRESERVATIVE-TREATED WITH OSMOSALTS OR WOLMAN SALTS.
- ALL OPENINGS IN THE BUILDING ENVELOPE (DOORS, WINDOWS, UTILITIES) SHALL BE CAULKED, WEATHER-STRIPPED, OR OTHERWISE SEALED. CORROSION RESISTIVE FLASHING SHALL BE PROVIDED AT THE LOCATIONS ON THE EXTERIOR WALL ENVELOPE PER R 703.8 OF THE RESIDENTIAL CODE OF NEW YORK (2015)
- CONTRACTOR SHALL VERIFY ALL NOTES AND DIMENSIONS PRIOR TO CONSTRUCTION. THESE DRAWINGS ARE NOT TO BE SCALED - USE DIMENSIONS GIVEN,
- CONTRACTOR SHALL BE RESPONSIBLE FOR ALL CONSTRUCTION MEANS, METHODS, TECHNIQUES, SEQUENCES AND SAFETY PRECAUTIONS IN CONNECTION WITH THE WORK
- THESE DRAWINGS HAVE BEEN PREPARED FOR STRUCTURAL INTENT ONLY. ELECTRICAL, MECHANICAL AND OTHER BUILDING SYSTEMS, AS REQUIRED ARE TO BE DESIGNED BY OTHERS.
- THE FOLLOWING DESIGN LOADS HAVE BEEN USED IN THE STRUCTURES DESIGN IN ACCORDANCE WITH THE PRINTED SPAN TABLES IN THE RESIDENTIAL CODE OF NEW YORK STATE (2015).
 - 40 PSF 30 PSF FLOOR LOADS (LIVING AREAS-IST FLOOR) SLEEPING AREAS (2ND FLOOR)
- ALL WORK, MATERIALS, METHODS, EQUIPMENT, ETC. SHALL BE IN STRICT ACCORDANCE WITH THE CONTRACT DOCUMENTS. ALL MATERIALS SHALL BE NEW, UNLESS NOTED OTHERWISE.
- MORK SEQUENCE AND SCHEDULE SHALL BE MUTUALLY AGREED UPON BY BOTH THE OWNER AND THE
- IT IS ASSUMED THAT THE SUBSURFACE CONDITIONS WILL BE EARTH OR SOIL. IF BEDROCK IS ENCOUNTERED, REMOVAL WILL BE CONSIDERED AN ADDITION TO CONTRACT.
- ANY DEMOLITION WORK SHALL BE DONE CAREFULLY. ALL DISTURBED SURFACES TO BE REPAIRED APPROPRIATELY. ALL SALVAGEABLE ITEMS SHALL BE TURNED OVER TO THE OWNER.
- EXAMINATION OF THE SITE SHOULD BE MADE BY ALL CONTRACTORS CONCERNED TO FULLY CONSIDER ALL SITE CONDITIONS WHICH MAY HAVE A BEARING ON THE WORK OF THE ENTIRE PROJECT. SUBMISSION OF A BID IS PRESUMPTIVE EVIDENCE THAT THE BIDDER IS CONVERSANT WITH LOCAL JURISDICTIONS AND HAS MADE DUE ALLOWANCES IN HIS BID FOR ALL CONTINGENCIES. THE OWNER RESERVES THE RIGHT TO REJECT ANY OR ALL BIDS.
- IT IS THE RESPONSIBILITY OF THE CONTRACTOR TO NOTIFY THE ARCHITECT IN CASE OF ANY OR ALL DEVIATIONS FROM THESE DRAWINGS. THE ARCHITECT SHALL BE HELD HARMLESS AS A RESULT OF ANY UNAUTHORIZED CHANGES TO THESE PLANS. ADDITIONAL FEES MAY OCCUR FOR "AS BUILT" DOCUMENTATION DUE TO CIRCUMSTANCES BEYOND THE ARCHITECT'S CONTROL, OR OWNER / CONTRACTOR CHANGES TO THESE DRAWINGS
- THE CONTRACTOR SHALL OBTAIN AND PAY FOR ALL PERMITS AND APPROVALS REQUIRED BY THE LOCAL ZONING AND BUILDING DEPARTMENTS AND ANY OTHER GOVERNMENTAL AGENCY HAVING JURISDICTION OVER THE WORK. ALL APPLICABLE REGULATIONS SHALL BE ADHERED TO AND CARRIED OUT BY ALL INDIVIDUALS
- THE CONTRACTOR SHALL FURNISH A CERTIFICATE OF INSURANCE INDICATING THE TYPE AND AMOUNTS OF COVERAGE AS REQUIRED BY NEW YORK STATE AND THE LOCAL MUNICIPALITY.
- THE CONTRACTOR SHALL REMOVE ALL RUBBISH AND LEAVE THE COMPLETED PROJECT IN A CLEAN STATE,
- THE CONTRACTOR SHALL GUARANTEE HIS WORK AND HIS SUBCONTRACTOR'S WORK AGAINST FAULTY
- MATERIALS AND MORKMANSHIP IN ACCORDANCE WITH NEW YORK STATE GENERAL BUSINESS LAW. ONLY COPIES FROM THE ORIGINALS OF THESE DRAWINGS MARKED WITH AN ORIGINAL OF THE ARCHITECT'S
- EMBOSSED SEAL SHALL BE CONSIDERED TO BE VALID TRUE COPIES. BUILDING IS CLASSIFIED AS A ONE FAMILY DWELLING

SATISFACTORY TO THE OWNER.

- SMOKE-DETECTING ALARM DEVICES SHALL BE INSTALLED IN COMPLIANCE WITH SECTION RSIS.I OF THE RESIDENTIAL CODE OF NEW YORK STATE (2015) CARBON MONOXIDE ALARM DEVICES SHALL BE INSTALLED IN COMPLIANCE WITH SECTION R3I3.4 OF THE RESIDENTIAL CODE OF NEW YORK STATE (2015)
- PROVIDE A MIN. 3/4 HR. FIRE SEPARATION PER SECTION R309.2 OF THE RESIDENTIAL CODE OF NEW YORK STATE (2015) ALL WALLS AND FLOORS DEMISING RESIDENCE FROM AN ATTACHED GARAGE
- ALL MATERIALS USED IN THIS PROJECT SHALL BE NON-ASBESTOS AND NON-LEAD CONTAINING

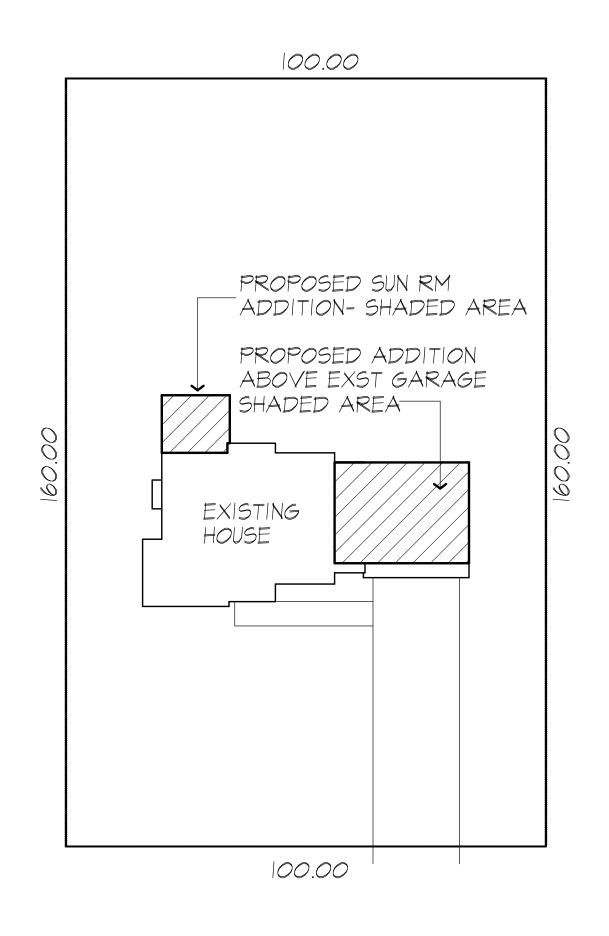

PLOT PLAN

SCALE: |"= 20.0

* NOTE: ALL LAND ENGINEERING TO BE PROVIDED BY OTHERS

RENOVATION AND ADDITION TO

M/M KUMAR RESIDENCE

4 SADDLE BROOK DRIVE PITTSFORD, NY

DRAWING INDEX

TITLE PAGE

ELEVATIONS EXISTING

FLOOR PLANS EXISTING

ELEVATIONS PROPOSED

FLOOR PLANS PROPOSED

ENERGY COMPLIANCE DETAILS & PATH

MEETS OR EXCEEDS PRESCRIPTIVE REQUIREMENTS PER INTERNATIONAL RESIDENTIAL CODE (2015 IRC) CLIMATE ZONE - 5

(2015 11.0) 5211 1/112 2012 3				
	COMPONENT	REQUIRED	PROVIDED	
1.	FENESTRATION U-FACTOR	.32	.32	
2.	CEILING R-FACTOR	49	49	
3.	IST & 2ND FLOOR WOOD FRAMED WALL R-VALUE	20 OR 13+5	HIGH DENSITY 21 21/BAND JSTS	
4.	BASEMENT CONCRETE WALL R-VALUE	15 CONTINUOUS OR 19 CAVITY FULL HEIGHT	R-15 CONTINUOUS FULL HEIGHT	
5.	FLOOR R-VALUE	30	30	

2015 INTERNATIONAL ENERGY CONSERVATION CODE (IECC) COMPLIANCE PATH

- I. A MINIMUM OF 75% OF THE LAMPS IN PERMANENTLY INSTALLED LIGHTING FIXTURES SHALL BE HIGH-EFFICIENCY LAMPS PER SECTION 1104.1
- 2. RECESSED LUMINARIES INSTALLED IN THE BUILDING THERMAL ENVELOPE SHALL BE SEALED WITH A GASKET OR CAULK BETWEEN THE HOUSING AND THE INTERIOR WALL OR CEILING COVERING TO LIMIT AIR LEAKAGE BETWEEN CONDITIONED AND UNCONDITIONED SPACES. PER SECTION 1102.4.5
- 3. CONTRACTOR TO PROVIDE A PROGRAMMABLE THERMOSTAT TO CONTROL THE HVAC SYSTEM PER SECTION 1103.1.1
- 4. ALL CIRCULATING SERVICE HOT WATER PIPING SHALL BE INSULATED TO AT LEAST R-2. CIRCULATION HOT WATER SYSTEMS SHALL INCULDE AN AUTOMATIC OR READILY ACCESSIBLE MANUAL SWITCH THAT CAN TURN OFF THE HOT WATER CIRCULATING PUMP WHEN THE SYSTEM IS NOT IN USE. PER SECTION 1103.3.4
- 5. AIR LEAKAGE TEST TO BE CONDUCTED & PERFORMED BY A THIRD PARTY IN COMPLIANCE WITH 1102.4.1.2. AIR LEAKAGE RATE MAY NOT EXCEED 3 ACH (CLIMATE ZONE 5)
- 6. ATTIC ACCESS SHALL BE INSULATED WITH THE SAME R-VALUE AS THE ATTIC, WEATHER STRIPPED AND LATCHED PER SECTION 1102.2.3
- 7. DUCTWORK ON EXTERIOR WALLS IF REQUIRED SHALL BE INSULATED TO A MINUMUM OF R-6 PER 1103.2.1
- 8. MECHANICAL VENTILATION PER SECTION NIIO3.6 TO BE MET WITH CONTINUOUS USE EXHAUST FANS AND MAKE-UP AIR CONTROLS, PER SECTION MISOT.3.3 REQUIREMENT.
- 9. MECHANICAL VENTILATION FAN EFFICACY SHALL MEET MINIMUM REQUIREMENTS PER SECTION NIIO3.6.1.
- ACCORDANCE WITH SECTION NIIO3.7 REQUIREMENTS.

BASIC DESIGN CRITERIA

- GROUND SNOW LOAD 40 PSF R301.2 (5)
- 2. WIND SPEED 115 MPH, EXPOSURE B R301.2.1
- 3. SEISMIC DESIGN CATEGORY A R301.2 (2)
- 4. WEATHERING SEVERE
- 5. FROST LINE DEPTH 48"
- 6. TERMITE DAMAGE NONE TO SLIGHT
- 7. DECAY DAMAGE NONE TO SLIGHT
- 8. WINTER DESIGN TEMPERATURE I
- 9. ICE SHIELD UNDERLAYMENT REQUIRED YES
- 10. FLOOD HAZARD FIRM 1992
- II. ROOF TIE DOWN REQUIREMENTS R802.II.I



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PATRICK J. MORABITO, A.I.A. ARCHITECT P.

RENOVATION/ADDITION TO

SADDLE BROOK DRIVE PITTSFORD, N

CLIENT: 1/M KUMAR

DRAWING:

TITLE PAGE

CHECKED: PAUL MORABITO

DATE: JANUARY 2019 **SCALE:** 1/4"=1'-0"

JOB NO.: 18M1214


SHEET:

SHEETS





FRONT ELEVATION

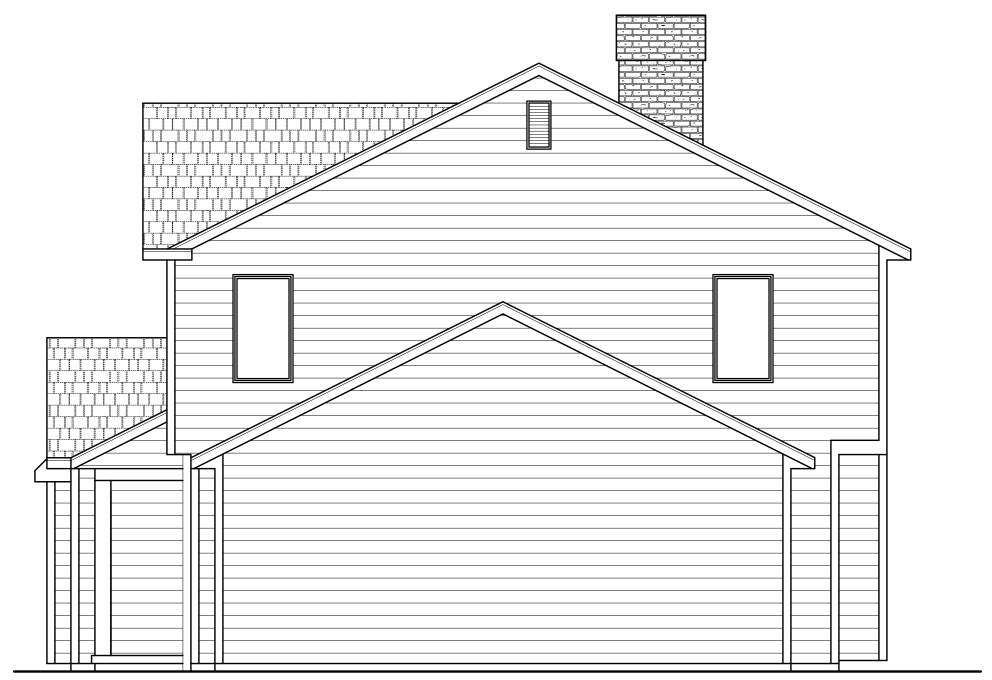

RIGHT SIDE ELEVATION





REAR ELEVATION



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RENOVATION/ADDITION TO KUMAR RESIDENCE 4 SADDLE BROOK DRIVE PITTSFORD, N

CLIENT:

DRAWING:

FRONT / LEFT SIDE ELEVATIONS

CHECKED:

PAUL MORABITO


DATE: JANUARY 2019

SCALE: 1/4"=1'-0"

of 5 sheets





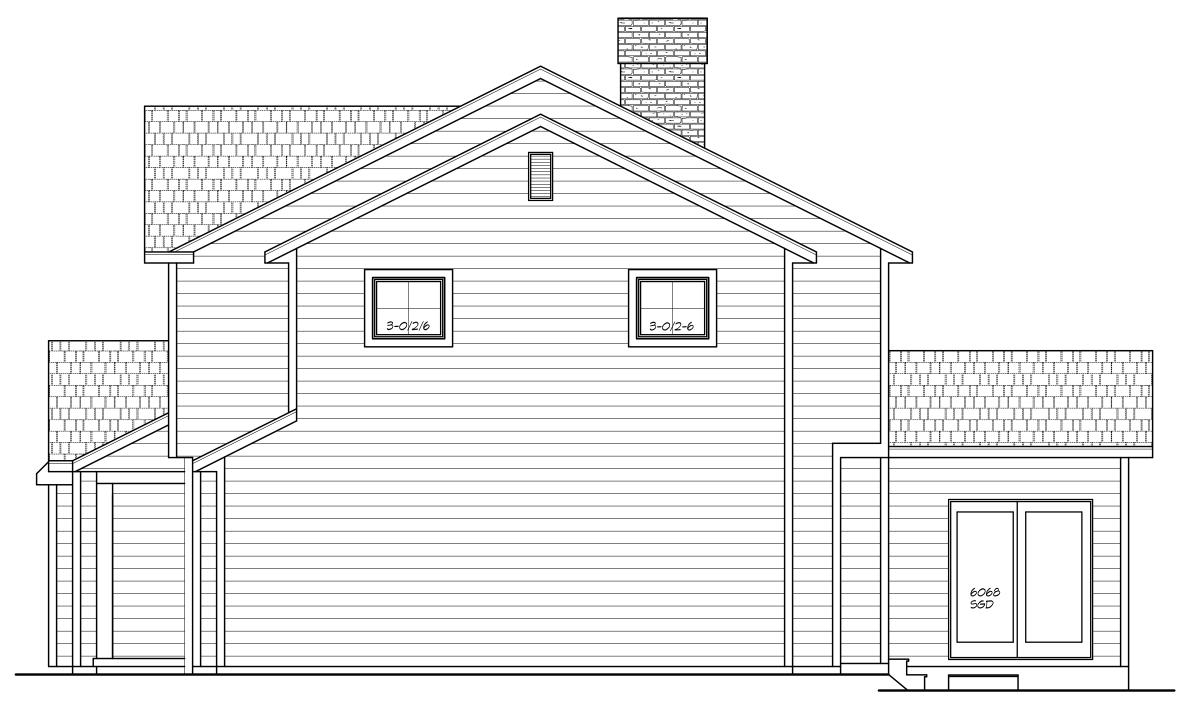

FRONT ELEVATION
PROPOSED

RIGHT SIDE ELEVATION







REAR ELEVATION PROPOSED

MORABITO ARCHITECTS

121 Sully's Trail Pittsford, NY 14534

(585) 264-1330 (585) 264-1333 Fax

www.morabitoarchitects.com

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PROJECT:

RENOVATION/ADDITION TO KUMAR RESIDENCE 4 SADDLE BROOK DRIVE PITTSFORD, N

CLIENT:

DRAWING:

ELEVATIONS PROPOSED

DRAWN: CHECKED:

PAUL MORABITO

V

DATE: JANUARY 2019

SCALE: |/4"=|'-0"


JOB NO.: |&M|2|4


SHEET:

4

of 5 sheets



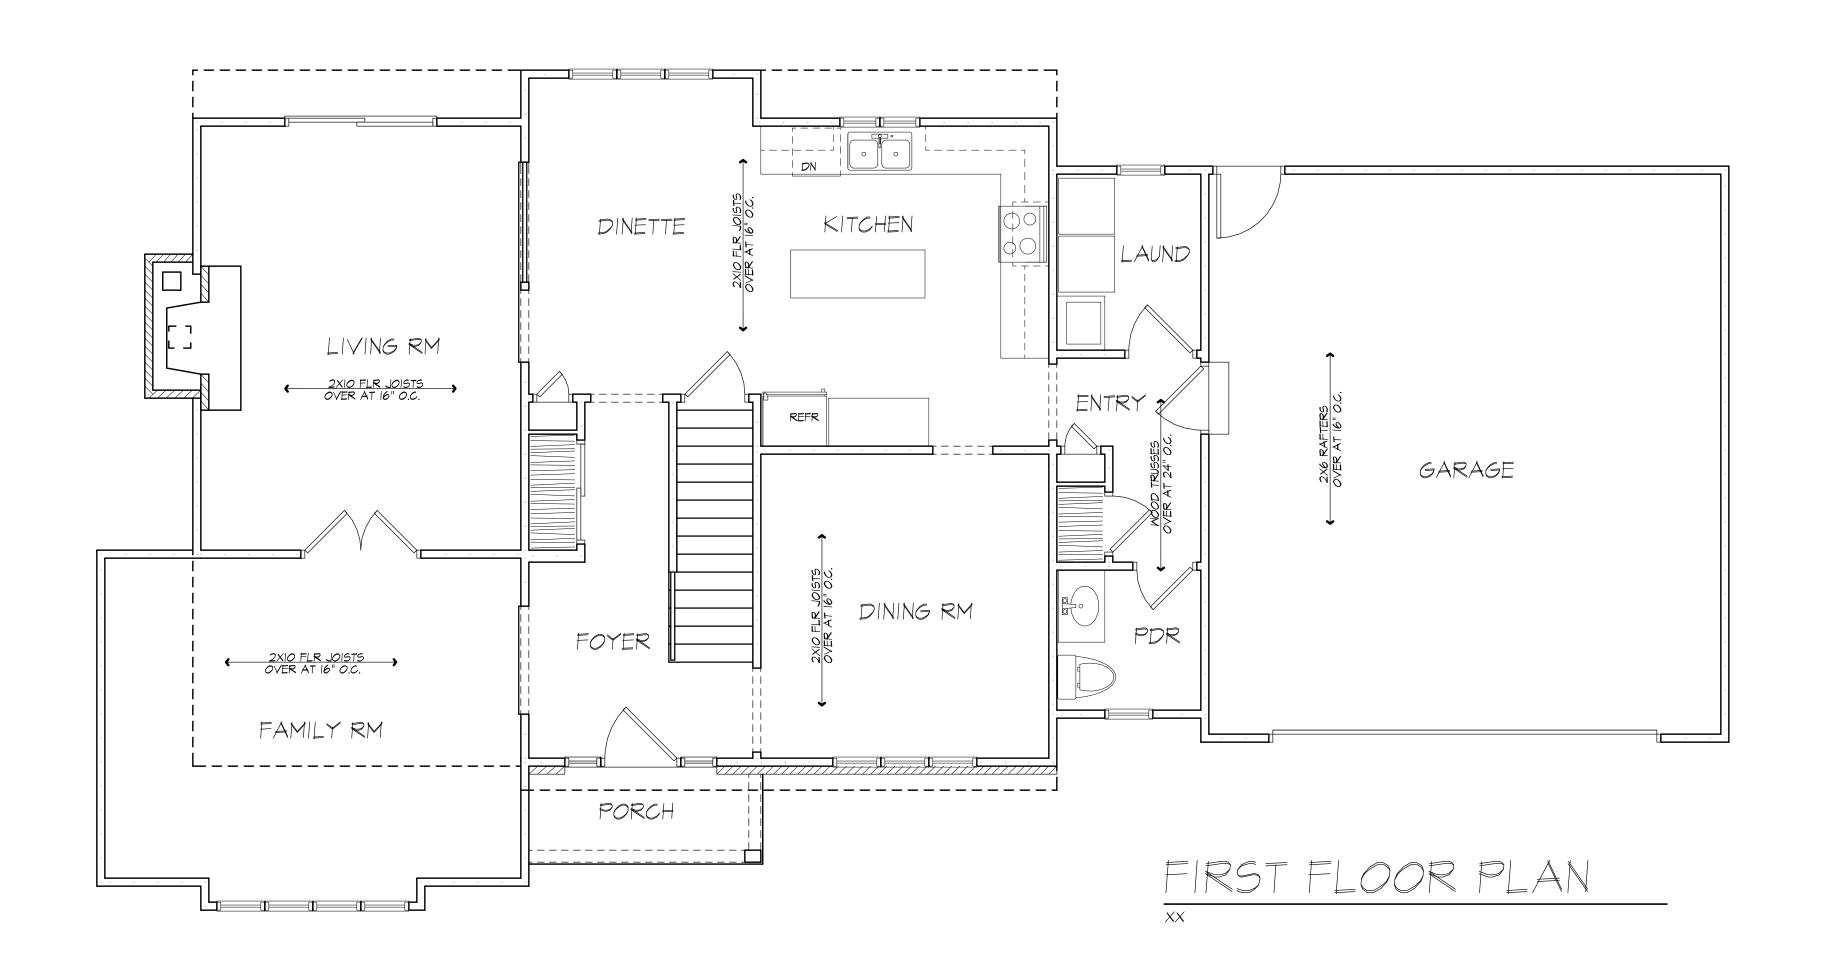

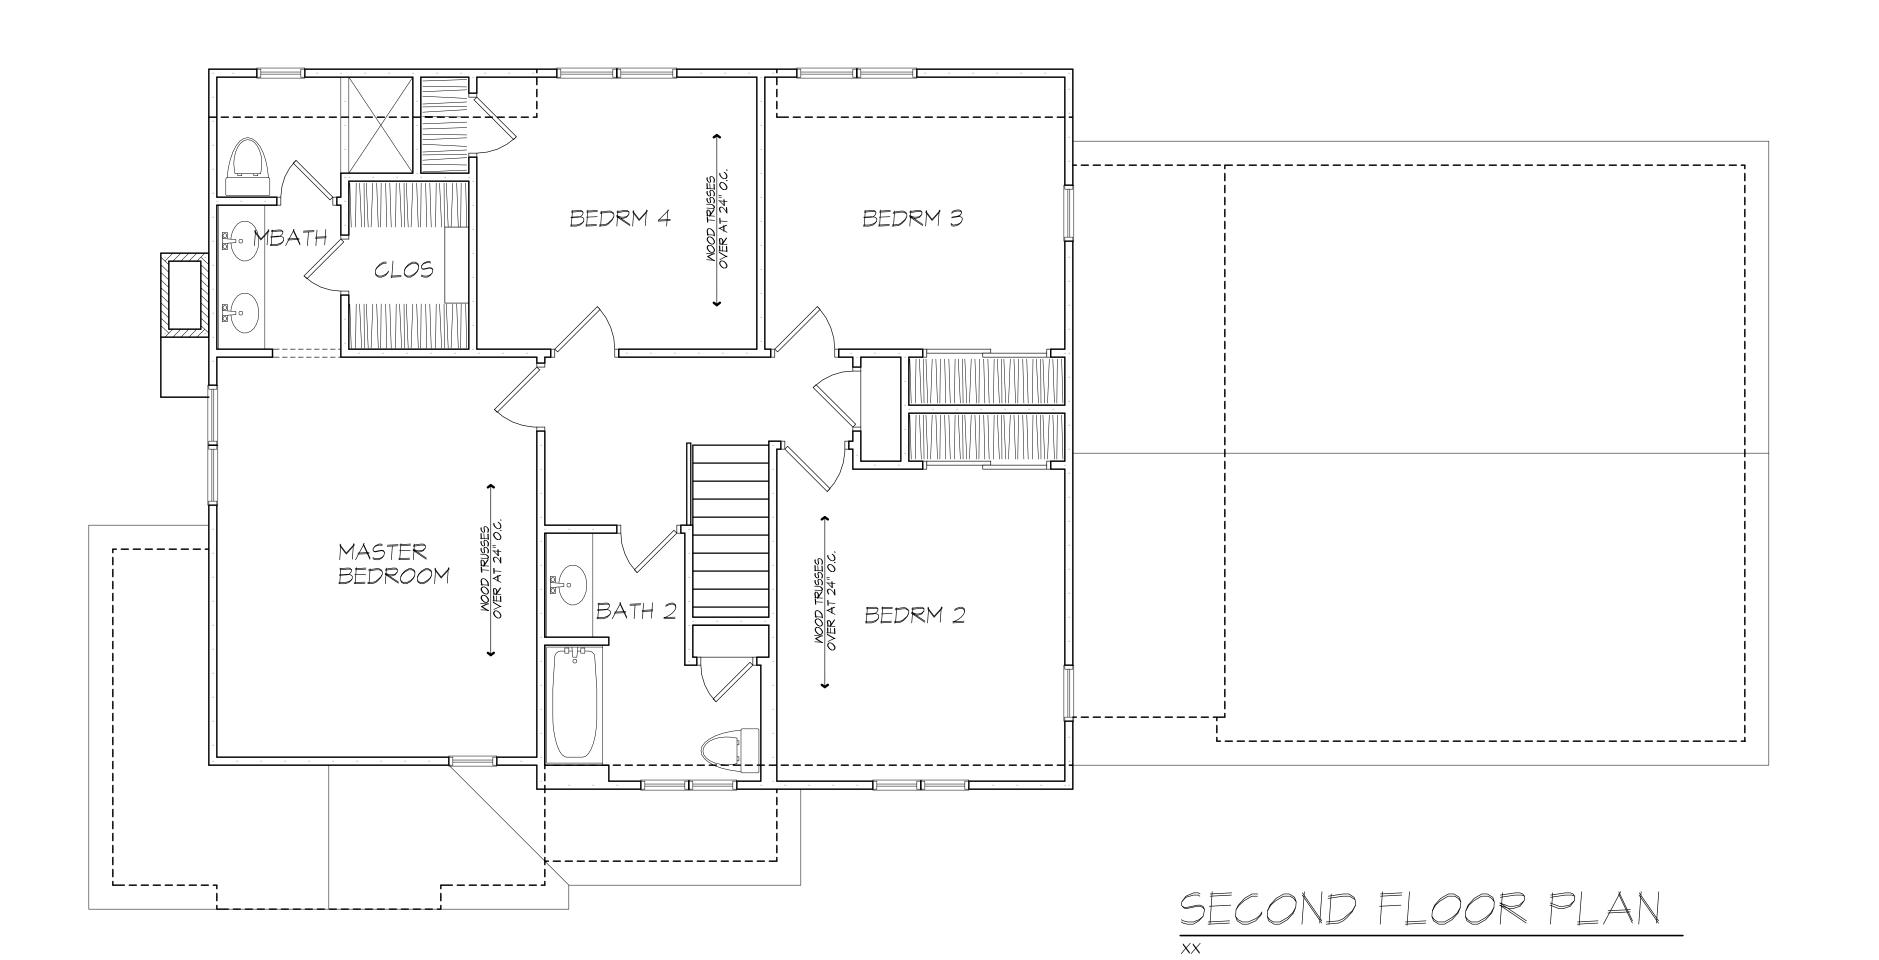



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121 Sully's Trail Pittsford, NY 14534

(585) 264-1330 (585) 264-1333 Fax

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RENOVATION/ADDITION TO KUMAR RESIDENCE 4 SADDLE BROOK DRIVE PITTSFORD, N

CLIENT:

M/M KUMAR

DRAWING:

FIRST FLOOR PLAN SECOND FLOOR PLAN


CHECKED: PAUL MORABITO

DATE: JANUARY 2019

SCALE: 1/4"=1'-0"

JOB NO.: 18M1214



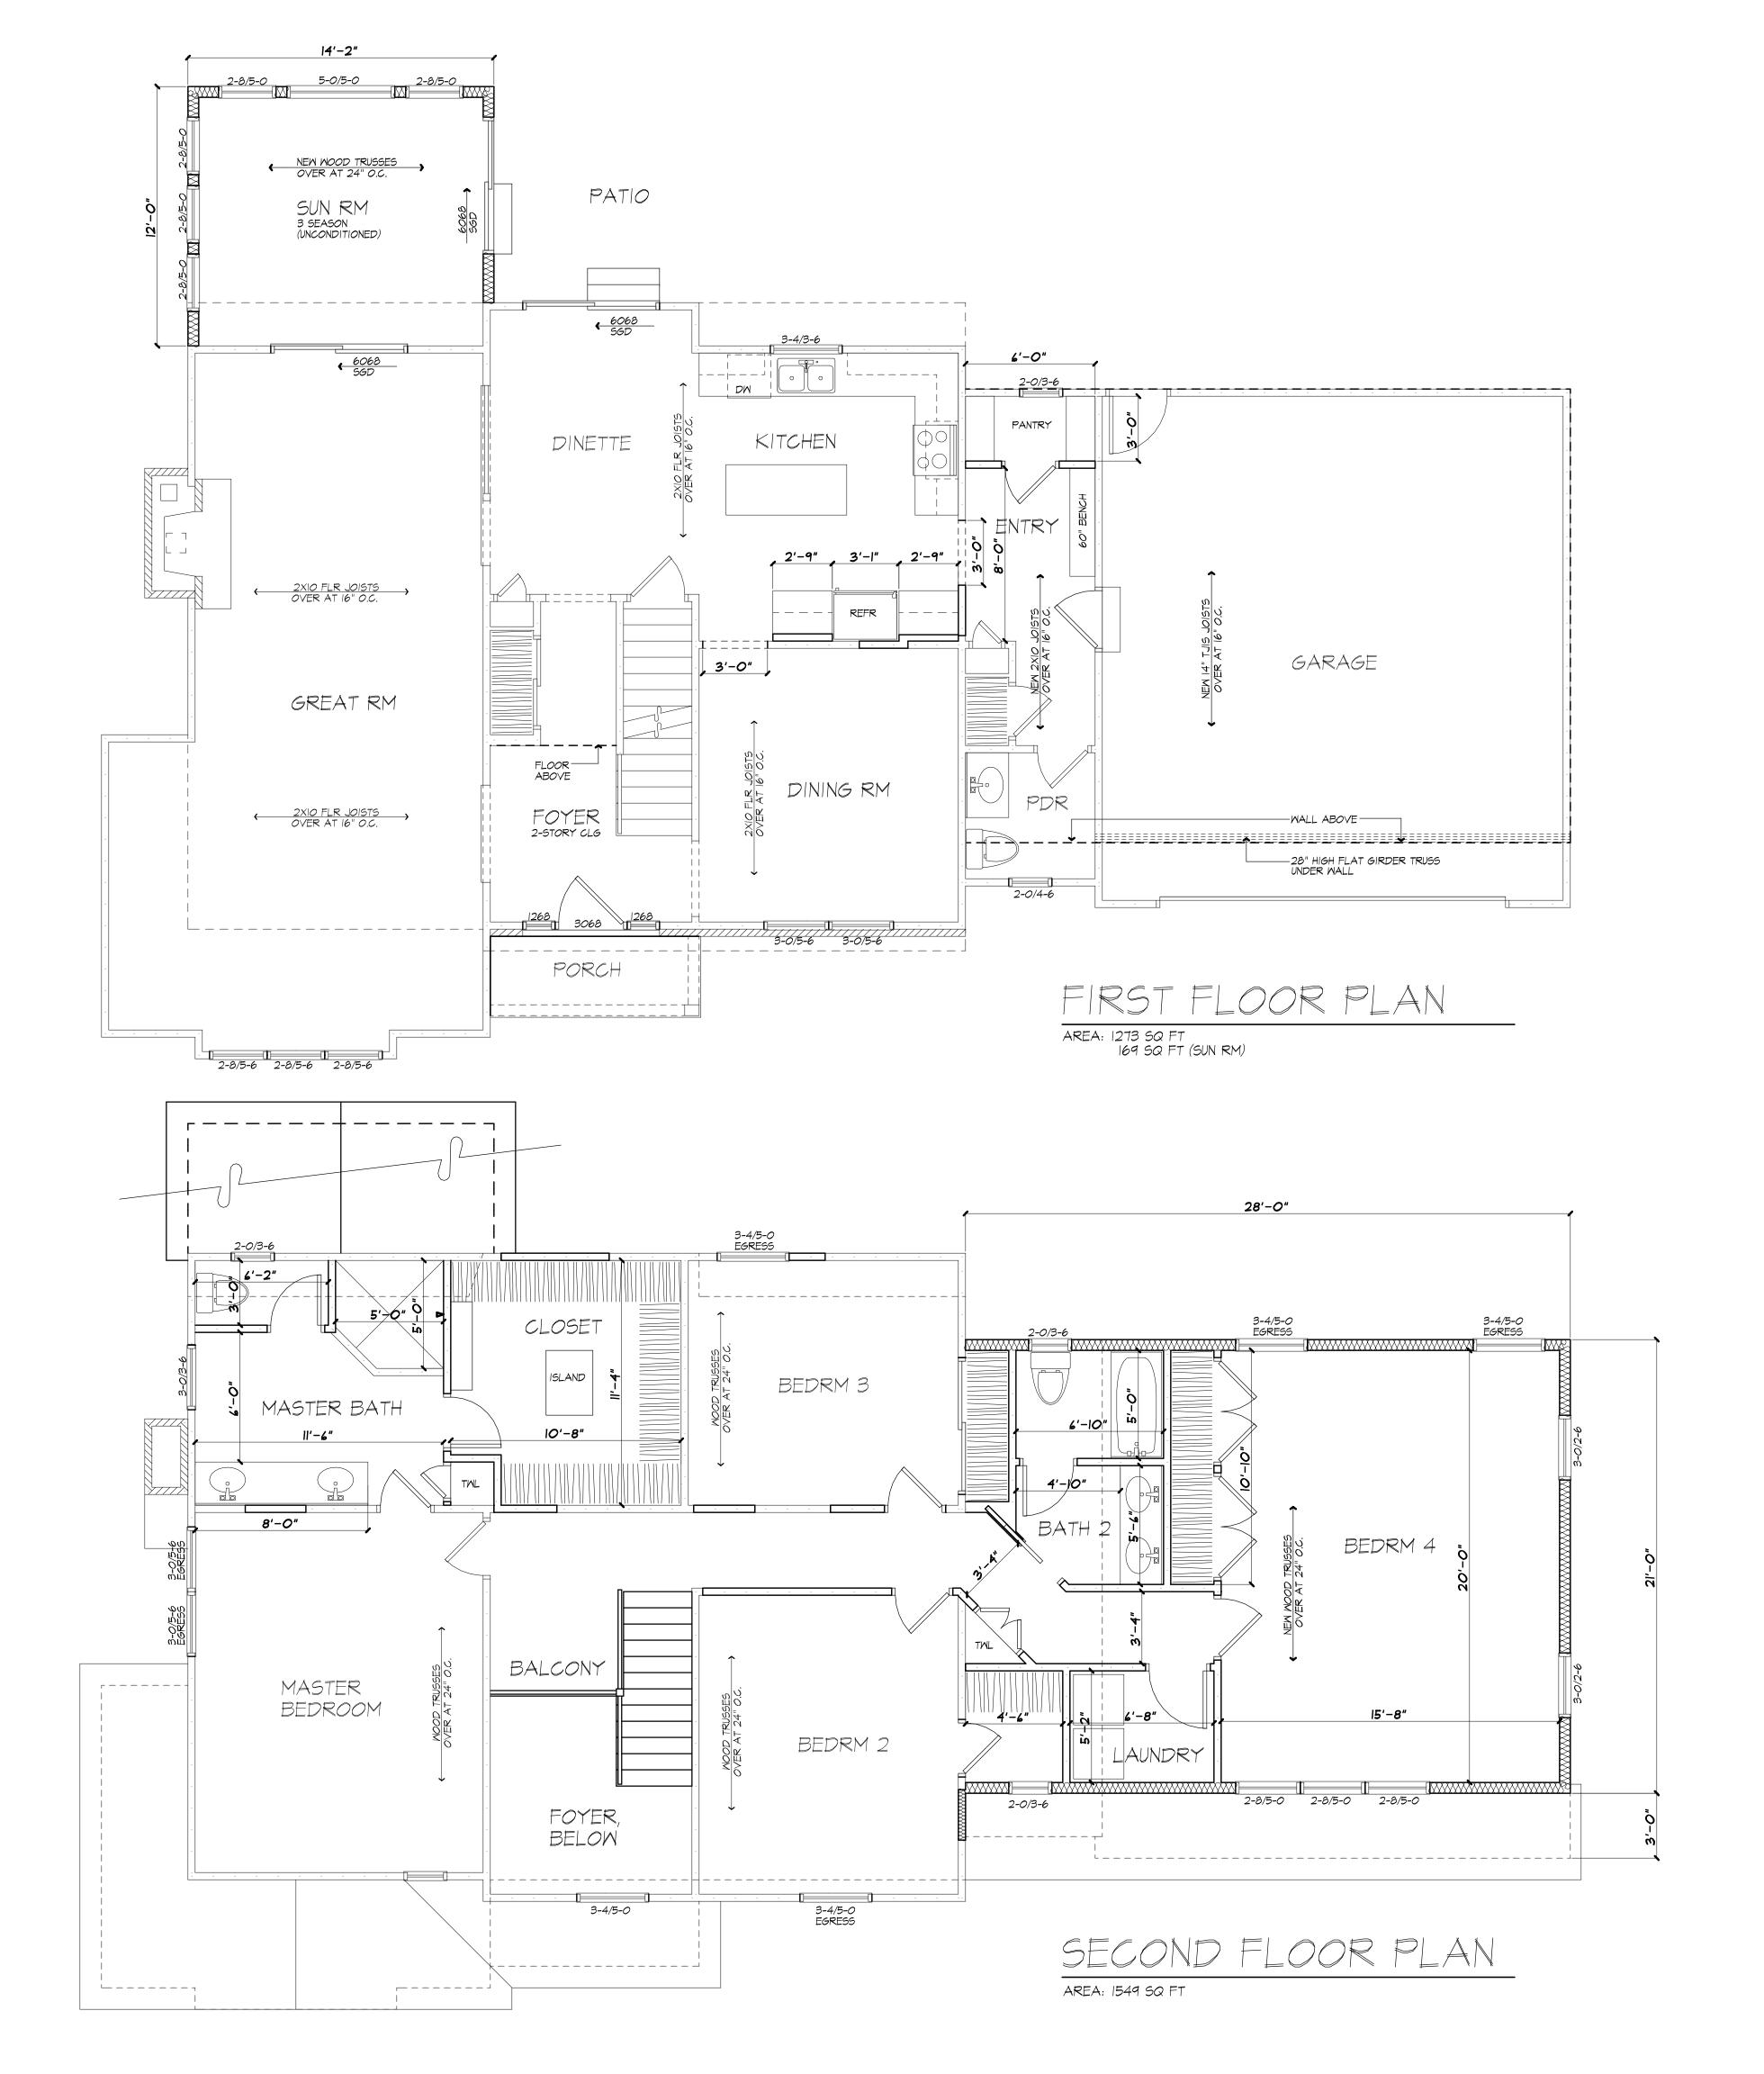



MORABITO

121 Sully's Trail Pittsford, NY 14534

(585) 264-1330 (585) 264-1333 Fax

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PROJECT:
RENOVATION/ADDITION TO
KUMAR RESIDENCE
4 SADDLE BROOK DRIVE PITTSFORD, NY

CLIENT:

M/M KUMAR

DRAWING:

2ND FLOOR PLAN

PAUL MORABITO

DRAWN:

CHECKED:

DATE: JANUARY 2019

SCALE: 1/4"=1'-0"

JOB NO.: 18M1214

SHEET:

of 5 sheets














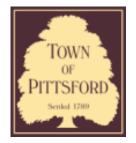

Town of Pittsford

Department of Public Works 11 South Main Street Pittsford, New York 14534

Permit # B19-00002

Phone: 585-248-6250 FAX: 585-248-6262

DESIGN REVIEW AND HISTORIC PRESERVATION BOARD REFERRAL OF APPLICATION

Property Address: 100&300 Hahnemann Trail PITTSFORD, NY 14534

Tax ID Number: 164.12-1-3.31

Zoning District: PUD Planned Unit Development

Owner: Highland Community Devlp Corp Applicant: Highland Community Devlp Corp

Application Type:


- Residential Design Review §185-205 (B)
- Commercial Design Review
- §185-205 (B)
- Signage
 - §185-205 (C)
- Certificate of Appropriateness
- §185-197
- Landmark Designation
 - §185-195 (2)
- Informal Review

- Build to Line Adjustment
 - §185-17 (B) (2)
- Building Height Above 30 Feet
 - §185-17 (M)
- Corner Lot Orientation
 - §185-17 (K) (3)
- Flag Lot Building Line Location
 - §185-17 (L) (1) (c)
- Undeveloped Flag Lot Requirements
 - §185-17 (L) (2)

Project Description: Applicant is requesting design review for three small projects on their existing campus at 5~100 Hahnemann Trail. The first item is a 150 Sq. Ft. addition onto the back of one of the existing cottages. The second is a covered service shed in the rear of the property adjacent to their service area, and the third is the installation of a prefabricated storage shed again adjacent to the cottages.

Meeting Date: January 10, 2019

RN Residential Neighborhood Zoning

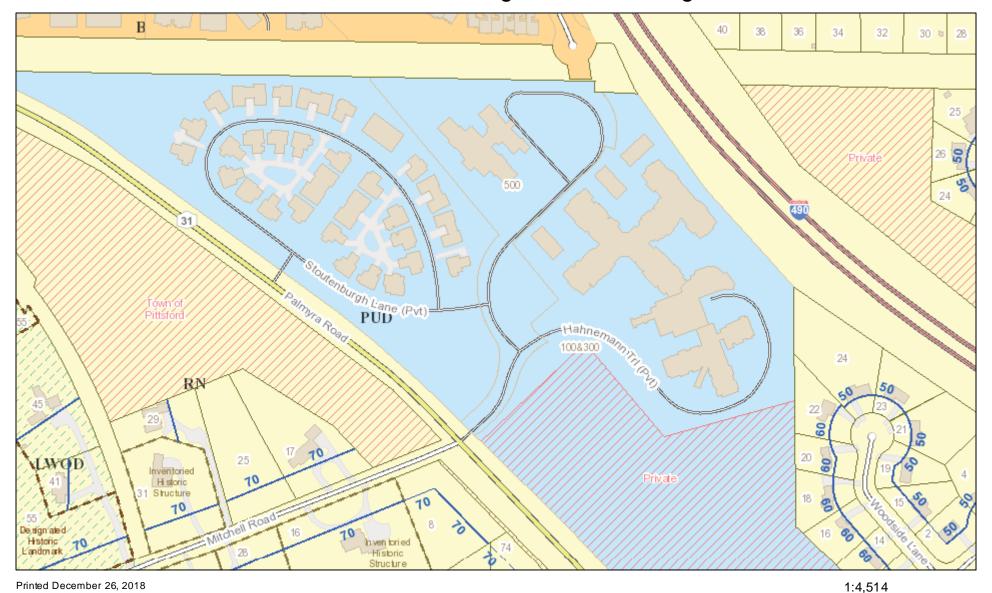

Town of Pittsford GIS

195

55


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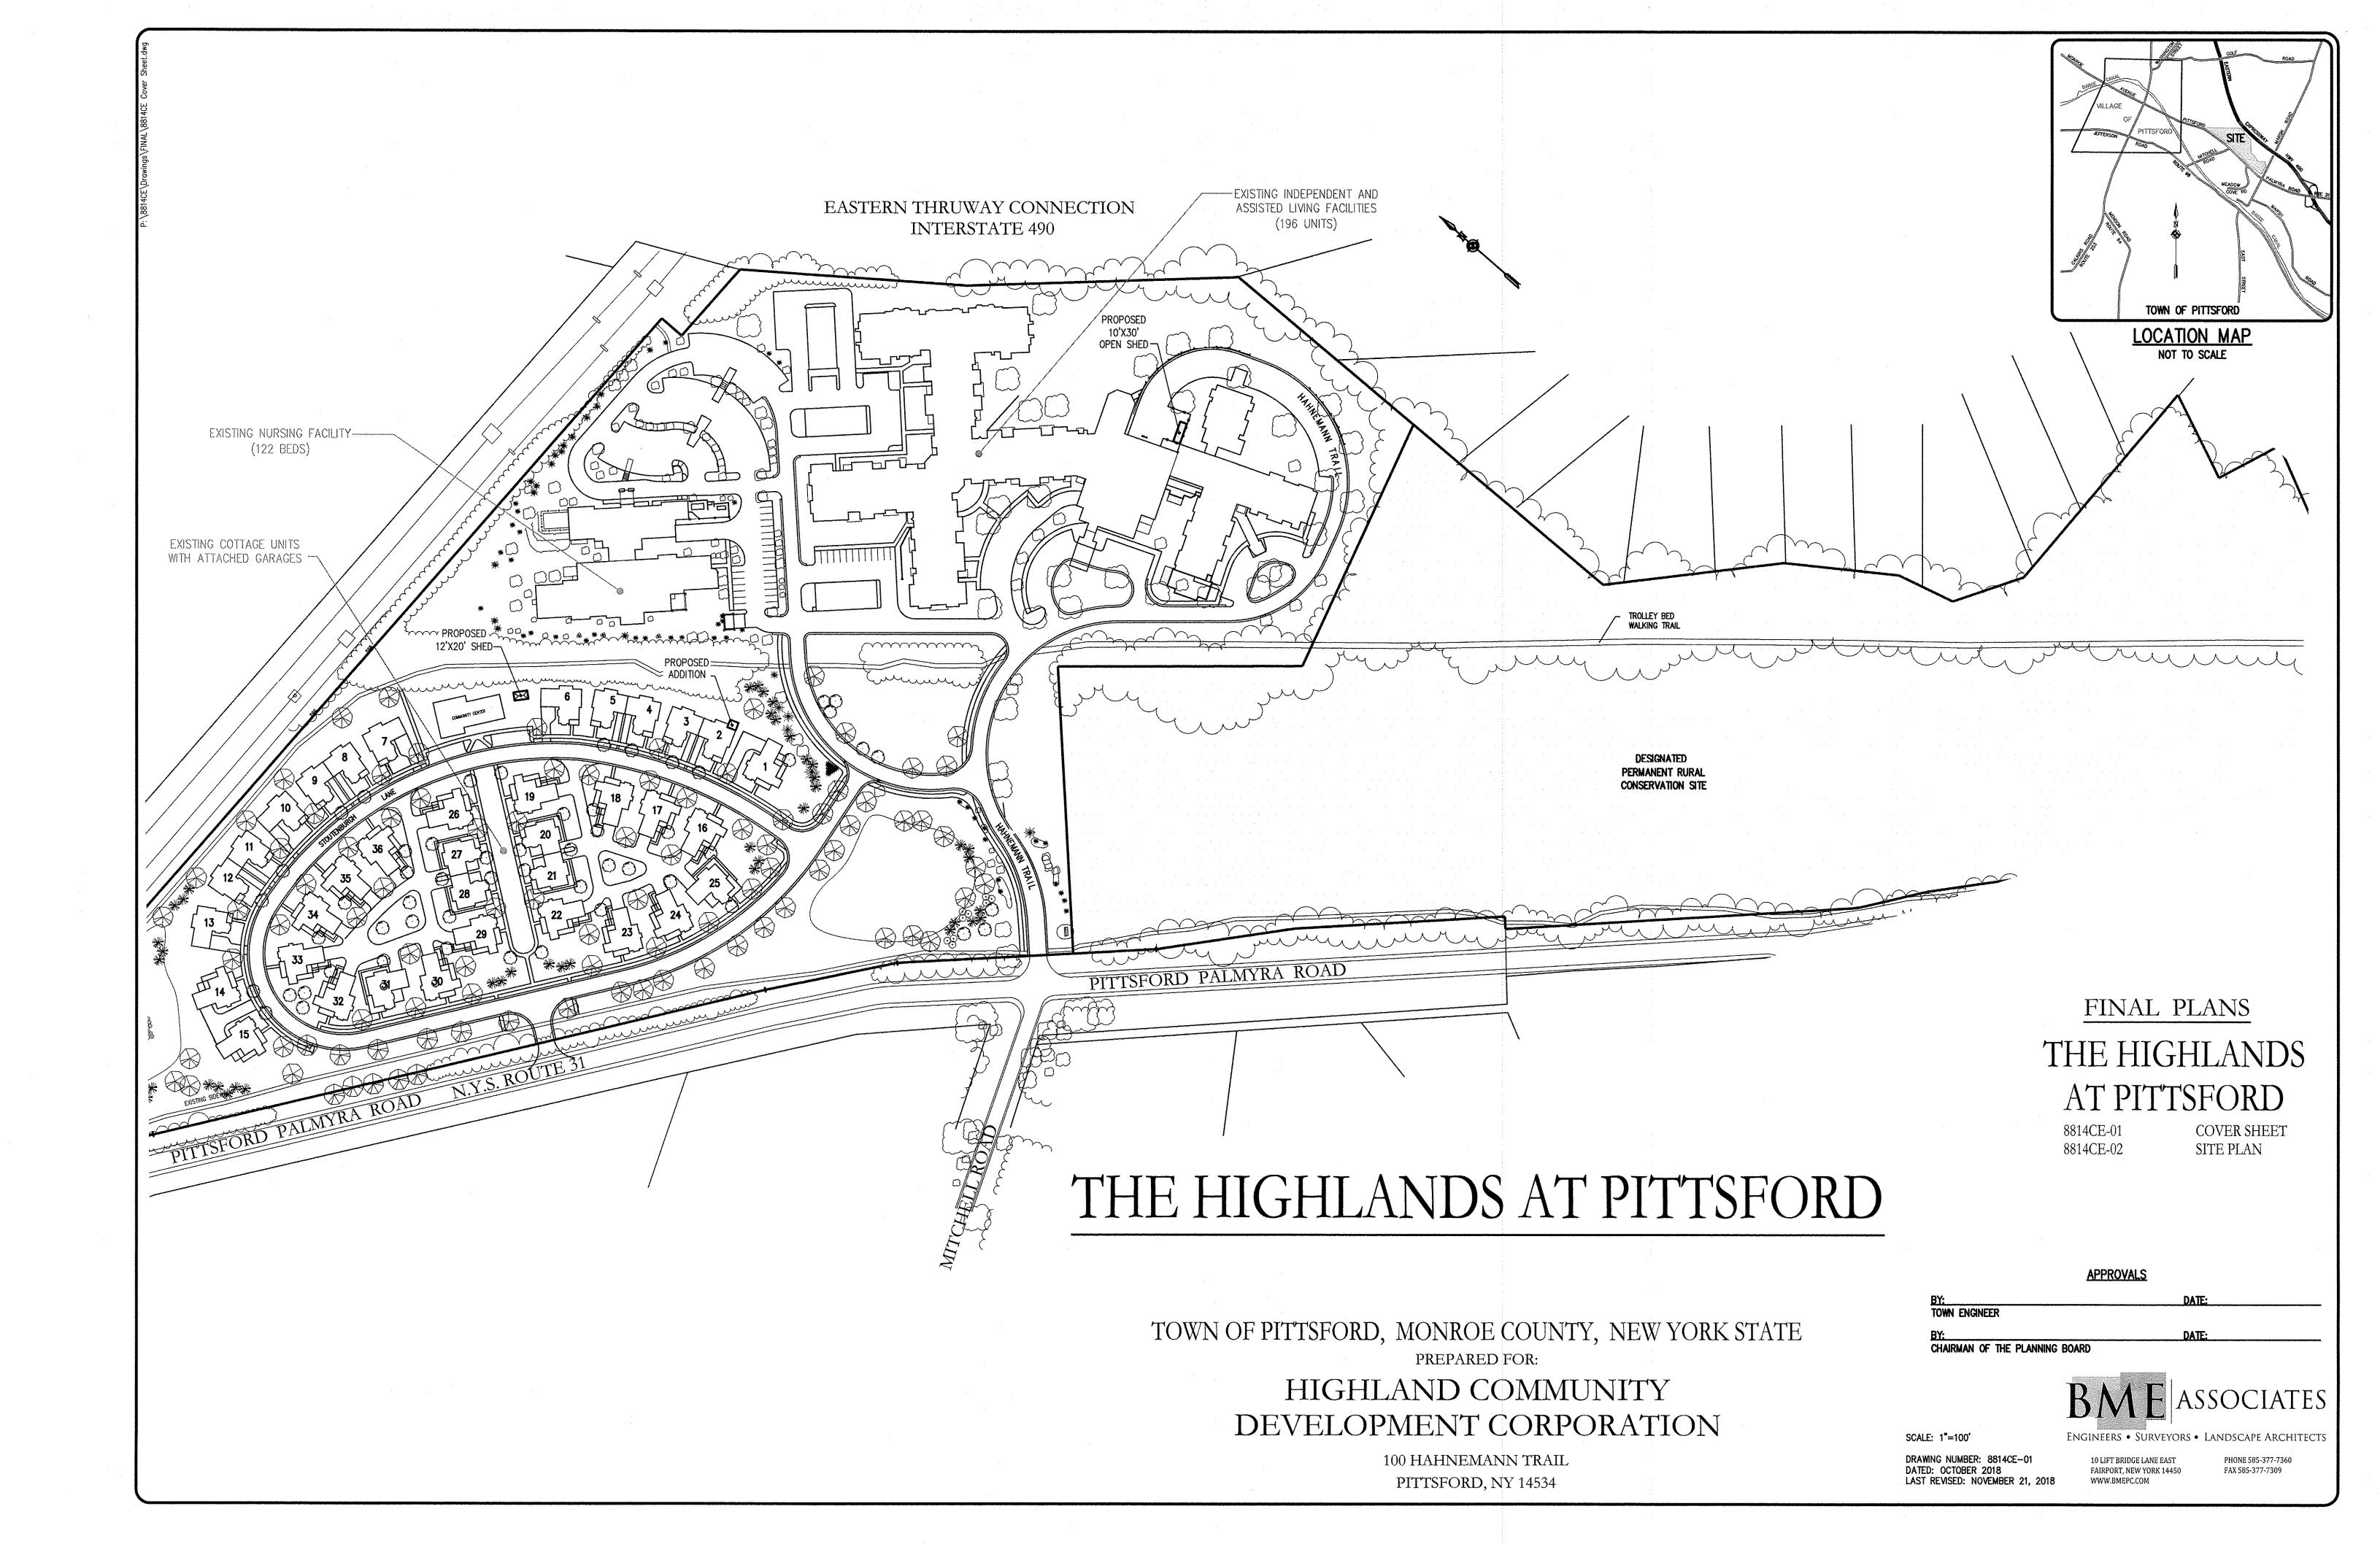
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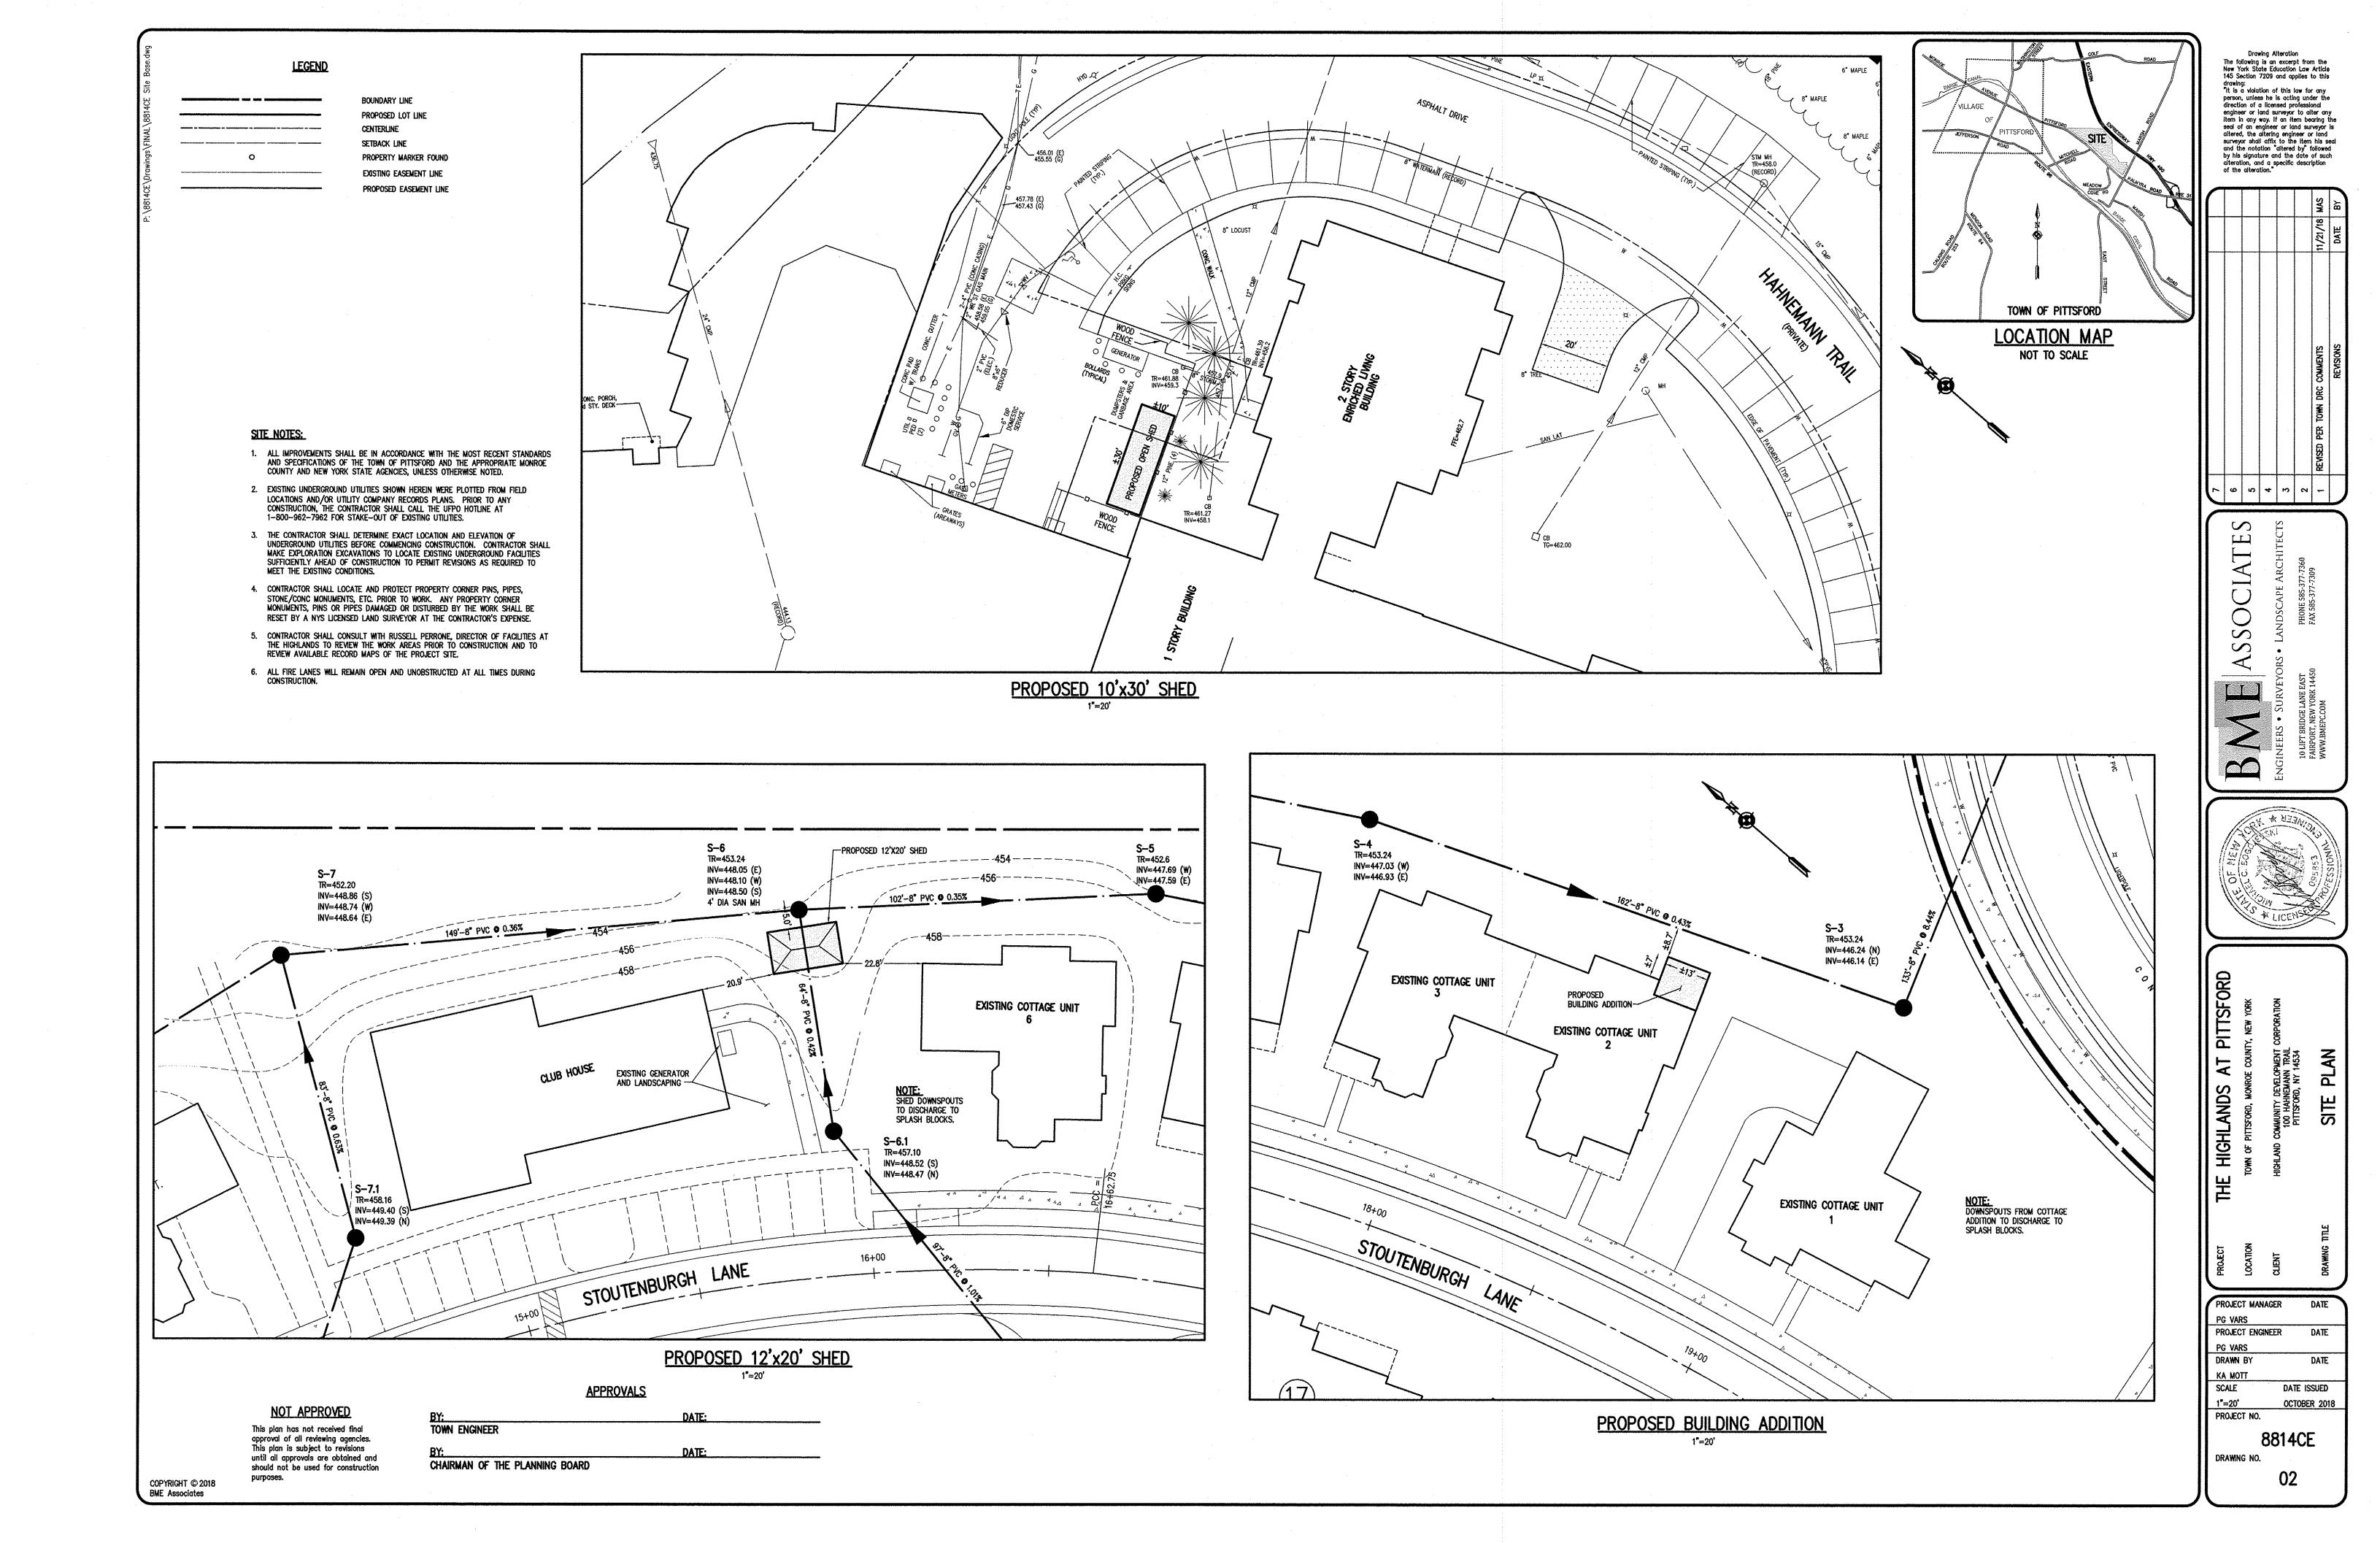
110


780 ft

220 m





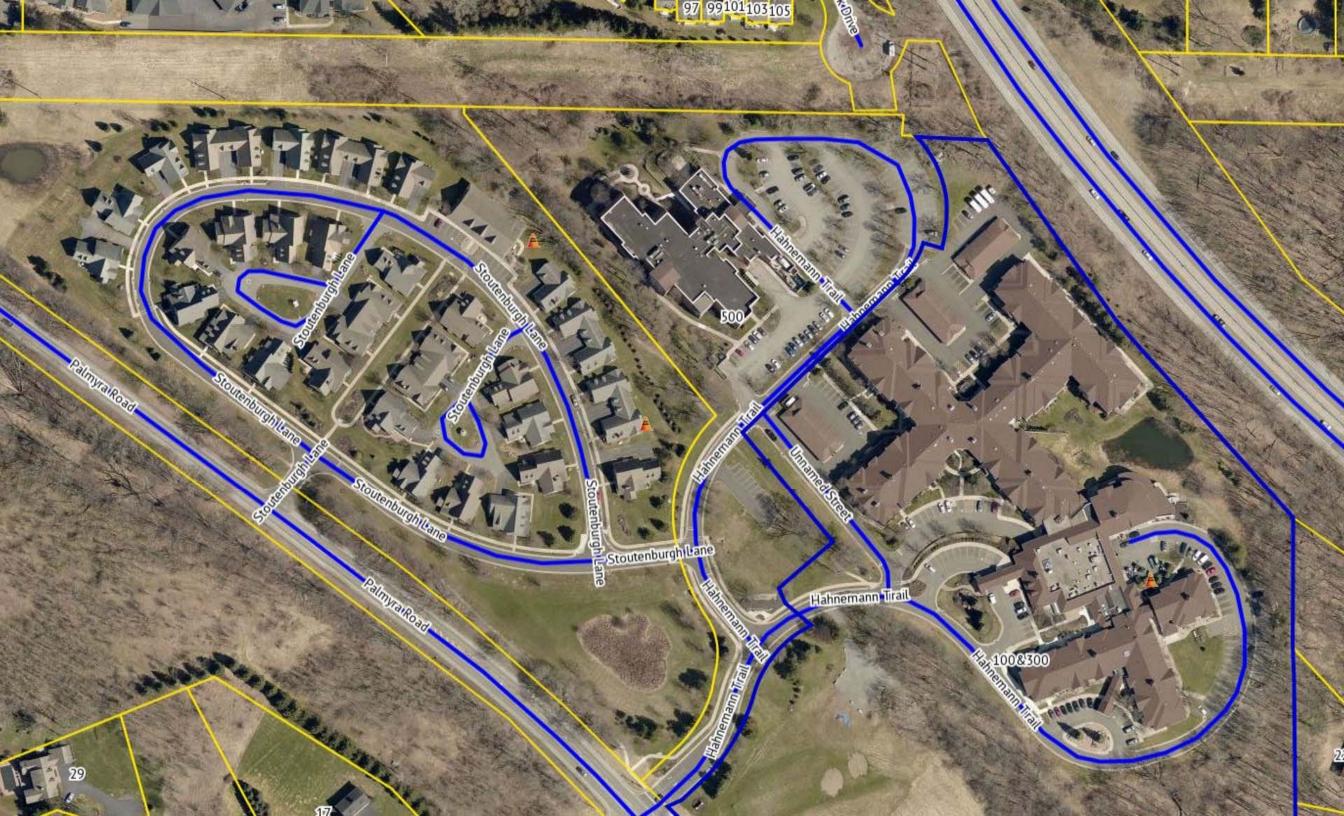

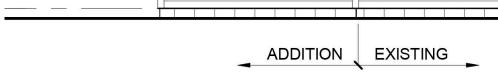

CONCEPT ELEVATIONS - NOT FOR CONSTRUCTION

Highlands at Pittsford Cottage Den Addition

Progress Set

12/7/2018

Stoutenburgh Lane Pittsford NY 14534

SWBR Project # 18221.00

SHEET LIST

T. PLATE - FIRST

G-000 - COVER SHEET

A-100 - SITE PLAN A-101 - FLOOR PLANS

A-201 - ELEVATIONS AND SECTIONS

Owner:

Highlands at Pittsford 100 Hahnemann Trail Pittsford, NY 14534 Architect & Structural Engineer:

SWBR

387 East Main Street Rochester, NY 14604 585 232 8300 rochester@swbr.com **SWBR**

Drawn By: ESR
Checked By: ESR
Project Manager: LBF

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Povisions

Highlands at Pittsford Cottage Den Addition Stoutenburgh Lane Pittsford NY 14534

SWBR Project Number 18221.00

Highland at Pittsford 100 Hahnemann Trail Pittsford, NY 14534


G-000

Cover Sheet

12/7/2018Progress Set



387 East Main Street Rochester NY 14604 585 232 8300 | rochester@swbr.com

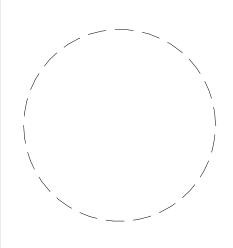

Drawn By:	ESR	
Checked By:	ESR	
Project Manager:	LBF	

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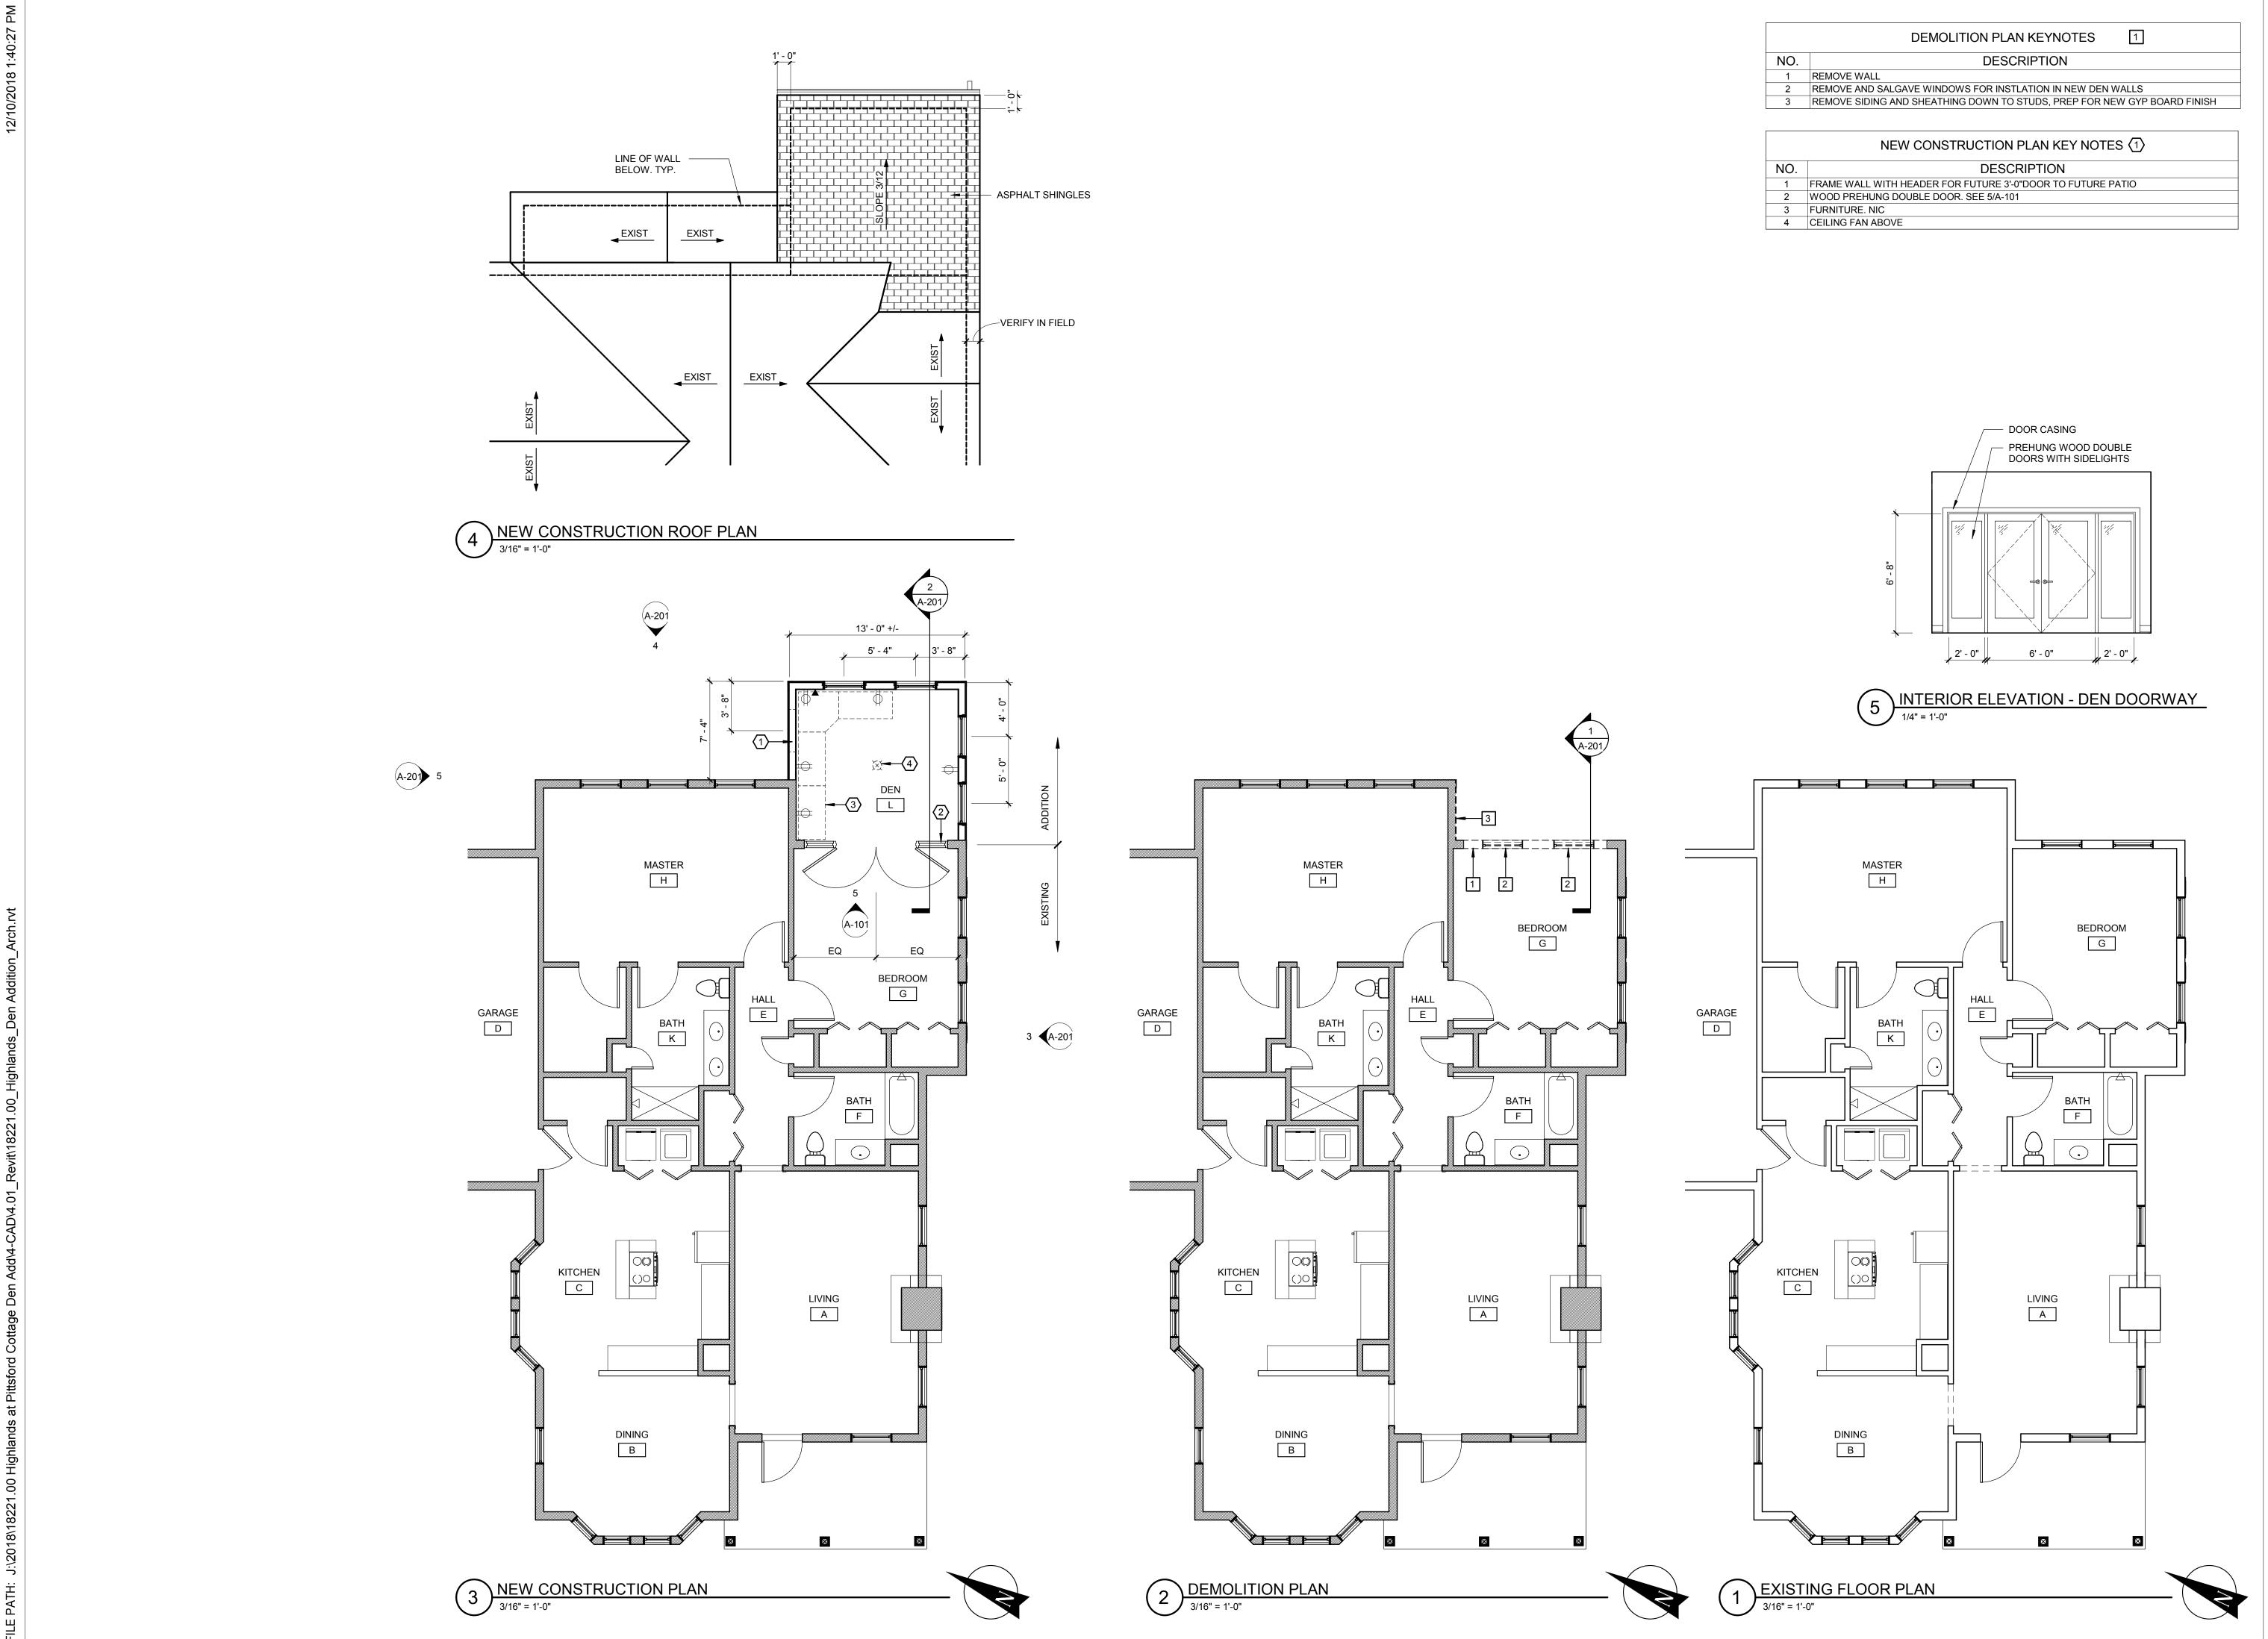
Highlands at Pittsford Cottage
Den Addition
SWBR Project Number 18221.00

Highland at Pittsford 100 Hahnemann Trail Pittsford, NY 14534

A-100

Site Plan

12/7/2018Progress Set





387 East Main Street Rochester NY 14604 585 232 8300 | rochester@swbr.com

Drawn By: ESR
Checked By: ESR
Project Manager: LBF

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Revisions

Highlands at Pittsford Cottage Den Addition SWBR Project Number 18221.00

Highland at Pittsford


100 Hahnemann Trail Pittsford,


A-101


Floor Plans

12/7/2018Progress Set

ELEVATION KEY NOTES			
NO.	DESCRIPTION		
1	VINYL SIDING. MATCH EXISTING		
2	VINYL CORNER TRIM		
3	VINYL WINDOW TRIM		
4	ASPHALT SHINGLES. MATCH EXISTING		
5	CMU FOUNDATION		
6	PREFINISHED GUTTER AND DOWNSPOUT		
7	ALUM CLAD 2X8 FASCIA		
8	DOUBLE HUNG WINDOW		
ΩΩ	DOLIBLE HUNG WINDOW EXISTING WINDOW LINIT IN NEW OPENING		

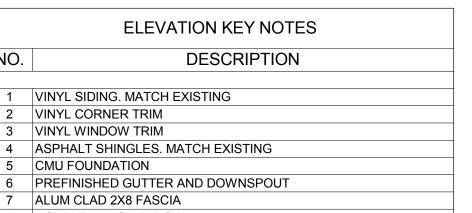

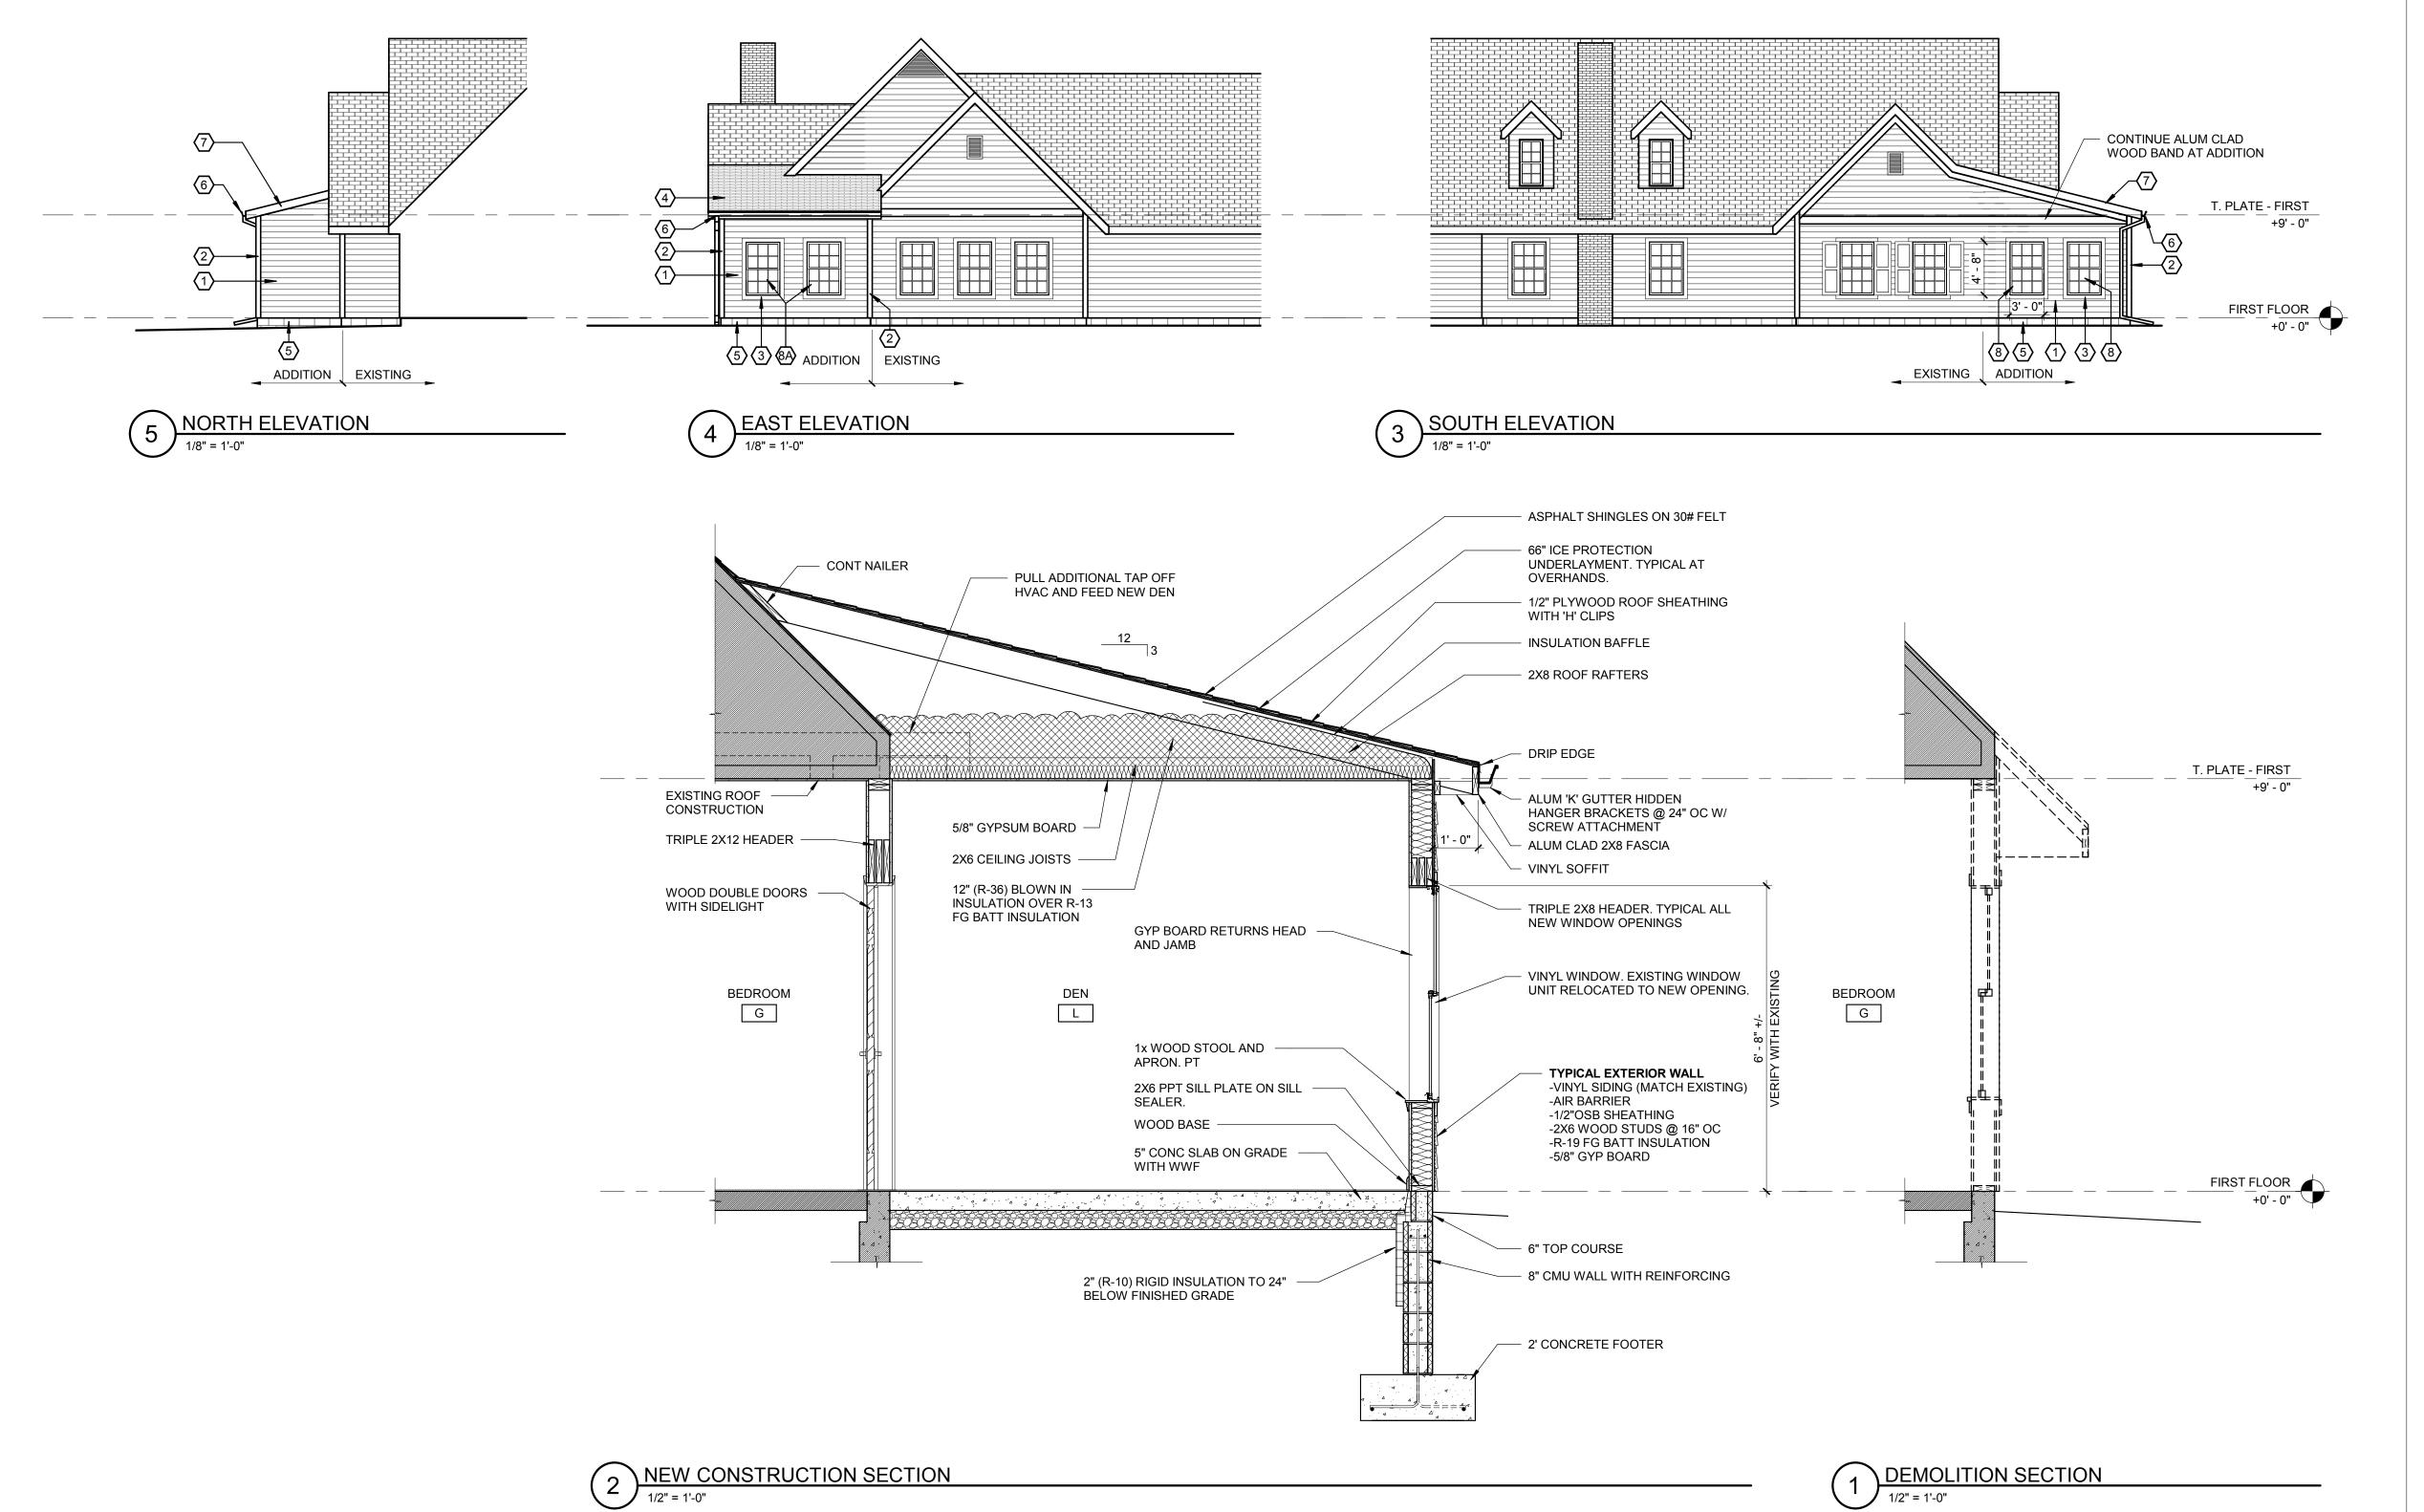

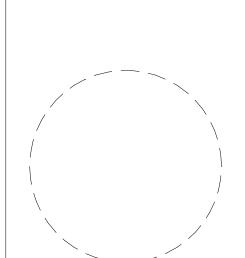

SWBR

387 East Main Street Rochester NY 14604 585 232 8300 | rochester@swbr.com

Drawn By:	ESR
Checked By:	ESR
Project Manager:	LBF
Project Manager:	LBF

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Revisions

Highlands at Pittsford Cottage Den Addition SWBR Project Number 18221.00

Highland at Pittsford 100 Hahnemann Trail Pittsford, NY 14534


A-201

Elevations and Sections

12/7/2018 Progress Set

-0.07.0

Highlands at Pittsford Service Shed

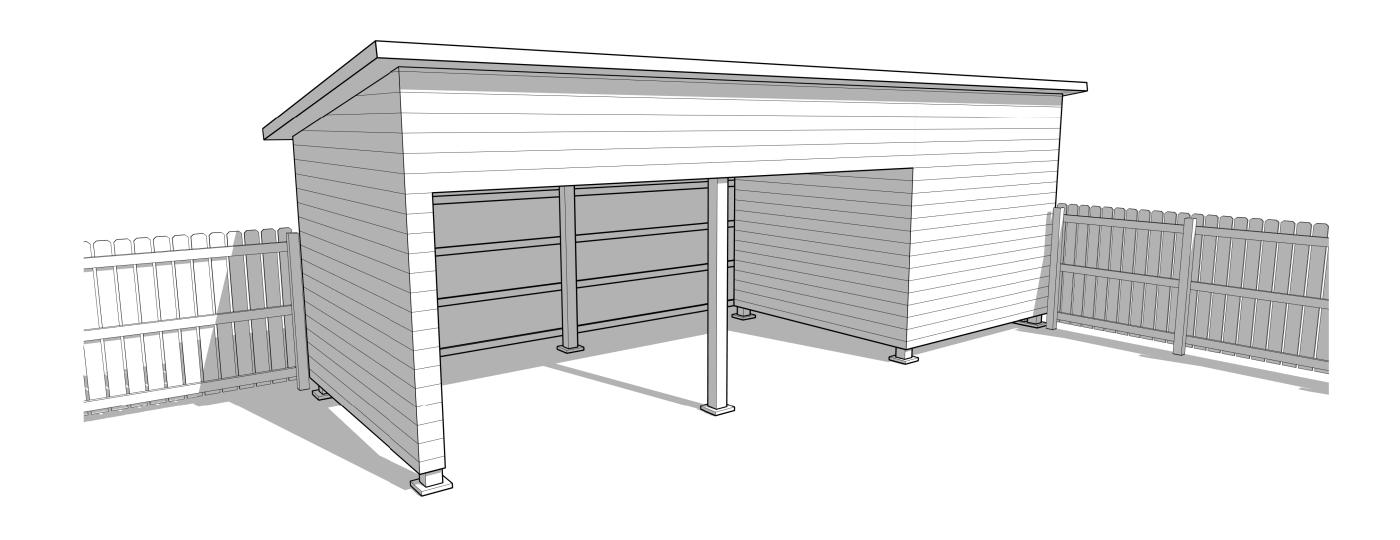

Concept Image - Not For Construction

Permit Set 3/16/2018

100 Hahnemann Trail

SWBR Project # 18050.00



309 South Franklin Street Syracuse NY 1320 315 488 5635 | syracuse@swbr.com

Drawn By:	ESR
Checked By:	ESR
Project Manager:	LBF
- roject manager:	

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Povisions

Highlands at Pittsford Service


100 Hahnemann Trail
SWBR Project Number 18050.00

Highlands at Pittsford 100 Hahnemann Trail

A-000Title Sheet

3/16/2018Permit Set



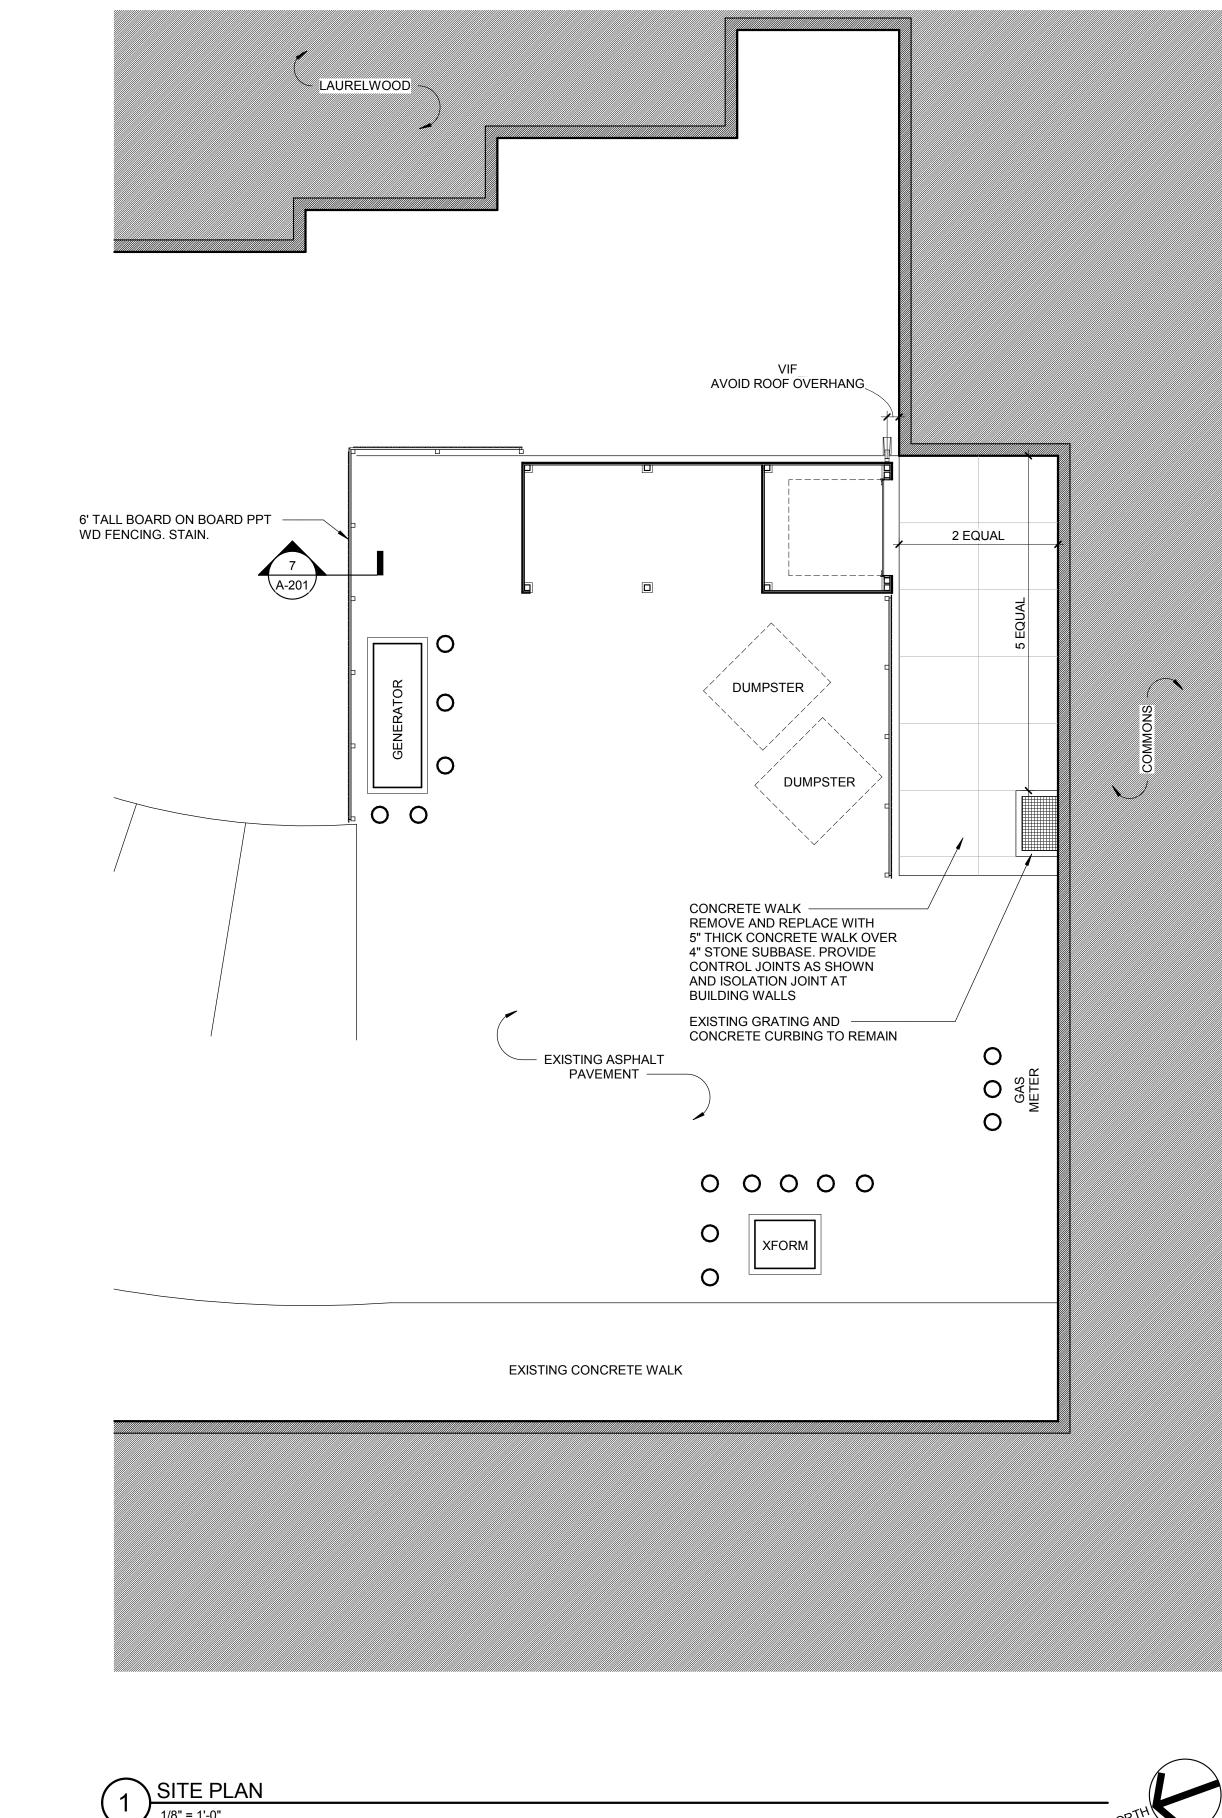

GARAGE DOOR WEATHERSTRIPPING

PPT WD BLOCKING FOR GARAGE JAMB ATTACHMENT. ALIGN WITH FACE OF CONCRETE PIER BELOW

- 6X6 PPT WD POST AT GARAGE DOOR

---- 1x PVC TRIMBOARD

2x4 BLOCKING AT EDGE

- 2X4 WD NAILER

- VINYL SIDING

10' - 0"

─ 8'-0" W X 7'-0" TALL

SECTIONAL GARAGE DOOR

A-101

3 PLAN DETAIL AT GARAGE JAMB
3/4" = 1'-0"

- 1/2" OSB SHEATHING

GARAGE DOOR

GARAGE DOOR TRACK

CONC PIER BELOW

A-201

SHEATHING SIDING AND -

ENCLOSE GARAGE


NAILERS AT THIS SECTION TO

10' - 0"

6X6 PPT WD POST ON
 CONCRETE FOUNDATION. TYP

10' - 0"

A-201 2

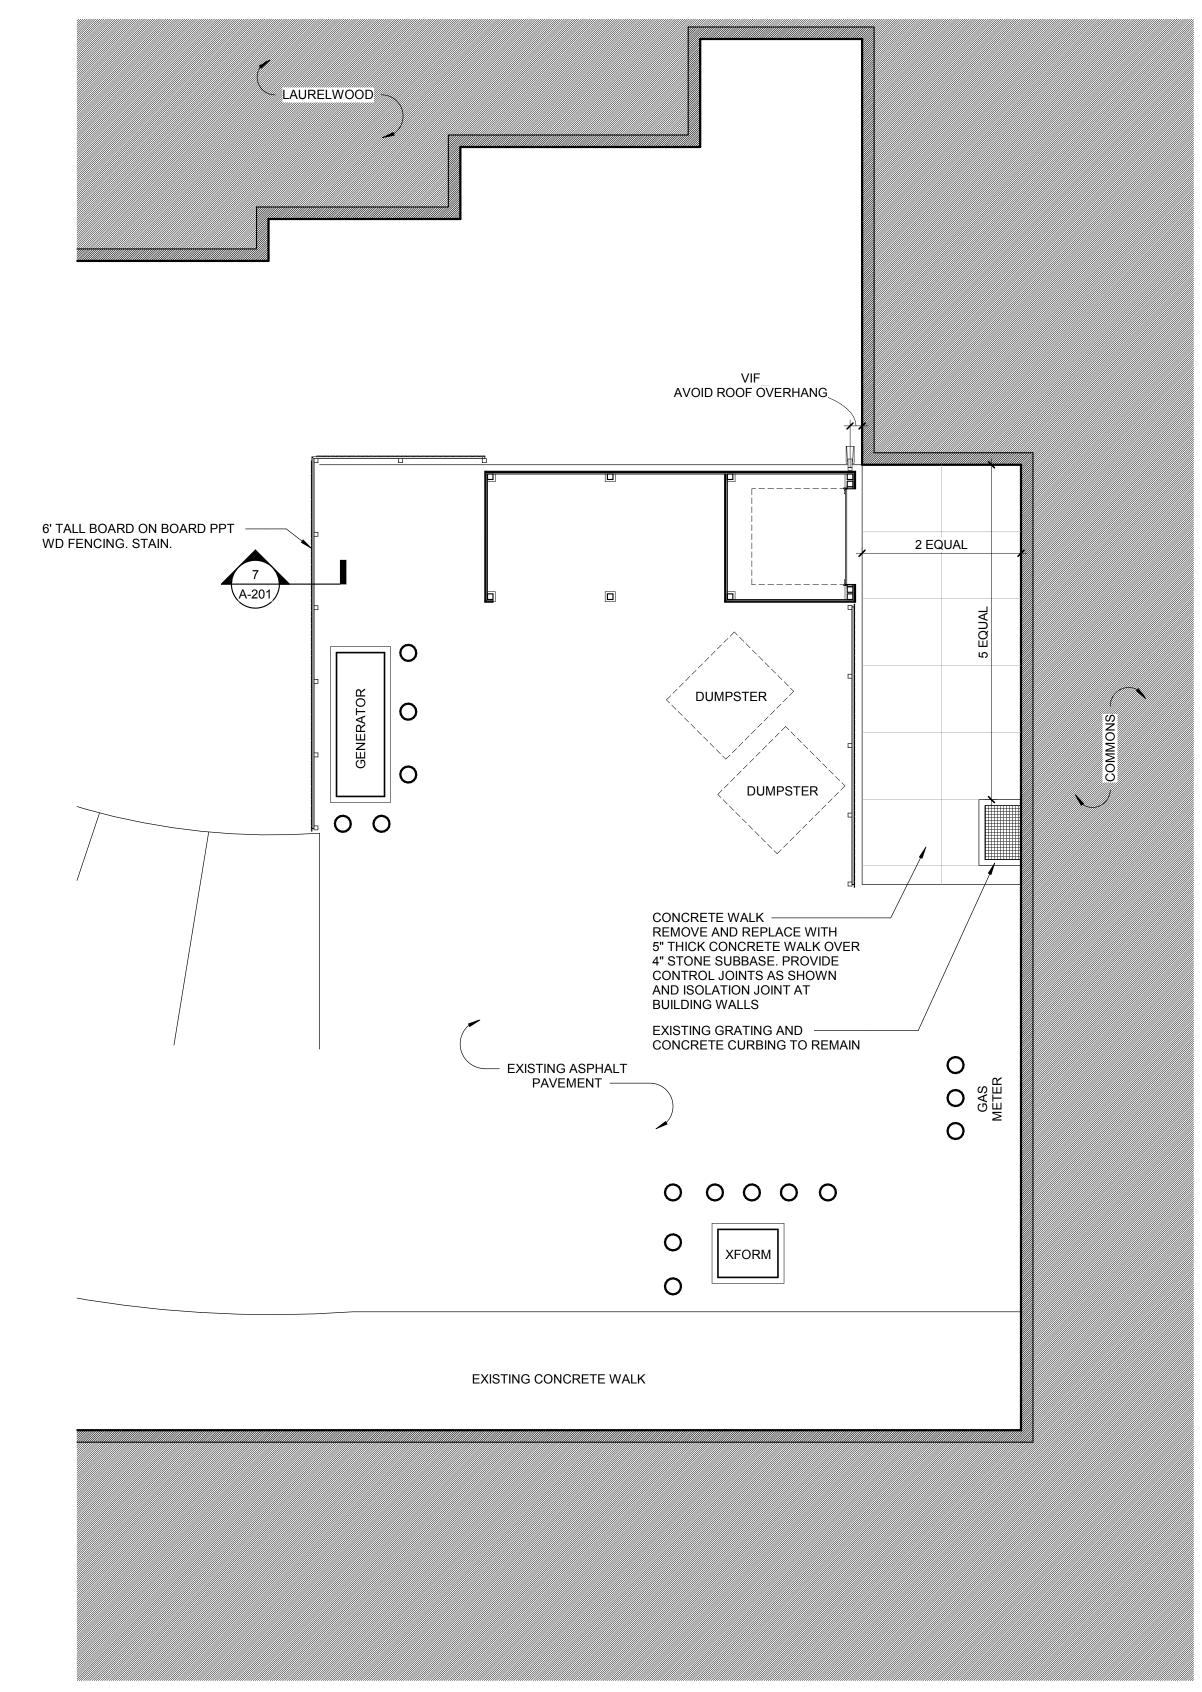

387 East Main Street Rochester NY 14604

585 232 8300 | rochester@swbr.com

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Highlands at Pittsford Service Shed


100 Hahnemann Trail SWBR Project Number 18050.00


Highlands at Pittsford 100 Hahnemann Trail

A-101 Plans and Details

3/16/2018 Permit Set



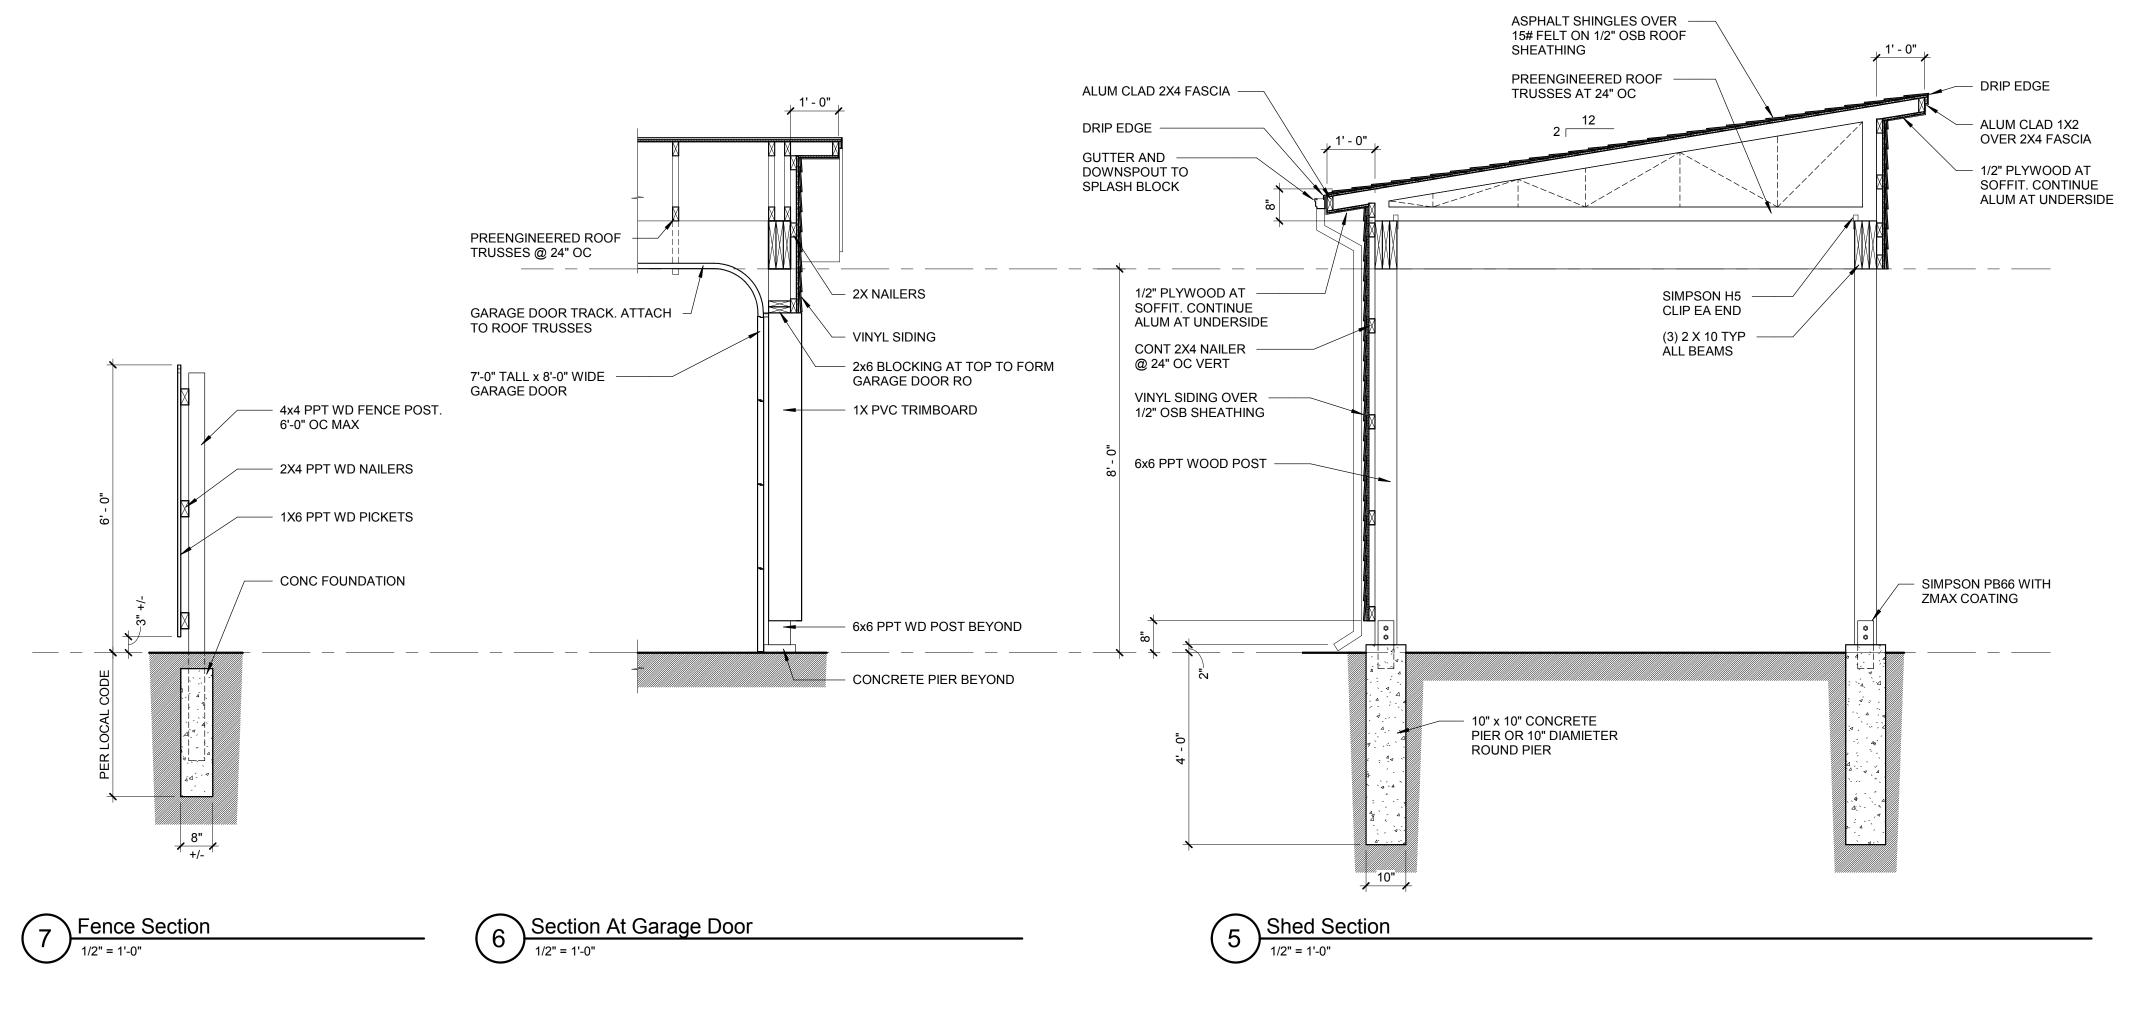

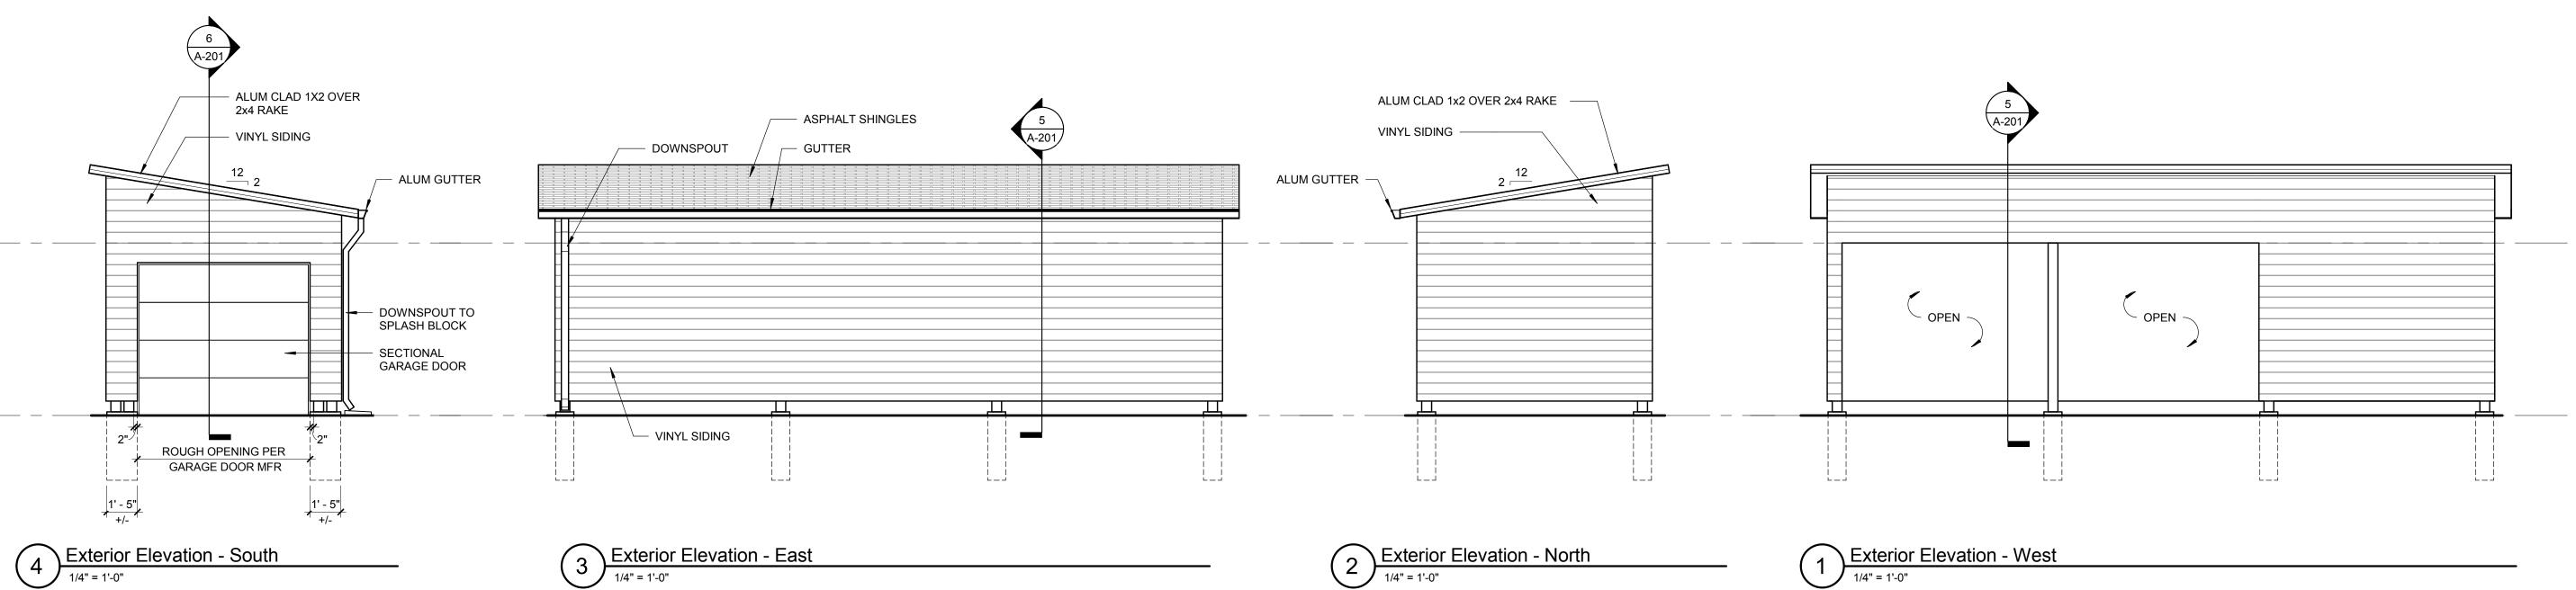

Drawn By: ESR
Checked By: ESR
Project Manager: LBF

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Revisions

Highlands at Pittsford Service Shed


100 Hahnemann Trail
SWBR Project Number 18050.00

Highlands at Pittsford 100 Hahnemann Trail

A-201

Elevations and Details

3/16/2018Permit Set

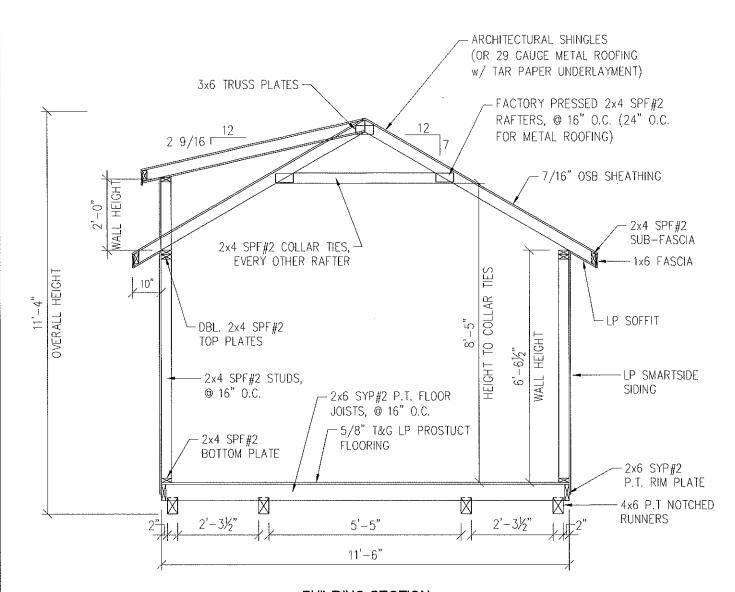


BUILDING SECTION



12' WIDE HERITAGE with DORMER



12x20 Hertitage

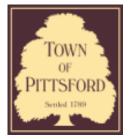

Town of Pittsford

Department of Public Works 11 South Main Street Pittsford, New York 14534

Permit # C18-000042

Phone: 585-248-6250 FAX: 585-248-6262

DESIGN REVIEW AND HISTORIC PRESERVATION BOARD REFERRAL OF APPLICATION

Property Address: 790 Linden Avenue ROCHESTER, NY 14625

Tax ID Number: 138.15-1-16

Zoning District: LI Light Industrial

Owner: Dr. Andrew Dvonch Applicant: Dimarco Group

Application Type:


- Residential Design Review
 - §185-205 (B)
- Commercial Design Review
 - §185-205 (B)
- Signage
 - §185-205 (C)
- Certificate of Appropriateness
- §185-197
- Landmark Designation
 - §185-195 (2) Informal Review

- Build to Line Adjustment
 - §185-17 (B) (2)
 - Building Height Above 30 Feet
 - §185-17 (M)
- Corner Lot Orientation
 - §185-17 (K) (3)
- Flag Lot Building Line Location
 - §185-17 (L) (1) (c)
- Undeveloped Flag Lot Requirements
 - §185-17 (L) (2)

Project Description: Applicant is requesting design review for exterior modifications to 790 Linden Avenue. Building is being re-purposed to convert it from professional office to a dental office. Modifications include adding windows for dental suites and relocating existing entry door on South elevation, filling in existing overhead doors on East elevation and adding windows for dental suites on West elevation. All modifications will include matching existing exterior building materials.

Meeting Date: January 10, 2019



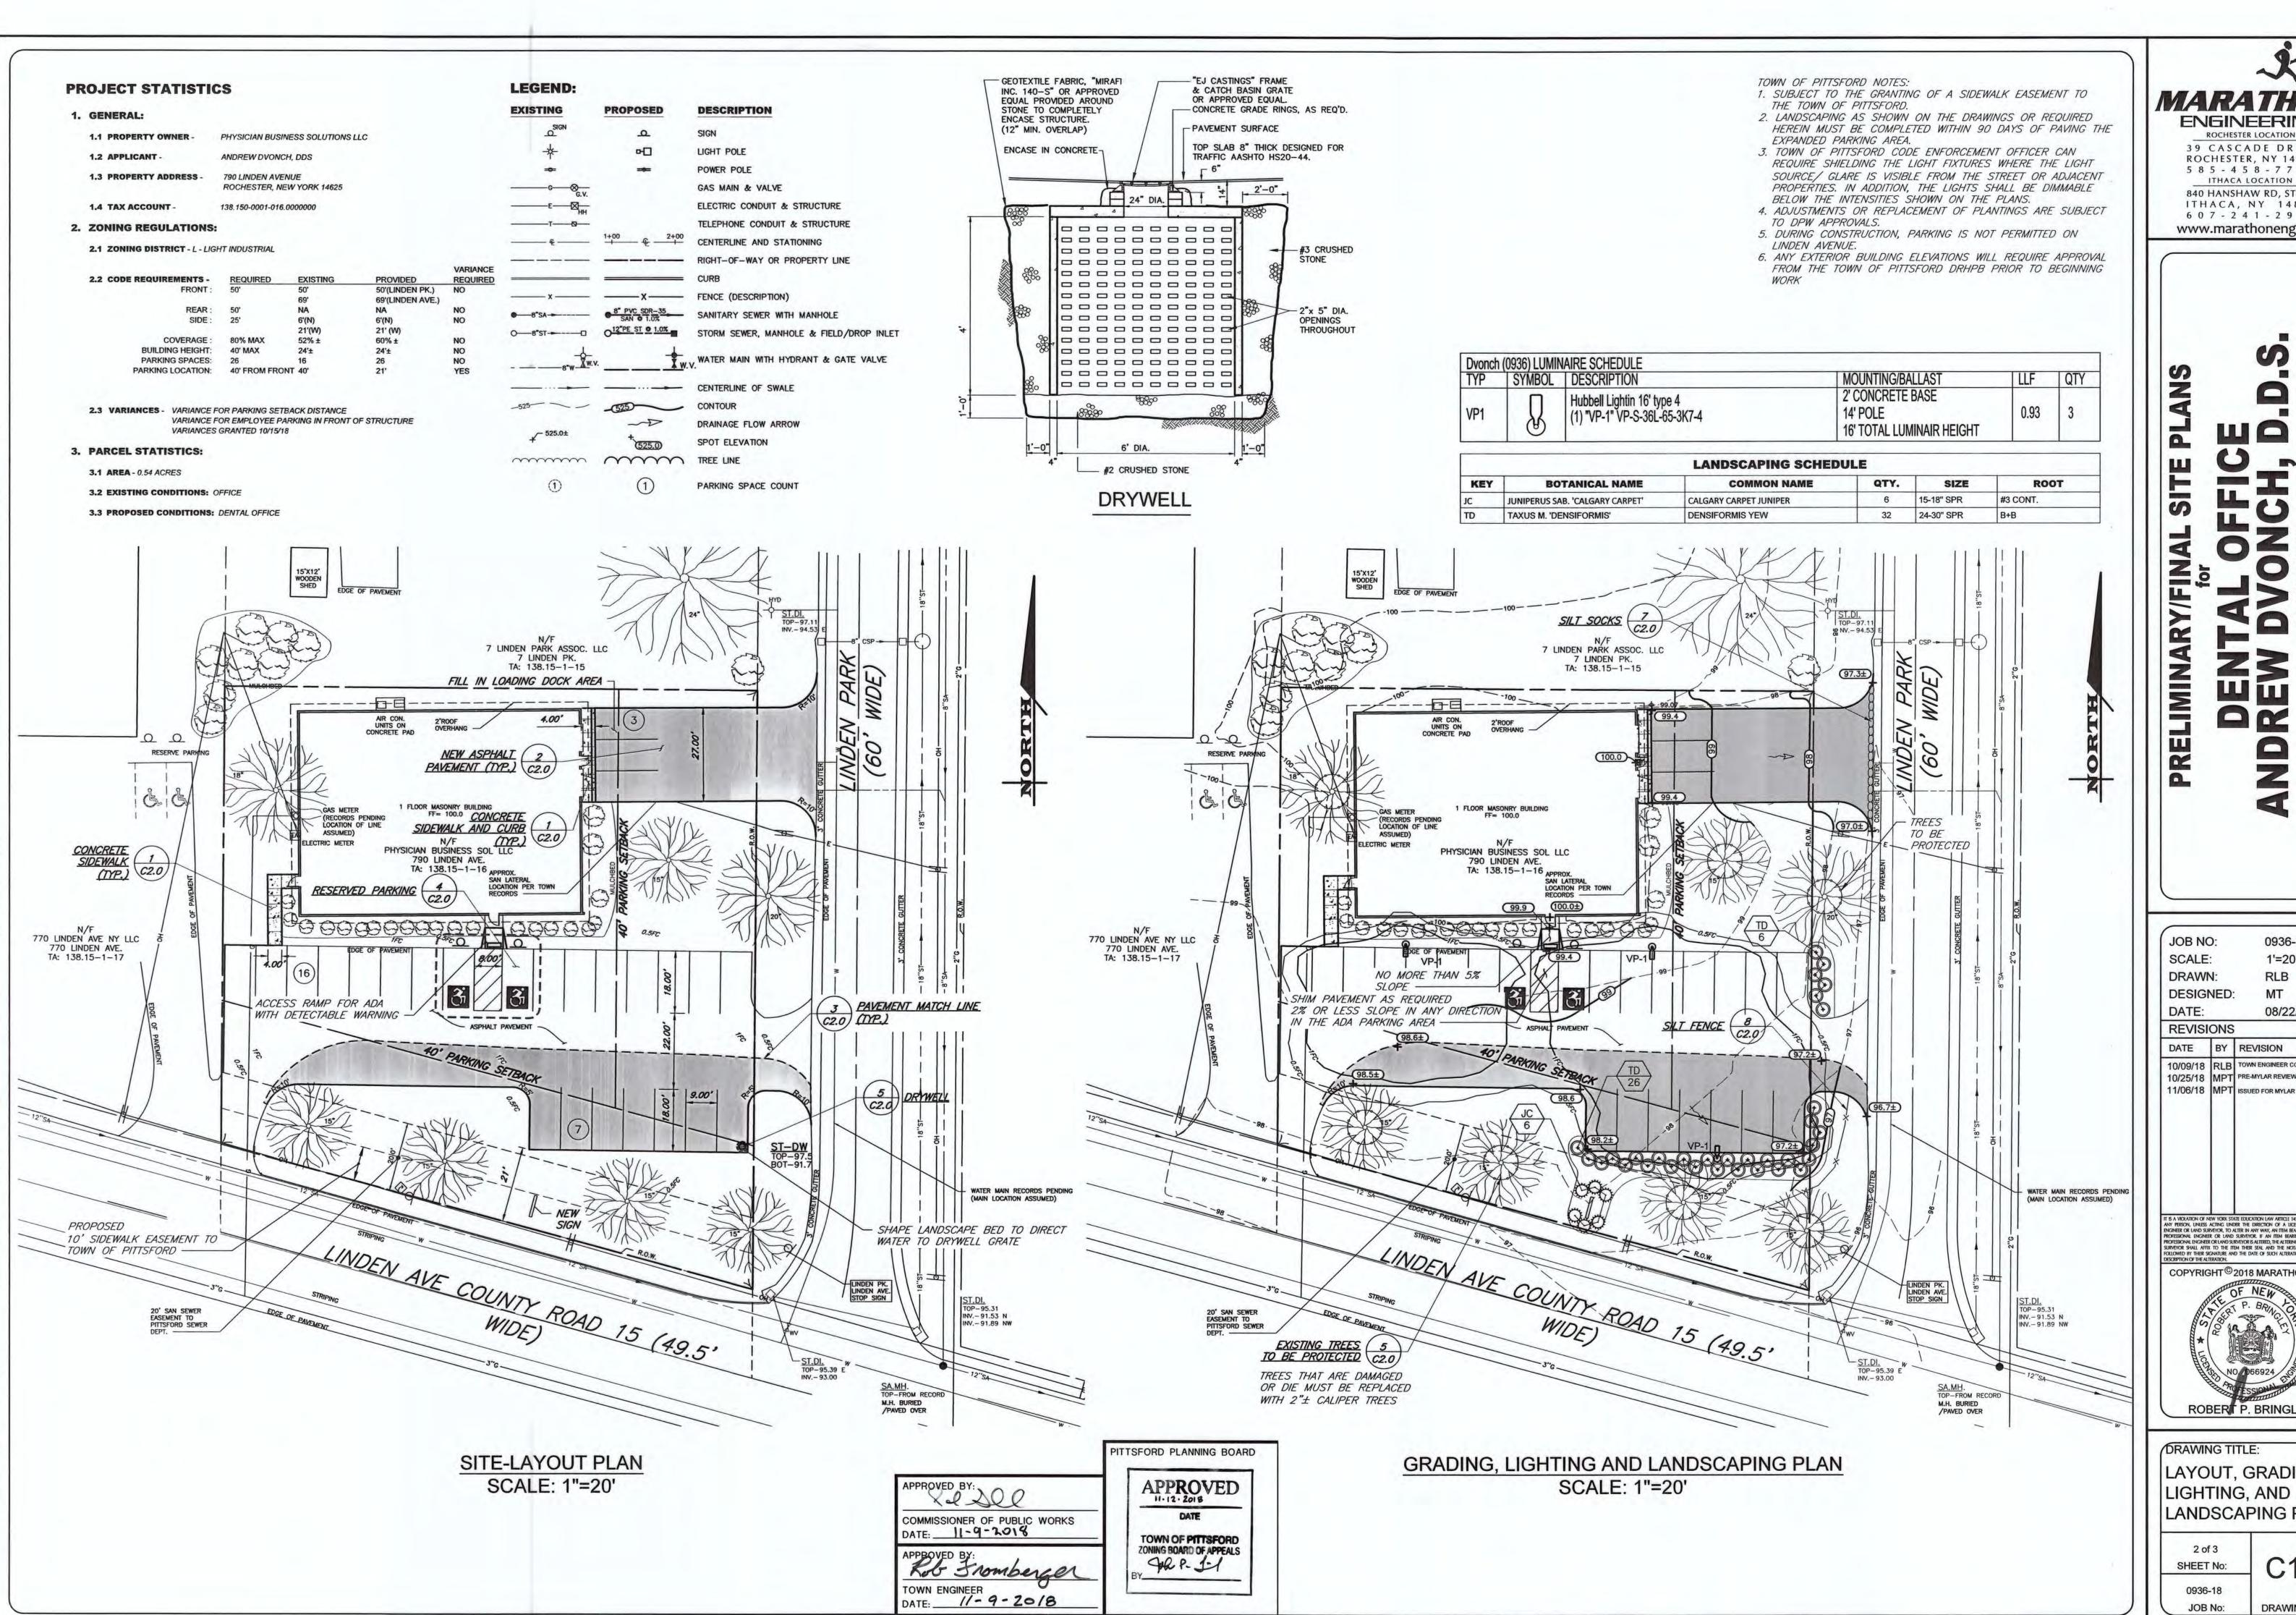



ROCHESTER LOCATION 39 CASCADE DRIVE ROCHESTER, NY 14614 ITHACA LOCATION

5 8 5 - 4 5 8 - 7 7 7 0 840 HANSHAW RD, STE 12 ITHACA, NY 14850 6 0 7 - 2 4 1 - 2 9 1 7

www.marathoneng.com

0936-18 1'=20' RLB MT **DESIGNED:** 08/22/2018

REVISIONS DATE BY REVISION 10/25/18 MPT PRE-MYLAR REVIEW

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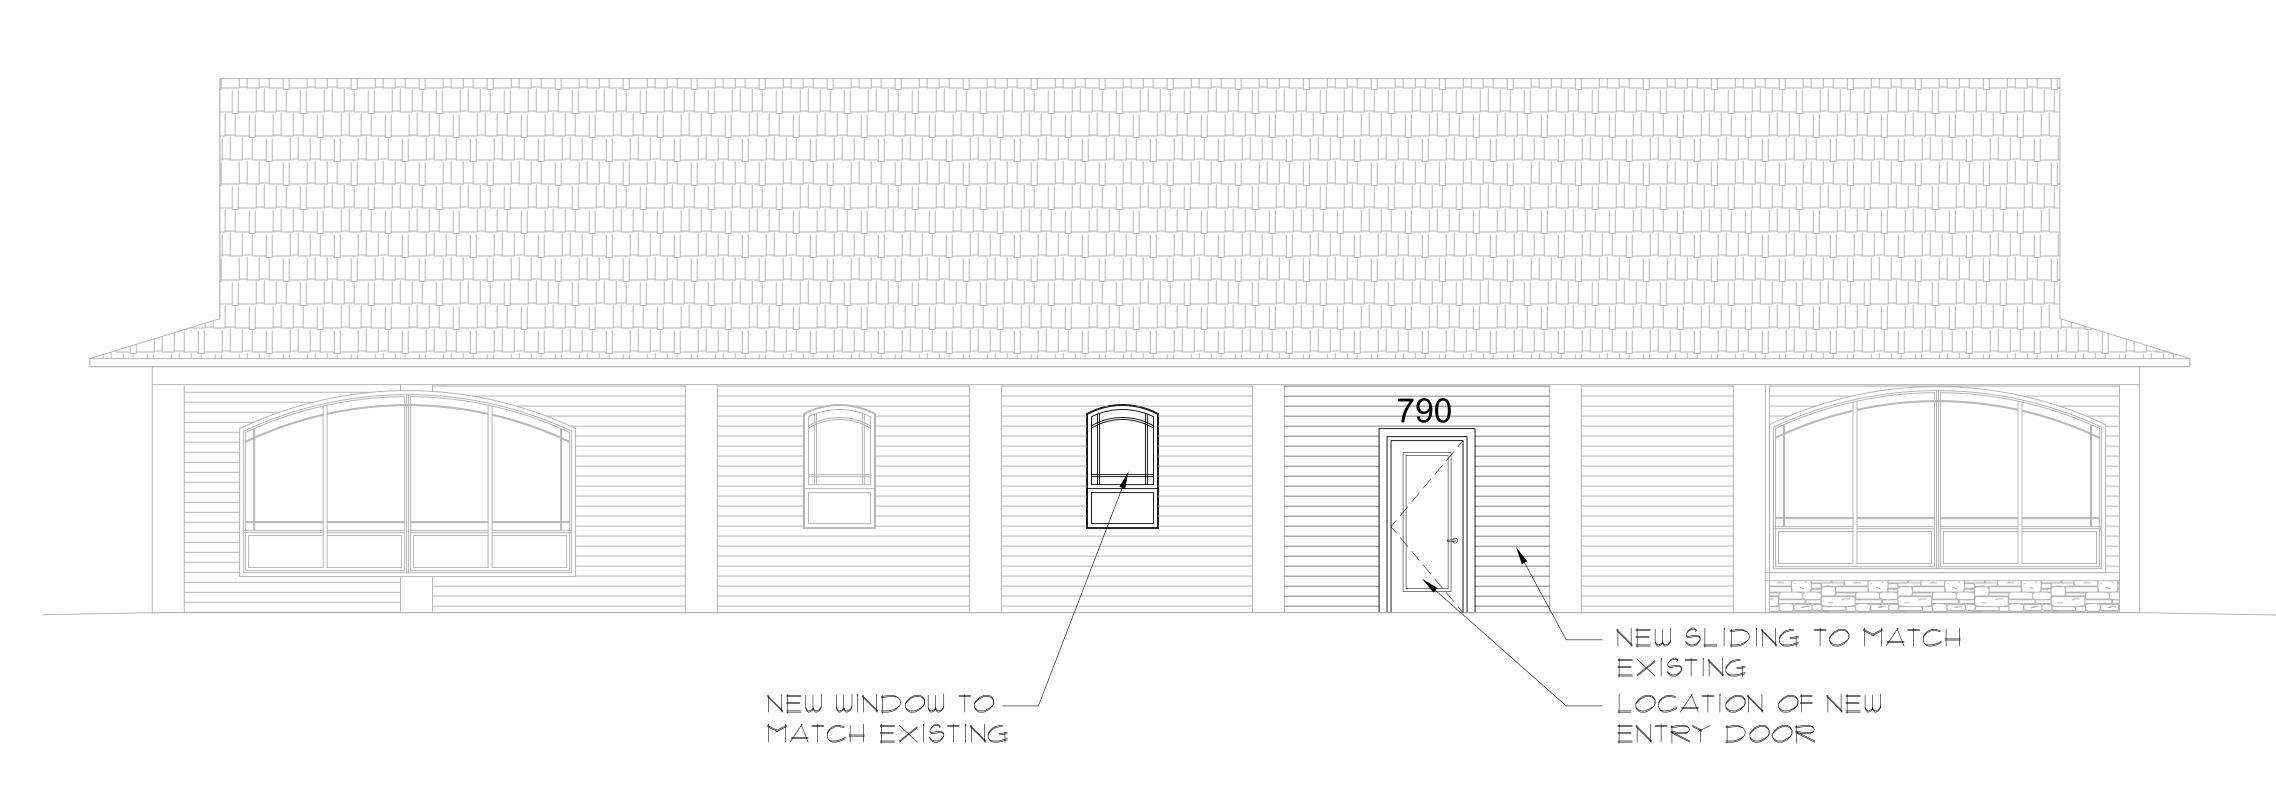
DESCRIPTION OF THE ALTERATION. COPYRIGHT[©] 2018 MARATHON ENG

ROBER P. BRINGLEY DRAWING TITLE: LAYOUT, GRADING

LIGHTING, AND LANDSCAPING PLAN 2 of 3

SHEET No: 0936-18

C1.0 JOB No: DRAWING No:



PROPOSED SOUTH ELEVATION

SCALE: 1/4"= 1'-0"




EXISTING SOUTH ELEVATION

SCALE: 1/4"= 1'-0"

PROJECT NO: 18-063

DRAWING TITLE:

ELEVATIONS

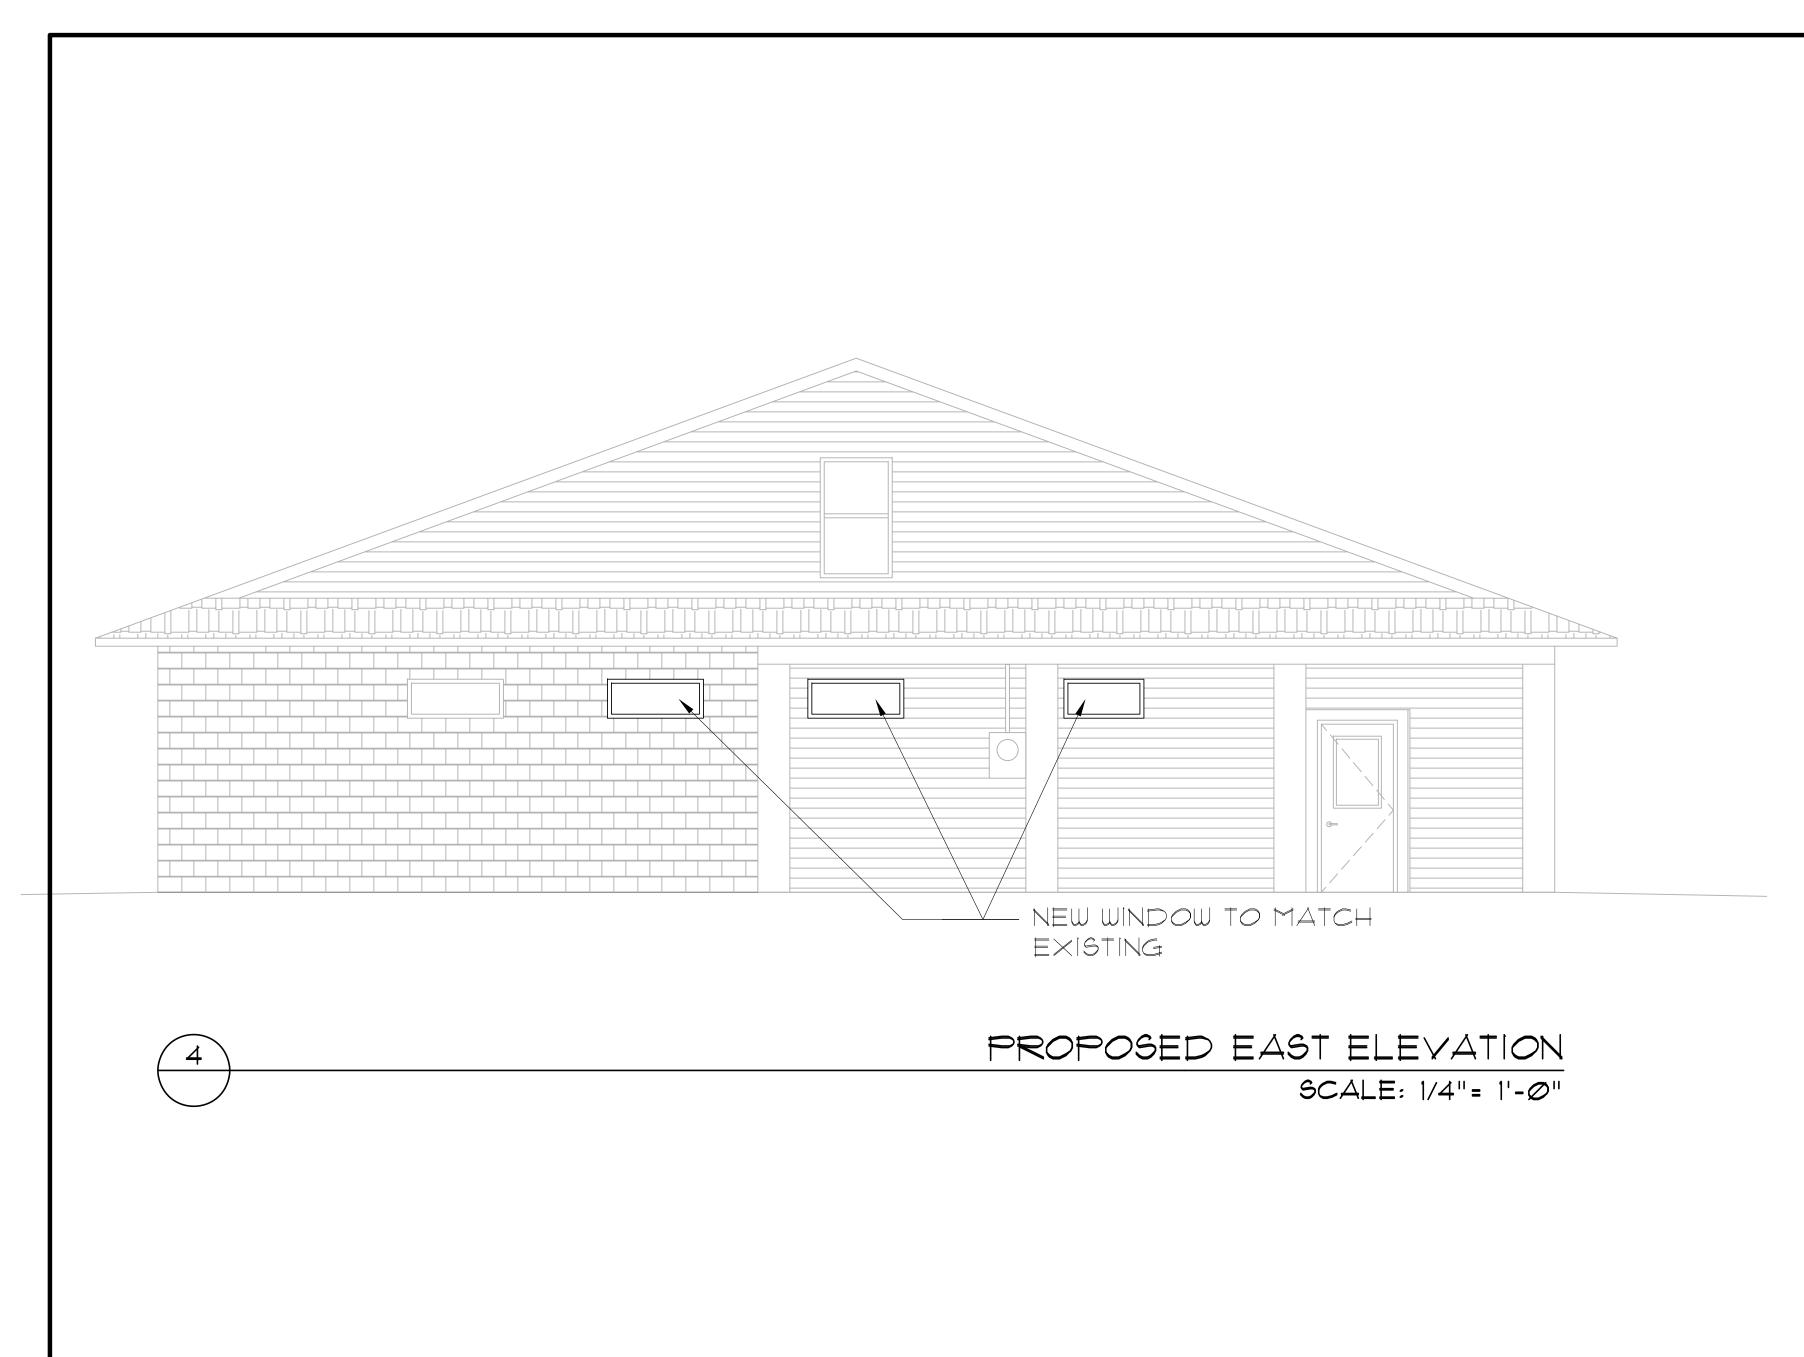

EXISTING

EXISTING EAST ELEVATION SCALE: 1/4"= 1'-0"

INFILL EXISTING OPENINGS

PROVIDE NEW SIDING TO MATCH EXISTING

PROPOSED WEST ELEVATION

SCALE: 1/4"= 1'-0"

EXISTING WEST ELEVATION

SCALE: 1/4"= 1'-0"


EXTERIOR ELEVATIONS DRAWING TITLE:

DR. DYONCH DENTIST

SHEET NO:

PROJECT NO: 18-063



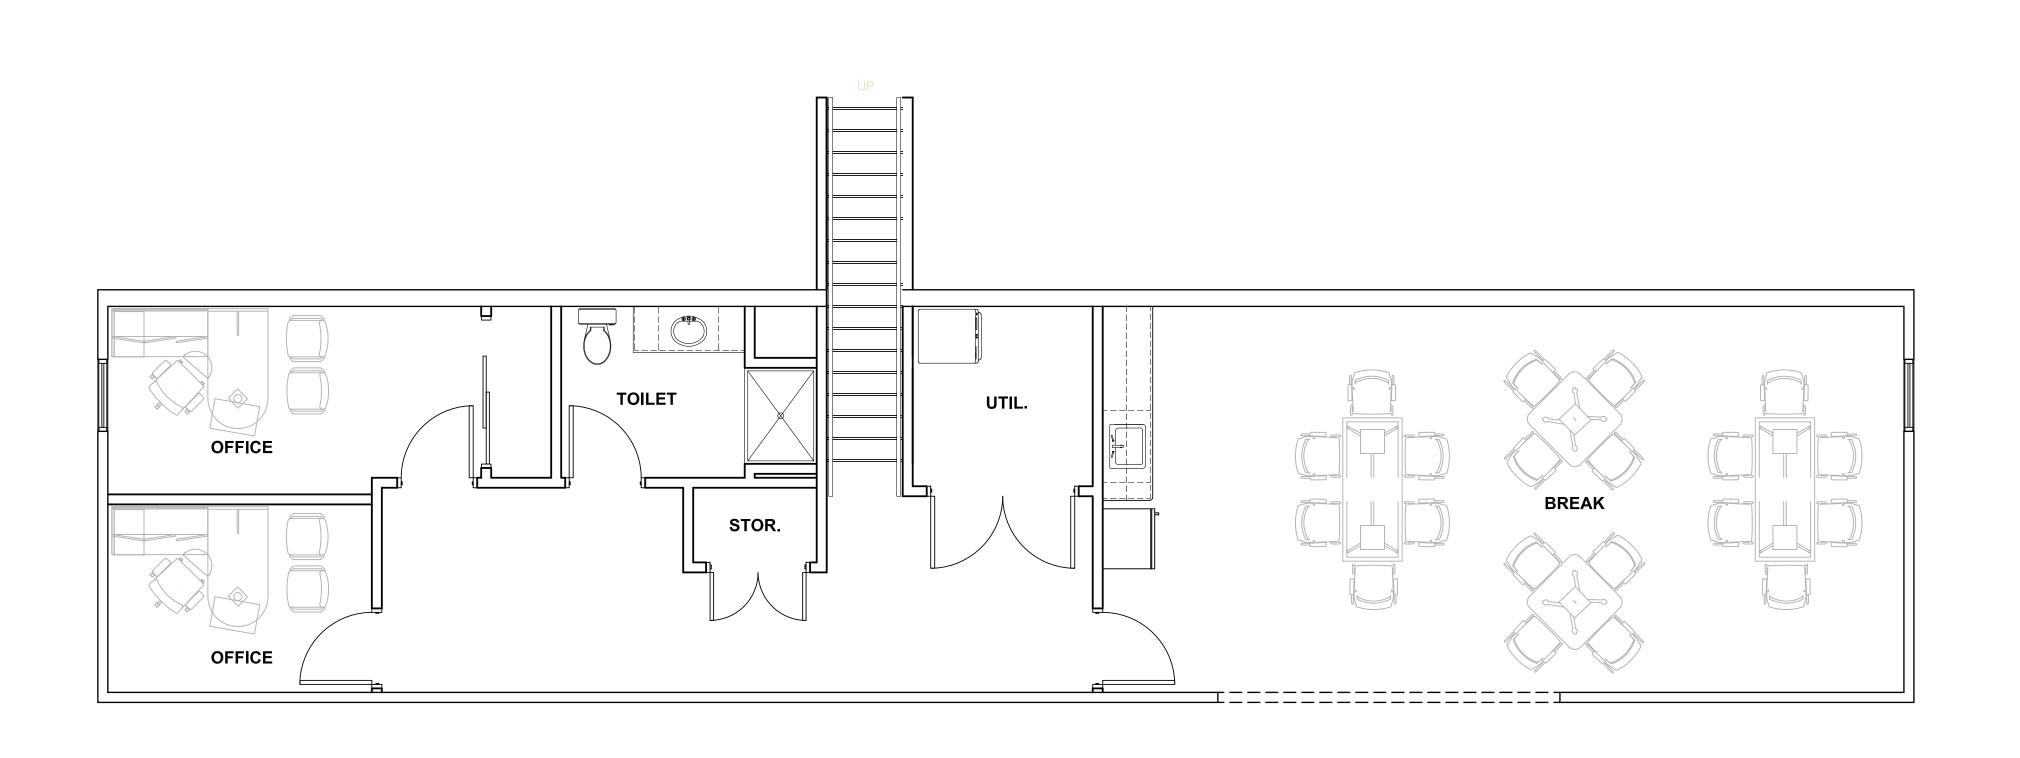

DR. DYONCH DENTIST


SECOND FLOOR

DRAWING TITLE:

SHEET NO:

PROJECT NO: 18-063

SECOND FLOOR PLAN SCALE: 1/4"=1'-0"

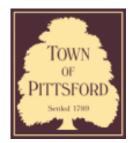

Town of Pittsford

Department of Public Works 11 South Main Street Pittsford, New York 14534

Permit # S19-000001

Phone: 585-248-6250 FAX: 585-248-6262

DESIGN REVIEW AND HISTORIC PRESERVATION BOARD REFERRAL OF APPLICATION

Property Address: 3350 Monroe Avenue ROCHESTER, NY 14618

Tax ID Number: 150.16-2-1

Zoning District: C Commercial

Owner: Graceland Properties LLC

Applicant: Sign & Lighting Services LLC

Application Type:


- Residential Design Review
 - §185-205 (B)
- Commercial Design Review
 - §185-205 (B)
- Signage
 - §185-205 (C)
- Certificate of Appropriateness
- §185-197
- Landmark Designation
 - §185-195 (2)
- Informal Review

- Build to Line Adjustment
 - §185-17 (B) (2)
- Building Height Above 30 Feet
 - §185-17 (M)
- Corner Lot Orientation
 - §185-17 (K) (3)
- Flag Lot Building Line Location
 - §185-17 (L) (1) (c)
- Undeveloped Flag Lot Requirements
 - §185-17 (L) (2)

Project Description: Applicant is requesting design review for a business identification sign. The sign will be approximately 62.6 Sq. Ft. and will be for identifying the "Good Will Outlet".

Meeting Date: January 10, 2019

RN Residential Neighborhood Zoning

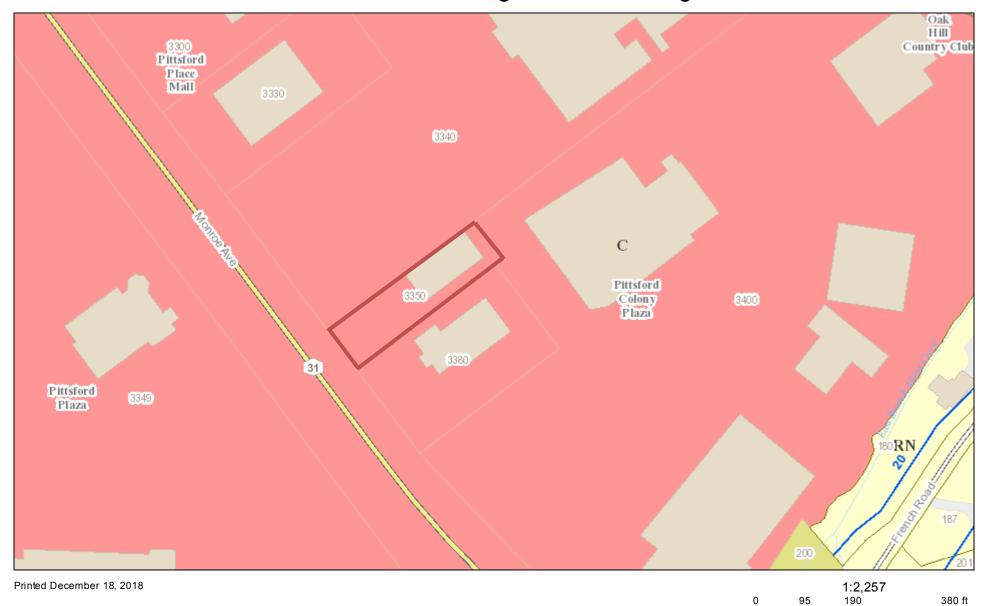

Town of Pittsford GIS


95

50

25

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100 m



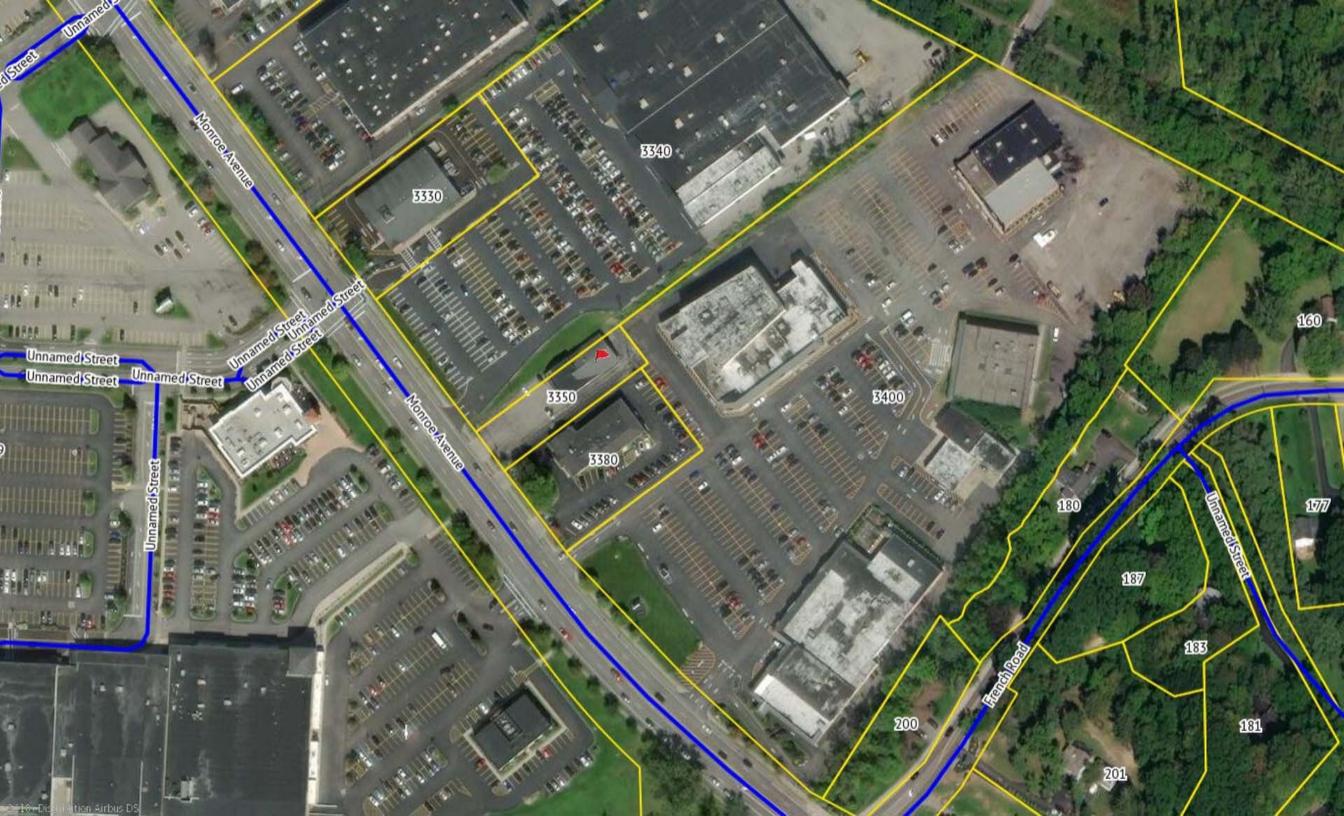



SIGN & LIGHTING SERVICES LLC

P.O. Box 597, Ontario, NY 14519

Phone: (585)265-4462 Fax: (585)265-4473



Customer: Goodwill Pittsford	Salesman: Kirk Wright	I have reviewed the attached drawings and authorize production as shown. I understand that any changes made before, during, or after production			
Project Name: Goodwill Pittsford	File: Goodwill Pittsford rev 1 dimensions proof	will alter the price as quoted. I accept that any changes will be in writing and approved before additional work is completed.			
Contact:	Date Prepared: 11/26/2018	and approved before additional work is completed.			
Address:	Remarks:	Signature			
City-State:		Date			
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SIGN & LIGHTING SERVICES LLC

P.O. Box 597, Ontario, NY 14519 Phone: (585)265-4462 Fax: (585)265-4473



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