

Design Review & Historic Preservation Board
Agenda
October 13, 2022

HISTORIC PRESERVATION DISCUSSION

BUILDING INSPECTOR REMARKS

APPLICATION FOR A CERTIFICATE OF APPROPRIATENESS

- **465 Marsh Road**
The Applicant is requesting a Certificate of Appropriateness, pursuant to Code Section 185-196, for renovations as well as demolition and rebuild of side structure. This property is zoned (RN) Residential Neighborhood and is designated historic.

RESIDENTIAL APPLICATION FOR REVIEW

- **289 Tobin Road**
The Applicant is requesting design review for the construction of a 1440 SF oversized over height accessory structure/Garage.
- **38 Old Farm Circle**
The Applicant is requesting design review for the construction of a 180 SF pool pavilion.
- **4035 East Avenue**
The Applicant is requesting design review for a 224 SF front porch encroaching into the front setback.
- **31 Falcon Trail**
The Applicant is requesting design review for a 224SF unconditioned addition to rear of garage.
- **25 Whitestone Lane**
The Applicant is requesting design review for the removal of the side entry to add 42 SF of pantry space to the kitchen.
- **4035 East Avenue**
The Applicant is requesting design review for a 224 SF front porch encroaching into the front setback.

RESIDENTIAL APPLICATION FOR REVIEW – NEW HOMES

- **19 High Street**
The Applicant is requesting design review for the construction of a one story single family home. The home will be approximately 2070 square feet including the garage.
- **45 & 47 Skylight Trail**
The Applicant is requesting design review for the proposed construction of a new town home dwelling. The proposed building will consist of 2 attached single family dwellings sharing a common wall. Lot 26 (47 Skylight Trail) will be approximately 2023 sq. ft. and Lot 25 (45 Skylight Trail) will be 2010 sq. ft. The town homes will be located in the new Alpine Ridge development.

Design Review and Historic Preservation Board
Minutes
September 22, 2022

PRESENT

Dirk Schneider, Chairman, David Wigg, Vice Chairman; Jim Vekasy, Bonnie Salem

ALSO PRESENT

Robert Koegel, Town Attorney; Anthony Caruso, Building Inspector; Susan Donnelly, Secretary to the Board

ABSENT

Kathleen Cristman, John Mitchell, Paul Whitbeck

HISTORIC PRESERVATION DISCUSSION

Bonnie Salem reviewed with the Board her meeting with the Town communications director, Shelley O'Brien. They defined the purpose of the project as increasing the awareness of historic properties in the Town of Pittsford through the Town website. Ideas are being formulated regarding the use of maps and an interactive website to highlight these properties. Bonnie indicated she will continue to work with Shelley to develop a plan.

Dirk Schneider alerted Town staff to developments concerning the removal of siding at the Wright Home at Kilbourn Place. Anthony Caruso will follow up with Riedman to discuss their plans.

RESIDENTIAL APPLICATION FOR REVIEW - RETURNING

• **4 San Rafael Drive**

The Applicant is requesting design review for the construction of a new single-family home. The home will be approximately 6703 SF of livable space and will be located on a vacant lot in the San Rafael Drive neighborhood.

Dominick Caroselli, architect for the project, was present.

Mr. Caroselli showed the Board previous plans and discussed the reasoning for adding the third bay garage. A second dormer will be added to the left elevation. He indicated that no materials have changed.

David Wigg moved to accept as submitted provided the flashing be a copper material or concealed.

Dirk Schneider seconded.

All Ayes.

RESIDENTIAL APPLICATION FOR REVIEW

• **25 Trotters Field Run**

The Applicant is requesting design review for the construction of an approximately 154 SF screen room addition off the front of the house.

Scott Ingerick from Patio Solutions was present. The posts will be the same size as the porch, 6 x 6 wrapped with the same detailing. The roof shingles will all match and be carried across the roofing on the front elevation. Two French doors will allow access into the home through the living room. The porch will have white framing with black mesh.

Bonnie Salem moved to accept the application as submitted.

Dave Wigg seconded.

All Ayes.

- **27 Whitestone Lane**

The Applicant is requesting design review for an approximate 70 SF covered porch over the front main entry of the home.

The homeowner, Patrick Coakley, was present.

The porch will be a pergola style over the front door. It will feature fiber wrapped posts. The walkway will be reconstructed.

The Board suggested the applicant consider which shape columns will work best with the home but overall felt this is a good improvement to the home.

David Wigg moved to accept the application as submitted.

Dirk Schneider seconded.

All Ayes.

RESIDENTIAL APPLICATION FOR REVIEW – NEW HOMES

- **7 Black Wood Circle**

The Applicant is requesting design review for the construction of a one-story single-family home. The home will be approximately 2013 SF and will be located in the Wilshire Hills Subdivision.

Jim Barbato of Pride Mark Homes was present.

He indicated this design is consistent with other homes in the Wilshire development.

The Board discussed the stone water table embellishment on the front elevation should be wrapped to the side elevations.

Dirk Schneider moved to approve the application as submitted.

Jim Vekasy seconded.

All Ayes.

- **3 Stable View**

The Applicant is requesting design review for the construction of a two-story single-family home. The home will be approximately 3256 SF.

George Masi of Mascot Builders was present.

The Board discussed their concerns regarding the multiple textures of materials proposed. It was determined to be acceptable if the color is consistent.

The Board was also concerned about the lack of a corner board or stone return for the stone trim on the front elevation.

Dirk Schneider moved to accept the application as submitted with the condition that a corner board be added to the left of the front elevation and the half post at the porch on the garage side and return the cultured stone at the garage on both sides of the return with the recommendation that the colors of the materials be in the same color family.

Bonnie Salem seconded.

All Ayes.

- **45 & 47 Skylight Trail**

The Applicant is requesting design review for the proposed construction of a new town home dwelling. The proposed building will consist of 2 attached single family dwellings sharing a common wall. Lot 26 (47 Skylight Trail) will be approximately 2023 SF. and Lot 25 (45 Skylight Trail) will be SF. The town homes will be in the Alpine Ridge development.

This application was removed from the agenda at the request of the Applicant.

COMMERCIAL APPLICATION FOR REVIEW – SIGNAGE

- **3660 Monroe Avenue**

The Applicant is requesting design review to replace existing a ground sign with a new 25 SF sign that is same size and same setback as existing sign.

Frank Cleere from Skylight Signs was present.

Mr. Cleere indicated the sign is being updated in response to a change in ownership. The sign will have an aluminum finish and illuminated internal lit letters.

There was question as to whether Town Code allows for the illumination of the channel lit letters in this area of Monroe Avenue.

Dirk Schneider moved to approve the design of the sign with the condition that the Town Code allows the illumination as proposed.

David Wigg seconded.

All Ayes.

DISCUSSION

David Wigg opened discussion regarding observations on siding materials at a development in Town. Town staff will look into this and report back to the Board.

REVIEW OF MINUTES OF SEPTEMBER 8, 2022, MEETING

Bonnie Salem moved to accept the minutes of the September 8, 2022, meeting as written.

David Wigg seconded.

All Ayes.

ADJOURNMENT


Dirk Schneider moved to close the meeting at 7:05 pm.

All Ayes.

Respectfully submitted,

Susan Donnelly
Secretary to the Design Review and Historic Preservation Board

DRAFT

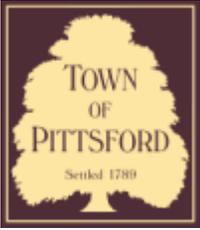

Town of Pittsford

Department of Public Works
11 South Main Street
Pittsford, New York 14534

Permit #
CA22-000004

Phone: 585-248-6250
FAX: 585-248-6262

DESIGN REVIEW AND HISTORIC PRESERVATION BOARD REFERRAL OF APPLICATION

Property Address: 465 Marsh Road PITTSFORD, NY 14534

Tax ID Number: 164.12-1-4

Zoning District: RN Residential Neighborhood

Owner: Robert Marshall


Applicant: Robert Marshall

Application Type:

- | | |
|--|---|
| <input type="checkbox"/> Residential Design Review
§185-205 (B) | <input type="checkbox"/> Build to Line Adjustment
§185-17 (B) (2) |
| <input type="checkbox"/> Commercial Design Review
§185-205 (B) | <input type="checkbox"/> Building Height Above 30 Feet
§185-17 (M) |
| <input type="checkbox"/> Signage
§185-205 (C) | <input type="checkbox"/> Corner Lot Orientation
§185-17 (K) (3) |
| <input checked="" type="checkbox"/> Certificate of Appropriateness
§185-197 | <input type="checkbox"/> Flag Lot Building Line Location
§185-17 (L) (1) (c) |
| <input type="checkbox"/> Landmark Designation
§185-195 (2) | <input type="checkbox"/> Undeveloped Flag Lot Requirements
§185-17 (L) (2) |
| <input type="checkbox"/> Informal Review | |

Project Description: Applicant is requesting a Certificate of Appropriateness, pursuant to Code Section 185-196, for renovations as well as demolition and rebuild of side structure. This property is zoned (RN) Residential Neighborhood and is designated historic.

Meeting Date: October 13, 2022

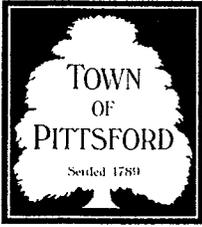

TOWN OF PITTSFORD

Design Review & Historic Preservation Board

Application for Certificate of Appropriateness

Case # _____

1. Property Address: 465 MARSH ROAD

2. Tax Account Number: _____

3. Applicant's Name: ROBERT J. MARSHALL

Address: 225 PINE VALLEY DRIVE Phone: 585-259-9796

ROCHESTER NY 14626
City State Zip Code

E-mail: INVEST@ROCHESTER
@YAHOO.COM

4. Applicant's Interest in Property:

Owner: Lessee: Holding Purchase Offer:

Other (explain): _____

5. Owner (if other than above): _____

Address: _____ Phone: _____
Street

_____ E-mail: _____
City State Zip Code

Has the Owner been contacted by the Applicant? Yes No

6. Application prepared by: ADDLETT

Address: _____ Phone: _____
Street

_____ E-mail: _____
City State Zip Code

7. Project Design Professional (if Available): _____

Address: _____ Phone: _____
Street

_____ E-mail: _____
City State Zip Code

B. Describe all significant site improvements proposed with this project (include proposed changes in landscaping, significant plant material alterations, and other improvements associated with hardscape materials such as driveways and retaining walls; attach additional sheets if necessary):

- Front stoop to be removed, front and side entries to have 60" wide x 42" deep concrete stoops.
- Driveway to have black asphalt millings graded smooth with matching paths/sidewalks to entry stoops at front and side doors.
- Stone bordered planting area to be reclaimed, built up to grade level, mulched river rock stone, planted with wild flowers found at north section of property.
- Grade around entire house to be brought up and pitched away from house with topsoil and lawn.


15. If the structure is a Commercial Property open to the Public, please describe all interior improvements proposed at the project site (attach additional sheets if necessary).

16. Additional materials submitted with this application (if available):

- | | |
|---|---|
| <input checked="" type="checkbox"/> Parcel map | <input type="checkbox"/> Architectural elevations |
| <input checked="" type="checkbox"/> Photographs | <input type="checkbox"/> Architectural plans |
| <input type="checkbox"/> Other materials | |
-

Applicant Certification:

I certify to the best of my knowledge that the information supplied on this application is complete and accurate.

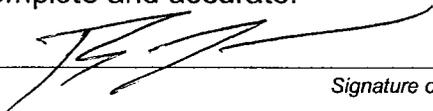

Signature of applicant


9/22/2022
Date






Owner Consent:



If the applicant is other than the owner, does the owner concur with this application?





Yes No

If Yes, owner's signature: _____

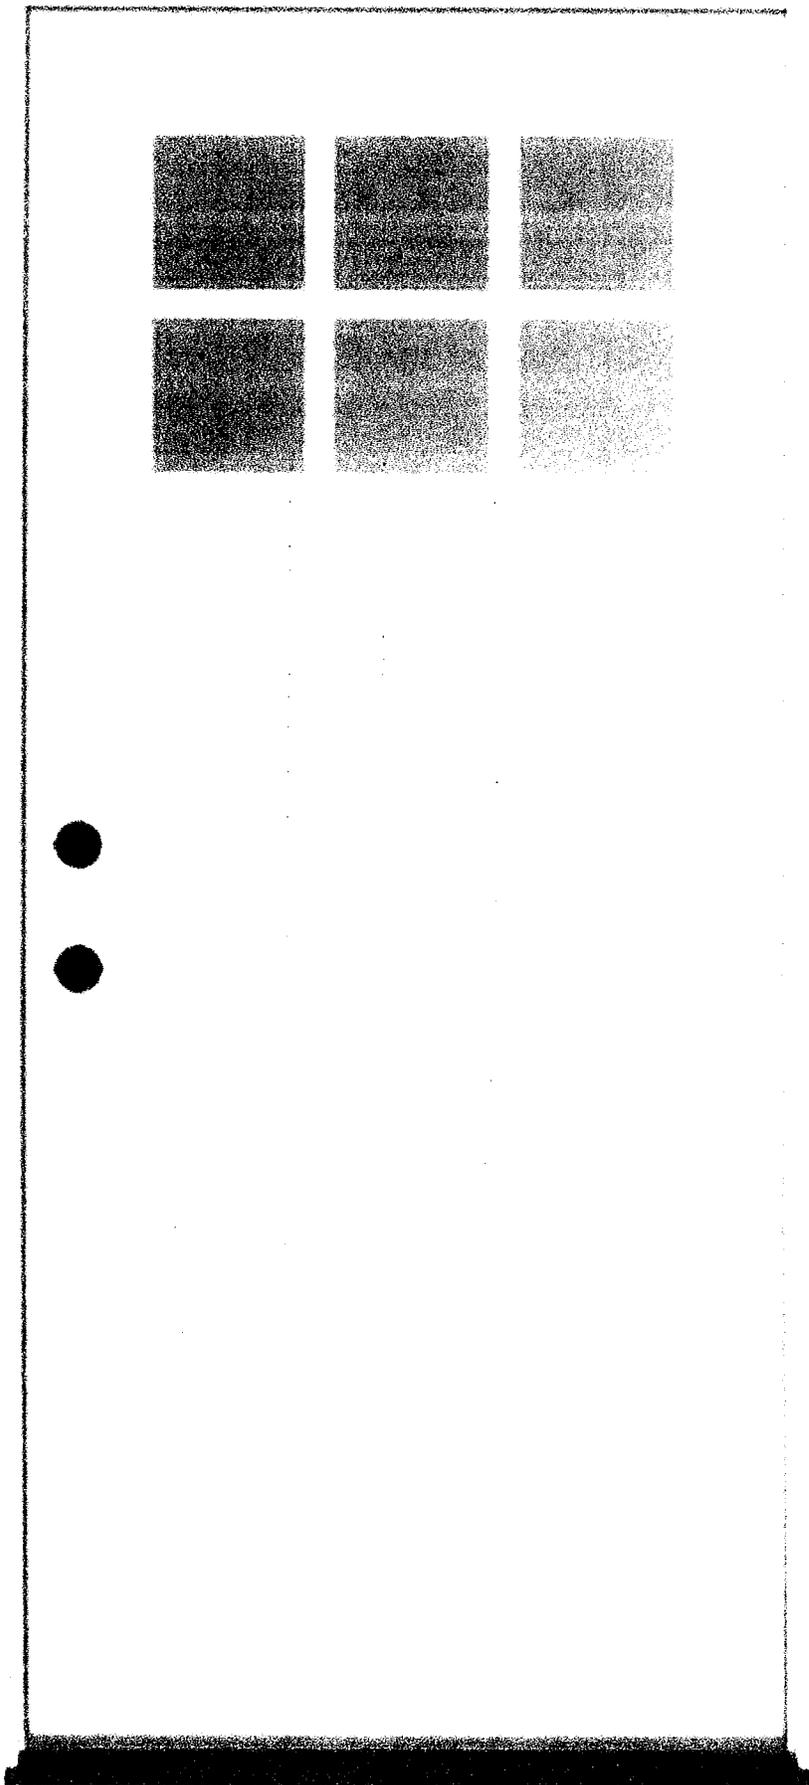

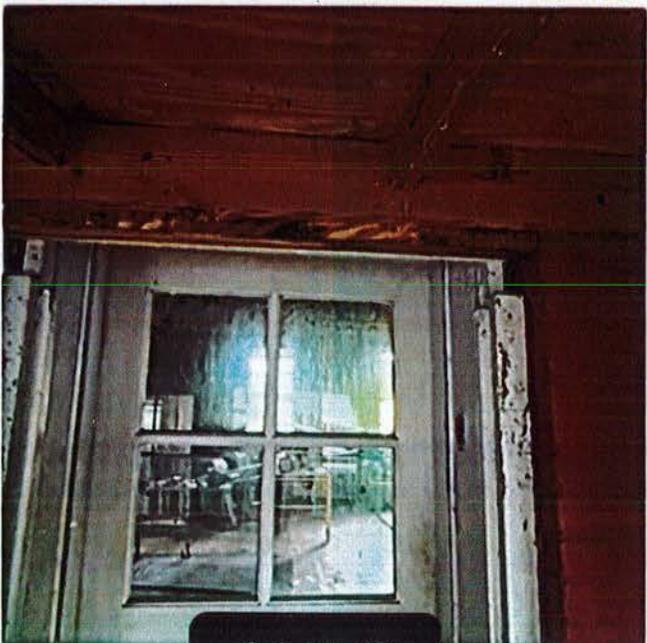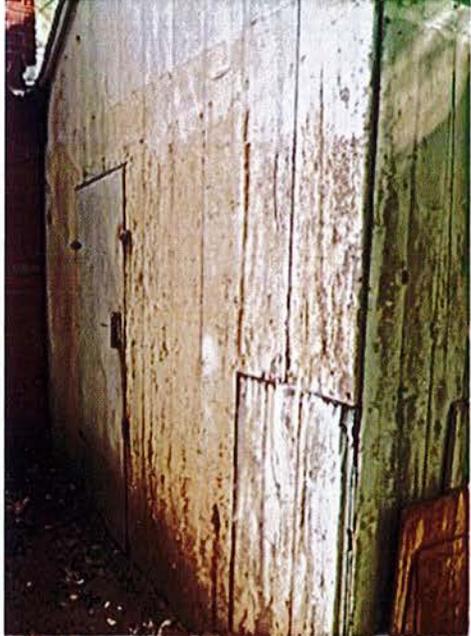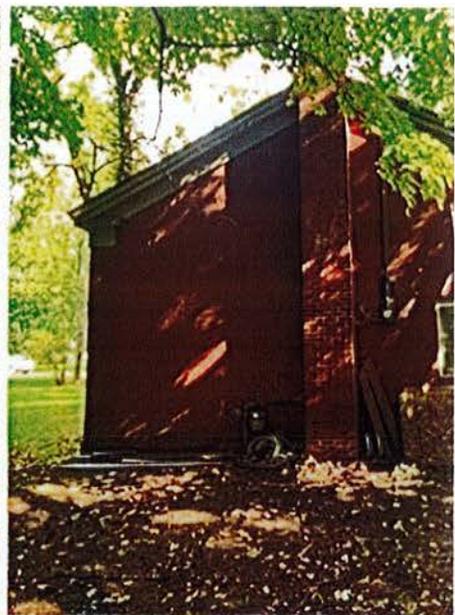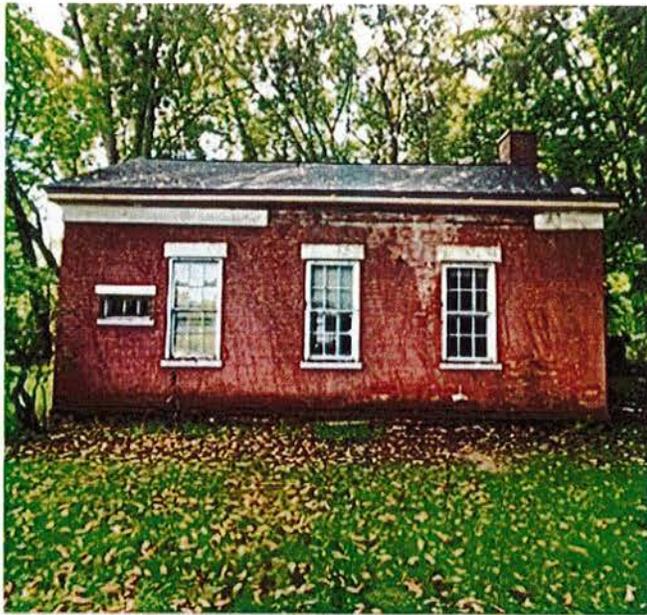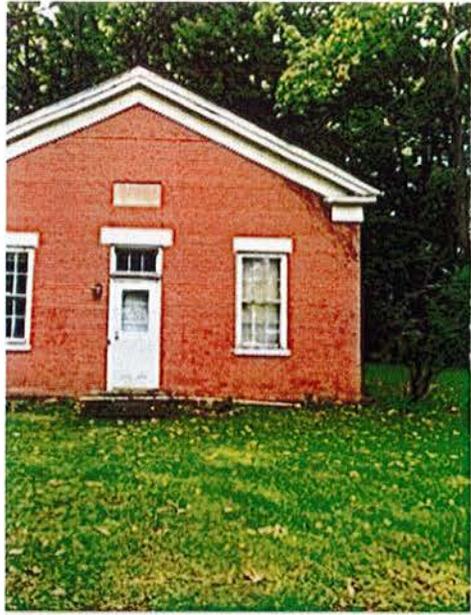

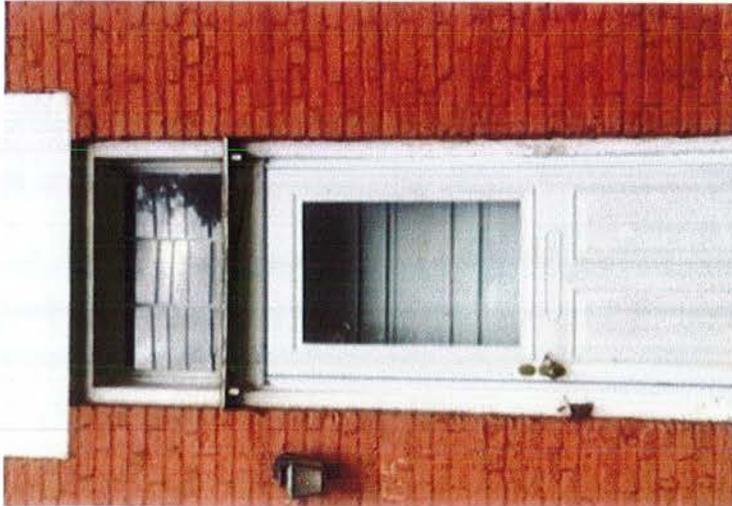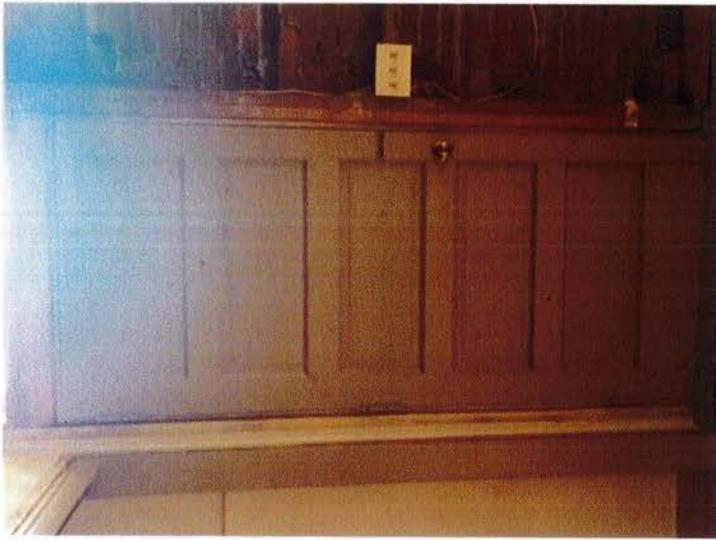

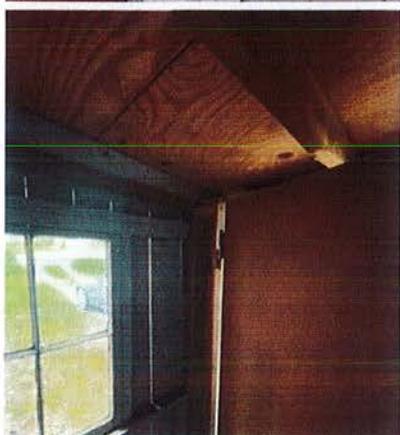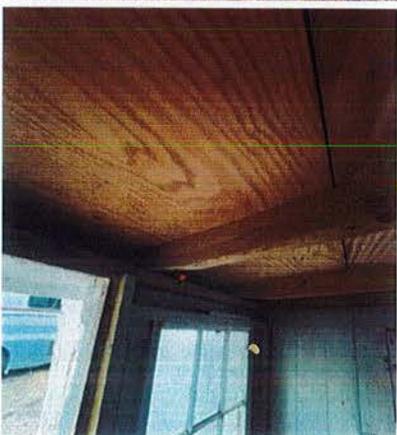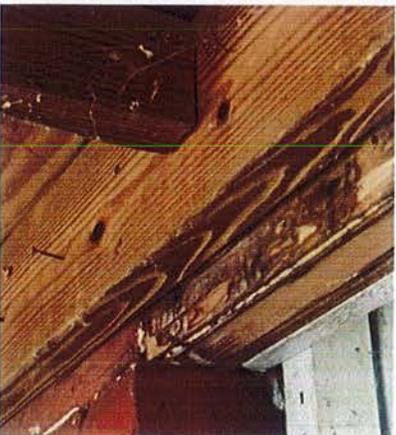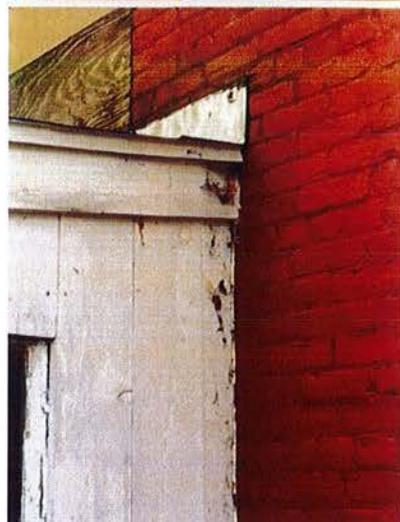

1. The first part of the document discusses the importance of maintaining accurate records of all transactions. It emphasizes that this is crucial for ensuring the integrity of the financial statements and for providing a clear audit trail. The text notes that any discrepancies or errors in the records can lead to significant complications during an audit and may result in the disallowance of certain expenses.

2. The second part of the document addresses the issue of proper documentation. It states that all receipts and invoices must be properly filed and indexed. This not only helps in the organization of the records but also facilitates the retrieval of information when needed. The document further explains that the lack of proper documentation can be a major red flag for auditors and may lead to the questioning of the validity of the underlying transactions.

3. The third part of the document focuses on the importance of timely reporting. It highlights that delays in reporting can obscure potential issues and make it more difficult to identify and correct errors. The text stresses that regular and timely reporting is essential for maintaining the accuracy and reliability of the financial information provided to management and other stakeholders.




4. The fourth part of the document discusses the role of internal controls in preventing errors and fraud. It explains that a strong system of internal controls is necessary to ensure that all transactions are properly authorized, recorded, and reviewed. The document notes that internal controls also help in the identification and correction of errors before they become significant. Furthermore, it states that a robust internal control system is a key indicator of the reliability of the financial reporting process.

5. The fifth part of the document addresses the importance of transparency and communication. It emphasizes that all parties involved in the financial reporting process should be kept informed of any changes or developments. This includes management, the audit committee, and external auditors. The text notes that transparency is essential for building trust and for ensuring that the financial reporting process is fair and equitable.

6. The sixth part of the document discusses the importance of staying up-to-date on changes in accounting standards and regulations. It explains that the accounting profession is constantly evolving, and it is essential for organizations to stay current on the latest developments. The document notes that failure to comply with the latest standards and regulations can result in the disallowance of certain expenses and may lead to the issuance of a qualified or adverse audit opinion.

7. The seventh part of the document focuses on the importance of maintaining a professional attitude. It states that all individuals involved in the financial reporting process should adhere to the highest standards of professional conduct. This includes being honest, objective, and impartial. The document notes that a professional attitude is essential for ensuring the integrity and reliability of the financial reporting process.

8. The eighth part of the document discusses the importance of maintaining accurate records of all transactions. It emphasizes that this is crucial for ensuring the integrity of the financial statements and for providing a clear audit trail. The text notes that any discrepancies or errors in the records can lead to significant complications during an audit and may result in the disallowance of certain expenses.

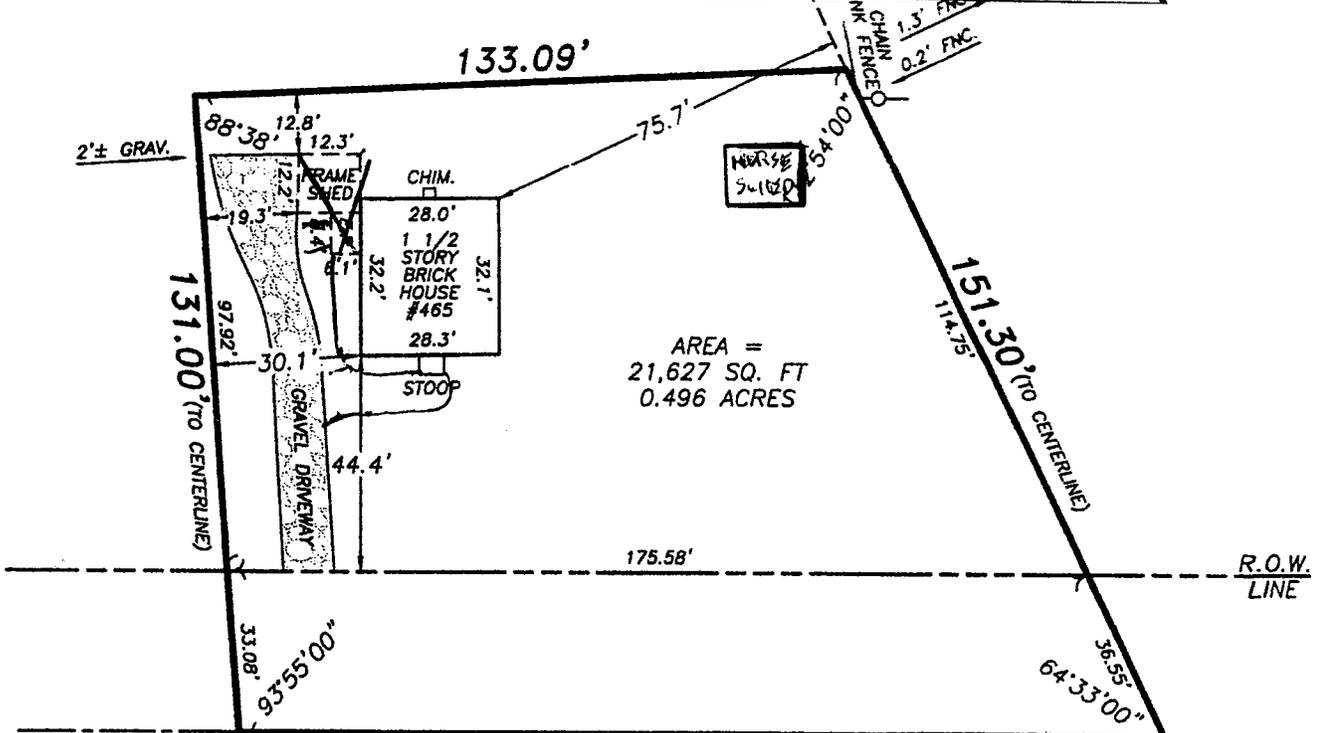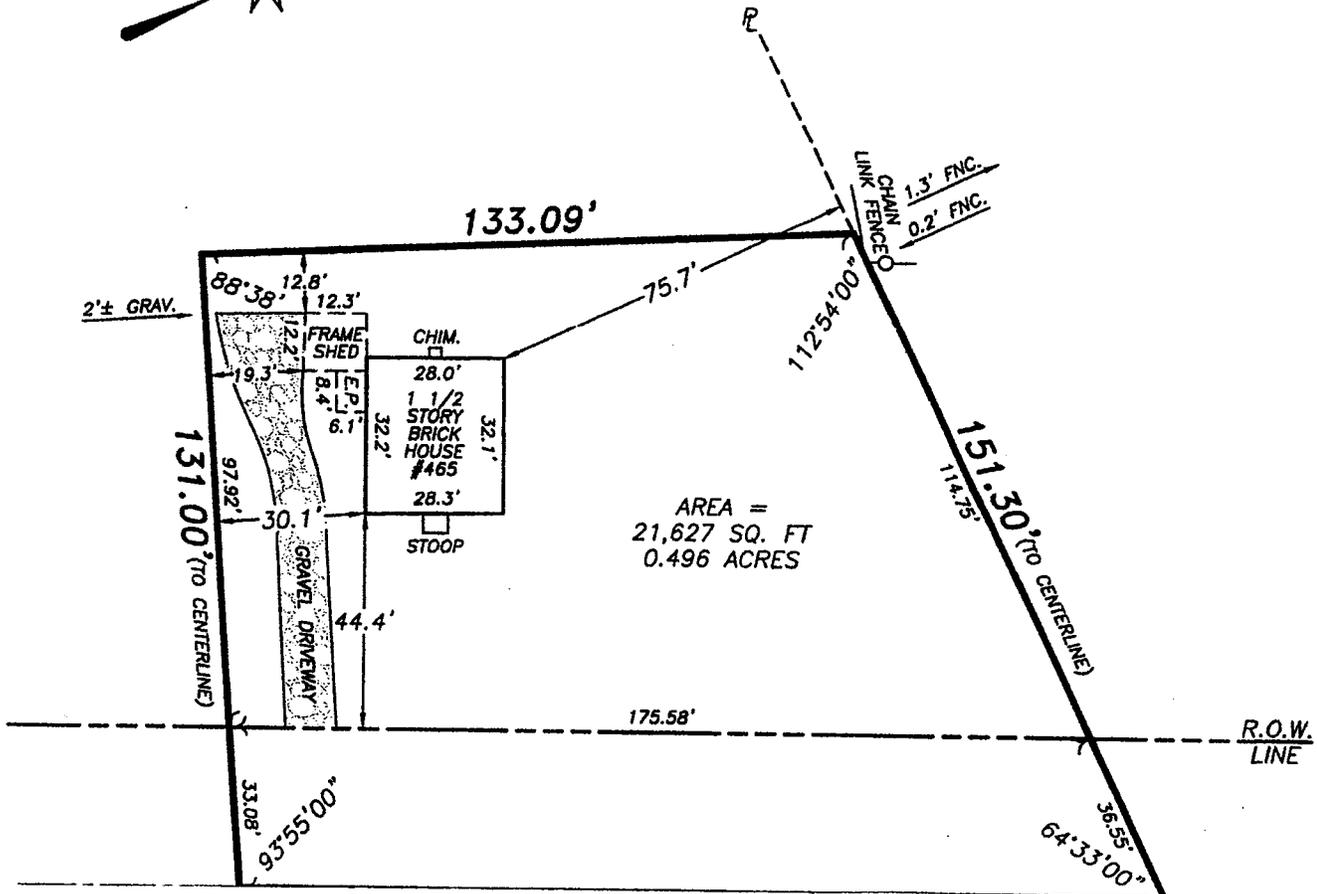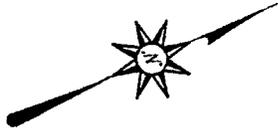

618.3' TO THE
CENTERLINE OF
PITTSFORD -
PALMYRA ROAD

189.02'
(66' WIDE R.O.W.)
MARSH ROAD

CENTERLINE


**TOWN OF PITTSFORD
DESIGN REVIEW & HISTORIC PRESERVATION BOARD MEETING
LEGAL NOTICE**

Please take notice that the Town of Pittsford Design Review & Historic Preservation Board will hold the following Public Hearing on Thursday, October 13, 2022 in the Town Hall lower level meeting room, 11 South Main Street, beginning at 6:00 P.M. local time.

PUBLIC HEARING

- 465 Marsh Rd, Tax # 164.12-1-4 Applicant is requesting a Certificate of Appropriateness, pursuant to Code Section 185-196, for renovations as well as demolition and rebuild of side structure. This property is zoned (RN) Residential Neighborhood and is designated historic.

Anthony Caruso
Building Inspector

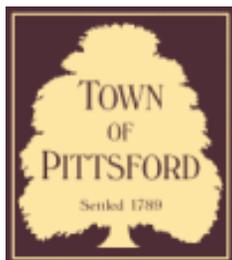

Town of Pittsford

Department of Public Works
11 South Main Street
Pittsford, New York 14534

Permit #
ZB22-000027

Phone: 585-248-6250

FAX: 585-248-6262

DESIGN REVIEW AND HISTORIC PRESERVATION BOARD REFERRAL OF APPLICATION

Property Address: 289 Tobin Road HENRIETTA, NY 14467

Tax ID Number: 190.04-3-1.1

Zoning District: RRSP Rural Residential South Pittsford

Owner: Driver, Robin

Applicant: Driver, Robin

Application Type:


- Residential Design Review §185-205 (B)
- Commercial Design Review §185-205 (B)
- Signage §185-205 (C)
- Certificate of Appropriateness §185-197
- Landmark Designation §185-195 (2)
- Informal Review
- Build to Line Adjustment §185-17 (B) (2)
- Building Height Above 30 Feet §185-17 (M)
- Corner Lot Orientation §185-17 (K) (3)
- Flag Lot Building Line Location §185-17 (L) (1) (c)
- Undeveloped Flag Lot Requirements §185-17 (L) (2)

Project Description: Applicant is requesting design review for the construction of a 1440 SF oversized overheight accessory structure/Garage.


Meeting Date: October 13, 2022



RN Residential Neighborhood Zoning

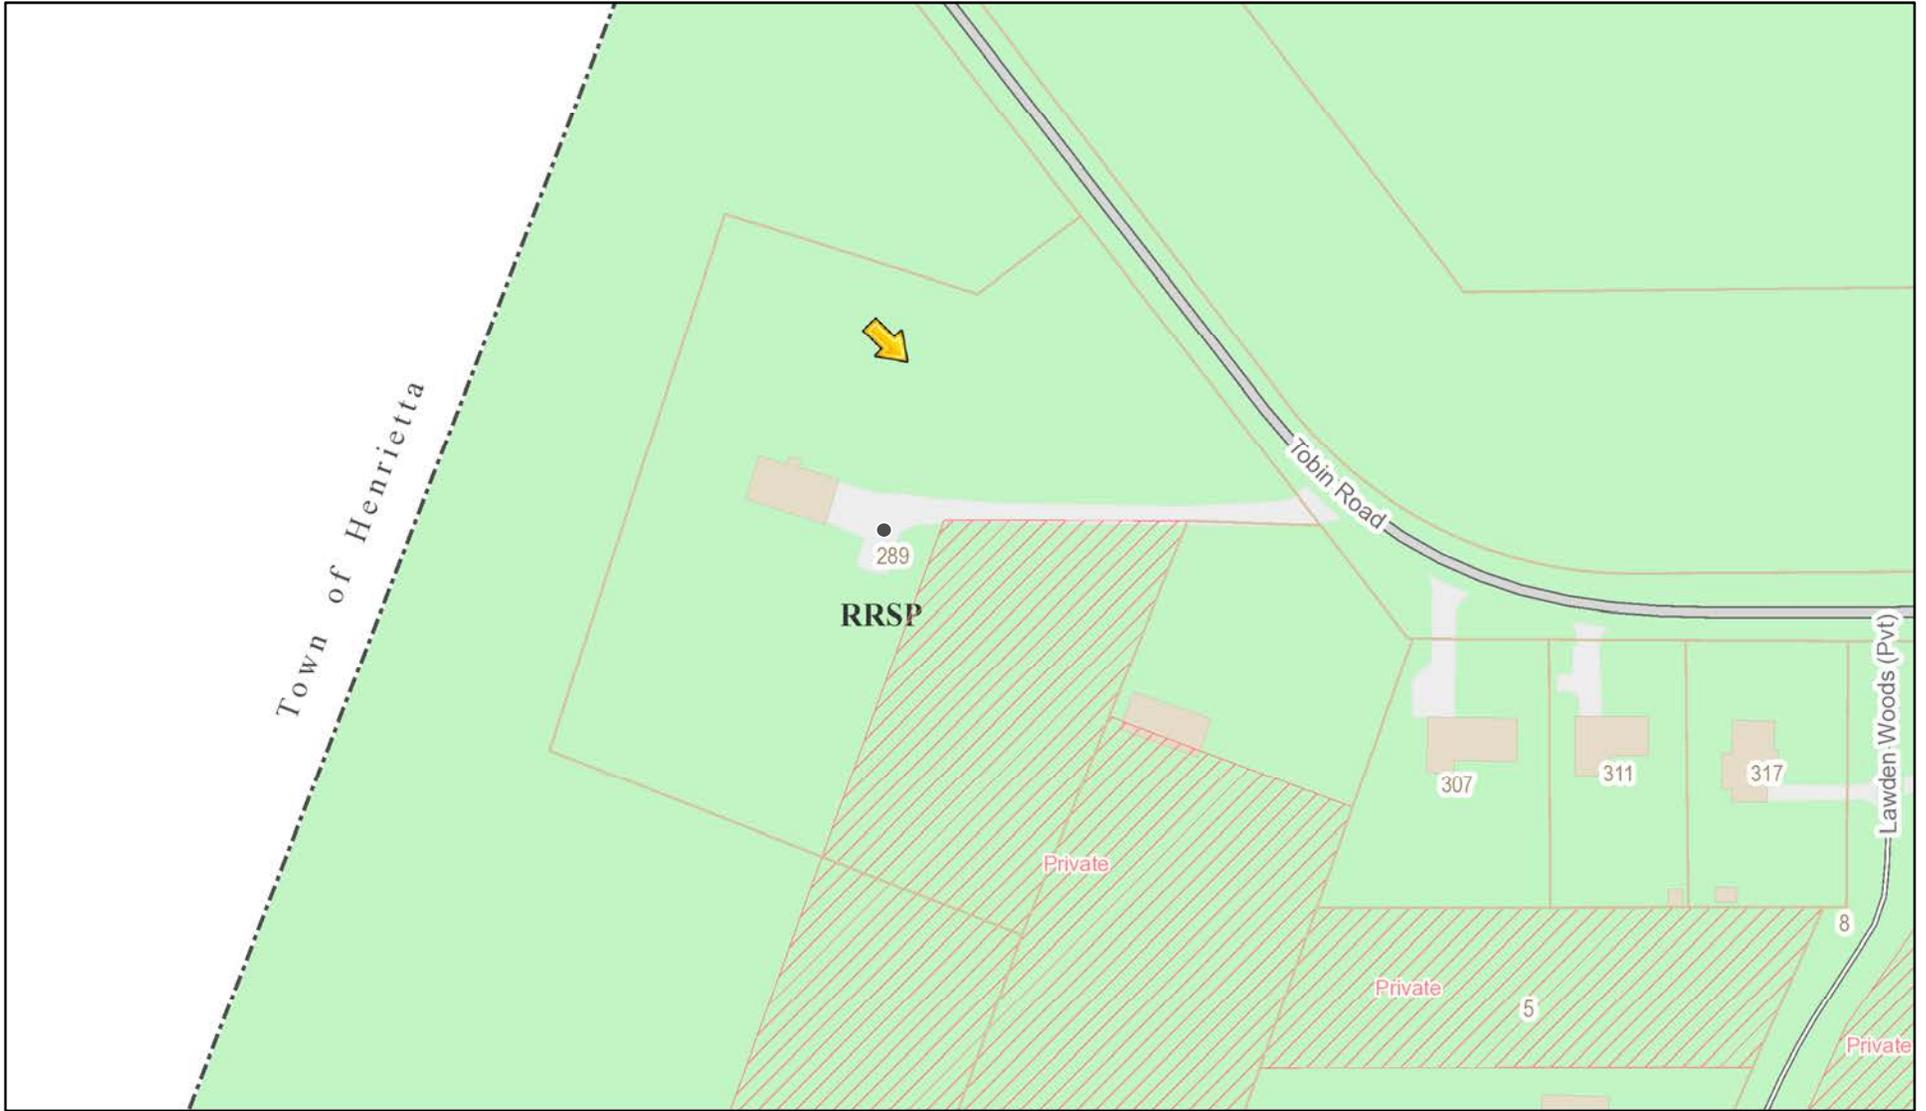

Printed October 4, 2022

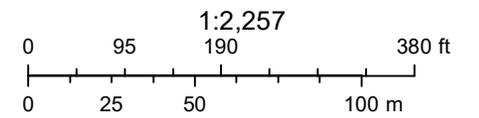

Town of Pittsford GIS

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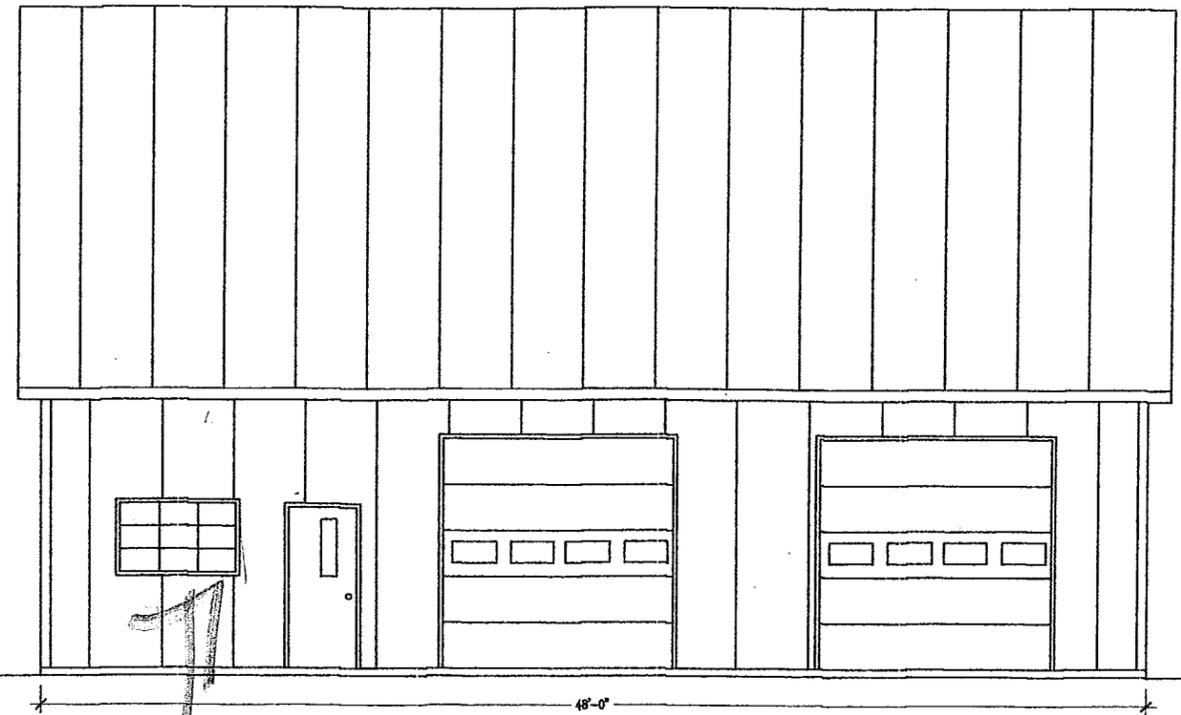
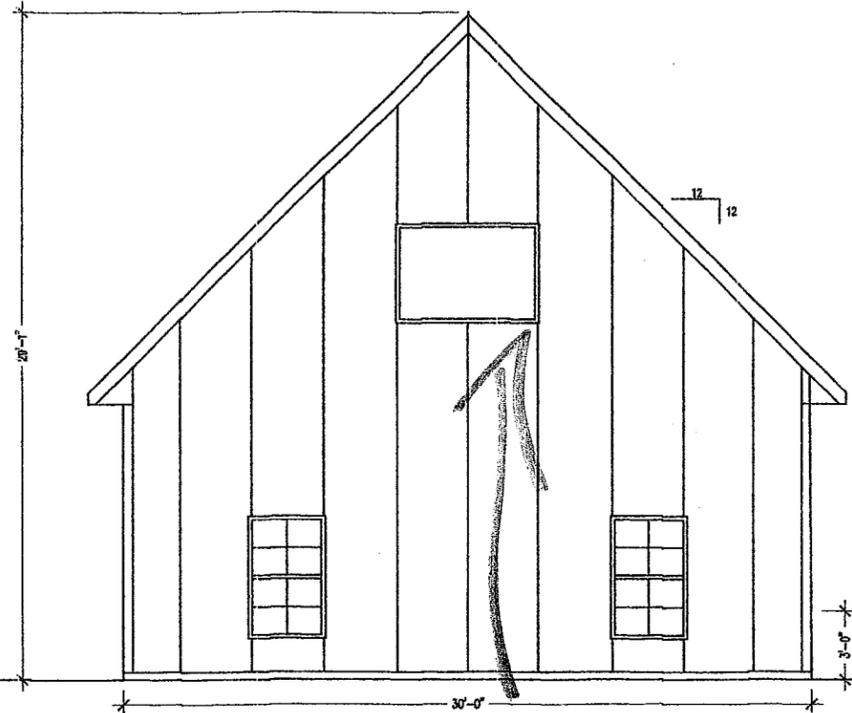


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289

307

©





Double Door



ELEVATIONS
NTS

MAS ENGINEERING
55 Ashley Street
Lyons, New York 14489
☎ 315-946-9552
Cell 315-573-0765

DATE:
24-Dec-18
SCALE:
As Noted

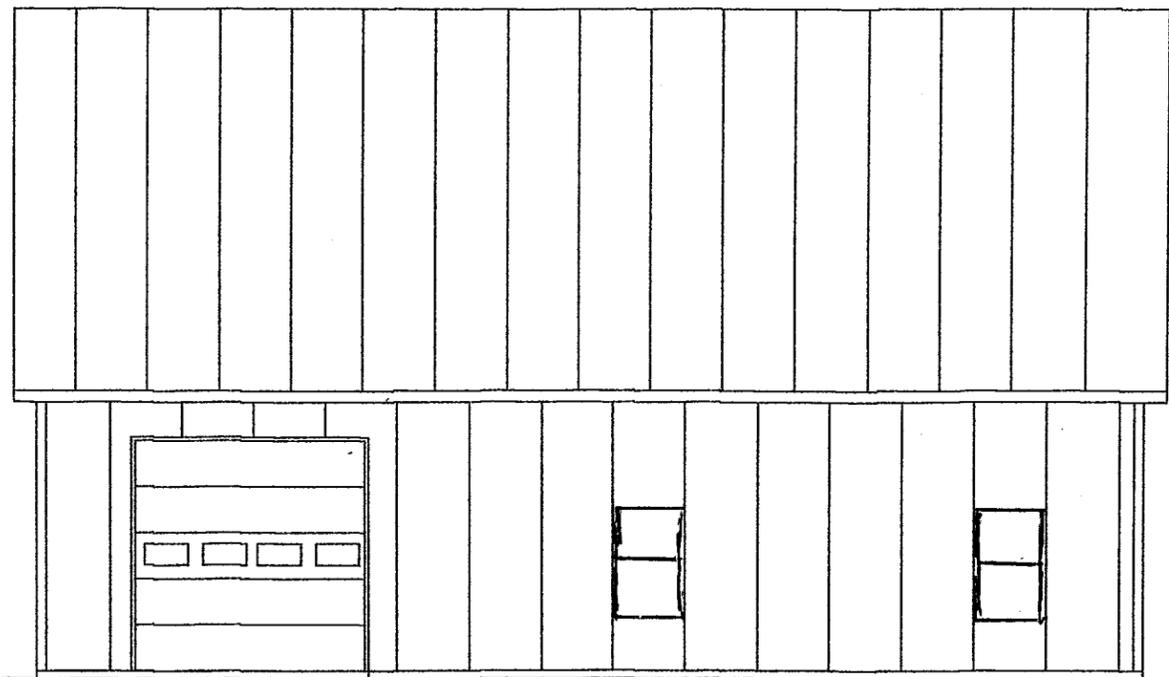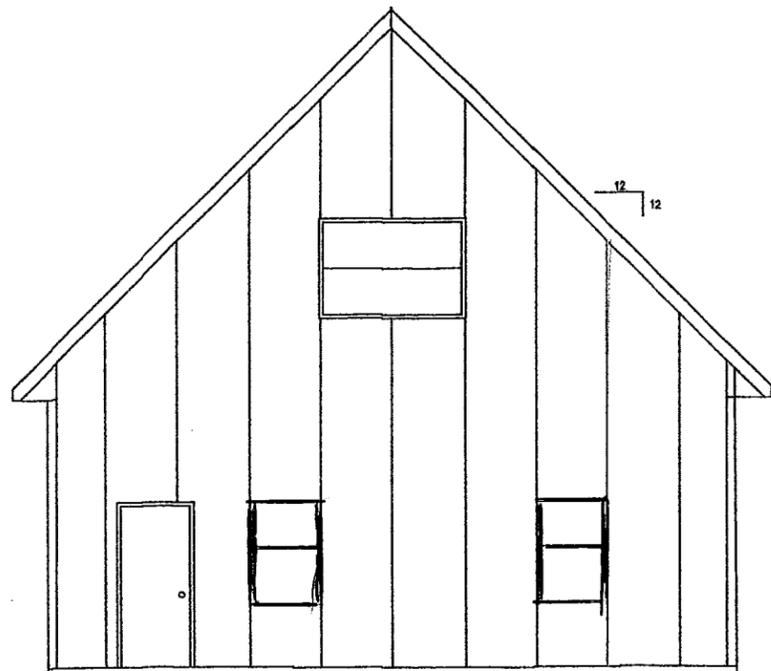

ELEVATIONS

NTS

MAS ENGINEERING
55 Ashley Street
Lyons, New York 14489
☎ 315-946-9552
Cell 315-573-0765

DATE:
24-Dec-18

SCALE:
As Noted












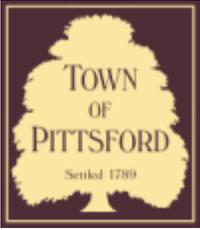

Town of Pittsford

Department of Public Works
11 South Main Street
Pittsford, New York 14534

Permit #
RA22-000221

Phone: 585-248-6250
FAX: 585-248-6262

DESIGN REVIEW AND HISTORIC PRESERVATION BOARD REFERRAL OF APPLICATION

Property Address: 38 Old Farm Circle PITTSFORD, NY 14534

Tax ID Number: 164.19-2-40

Zoning District: RN Residential Neighborhood

Owner: Madden, Lucas H

Applicant: ADS Renovations

Application Type:


- | | |
|---|---|
| <input checked="" type="checkbox"/> Residential Design Review
§185-205 (B) | <input type="checkbox"/> Build to Line Adjustment
§185-17 (B) (2) |
| <input type="checkbox"/> Commercial Design Review
§185-205 (B) | <input type="checkbox"/> Building Height Above 30 Feet
§185-17 (M) |
| <input type="checkbox"/> Signage
§185-205 (C) | <input type="checkbox"/> Corner Lot Orientation
§185-17 (K) (3) |
| <input type="checkbox"/> Certificate of Appropriateness
§185-197 | <input type="checkbox"/> Flag Lot Building Line Location
§185-17 (L) (1) (c) |
| <input type="checkbox"/> Landmark Designation
§185-195 (2) | <input type="checkbox"/> Undeveloped Flag Lot Requirements
§185-17 (L) (2) |
| <input type="checkbox"/> Informal Review | |

Project Description: Applicant is requesting design review for the construction of a 180 SF pool pavilion.


Meeting Date: October 13, 2022



RN Residential Neighborhood Zoning

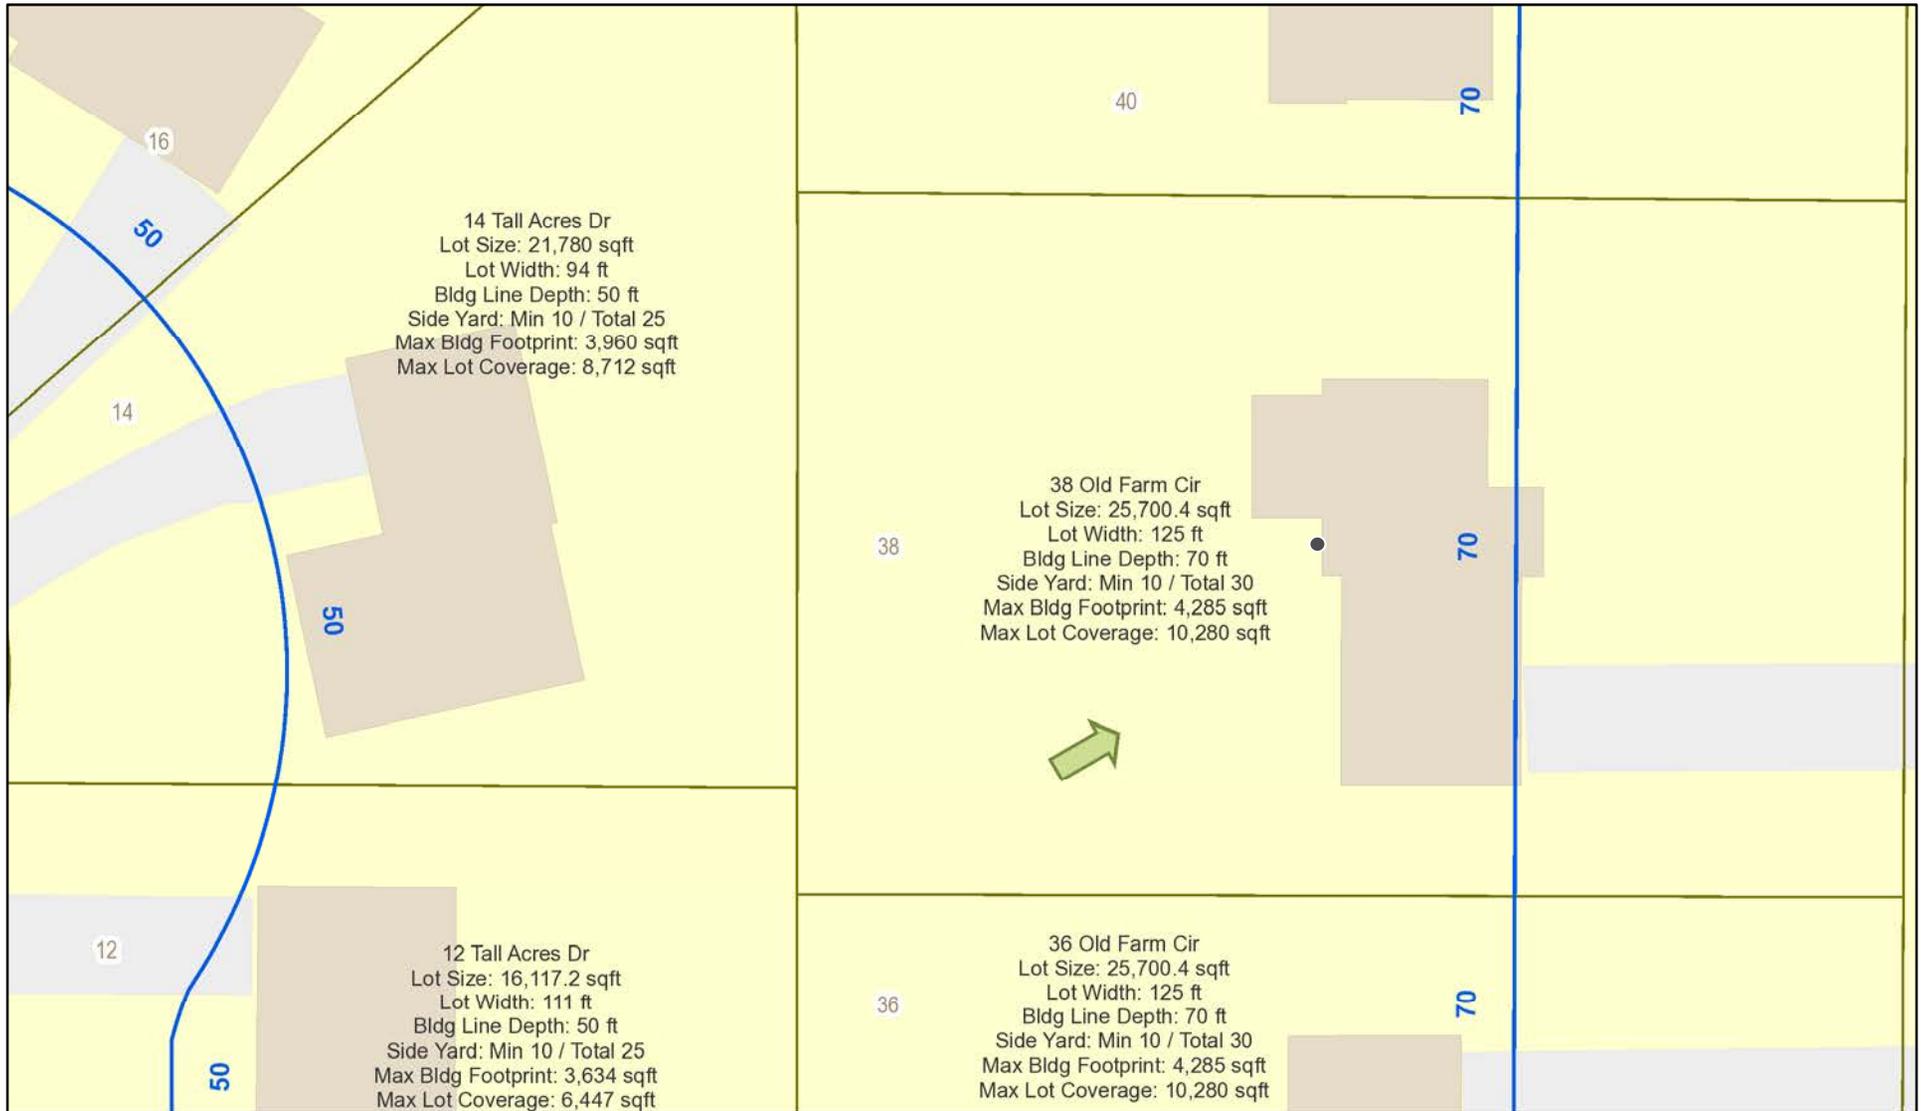


Printed October 4, 2022

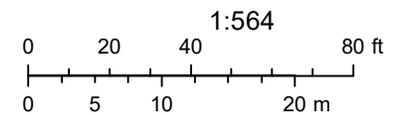

Town of Pittsford GIS

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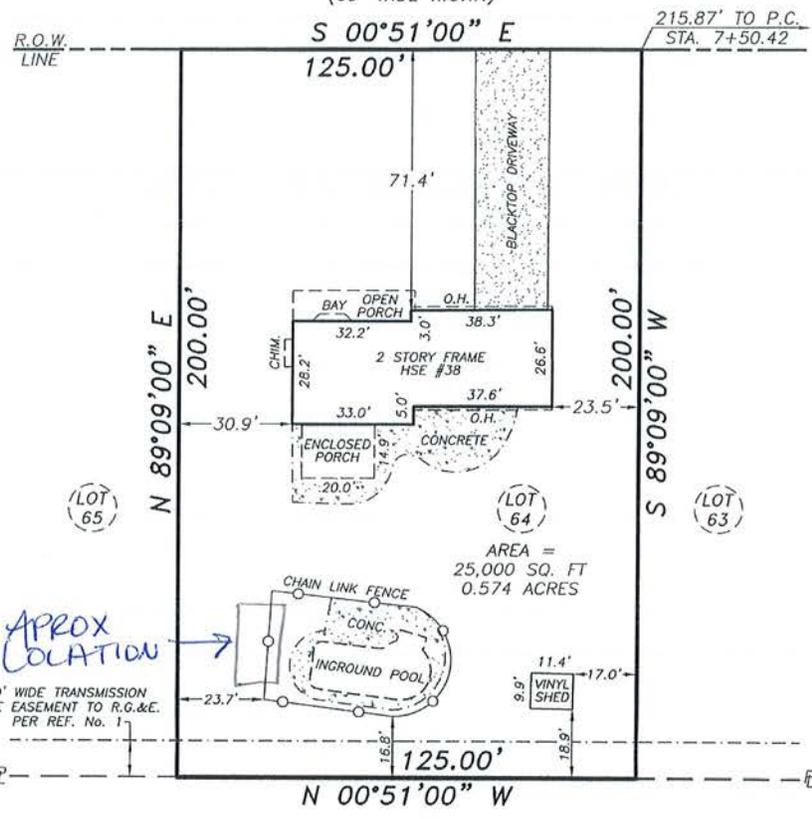


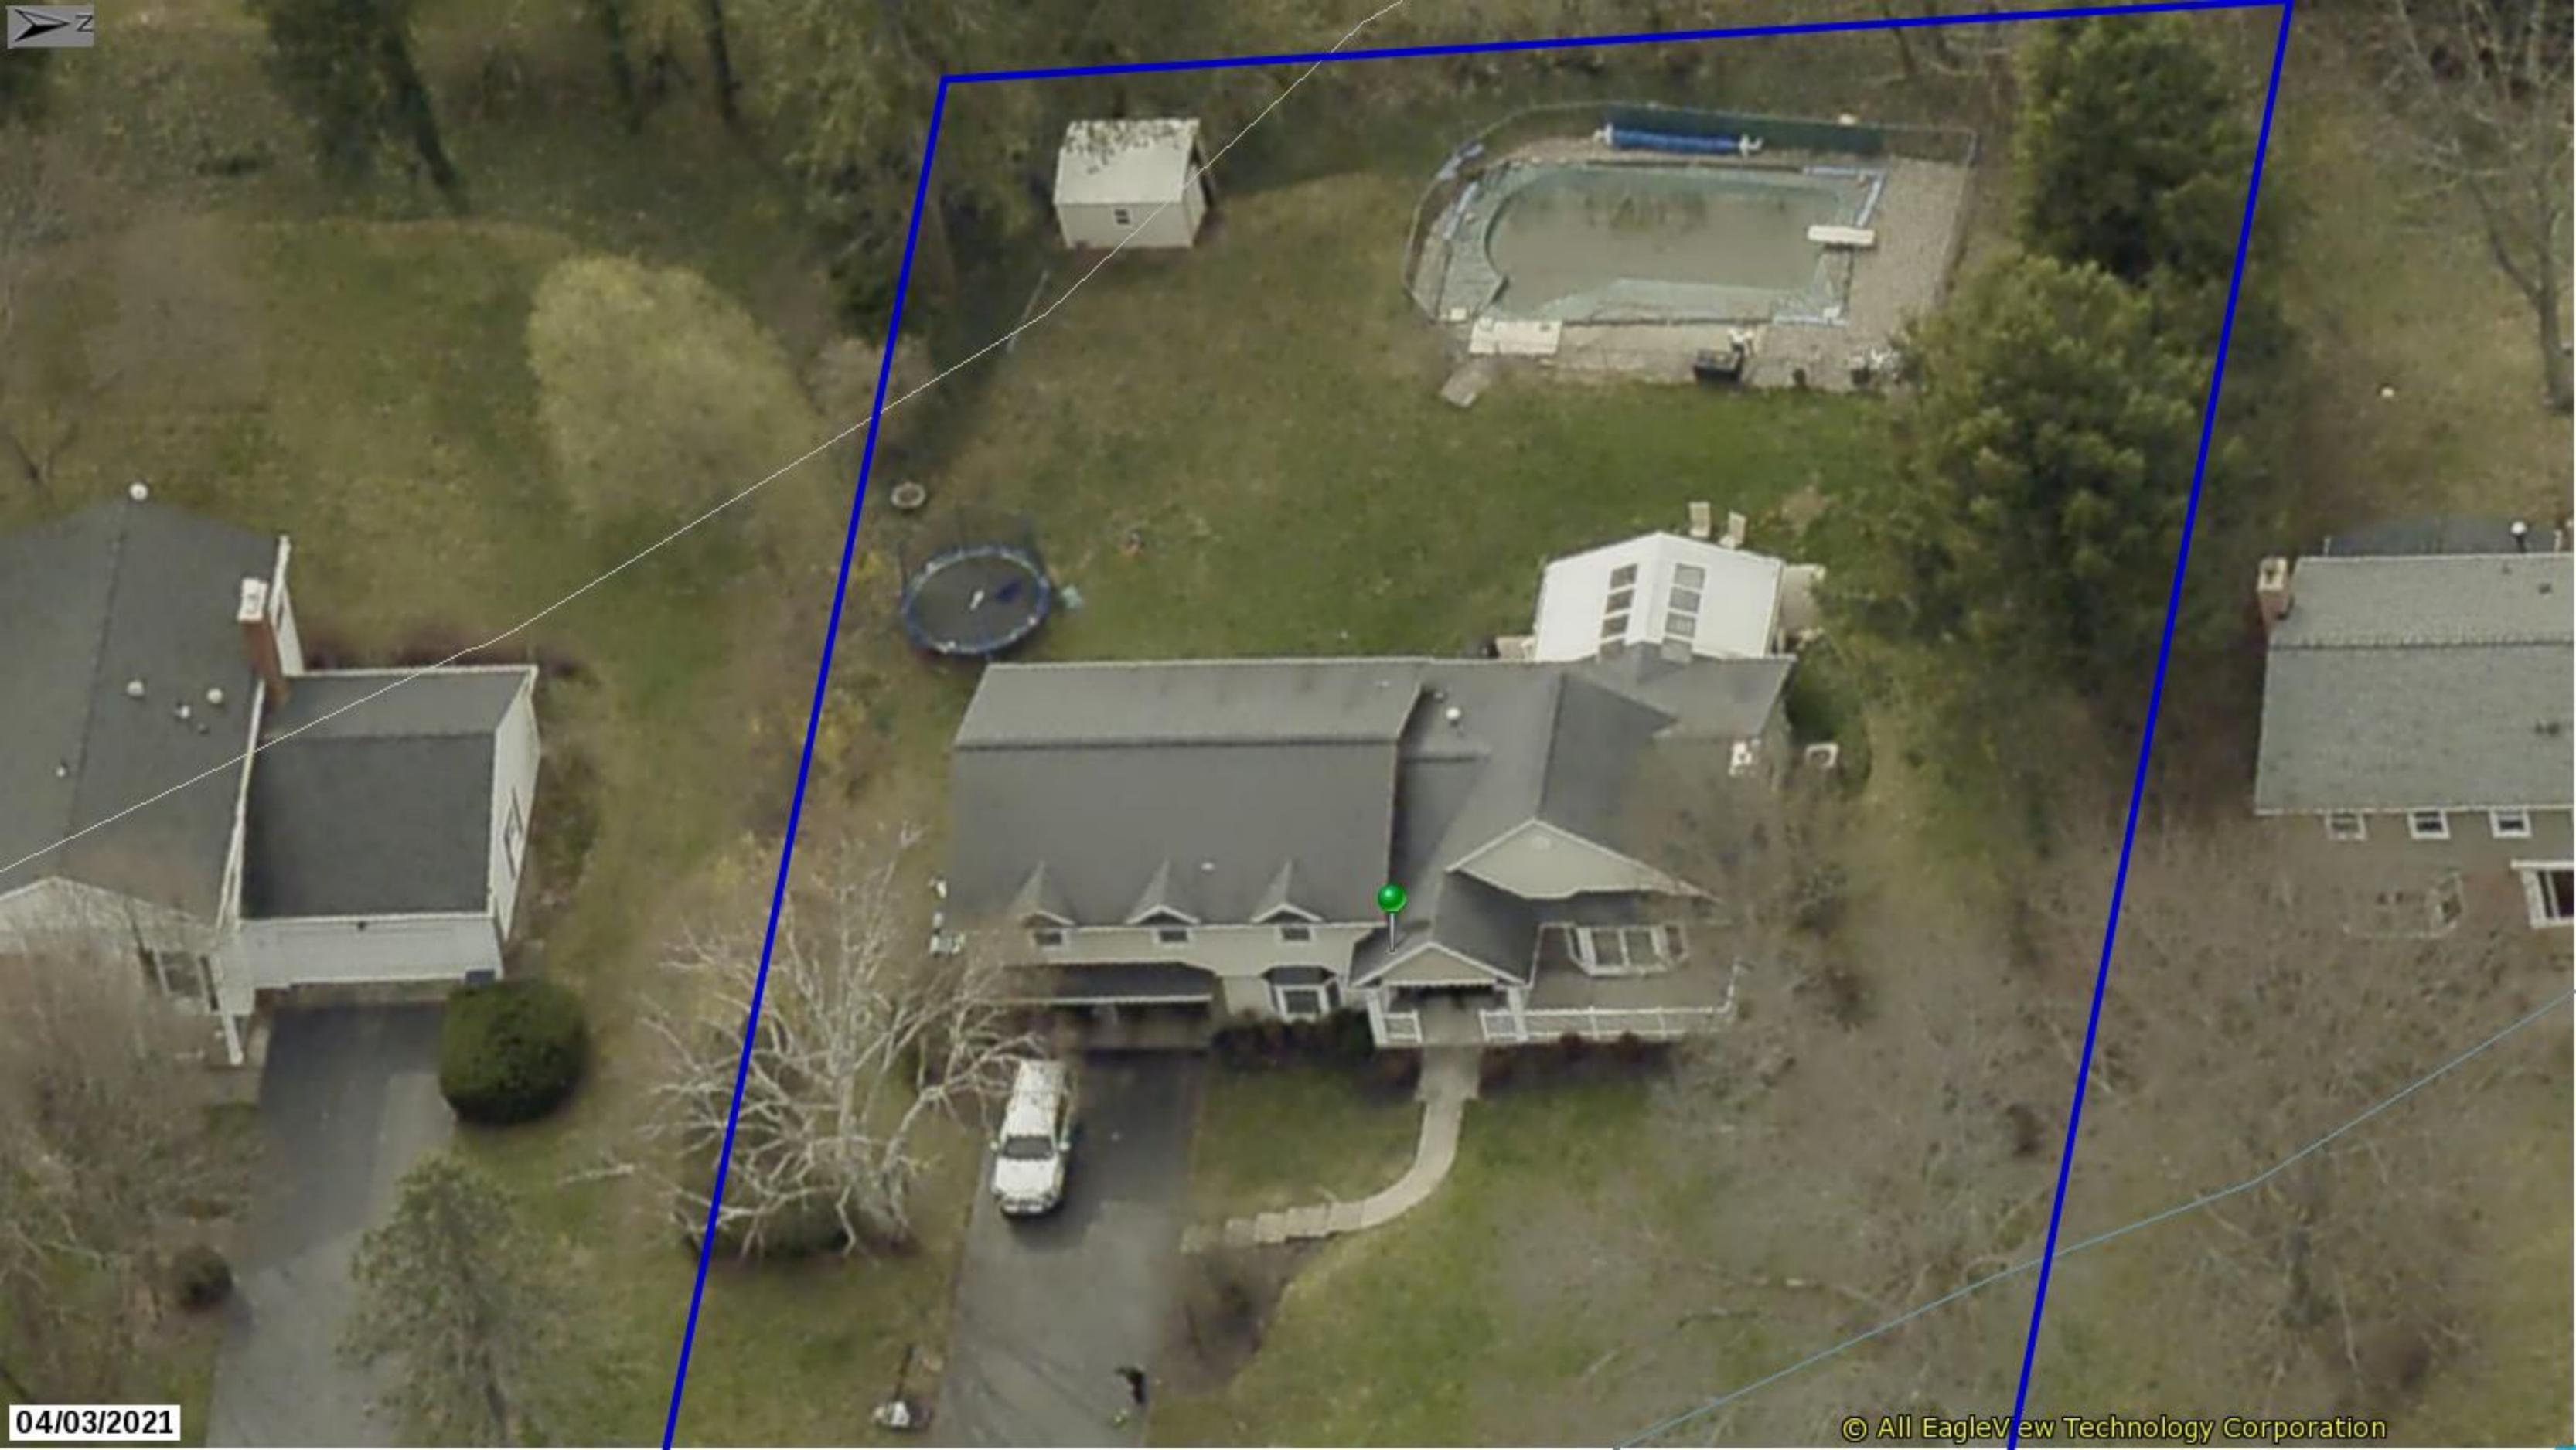04/03/2021

© All EagleView Technology Corporation



OLD FARM CIRCLE
(60' WIDE R.O.W.)



AREA =
25,000 SQ. FT
0.574 ACRES

APPROX
COLLOCATION
10' WIDE TRANSMISSION
LINE EASEMENT TO R.G.&E.
PER REF. No. 1

CERTIFICATION:

I, DAVID A. STAUB, HEREBY CERTIFY TO:
-FIRST AMERICAN TITLE INSURANCE COMPANY
-MORGENSTERN DEVOESICK PLLC
-GALLO & IACOVANGELO, LLP
-CNB MORTGAGE COMPANY,
ITS SUCCESSORS AND/OR ASSIGNS
-LUCAS H. MADDEN & CHELSEA A. MADDEN
THAT THIS MAP WAS MADE OCTOBER 21, 2016
FROM NOTES OF AN INSTRUMENT SURVEY
COMPLETED OCTOBER 20, 2016
AND REFERENCES LISTED HEREON.

REFERENCES:

- 1.) LIBER 147 OF MAPS, PAGE 51.
- 2.) LIBER 7906 OF DEEDS, PAGE 66.
- 3.) ABSTRACT OF TITLE No. TSA-2016-3569 (TIMES SQUARE).
- 4.) DEED RESTRICTIONS PER LIBER 3556 OF DEEDS, PAGE 92.
- 5.) EASEMENT TO R.G.&E. PER LIBER 3301 OF DEEDS, PAGE 291. (ALONG ROAD R.O.W. - NO WIDTH GIVEN)
- 6.) EASEMENT TO R.G.&E. & R.T.C. PER LIBER 3301 OF DEEDS, PAGE 288. (ALONG SIDE & REAR LINES - NO WIDTH GIVEN)

NOTES: 1.) PREMISES SUBJECT TO ALL EASEMENTS, RESTRICTIONS & COVENANTS OF RECORD NOT REFERENCED IN ABSTRACT OF TITLE.
2.) THE USE OF THIS MAP IN CONJUNCTION WITH AN AFFIDAVIT OF NO CHANGES RELEASES THE SURVEYOR OF ALL RESPONSIBILITY



TITLE: INSTRUMENT SURVEY MAP
38 OLD FARM CIRCLE
BEING LOT No. 64 OF
THE KNICKERBOCKER HILL SUBDIVISION,
TOWN OF PITTSFORD, COUNTY OF MONROE, STATE OF NEW YORK

*Unauthorized alteration or addition to a survey map bearing a licensed land surveyor's seal is a violation of Section 7209, sub-division 2, of the New York State Education Law.

*Only copies from the original of this survey marked with an original of the land surveyor's red ink seal shall be considered to be valid true copies.


*Certifications indicated hereon signify that this survey was prepared in accordance with the existing Code of Practice for Land Surveys adopted by the New York State Association of Professional Land Surveyors. Said certifications shall run only to the person for whom the survey is prepared, and on his behalf to the title company, governmental agency and lending institution listed hereon, and to the assignees of the lending institution. Certifications are not transferable to additional institutions or subsequent owners.



TRIPLE POINT LAND
SURVEYING, LLC.
16 EAST MAIN STREET SUITE 320
ROCHESTER, NEW YORK 14614
PHONE (585) 263-9950
FAX (585) 263-3591
TRIPLEPOINTSURVEYING@YAHOO.COM


SCALE: 1" = 40'	TAX ACCOUNT: 164.19-2-40	JOB NO.: 1467-16	DATE: OCT. 21, 2016
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This foundation design is to be used together with the complete structural pavilion drawings by Timber Tech Engineering, Inc. and is acceptable for the following four-post Wood pavilion size only: 12'x20' for 160 mph V_{ASD} .

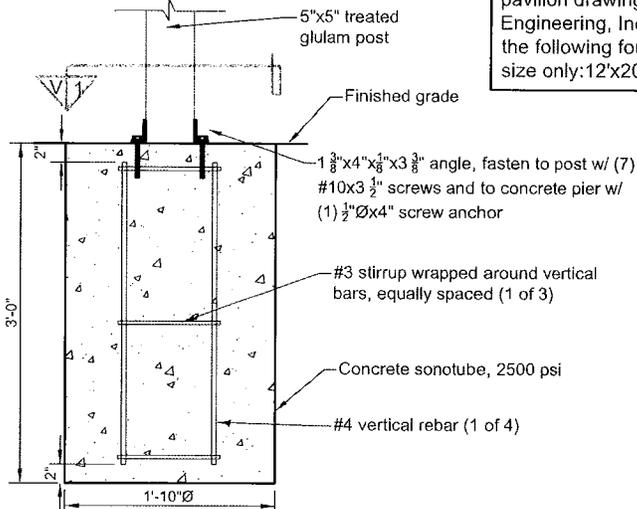


Pier Design

NTS

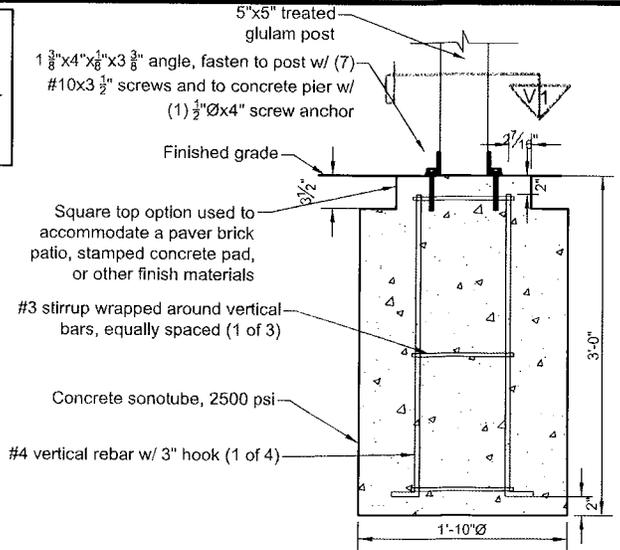


Alternative Pier Design
Square Top

NTS

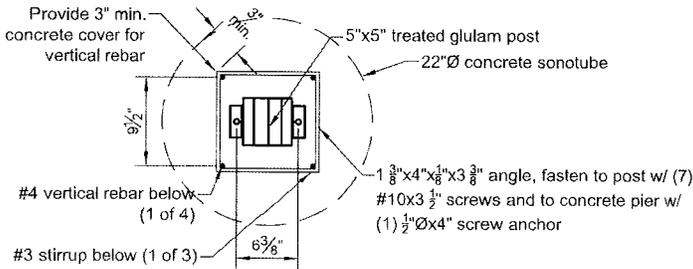

View 1 Pier Design

NTS

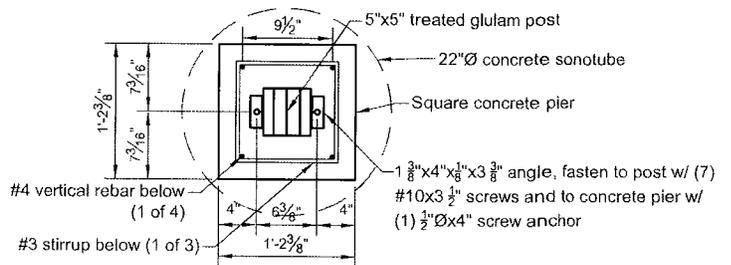

View 1 Alternative Pier Design
Square Top

NTS

EARTHWORK

- 1. Requirements
 - A. Provide a construction grade extending ten feet beyond building exterior walls or an alternative method per Section 1804 of the IBC.
 - B. Excavate for foundations to subgrade elevations regardless of character of materials and obstructions encountered, unless otherwise approved by the structural engineer.
 - C. Perform excavation work in compliance with applicable requirements of authorities having jurisdiction.
- 2. Materials
 - A. Satisfactory soil: ASTM D2487 unified soil classification groups GW, GP, GM, SW, SP, and SM; free of rock or gravel larger than two inches in any dimension, debris, waste, frozen materials, vegetation, or other deleterious matter.
 - B. Unsatisfactory soil: ASTM D2487 unified soil classification groups GC, SC, ML, MH, CL, CH, OL, OH, and PT.
 - C. Backfill and fill: satisfactory soil materials.
- 3. Execution
 - A. Footings have been designed for an assumed allowable loadbearing pressure of 2,000 psf. (No increases permitted.) The contractor shall verify this assumption, and shall immediately notify the structural engineer in writing of any deficiency.
 - B. Place backfill and fill in layers not more than eight inches in loose depth at optimum moisture content. Compact each layer under footings and slabs to a dry density of at least 95 percent of maximum dry density as determined by ASTM D1557.
 - C. Bottom of exterior footings shall be a minimum of 36 inches below finished grade, unless noted otherwise

Structural Steel

- 1. Connections shall be designed and constructed according to AISC, and shall conform to the following:
 - A. Screw Anchors (exterior applications): Use screw anchors of the diameter and length indicated on the drawings as manufactured by Rod Head or approved equal. Use LDT Stainless Steel bolts, or LDT bolts with EnviroX coating in concrete and CMU. Fill CMU cells at all bolt locations.
 - B. Connections exposed to weather or high relative humidity shall be hot-dip galvanized per ASTM A153 / A153M.

CAST-IN-PLACE CONCRETE

- 1. Concrete work shall conform to the following specifications by The American Concrete Institute (ACI).
 - A. "Building Code Requirements for Structural Concrete" (ACI 318).
 - B. "Hot Weather Concreting" (ACI 318).
 - C. "Cold Weather Concreting" (ACI 318).
- 2. Materials used shall adhere to the following:
 - A. Portland Cement: ASTM C150, type 1.
 - B. Fly Ash: ACI 318.
 - C. Aggregates: ASTM C33, maximum aggregate size is one inch.
 - D. Fiberglass reinforcement: PCI MNL 128 Standard.
 - E. Air-entraining admixture: ACI 318.
 - F. Chemical admixtures: ASTM C494, water reducing. All concrete, except footings, shall contain a water reducing admixture. No admixtures containing calcium chloride are permitted. All other additives shall not be used without prior approval of the structural engineer.
 - G. Vapor retarder: Clear 8-mil thick polyethylene.
- 3. Proportion normal-weight (145 pcf) concrete mixes to provide the following properties:
 - A. Compressive strength: 3,000 psi at 28 days (unless noted otherwise).
 - B. Slump limit: 4 inches (3 inches for slab-on-grade) at point of placement.
 - C. Water-cement ratio: 0.45 maximum at point of placement.
 - D. Air content: 5 to 7 percent for concrete exposed to freezing and thawing, 2 to 4 percent elsewhere.
- 4. Reinforcing steel shall be fabricated, detailed and placed in accordance with the ACI 318, and shall conform to the following:
 - A. Deformed reinforcing bars: ASTM A615/A 615M with a minimum yield strength of 60,000 psi (grade 60).
 - B. Welded wire fabric (WWF): ASTM A1064, flat sheets, not rolls.
 - C. Ties/Silnrups: ASTM A615/A615M, grade 40.
- 5. Concrete work shall be executed according to the following:
 - A. Maintain tolerances and surface irregularities within ACI 117 limits of class A for concrete exposed to view, and class C for other concrete surfaces. Floor slabs shall be screeded, floated and steel troweled to a smooth, dense and plane surface.
 - B. Accurately position, support, and secure reinforcement.
 - 1. Reinforcing bars shall lap 48 bar diameters at splices in concrete unless otherwise noted.
 - 2. Provide corner bars to match all continuous reinforcing in concrete and masonry.
 - 3. Reinforcing bar hooks shall be ACI standard.
 - 4. WWF shall have ends lapped one full mesh, and shall extend onto supporting walls.
 - 5. Chairs, bolsters, bar supports, and spacers shall be sized and shaped for strength and support of reinforcement during concrete placement.
 - C. Provide minimum concrete cover on reinforcing bars as follows:
 - 1. Cast against earth.....3"
 - 2. Exposed to earth or weather (#5 or smaller)....1 1/2"
 - 3. Exposed to earth or weather (#6 or larger).....2"
 - 4. Slabs and walls not exposed.....3/4"
 - D. The contractor shall be responsible for stability and integrity of all excavations and existing structures.

12'x20' Rectangle Vinyl Pavilion

GENERAL NOTES

All notes do not necessarily apply due to different requirements on each project. This plan is intended to reflect only the structural design of this building. The contractor shall review all applicable local, state, and federal building codes prior to the start of construction to ensure building conformance. Timber Tech Engineering, Inc. is not responsible for information pertaining to this project if not shown on drawings or listed below. Revisions to the plans shall be approved by engineer of record.

DESIGN REQUIREMENTS

1. Governing Code:
Including, not limited to: IBC 2015 (ASCE 7-10)
Risk Category I
2. Dead Loads:

A. Roof	10 psf
B. Floor	n/a psf
C. Other	n/a psf
3. Live Loads:

A. Roof (See also note #4)	30 psf
B. Floor	n/a psf
C. Other	n/a psf
4. Snow Loads:

A. Ground Snow (Pg)	45 psf
B. Flat Roof Snow (Pf)	30 psf
C. Snow Exposure Factor (Ce)	1.0
D. Snow Load Importance Factor (I)	0.8
5. Wind Load

A. Ultimate Wind Speed (V ult)	160 mph
B. Nominal Wind Speed (V asd)	142 mph
C. Wind Exposure Category	C
D. Enclosure Category	Open
6. Earthquake Design Data:
(Analysis based on equivalent lateral force procedure)

A. Spectral Response Acceleration at 1 sec, S	0.35
B. Spectral Response Acceleration at short periods, S	0.75
C. Seismic Importance Factor, I	1.0
D. Site Class	D
E. Seismic Design Category	D
F. Basic Structural System	Cantilevered Column; Timber Frame
G. Response Modification Factor (R)	1.5
H. Deflection Amplification Factor (Cd)	1.5

WOOD

1. General Requirements
 - A. Structural wood members and connections shall be of sufficient size or capacity to carry all design loads without exceeding the allowable design values specified in "The National Design specification for Wood Construction" (NDS), and its "Supplement" by the American Wood Council (AWC).
 - B. Wood members used for load supporting purposes shall have the grade mark of a lumber grading agency certified by the American Lumber Standards Committee.
2. Heavy Timbers
 - A. Structural solid sawn timbers shall be designed, fabricated and installed in accordance with the NDS by AWC.
 - B. Structural glued laminated soft wood timbers shall conform with the "American National Standard or Structural Glued Laminated Timber" (ANSI/AITC 190.1).
 - C. Structural decking shall conform to the NDS.
 - D. Glued laminated columns shall be manufactured with laminating combinations that will provide a minimum design value of 1,850 psi for compressive stress (Fc), and 2,200 psi for bending stress (Fb).
3. Dimension Lumber
 - A. All lumber species, graded visually or mechanically, shall comply with the NDS by AWC, and the "American Softwood Lumber Standard" (PS 20) by the U.S. Department of Commerce.
 - B. The minimum grade and species for posts, beams, headers, and other primary structural members shall be Dense Select Structural Southern Pine, unless specified otherwise.
 - C. Lumber used for secondary framing shall be #1 Southern Yellow Pine (SYP) or better.
 - D. Mechanically laminated columns shall conform with ANSI/ASAE EP 559.
4. Pressure Preservative Treatment (PPT)
 - A. Pressure treatment to be performed according to the American Wood Preservers' Association (AWPA) standards.
 - B. Pressure treated members shall have the inspection mark of an agency accredited by the American Lumber Standards Committee.
 - C. Preservative: Ammonia Copper Quaternary ammonia (ACQ) or Copper Boron Azole (CBA)
 - D. Minimum waterborne treatment retention shall be 0.4 pcf for members above ground, and 0.6 pcf for members in contact with earth.
- E. Treat indicated items and the following:
 1. Wood members exposed to weather or insect infestation.
 2. Wood members in direct contact with earth or concrete.
 3. Wood members exposed to high moisture content (>19% for dimension lumber, >16% for glued laminated timber).
 4. Wood members less than 12 inches above grade.
 - F. Field treat newly exposed wood where cutting, drilling or notching pressure treated lumber.
 - G. Metal connectors used in treated wood shall be hot-dip galvanized as per ASTM A153.
5. Connections shall be designed and constructed according to the NDS by AWC and shall conform to the following:
 - A. The minimum connection shall be two #10x3 1/4" wood screws, or as detailed on the drawings.
 - B. Other connections as per standard construction practice.

Polyvinyl Chloride Compound (PVC)


1. General Requirements
 - A. PVC sleeve material used to wrap wood members to be supplied according to Certified corporation specifications or equivalent.
 - B. PVC sleeve material to be 0.160" thick for posts, and 0.105" thick for other structural members

This drawing is the property of Country Lane Woodworking, LLC, provided by Timber Tech Engineering, Inc. and reproduction, alteration or use of this drawing without the written consent of Country Lane Woodworking, LLC is prohibited. Drawings shall not be scaled to obtain dimensions. The contractors and builders involved on this project shall verify all dimensions and conditions before starting work and any discrepancy shall be reported to the engineer in writing before starting work.

Drawing Index


- Cover Page - Notes, Reaction Chart
- Page 1 - Elevations, Post Layout Plan
- Page 2 - Roof Framing Plan, Cross Section A/2, Detail A-A/2
- Page 3 - Detail B-B/3
- Page 4 - Detail B-B/4
- Page 5 - Detail C-C/5, Detail D-D/5, Base Angle Detail
- Page 6 - Detail E-E/6, Angle "A1", Angle "A2"
- Page 7 - Detail F-F/7
- Page 8 - View 1 Detail F-F/7, View 2 Detail F-F/7, Plate "P2"

Design Reaction Chart	
Max. uplift at column base	1000 lb
Max. downward force at column base	2650 lb
Max. shear at column base	450 lb

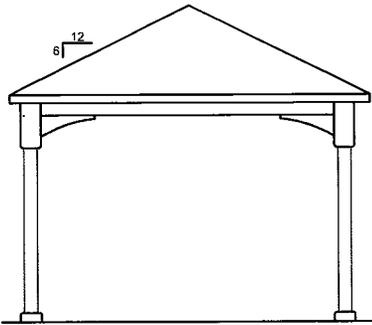


End Elevation

NTS

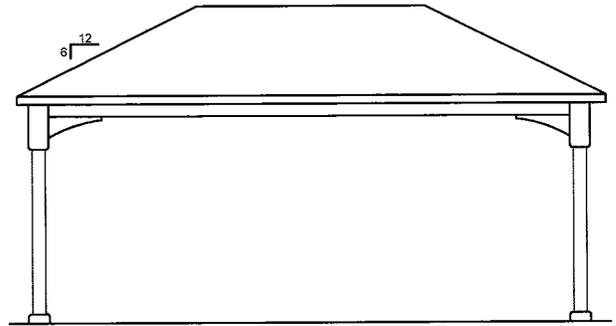



Side Elevation

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Post Layout Plan

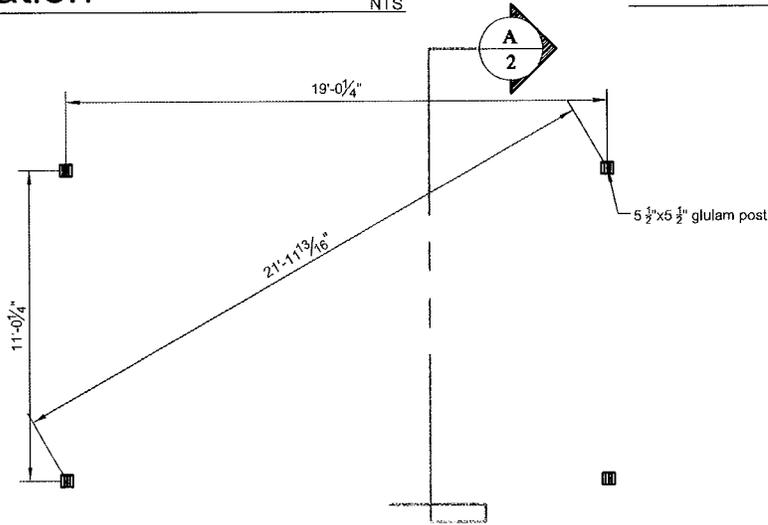
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View 2 Detail B-B/3


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Detail B-B/3
Typical Single Rafter

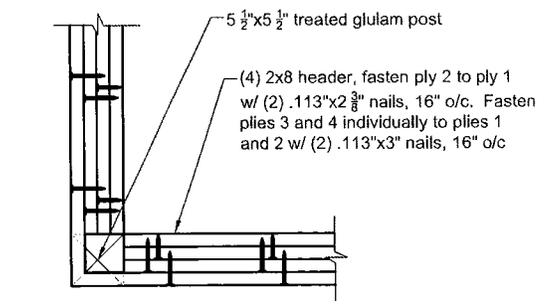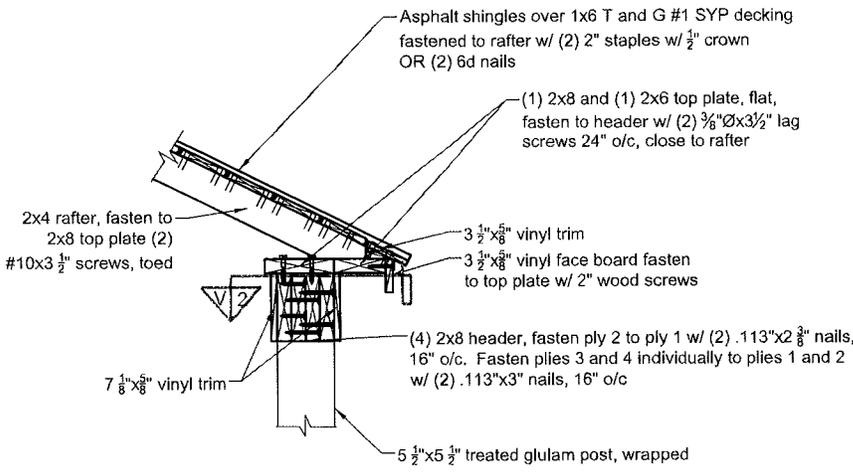


View 1 Detail B-B/3


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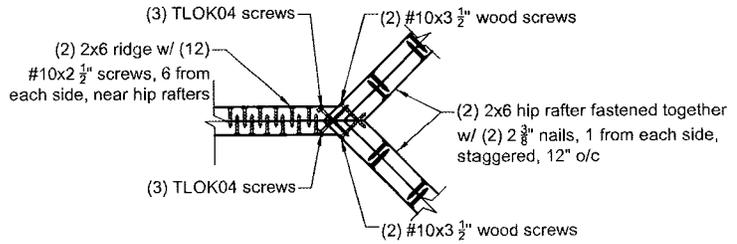
Detail B-B/4
Hip Rafter Connection NTS

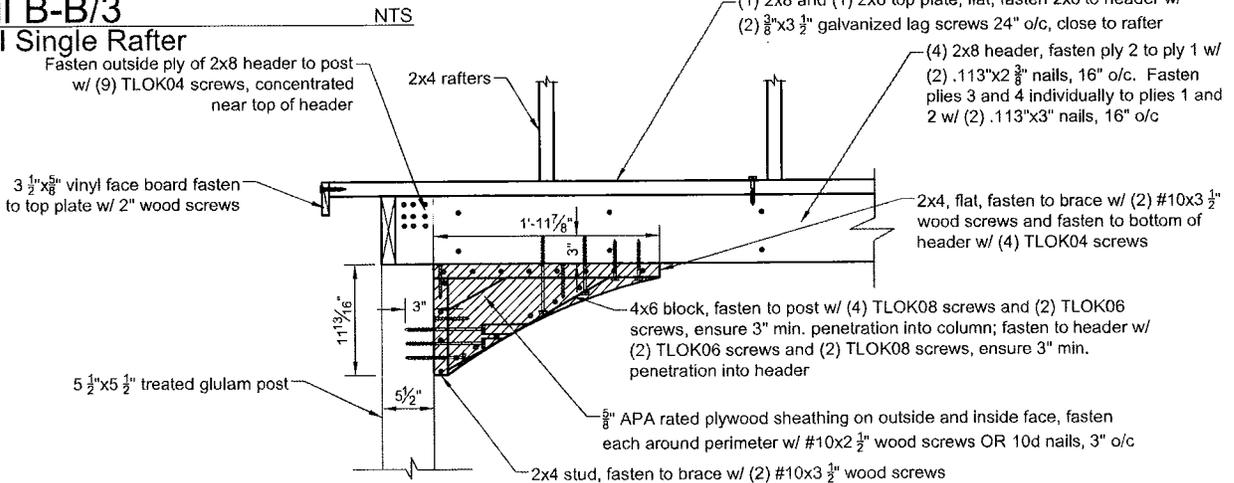

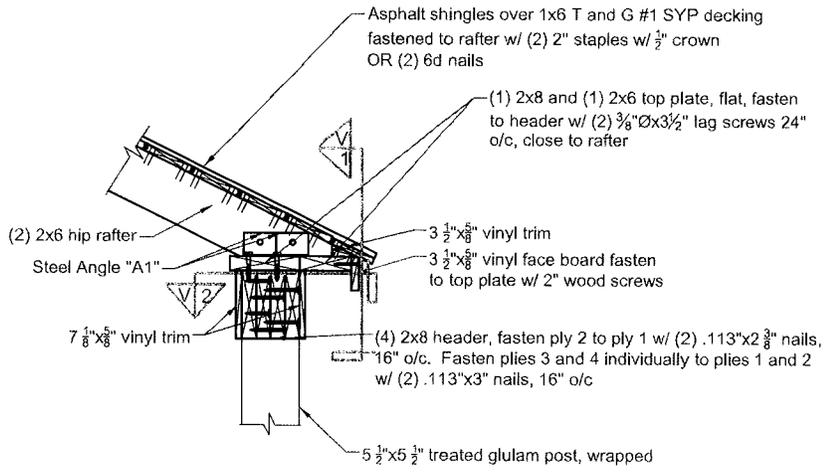
Detail C-C/5 NTS

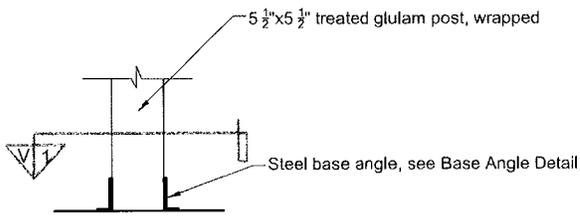


View 1 Detail C-C/5 NTS

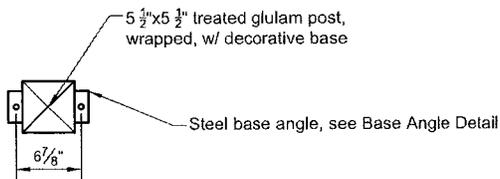


Detail D-D/5 Option 1 NTS

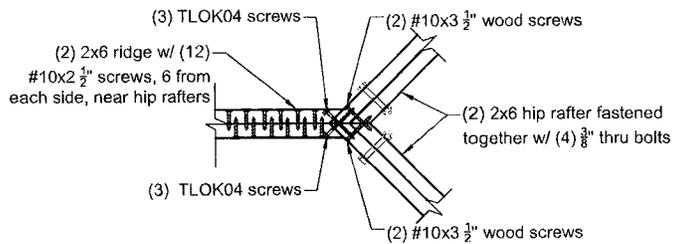

Detail D-D/5 Option 2 NTS

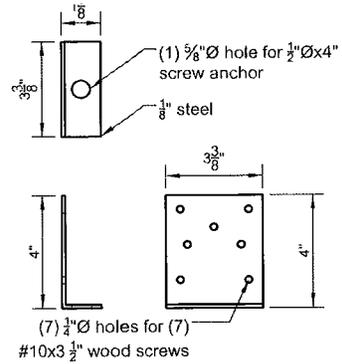


Base Angle Detail NTS

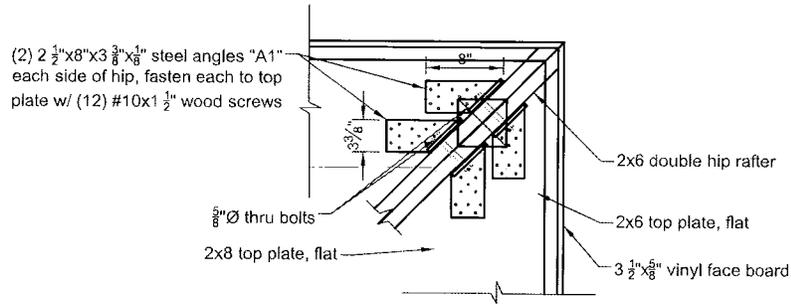


Detail E-E/6

NTS

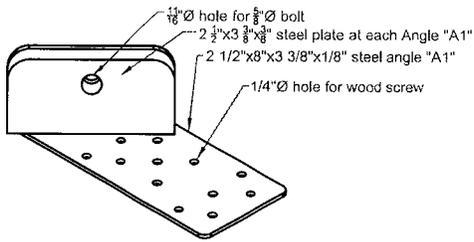

Angle "A1"


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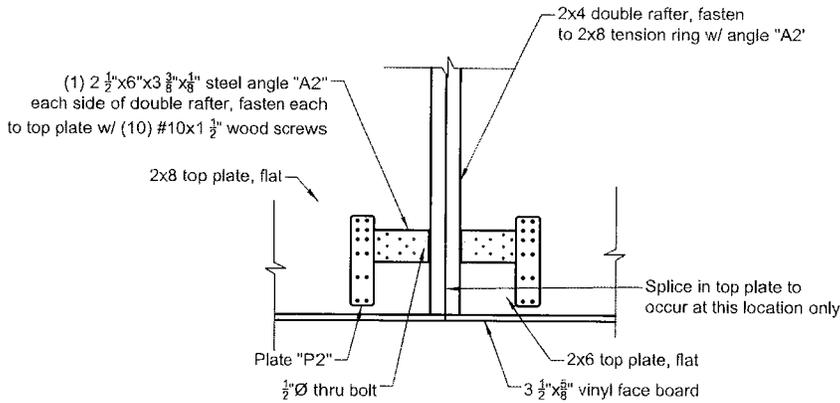
Note:
Use flat washers under bolt head and nut (1 3/8" O.D. min.)

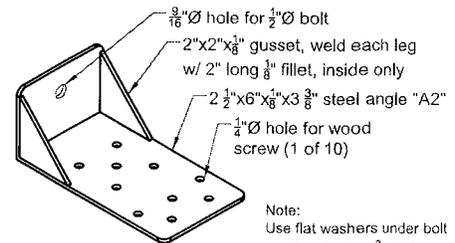Angle "A2"

NTS



Detail F-F/7 NTS
Center Double Rafter

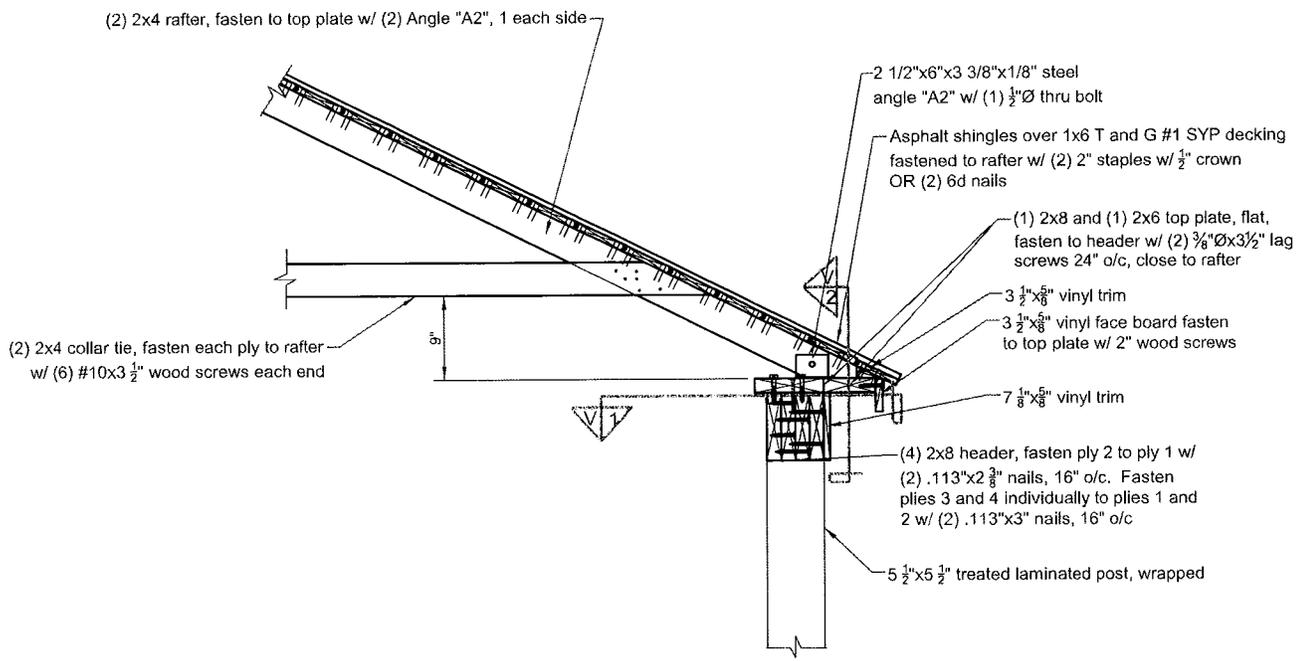

View 1 Detail F-F/7 NTS


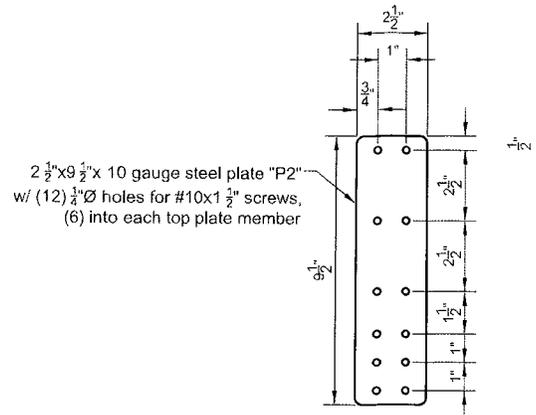


Plate "P2" NTS



View 2 Detail F-F/7 NTS


Backyard Pics - 38 Old Farm Circle

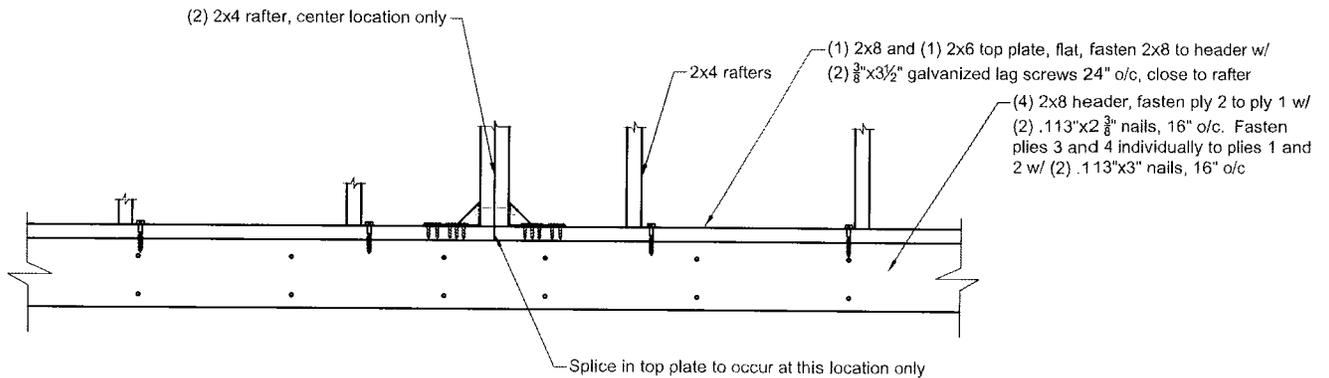

Facing North



Facing Southwest

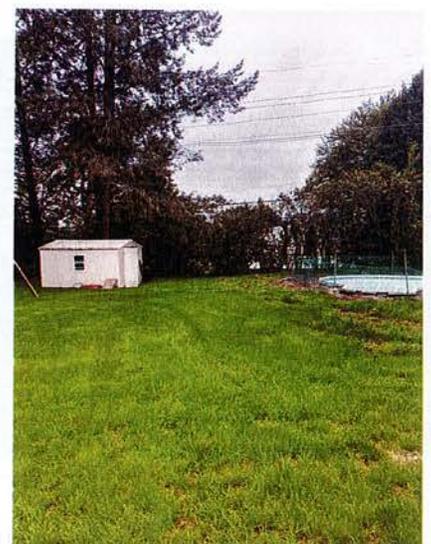


Facing East

Proposed location of structure



TBD on
wood or
vinyl. Post
location/
size is the
same



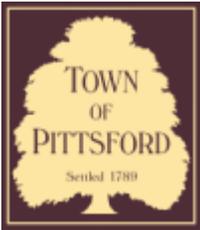

Town of Pittsford

Department of Public Works
11 South Main Street
Pittsford, New York 14534

Permit #
B22-000147

Phone: 585-248-6250
FAX: 585-248-6262

DESIGN REVIEW AND HISTORIC PRESERVATION BOARD REFERRAL OF APPLICATION

Property Address: 31 Falcon Trail PITTSFORD, NY 14534

Tax ID Number: 165.09-3-9

Zoning District: RN Residential Neighborhood

Owner: Gilmore, Daniel R

Applicant: Gilmore, Daniel R

Application Type:


- | | |
|---|---|
| <input checked="" type="checkbox"/> Residential Design Review
§185-205 (B) | <input type="checkbox"/> Build to Line Adjustment
§185-17 (B) (2) |
| <input type="checkbox"/> Commercial Design Review
§185-205 (B) | <input type="checkbox"/> Building Height Above 30 Feet
§185-17 (M) |
| <input type="checkbox"/> Signage
§185-205 (C) | <input type="checkbox"/> Corner Lot Orientation
§185-17 (K) (3) |
| <input type="checkbox"/> Certificate of Appropriateness
§185-197 | <input type="checkbox"/> Flag Lot Building Line Location
§185-17 (L) (1) (c) |
| <input type="checkbox"/> Landmark Designation
§185-195 (2) | <input type="checkbox"/> Undeveloped Flag Lot Requirements
§185-17 (L) (2) |
| <input type="checkbox"/> Informal Review | |

Project Description: The applicant is requesting design review for a 224SF unconditioned addition to rear of garage


Meeting Date: October 13, 2022



RN Residential Neighborhood Zoning

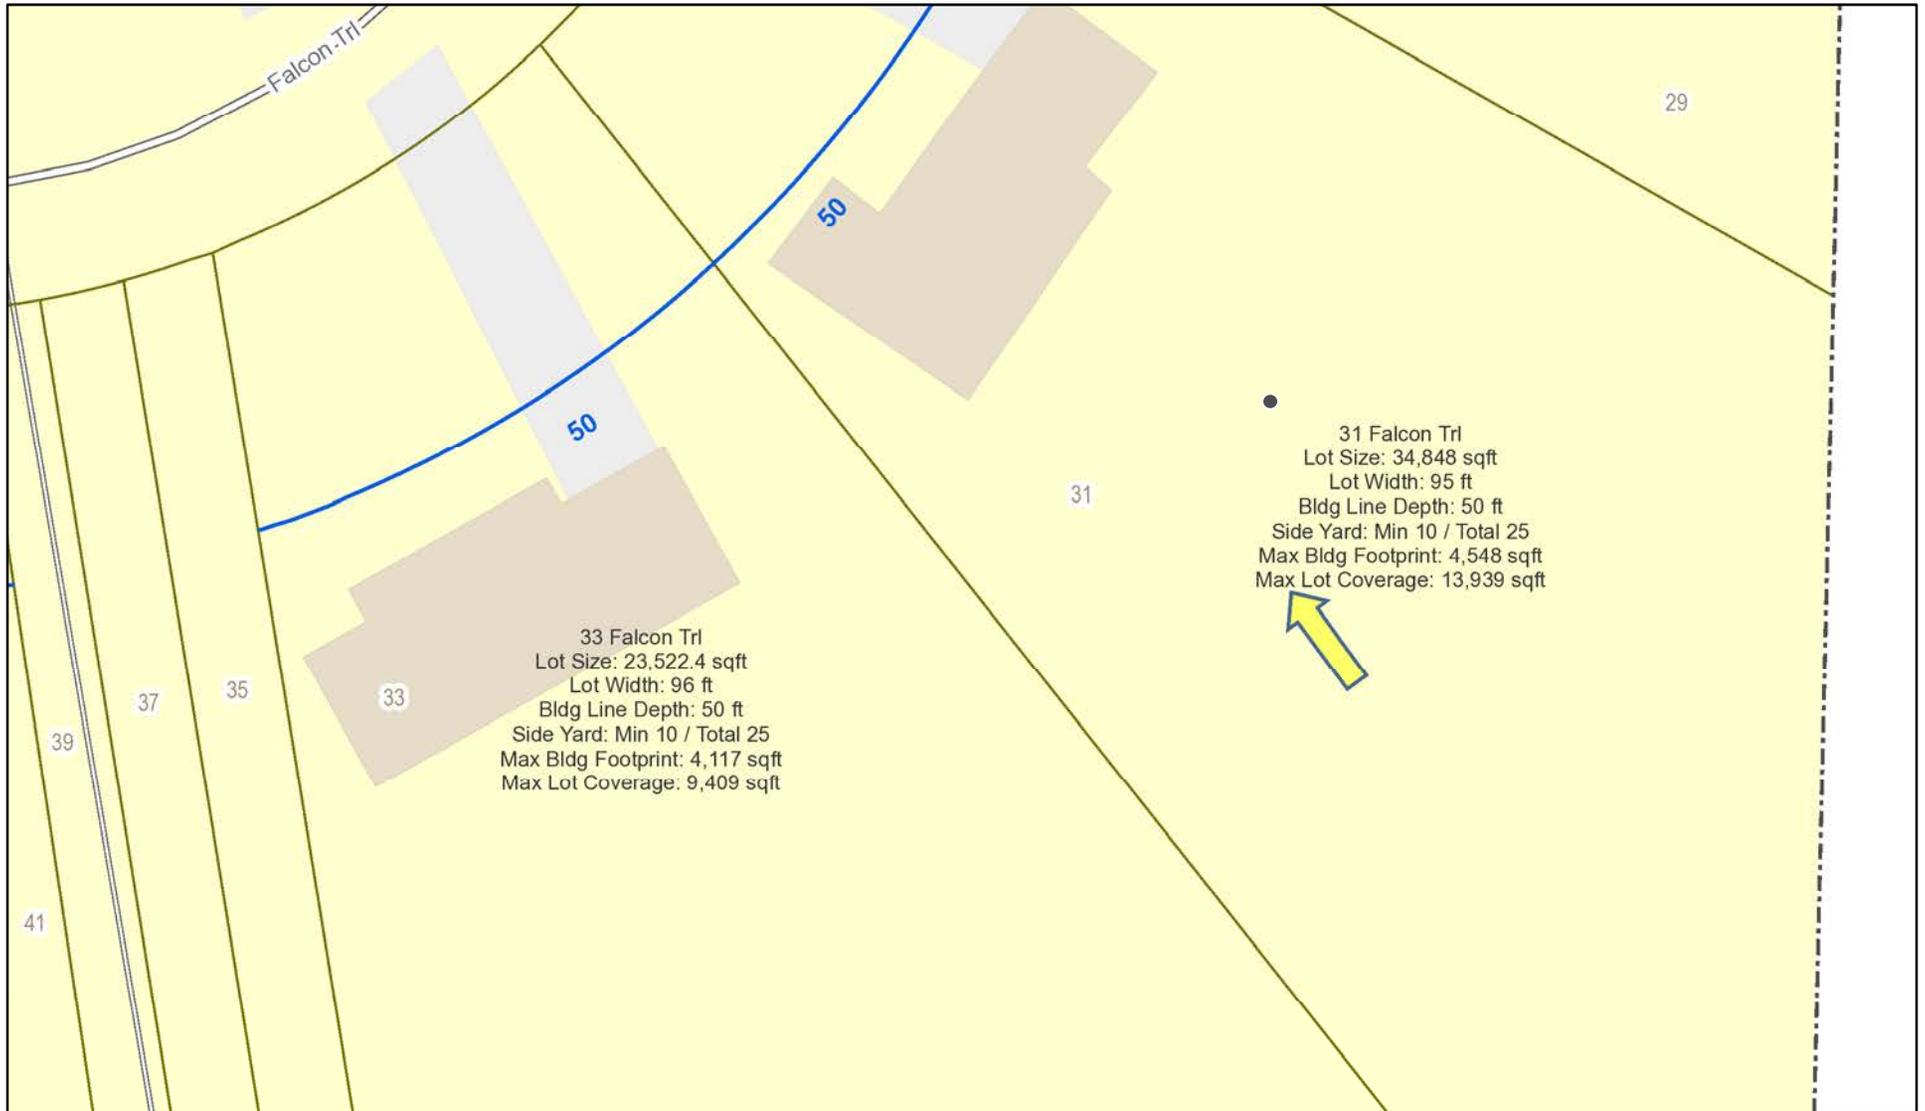

Printed October 4, 2022

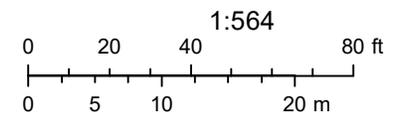

Town of Pittsford GIS

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Falcon Trl

Unnamed Street


Falcon Trl

04/03/2021

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GENERAL NOTES:

1. THESE PLANS HAVE BEEN PREPARED TO THE BEST OF THE ARCHITECT'S KNOWLEDGE, BELIEF, AND PROFESSIONAL JUDGMENT IN ACCORDANCE WITH THE 2020 RESIDENTIAL CODE OF NEW YORK STATE AND ENERGY CONSERVATION CODE REQUIREMENTS. THE CONTRACTOR SHALL BE RESPONSIBLE FOR ADAPTING THESE PLANS, IF REQUIRED, TO SUIT THE NEEDS OF THE BUILDING ON THE SITE, PROVIDED THAT THE ALTERATIONS DO NOT VIOLATE THE CODE OR ALTER THE STRUCTURAL INTEGRITY OF THE BUILDING.
2. THE CONTRACTOR SHALL BE RESPONSIBLE FOR COMPLIANCE WITH ALL APPLICABLE BUILDING/ELECTRICAL/MECHANICAL/SANITARY AND ENERGY CODES; STATE OR LOCAL. THE CONTRACTOR SHALL BE RESPONSIBLE FOR COMPLIANCE WITH THE ENERGY CONSERVATION CODE FOR ALL HVAC EQUIPMENT, HVAC CONTROLS, WATER HEATING EQUIPMENT, PIPE AND DUCT INSULATION, AND FLUORESCENT LAMPS AND BALLASTS.
3. THE CONTRACTOR SHALL BE RESPONSIBLE SO THAT BRANDS OF WINDOWS AND DOORS INSTALLED MEET THE NEW YORK STATE ENERGY CONSERVATION CODE REQUIREMENTS. WINDOWS AND / OR DOORS SHOWN ARE INDICATED FOR SIZING ONLY.
4. ALL FOOTINGS SHALL REST ON UNDISTURBED VIRGIN SOIL. THE FOOTING/FOUNDATION DESIGN ASSUMES MINIMUM SOIL BEARING PRESSURE TO BE 2000 PSF. CONTRACTOR SHALL BE RESPONSIBLE FOR ALL SUBGRADE CONDITIONS. IF REQUIRED, THE OWNER AND / OR CONTRACTOR SHALL BE RESPONSIBLE FOR HIRING A SOILS ENGINEER TO VERIFY SUBGRADE CONDITIONS AND SUBSTANTIATE ACTUAL BEARING CAPACITY.
5. BACKFILL MATERIALS SHALL BE NATIVE SOIL. FOR FILL UNDER THE GARAGE FLOOR OR BASEMENT FLOOR, PROVIDE SAND/ GRAVEL FILL FOR COMPACTION AS NEEDED.
6. MINIMUM CONCRETE COMPRESSIVE STRENGTH:
2500 PSI FOOTINGS
2500 PSI FLOOR SLABS
7. CONCRETE BLOCK SHALL CONFORM TO ASTM C40 N-1, WALL REINFORCING - ASTM A82. ALL MORTAR SHALL CONFORM TO ASTM C270, TYPE S - 1 PART PORTLAND CEMENT, 1/4 PART LIME, 3 PARTS SAND.
8. N/A
9. MINIMUM FIBER STRESS IN BENDING (FB) FOR ALL FRAMING LUMBER TO BE 1150 PSI #2 HEM-FIR OR BETTER. PROVIDE DOUBLE FRAMING MEMBERS UNDER PARTITIONS RUNNING IN SAME DIRECTION.
10. N/A
11. N/A
12. PLYWOOD SHALL CONFORM TO U.S. PRODUCT STANDARD PS - 1, THICKNESS AS SHOWN. APA RATED SHEATHING EXP-1, NAILING AND SPACING PER APA RECOMMENDATIONS FOR LOCATIONS INTENDED.
13. ALL WOOD IN CONTACT WITH CONCRETE OR MASONRY SHALL BE FULLY WOOD PRESERVATIVE-TREATED WITH OSBOSALTS OR WOLMAN SALTS.
14. N/A
15. CONTRACTOR SHALL VERIFY ALL NOTES AND DIMENSIONS PRIOR TO CONSTRUCTION. THESE DRAWINGS ARE NOT TO BE SCALED - USE DIMENSIONS GIVEN.
16. CONTRACTOR SHALL BE RESPONSIBLE FOR ALL CONSTRUCTION MEANS, METHODS, TECHNIQUES, SEQUENCES AND SAFETY PRECAUTIONS IN CONNECTION WITH THE WORK.
17. THESE DRAWINGS HAVE BEEN PREPARED FOR STRUCTURAL INTENT ONLY. ELECTRICAL, MECHANICAL AND OTHER BUILDING SYSTEMS, AS REQUIRED ARE TO BE DESIGNED BY OTHERS.
18. N/A
19. ALL WORK, MATERIALS, METHODS, EQUIPMENT, ETC. SHALL BE IN STRICT ACCORDANCE WITH THE CONTRACT DOCUMENTS. ALL MATERIALS SHALL BE NEW UNLESS NOTED OTHERWISE.
20. WORK SEQUENCE AND SCHEDULE SHALL BE MUTUALLY AGREED UPON BY BOTH THE OWNER AND THE CONTRACTOR.
21. IT IS ASSUMED THAT THE SUBSURFACE CONDITIONS WILL BE EARTH OR SOIL. IF BEDROCK IS ENCOUNTERED, REMOVAL WILL BE CONSIDERED AN ADDITION TO CONTRACT.
22. ANY DEMOLITION WORK SHALL BE DONE CAREFULLY. ALL DISTURBED SURFACES TO BE REPAIRED APPROPRIATELY. ALL SALVAGEABLE ITEMS SHALL BE TURNED OVER TO THE OWNER.
23. EXAMINATION OF THE SITE SHOULD BE MADE BY ALL CONTRACTORS CONCERNED TO FULLY CONSIDER ALL SITE CONDITIONS WHICH MAY HAVE A BEARING ON THE WORK OF THE ENTIRE PROJECT. SUBMISSION OF A BID IS PRESUMPTIVE EVIDENCE THAT THE BIDDER IS CONVERSANT WITH LOCAL JURISDICTIONS AND HAS MADE DUE ALLOWANCES IN HIS BID FOR ALL CONTINGENCIES. THE OWNER RESERVES THE RIGHT TO REJECT ANY OR ALL BIDS.
24. IT IS THE RESPONSIBILITY OF THE CONTRACTOR TO NOTIFY THE ARCHITECT IN CASE OF ANY OR ALL DEVIATIONS FROM THESE DRAWINGS. THE ARCHITECT SHALL BE HELD HARMLESS AS A RESULT OF ANY UNAUTHORIZED CHANGES TO THESE PLANS. ADDITIONAL FEES MAY OCCUR FOR "AS BUILT" DOCUMENTATION DUE TO CIRCUMSTANCES BEYOND THE ARCHITECT'S CONTROL, OR OWNER / CONTRACTOR CHANGES TO THESE DRAWINGS.
25. THE CONTRACTOR SHALL OBTAIN AND PAY FOR ALL PERMITS AND APPROVALS REQUIRED BY THE LOCAL ZONING AND BUILDING DEPARTMENTS AND ANY OTHER GOVERNMENTAL AGENCY HAVING JURISDICTION OVER THE WORK. ALL APPLICABLE REGULATIONS SHALL BE ADHERED TO AND CARRIED OUT BY ALL INDIVIDUALS UNDER THIS CONTRACT.
26. THE CONTRACTOR SHALL FURNISH A CERTIFICATE OF INSURANCE INDICATING THE TYPE AND AMOUNTS OF COVERAGE AS REQUIRED BY NEW YORK STATE AND THE LOCAL MUNICIPALITY.
27. THE CONTRACTOR SHALL REMOVE ALL RUBBISH AND LEAVE THE COMPLETED PROJECT IN A CLEAN STATE, SATISFACTORY TO THE OWNER.
28. THE CONTRACTOR SHALL GUARANTEE HIS WORK AND HIS SUBCONTRACTOR'S WORK AGAINST FAULTY MATERIALS AND WORKMANSHIP IN ACCORDANCE WITH NEW YORK STATE GENERAL BUSINESS LAW.
29. ONLY COPIES FROM THE ORIGINALS OF THESE DRAWINGS MARKED WITH AN ORIGINAL OF THE ARCHITECT'S EMBOSSED SEAL SHALL BE CONSIDERED TO BE VALID TRUE COPIES.
30. BUILDING IS CLASSIFIED AS A ONE FAMILY DWELLING.
31. N/A
32. N/A
33. ALL MATERIALS USED IN THIS PROJECT SHALL BE NON-ASBESTOS AND NON-LEAD CONTAINING.

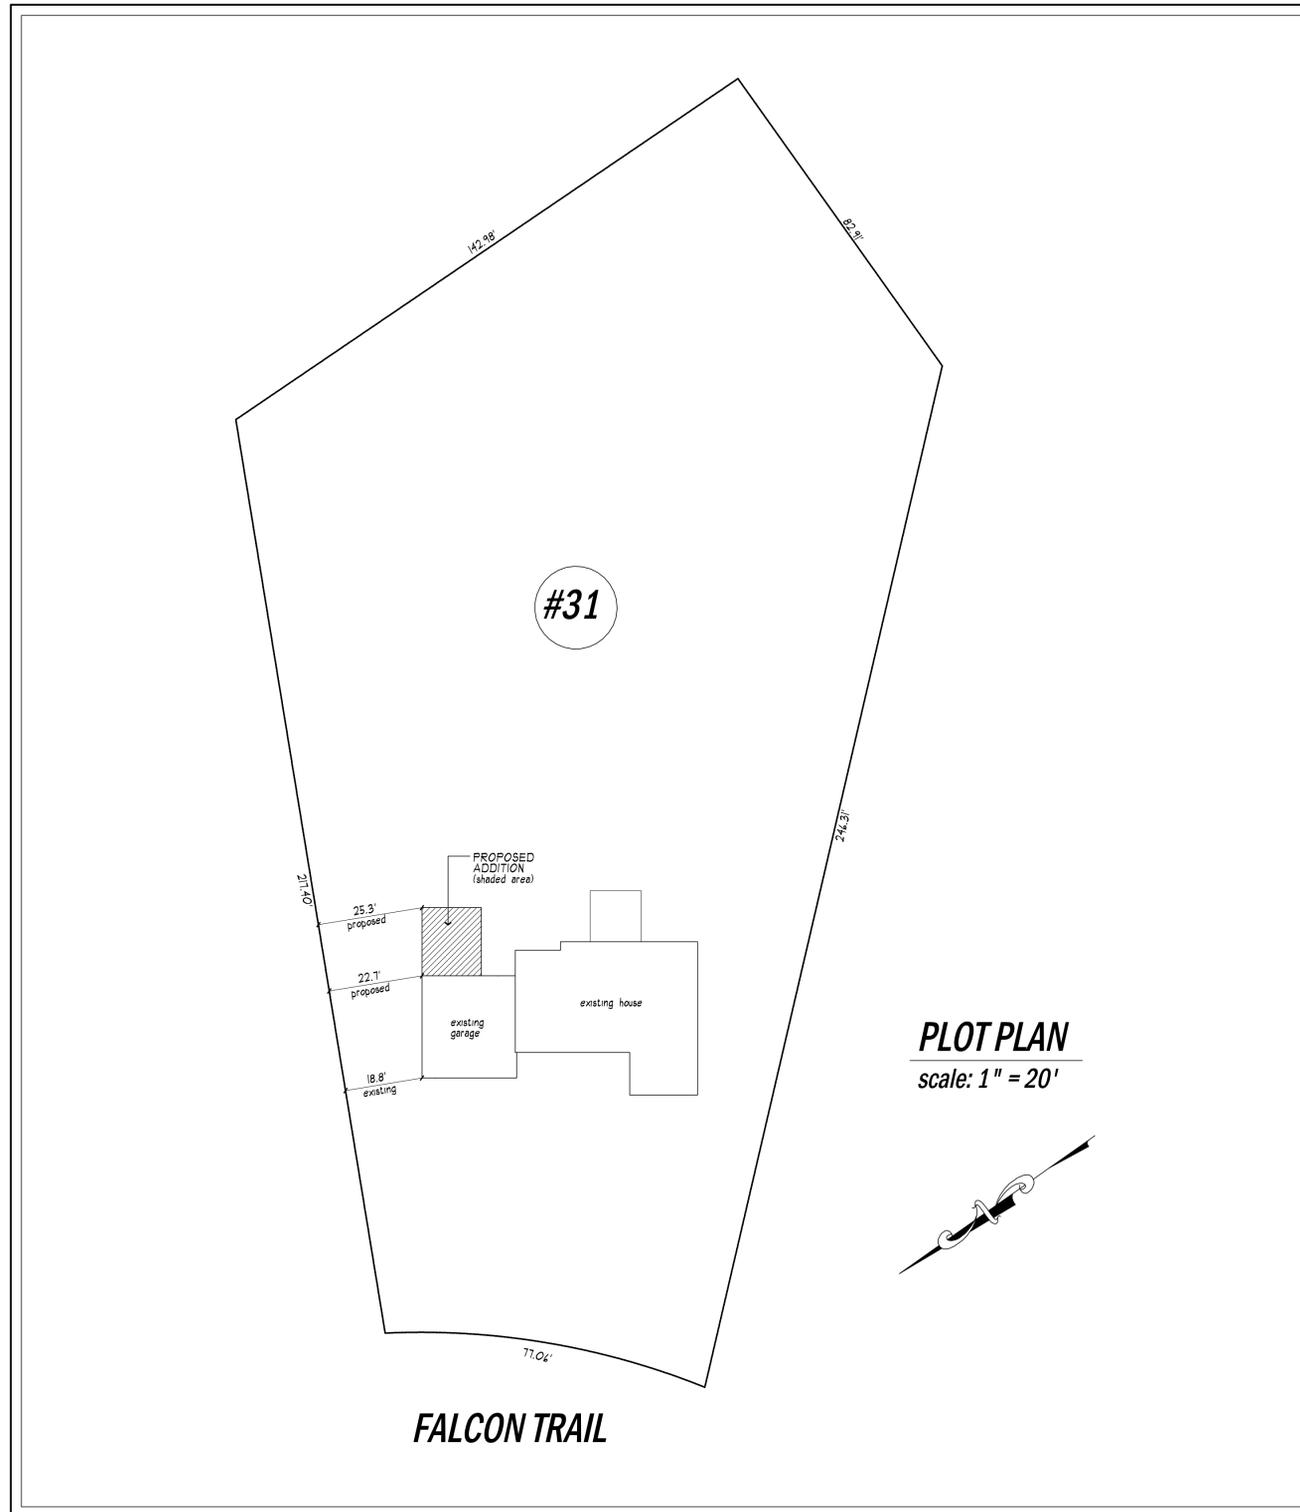

PLOT PLAN
scale: 1" = 20'



DRAWING INDEX

1	TITLE PAGE/PLOT PLAN
2	PROPOSED ELEVATIONS
3	PROPOSED FLOOR PLAN

2020 Energy Conservation Construction Code of New York State

1. A MINIMUM OF 90% OF THE LAMPS IN PERMANENTLY INSTALLED LIGHTING FIXTURES SHALL BE HIGH-EFFICIENCY LAMPS PER SECTION 1104.1
2. RECESSED LUMINARIES INSTALLED IN THE BUILDING THERMAL ENVELOPE SHALL BE SEALED WITH A BASKET OR CAULK BETWEEN THE HOUSING AND THE INTERIOR WALL OR CEILING COVERING TO LIMIT AIR LEAKAGE BETWEEN CONDITIONED AND UNCONDITIONED SPACES. PER SECTION 1102.4.5
3. DUCTWORK ON EXTERIOR WALLS IF REQUIRED SHALL BE INSULATED TO A MINIMUM OF R-6 PER 1105.2.1
4. MECHANICAL VENTILATION PER SECTION 1103.6 TO BE MET WITH CONTINUOUS USE EXHAUST FANS AND MAKE-UP AIR CONTROLS, PER SECTION M507.3.3 REQUIREMENT.
5. MECHANICAL VENTILATION FAN EFFICACY SHALL MEET MINIMUM REQUIREMENTS PER SECTION 1103.6.1.

BASIC DESIGN CRITERIA

1. GROUND SNOW LOAD - 40 PSF R301.2 (5)
2. WIND SPEED - 115 MPH, EXPOSURE B R301.2.1
3. SEISMIC DESIGN CATEGORY - A R301.2 (2)
4. WEATHERING - SEVERE
5. FROST LINE DEPTH - 48"
6. TERMITE DAMAGE - NONE TO SLIGHT
7. DECAY DAMAGE - NONE TO SLIGHT
8. WINTER DESIGN TEMPERATURE - 1
9. ICE SHIELD UNDERLAYMENT REQUIRED - YES
10. FLOOD HAZARD - FIRM - 1992
11. ROOF TIE DOWN REQUIREMENTS R302.11.1

GARAGE STORAGE ADDITION

DAN GILMORE RESIDENCE

31 FALCON TRAIL PITTSFORD, NY



**MORABITO
ARCHITECTS**

PATRICK J. MORABITO, A.I.A. ARCHITECT, P.C.
LICENSED IN CO, MA, ME, NY, PA, SC

121 Sully's Trail
Pittsford, NY 14534

(585) 264-1330
(585) 264-1333 Fax

www.MorabitoArchitects.com

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PROJECT:
GARAGE STORAGE ADDITION
31 FALCON TRAIL
PITTSFORD, NY

CLIENT:
DAN GILMORE

DRAWING:
TITLE PAGE

DRAWN:
PAUL MORABITO

DATE: OCTOBER 2022

SCALE: 1/4" = 1'-0"

JOB NO.: 22PMO422

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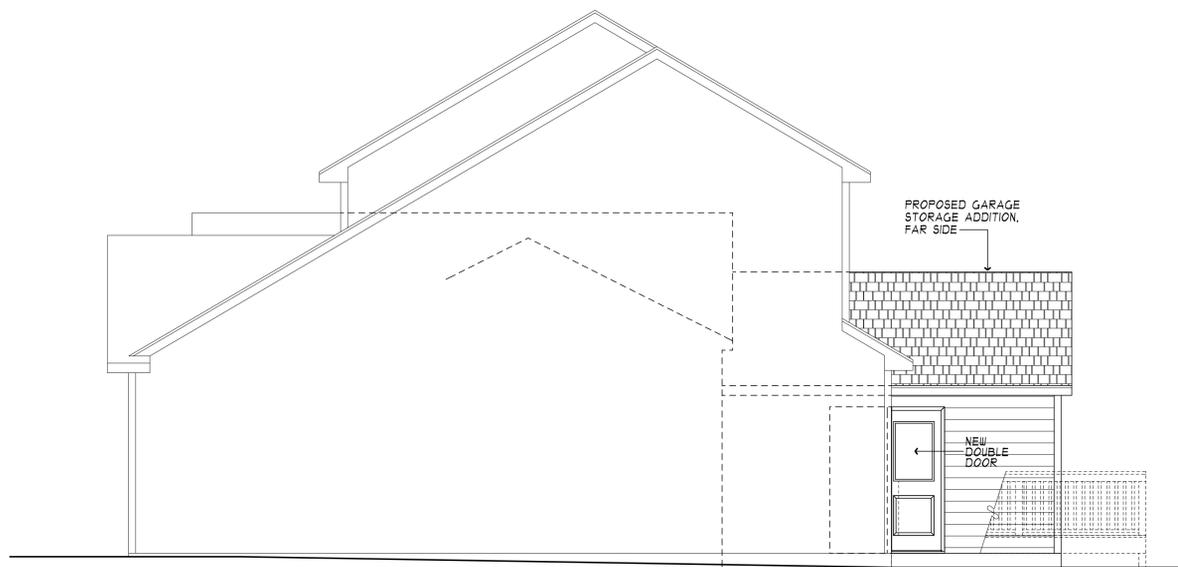
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OF 3 SHEETS






REAR ELEVATION



RIGHT SIDE ELEVATION

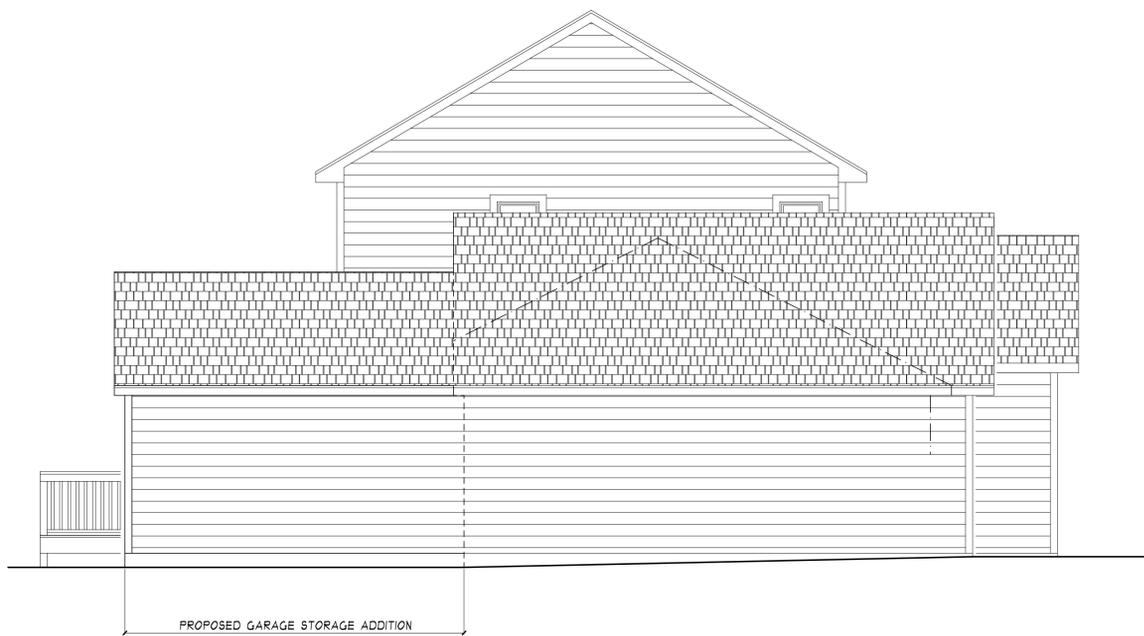

LEFT SIDE ELEVATION



MORABITO ARCHITECTS

PATRICK J. MORABITO, A.I.A. ARCHITECT, P.C.
LICENSED IN CO, MA, ME, NV, NY, PA, SC

121 Sully's Trail
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PROJECT:
GARAGE STORAGE ADDITION
31 FALCON TRAIL
PITTSFORD, NY

CLIENT:
DAN GILMORE

DRAWING:
ELEVATIONS- PROPOSED

DRAWN:
PAUL MORABITO

DATE: OCTOBER 2022

SCALE: 1/4" = 1'-0"


JOB NO.: 22PMO922

SHEET:

2

OF **3** SHEETS



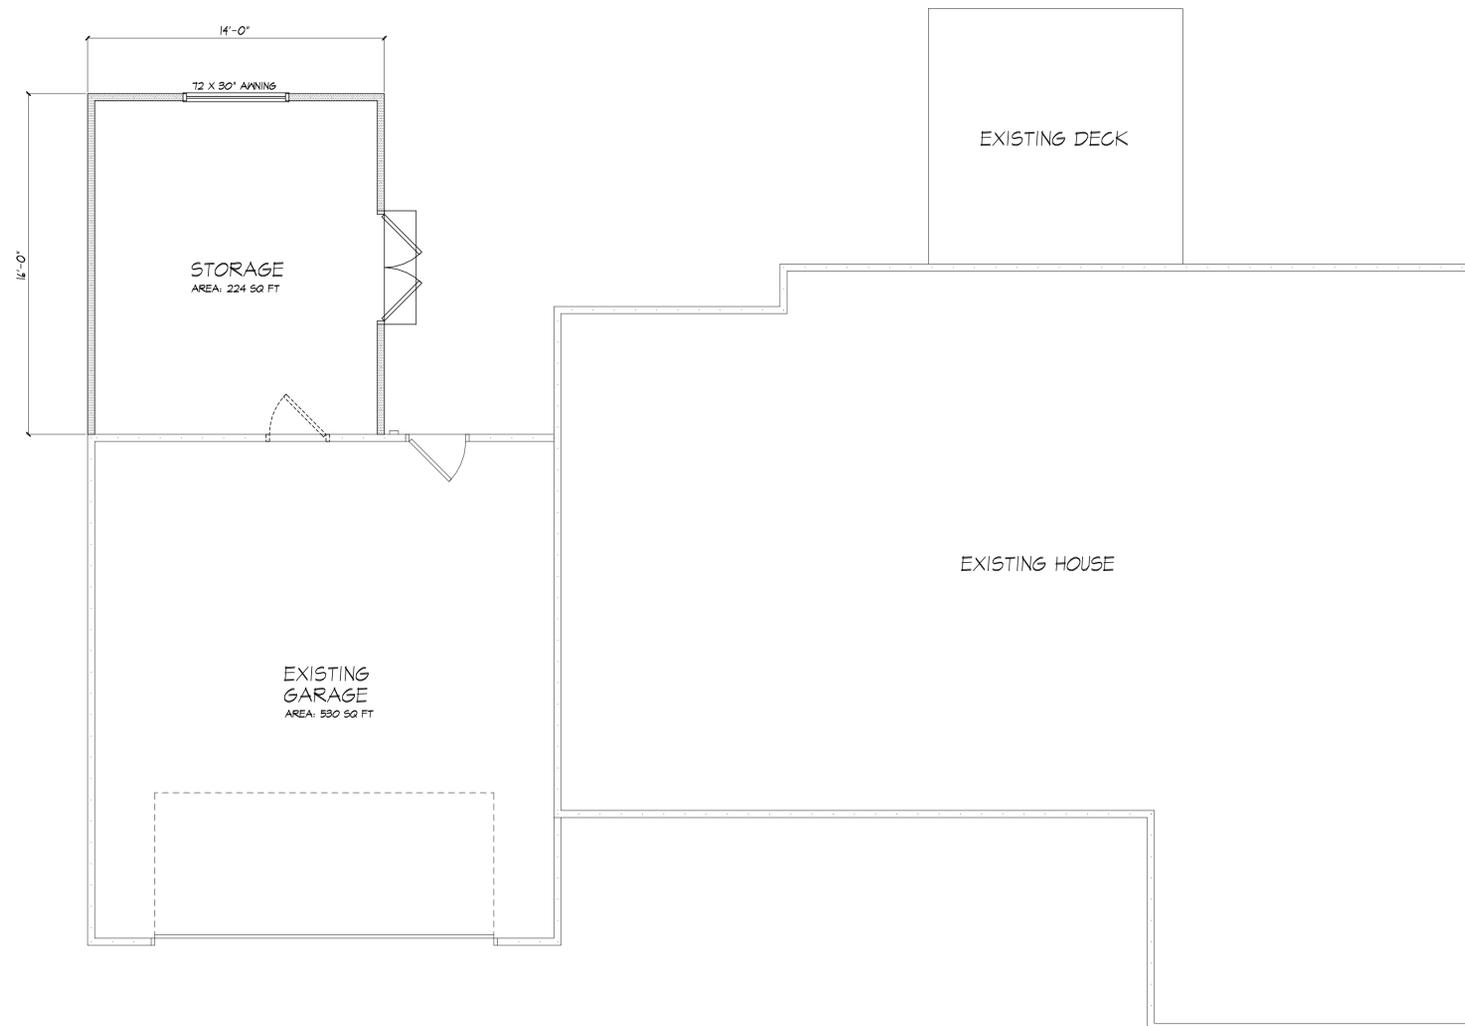

PLAN VIEW



**MORABITO
ARCHITECTS**

PATRICK J. MORABITO, A.I.A. ARCHITECT, P.C.
LICENSED IN CO, MA, ME, NV, NY, PA, SC

121 Sully's Trail
Pittsford, NY 14534

(585) 264-1330
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PATRICK J. MORABITO, A.I.A. ARCHITECT P.C.

PROJECT:
GARAGE STORAGE ADDITION
31 FALCON TRAIL
PITTSFORD, NY

CLIENT:
DAN GILMORE

DRAWING:
PLAN VIEW- PROPOSED

DRAWN:
PAUL MORABITO

DATE: OCTOBER 2022

SCALE: 1/4" = 1'-0"

JOB NO.: 22PM0922


SHEET:

3
OF **3** SHEETS







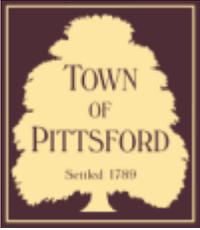

Town of Pittsford

Department of Public Works
11 South Main Street
Pittsford, New York 14534

Permit #
B22-000150

Phone: 585-248-6250
FAX: 585-248-6262

DESIGN REVIEW AND HISTORIC PRESERVATION BOARD REFERRAL OF APPLICATION

Property Address: 25 Whitestone Lane ROCHESTER, NY 14618

Tax ID Number: 137.20-2-27

Zoning District: RN Residential Neighborhood

Owner: Frank Pecora

Applicant: Frank Pecora

Application Type:


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|---|---|
| <input checked="" type="checkbox"/> Residential Design Review
§185-205 (B) | <input type="checkbox"/> Build to Line Adjustment
§185-17 (B) (2) |
| <input type="checkbox"/> Commercial Design Review
§185-205 (B) | <input type="checkbox"/> Building Height Above 30 Feet
§185-17 (M) |
| <input type="checkbox"/> Signage
§185-205 (C) | <input type="checkbox"/> Corner Lot Orientation
§185-17 (K) (3) |
| <input type="checkbox"/> Certificate of Appropriateness
§185-197 | <input type="checkbox"/> Flag Lot Building Line Location
§185-17 (L) (1) (c) |
| <input type="checkbox"/> Landmark Designation
§185-195 (2) | <input type="checkbox"/> Undeveloped Flag Lot Requirements
§185-17 (L) (2) |
| <input type="checkbox"/> Informal Review | |

Project Description: The applicant is requesting design review for the removal of the side entry to add 42 SF of pantry space to the kitchen.


Meeting Date: October 13, 2022



RN Residential Neighborhood Zoning

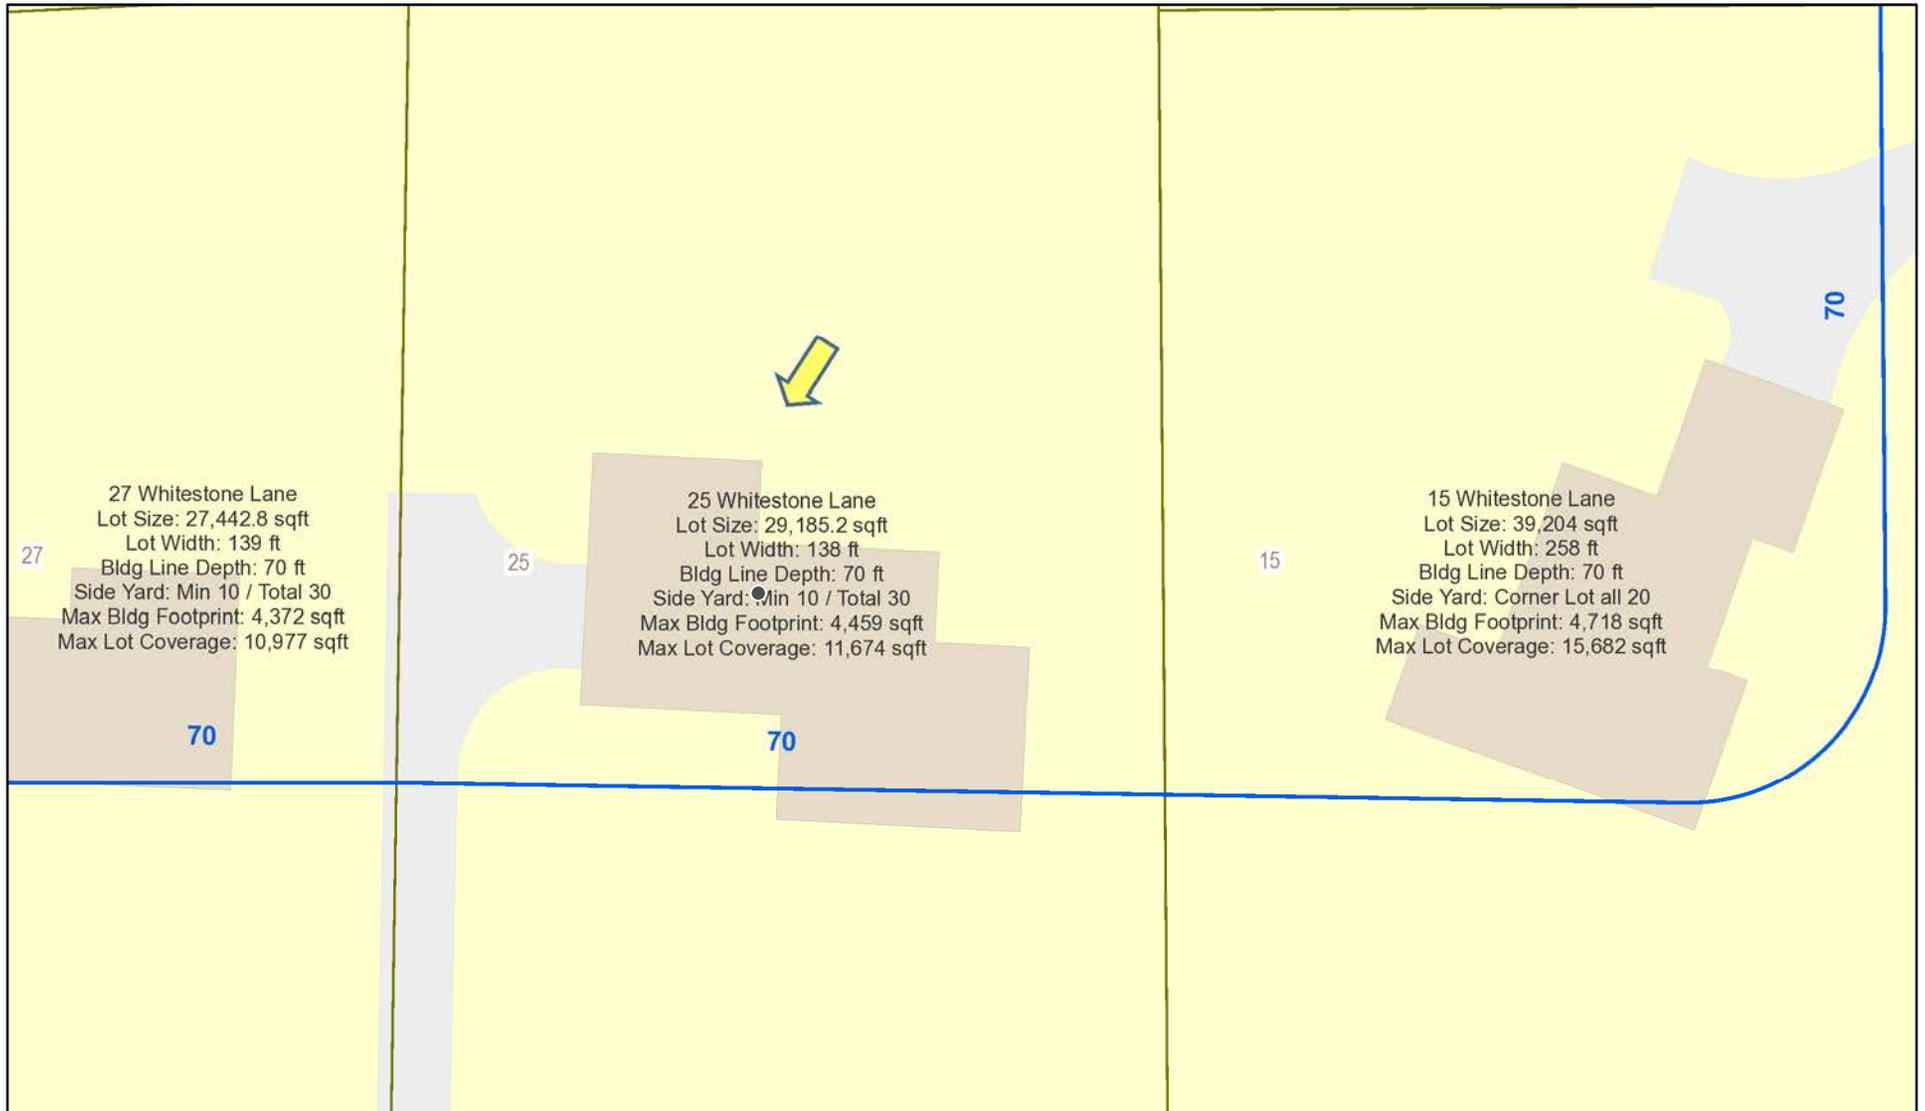


Printed October 5, 2022

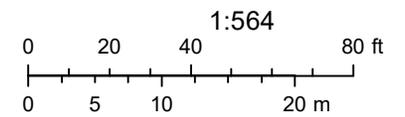

Town of Pittsford GIS

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Whitestone Ln

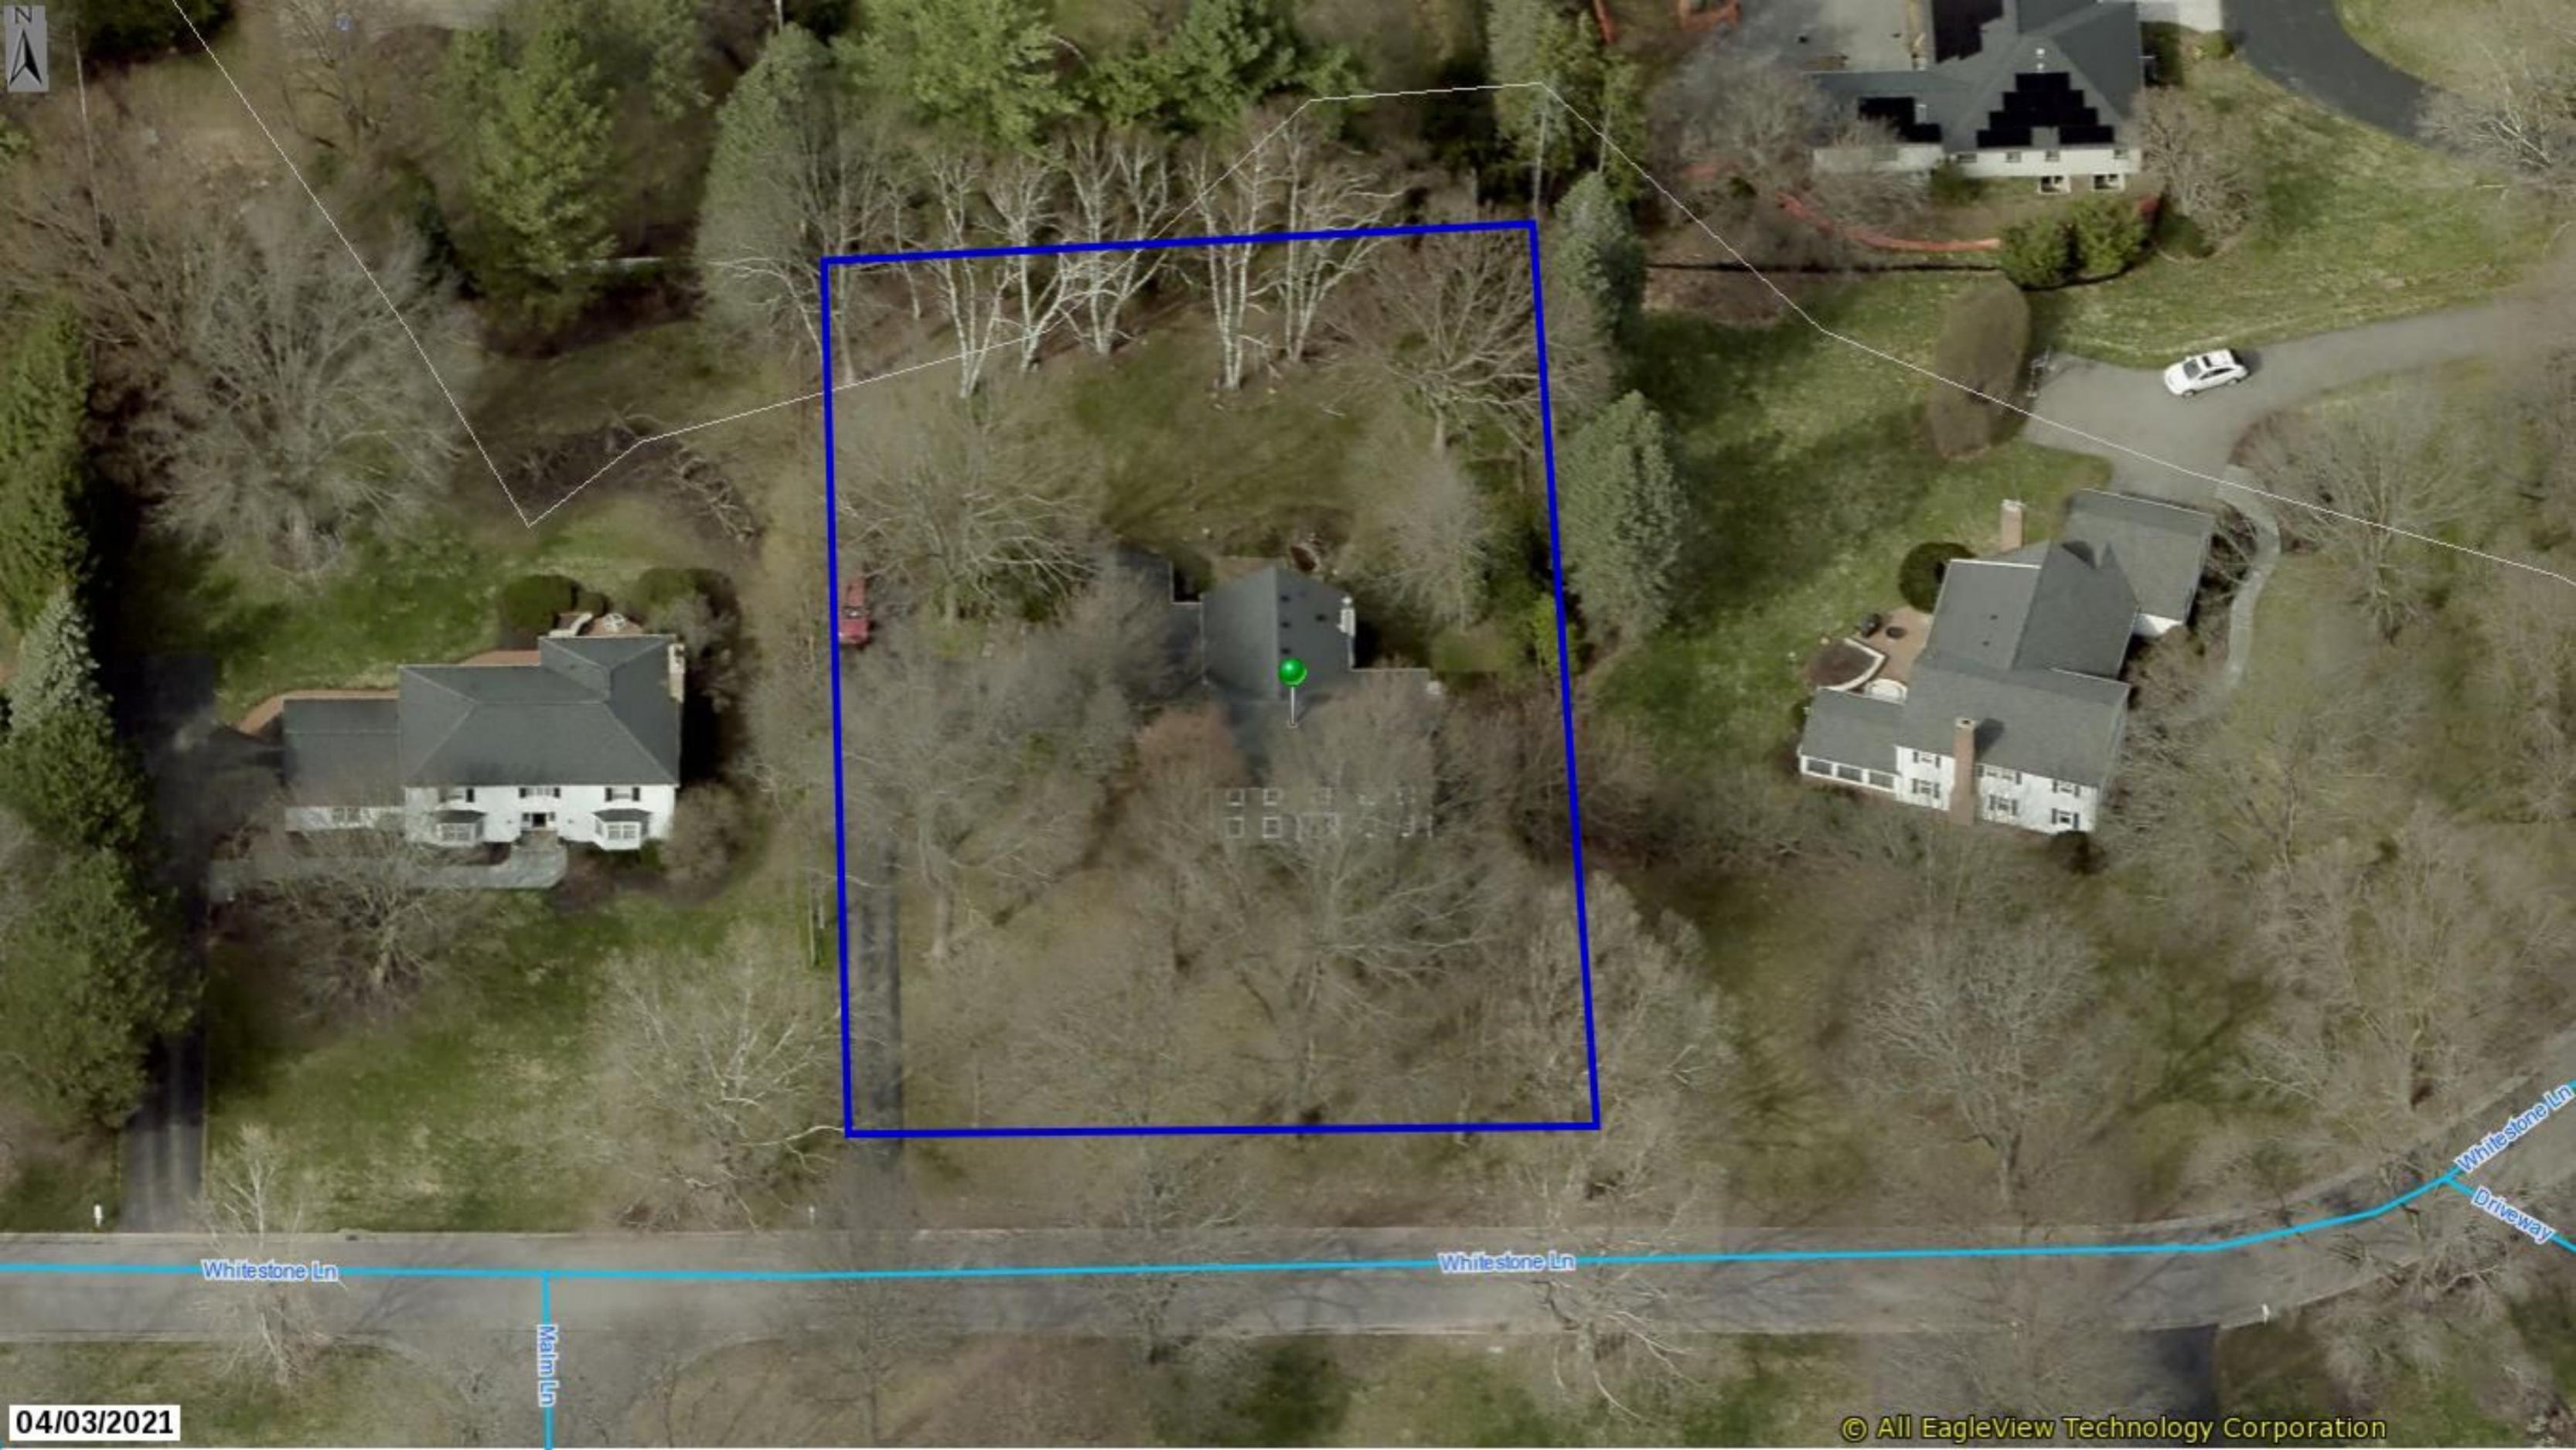Whitestone Ln

Whitestone Ln
Driveway

Malm Ln

04/03/2021

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CONSTRUCTION

Revisions:

Project: EXISTING SINGLE FAMILY RESIDENCE

Client: FRANK & BECKY PECORA

Job Location: 25 WHITESTONE LANE
PITTSFORD, NEW YORK

Drawing Title: ELEVATIONS


Drawn: SMK Checked By:

Date: SEPTEMBER, 2022

Job No: 38579

Sheet

2 of 5

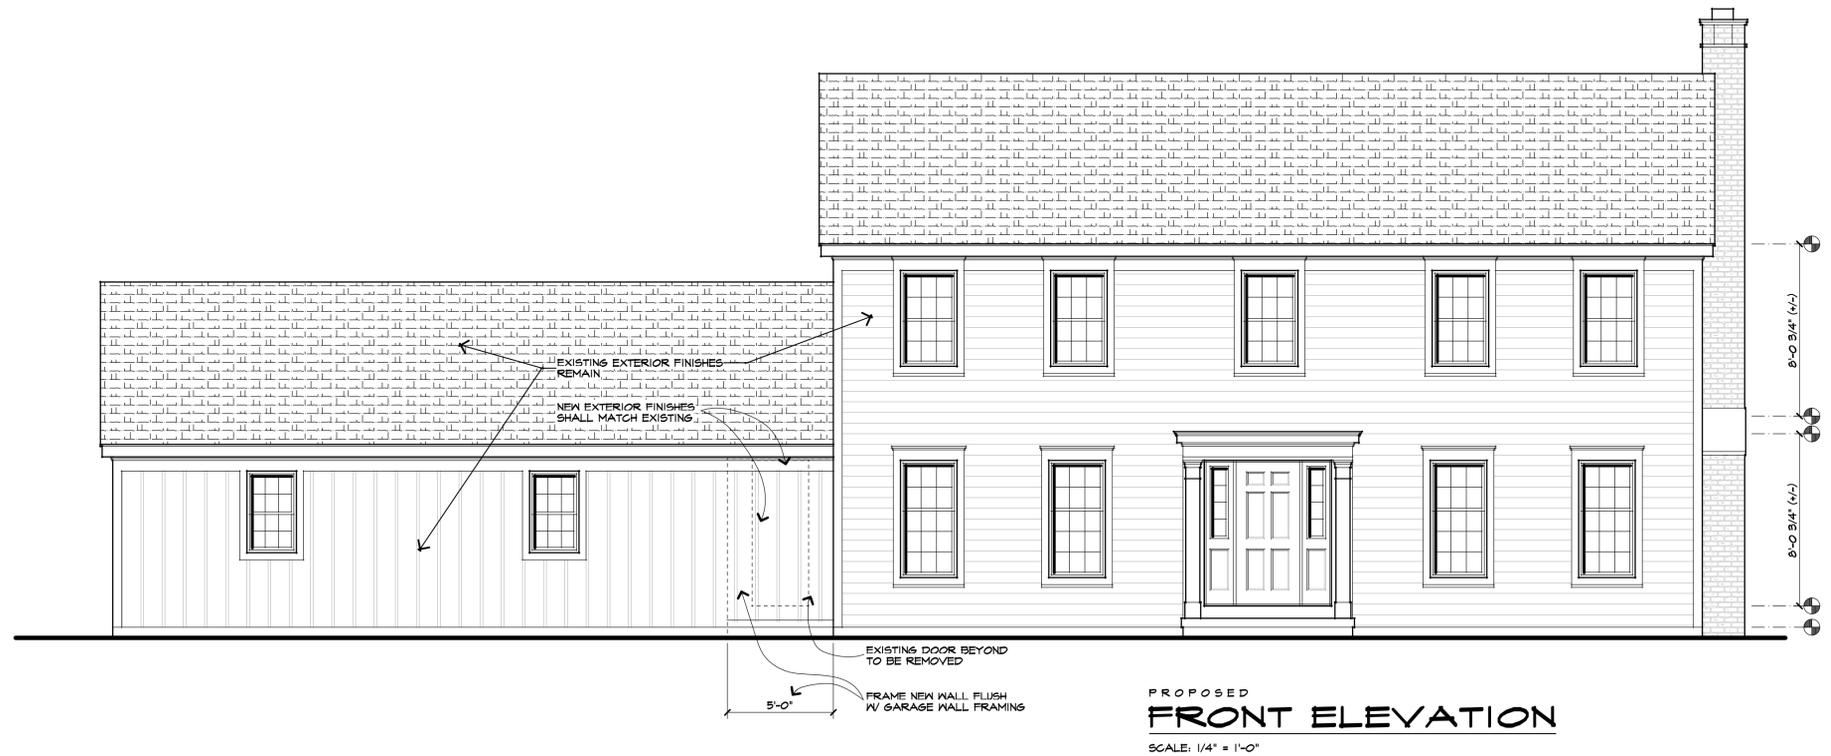

PROPOSED
FRONT ELEVATION


SCALE: 1/4" = 1'-0"



EXISTING
FRONT ELEVATION

SCALE: 1/4" = 1'-0"

UNLESS OTHERWISE NOTED	
ROOFING:	N/A
ROOF VENTING:	ONE SQ.FT. NET PER 300 SQ. FT. ATTIC SPACE (PER EXCEPTION IN R806.2 OF THE CODE)
FACIA:	N/A
FRIEZEBOARDS:	N/A
CORNERBOARDS:	MATCH EXISTING
CASINGS:	
SIDING:	
EAVE O/HANGS:	N/A
RAKE O/HANGS:	N/A
FOOTING DEPTH:	3'-6" BELOW GRADE
PLATE HEIGHT:	
FIRST FLOOR:	8'-0 3/4" (+/-)
SECOND FLOOR:	8'-0 3/4" (+/-)
WINDOW R.O. HEIGHT:	
FIRST FLOOR:	6'-10 1/2"
SECOND FLOOR:	6'-10 1/2"
WINDOW MFR:	"MARVIN ELEVATE" OR EQUAL

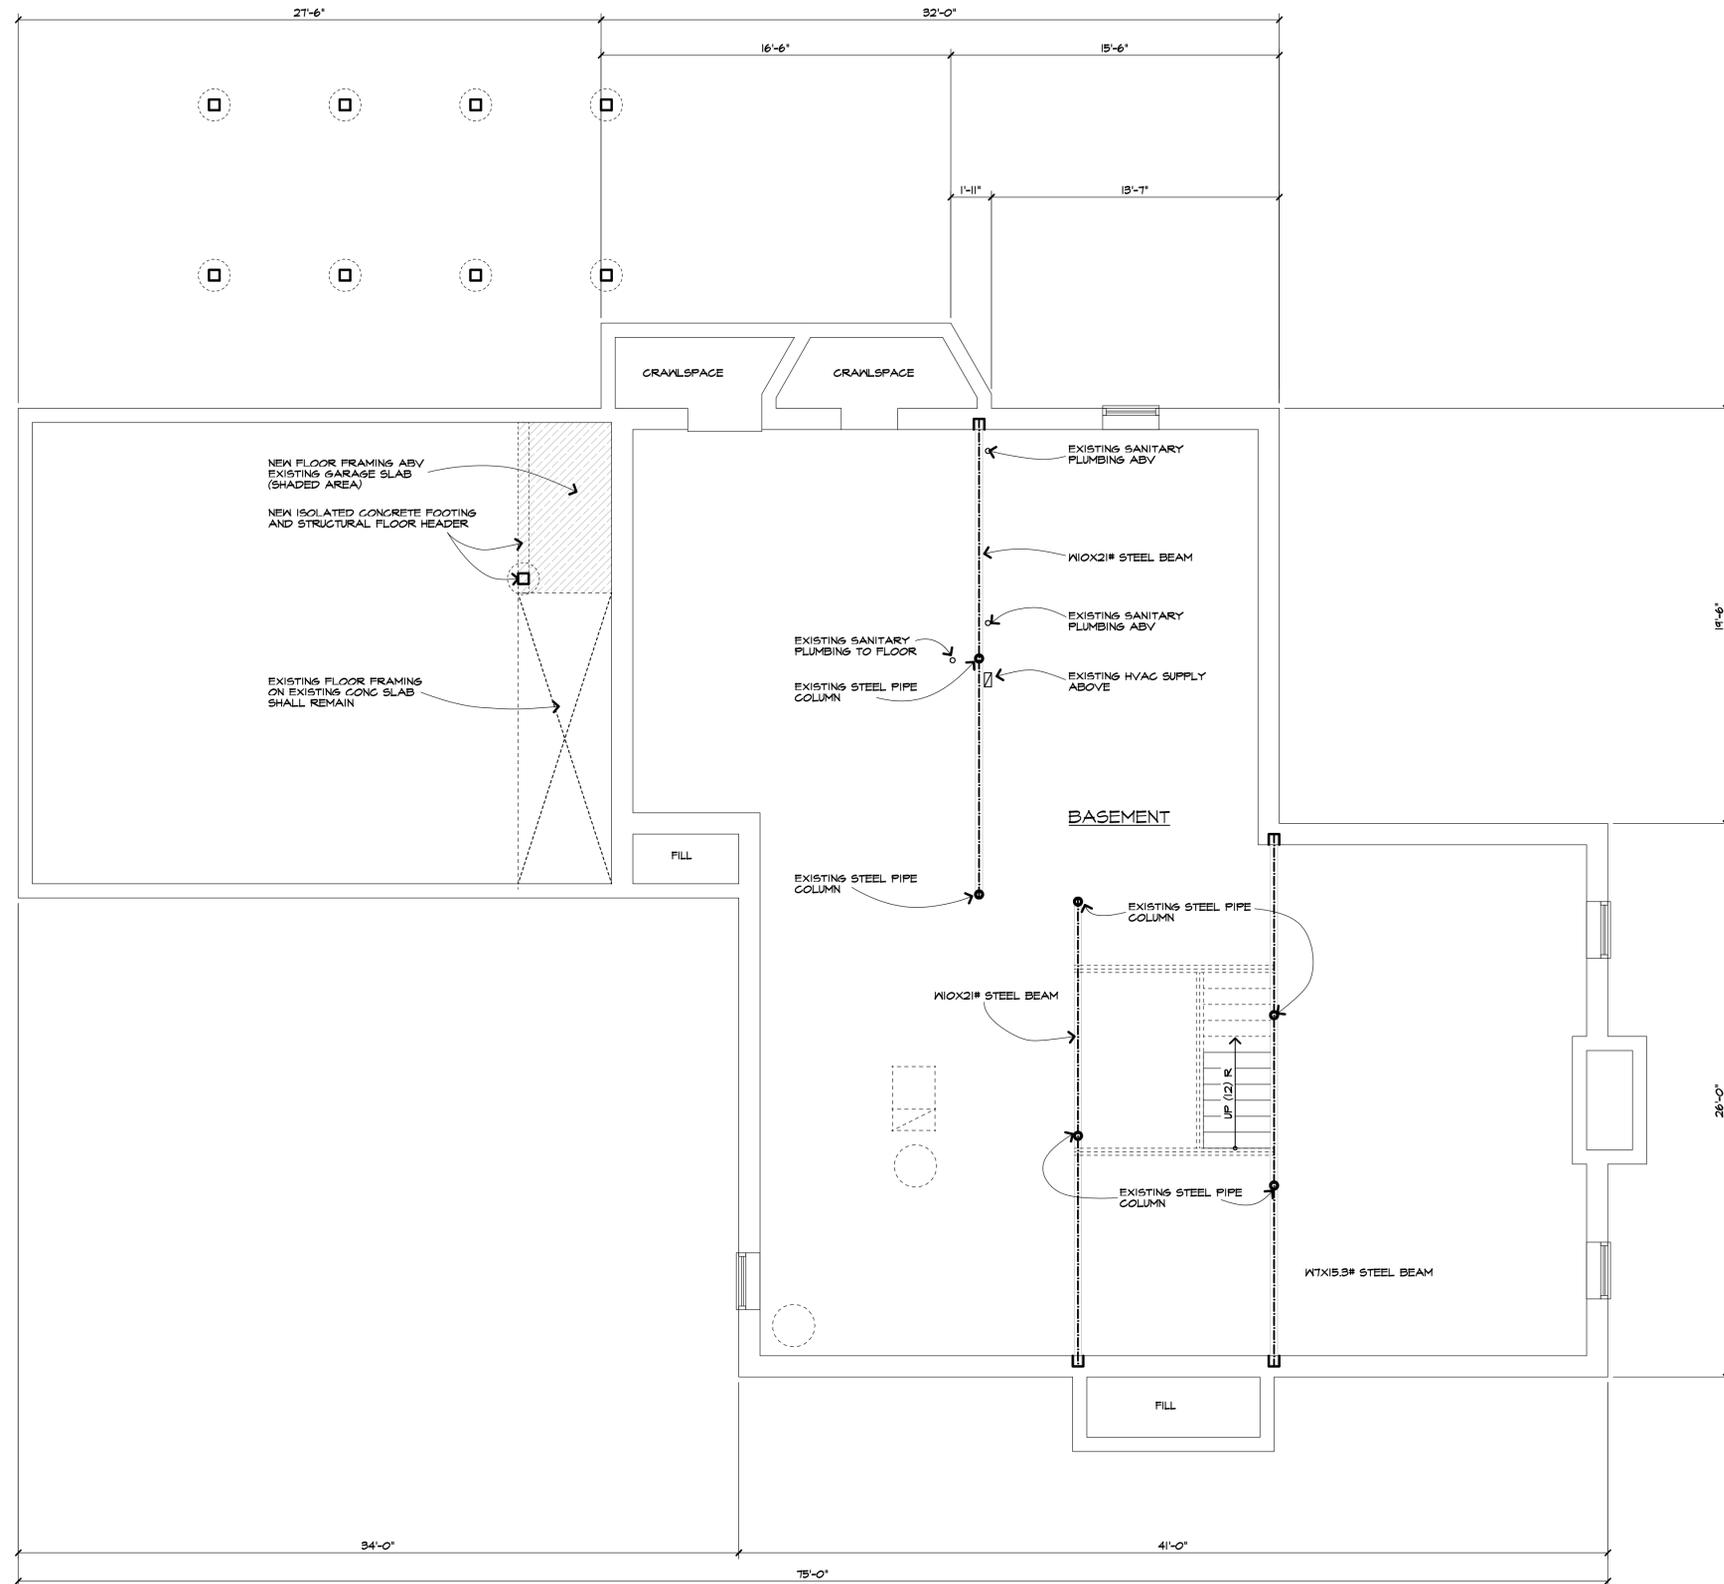

EXISTING
BASEMENT & FOUNDATION PLAN
 SCALE: 1/4" = 1'-0"
 (1) BLOCK COURSE BASEMENT 12" BLOCK

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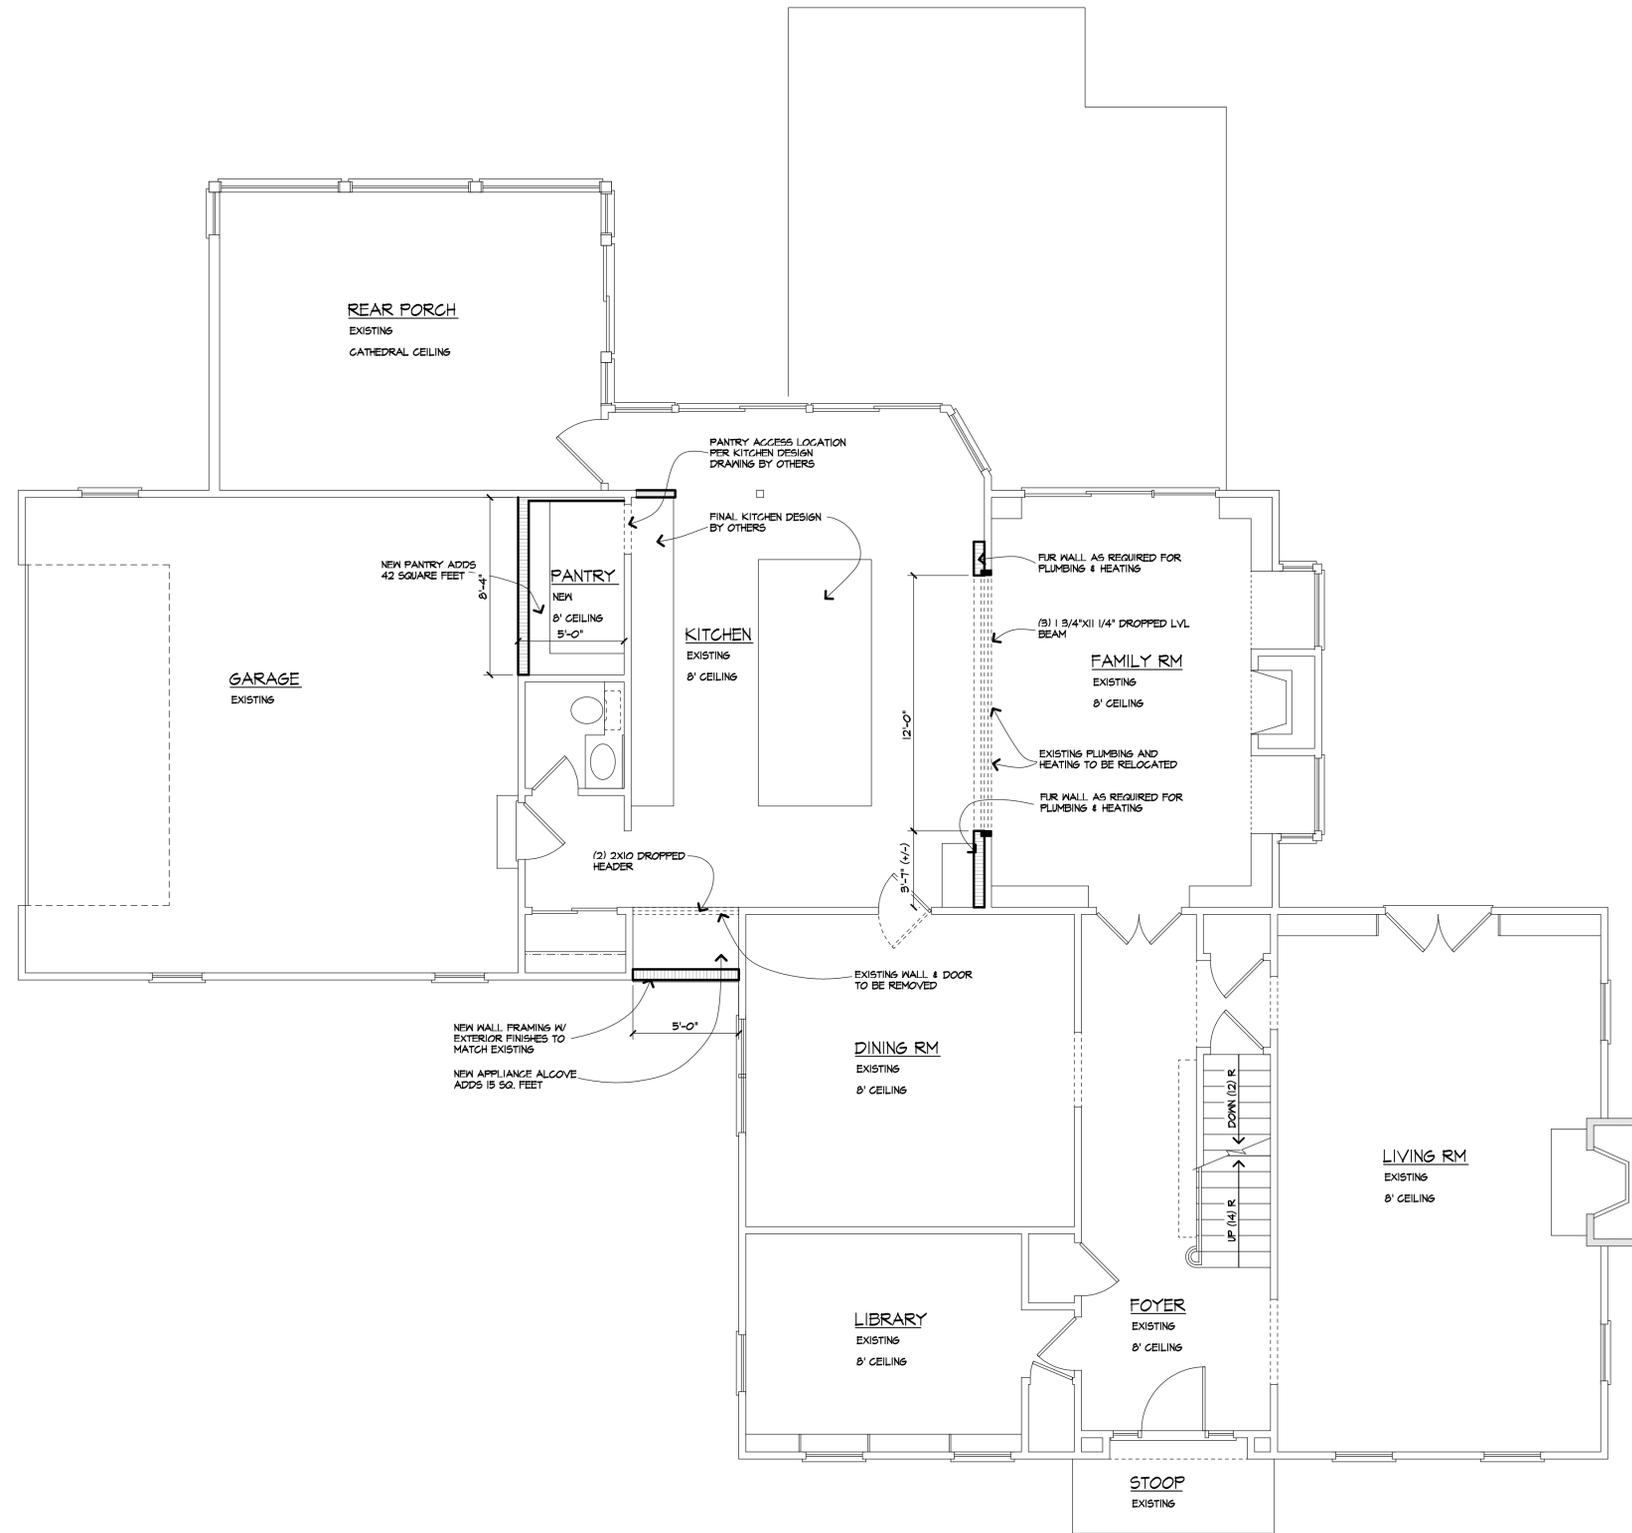
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Revisions:	
Project: EXISTING SINGLE FAMILY RESIDENCE	
Client: FRANK & BECKY PECORA	
Job Location: 25 WHITESTONE LANE PITTSFORD, NEW YORK	
Drawing Title: BASEMENT PLAN	
Drawn: SMK	Checked By:
Date: SEPTEMBER, 2022	
Job No.:	30579
Sheet:	3 of 5



FIRST FLOOR PLAN
 SCALE: 1/4" = 1'-0"
 HEATED ADDITION AREA = 57 SQUARE FEET

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Revisions:

Project: EXISTING SINGLE FAMILY RESIDENCE

Client: FRANK & BECKY PECORA

Job Location: 25 WHITESTONE LANE
 PITTSFORD, NEW YORK

Drawing Title: FIRST FLOOR PLAN

Drawn: SMK Checked By:

Date: SEPTEMBER, 2022

Job No: 30579


Sheet: 4 of 5



Door area to be enclosed

Reworked brick walk



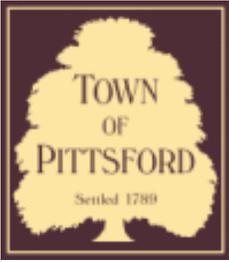

Town of Pittsford

Department of Public Works
11 South Main Street
Pittsford, New York 14534

Permit #
B22-000152

Phone: 585-248-6250

FAX: 585-248-6262

DESIGN REVIEW AND HISTORIC PRESERVATION BOARD REFERRAL OF APPLICATION

Property Address: 4035 East Avenue ROCHESTER, NY 14618

Tax ID Number: 151.06-1-21

Zoning District: RN Residential Neighborhood

Owner: Michael Devin

Applicant: Michael Devin

Application Type:

- | | |
|---|---|
| <input checked="" type="checkbox"/> Residential Design Review
§185-205 (B) | <input type="checkbox"/> Build to Line Adjustment
§185-17 (B) (2) |
| <input type="checkbox"/> Commercial Design Review
§185-205 (B) | <input type="checkbox"/> Building Height Above 30 Feet
§185-17 (M) |
| <input type="checkbox"/> Signage
§185-205 (C) | <input type="checkbox"/> Corner Lot Orientation
§185-17 (K) (3) |
| <input type="checkbox"/> Certificate of Appropriateness
§185-197 | <input type="checkbox"/> Flag Lot Building Line Location
§185-17 (L) (1) (c) |
| <input type="checkbox"/> Landmark Designation
§185-195 (2) | <input type="checkbox"/> Undeveloped Flag Lot Requirements
§185-17 (L) (2) |
| <input type="checkbox"/> Informal Review | |

Project Description: Applicant is requesting design review for the construction of a covered front porch.


Meeting Date: October 13, 2022



RN Residential Neighborhood Zoning



Printed February 3, 2022

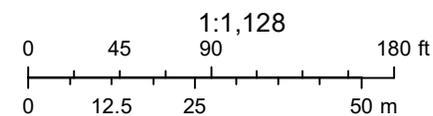

Town of Pittsford GIS

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28

4035

30

4040

4030




4028

4016

REFERENCES:

FIRST AMERICAN TITLE INSURANCE COMPANY #471994 DATED SEPT. 24, 2021
 LIBER 7788 OF DEEDS, PAGE 125
 LIBER 53 OF MAPS, PAGE 8

REPUTED OWNER
ASHLEY & ANDREW BILLONE
 #30 SAN RAFAEL DRIVE

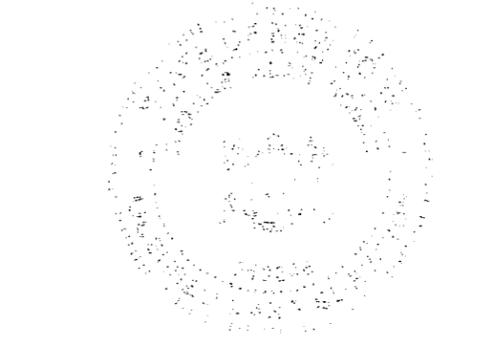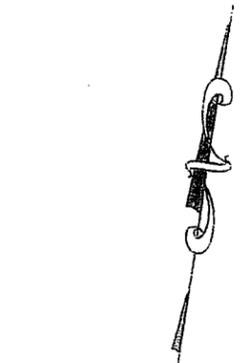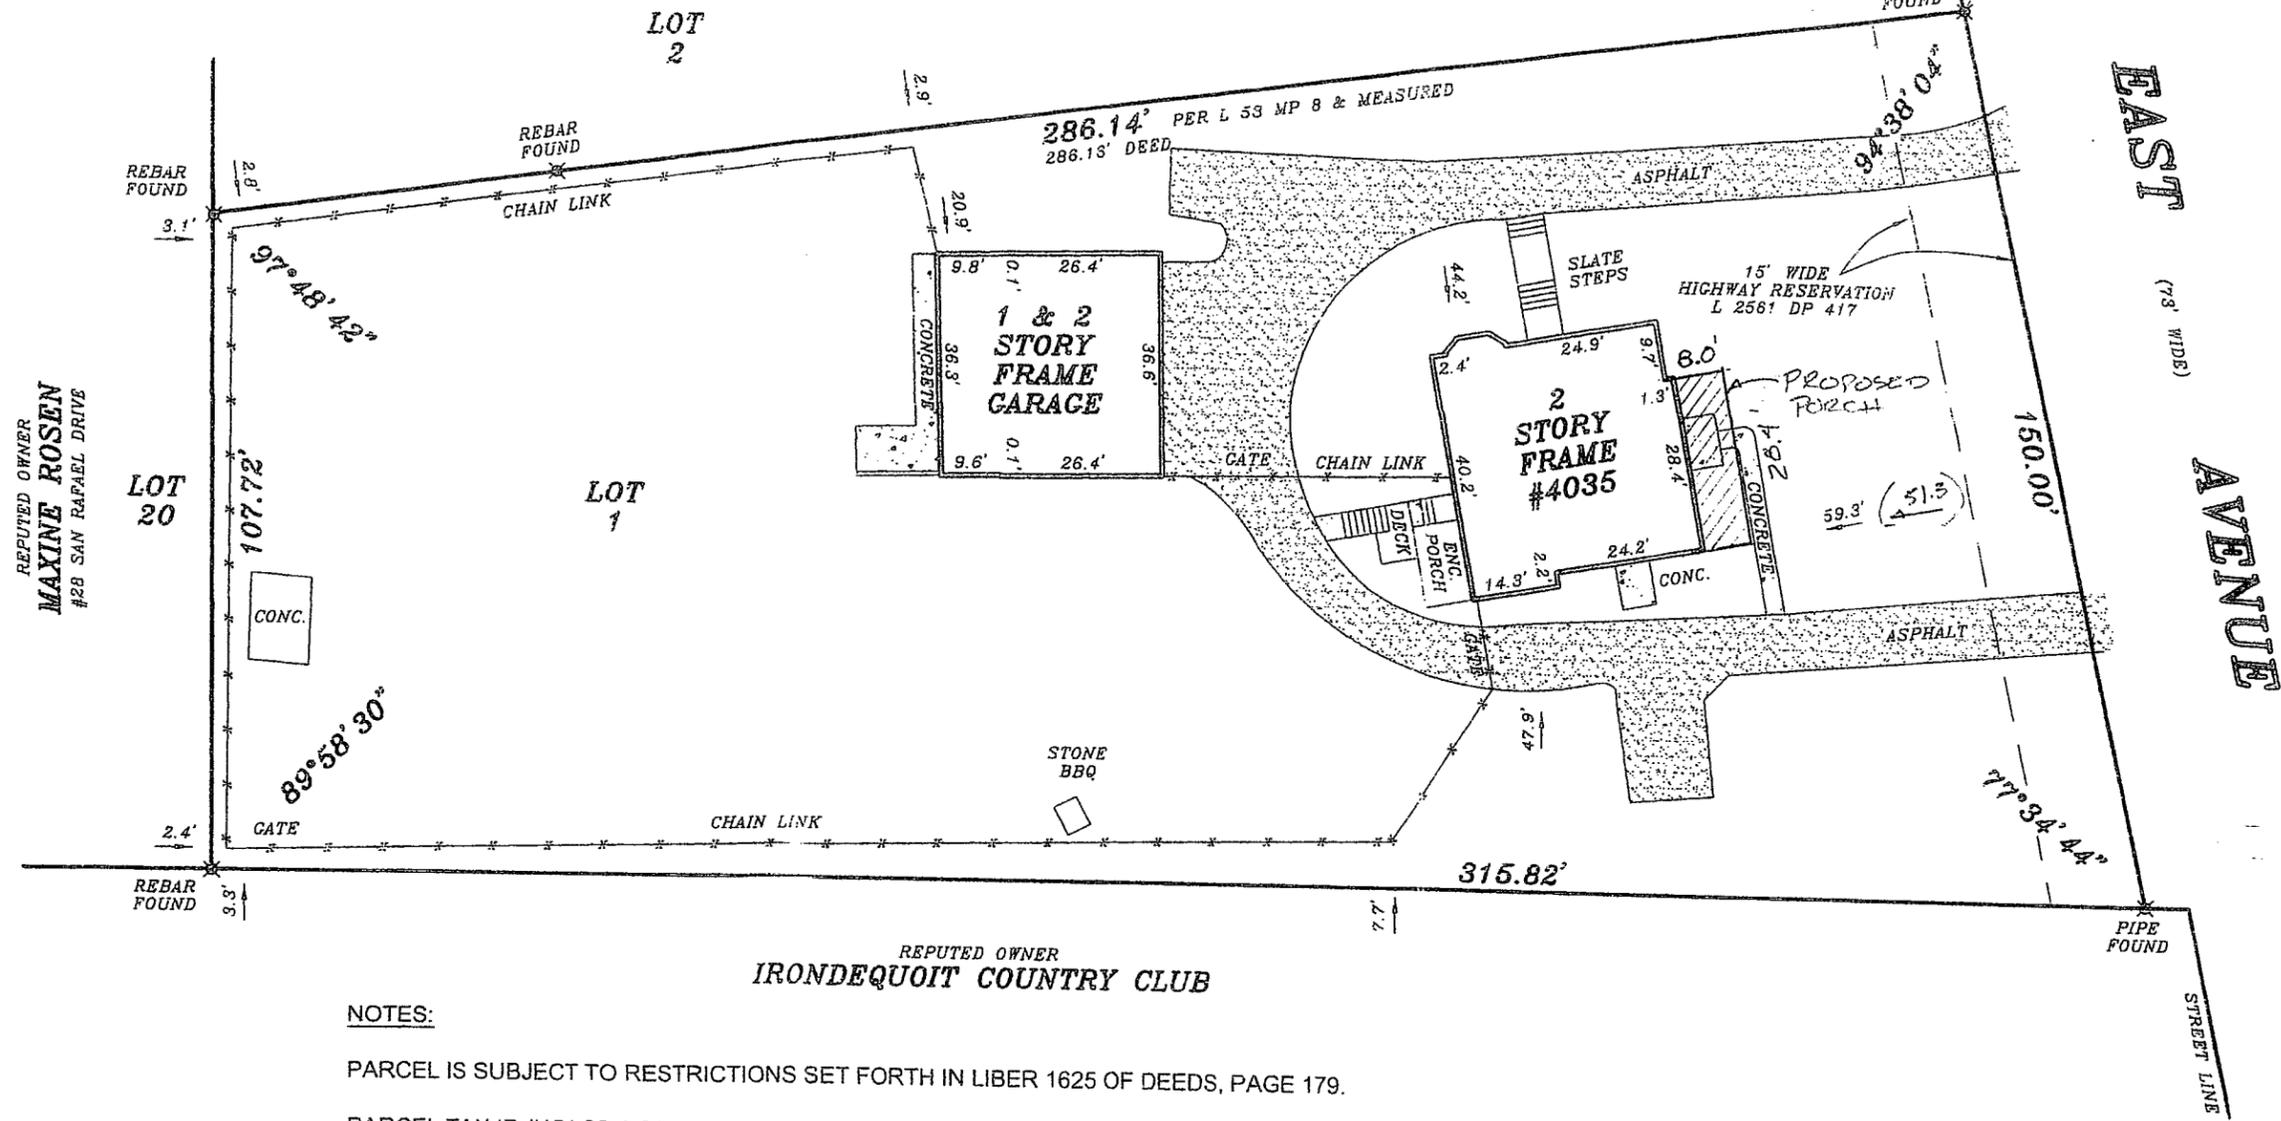

REPUTED OWNER
IRONDEQUOIT COUNTRY CLUB

NOTES:

PARCEL IS SUBJECT TO RESTRICTIONS SET FORTH IN LIBER 1625 OF DEEDS, PAGE 179.

PARCEL TAX ID #151.06-1-21


WE, O'NEILL-RODAK LAND SURVEYING ASSOCIATES, P.C., CERTIFY TO:

1. MICHAEL DEVINE & WENDY DEVINE
2. HANDELMAN, WITKOWICZ & LEVITSKY
3. CHICAGO TITLE INSURANCE COMPANY

THAT THIS MAP WAS PREPARED FROM NOTES OF AN INSTRUMENT SURVEY COMPLETED OCTOBER 11, 2021.

Thomas A. Rodak
 THOMAS A. RODAK, P.L.S. #050246

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 Guarantees or certifications are not transferable to the institutions or subsequent owners"

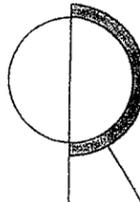 <p>O'NEILL-RODAK LAND SURVEYING ASSOCIATES, P.C. LAND SURVEYORS - PLANNERS BOUNDARY CONSULTANTS FLOOD ZONE DETERMINATIONS ALTA/NSPS SURVEYS</p>	MAP OF A SURVEY LOT 1 OVERBROOK SUBDIVISION TOWN OF PITTSFORD MONROE COUNTY, NEW YORK		
	CLIENT UNDERBERG & KESSLER LLP		
5 SOUTH FITZHUGH STREET ROCHESTER, NY 14614 PHONE (585) 325-7520 FAX (585) 325-1708 e-mail surveyors@oneillrodak.com	SCALE 1" = 30'	DATE 05/08/2017 REDATED 10/18/2021	PROJECT NO. 2017-0499



ASPHALT SHINGLE ROOF

CEM BRD.
SDR

STEEL ROOF

CEM BRD
TRIM

EAST ELEVATION


1/4"=1'-0

4035 EAST AVE

MARK P. MULLER
ARCHITECT


Tel 657-6905

3509 Taft Road
Bloomfield, NY 14469

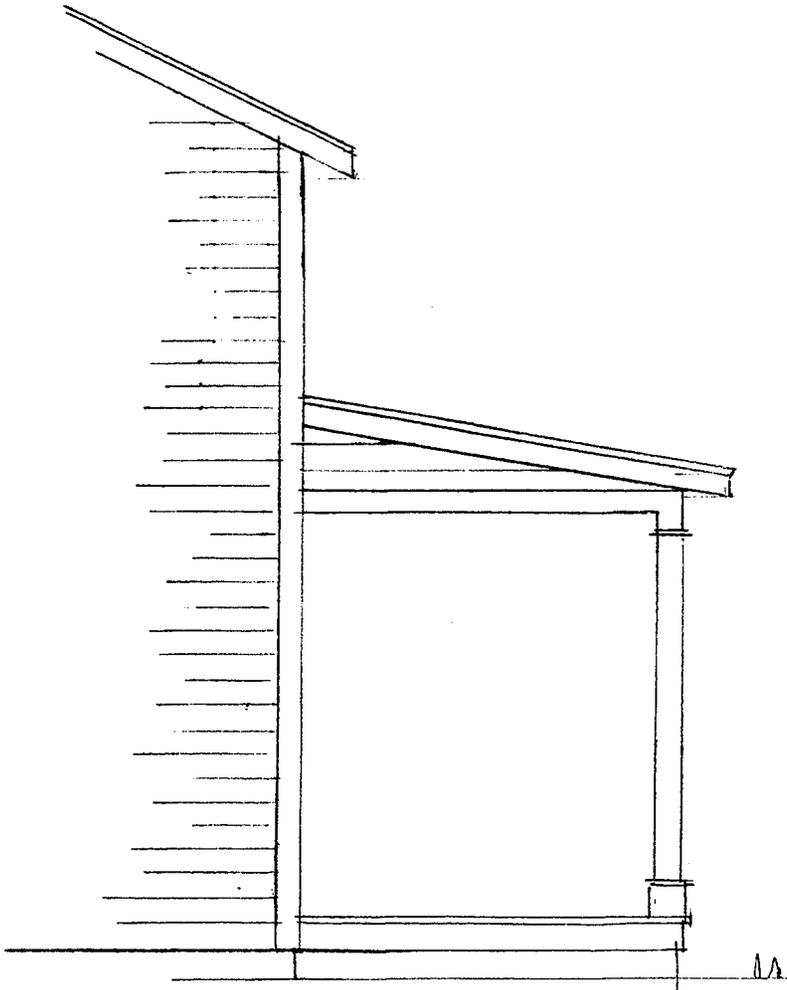

SOUTH ELEV.

$\frac{1}{4}'' = 1'-0$

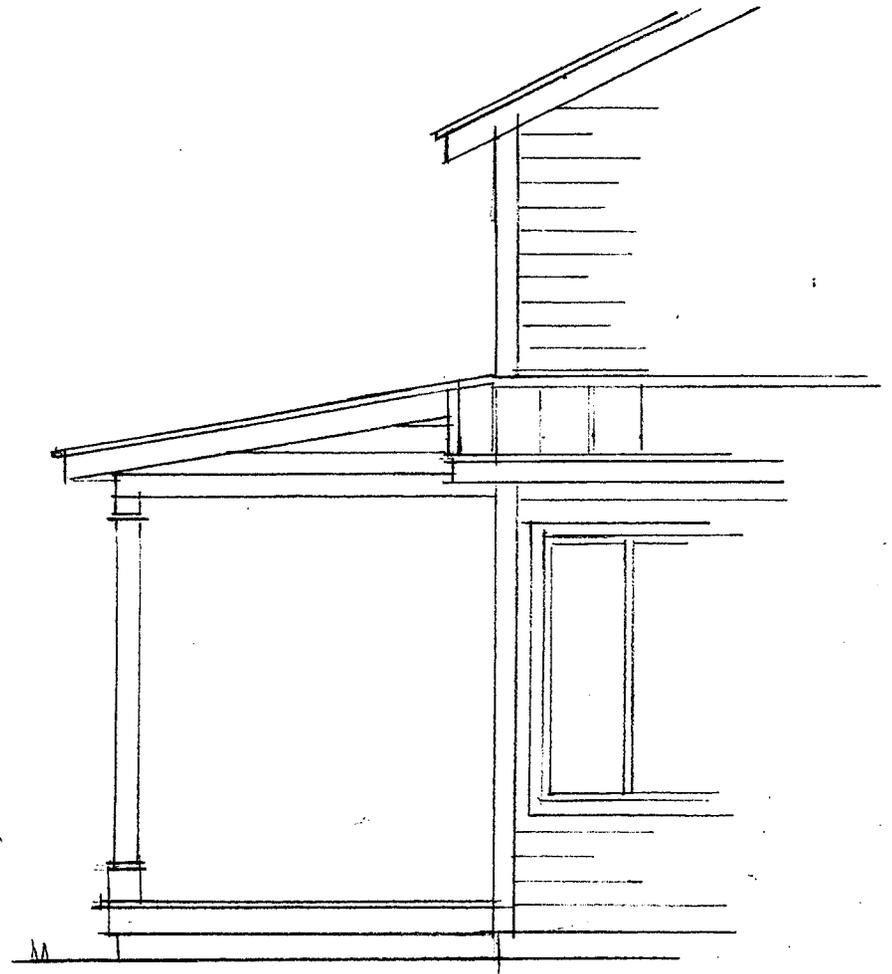


NORTH ELEV.

$\frac{1}{4}'' = 1'-0$







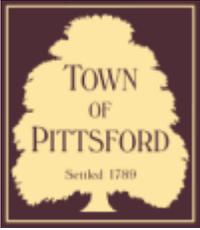

Town of Pittsford

Department of Public Works
11 South Main Street
Pittsford, New York 14534

Permit #
B22-000146

Phone: 585-248-6250
FAX: 585-248-6262

DESIGN REVIEW AND HISTORIC PRESERVATION BOARD REFERRAL OF APPLICATION

Property Address: 19 High Street PITTSFORD, NY 14534

Tax ID Number: 151.14-1-59.1

Zoning District: RN Residential Neighborhood

Owner: Imburgia, Samuel J

Applicant: Gerber Homes & Additions LLC


Application Type:

- | | |
|---|---|
| <input checked="" type="checkbox"/> Residential Design Review
§185-205 (B) | <input type="checkbox"/> Build to Line Adjustment
§185-17 (B) (2) |
| <input type="checkbox"/> Commercial Design Review
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§185-17 (M) |
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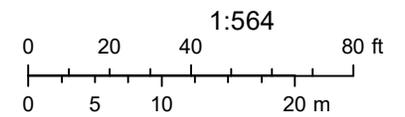
Project Description: Applicant is requesting design review for the construction of a one story single family home. The home will be approximately 2070 square feet including the garage

Meeting Date: October 13, 2022

RN Residential Neighborhood Zoning

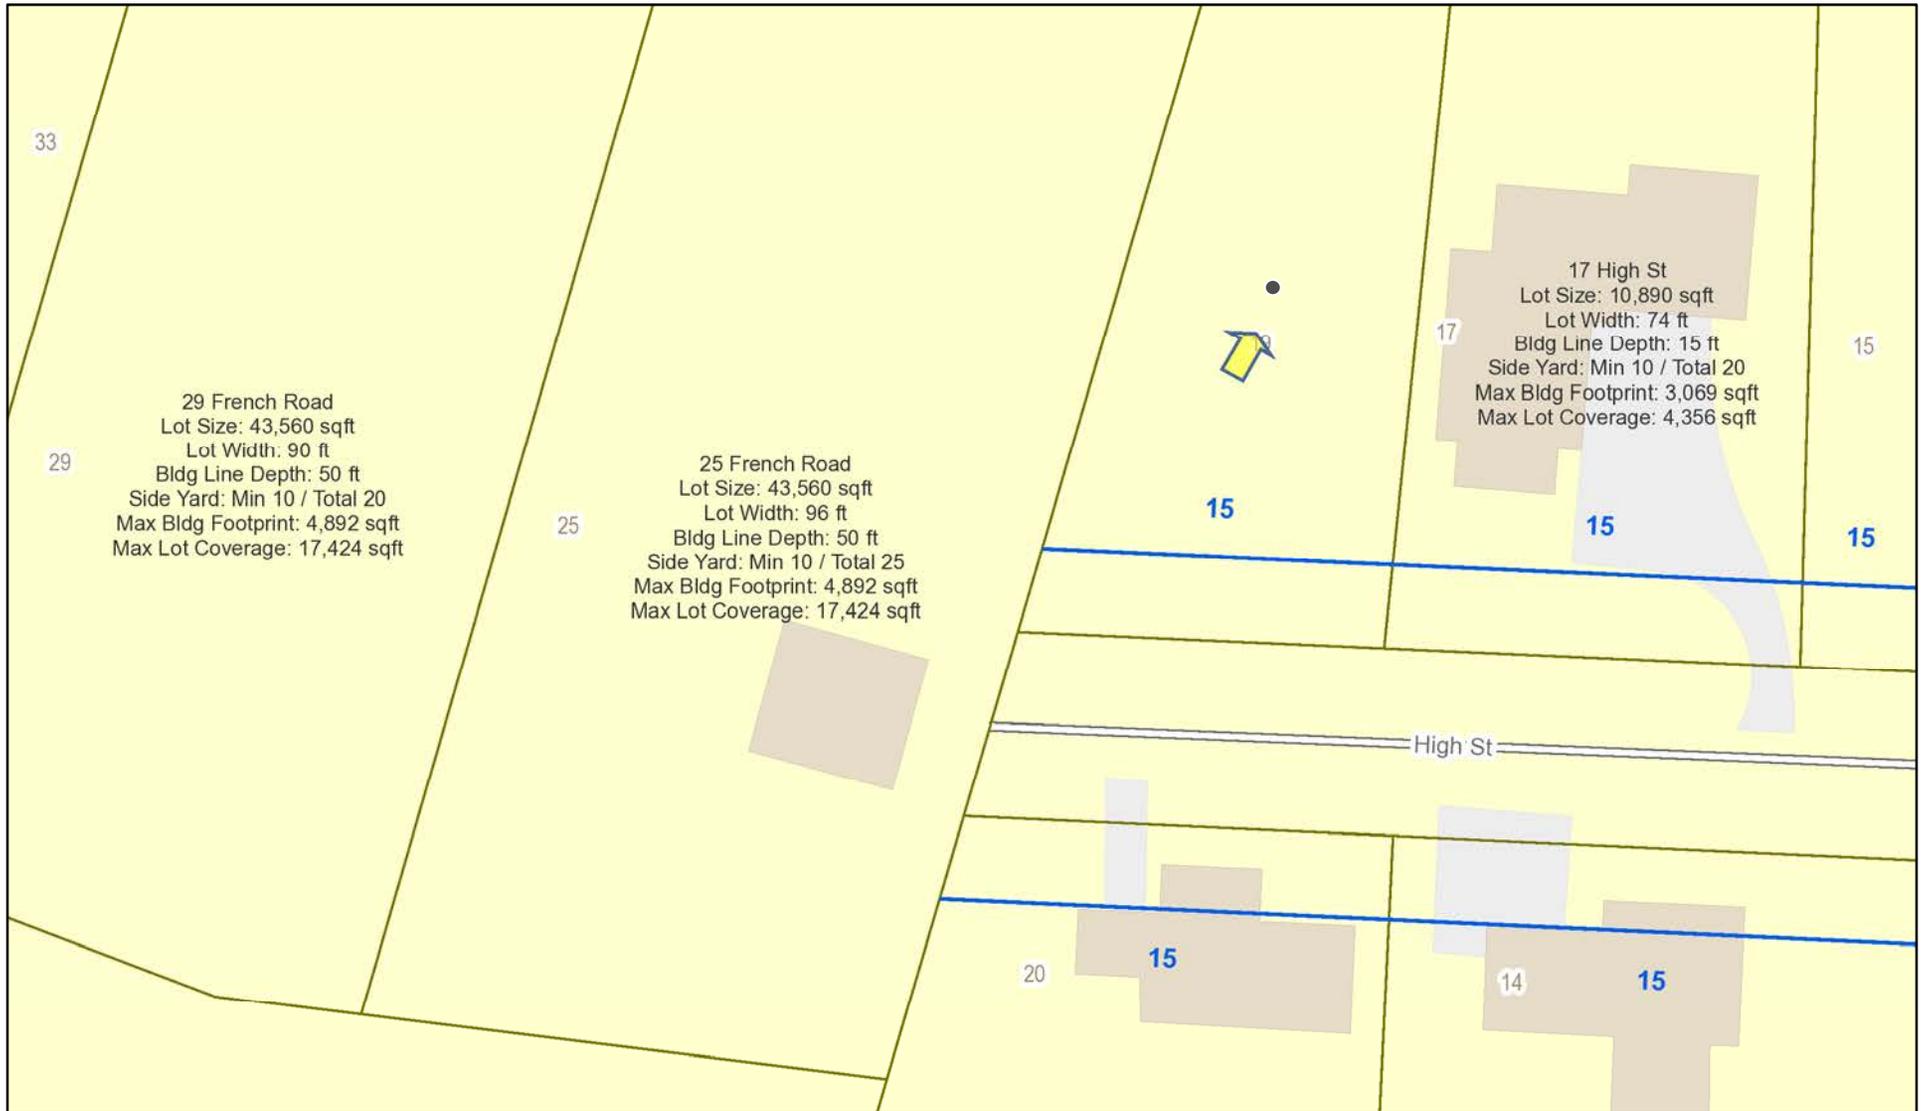

Printed October 4, 2022



Town of Pittsford GIS

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Kosinski Residence

Town of PITTSFORD, NEW YORK

STRUCTURAL LOADING DESIGN CRITERIA:

- ALL LOADS IN POUNDS PER SQUARE FOOT

LOCATION	LIVE	DEAD	LIMIT
1ST FLOOR	40	15	L/860
2ND FLOOR (SLEEPING)	30	10	L/860
2ND FLOOR (NON-SLEEPING)	40	10	L/860
ATTIC (NO STORAGE)	10	5	L/240
ATTIC (LIGHT STORAGE)	20	10	L/240
ROOF (W/ FINISHED CLNG.)	20	20	L/240
ROOF (W/ NO FINISHED CLNG.)	15	15	L/180
DECKS	50	10	L/860

NOTE: ASSUMED SAFE SOIL BEARING CAPACITY IS 2000 PSF AT MIN. FROST DEPTH. VALUES MAY BE INCREASED IF SITE SPECIFIC SOIL CLASSIFICATION OR LOAD BEARING TEST DATA IS AVAILABLE.

INSULATION AND FENESTRATION REQUIREMENTS BY COMPONENT:

-TABLE N1021.2 2020 RESIDENTIAL CODE
MONROE COUNTY

CLIMATE ZONE	FENESTRATION U-FACTOR	SKYLIGHT U-FACTOR	GLAZED FENESTRATION SHGC	CEILING R-VALUE	WOOD FRAME WALL R-VALUE	MASS WALL R-VALUE	FLOOR R-VALUE	BASEMENT WALL R-VALUE	SLAB R-VALUE DEPTH	CRAWL SPACE WALL R-VALUE
5	0.30	0.35	NR	44	20 OR 15 + 5	15 / 17	30	15 / 14	10 / 2 ft HEATED SLAB 5	15 / 14

CLIMATIC & GEOGRAPHICAL DESIGN CRITERIA:

-TABLE R501.2(1) 2020 RESIDENTIAL CODE

GROUND SNOW LOAD (psf)	WIND SPEED (mph)	SEISMIC DESIGN CATEGORY	SUBJECT TO DAMAGE FROM				ICE SHIELD UNDERLAYMENT REQUIRED	FLOOD HAZARDS
			WEATHERING	FROST LINE DEPTH	TERMITES	DECAY		
40	115	B	SEVERE	42"	SLIGHT TO MODERATE	NONE TO SLIGHT	YES	NO

LIST OF DRAWINGS:

- A-0.0 Cover Sheet
- A-0.1 Standard Details
- A-1.1 Foundation Plan and Wall Section
- A-2.1 Floor Plans
- A-3.1 Building Sections
- A-4.1 Exterior Elevations

GENERAL NOTES & CODE

GENERAL NOTES:

- THIS SET OF PLANS HAS BEEN DESIGNED AND SHALL BE BUILT TO COMPLY WITH THE RESIDENTIAL CODE OF NYS AND MEETS OR EXCEEDS THE NYS ENERGY CONSERVATION CODE. IN ADDITION, CONSTRUCTION SHALL COMPLY WITH ALL LOCAL, STATE AND FEDERAL CODES AND REGULATIONS.
- GENERAL CONTRACTOR IS RESPONSIBLE FOR MEANS, METHODS, TECHNIQUES, SEQUENCE AND SAFETY ISSUES IN REFERENCE TO THE CONSTRUCTION CONTRACT.
- GENERAL CONTRACTOR TO VERIFY ALL EXISTING CONDITIONS, REQUIREMENTS, NOTES, AND DIMENSIONS PRIOR TO START OF CONSTRUCTION. ANY DISCREPANCIES SHALL BE BROUGHT TO THE ATTENTION OF THE ARCHITECT.
- GENERAL CONTRACTOR TO PROVIDE ADEQUATE SUPPORT OF EXISTING FOUNDATION WALLS, LOAD BEARING WALLS AND PARTITIONS DURING DEMOLITION (IF APPLICABLE TO PROJECT) AND CONSTRUCTION.
- ALL PRE-ENGINEERED ROOF & FLOOR SYSTEMS AND THEIR BLOCKING/BRACING TO BE CERTIFIED BY THE MANUFACTURER.
- CONTRACTOR IS RESPONSIBLE FOR COORDINATING WORK WITH OTHER TRADES WHEREVER THEY OVERLAP.
- WHEN MATERIALS AND/OR FINISHES ARE FOUND TO BE DEFECTIVE OR WHEN EXISTING CONSTRUCTION IS REMOVED, DISTURBED, DAMAGED, REPLACED OR RESURFACED IN ANY WAY, CONTRACTOR SHALL PROVIDE PATCHING AND PAINTING WITH MATERIALS OF SAME TYPE AND QUALITY AS TO MATCH ADJACENT EXISTING SURFACES UNLESS OTHERWISE NOTED.
- PROVIDE ALL BLOCKING, BRACING AND SHIMMING AS NECESSARY FOR INSTALLATION AND COMPLETION OF THE WORK.

- ALL NEW WORK SHALL BE PLUMB, LEVEL AND SQUARE, SCRIBE AND MAKE FIT ALL NEW WORK TO EXISTING (IF APPLICABLE TO PROJECT).
- ALL DETAILS ARE SUBJECT TO CHANGE DUE TO EXISTING FIELD CONDITIONS. CONTRACTOR MUST NOTIFY OWNER AND ARCHITECT IF SO.
- COORDINATE INTERIOR DOORS/HARDWARE, WOOD TRIM AND FINISHES, AND EXTERIOR FINISH MATERIALS (SIDING, ROOFING, ETC.) TO MATCH EXISTING (IF APPLICABLE TO PROJECT). FINAL SELECTIONS BY OWNER AND GENERAL CONTRACTOR, UNLESS OTHERWISE SPECIFIED.
- COORDINATE THE INSTALLATION OF CONTINUOUS ALUMINUM GUTTERS AND DOWNSPOUTS TO MATCH EXISTING (IF APPLICABLE TO PROJECT). DOWNSPOUTS NOT LOCATED ON DRAWINGS ARE TO BE LOCATED IN FIELD AND APPROVED BY OWNER. ALL DOWNSPOUTS ARE TO RUN TO PRECAST CONCRETE SPASHBLOCKS, OR TO UNDERGROUND CONDUCTORS PER LOCAL CODE.
- GENERAL CONTRACTOR IS RESPONSIBLE FOR COORDINATION OF ALL SITEWORK, INCLUDING FINISH GRADING AND HYDROSEEDING.
- GENERAL CONTRACTOR IS RESPONSIBLE FOR COORDINATION OF ELECTRIC, PLUMBING AND HVAC SYSTEM INSTALLATION. VERIFY CAPACITY AND LOCATION OF EXISTING UTILITIES/SERVICES PRIOR TO CONSTRUCTION (IF APPLICABLE TO PROJECT).
- THESE DOCUMENTS DO NOT PURPORT TO SHOW ALL MEANS AND METHODS REQUIRED FOR A COMPLETE INSTALLATION. THE INTENT IS TO INDICATE THE GENERAL SCOPE FOR THE PROJECT. IN TERMS OF THE ARCHITECTURAL DESIGN CONCEPT, THE LOCATION/DIMENSIONS OF THE CONSTRUCTION AND MAJOR ARCHITECTURAL ELEMENTS OF CONSTRUCTION.

CODE REQUIREMENTS:

- STAIRS: PER IRC R501.7**
- STAIR TO HAVE HEIGHTS FIELD VERIFIED AND SHOP DRAWINGS APPROVED PRIOR TO FABRICATION. STAIR CONSTRUCTION SHALL CONSIST OF STRINGERS, 3/4" THICK TREADS AND 3/4" THICK RISERS OR MATERIALS FABRICATED BY A COMPONENT MANUFACTURER.
 - STAIRWELLS TO BE A MIN. OF 36" IN WIDTH AND HAVE A CONSISTENT HEAD HEIGHT TO FINISHED CEILING OF 6'-8" FROM THE TREAD NOSING.
 - CLOSED RISERS WITH 1" NOSING UNLESS NOTED OTHERWISE. MAX. RISER HEIGHT OF 7 1/2" AND MIN. TREAD DEPTH OF 10" (4" MIN. RUN DEPTH).
 - A LANDING IS NOT REQUIRED AT TOP OF INTERIOR STAIRS PROVIDED A DOOR DOES NOT SWING OVER STAIR.
- HANDRAILS: PER IRC**
- HANDRAILS ARE REQUIRED ON AT LEAST ONE (1) SIDE OF STAIRWAYS FOR (4) OR MORE RISERS.
 - HANDRAILS AND EXTENSIONS SHALL BE 34" TO 38" ABOVE NOSING OF TREADS AND BE CONTINUOUS.
 - THE HANDRAIL PORTION OF ALL HANDRAILS SHALL BE NOT LESS THAN 1 1/2" NOR MORE THAN 2" IN CROSS-SECTIONAL DIMENSION.
 - HANDRAILS PROJECTING FROM A WALL SHALL HAVE AT LEAST 1 1/2" BETWEEN THE WALL AND THE HANDRAIL. ENDS OF THE HANDRAILS SHALL BE RETURNED OR SHALL HAVE ROUNDED TERMINATION OR BENDS.

GUARDRAILS: PER IRC


- PORCHES, BALCONIES, AND RAISED FLOORS GREATER THAN 30" ABV. FLR. OR GRADE SHALL HAVE A HALF WALL OR RAIL, GUARD 36" MIN. HT.
 - ON OPEN STAIRWAYS SHALL HAVE A GUARDRAIL HEIGHT OF 34" TO 38" ABOVE NOSING OF TREADS AND BE CONTINUOUS.
 - OPENINGS BETWEEN RAILINGS SHALL BE LESS THAN 4". THE TRIANGULAR OPENINGS FORMED BY THE RISER, TREAD AND BOTTOM ELEMENT OF A GUARDRAIL AT A STAIR SHALL BE LESS THAN 6".
- GLAZING:**
- GLAZING TO BE TEMPERED WHEN CONSIDERED A HAZARDOUS LOCATION AS DEFINED IN THE RESIDENTIAL CODE OF NYS SUCH AS:
 - GLAZING IN DOORS
 - GLAZING ADJACENT TO DOORS - WITHIN 24" OF A DOOR, WHEN BOTTOM EDGE IS LESS THAN 60" AFF.
 - GLAZING IN WINDOWS - WHEN INDIVIDUAL PANE IS GREATER THAN 9 SF, BOTTOM EDGE IS LESS THAN 18" AFF, TOP EDGE IS GREATER THAN 36" AFF, AND WALKING SURFACE IS WITHIN 36"
 - GLAZING 4 FEET SURFACES - ANY GLAZING IN WALLS SURROUNDING TUBS, SHOWERS, SAUNAS WHERE BOTTOM EDGE IS LESS THAN 60" AFF
 - GLAZING ADJACENT TO STAIRWAYS AND RAMPS - BOTTOM EDGE OF GLAZING IS LESS THAN 60" AFF.
 - THE MAXIMUM ALLOWABLE U-FACTOR FOR ALL NEW EXTERIOR DOORS AND WINDOWS SHALL BE 0.30. THE MAXIMUM ALLOWABLE U-FACTOR FOR SKYLIGHTS SHALL BE 0.5

ELECTRICAL/MECHANICAL/PLUMBING:

- ELECTRIC AND PLUMBING LAYOUT SHALL MEET OR EXCEED LOCAL & NATIONAL CODES AND SHALL BE INSPECTED DURING CONSTRUCTION.
 - EQUIPMENT AND APPLIANCES HAVING AN IGNITION SOURCE SHALL BE ELEVATED SUCH THAT THE IGNITION IS NOT LESS THAN 18 INCHES ABOVE THE FLOOR IN HAZARDOUS LOCATIONS AND PRIVATE GARAGES. APPLIANCES LOCATED IN PRIVATE GARAGES SHALL BE LISTED IN ACCORDANCE WITH UL 2094. COMBINATION CARBON MONOXIDE AND SMOKE ALARMS SHALL BE LISTED IN ACCORDANCE WITH UL 2094 AND UL 217 AND SHALL BE INSTALLED IN ACCORDANCE WITH MANUFACTURER'S INSTRUCTIONS.
 - WHERE WALL AND/OR CEILING FINISHES ARE REMOVED TO EXPOSE THE STRUCTURE, ALARMS SHALL BE HAND-WIRED. OTHER ALARMS MAY BE BATTERY OPERATED.
 - AT LEAST ONE RECEPTACLE OUTLET SHALL BE INSTALLED IN EACH ATTACHED GARAGE, AND IN EACH DETACHED GARAGE THAT IS PROVIDED WITH ELECTRICAL POWER.
 - IF AN AUTOMATIC GARAGE DOOR OPENER IS PROVIDED IT SHALL BE LISTED IN ACCORDANCE WITH UL 325.
- SMOKE/CARBON MONOXIDE ALARMS:**
- FOR NEW CONSTRUCTION SMOKE DETECTING ALARM DEVICES SHALL BE DIRECT WIRED AND CONFORM TO THE RESIDENTIAL CODE OF NYS.
 - IN EACH SLEEPING ROOM
 - IN HALLWAYS ADJACENT TO SLEEPING ROOMS
 - AT LEAST ONE ON EACH STORY INCLUDING BASEMENT
 - SHALL NOT BE INSTALLED LESS THAN 3 FEET HORIZONTALLY FROM THE DOOR OF OPENING OF A BATHROOM THAT CONTAINS A BATHRUB OR SHOWER.

ENERGY CONSERVATION STATEMENT:

- THE PROPOSED BUILDING HAS BEEN DESIGNED TO MEET OR EXCEED THE REQUIREMENTS AND COMPLY WITH THE RESIDENTIAL ENERGY CONSERVATION CODE. INSULATION WILL BE UTILIZED TO SEAL THE BUILDING ENVELOPE, INCLUDING BUT NOT LIMITED TO WALLS, ROOF, RIM JOIST, ABOVE GARAGE FLOORS, CANTILEVERED SPACES AND ALL PERFORATIONS INTO UNCONDITIONED SPACE. BREAKS AND JOINTS IN THE AIR BARRIER WILL BE SEALED WITH FOAM OR GASKETS. A VENTILATION CONTROL SYSTEM WILL BE UTILIZED TO PROVIDE THE REQUIRED AIR EXCHANGE.
- DRYER EXHAUST DUCTS SHALL HAVE A SMOOTH INTERIOR FINISH AND BE CONSTRUCTED OF METAL HAVING A MINIMUM THICKNESS OF 0.0281 INCHES (NO. 28 GAUGE), AND SHALL BE 4 INCHES NOMINAL IN DIAMETER. EXHAUST DUCTS SHALL TERMINATE ON THE OUTSIDE OF THE BUILDING AS PER MANUFACTURER'S INSTALLATION INSTRUCTIONS, BUT NOT LESS THAN 5 FEET IN ANY DIRECTION FROM OPENINGS INTO BUILDINGS.
- THE MAXIMUM LENGTH OF A CLOTHES DRYER EXHAUST DUCT SHALL NOT EXCEED 95 FEET FROM THE DRYER LOCATION TO THE OUTLET TERMINAL, WHERE FITTINGS ARE USED, THE MAXIMUM LENGTH OF THE DUCT SHALL BE REDUCED AS PER THE RESIDENTIAL CODE OF NEW YORK STATE.

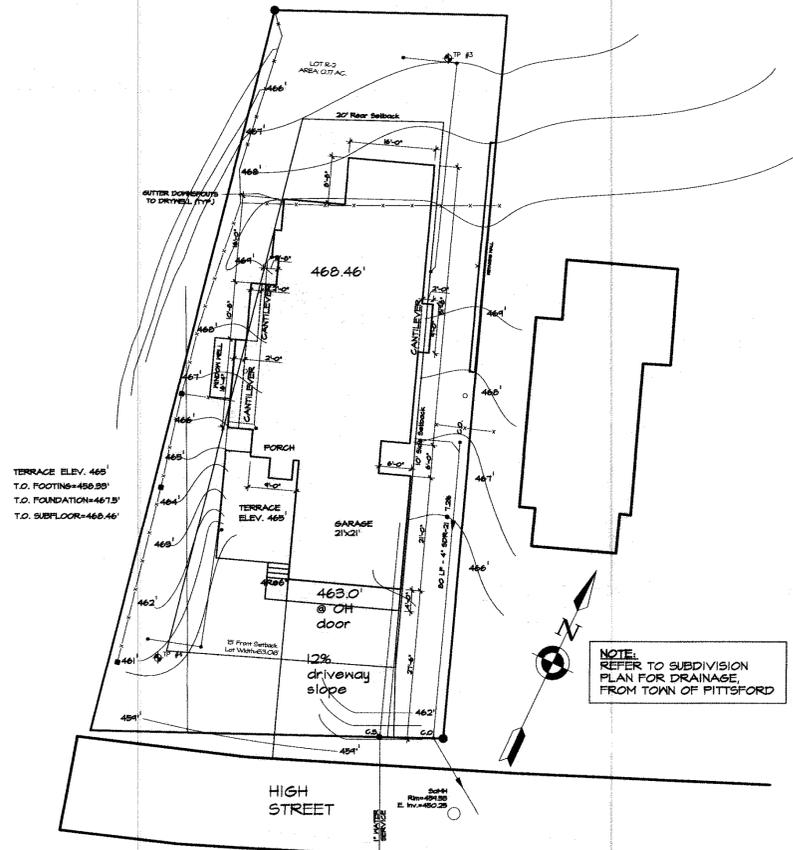

No.	Date	REVISIONS
		Description

DESIGN WORKS
ARCHITECTURE

6 North Main Street, Suite 104 :: Fairport, New York 14450
Phone: 585-377-9001 :: www.newdesignworks.com
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Mark and Mary
KOSINSKI RESIDENCE
19 High Street
Town of Pittsford
Monroe County, New York

Project No. 2141
Date: 9-13-2022
Scale: AS NOTED
Drawn by: AW
Checked by: CBS

Construction Documents
COVER SHEET
A-0.0

PERMIT SET

A-0.0 SITE PLAN 1/16" = 1'-0"

FLOOR PLAN NOTES:

- ALL EXTERIOR DIMENSIONS ARE FROM OUTSIDE EDGE OF SHEATHING OR CENTERLINE OF STRUCTURAL MEMBER.
- ALL INTERIOR STUD DIMENSIONS ARE FROM CENTER LINE TO CENTER LINE OF STUDS (U.N.O. - UNLESS NOTED OTHERWISE).
- ALL EXTERIOR FRAMED WALLS TO BE 2x6 @ 16" O.C. (U.N.O.)
- ALL INTERIOR WALLS TO BE 2x4 @ 16" O.C. (U.N.O.)
- ALL EXTERIOR HEADERS TO BE (2) 2x6 INSULATED (U.N.O.)
- DOUBLE JACK STUDS AT ALL 4'-0" OPENINGS AND LARGER.
- ALL DOORS TO BE LOCATED IN CENTER OF OPENING OR MIN. 4" FROM ADJACENT WALL (U.N.O.)
- ALL SPOT ELEVATIONS ARE TAKEN FROM 0'-0" DATUM OF MAIN LEVEL SUB-FLOOR (U.N.O.)
- INDICATES (3) STUD POST, GLUED AND NAILED (U.N.O.)
- REFER TO EXTERIOR ELEVATION FOR WINDOW SIZES.
- COORDINATE LOCATION OF UTILITY METERS WITH SITE PLAN AND LOCATE AWAY FROM PUBLIC VIEW. VISUAL IMPACT SHALL BE MINIMIZED, I.E. MOUNT AS LOW AS POSSIBLE.
- CONTRACTOR TO COORDINATE ALL CLOSET SHELVING AND CABINETRY REQUIREMENTS. CONTRACTOR TO FIELD VERIFY ALL CABINET DIMENSIONS PRIOR TO FABRICATION.
- PREFABRICATED FIREPLACE CONSTRUCTION SHALL MEET OR EXCEED ALL APPLICABLE CODES REGARDING USE OF FIRE SEPARATION, CLEARANCES, ETC. IT IS THE CONTRACTOR'S RESPONSIBILITY TO ENSURE THAT ALL ITEMS AND CONSTRUCTION MEET OR EXCEED CODE. OVERALL FLUE HEIGHT SHALL BE COORDINATED TO MATCH HEIGHT SHOWN ON PLANS, AND SHALL NOT EXCEED THE TOP OF CHIMNEY CHASE AS CONSTRUCTED.
- ALL EXPOSED INSULATION SHALL HAVE A FLAME SPREAD RATING LESS THAN 25 AND A SMOKE DENSITY RATING LESS THAN 450.
- PROVIDE COMBUSTION AIR VENTS, WITH SCREEN AND BACK DAMPER, FOR FIREPLACES, WOOD STOVES AND ANY APPLIANCE WITH AN OPEN FLAME.
- BATHROOMS AND UTILITY ROOMS SHALL BE VENTED TO THE OUTSIDE WITH A MINIMUM OF A 70 CFM FAN, OR WITH A WHOLE HOUSE VENTILATION HEAT RECOVERY SYSTEM. RANGE HOODS SHALL ALSO BE VENTED TO THE OUTSIDE.
- RANGE HOODS WITH A CFM OF 400 OR GREATER SHALL BE PROVIDED WITH MAKEUP AIR FROM EXTERIOR TO MAINTAIN NEUTRAL INTERIOR AIR PRESSURE.

ROOF & ATTIC NOTES:

- APPROVED BITUTHANE WATER SHIELD PRODUCT (e.g. GRACE ICE AND WATER SHIELD) TO BE APPLIED TO ALL EAVES AND VALLEYS.


ROOF PITCH	3:12 OR LESS	3:12 - 6:12	6:12 OR GREATER
WATER SHIELD *	ENTIRE ROOF	5'-0"	3'-0"

* DIMENSION FROM EXTERIOR FACE OF WALL UP ROOF SLOPE


- USE A RUBBER MEMBRANE ROOF ON ALL ROOFS WITH A PITCH OF LESS THAN 3:12.
- HIGH TEMPERATURE ICE & WATER SHIELD UNDER METAL ROOF (IF APPLICABLE).
- ENCLOSED ATTIC SPACES MUST HAVE A MIN. NET FREE VENTILATING AREA OF 1/30 OF THE AREA OF VENTED SPACE WITH THE EXCEPTION OF 1/30 BEING ALLOWED IN CLIMATE ZONES 6, 7 OR 8 WHEN A CLASS I OR II VAPOR RETARDER IS INSTALLED ON THE WARM-IN-WINTER SIDE OF THE CEILING OR NOT LESS THAN 40% AND NOT MORE THAN 50% OF THE REQUIRED VENTILATING AREA IS PROVIDED BY VENTILATORS IN THE UPPER PORTION OF THE ATTIC OR RAFTER SPACE PER THE RESIDENTIAL CODE OF N.Y.S..
- ROOF CAVITIES THAT EXCEED 30 SF, REQUIRE ACCESS OF 22"x30" WITH HEADROOM ABOVE THE OPENING OF AT LEAST 30" MUST BE LOCATED IN A HALLWAY OR OTHER READILY ACCESSIBLE LOCATION PER THE RESIDENTIAL CODE OF N.Y.S..
- PROVIDE REQUIRED FLASHING TO MEET OR EXCEED COMMON BUILDING PRACTICE WHERE REQUIRED AND AT ROOF CHANGES, PROJECTIONS, VALLEYS, ETC. INSTALL DIVERTER FLASHING AWAY FROM WHERE THE EAVE OF A SLOPED ROOF INTERSECTS A VERTICAL SIDEWALL.
- FINAL ON CENTER ROOF RAFTER LAYOUT BY BUILDER.
- BUILDER TO MAINTAIN PROPER VENTILATION GAP PER DETAILS IN ALL RAFTER BAYS.
- FINAL GUTTER AND DOWNSPOUT SIZES AND LOCATIONS TBD BY SITE ENGINEER, OWNER, AND/OR CONTRACTOR. DOWNSPOUTS SHALL BE TIED INTO STORM WATER SYSTEM IF AVAILABLE OR EMPTY ONTO SPLASHBLOCKS.

TRUSSES (IF APPLICABLE TO PROJECT)

- TRUSSES SHOWN AS CONCEPTUAL DESIGN ONLY.
- TRUSSES TO BE ENGINEERED AND SUPPLIED BY CERTIFIED TRUSS MANUFACTURER.
- FINAL DESIGN BY TRUSS MANUFACTURER TO BE APPROVED BY OWNER PRIOR TO FABRICATION.
- PROVIDE HURRICANE TIE FOR EACH TRUSS. USE SIMPSON H2.5 UNLESS NOTED OTHERWISE.

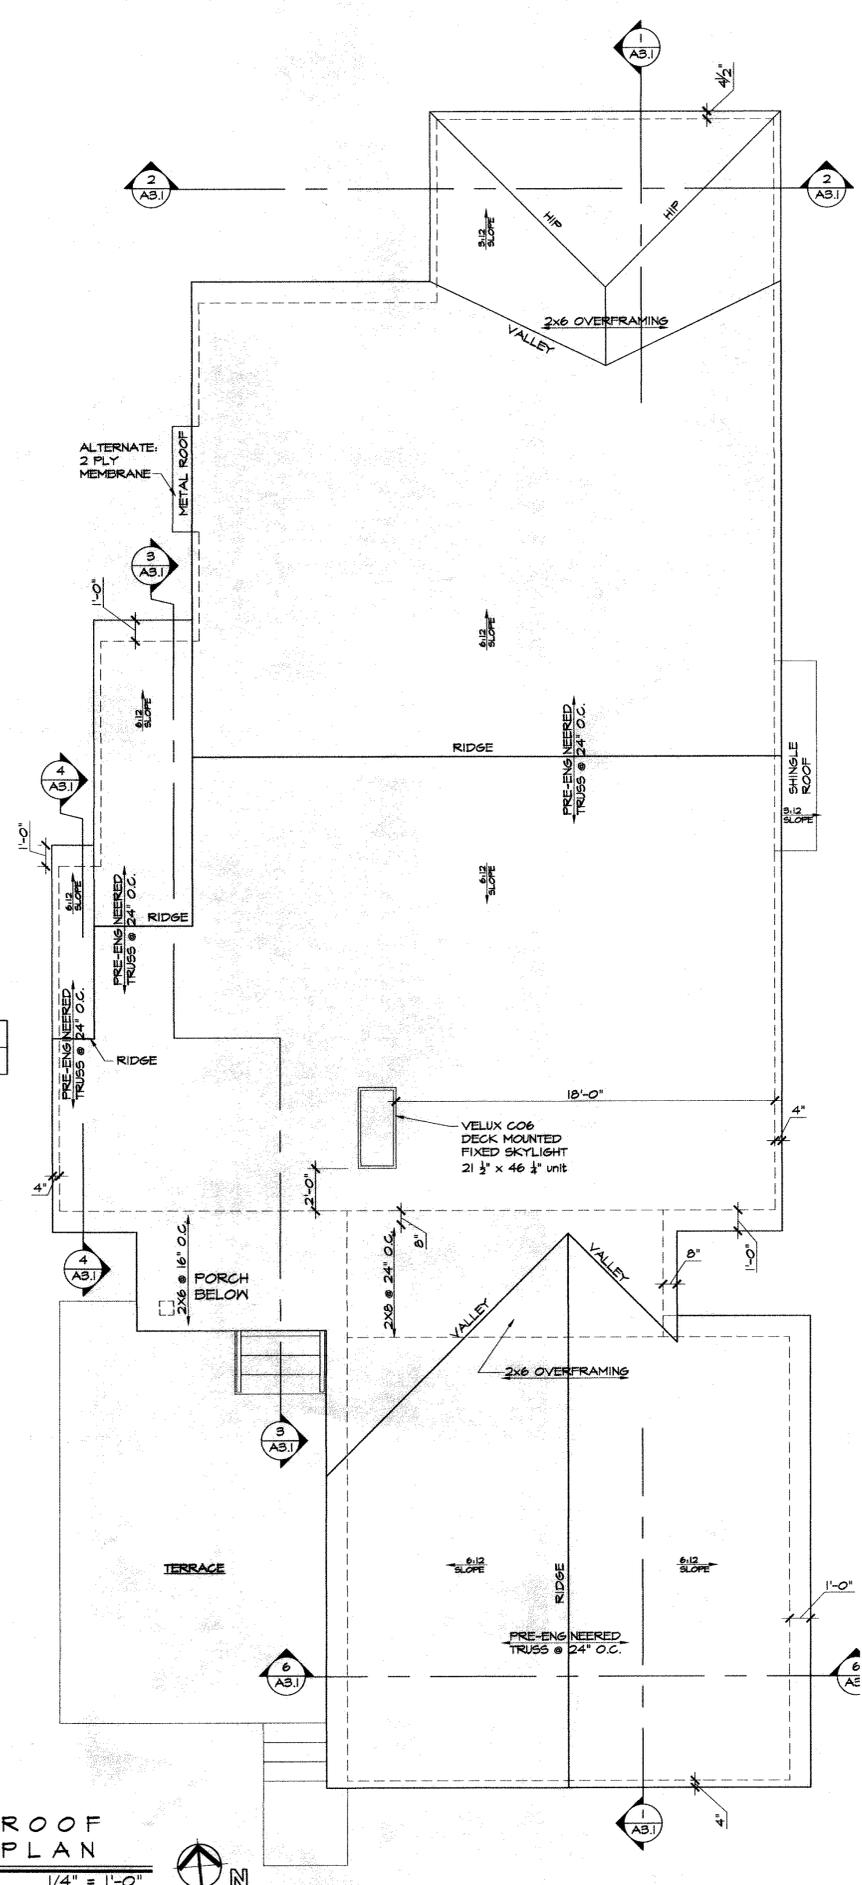

2
A-2.1
ROOF PLAN
1/4" = 1'-0"
N

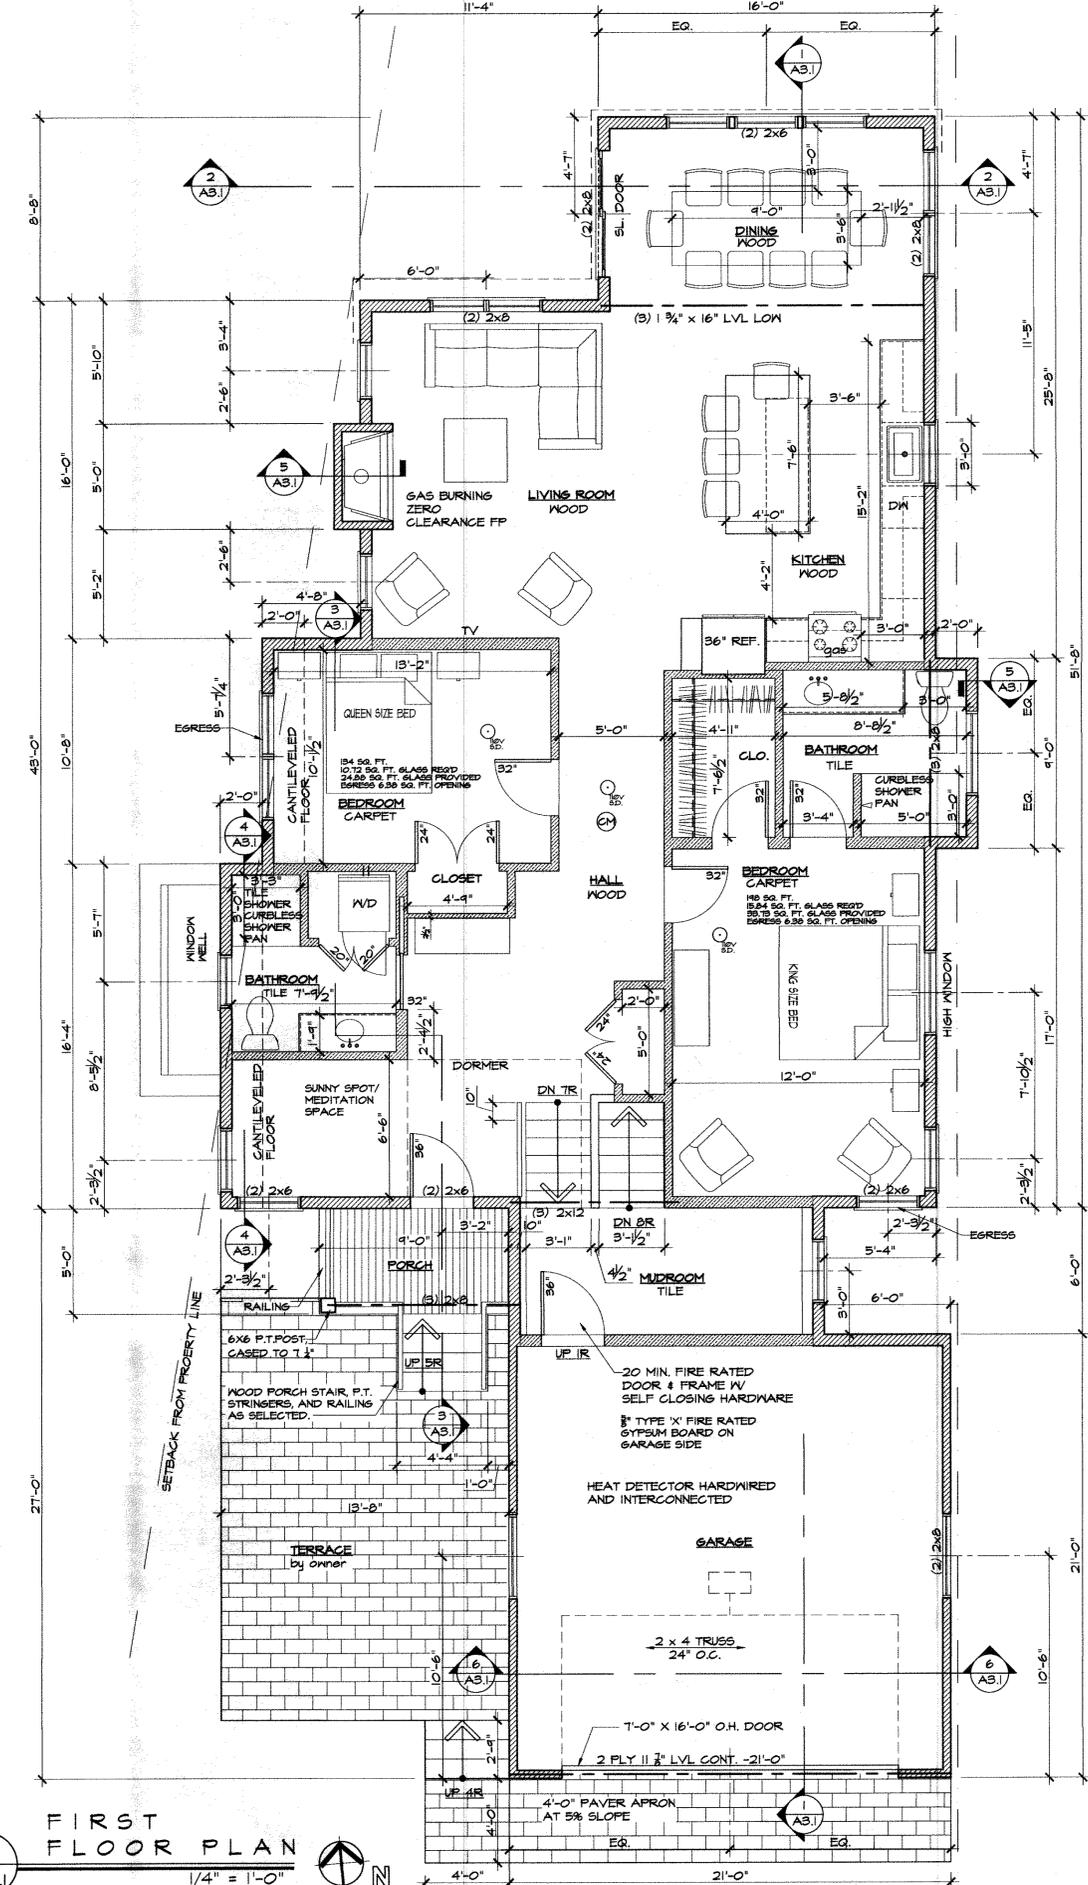

1
A-2.1
FIRST FLOOR PLAN
1/4" = 1'-0"
N


REVISIONS	
No.	Description

DESIGN WORKS ARCHITECTURE
 6 North Main Street, Suite 104 :: Fairport, New York 14450
 Phone: 585-377-9001 :: www.newdesignworks.com
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Mark and Mary KOSINSKI RESIDENCE
 19 High Street
 Town of Pittsford
 Monroe County, New York

Project No.	2141
Date	9-13-2022
Scale	AS NOTED
Drawn by	AW
Checked by	CBS

Permit Set
 Construction Documents
 FLOOR PLAN
A-2.1

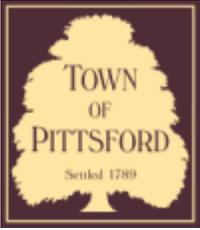

Town of Pittsford

Department of Public Works
11 South Main Street
Pittsford, New York 14534

Permit #
B22-000140

Phone: 585-248-6250
FAX: 585-248-6262

DESIGN REVIEW AND HISTORIC PRESERVATION BOARD REFERRAL OF APPLICATION

Property Address: 47 Skylight Trail ,

Tax ID Number:

Zoning District:

Owner: Morrell Builders

Applicant: Morrell Builders


Application Type:

- | | |
|---|---|
| <input checked="" type="checkbox"/> Residential Design Review
§185-205 (B) | <input type="checkbox"/> Build to Line Adjustment
§185-17 (B) (2) |
| <input type="checkbox"/> Commercial Design Review
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§185-17 (K) (3) |
| <input type="checkbox"/> Certificate of Appropriateness
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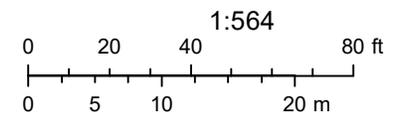
Project Description: Applicant is requesting design review for the proposed construction of a new town home dwelling. The proposed building will consist of 2 attached single family dwellings sharing a common wall. Lot 26 (47 Skylight Trail) will be approximately 2023 sq. ft. and Lot 25 (45 Skylight Trail) will be 2010 sq. ft. The town homes will be located in the new Alpine Ridge development.

Meeting Date: October 13, 2022

RN Residential Neighborhood Zoning

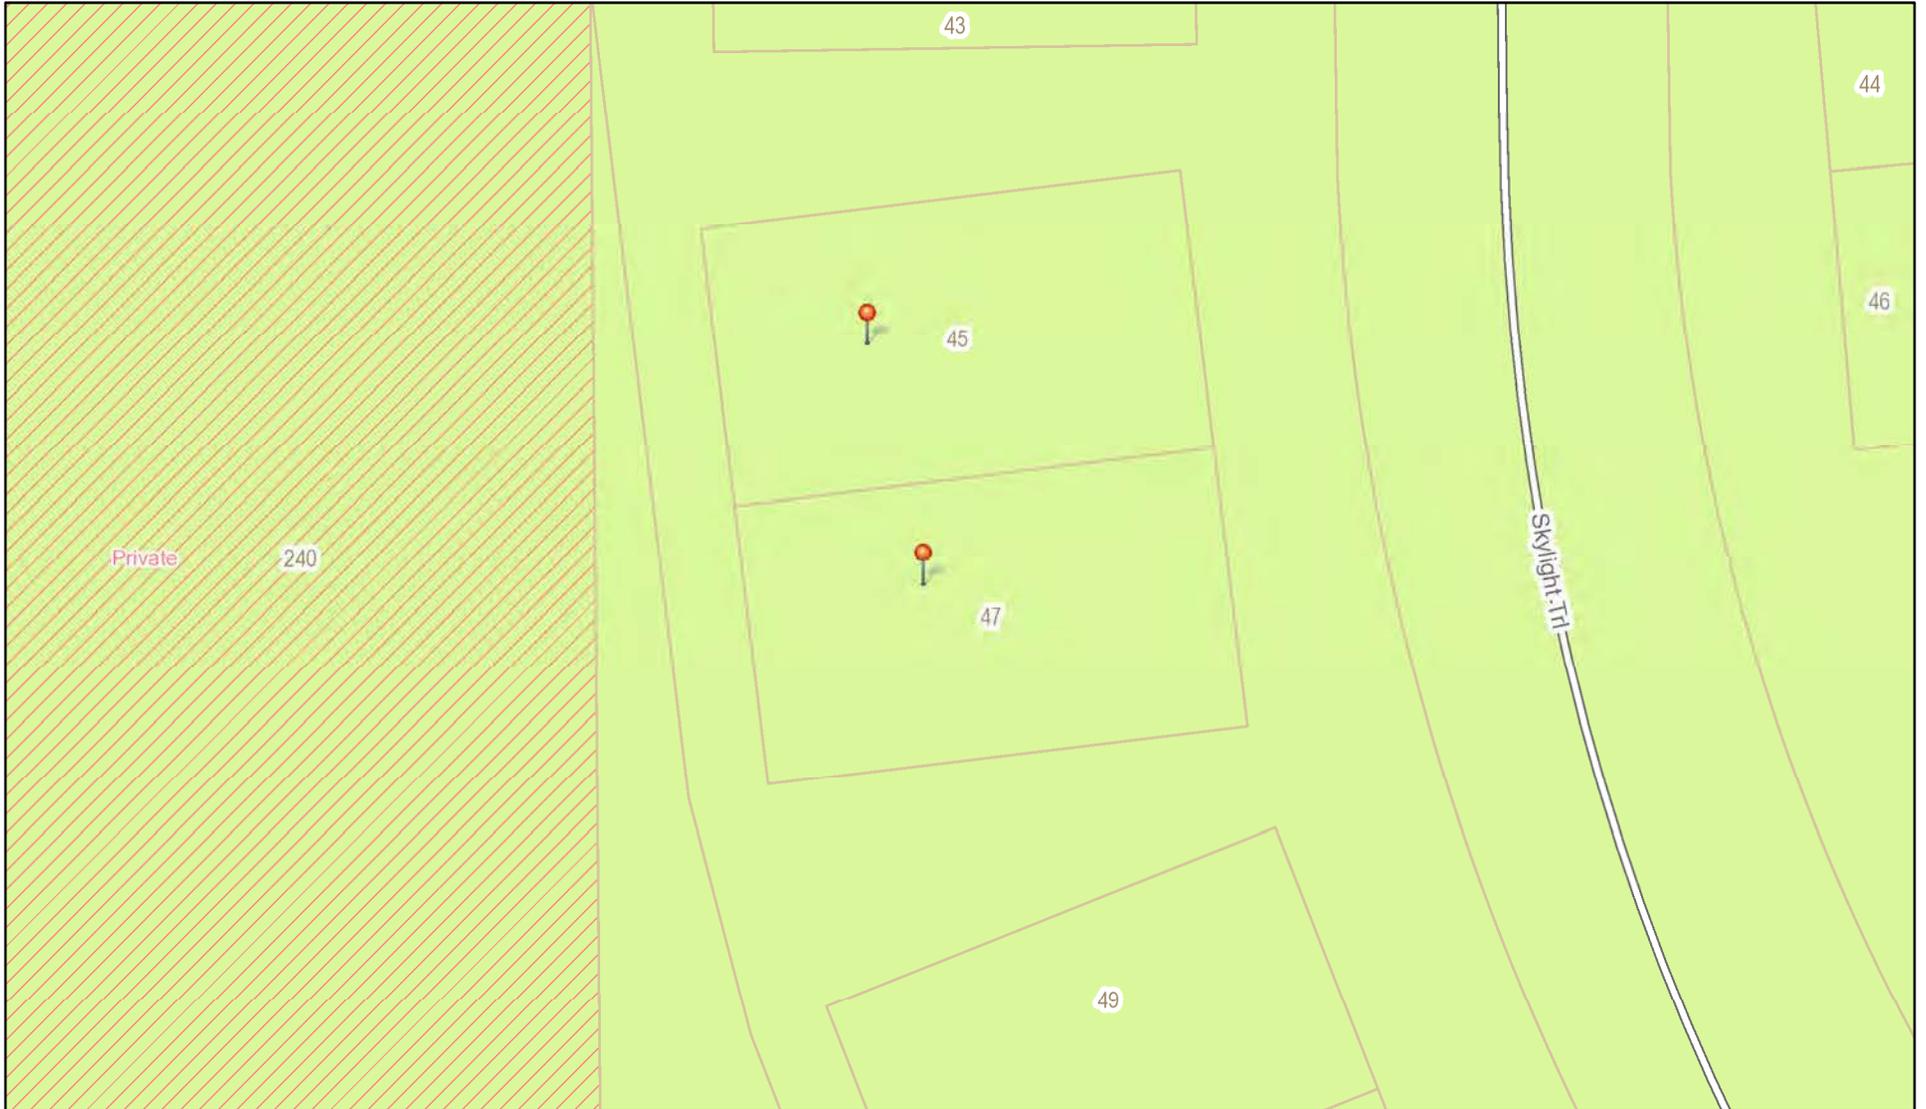

Printed September 15, 2022



Town of Pittsford GIS

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04/05/2021

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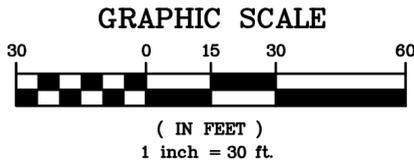
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BME Associates

"CERTIFICATIONS INDICATED HEREON SHALL RUN ONLY TO THE PERSON FOR WHOM THE SURVEY IS PREPARED, AND ON HIS BEHALF TO THE TITLE COMPANY, GOVERNMENTAL AGENCY AND LENDING INSTITUTION LISTED HEREON, AND TO THE ASSIGNEES OF THE LENDING INSTITUTION. CERTIFICATIONS ARE NOT TRANSFERABLE TO ADDITIONAL INSTITUTIONS OR SUBSEQUENT OWNERS."


THIS MAP AND THE INFORMATION SHOWN HEREON IS NOT TO BE USED WITH AN "AFFIDAVIT OF NO CHANGE." BME ASSOCIATES ASSUMES NO LIABILITY TO THE PARTIES NOTED HEREON OR TO ANY FUTURE OWNER, TITLE COMPANY, GOVERNMENTAL AGENCY, ATTORNEY OR LENDING INSTITUTION IN THE EVENT THAT THIS MAP IS USED WITH AN "AFFIDAVIT OF NO CHANGE," OR SIMILAR INSTRUMENT.

COPIES OF THIS SURVEY MAP NOT BEARING THE LAND SURVEYOR'S ORIGINAL INKED SEAL OR EMBOSSED SEAL SHALL NOT BE CONSIDERED TO BE A VALID TRUE COPY.


"UNAUTHORIZED ALTERATION OR ADDITION TO THIS SURVEY MAP IS A VIOLATION OF SECTION 7209, OF THE NEW YORK STATE EDUCATION LAW."




LEGEND

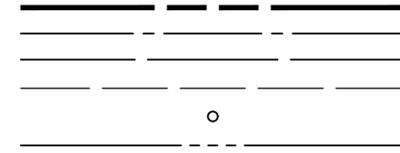

- BOUNDARY LINE
- CENTERLINE
- ADJOINER/R.O.W. LINE
- SETBACK LINE
- PROPERTY MARKER FOUND
- EXISTING EASEMENT LINE

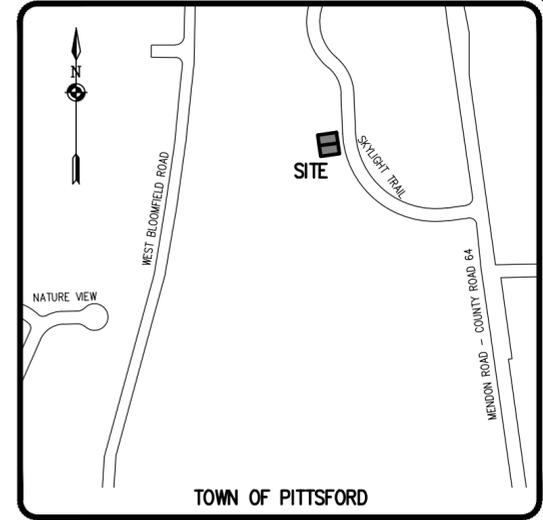

LOCATION MAP
NOT TO SCALE

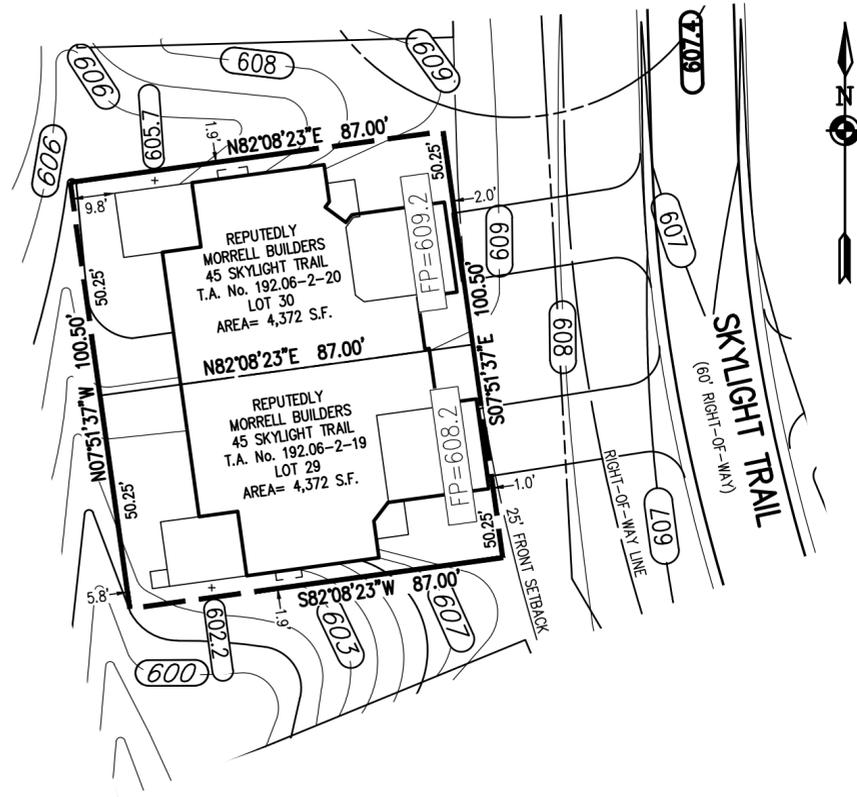

REFERENCES:

1. A PLAN ENTITLED "ALPINE RIDGE SUBDIVISION, SECTION 2", AS FILED IN THE MONROE COUNTY CLERK'S OFFICE AT LIBER 364 OF MAPS, PAGE 2.
2. A PLAN ENTITLED "FINAL SECTION 2 PLANS FOR ALPINE RIDGE SUBDIVISION, GRADING PLAN," PREPARED BY MARATHON ENGINEERING, HAVING JOB NUMBER 0891-17, DRAWING NUMBER C4.0 AND LAST REVISED SEPTEMBER 17, 2021
3. AN ABSTRACT OF TITLE WAS NOT PROVIDED FOR THE COMPLETION OF THIS SURVEY.

NOTES:

1. THE BEARING BASE SHOWN HEREON WAS TAKEN FROM REFERENCE 1.
2. SETBACK REQUIREMENTS:
FRONT 0' (LOT) 25' (R.O.W.)
SIDE 0'
REAR 0'
3. GRADING SHOW HEREON WAS TAKEN FROM REFERENCE 2.

PHELPS & GORHAM PURCHASE, TOWNSHIP 12, RANGE 5, TOWN LOT 6, TAX ACCOUNT No.'S 192.06-2-20 & 192.06-2-19

P:\2688\Instrument Surveys\2688 Lot 29-30 Plot Plan.dwg

PROJECT MANAGER	GD BELL
PROJECT SURVEYOR	GD BELL
DRAWN BY	JT GILMORE
DATE ISSUED	SEPTEMBER 13, 2022
SCALE	1"=30'
PROJECT NO.	2688
DRAWING NO.	36

PROJECT	ALPINE RIDGE SUBDIVISION SECTION 2
LOCATION	TOWN OF PITTSFORD, MONROE COUNTY, NEW YORK STATE
CLIENT	MORRELL BUILDERS 1501 PITTSFORD-VICTOR ROAD VICTOR, NEW YORK, 14564
DRAWING TITLE	PLOT PLAN OF LOTS 29 & 30




BME ASSOCIATES
ENGINEERS • SURVEYORS • LANDSCAPE ARCHITECTS

10 LIFTBRIDGE LANE EAST
FAIRPORT, NEW YORK 14450
WWW.BMEPC.COM

PHONE 585-377-7360
FAX 585-377-7309

NO.	REVISIONS	DATE	BY
7			
6			
5			
4			
3			
2			
1			

Drawing Attention
The following is an excerpt from the New York State Education Law Article 146 Section 7209 and applies to this drawing:
"It is a violation of this law for any person, unless he is acting under the direction of a licensed professional engineer or land surveyor to alter any drawing or map prepared by him without the seal of an engineer or land surveyor is altered, the altering engineer or land surveyor shall affix to the item his seal and the notation altered by followed by his signature and the date of such alteration and a specific description of the alteration."

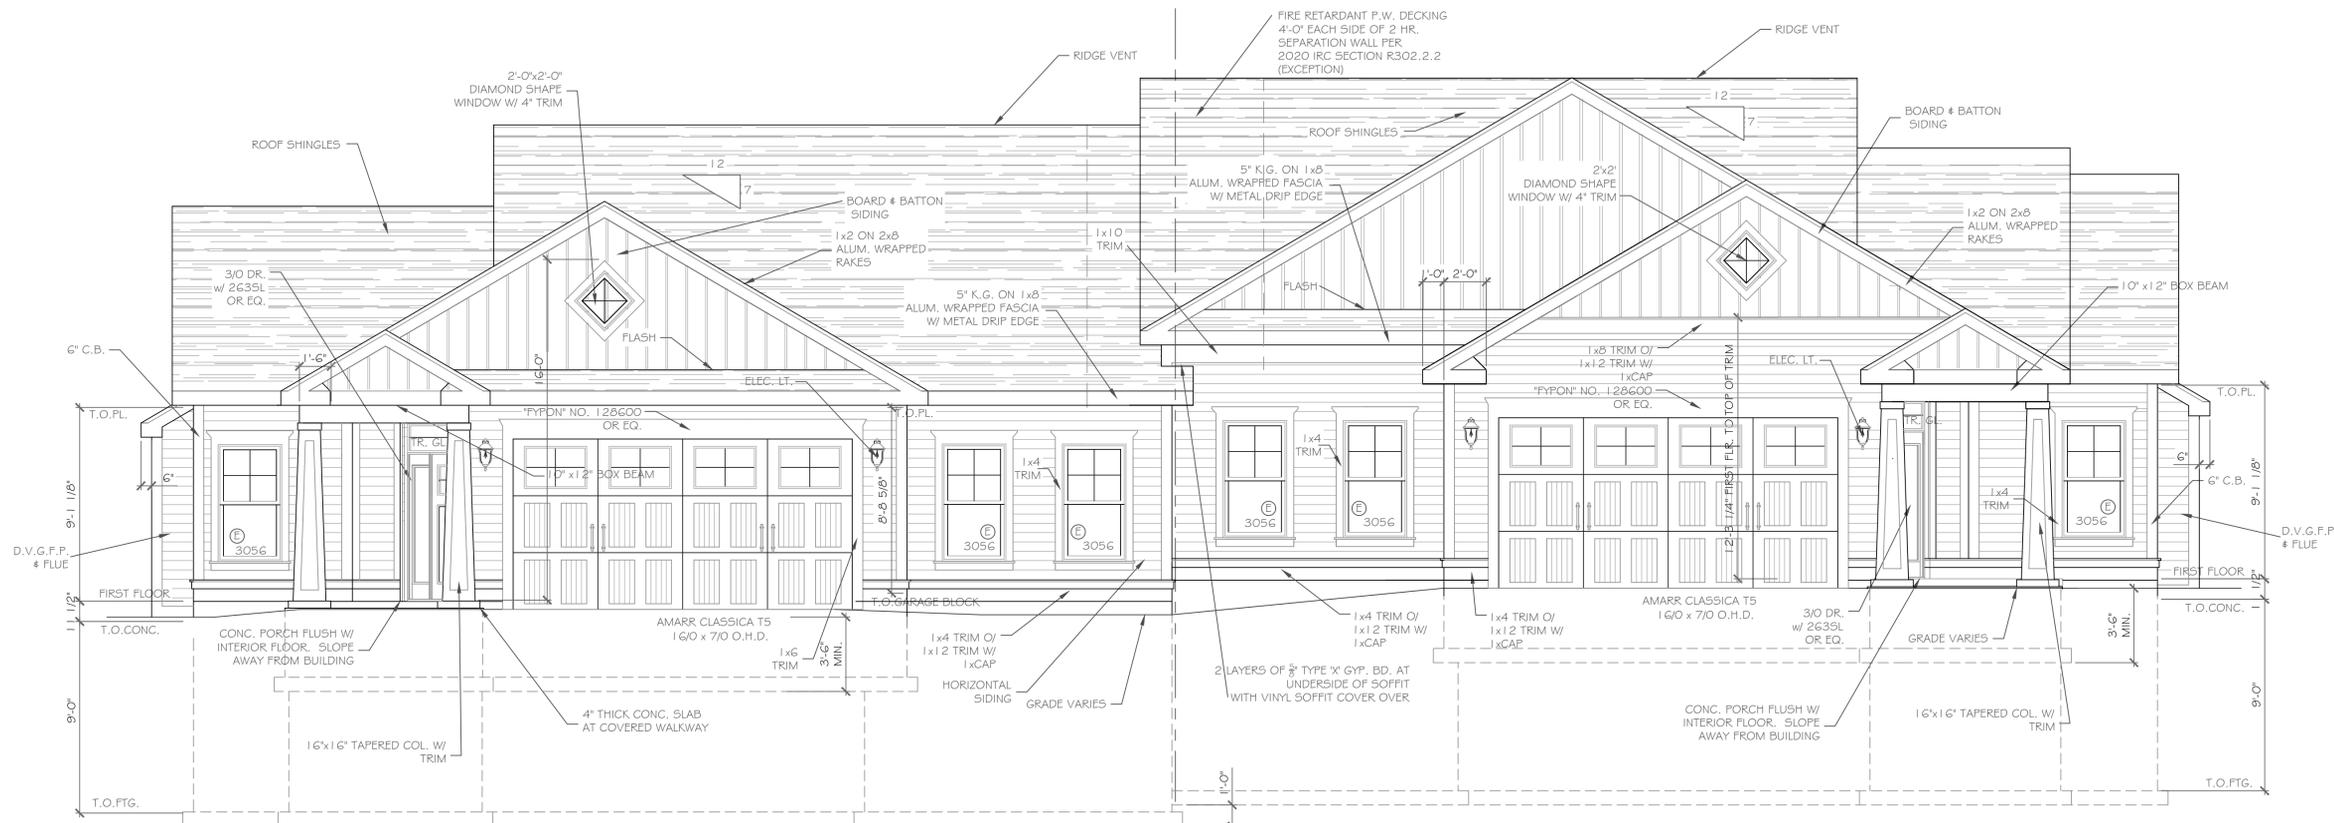


FRONT ELEVATION - LOT 29 2023 S.F. 1/4" = 1'-0"

FRONT ELEVATION - LOT 30 2010 S.F. 1/4" = 1'-0"

NOTE: - WINDOWS TO BE "VWD 210 SERIES" DOUBLE-HUNG, LOW-E DOORS TO BE "THERMA-TRU" OR EQ. - DOWN SPOUTS TO BE LOCATED BY CONTRACTOR IN FIELD (E) WINDOW MEETS OR EXCEEDS THE EGRESS REQUIREMENTS PER SECTION R310 OF THE RES. CODE OF NYS

ALL FOOTINGS MUST BEAR ON FIRM, UNDISTURBED NATIVE SOILS OR ENGINEERED FILL 42" MIN. BELOW ADJACENT GRADE. ON SITE SOIL USED AS ENGINEERED FILL SHALL BE FREE OF DELETERIOUS MATERIALS WITH NO PARTICLES GREATER THAN 3". FILL SHALL BE PLACED IN LOOSE LIFTS NOT TO EXCEED 8" IN DEPTH AND COMPACTED TO 95% MAXIMUM DRY DENSITY PER ASTM D1557 AT MOISTURE CONTENTS WITHIN 3% OF OPTIMUM

NOTE: - WINDOWS TO BE "VWD 210 SERIES" DOUBLE-HUNG, LOW-E DOORS TO BE "THERMA-TRU" OR EQ. - DOWN SPOUTS TO BE LOCATED BY CONTRACTOR IN FIELD (E) WINDOW MEETS OR EXCEEDS THE EGRESS REQUIREMENTS PER SECTION R310 OF THE RES. CODE OF NYS

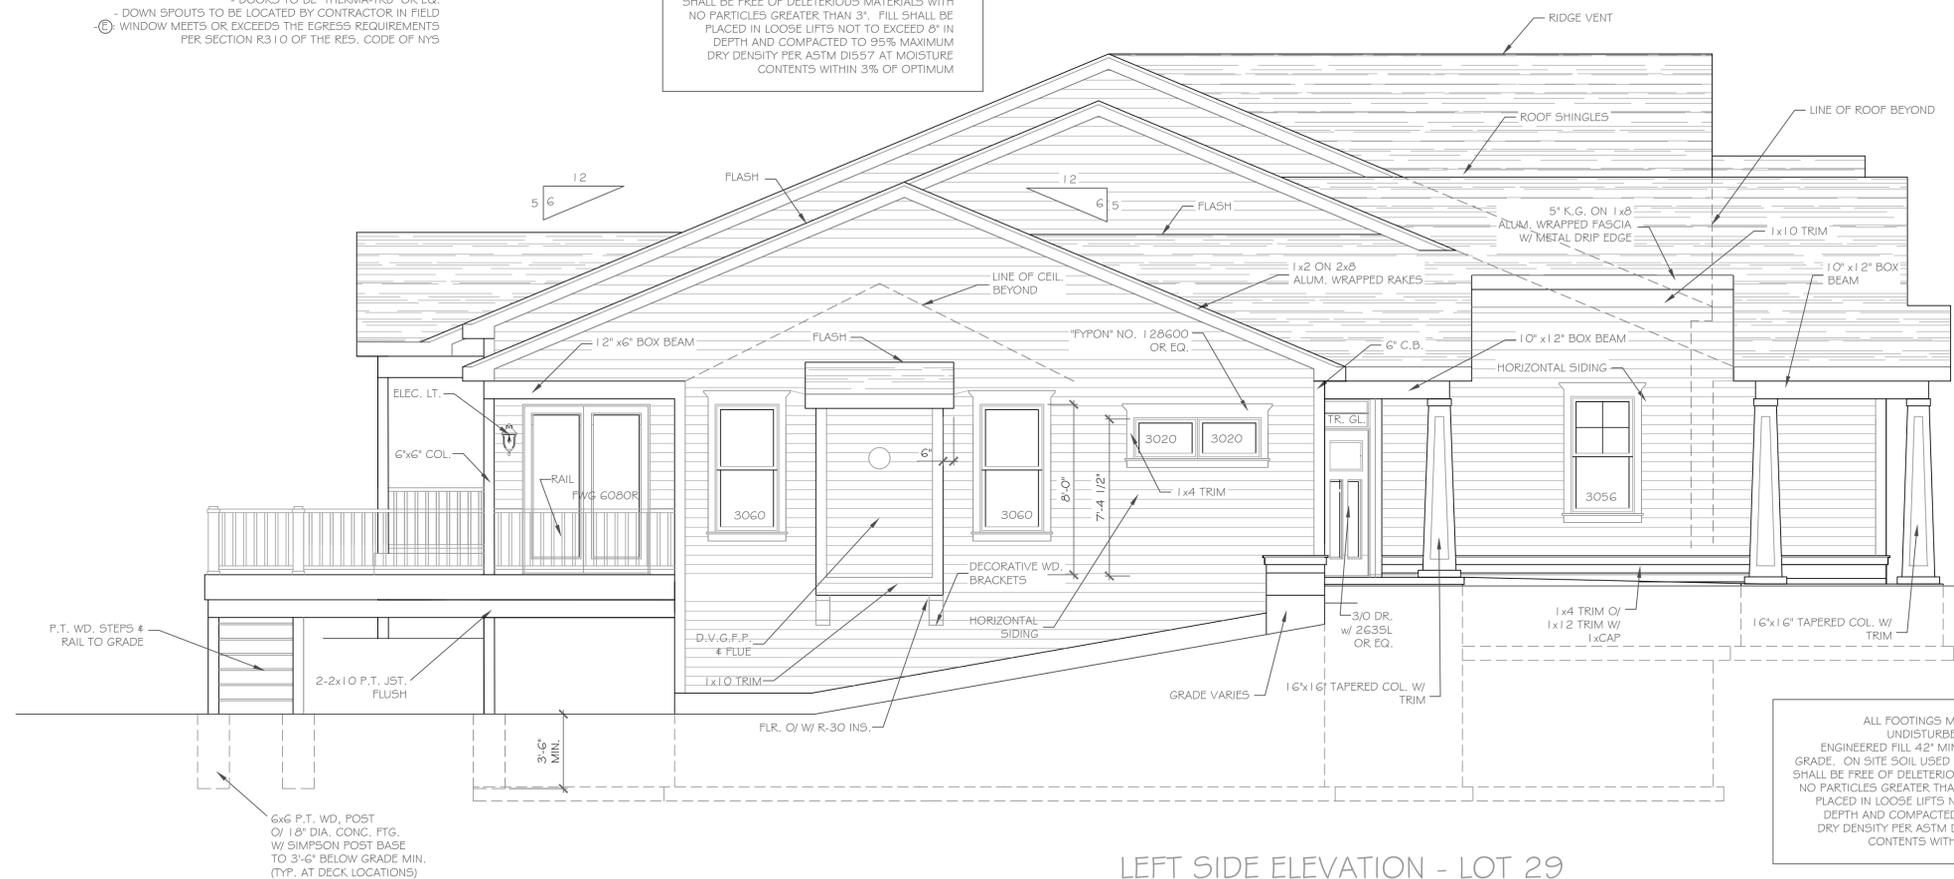

LEFT SIDE ELEVATION - LOT 29 1/4" = 1'-0"

HANDRAIL NOTES: -HANDRAILS TO BE 34"-38" ABV. THE SLOPED PLANE TO BE CONTINUOUS FULL LENGTH OF STAIR. -HANDRAILS TO CONFORM TO 2020 IRC SECTION R311.7.8 AND SECTION R312.1.1

ALL FOOTINGS MUST BEAR ON FIRM, UNDISTURBED NATIVE SOILS OR ENGINEERED FILL 42" MIN. BELOW ADJACENT GRADE. ON SITE SOIL USED AS ENGINEERED FILL SHALL BE FREE OF DELETERIOUS MATERIALS WITH NO PARTICLES GREATER THAN 3". FILL SHALL BE PLACED IN LOOSE LIFTS NOT TO EXCEED 8" IN DEPTH AND COMPACTED TO 95% MAXIMUM DRY DENSITY PER ASTM D1557 AT MOISTURE CONTENTS WITHIN 3% OF OPTIMUM

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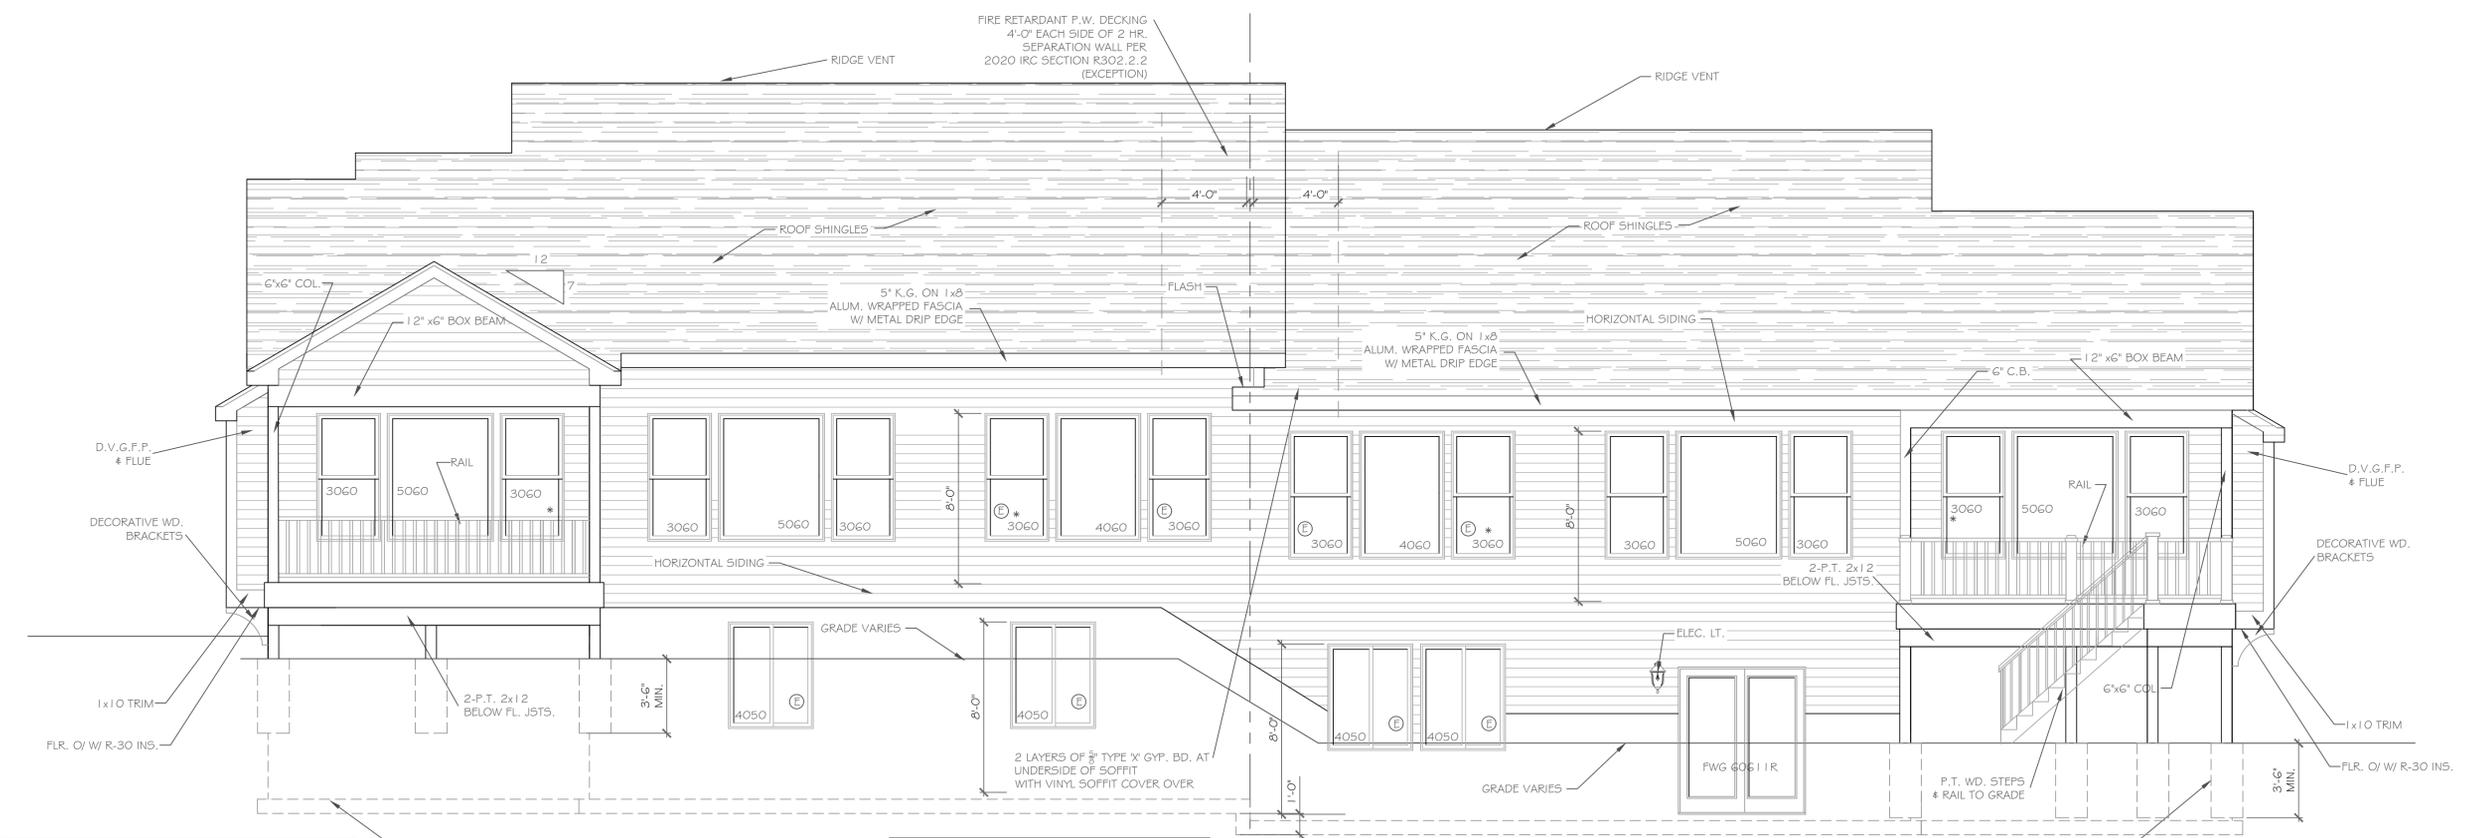
NO.	DATE	DESCRIPTION

PROJECT:	Alpine Ridge - Units 29 & 30
CLIENT:	Morrell Builders
DRAWING TITLE:	Front Elevation Units 29 & 30
PHASE:	Construction Documents
DATE:	September 14, 2022
JOB NO.:	A22-043


PROJECT:	Alpine Ridge - Units 29 & 30
CLIENT:	Morrell Builders
DRAWING TITLE:	Front Elevation Units 29 & 30
PHASE:	Construction Documents
DATE:	September 14, 2022
JOB NO.:	A22-043

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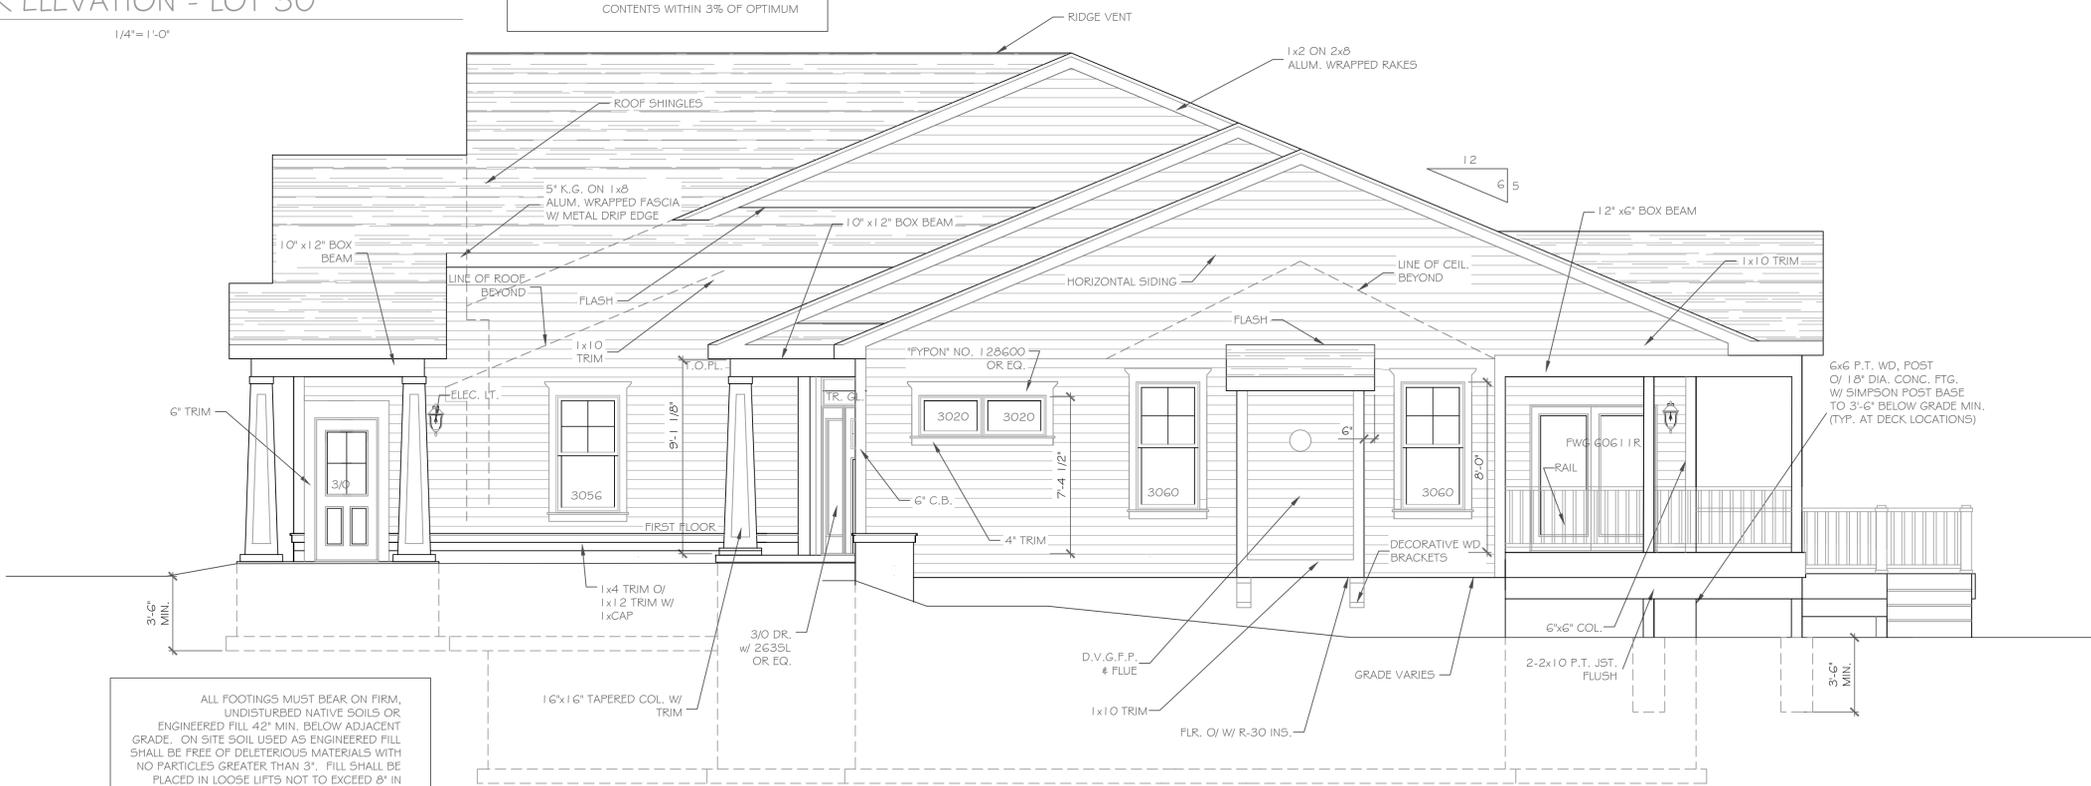
DRAWING NO. - A-1



REAR ELEVATION - LOT 29
1/4" = 1'-0"

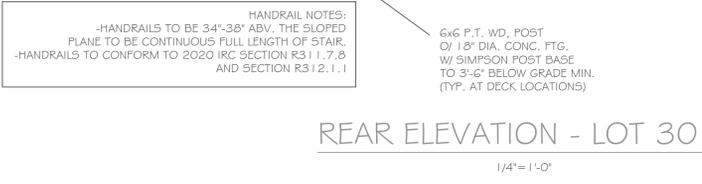

REAR ELEVATION - LOT 30
1/4" = 1'-0"



RIGHT SIDE ELEVATION - LOT 30
1/4" = 1'-0"

HANDRAIL NOTES:
-HANDRAILS TO BE 34"-38" ABV. THE SLOPED PLANE TO BE CONTINUOUS FULL LENGTH OF STAIR.
-HANDRAILS TO CONFORM TO 2020 IRC SECTION R311.7.8 AND SECTION R312.1.1

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NO.	DATE	DESCRIPTION

DRAWING TITLE:
Rear Elevation
Lots 29 & 30

PHASE:
Construction Documents

PROJECT:
Alpine Ridge - Lots 29 & 30
Pittsford, N.Y.


CLIENT:
Morrell Builders

JOB NO.:
A22-043

DATE:
September 14, 2022

CKH
architecture
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Suite 100
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phone: (585) 249-1334
e-mail: CKHennessey@frontier.net

DRAWING NO.:
A-2

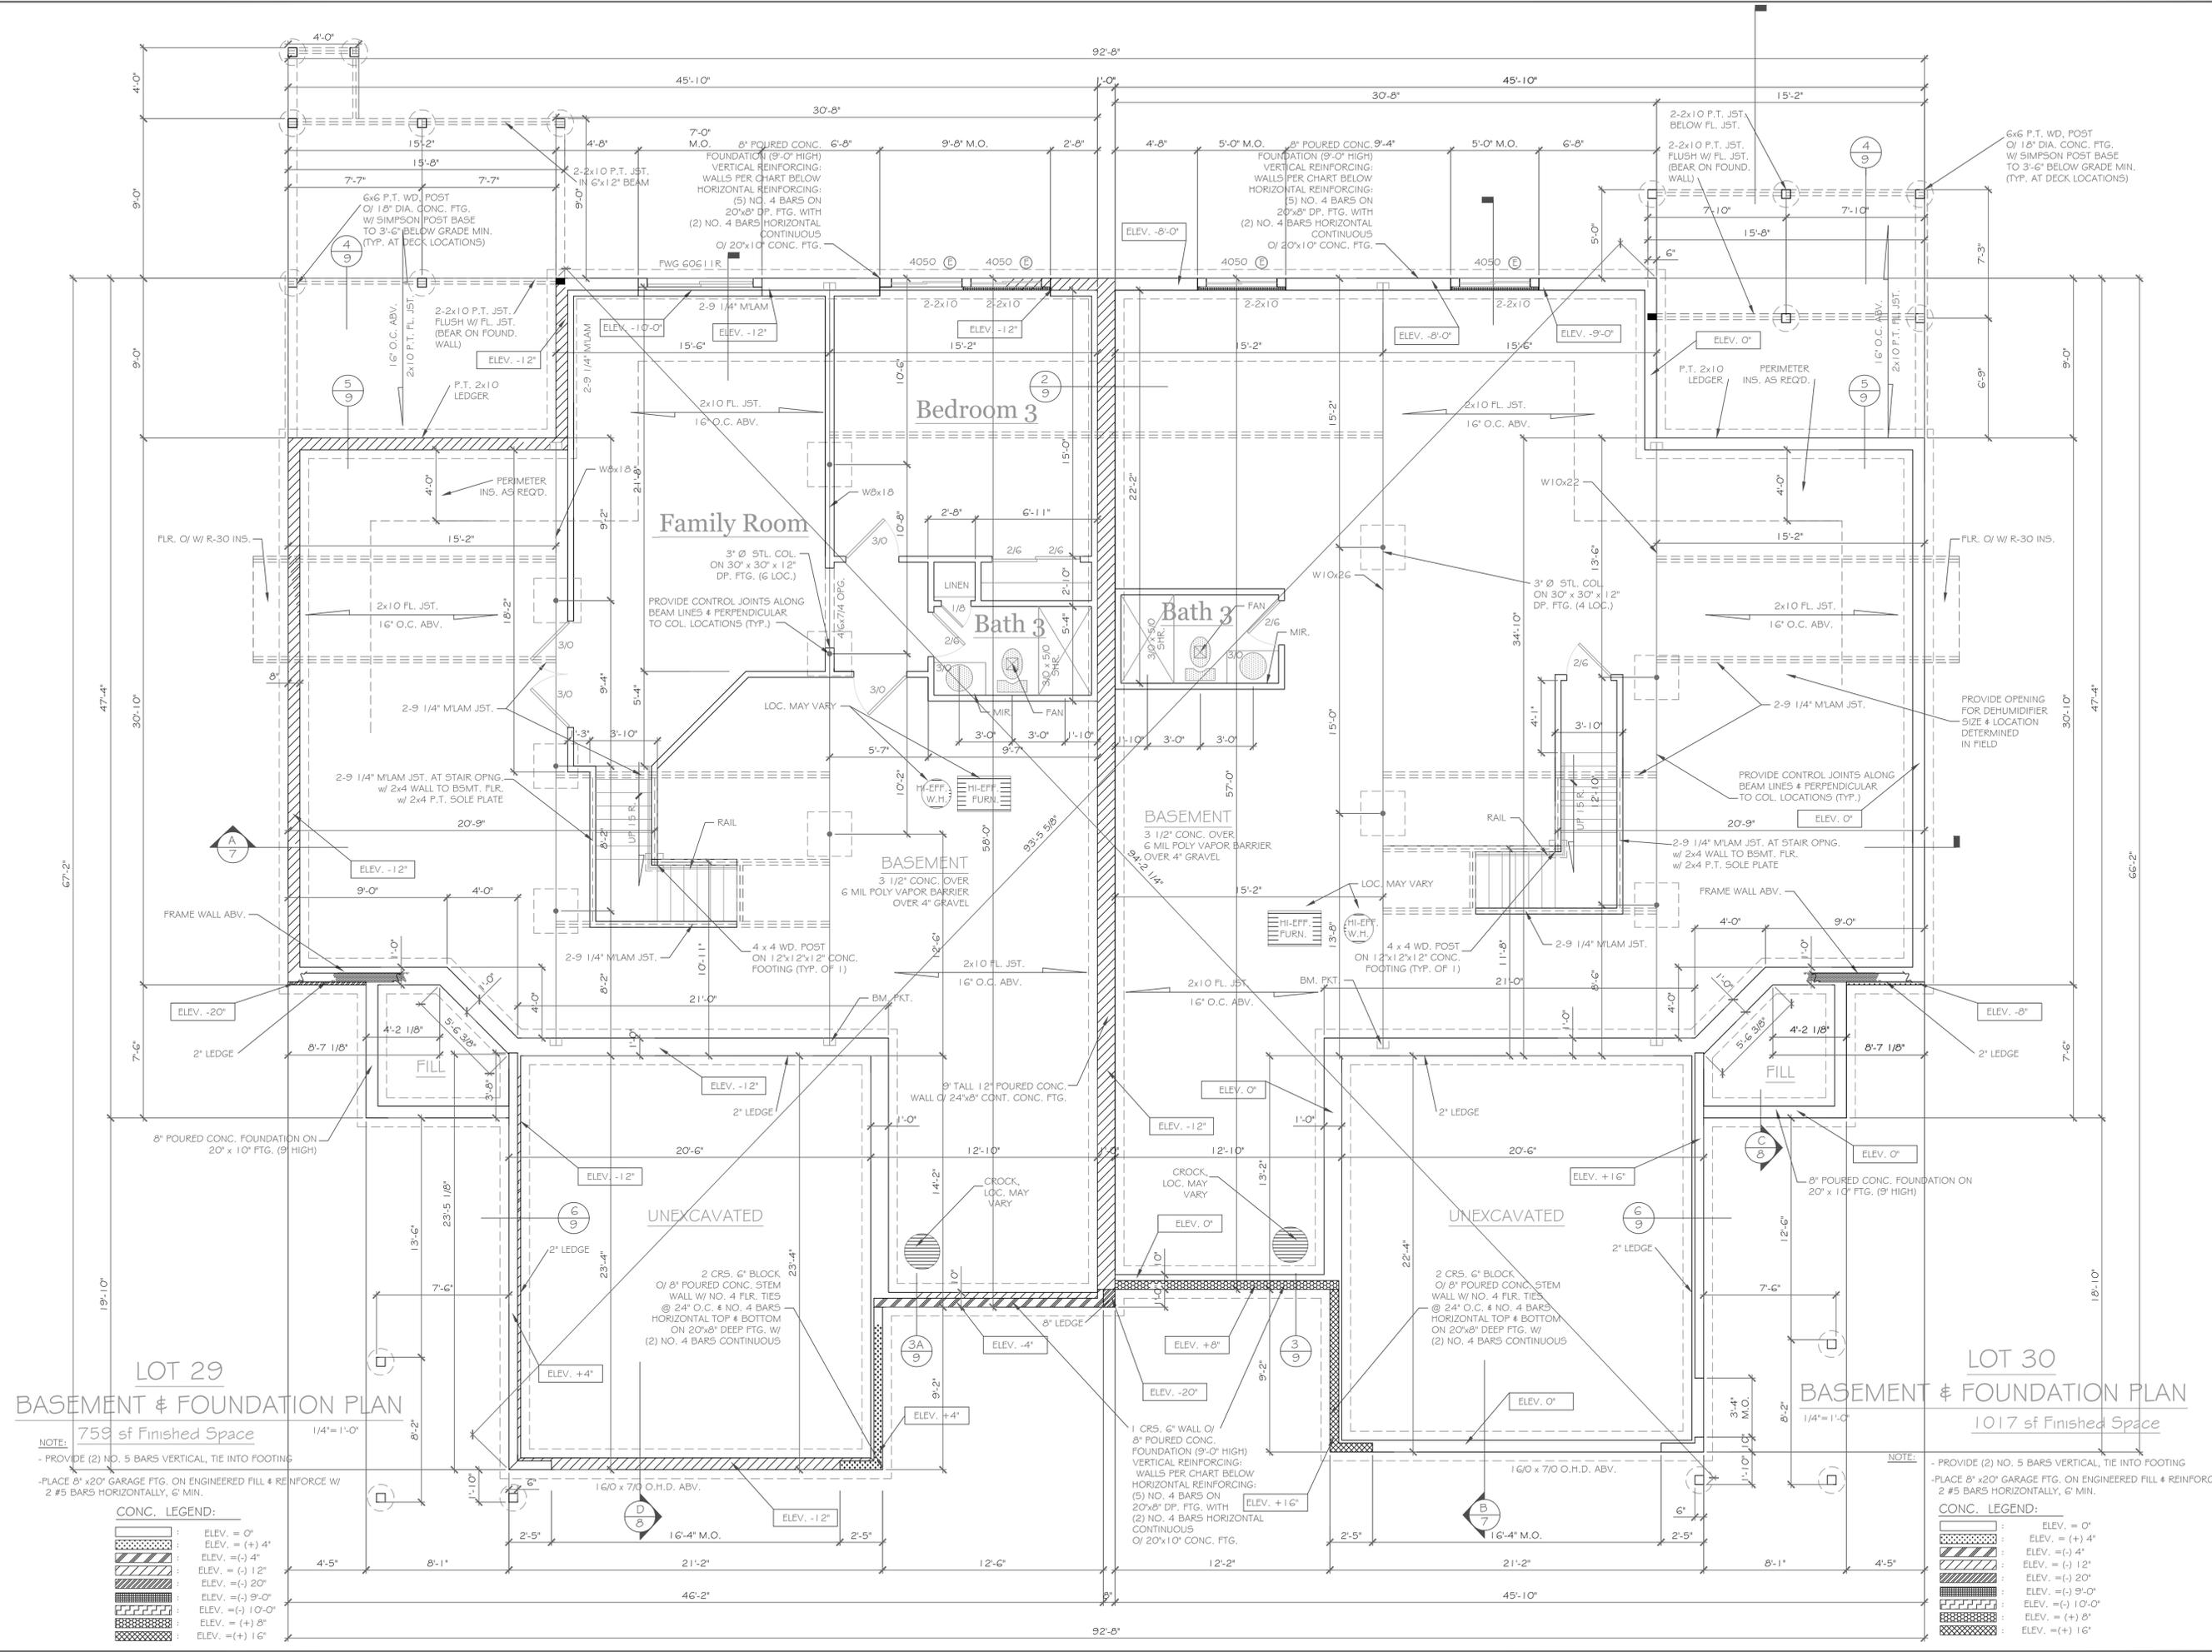

LOT 29
BASEMENT & FOUNDATION PLAN

759 sf Finished Space
 1/4" = 1'-0"
 NOTE: PROVIDE (2) NO. 5 BARS VERTICAL, TIE INTO FOOTING
 - PLACE 8" x 20" GARAGE FTG. ON ENGINEERED FILL & REINFORCE W/ 2 #5 BARS HORIZONTALLY, 6" MIN.
CONC. LEGEND:
 [Pattern] : ELEV. = 0'
 [Pattern] : ELEV. = (+) 4'
 [Pattern] : ELEV. = (-) 4'
 [Pattern] : ELEV. = (-) 12'
 [Pattern] : ELEV. = (-) 20'
 [Pattern] : ELEV. = (-) 9'-0"
 [Pattern] : ELEV. = (-) 10'-0"
 [Pattern] : ELEV. = (+) 8'
 [Pattern] : ELEV. = (+) 16'

LOT 30
BASEMENT & FOUNDATION PLAN

1017 sf Finished Space
 1/4" = 1'-0"
 NOTE: PROVIDE (2) NO. 5 BARS VERTICAL, TIE INTO FOOTING
 - PLACE 8" x 20" GARAGE FTG. ON ENGINEERED FILL & REINFORCE W/ 2 #5 BARS HORIZONTALLY, 6" MIN.
CONC. LEGEND:
 [Pattern] : ELEV. = 0'
 [Pattern] : ELEV. = (+) 4'
 [Pattern] : ELEV. = (-) 4'
 [Pattern] : ELEV. = (-) 12'
 [Pattern] : ELEV. = (-) 20'
 [Pattern] : ELEV. = (-) 9'-0"
 [Pattern] : ELEV. = (-) 10'-0"
 [Pattern] : ELEV. = (+) 8'
 [Pattern] : ELEV. = (+) 16'

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REVISIONS-	NO.	DATE	DESCRIPTION

DRAWING TITLE:
Basement & Foundation Plan

PHASE:
 Construction Documents

PROJECT:
 Alpine Ridge - Units 29 & 30
 Pittsford, New York

CLIENT:
 Morrell Builders

JOB NO.:
 A22-043

DATE:
 August 2022

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DRAWING NO.:
A-3

HANDRAIL NOTES:
 -HANDRAILS TO BE 34"-38" ABV. THE SLOPED PLANE TO BE CONTINUOUS FULL LENGTH OF STAIR.
 -HANDRAILS TO CONFORM TO 2020 IRC SECTION R311.7.8 AND SECTION R312.1.1

NOTES: SMOKE DETECTION & ALARM DEVICES:
 SMOKE DETECTING ALARM DEVICES, INSTALLED IN CONFORMITY WITH SECTION R313 OF THE RESIDENTIAL CODE OF NEW YORK STATE AND THE HOUSEHOLD FIRE WARNING EQUIPMENT PROVISIONS OF NFPA 72, SHALL BE PROVIDED IN EACH SLEEPING SPACE, OUTSIDE EACH SEPARATE SLEEPING AREA IN THE IMMEDIATE VICINITY OF THE BEDROOMS, AND ON EACH ADDITIONAL STORY OF THE DWELLING, INCLUDING BASEMENTS AND CELLARS BUT NOT INCLUDING CRAWL SPACES AND UNINHABITABLE ATTICS.

CARBON MONOXIDE ALARMS, INSTALLED IN CONFORMITY WITH SECTION R313 OF THE RCNY, SHALL BE PROVIDED IN EACH DWELLING UNIT ON ANY STORY HAVING A SLEEPING AREA AND ON ANY STORY OF A DWELLING UNIT WHERE FUEL-FIRED APPLIANCES AND EQUIPMENT, SOLID-FUEL BURNING APPLIANCES AND EQUIPMENT, FIREPLACES, OR ATTACHED GARAGES ARE LOCATED.


HANDRAIL NOTES:
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REVISIONS:	NO.	DATE	DESCRIPTION



FIRST FLOOR PLAN 2023 S.F.
LOT 29

FIRST FLOOR PLAN 2010 S.F.
LOT 30

NOTES:
 - EXTERIOR WALLS TO BE 2 x 6 - 24" O.C. U.O.N. (UNLESS OTHERWISE NOTED)
 - INTERIOR WALLS TO BE 2 x 4 - 24" O.C. U.O.N.
 - PROVIDE SOLID BLDG. (3 STUD POST MIN. GLUE AND NAIL) @ ALL BRG. POINTS
 - APPLIANCES PER CONTRACT
 - WINDOW R.O. HTS. TO BE 7'-4 1/2" U.O.N.
 - CEILING HTS. TO BE 9'-1 1/8" U.O.N.
 - ANGLES TO BE 12/12 U.O.N.

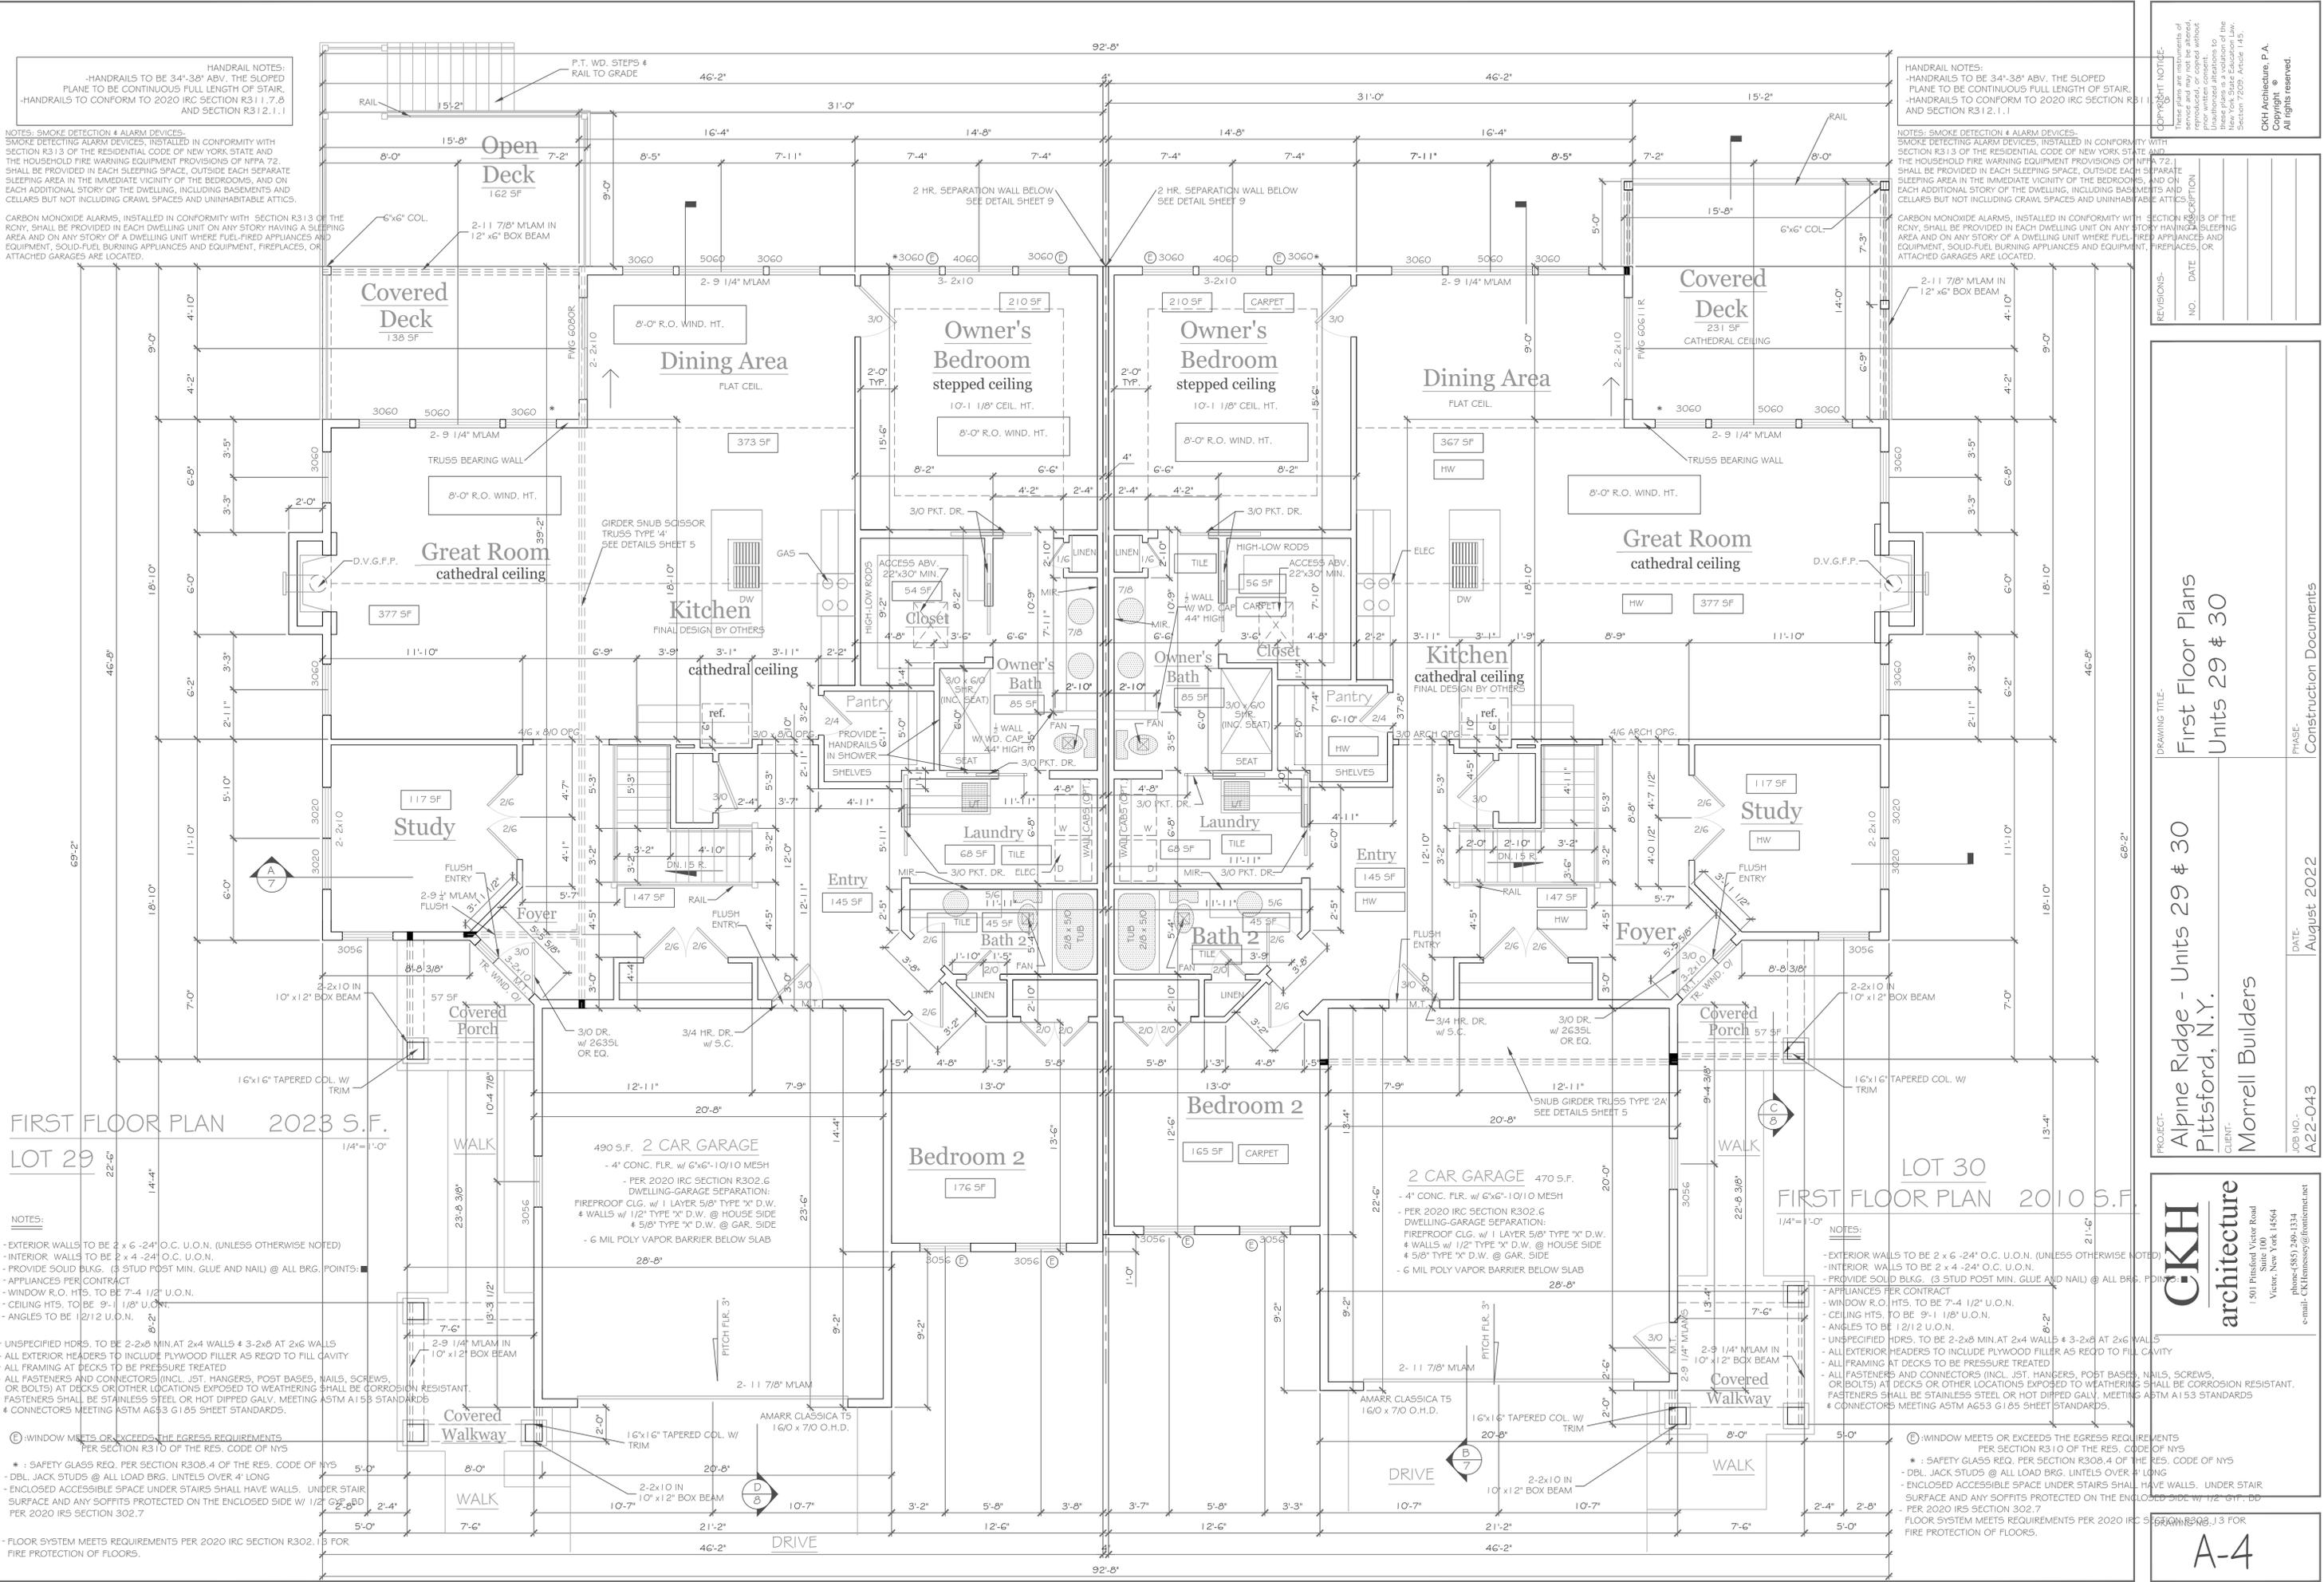NOTES:
 - EXTERIOR WALLS TO BE 2 x 6 - 24" O.C. U.O.N. (UNLESS OTHERWISE NOTED)
 - INTERIOR WALLS TO BE 2 x 4 - 24" O.C. U.O.N.
 - PROVIDE SOLID BLDG. (3 STUD POST MIN. GLUE AND NAIL) @ ALL BRG. POINTS
 - APPLIANCES PER CONTRACT
 - WINDOW R.O. HTS. TO BE 7'-4 1/2" U.O.N.
 - CEILING HTS. TO BE 9'-1 1/8" U.O.N.
 - ANGLES TO BE 12/12 U.O.N.

- UNSPECIFIED HDRS. TO BE 2-2x8 MIN. AT 2x4 WALLS & 3-2x8 AT 2x6 WALLS
 - ALL EXTERIOR HEADERS TO INCLUDE PLYWOOD FILLER AS REQ'D TO FILL CAVITY
 - ALL FRAMING AT DECKS TO BE PRESSURE TREATED
 - ALL FASTENERS AND CONNECTORS (INCL. JST. HANGERS, POST BASES, NAILS, SCREWS, OR BOLTS) AT DECKS OR OTHER LOCATIONS EXPOSED TO WEATHERING SHALL BE CORROSION RESISTANT. FASTENERS SHALL BE STAINLESS STEEL OR HOT DIPPED GALV. MEETING ASTM A153 STANDARDS & CONNECTORS MEETING ASTM A653 G185 SHEET STANDARDS.

- UNSPECIFIED HDRS. TO BE 2-2x8 MIN. AT 2x4 WALLS & 3-2x8 AT 2x6 WALLS
 - ALL EXTERIOR HEADERS TO INCLUDE PLYWOOD FILLER AS REQ'D TO FILL CAVITY
 - ALL FRAMING AT DECKS TO BE PRESSURE TREATED
 - ALL FASTENERS AND CONNECTORS (INCL. JST. HANGERS, POST BASES, NAILS, SCREWS, OR BOLTS) AT DECKS OR OTHER LOCATIONS EXPOSED TO WEATHERING SHALL BE CORROSION RESISTANT. FASTENERS SHALL BE STAINLESS STEEL OR HOT DIPPED GALV. MEETING ASTM A153 STANDARDS & CONNECTORS MEETING ASTM A653 G185 SHEET STANDARDS.

© WINDOW MEETS OR EXCEEDS THE EGRESS REQUIREMENTS PER SECTION R310 OF THE RES. CODE OF NYS
 * SAFETY GLASS REQ. PER SECTION R308.4 OF THE RES. CODE OF NYS
 - DBL. JACK STUDS @ ALL LOAD BRG. LITELS OVER 4' LONG
 - ENCLOSED ACCESSIBLE SPACE UNDER STAIRS SHALL HAVE WALLS, UNDER STAIR SURFACE AND ANY SOFFITS PROTECTED ON THE ENCLOSED SIDE W/ 1/2" GYP. BD PER 2020 IRS SECTION 302.7

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 * SAFETY GLASS REQ. PER SECTION R308.4 OF THE RES. CODE OF NYS
 - DBL. JACK STUDS @ ALL LOAD BRG. LITELS OVER 4' LONG
 - ENCLOSED ACCESSIBLE SPACE UNDER STAIRS SHALL HAVE WALLS, UNDER STAIR SURFACE AND ANY SOFFITS PROTECTED ON THE ENCLOSED SIDE W/ 1/2" GYP. BD PER 2020 IRS SECTION 302.7

DRAWING TITLE:
First Floor Plans
Units 29 & 30

PROJECT:
Alpine Ridge - Units 29 & 30
Pittsford, N.Y.

CLIENT:
Morrell Builders

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EMAIL: CKHennessey@frontiernet.net

PHASE: Construction Documents
DATE: August 2022
JOB NO.: A22-043
SCALE: AS SHOWN
DATE: August 2022