

**Design Review & Historic Preservation Board
Agenda
July 14, 2022**

HISTORIC PRESERVATION DISCUSSION

BUILDING INSPECTOR REMARKS

RESIDENTIAL APPLICATION FOR REVIEW

- **71 Reitz Parkway**
The Applicant is requesting design review for an addition of a 446sf master bedroom addition, renovation of their 3 season room to a 4 season room, and addition of a roof over the front porch.
- **17 Northfield Gate**
The Applicant is requesting design review for an addition of a 150 sf addition off the southwest corner of the existing house.
- **57 Shire Oaks**
The applicant is requesting design review for an addition of a 255 sf front porch deck on the front entry way of the property.
- **81 Knickerbocker Road**
The applicant is requesting design review for an addition of a 683 sf worth of additions including, Phase 1: second floor renovations including new roof line for master bedroom and bath. Remodel 2 existing baths and relocate laundry. Phase 2: including front bump out/entry way and moving kitchen, rebuilding and adding to sunroom in back.
- **111 Mill Road**
The applicant is requesting design review for an addition of a 436 sf addition off the back of the existing house.

RESIDENTIAL APPLICATION FOR REVIEW – NEW HOMES

- **54 Coventry Ridge**
Applicant is requesting design review for the construction of a two story single family home. The home will have approximately 4342 square feet of livable area and is located in the Coventry Ridge Subdivision.

COMMERCIAL APPLICATION FOR REVIEW – COMMERCIAL

- **3500 East Ave - Garages**
Applicant is requesting design review for the construction of 2 detached garages, 2490 sq ft per garage, that will be located on the Kilbourne Place on East property.

DEMOLITION AND RESIDENTIAL APPLICATION FOR REVIEW - RETURNING

- **93 Kilbourn Road**
In accordance with Chapter 64 Article VIII, §64-43 of the Pittsford Town Code, the owner of 93 Kilbourn Road is requesting approval from the Design Review and Historic Preservation Board to demolish the existing 2,220 +/- square foot home at 93 Kilbourn Road and rebuild a new 5,400 +/- square foot single family home on the property. Tax Parcel No. 138.13-3-8. This property is Zoned Residential Neighborhood (RN).

Design Review and Historic Preservation Board
Minutes
June 23, 2022

PRESENT

Dirk Schneider, Chairman; David Wigg, Vice Chairman; Jim Vekasy, Kathleen Cristman, Bonnie Salem, John Mitchell, Paul Whitbeck

ALSO PRESENT

Robert Koegel, Town Attorney; Bill Zink, Building Inspector; Anthony Caruso, Building Inspector; Susan Donnelly, Secretary to the Board

HISTORIC PRESERVATION DISCUSSION

The Board discussed historical marker will be installed once the paint is procured for the pole to match the sign.

The Board requested that the Board Secretary communicate with the Town Communications Director about pursuing the website project regarding posting information on Historic Designated homes and report back at a future meeting.

BUILDING INSPECTOR REMARKS

Bill Zink addressed the audience regarding protocol for approaching the Board and information on the next steps regarding approved applications.

RESIDENTIAL APPLICATION FOR REVIEW – NEW HOMES

- **2 Rockdale Meadows (Lot 21)**

The Applicant is requesting design review for the construction of a one story single family home. The home will be approximately 2866 square feet.

Austin Miller of Rockdale Meadows Construction Corporation was present to discuss the application with the Board.

This is the last patio home in the development. It will feature an end load garage and a walkout basement. This home features 3 materials on the front elevations but is similar to others in the area. There will be no stone return on the front elevation as there are corner boards detailed in the design.

Paul Whitbeck moved to approve the application as submitted.

John Mitchell seconded.

All Ayes.

- **52 Nature View**

The Applicant is requesting design review for the construction of a two story single family home. The home will be approximately 2023 square feet.

George Masi of Mascot Builders was in attendance.

This home will feature vinyl siding with decorative brick veneer or cultured stone on the front elevation.

The Board drew attention to the cantilevered fireplace and the massing of the left side of the rear elevation. They would like to see a window added to match the other small window closest to the left side of that elevation.

Dirk Schneider moved to approve the application as submitted with the following conditions:

1. Two brackets to be added below the fireplace if the grade is lower than 24".
2. A double hung window to be added at the garage rear elevation.

COMMERCIAL APPLICATION FOR REVIEW – SIGNAGE

- **3349 Monroe Avenue - Asurion**

The Applicant is requesting design review for the addition of an approximately 14.94 SF sign for a tech repair shop.

Kirk Wright was present to represent Sign and Lighting Services.

The sign which will feature illuminated channel letters was reviewed by the Board and determined to be in keeping with the Plaza.

Bonnie Salem moved to approve the application as submitted.

David Wigg seconded.

All Ayes.

DEMOLITION AND RESIDENTIAL APPLICATION FOR REVIEW

- **4000 East Avenue**

In accordance with Chapter 64 Article VIII, §64-43 of the Pittsford Town Code, the owner of 4000 East Avenue is requesting approval from the Design Review and Historic Preservation Board to demolish the existing "Caretaker home" and rebuild a new guest house on the same footprint. Tax Parcel No. 151.06-2-45. This property is Zoned Residential Neighborhood (RN).

Dirk Schneider opened the Public Hearing.

Chuck Smith of Design Works Architecture was in attendance.

The proposal is to demolish a guest house and build a similar structure on this property. The guest house that is proposed to be demolished is on the site of a home which was built in 1972. The foundation is unstable and the structure is in poor condition and not adequate to for use as a renovated structure. The Board asked for documentation of this in order to approve a demolition.

Documents submitted show that this structure may have been part of a hotel compound which was built prior to 1936 and has since been demolished. Bonnie Salem noted it would be important to archive these documents. Mr. Smith indicated that old stone walks have been discovered on the property and are proposed to be restored.

The new guest house is proposed to be of the same footprint of the old structure with the intent to match the current height. A new garage/garden shed and courtyard is also proposed to be constructed in conjunction with the new guest house. A variance per Town Code will be required from the Zoning Board of Appeals for a structure exceeding 180 sq. ft.

Bonnie Salem requested documentation of the on the property to see if the proposed design is compatible with the current structure.

Robert Koegel reminded the Board that any demolition approval must go hand in hand with the approval of a proposed structure, therefore the demolition approval should not be voted on until the Board can review and deliberate on all the requested documentation.

There was no public comment.

This hearing remains open pending the submission of further information.

- **93 Kilbourn Road**

In accordance with Chapter 64 Article VIII, §64-43 of the Pittsford Town Code, the owner of 93 Kilbourn Road is requesting approval from the Design Review and Historic Preservation Board to demolish the existing 2,220 +/- square foot home at 93 Kilbourn Road and rebuild a new 5,400 +/- square foot single family home on the property. Tax Parcel No. 138.13-3-8. This property is Zoned Residential Neighborhood (RN).

Dirk Schneider opened the Public Hearing.

Dan DeLaus, attorney for the homeowners, discussed with the Board that his clients had not uncovered any information that the structure at 93 Kilbourn has any historical significance. Mr. DeLaus referenced the Town Code regarding Design Review in regards to excessive similarity or dissimilarity and detriment to the neighborhood caused by any new structure. He shared with the Board that a previous two-story design had been withdrawn by the homeowner in an effort to develop a structure more compatible with the Kilbourn neighborhood. A discussion ensued about what the definition of this particular neighborhood is. Mr. DeLaus expressed his opinion that this design would enhance this neighborhood and it would not prove detrimental.

Robert Koegel, attorney for the Town of Pittsford, reviewed the standards of the recently enacted demolition code stating that the new construction must meet the standards of that for demolition and the Board's role is to determine what impact the new home would have on the neighborhood. Furthermore, the Board has the discretion to determine what the definition of the neighborhood is.

Al Arilotta, architect for the homeowners, discussed his opinion that from the road the house will blend in with the height of the homes in the neighborhood. Mr. Arilotta referred an illustration presented to the Board (A-4) during the meeting demonstrating the current and proposed front elevations of the new structure.

Christine Giangreco, homeowner and designer, described the proposed structure as a one-story white stucco home with a 3 car courtyard style garage featuring dark wood carriage doors. Russ Giangreco described their justification for the three-car garage including their desire not to have multiple cars in the driveway. An email from a neighbor residing at 113 Kilbourn Road was provided to the Board from the Giangreco's indicating he had no objection to the project. An updated plot map was also provided from the homeowners to the Board at this meeting indicating there is no need for a variance for a side setback. Ms. Giangreco discussed the potential for planting arbor vitae to buffer the neighbor's view of the new home.

Kathleen Cristman asked to review the reason for the demolition. It was discussed how the current home does not meet the homeowner's need for 4 bedrooms when they are hosting company. The need for asbestos abatement was also discussed.

The Board discussed the plans and facts presented to them. Dirk Schneider discussed that the new plan more than doubles the current footprint. He stated that the garage in front, despite the courtyard design, points to dissimilarity in the neighborhood. He felt the siding is a departure from the neighborhood but held some interest as a material. Bonnie Salem indicated that she would like to review a comparison of the sizes of other homes in the neighborhood. A discussion of sizes and square footage of other homes in the neighborhood was then held. It was noted that this property at 93 Kilbourn Road has more acreage than some and lot sizes vary on the street.

Dirk Schneider called for public comment.

Ray Siefert of 103 Kilbourn Road, the immediate next door neighbor, referred to photographs submitted to the Board of his backyard and discussed the impact this new larger structure would have on his property. He feels the length of the home will block his view and would be detrimental to his property.

Richard Morton of 50 Kilbourn Road spoke regarding traffic concerns during construction and the upcoming PGA Tournament in May of 2023.

Bonnie Salem indicated that her opinion is that the Board needs time to consider what they have heard. Robert Koegel indicated that the Board should consider providing a list of concerns to the applicants to give them an opportunity to consider any changes based on feedback from the Board.

While the Board appreciated the effort of the one story design, further discussion of concerns by the Board included the following:

1. The home will be a disruption of the view for the neighbors.
2. The character of the neighborhood is being chipped away in favor of newer, larger homes.
3. The home is too large for this neighborhood; the homeowner should consider decreasing the size of the footprint.
4. A two-car garage could be a consideration to decrease the size.

The Board referenced another home demolition prior to the new demolition law being enacted where the homeowners considered and complied with the Board's input and felt that some revision is also appropriate in this case.

It was determined that this hearing should be left open to give the applicant some time to consider their submission given the Board's remarks before it is put to a vote.

REVIEW OF MINUTES OF JUNE 9, 2022 MEETING

Bonnie Salem moved to accept the minutes of the June 9, 2022 meeting as written.

Kathleen Cristman seconded.

All Ayes.


ADJOURNMENT

Dirk Schneider moved to close the meeting at 8:26 pm.

All Ayes.

Respectfully submitted,

Susan Donnelly
Secretary to the Design Review and Historic Preservation Board

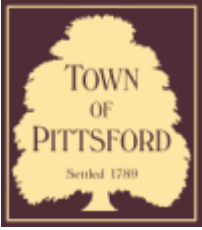

Town of Pittsford

Department of Public Works
11 South Main Street
Pittsford, New York 14534

Permit #
B22-000102

Phone: 585-248-6250
FAX: 585-248-6262

DESIGN REVIEW AND HISTORIC PRESERVATION BOARD REFERRAL OF APPLICATION

Property Address: 71 Reitz PITTSFORD, NY 14534

Tax ID Number: 164.11-2-60

Zoning District: RN Residential Neighborhood

Owner: Chin, Kenneth T

Applicant: Chin, Kenneth T

Application Type:


- | | |
|---|---|
| <input checked="" type="checkbox"/> Residential Design Review
§185-205 (B) | <input type="checkbox"/> Build to Line Adjustment
§185-17 (B) (2) |
| <input type="checkbox"/> Commercial Design Review
§185-205 (B) | <input type="checkbox"/> Building Height Above 30 Feet
§185-17 (M) |
| <input type="checkbox"/> Signage
§185-205 (C) | <input type="checkbox"/> Corner Lot Orientation
§185-17 (K) (3) |
| <input type="checkbox"/> Certificate of Appropriateness
§185-197 | <input type="checkbox"/> Flag Lot Building Line Location
§185-17 (L) (1) (c) |
| <input type="checkbox"/> Landmark Designation
§185-195 (2) | <input type="checkbox"/> Undeveloped Flag Lot Requirements
§185-17 (L) (2) |
| <input type="checkbox"/> Informal Review | |

Project Description: The applicant is requesting design review for an addition of a 446sf master bedroom addition, renovation of their 3 season room to a 4 season room, and addition of a roof over the front porch.


Meeting Date: July 14, 2022



RN Residential Neighborhood Zoning

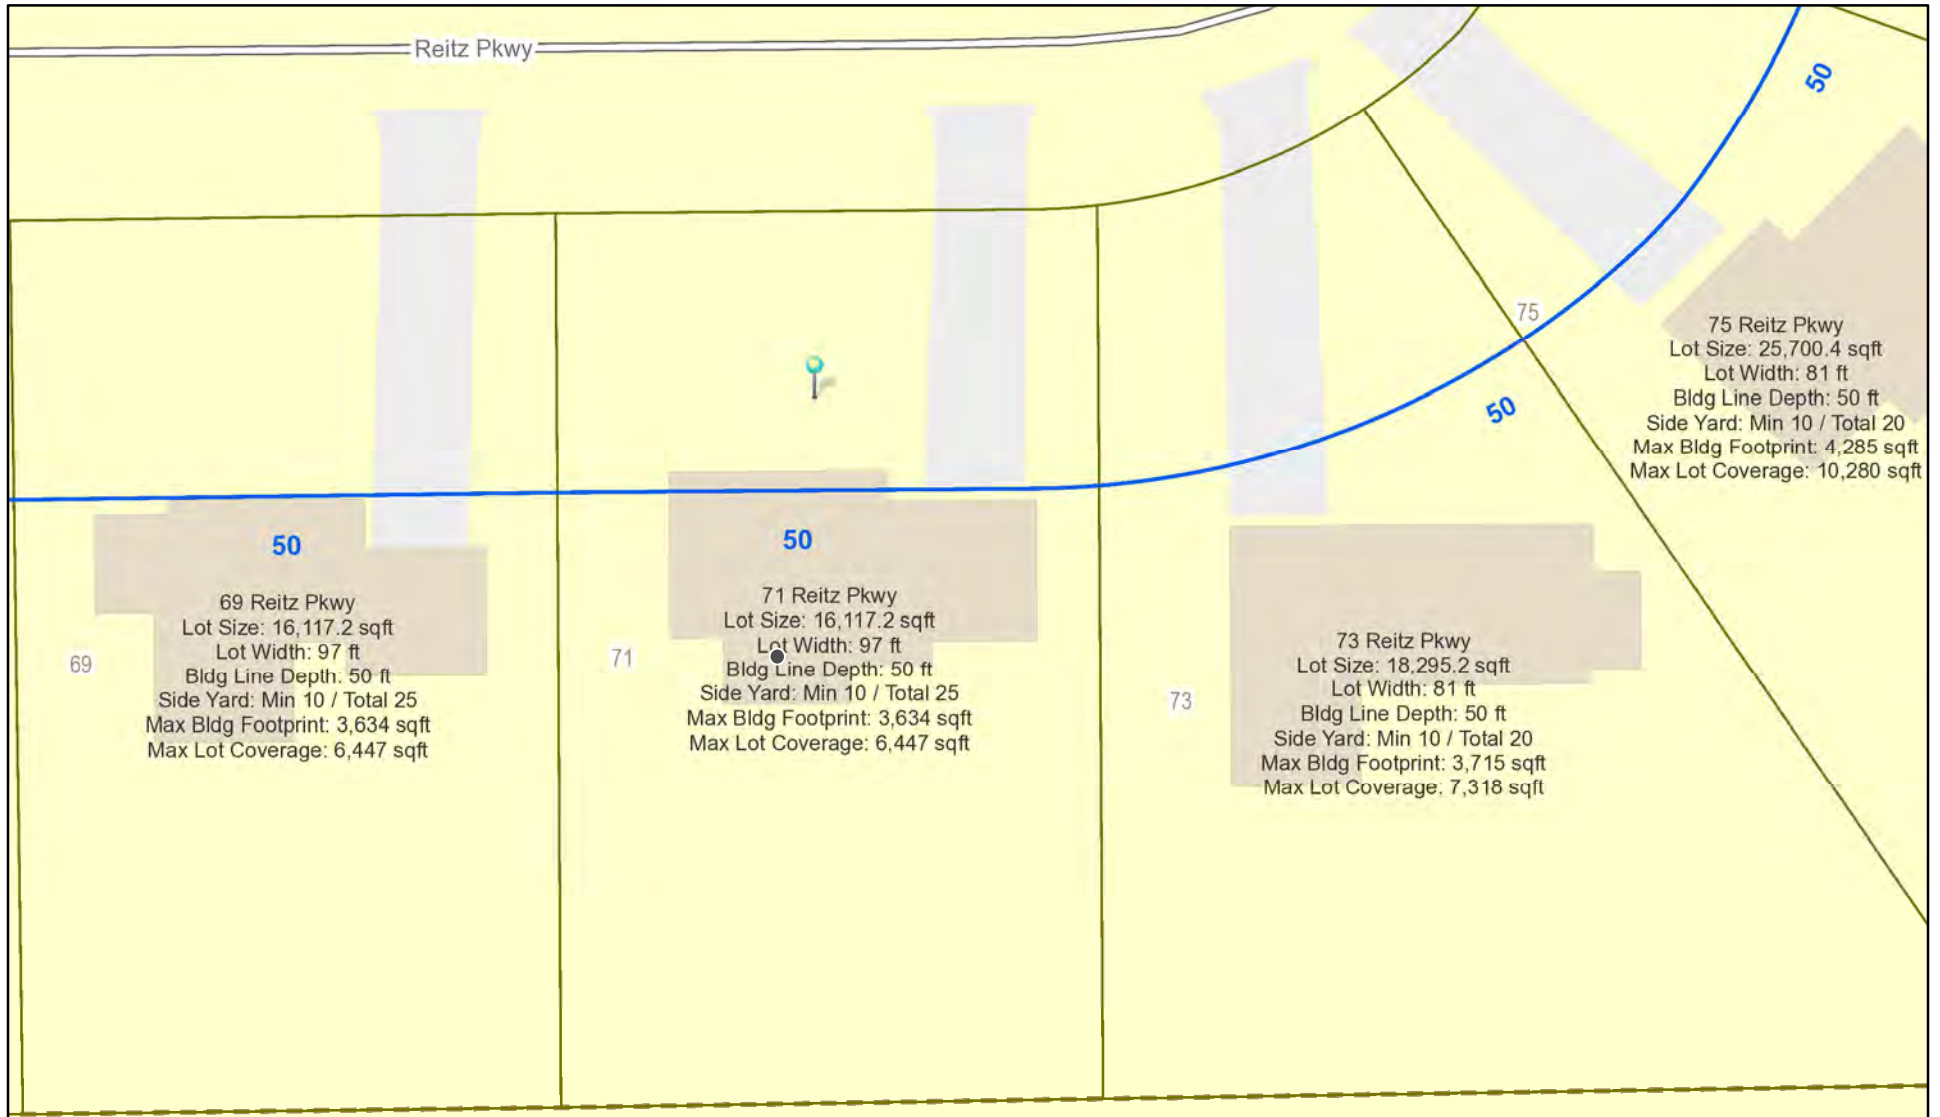

Printed June 28, 2022

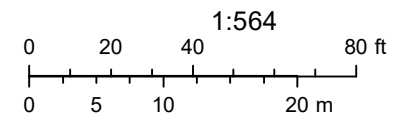


Town of Pittsford GIS

The information depicted on this map is representational and should be used for general reference purposes only. No warranties, expressed or implied, are provided for the data or its use or interpretation.



Reitz Pkwy

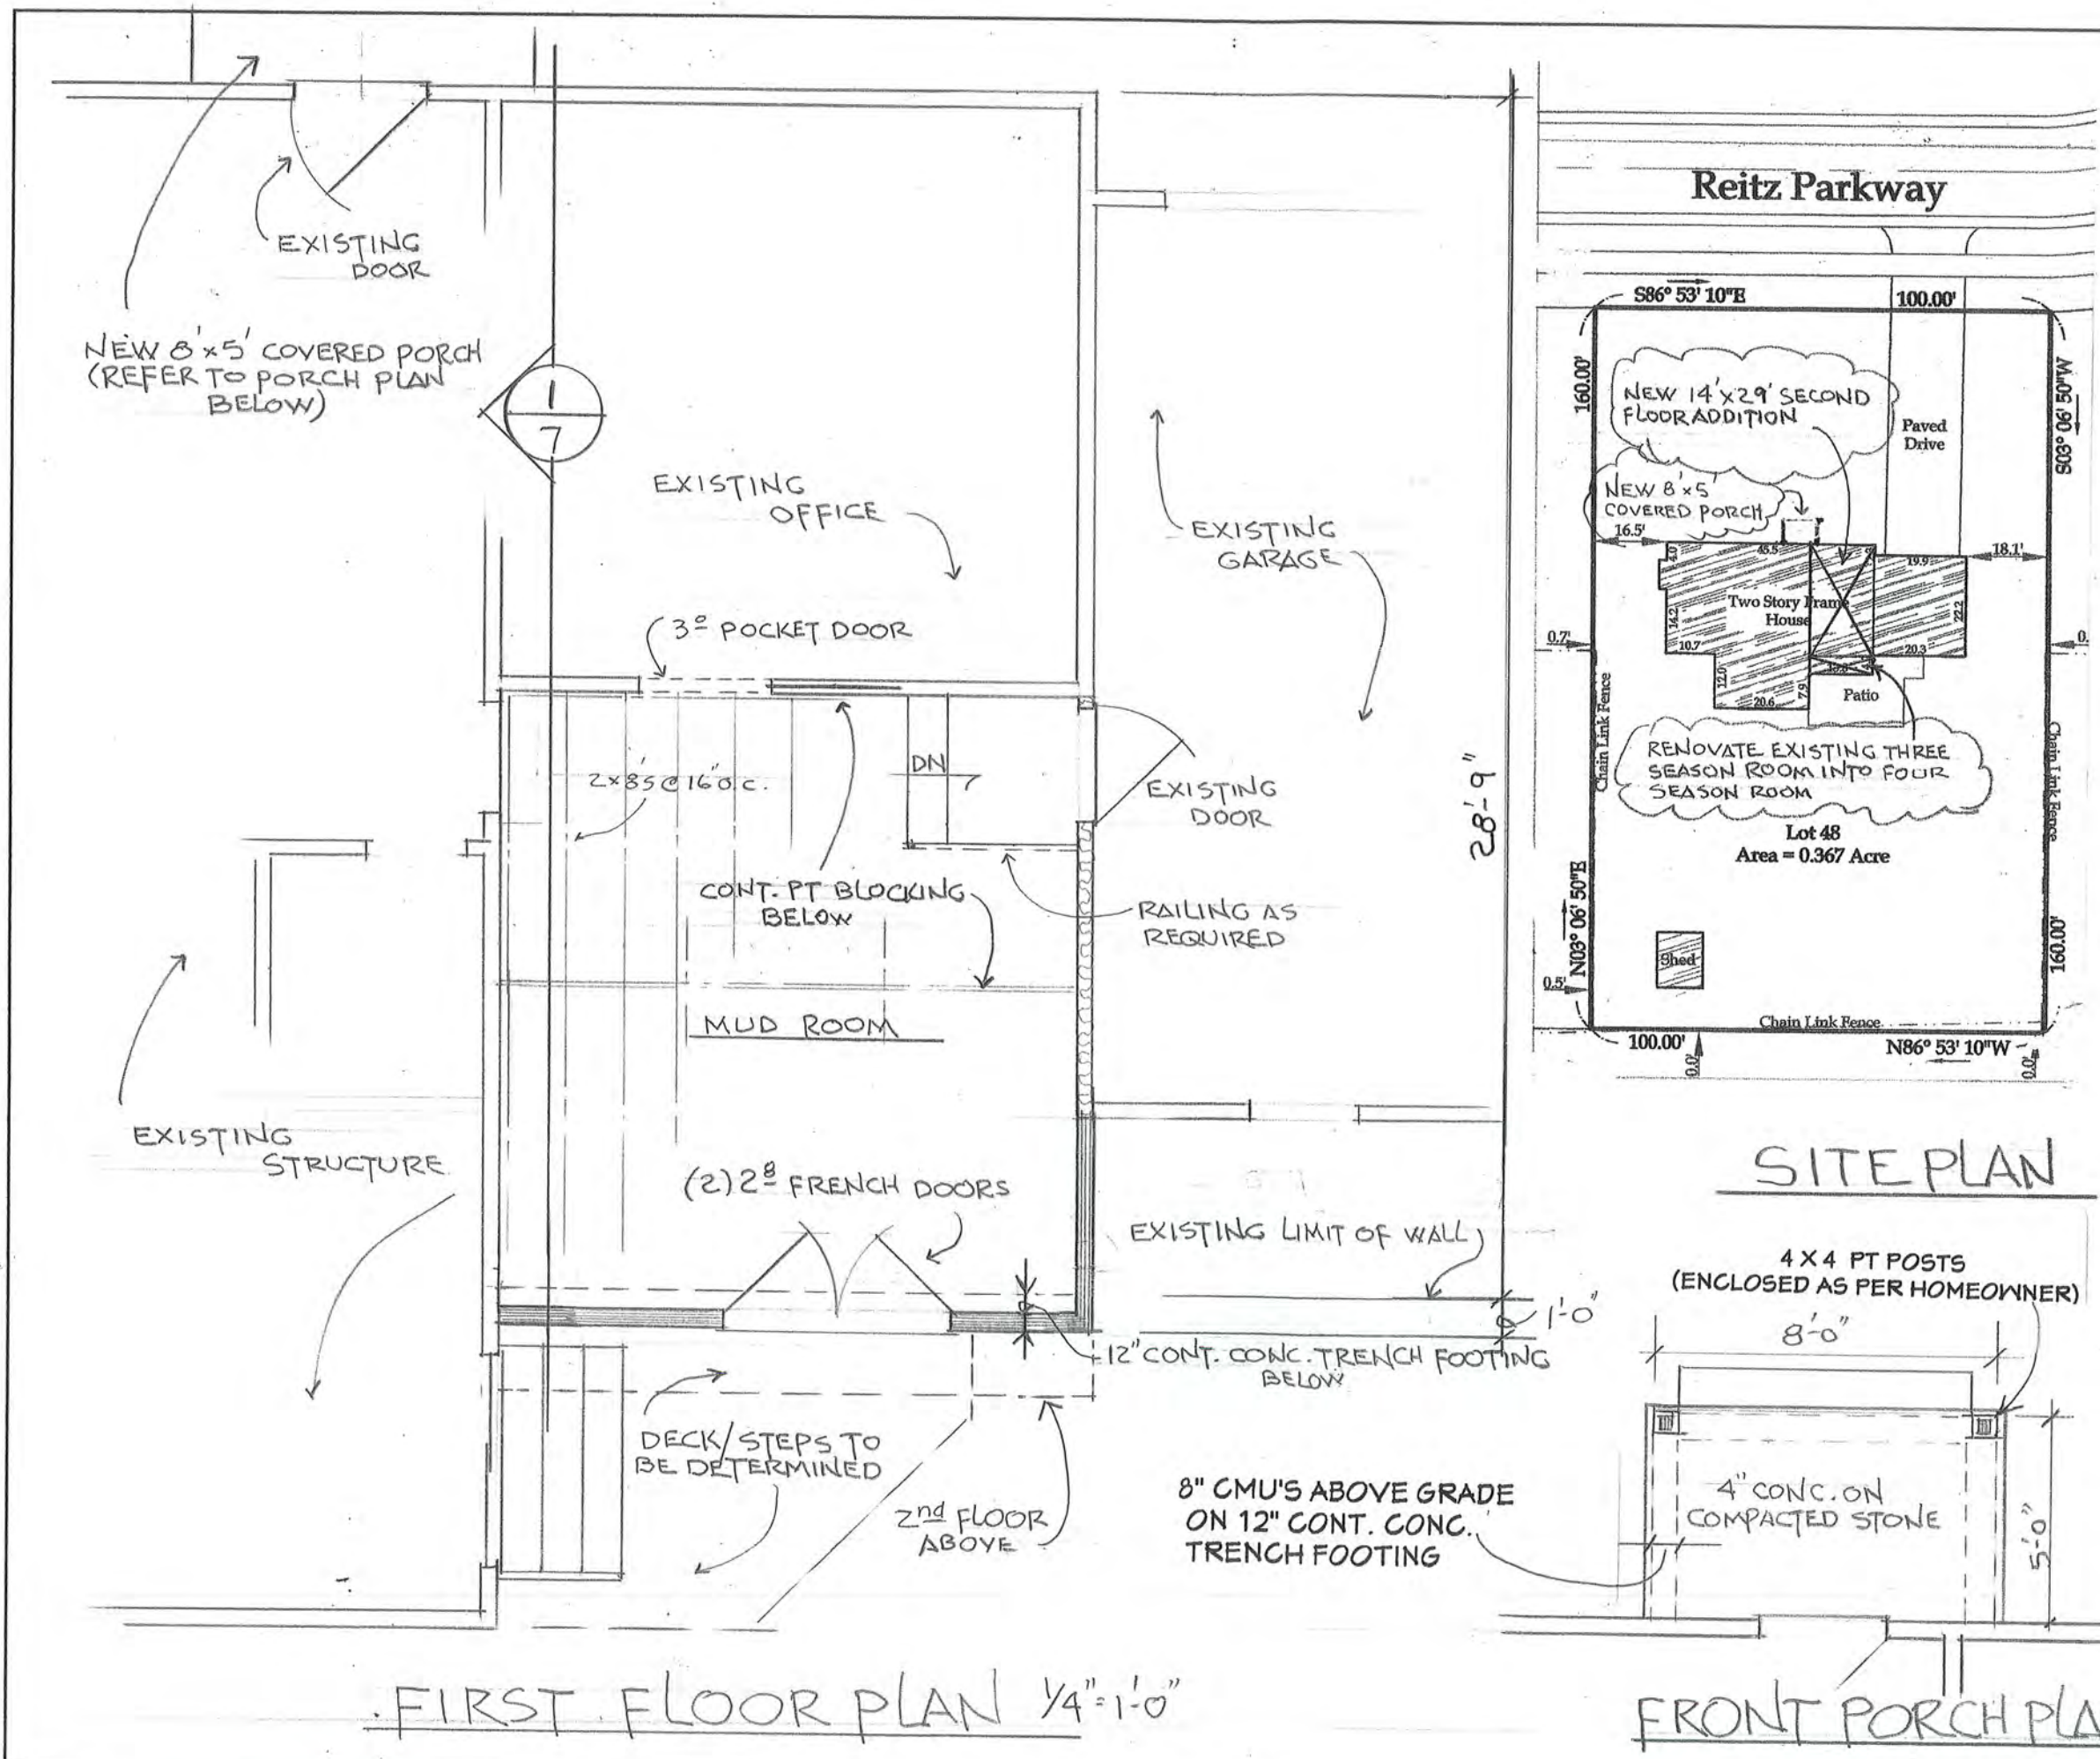

**THOMAS R. DOUGHTY
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DATE: 12-17-2020

SCALE:

REVISIONS

- 1/20/2021
- 5/19/2022
- 6/10/2022

PROJECT

Residential Addition/Renovation for:

71 Reitz Parkway
Pittsford, New York 14534

DRAWING TITLE

SITE PLAN &
FIRST FLOOR PLAN

SHEET NUMBER

1 OF 7

ROOF OVER NEW PORCH

* ESCAPE/RESCUE OPENINGS NOTED OPENING SIZES TO HAVE MIN. NET CLEAR OPENING OF 5 sq.ft. FOR GRADE FLOOR AND 5.7 sq.ft. FOR SECOND FLOOR

THOMAS R. DOUGHTY ARCHITECT, P.C.

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DATE: 12-17-2020

SCALE: 1/4" = 1'-0"

1/20/2021 REVISIONS
6/10/2022

PROJECT

Residential Addition/Renovation for:


71 Reitz Parkway
Pittsford, New York 14534

DRAWING TITLE

SECOND FLOOR PLAN

SHEET NUMBER

2 OF 7

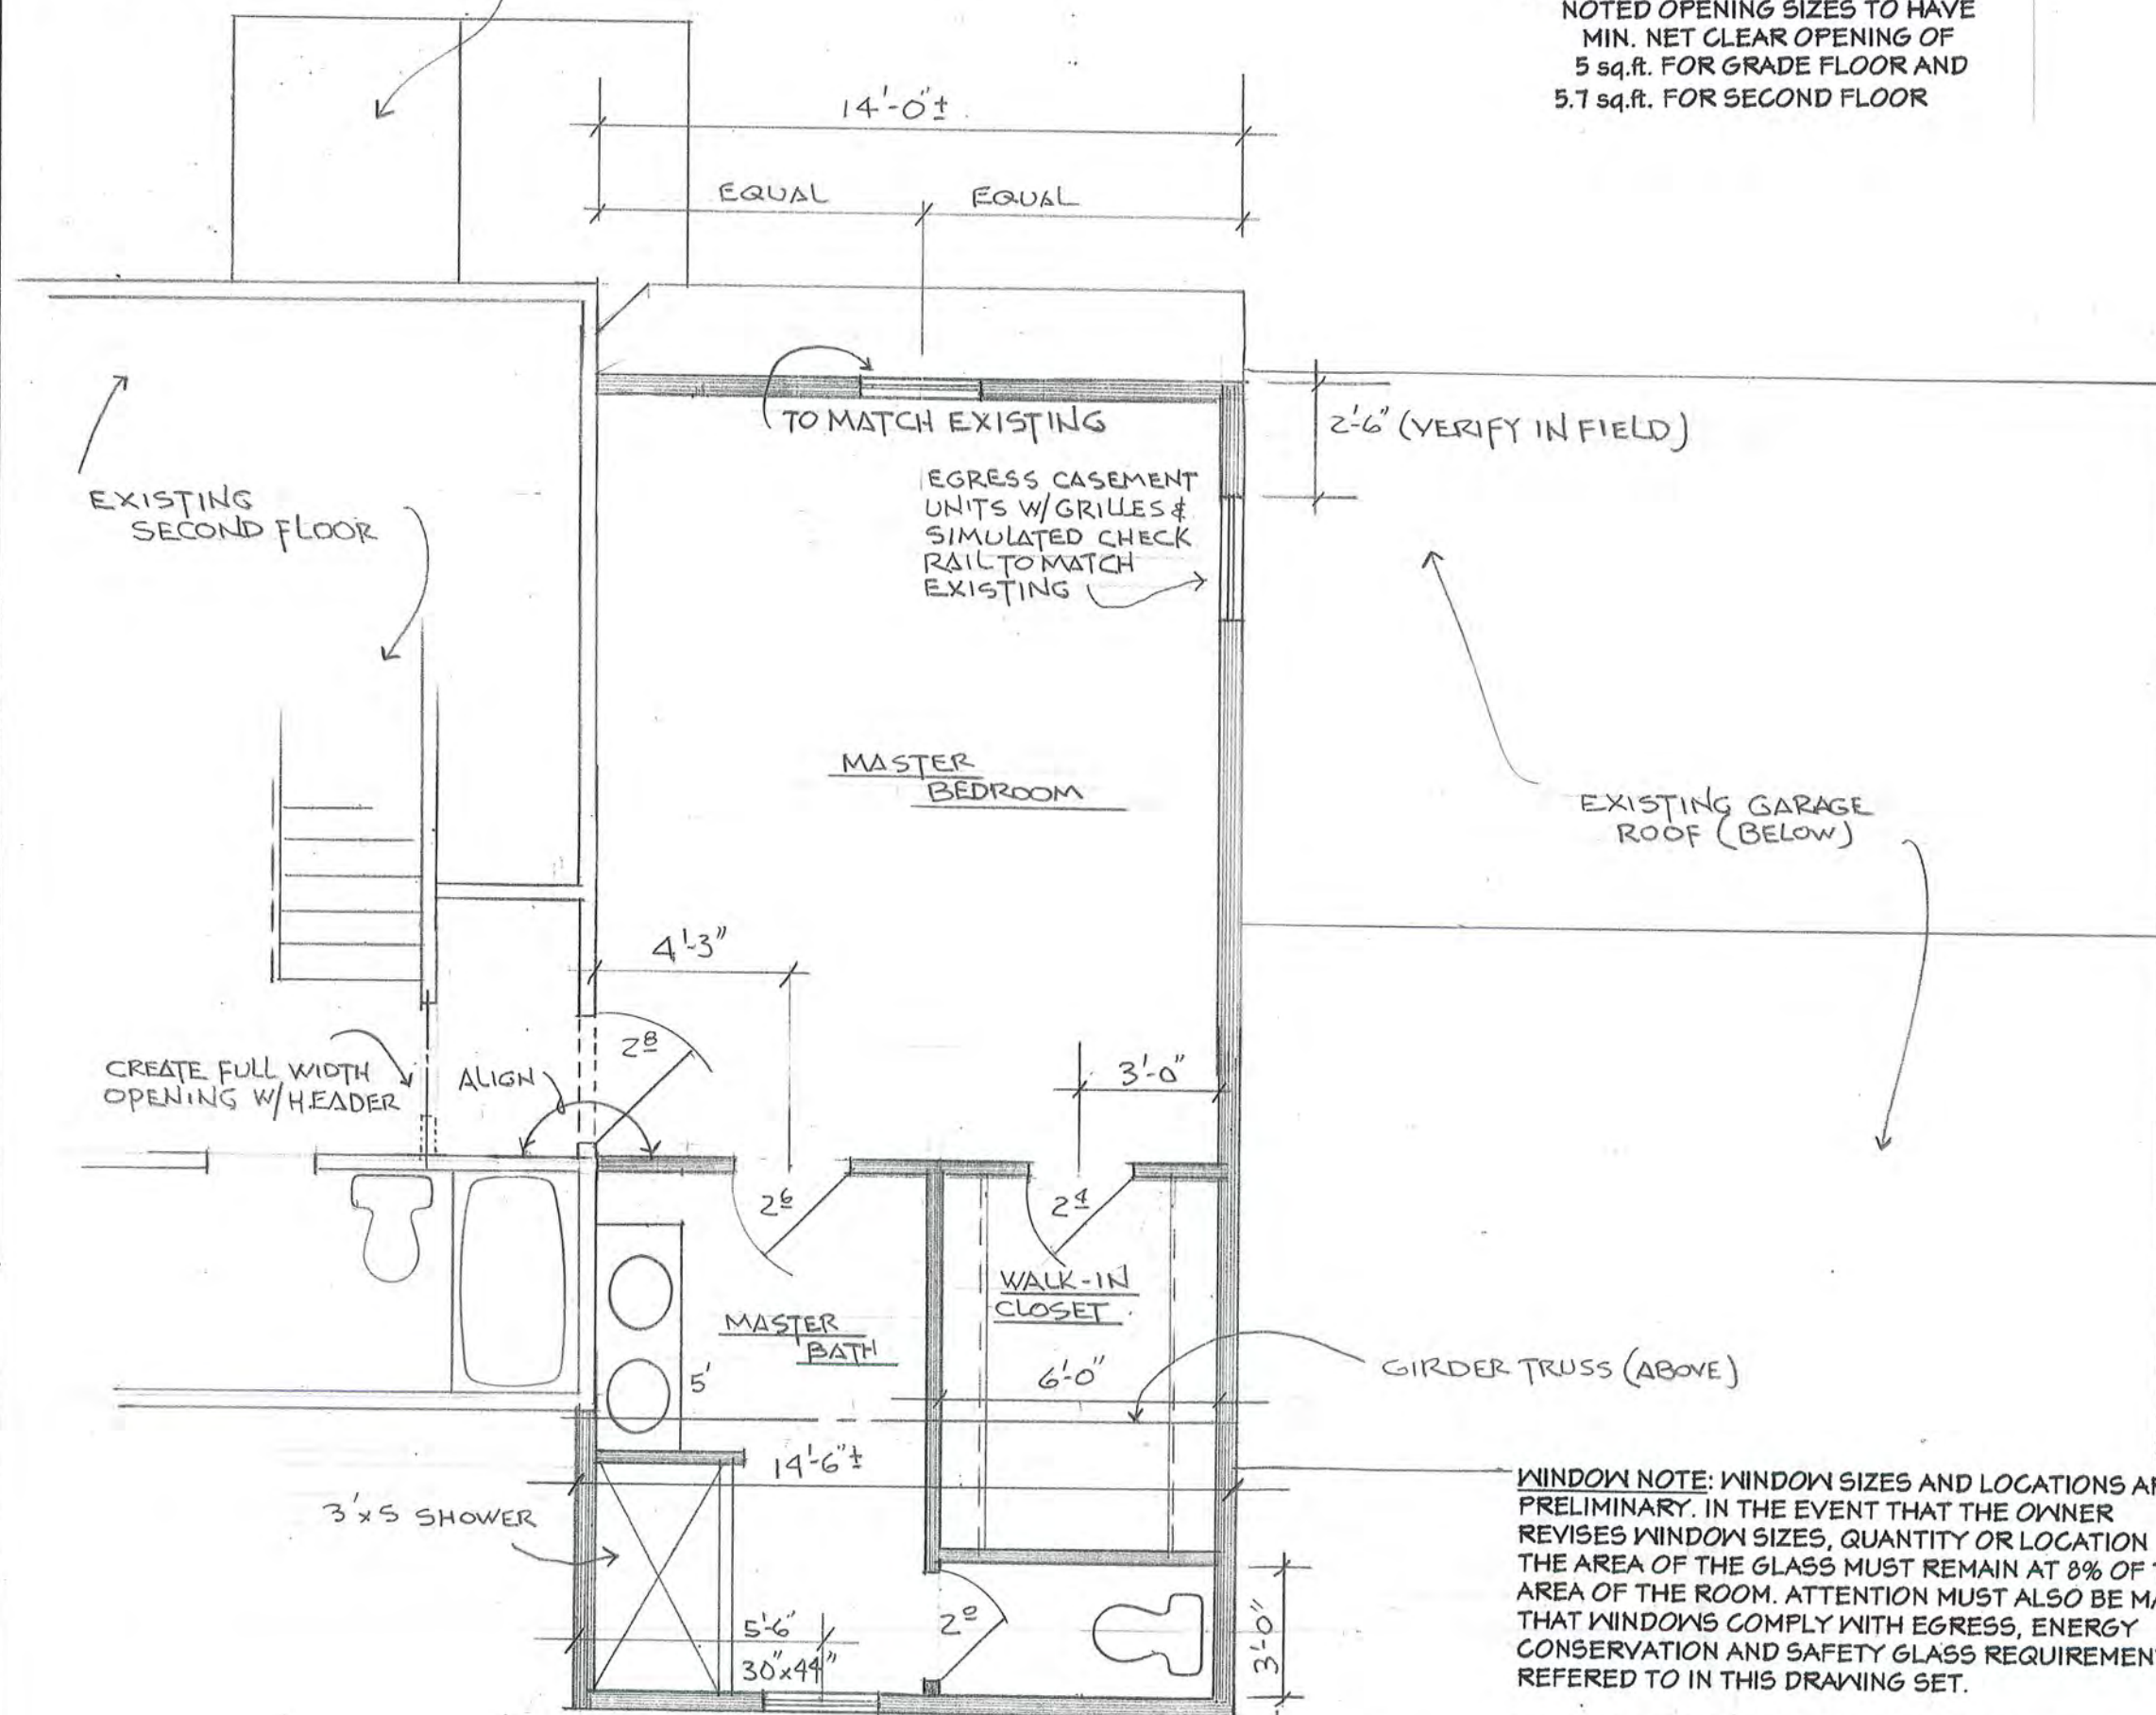

SECOND FLOOR PLAN

WINDOW NOTE: WINDOW SIZES AND LOCATIONS ARE PRELIMINARY. IN THE EVENT THAT THE OWNER REVISES WINDOW SIZES, QUANTITY OR LOCATION THE AREA OF THE GLASS MUST REMAIN AT 8% OF THE AREA OF THE ROOM. ATTENTION MUST ALSO BE MADE THAT WINDOWS COMPLY WITH EGRESS, ENERGY CONSERVATION AND SAFETY GLASS REQUIREMENTS REFERED TO IN THIS DRAWING SET.

CONTRACTOR/OWNER TO CONTACT ARCHITECT (585 247-6480) IF ANY CLARIFICATION IS NEEDED

EXISTING CONDITIONS
 THESE DRAWINGS HAVE BEEN DEVELOPED FROM OWNER INPUT AND READILY VISIBLE EXISTING CONDITIONS. EXISTING CONDITIONS THAT WERE NOT VERIFIED SUCH AS FOUNDATIONS, ROOF STRUCTURE, HEADERS, ETC. HAVE BEEN ASSUMED TO BE DESIGNED AND INSTALLED AS PER BUILDING CODES AT THE TIME OF INSTALLATION AND AS PER COMMON CONSTRUCTION PRACTICES.

VALUE ENGINEERING
 ARCHITECT WELCOMES INPUT FROM CONTRACTOR(S) ON OPPORTUNITIES FOR VALUE ENGINEERING (ANALYZING COST VS VALUE AND ALTERNATIVE MATERIALS / METHODS). ALL CONTRACTOR INPUT SHALL BE IN WRITING AND APPROVED BY ARCHITECT BEFORE REVISION MAY BE IMPLEMENTED

SMOKE DETECTORS
 SMOKE DETECTORS SHALL BE INSTALLED IN THE ADDITION AS WELL AS IN THE EXISTING STRUCTURE AS FOLLOWS: IN EACH BEDROOM, OUTSIDE THE BEDROOM AREA IN THE IMMEDIATE VICINITY OF THE BEDROOMS, IN THE BASEMENT AND ADDITIONAL AREAS AS REQUIRED SO EACH STORY SHALL HAVE AT LEAST ONE SMOKE DETECTOR. IF POSSIBLE THE DETECTORS SHOULD BE INTERCONNECTED IN SUCH A MANNER THAT THE ACTUATION OF ONE ALARM WILL ACTIVATE ALL OF THE ALARMS AND BE HARD WIRED WITH BATTERY BACK-UP. BATTERY OPERATED DETECTOR/ALARMS ARE PERMITTED IF WALLS AND CEILINGS OF THE EXISTING STRUCTURE REMAIN INTACT.

CARBON MONOXIDE ALARMS
 CARBON MONOXIDE ALARMS SHALL BE INSTALLED IN THE EXISTING STRUCTURE AS FOLLOWS: IN EVERY STORY (INCLUDING BASEMENT). IF POSSIBLE THE DETECTORS SHOULD BE INTERCONNECTED IN SUCH A MANNER THAT THE ACTUATION OF ONE ALARM WILL ACTIVATE ALL OF THE ALARMS AND BE HARD WIRED WITH BATTERY BACK-UP. BATTERY OPERATED DETECTOR/ALARMS ARE PERMITTED IF WALLS AND CEILINGS OF THE EXISTING STRUCTURE REMAIN INTACT. ALARMS SHALL NOT BE LOCATED IN OR NEAR LOCATIONS SPECIFIED IN THE MANUFACTURER'S INSTALLATION INSTRUCTIONS.

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DATE: 12-17-2020

SCALE: 1/4" = 1'-0"

1/20/2021 REVISIONS
 6/19/2022

PROJECT

Residential Addition/Renovation for:


71 Reitz Parkway
 Pittsford, New York 14534

DRAWING TITLE

FRONT ELEVATION


SHEET NUMBER

3 of 7

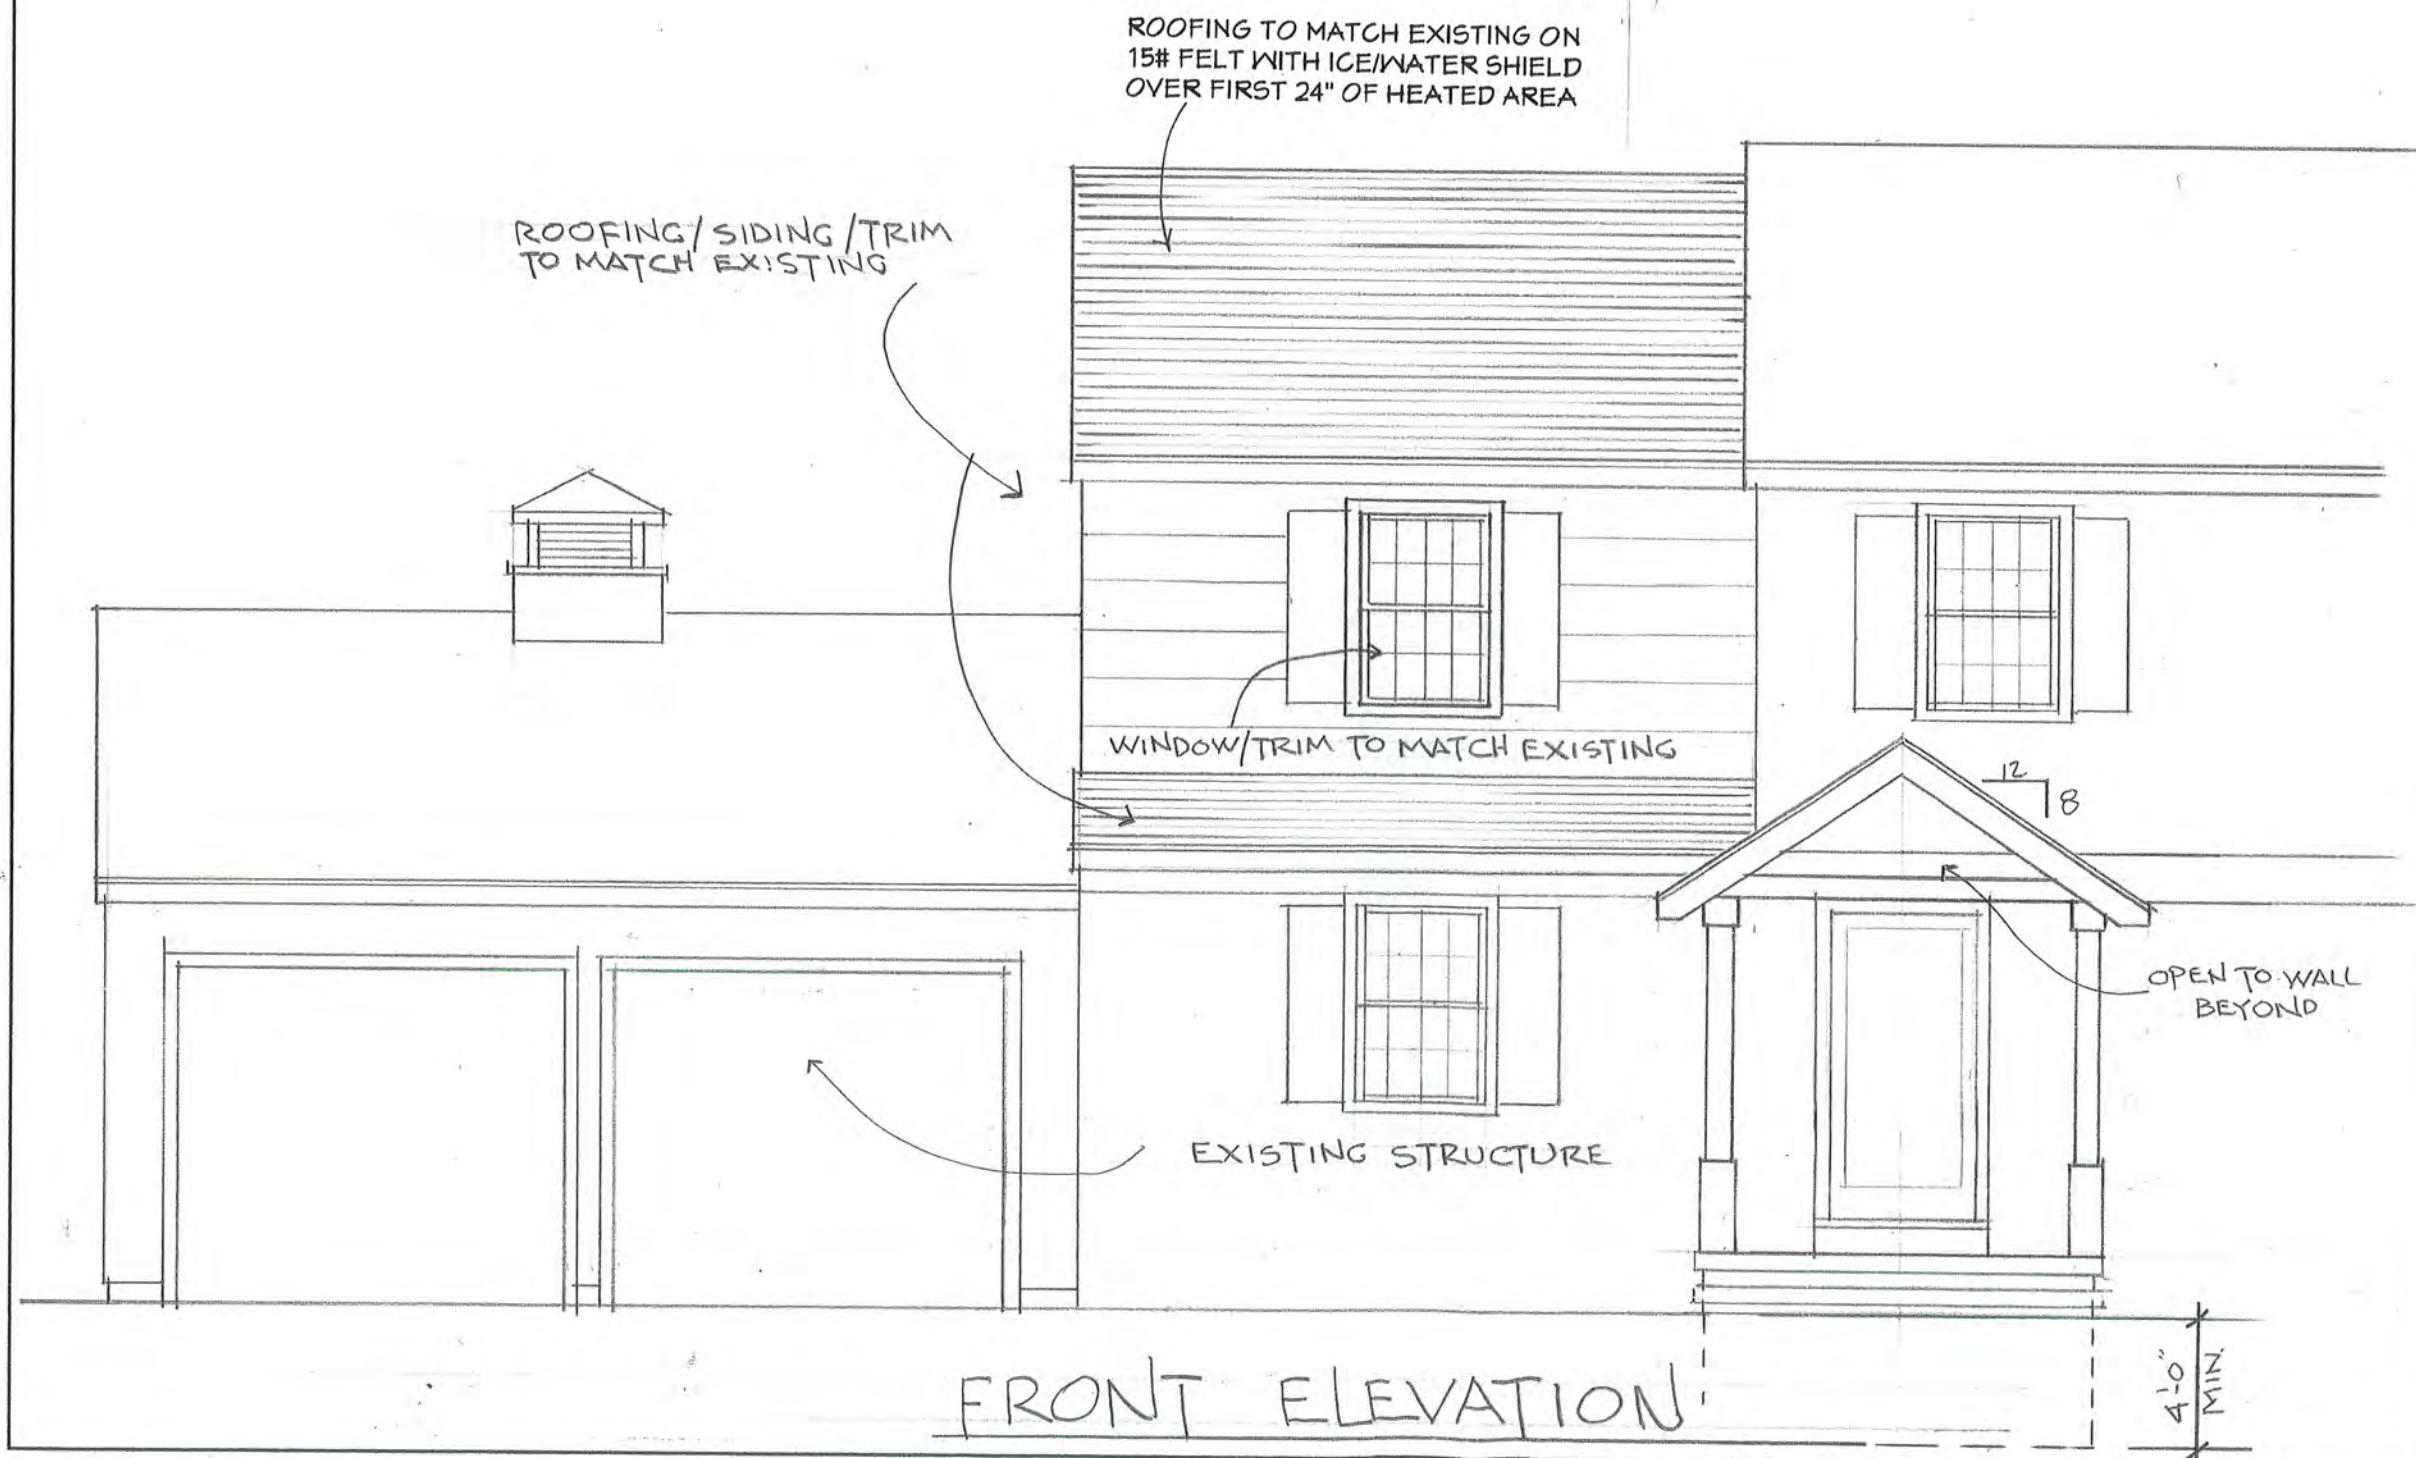

MISC. NOTES

- Owner to specify interiors as required (floor covering, wall covering, moldings, interior doors, etc.)
- All penetrations in the building envelope shall be sealed (caulked, weather-stripped, etc.)
- Seamless aluminum gutters and downspouts to be provided for positive drainage away from foundation
- Provide required flashing to meet or exceed acceptable common building practice where required and at roof changes, horizontal abutments, projections, valleys, openings... etc.
- All glass located within 18" of floor, 24" of door swing or located within 60" off floor at bathtubs, whirlpools, showers, saunas, steam rooms, or hot tubs shall be tempered
- All exposed insulation shall have a flame spread rating less than 25 and a smoke density rating less than 450
- Contractor to coordinate all closet shelving and cabinetry requirements

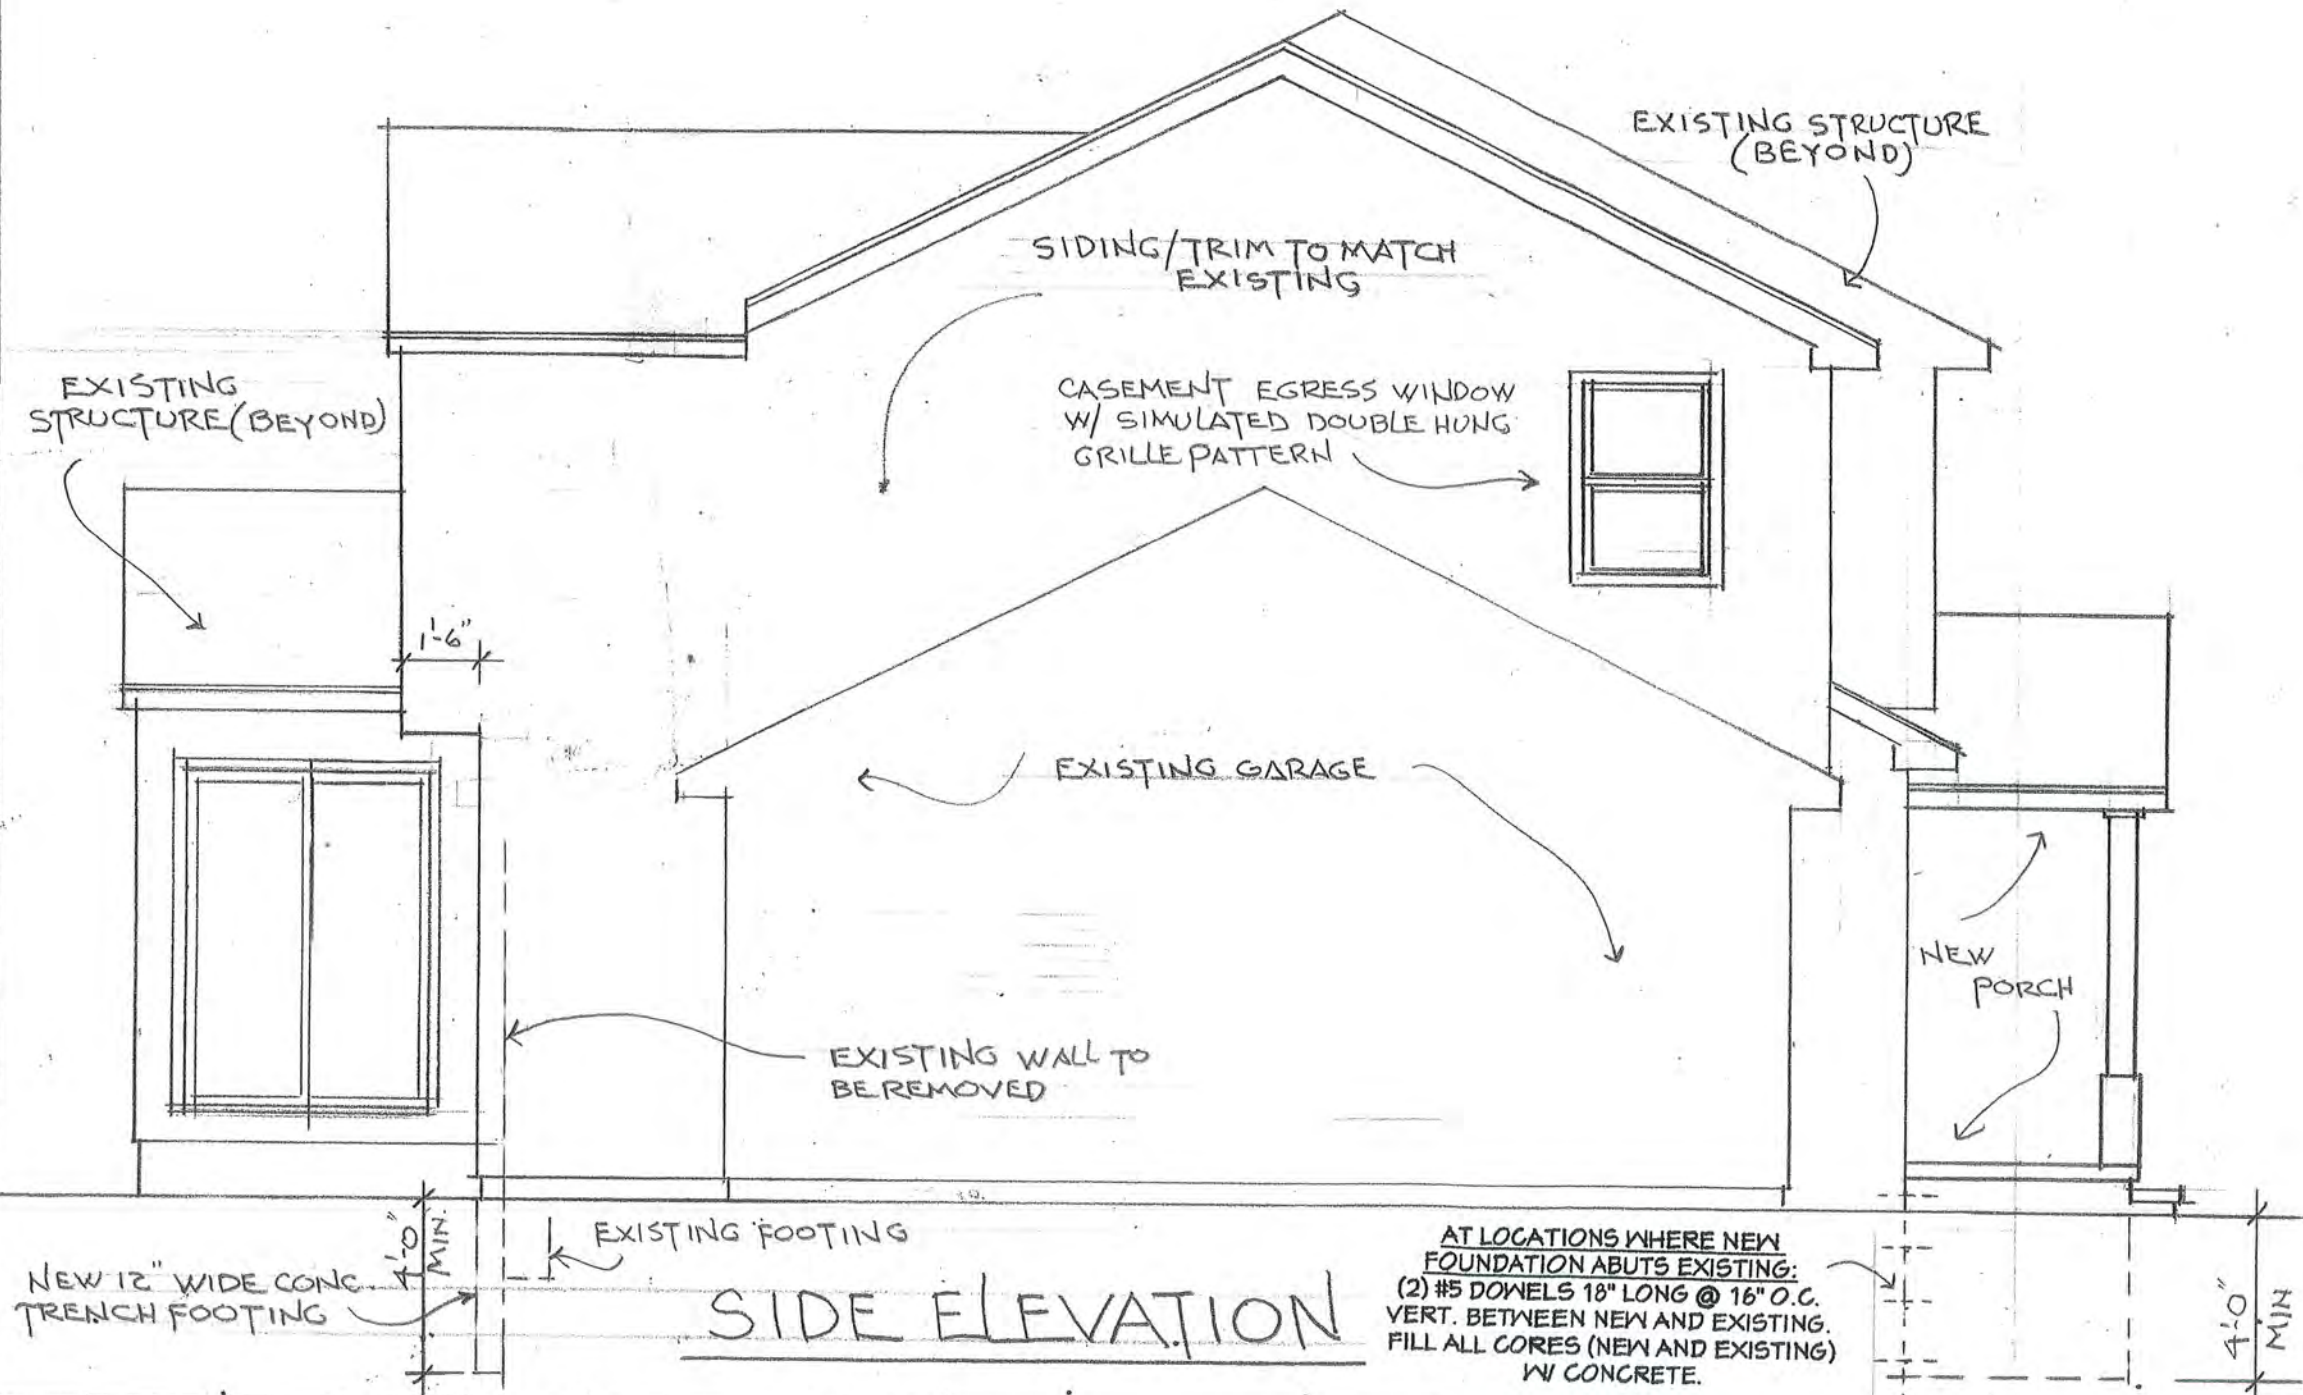

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REVISIONS
1/21/2021
6/10/2022

PROJECT
Residential Addition/Renovation for:

71 Reitz Parkway
Pittsford, New York 14534

DRAWING TITLE
SIDE ELEVATION
& NOTES

SHEET NUMBER
4 of 7

ENERGY EFFICIENCY

TABLE N1102.4.1.1 (R402.4.1.1)
AIR BARRIER AND INSULATION INSTALLATION*

COMPONENT	AIR BARRIER CRITERIA	INSULATION INSTALLATION CRITERIA
General requirements	A continuous air barrier shall be installed in the building envelope. The exterior thermal envelope contains a continuous air barrier. Breaks or joints in the air barrier shall be sealed.	Air-permeable insulation shall not be used as a sealing material.
Ceiling/attic	The air barrier in any dropped ceiling or soffit shall be aligned with the insulation and any gaps in the air barrier sealed. Access openings, drop down stairs or knee wall doors to unconditioned attic spaces shall be sealed.	The insulation in any dropped ceiling/soffit shall be aligned with the air barrier.
Walls	The junction of the foundation and sill plate shall be sealed. The junction of the top plate and the top of exterior walls shall be sealed. Knee walls shall be sealed.	Cavities within corners and headers of frame walls shall be insulated by completely filling the cavity with a material having a thermal resistance of not less than R-3 per inch. Exterior thermal envelope insulation for framed walls shall be installed in substantial contact and in continuous alignment with the air barrier.
Windows, skylights and doors	The space between framing and skylights, and the jamb of windows and doors, shall be sealed.	
Rim joists	Rim joists shall include the air barrier.	Rim joists shall be insulated.
Floors including cantilevered floors and floors above garages.	The air barrier shall be installed at any exposed edge of insulation.	Floor framing cavity insulation shall be installed to maintain permanent contact with the underside of subfloor decking. Alternatively, floor framing cavity insulation shall be in contact with the top side of sheathing or continuous insulation installed on the underside of floor framing; and extending from the bottom to the top of all perimeter floor framing members.
Crawl space walls	Exposed earth in unvented crawl spaces shall be covered with a Class I vapor retarder with overlapping joints taped.	Crawl space insulation, where provided instead of floor insulation, shall be permanently attached to the walls.
Shafts, penetrations	Duct shafts, utility penetrations, and flue shafts opening to exterior or unconditioned space shall be sealed.	
Narrow cavities		Batts to be installed in narrow cavities shall be cut to fit or narrow cavities shall be filled with insulation that on installation readily conforms to the available cavity space.
Garage separation	Air sealing shall be provided between the garage and conditioned spaces.	
Recessed lighting	Recessed light fixtures installed in the building thermal envelope shall be sealed to the finished surface.	Recessed light fixtures installed in the building thermal envelope shall be airtight and IC rated.
Plumbing and wiring		In exterior walls, batt insulation shall be cut neatly to fit around wiring and plumbing or insulation that on installation, readily conforms to available space, shall extend behind piping and wiring.
Shower/tub on exterior wall	The air barrier installed at exterior walls adjacent to showers and tubs shall separate the wall from the shower or tub.	Exterior walls adjacent to showers and tubs shall be insulated.
Electrical/phone box on exterior walls	The air barrier shall be installed behind electrical and communication boxes. Alternatively, air-sealed boxes shall be installed.	
HVAC register boots	HVAC supply and return register boots that penetrate building thermal envelope shall be sealed to the subfloor, wall covering or ceiling penetrated by the boot.	
Concealed sprinklers	Where required to be sealed, concealed fire sprinklers shall only be sealed in a manner that is recommended by the manufacturer. Caulking or other adhesive sealants shall not be used to fill voids between fire sprinkler cover plates and walls or ceilings.	

a. Inspection of log walls shall be in accordance with the provisions of ICC 400.

482

2020 RESIDENTIAL CODE OF NEW YORK STATE

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PROJECT

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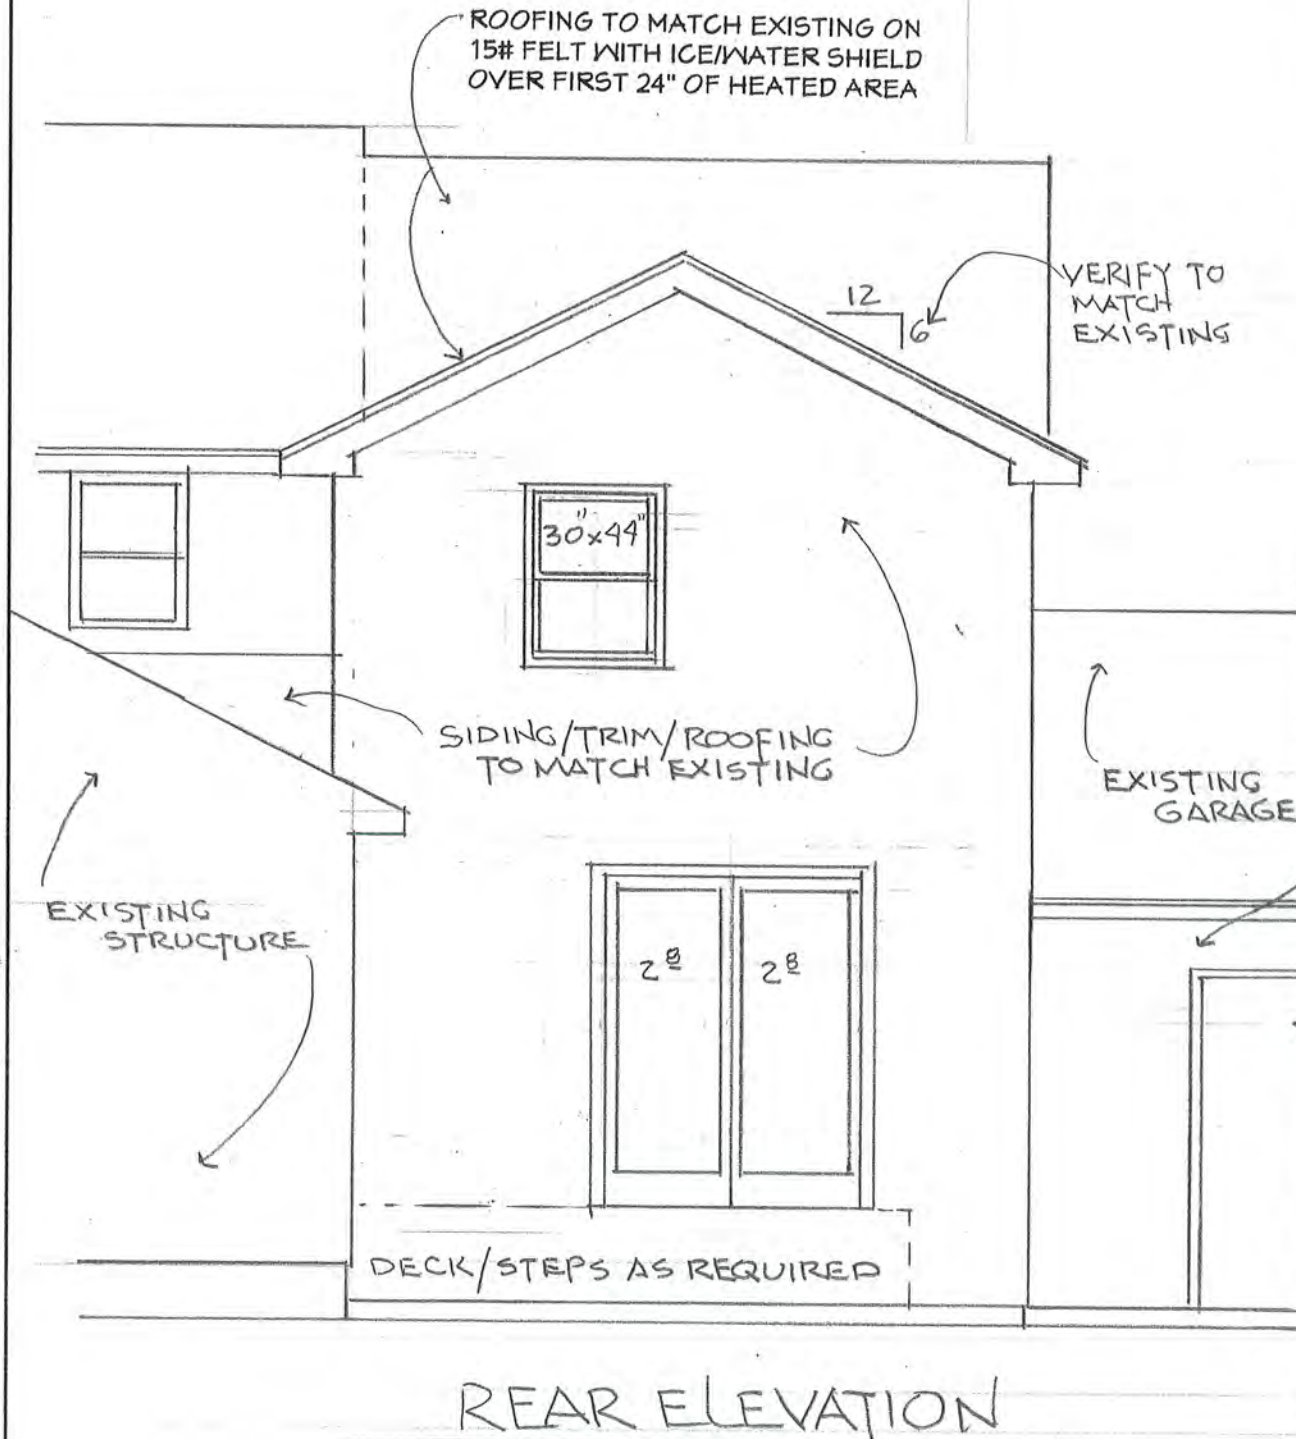
71 Reitz Parkway
Pittsford, New York 14534

DRAWING TITLE

REAR ELEVATION

SHEET NUMBER

5 of 7



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6/10/2022 REVISIONS

PROJECT

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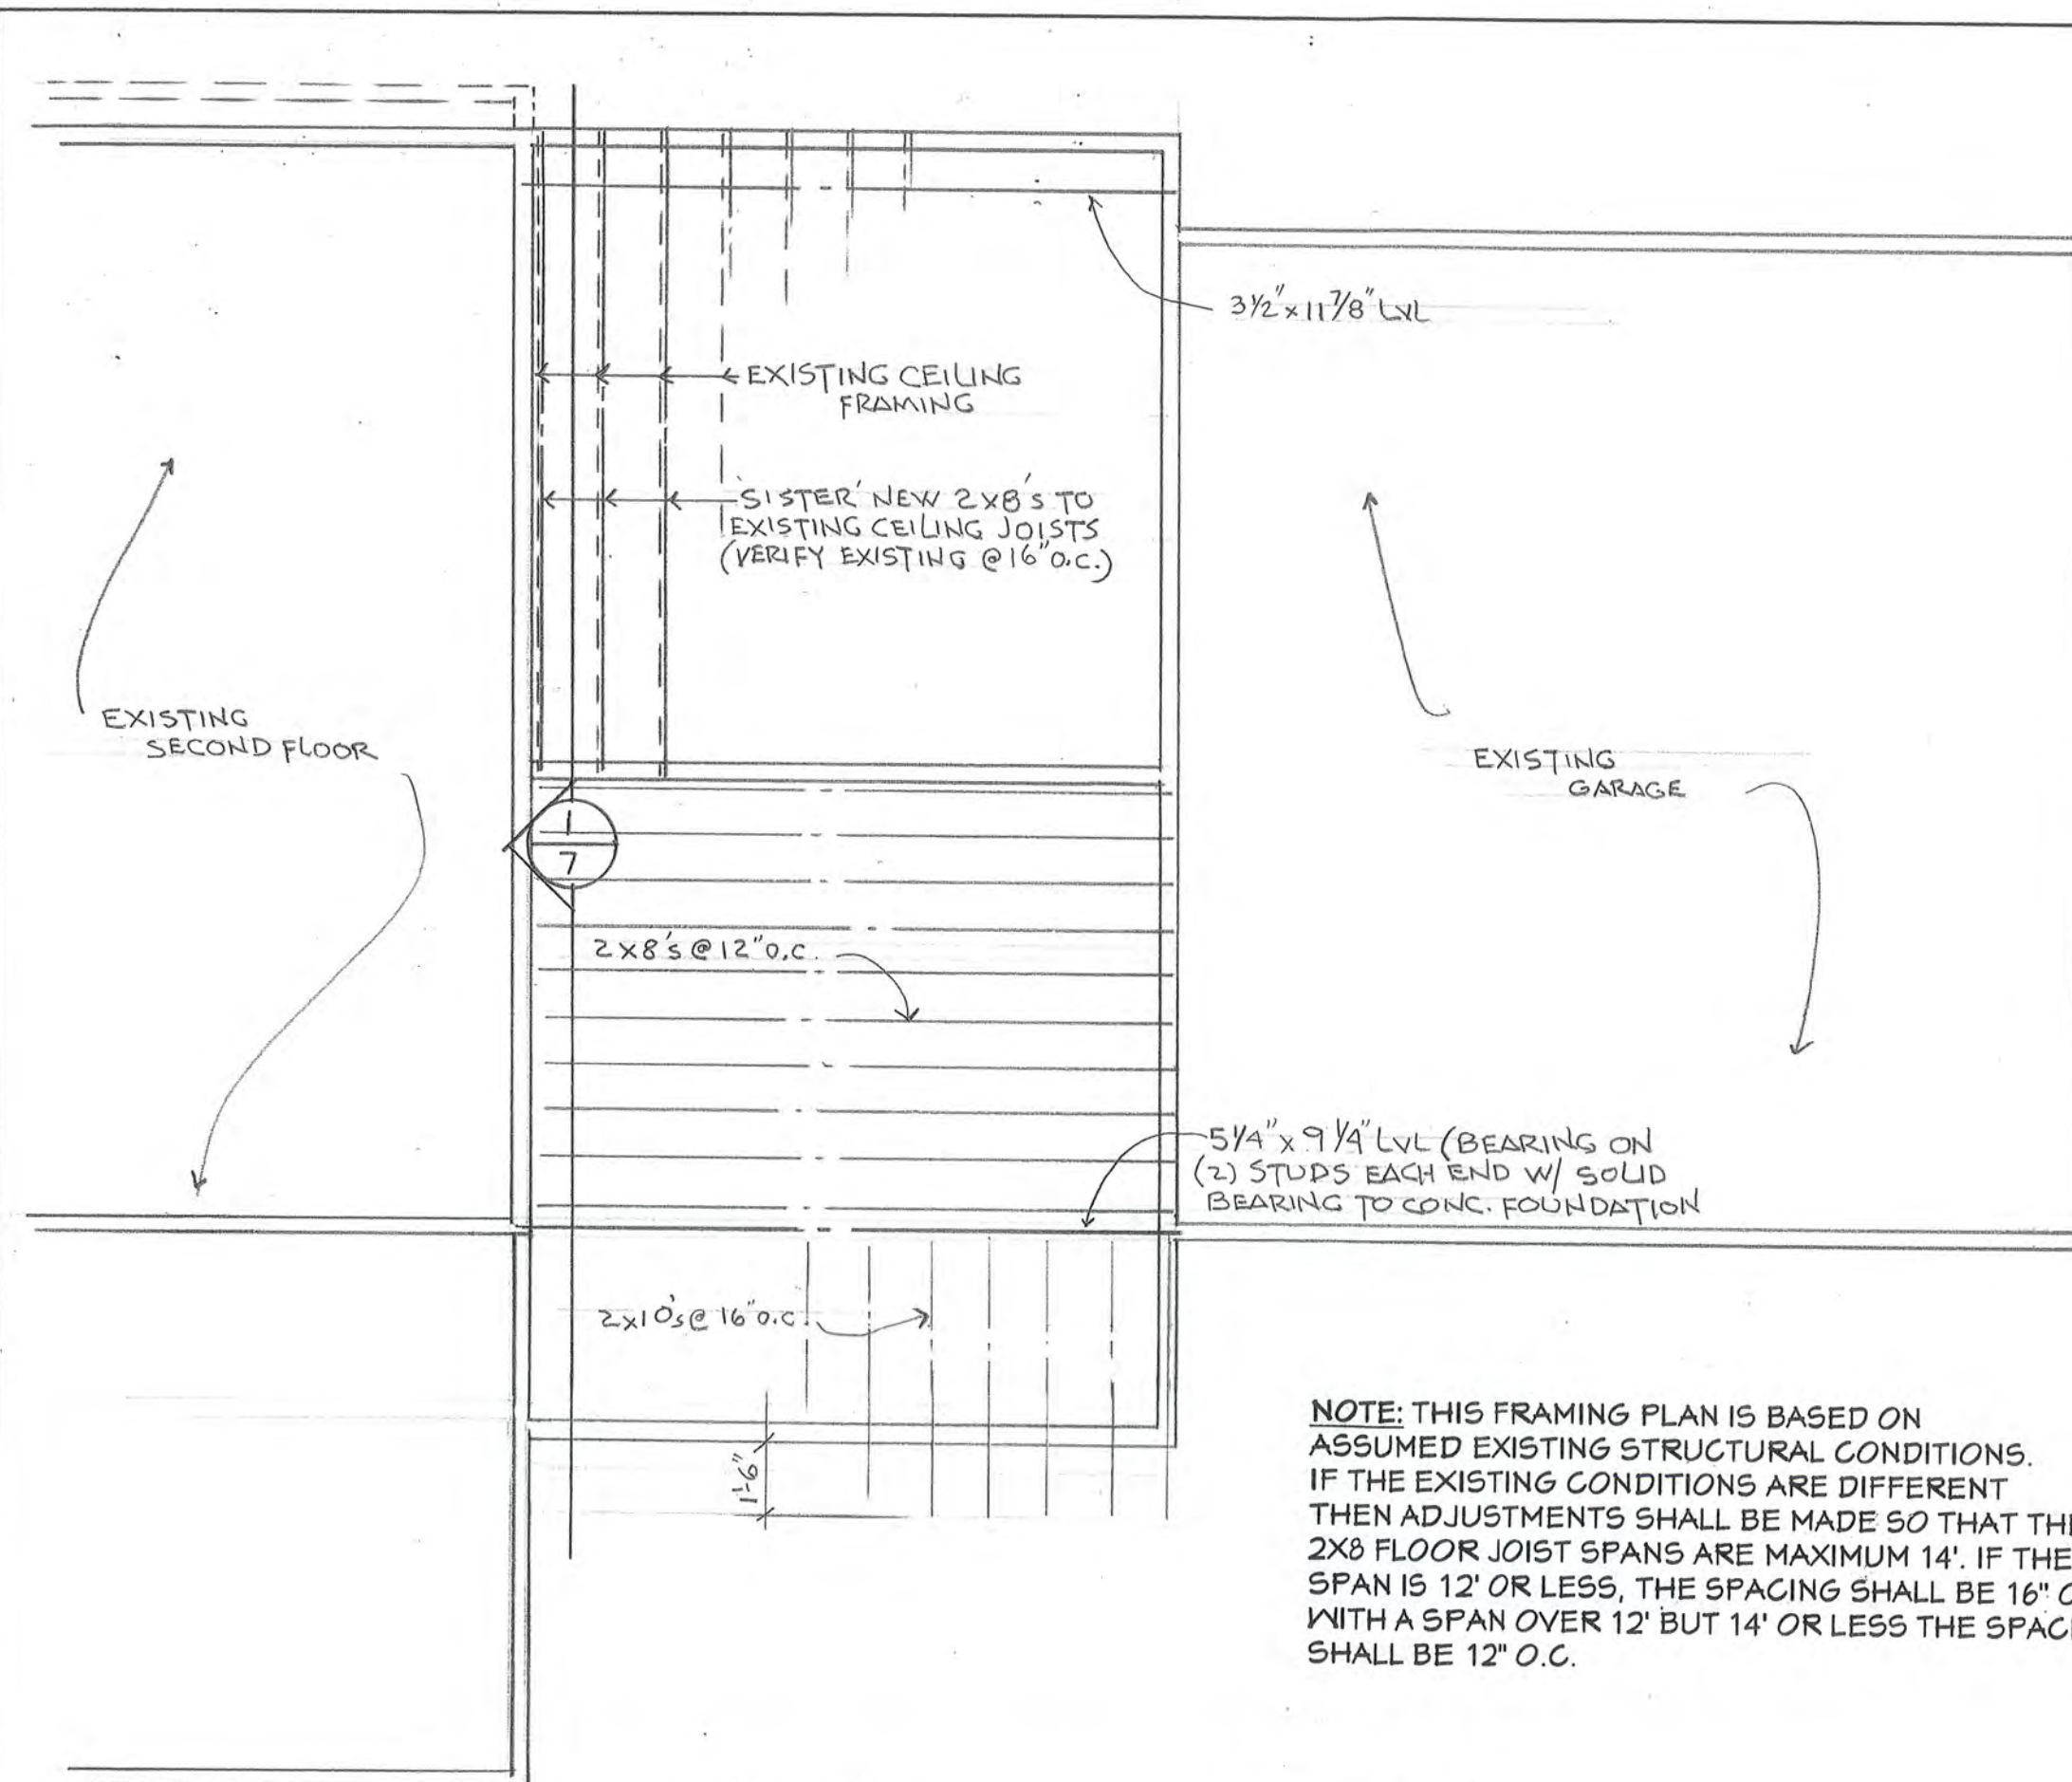
71 Reitz Parkway
Pittsford, New York 14534

DRAWING TITLE

SECOND FLOOR
FRAMING PLAN


SHEET NUMBER

6 of 7



NOTE: THIS FRAMING PLAN IS BASED ON ASSUMED EXISTING STRUCTURAL CONDITIONS. IF THE EXISTING CONDITIONS ARE DIFFERENT THEN ADJUSTMENTS SHALL BE MADE SO THAT THE 2X8 FLOOR JOIST SPANS ARE MAXIMUM 14'. IF THE SPAN IS 12' OR LESS, THE SPACING SHALL BE 16" O.C.. WITH A SPAN OVER 12' BUT 14' OR LESS THE SPACING SHALL BE 12" O.C.

SECOND FLOOR FRAMING PLAN

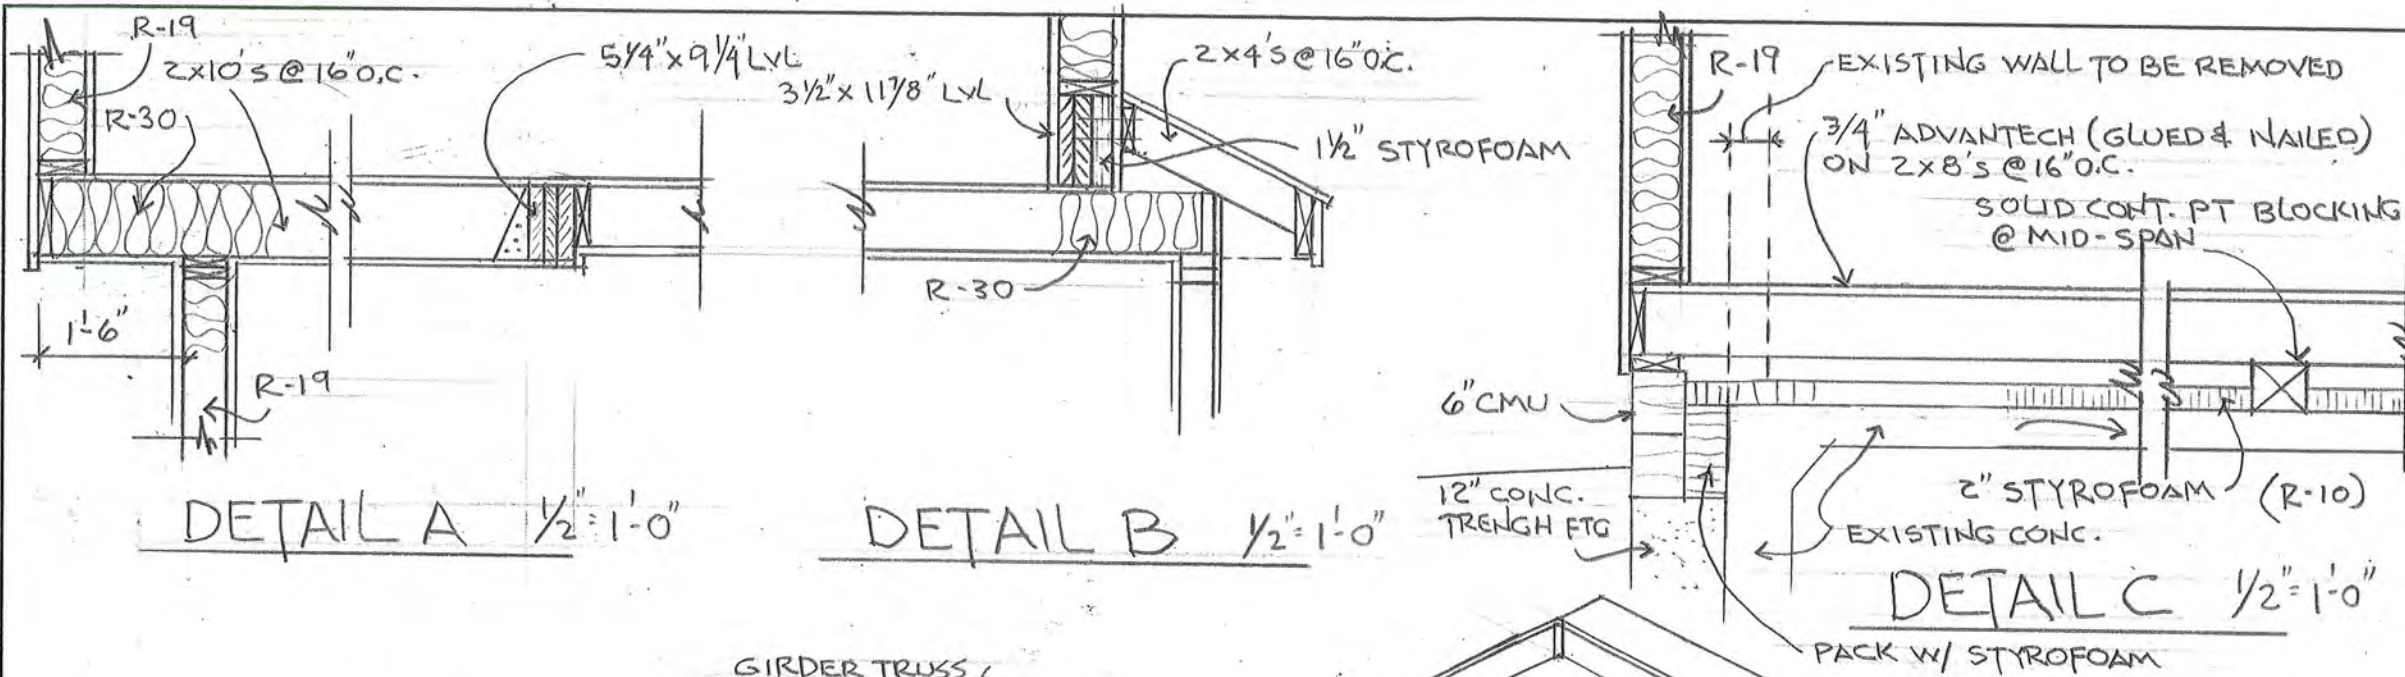


DETAIL A 1/2"=1'-0"

DETAIL B 1/2"=1'-0"

DETAIL C 1/2"=1'-0"

ROOF TRUSSES AT 24" o.c. DESIGNED BY TRUSS MANUFACTURER FOR GROUND SNOW LOAD OF 40 LBS. PER SQ.FT.

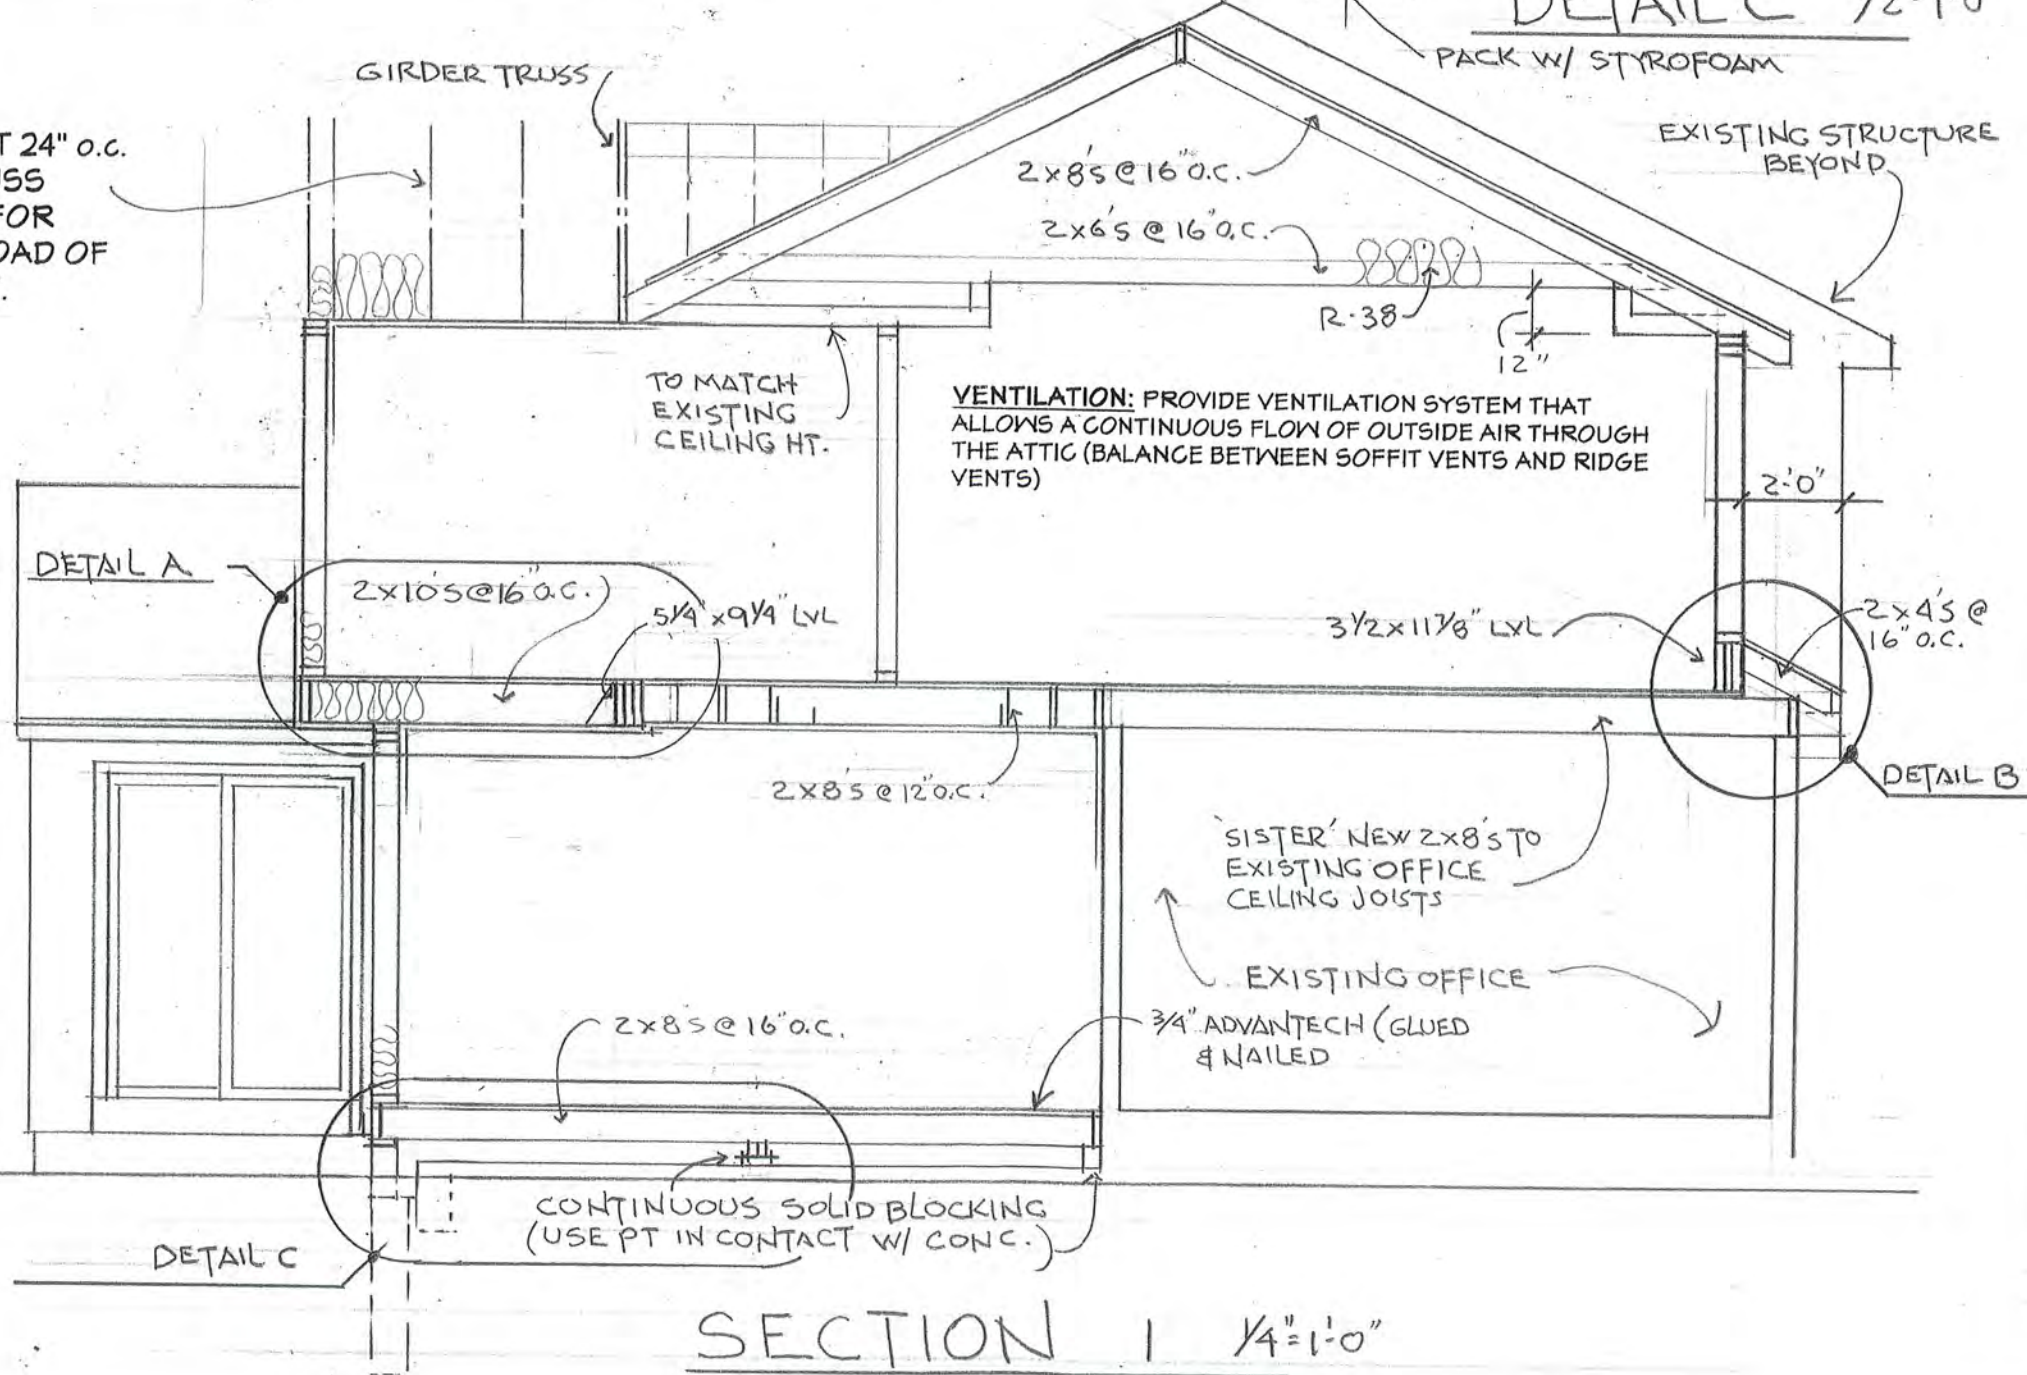

SECTION 1 1/4"=1'-0"

THOMAS R. DOUGHTY ARCHITECT, P.C.

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SCALE:

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PROJECT

Residential Addition/Renovation for:


71 Reitz Parkway
Pittsford, New York 14534

DRAWING TITLE

SECTIONS

SHEET NUMBER

7 of 7

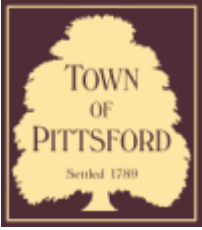

Town of Pittsford

Department of Public Works
11 South Main Street
Pittsford, New York 14534

Permit #
B22-000103

Phone: 585-248-6250
FAX: 585-248-6262

DESIGN REVIEW AND HISTORIC PRESERVATION BOARD REFERRAL OF APPLICATION

Property Address: 17 Northfield Gate PITTSFORD, NY 14534

Tax ID Number: 178.05-1-34

Zoning District: RN Residential Neighborhood

Owner: Barker, William H

Applicant: Barker, William H

Application Type:


- | | |
|---|---|
| <input checked="" type="checkbox"/> Residential Design Review
§185-205 (B) | <input type="checkbox"/> Build to Line Adjustment
§185-17 (B) (2) |
| <input type="checkbox"/> Commercial Design Review
§185-205 (B) | <input type="checkbox"/> Building Height Above 30 Feet
§185-17 (M) |
| <input type="checkbox"/> Signage
§185-205 (C) | <input type="checkbox"/> Corner Lot Orientation
§185-17 (K) (3) |
| <input type="checkbox"/> Certificate of Appropriateness
§185-197 | <input type="checkbox"/> Flag Lot Building Line Location
§185-17 (L) (1) (c) |
| <input type="checkbox"/> Landmark Designation
§185-195 (2) | <input type="checkbox"/> Undeveloped Flag Lot Requirements
§185-17 (L) (2) |
| <input type="checkbox"/> Informal Review | |

Project Description: The applicant is requesting design review for an addition of a 150 sf addition off the southwest corner of the existing house.


Meeting Date: July 14, 2022



RN Residential Neighborhood Zoning

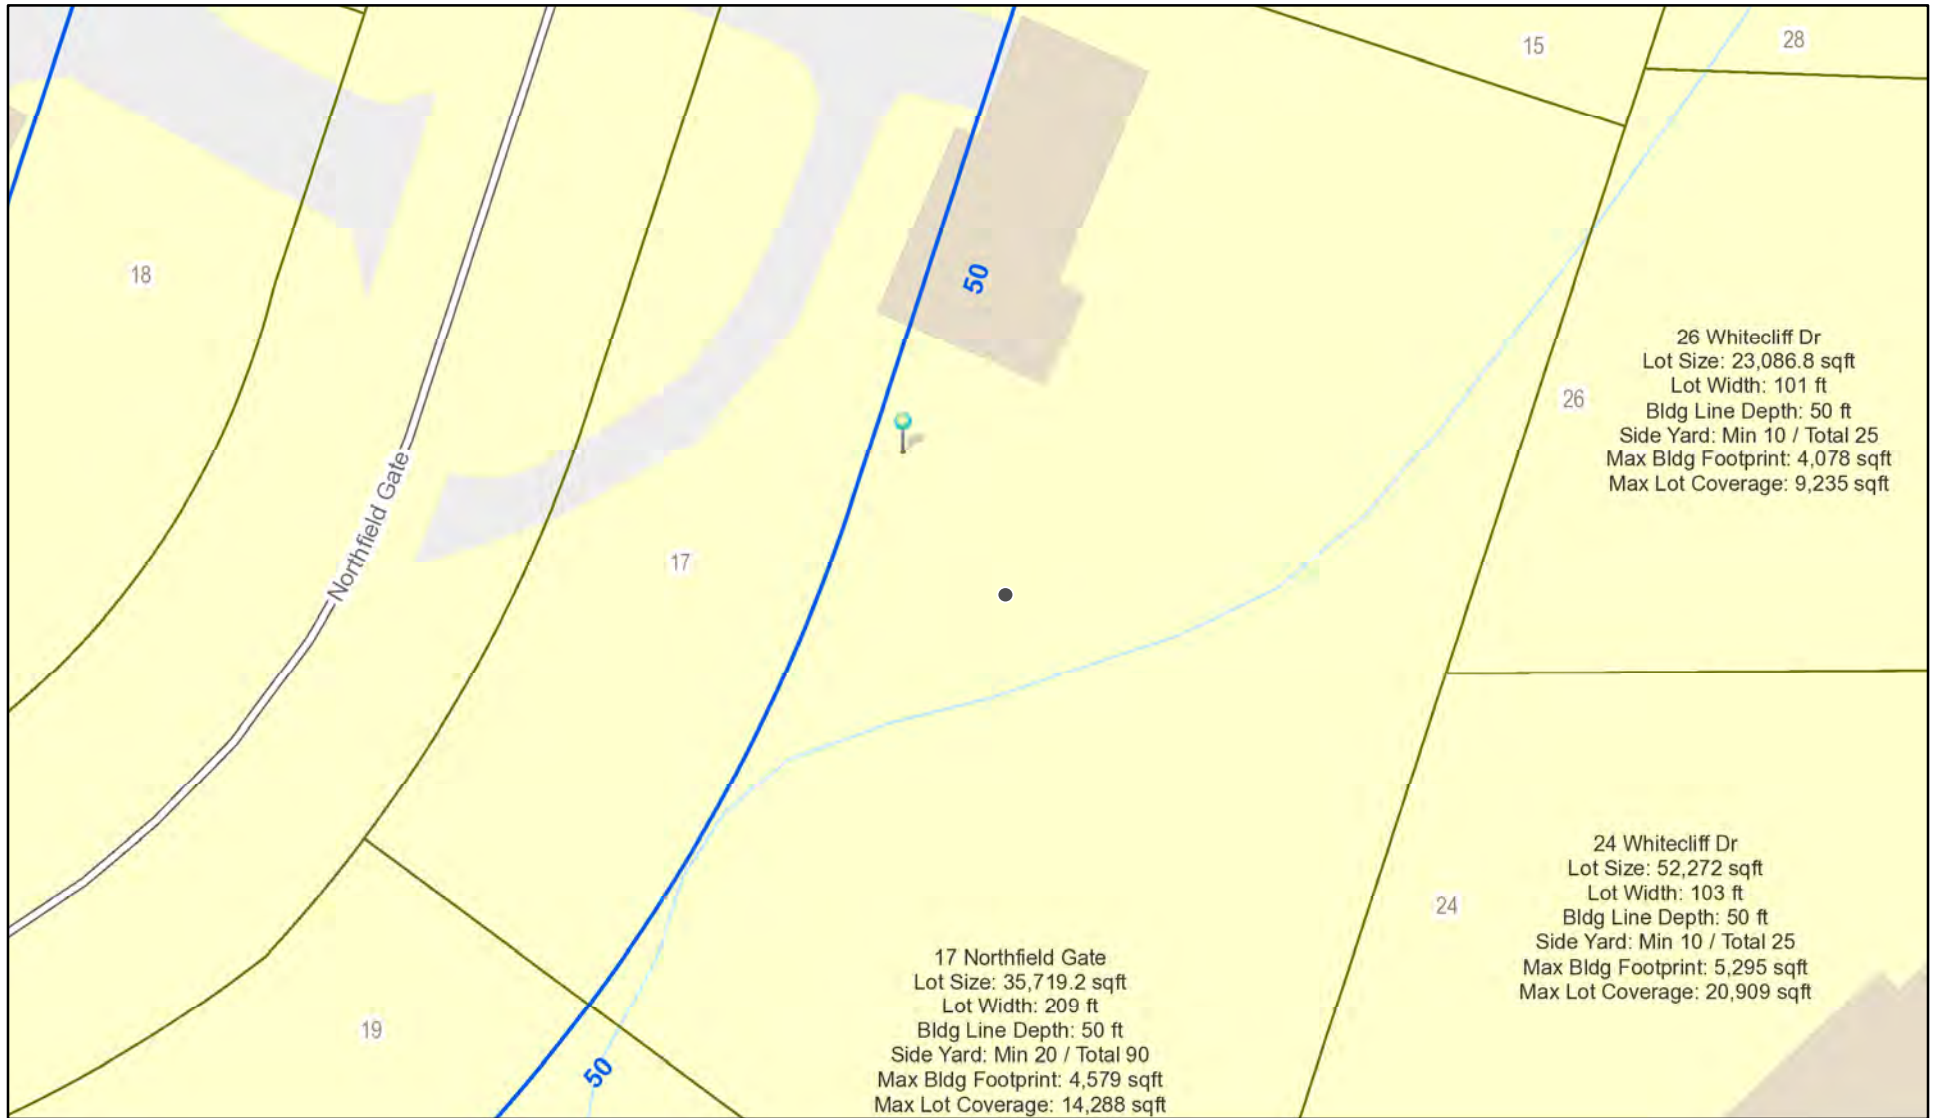

Printed June 28, 2022

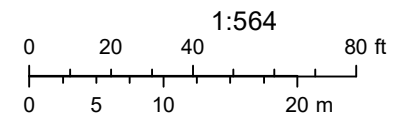

Town of Pittsford GIS

The information depicted on this map is representational and should be used for general reference purposes only. No warranties, expressed or implied, are provided for the data or its use or interpretation.



Northfield Gate

04/03/2021

© All Pictometry



FITCH

CONSTRUCTION, INC.

Fresh Ideas for the Good Life

Fitch Construction, Inc.

7278 Rt. 31 Fairport, New York 14450

Office (585) 377-3330 Fax: (585) 377-6319

E-Mail Dan @Fitchconstruction.com

Project Name: Bauch-Barker Sunroom Addition.

Home phone: (585) 267-7356

Cell phone: (716) 940-8757

E-Mail address: Dorothy.bauch@gmail.com

Agreement

Dorothy and Will Bauch-Barker

17 Northfield Gate

Pittsford, New York

14534

PROPOSAL INFORMATION

Issue Date: 4/11/22

Status:

Proposal

Build a Sunroom Addition

Overview:

Build a 15' x 10' (150SF) addition off southwest corner of existing house. Fitch Construction will provide all materials and labor, following specifications and design in construction drawings provided by homeowner. All specifications are described in the stamped drawings by Carini Engineering Designs. Building and Electrical permits through the Town of Pittsford will be obtained by Fitch Construction. A Fitch Construction representative will schedule and be present at all rough and final inspections, as necessary. Any specifications not expressed, selected and/or finalized in job drawings are listed below.

Scope of Work:

1. Specifications:

a. Excavation/Foundation: Any excess soil from foundation trenching not used in backfilling, to be left on site. Homeowner may have some low spots on property where excess soils can be piled. Removal/hauling of excess soils off property, will be charged as an additional expense. Moving geo-thermal pipes or running geo-thermal pipes through a sleeve at time of trenching for foundation will be assessed when/if these pipes are exposed. Costs for moving or altering geo-thermal lines are NOT factored into the proposal.

b. HVAC: Supply and Install "Ditra-Heat" electric radiant floor heating system. Includes: membrane sheet/roll, wiring cable, thermostat and panel connection.

c. Doors: Supply and install one (1) entry door from main house living area into new addition. Includes all demolition of interior and exterior wall coverings, relocation of electrical wiring/receptacles, rough framing of opening, finish trim on both sides, door hardware (for barn-style door) and 3-0 x 6-8 door. Final door style TBD. Door, door opening and threshold to meet ADA standards. Final door selection could change price +or-.

d. Windows: Supply and install seven (7) Andersen 100 series horizontal gliding windows in new openings. Unit size 4-0 width x 5-0 height. Dark Bronze exterior; white interior. Low-E Sun Smart insulated glass. One sash active/one sash fixed (final slide pattern TBD); full fiberglass screen; white locking hardware.

e. Electric: All electric to Code; includes four (4) receptacles, ceiling fan/light unit with dimmer switch sets, smoke and CO detector(s)

Scope of Work (Cont'd)

f. Skylights: (listed as optional on drawings) Supply and Install two (2) Velux MO8 FS (deck mount, fixed) skylights.


g. Flooring: Supply and install 150SF of ceramic tile, grout and sealer. Tile budgeted at \$6/Sf. Tile cost subject to change +or- depending on final selection.

h. Building & Electrical Permit: We have included _1_ Building permit for the Town and _1_ Electrical permit. Both permits include necessary rough and final inspections, as well as a Final Certificate of Occupancy which will be delivered to you by the Town.


i. Trim Interior: Supply and install window/door casing and baseboard molding to closely match existing house trim package (as close as possible).

j. Painting/Staining: Supply and apply paint/stain: Includes interior and exterior paint prep, exterior siding/trim paint/stain; interior ceiling/wall paint, interior trim/door paint. Interior paint colors TBD; Exterior paint/stain colors to match existing.

k. Cleanup/hauling: Includes all cleanup, waste removal and hauling of construction debris. Includes on-site dumpster

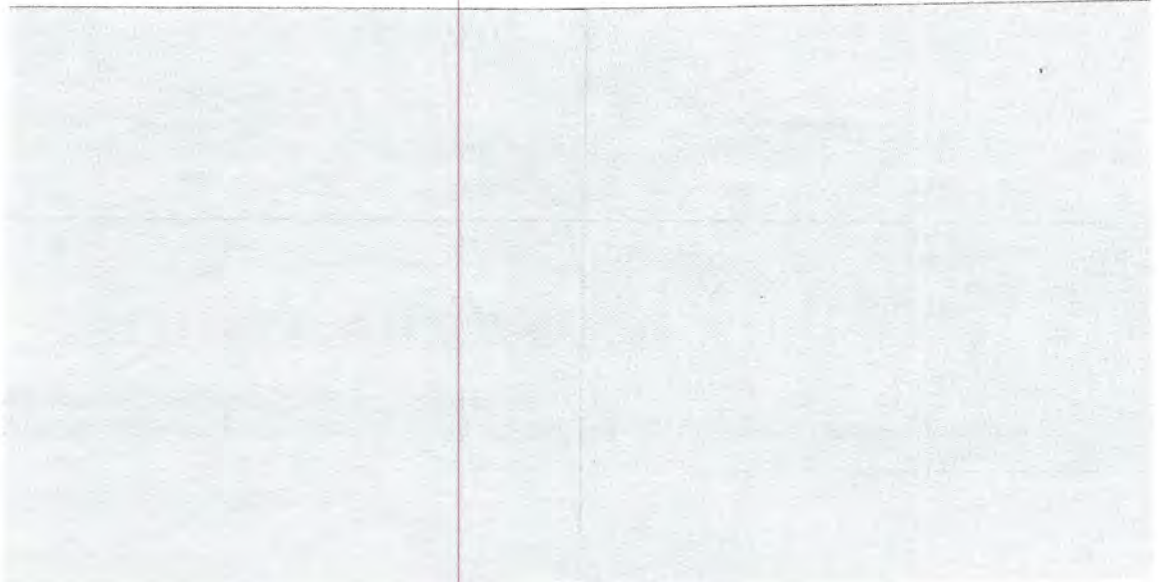

1. Upgrade skylights to
2. Upgrade skylights to

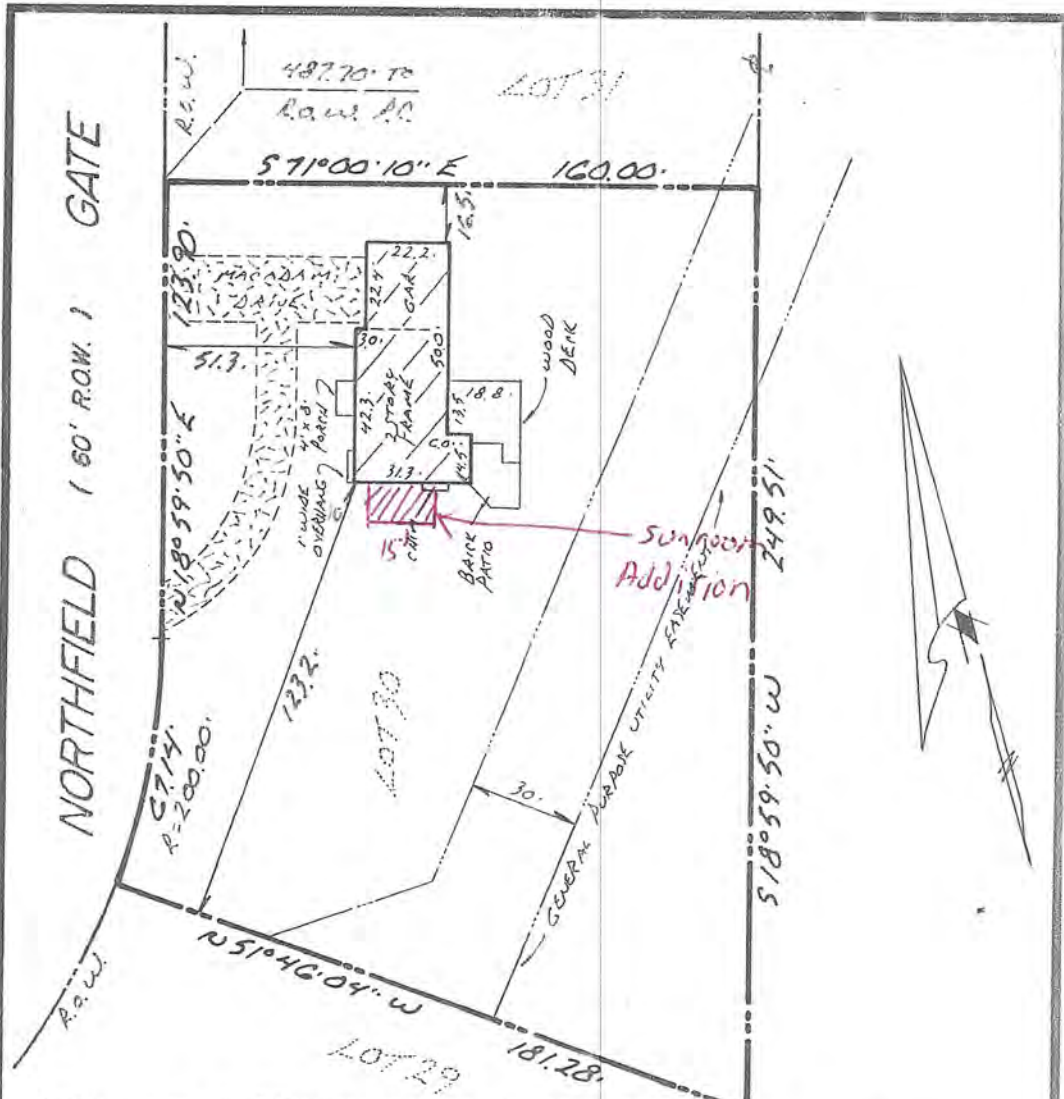

- REFERENCES:
- 1) ABSTRACT OF TITLE NOT PROVIDED
 - 2) LIBER 190 OF MAPS PAGE 79 - NORTHFIELD HILLS SUBD. SECTION 2
 - 3) LIBER 8802 OF RECORDS PAGE 134

CERTIFICATION:

I hereby certify to: **CNB MORTGAGE COMPANY, ITS SUCCESSORS AND/OR ASSIGNS**
WILLIAM H. BARKER & DOROTHY G. BAUCH
GALLO & IACOVANGELO, LLP
 THE TITLE INSURANCE COMPANY INSURING THE MORTGAGE

that this map was made June 6, 2008 from notes of an Instrument Survey completed June 3, 2008 and from references listed hereon.

James M. Leoni
JAMES M. LEONI, N.Y.S.L.S. # 49225

NOTE: Property corners should only be set by a licensed, registered land surveyor. Snow-cover has impeded ability to locate ground features.



TITLE: **INSTRUMENT SURVEY MAP**
#17 NORTHFIELD GATE
Lot 30 - NORTHFIELD HILLS SUBDIVISION, SECTION 2
TOWN OF PITTSFORD, MONROE COUNTY, NEW YORK

Tax Account No.
17R050-01-034

JB
BILESCHI LAND SURVEYING
 435 REYNOLDS ARCADE
 ROCHESTER, NEW YORK 14614
 (585) 454-6010 (phone)
 (585) 454-6015 (fax)
JAMES M. LEONI, L.S. OF CONSULT


DATE: June 6, 2008
 FILE No.
 OWNER: R. Leoni
 SCALE: 1 inch = 50 feet

"Unauthorized alteration or addition to a survey map bearing a licensed land surveyors seal is a violation of section 7209 Subdivision 2, of the New York State Education Law."
 "Only copies from the original of this survey marked with an original land surveyors seal shall be considered to be valid true copies." Certifications shall run only for the person for whom the survey is prepared, and on behalf of the title company insuring the fee, the governmental agency and lending institution listed hereon, and to the assignees of the lending institution. Certifications are not transferable to additional institutions or subsequent owners." This map is subject to any encumbrances and/or circumstances that an abstract of title may show. The word "certify" or "certification" as shown and used hereon means an expression of professional opinion regarding the facts of the survey and does not constitute a warranty or guarantee expressed or implied. Location of subterranean improvements and those which are covered may be approximate or not shown hereon. Leveling features are not shown hereon, unless otherwise specified.




FRONT ELEVATION

SCALE: 1/4" = 1'-0"
ADDITION AREA = 30 SQ. FEET

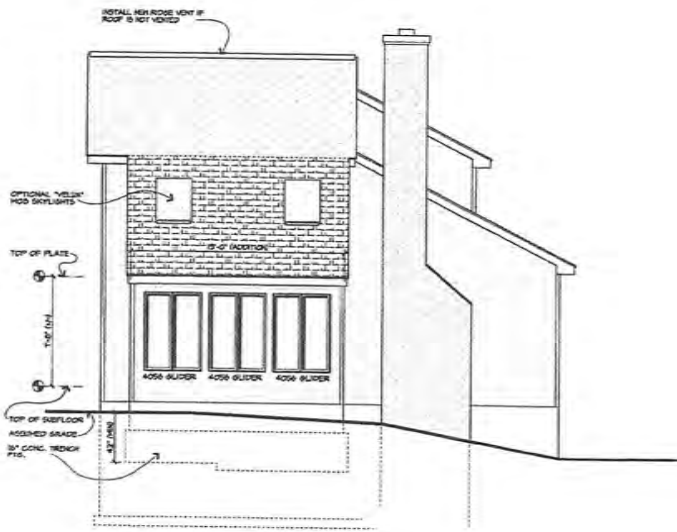


RIGHT SIDE ELEVATION

SCALE: 1/4" = 1'-0"

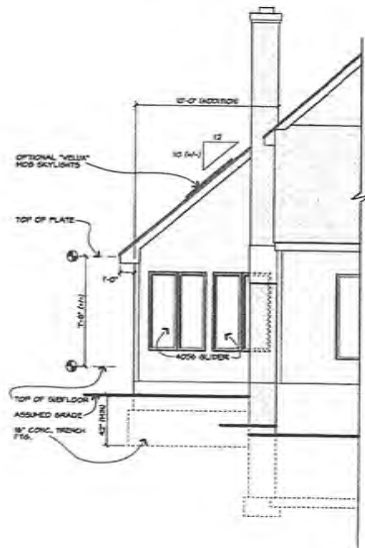

PARTIAL REAR ELEVATION

SCALE: 1/4" = 1'-0"

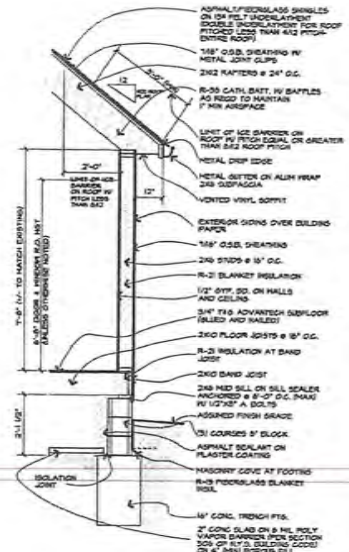

TYPICAL WALL SECTION

SCALE: 1/2" = 1'-0"


UNLESS OTHERWISE NOTED	
ROOFING: ASPHALT / FIBERGLASS SHINGLES AS SELT	
ROOF VENTING: ONE ROSE VENT PER 300 SQ. FT. AT THE SPACE (PER SECTION 5.3. ROSES OF THE CODE)	
FACIA: FREEBOARDS, CONDENSED GASKETS, SIDING, GABLE CHANGES, RAISE CHANGES, FOOTING DEPTH, PLATE HEIGHT, FIRST FLOOR, SECOND FLOOR,	MATCH EXISTING
FINISH FLOOR HEIGHT: FIRST FLOOR,	5'-4" BELOW GRADE
FINISH FLOOR:	1'-0" (A-1)
FINISH FLOOR:	R.A.
FINISH FLOOR:	6'-0"
FINISH FLOOR:	"ANDERSON" 100 SLIDER WINDOW WITH W. LOCK C

CARINI ENGINEERING DESIGNS, P.C.
STEVEN L. CARINI, P.E.
1337 FAIRBORN ROAD
PITTSFORD, NY 14110-1005
PH: (516) 432-5435
www.carinieng.com

Also doing business as
DWELL
10101 ROUTE 104
SUITE 100
61 NORTH MAIN STREET
CAMARON, NY 14824
PH: 716-353-1887

All of the plan indicates understanding and agreement with the following:
Carini Engineering Design, P.C. has not been licensed for construction administration or administration and cannot be responsible for the design, contractor methods, material selection, limited performance of materials, lack of diligent supervision or safety during construction.
It is a violation of Section 1221 (2) of the Education Law for any person, other than the duly licensed architect or engineer, to prepare or cause to be prepared any drawings or specifications for a building or structure or any part thereof, which drawings or specifications are intended to be used for the construction of a building or structure, or any part thereof, unless such drawings or specifications are prepared by a duly licensed architect or engineer and are signed and sealed by him or her in accordance with the provisions of the Education Law.
The seal used in these drawings is for the seal of Steven L. Carini, P.E., a Professional Engineer in the State of New York, No. 14824, in the regular practice of his profession, and is not to be used in any other capacity, nor shall it be used in any other capacity without the written consent of Carini Engineering Design, P.C. The plan is filed in accordance with the provisions of the Education Law and a record of its receipt will be preserved.
The architect is responsible for checking dimensions and site conditions and to report any errors or omissions to the client before the start of construction. Another Government agency may require other record drawings. The plan is filed in accordance with the provisions of the Education Law and a record of its receipt will be preserved.
These plans are instruments of service for the construction of the building and are not to be used in any other capacity, nor shall they be used in any other capacity without the written consent of Carini Engineering Design, P.C. The plan is filed in accordance with the provisions of the Education Law and a record of its receipt will be preserved.
These plans comply with the 2010 code.
© CARINI 2010

Project: RESIDENTIAL ADDITION
Client: BILL & CHERYL BAUGH-BARDON
Job Location: 17 NORTHFIELD GATE PITTSFORD, NY
Drawing Title: ELEVATIONS
Drawn: JCD
Checked By: JCD
Date: JANUARY, 2012
Sheet No: 36448
Sheet: 2 of 3

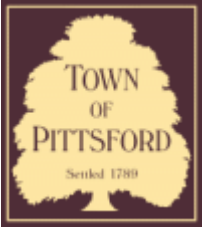

Town of Pittsford

Department of Public Works
11 South Main Street
Pittsford, New York 14534

Permit #
B22-000107

Phone: 585-248-6250
FAX: 585-248-6262

DESIGN REVIEW AND HISTORIC PRESERVATION BOARD REFERRAL OF APPLICATION

Property Address: 57 Shire Oaks Drive PITTSFORD, NY 14534

Tax ID Number: 151.12-3-9

Zoning District: RN Residential Neighborhood

Owner: Lloyd, Kevin

Applicant: Lloyd, Kevin

Application Type:


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§185-205 (B) | <input type="checkbox"/> Build to Line Adjustment
§185-17 (B) (2) |
| <input type="checkbox"/> Commercial Design Review
§185-205 (B) | <input type="checkbox"/> Building Height Above 30 Feet
§185-17 (M) |
| <input type="checkbox"/> Signage
§185-205 (C) | <input type="checkbox"/> Corner Lot Orientation
§185-17 (K) (3) |
| <input type="checkbox"/> Certificate of Appropriateness
§185-197 | <input type="checkbox"/> Flag Lot Building Line Location
§185-17 (L) (1) (c) |
| <input type="checkbox"/> Landmark Designation
§185-195 (2) | <input type="checkbox"/> Undeveloped Flag Lot Requirements
§185-17 (L) (2) |
| <input type="checkbox"/> Informal Review | |

Project Description: The applicant is requesting design review for an addition of a 255 sf front porch deck on the front entry way of the property


Meeting Date: July 14, 2022



RN Residential Neighborhood Zoning

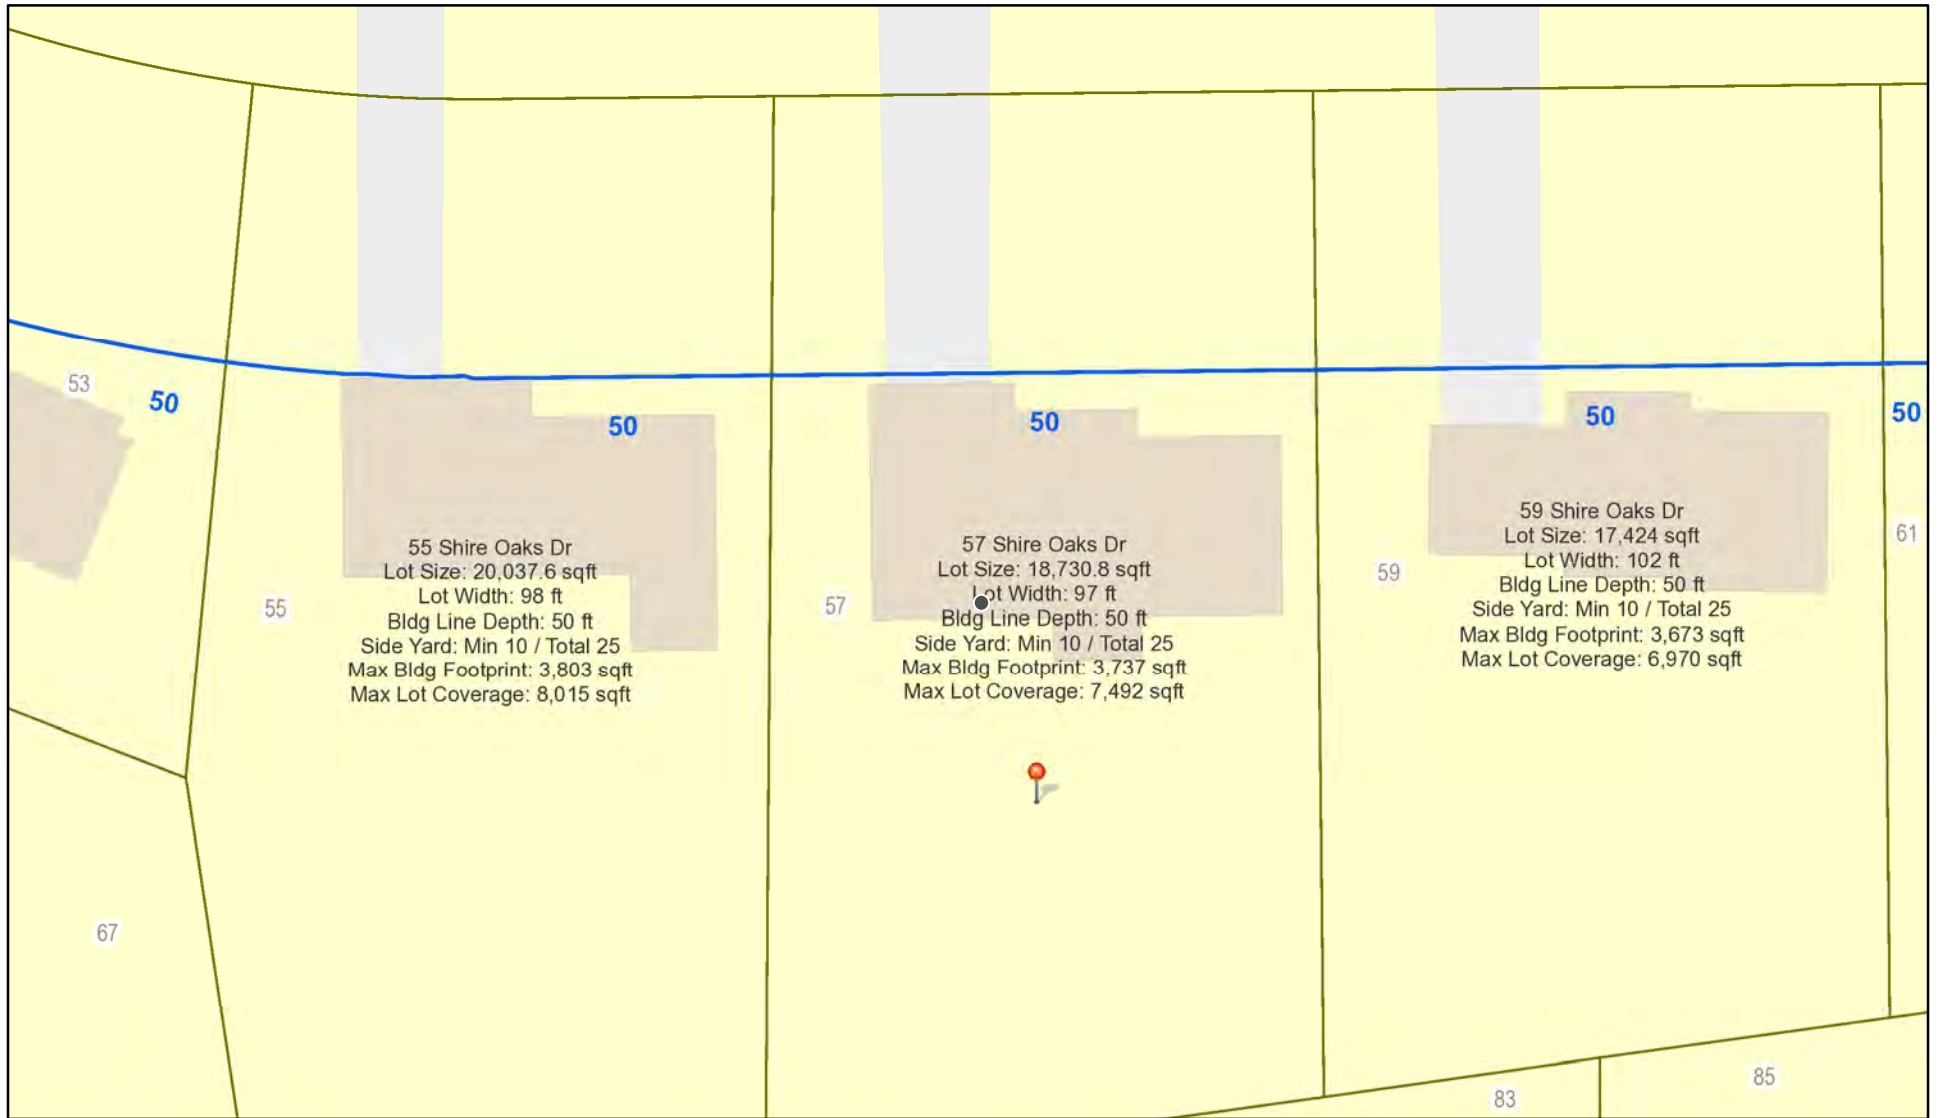

Printed July 6, 2022

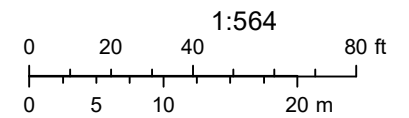


Town of Pittsford GIS

The information depicted on this map is representational and should be used for general reference purposes only. No warranties, expressed or implied, are provided for the data or its use or interpretation.



Shire Oaks Dr

COPY

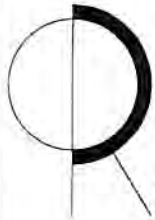

O'NEILL-RODAK
LAND SURVEYING ASSOCIATES, P.C.
LAND SURVEYORS - PLANNERS
BOUNDARY CONSULTANTS
FEMA ELEVATION CERTIFICATES
ALTA/NSPS SURVEYS

5 SOUTH FITZHUGH STREET
ROCHESTER, NY
14614
PHONE (585) 325-7520 FAX (585) 325-1708
e-mail surveyors@oneillrodak.com

MAP OF A SURVEY

LOT 110
EAST PITTSFORD MANOR, SECTION 1
TOWN OF PITTSFORD
MONROE COUNTY, NEW YORK

CLIENT	JOHN E. BERNACKI, JR., P.C	
SCALE	DATE	PROJECT NO.
1" = 30'	07/09/2019	2019-0945

NOTES:

PARCEL IS SUBJECT TO AN EASEMENT GRANTED TO ROCH. GAS & ELEC. CORP. AND ROCH. TELEPHONE CORP. FOR FIXTURES AS SET FORTH IN LIBER 3446 OF DEEDS, PAGE 334.

REFERENCE IS MADE TO A GAS MAIN EASEMENT GRANTED TO ROCH. GAS & ELEC. CORP. AS SET FORTH IN LIBER 3446 OF DEEDS, PAGE 335.


PARCEL TAX ID #151.12-3-9



SHIRE OAKS DRIVE

(60' WIDE)

N 81°43'00" W

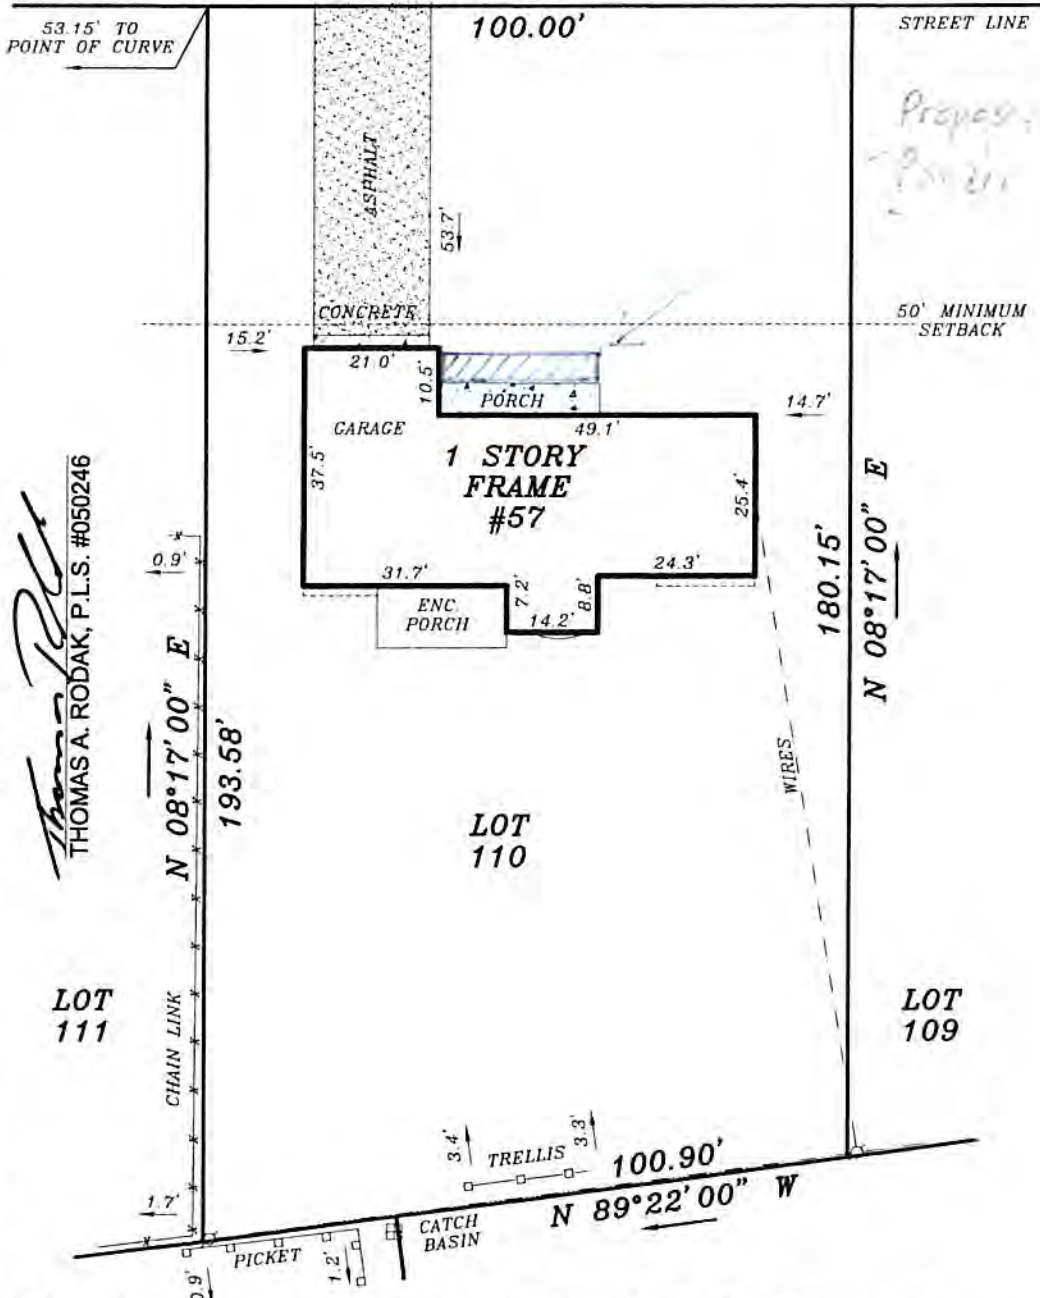

WE, O'NEILL-RODAK LAND SURVEYING ASSOCIATES, P.C., CERTIFY TO PREMIUM MORTGAGE CORP., ITS SUCCESSORS AND/OR ASSIGNS, AS THEIR INTEREST MAY APPEAR; DOLLINGER ASSOCIATES, P.C.; KEVIN LLOYD; JOHANNA C. PATASHNICK; STEFANO LAW FIRM, PLLC AND NETWORK TITLE AGENCY OF NEW YORK THAT THIS MAP WAS PREPARED FROM NOTES OF AN INSTRUMENT SURVEY COMPLETED JULY 8, 2019.

Thomas A. Rodak
THOMAS A. RODAK, P.L.S. #050246

REFERENCES:

CROSSROADS ABSTRACT #441540 DATED JUNE 12, 2019
LIBER 11470 OF DEEDS, PAGE 118
LIBER 156 OF MAPS, PAGE 59

"Unauthorized alteration of, or addition to, this survey map is a violation of section 7209 of the New York State Education Law" Copies of this survey map not bearing the land surveyor's inked or embossed seal shall not be considered to be a valid true copy.
"Guarantees or certifications indicated hereon shall run only to the person for whom the survey is prepared, and on his behalf to the title company, governmental agency and lending institution listed hereon, and to the assignees of the lending institution.
Guarantees or certifications are not transferable to the institutions or subsequent owners"

8

7

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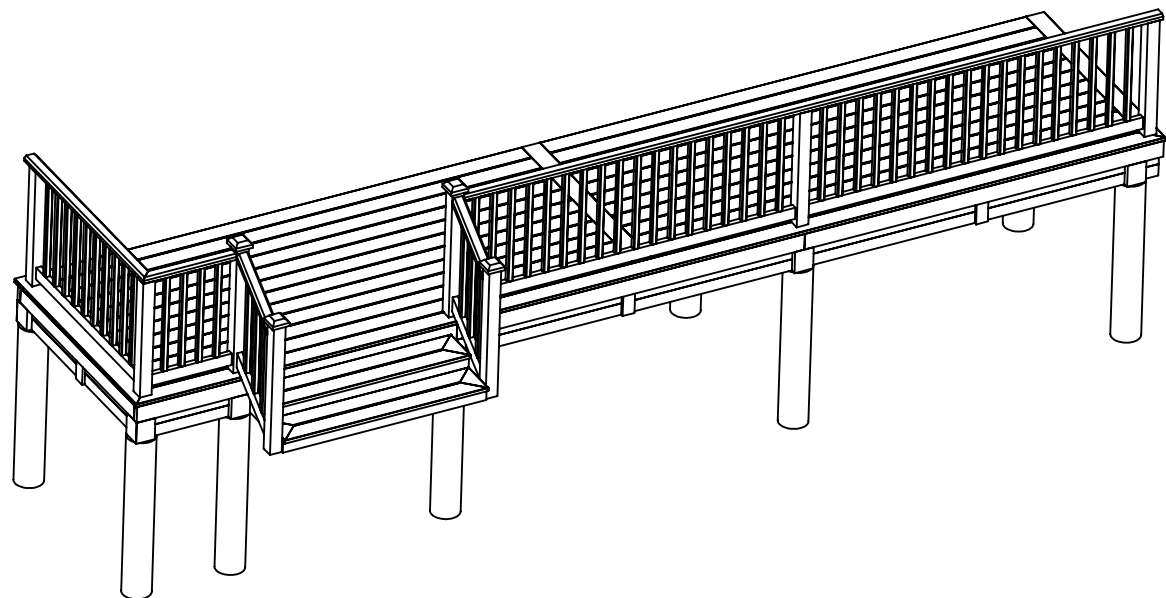
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1

REV	ECO	REVISION DESCRIPTION	NAME	DATE
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D


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C


C

FOOTERS



B

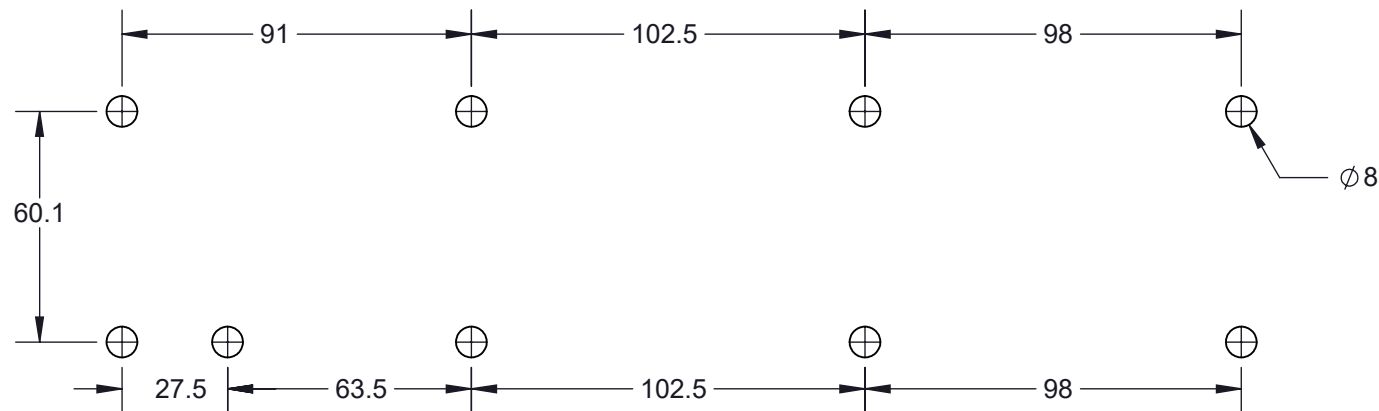B

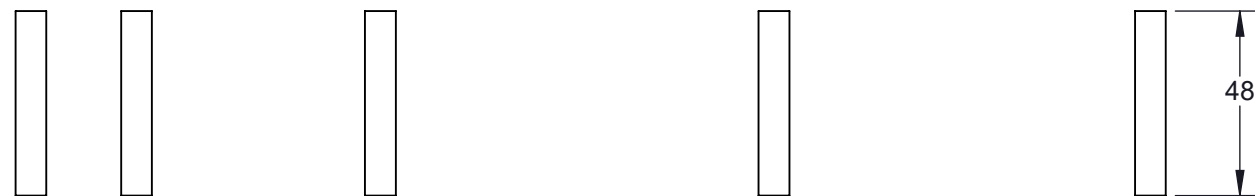

A

A

FRONT SECTION NOT ATTACHED TO HOUSE.
 SECURED TO FOOTERS WITH BRACKETS.

8

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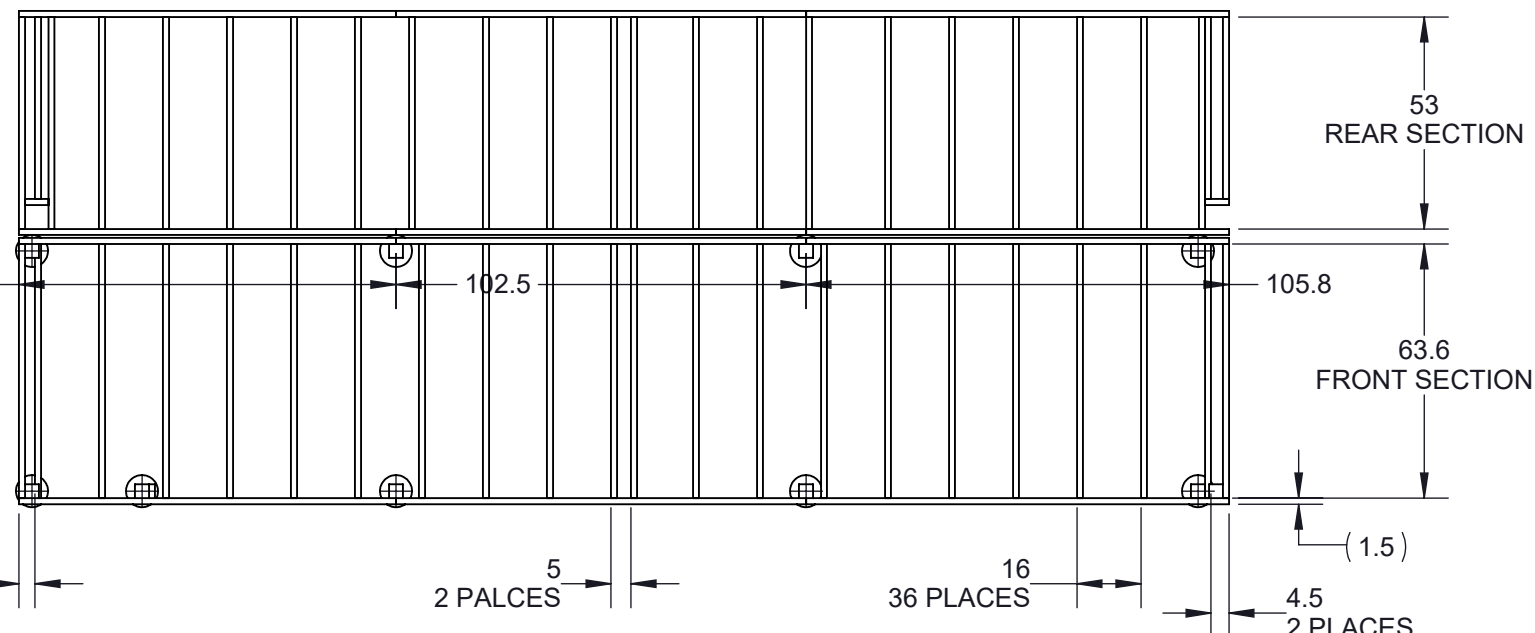
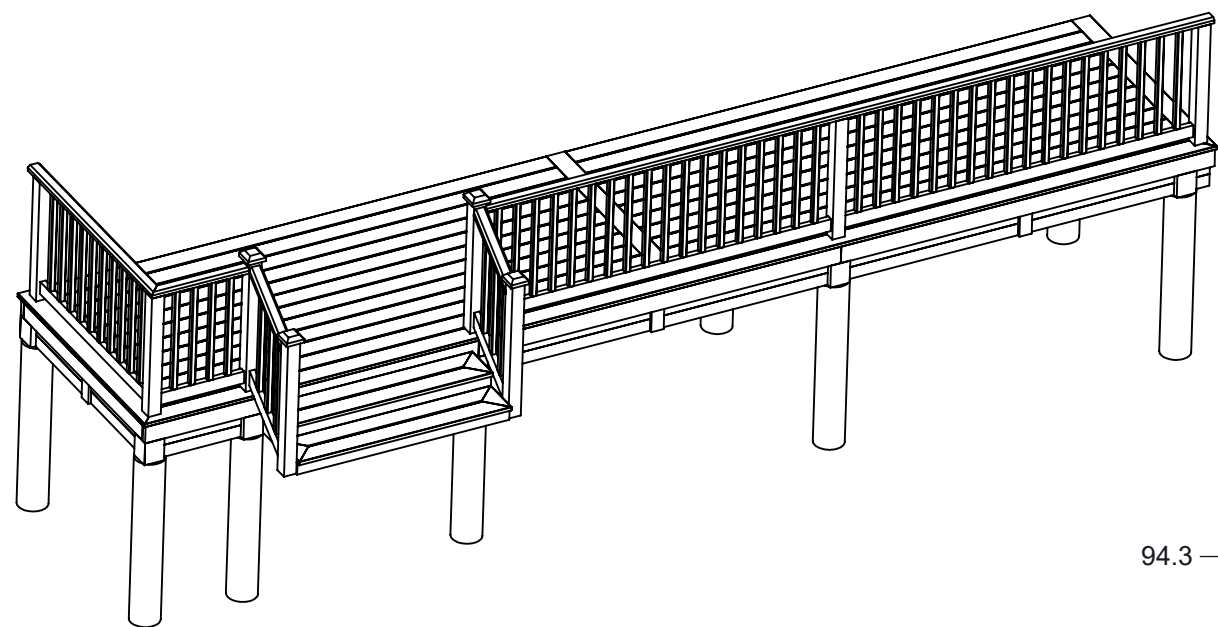
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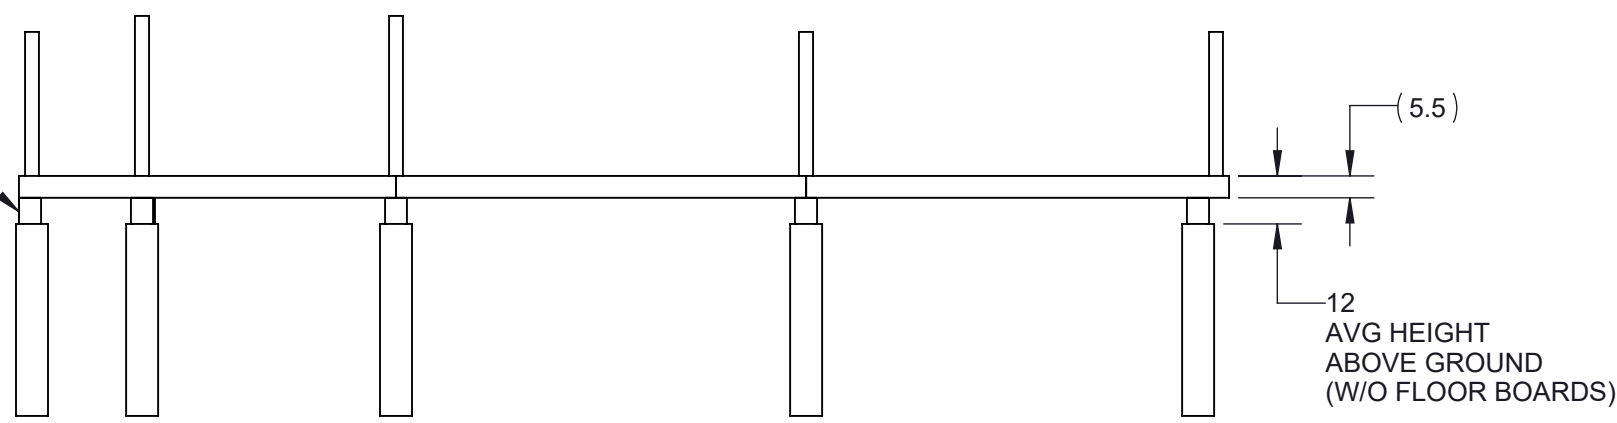
		DRAWN BY HOMEOWNER:	
		Kevin Lloyd	
UNITS	INCHES	SIZE	ADDRESS
SHEET	1 OF 3	B	57 Shire Oaks Dr
			REV. X1

8 7 6 5 4 3 2 1

Beams & Joists



(2x6 post mounted to 4x4 post)



SPECIFICATIONS

REAR SECTION (Rests on existing concrete porch)

- BEAMS: 2x6's
Rest on existing concrete porch and secure to concrete floor by brackets.
- JOISTS: 2x4's
Attached with face mount joist hanger brackets.

FRONT SECTION (w/ Footers)


- BEAMS: 2x6's
Attached to 4x4 posts with two 1/2" carriage bolts per and reinforced by 2x6 post.
2x6 posts attach to 4x4 with 2.5" outdoor deck screws.
- JOISTS: 2x6's
Attached with face mount joist hanger brackets.

UNITS INCHES		SIZE B	ADDRESS 57 Shire Oaks Dr	REV. X1
SHEET 2 OF 5				

DRAWN BY HOMEOWNER: Kevin Lloyd

8 7 6 5 4 3 2 1

Railings & Stairs

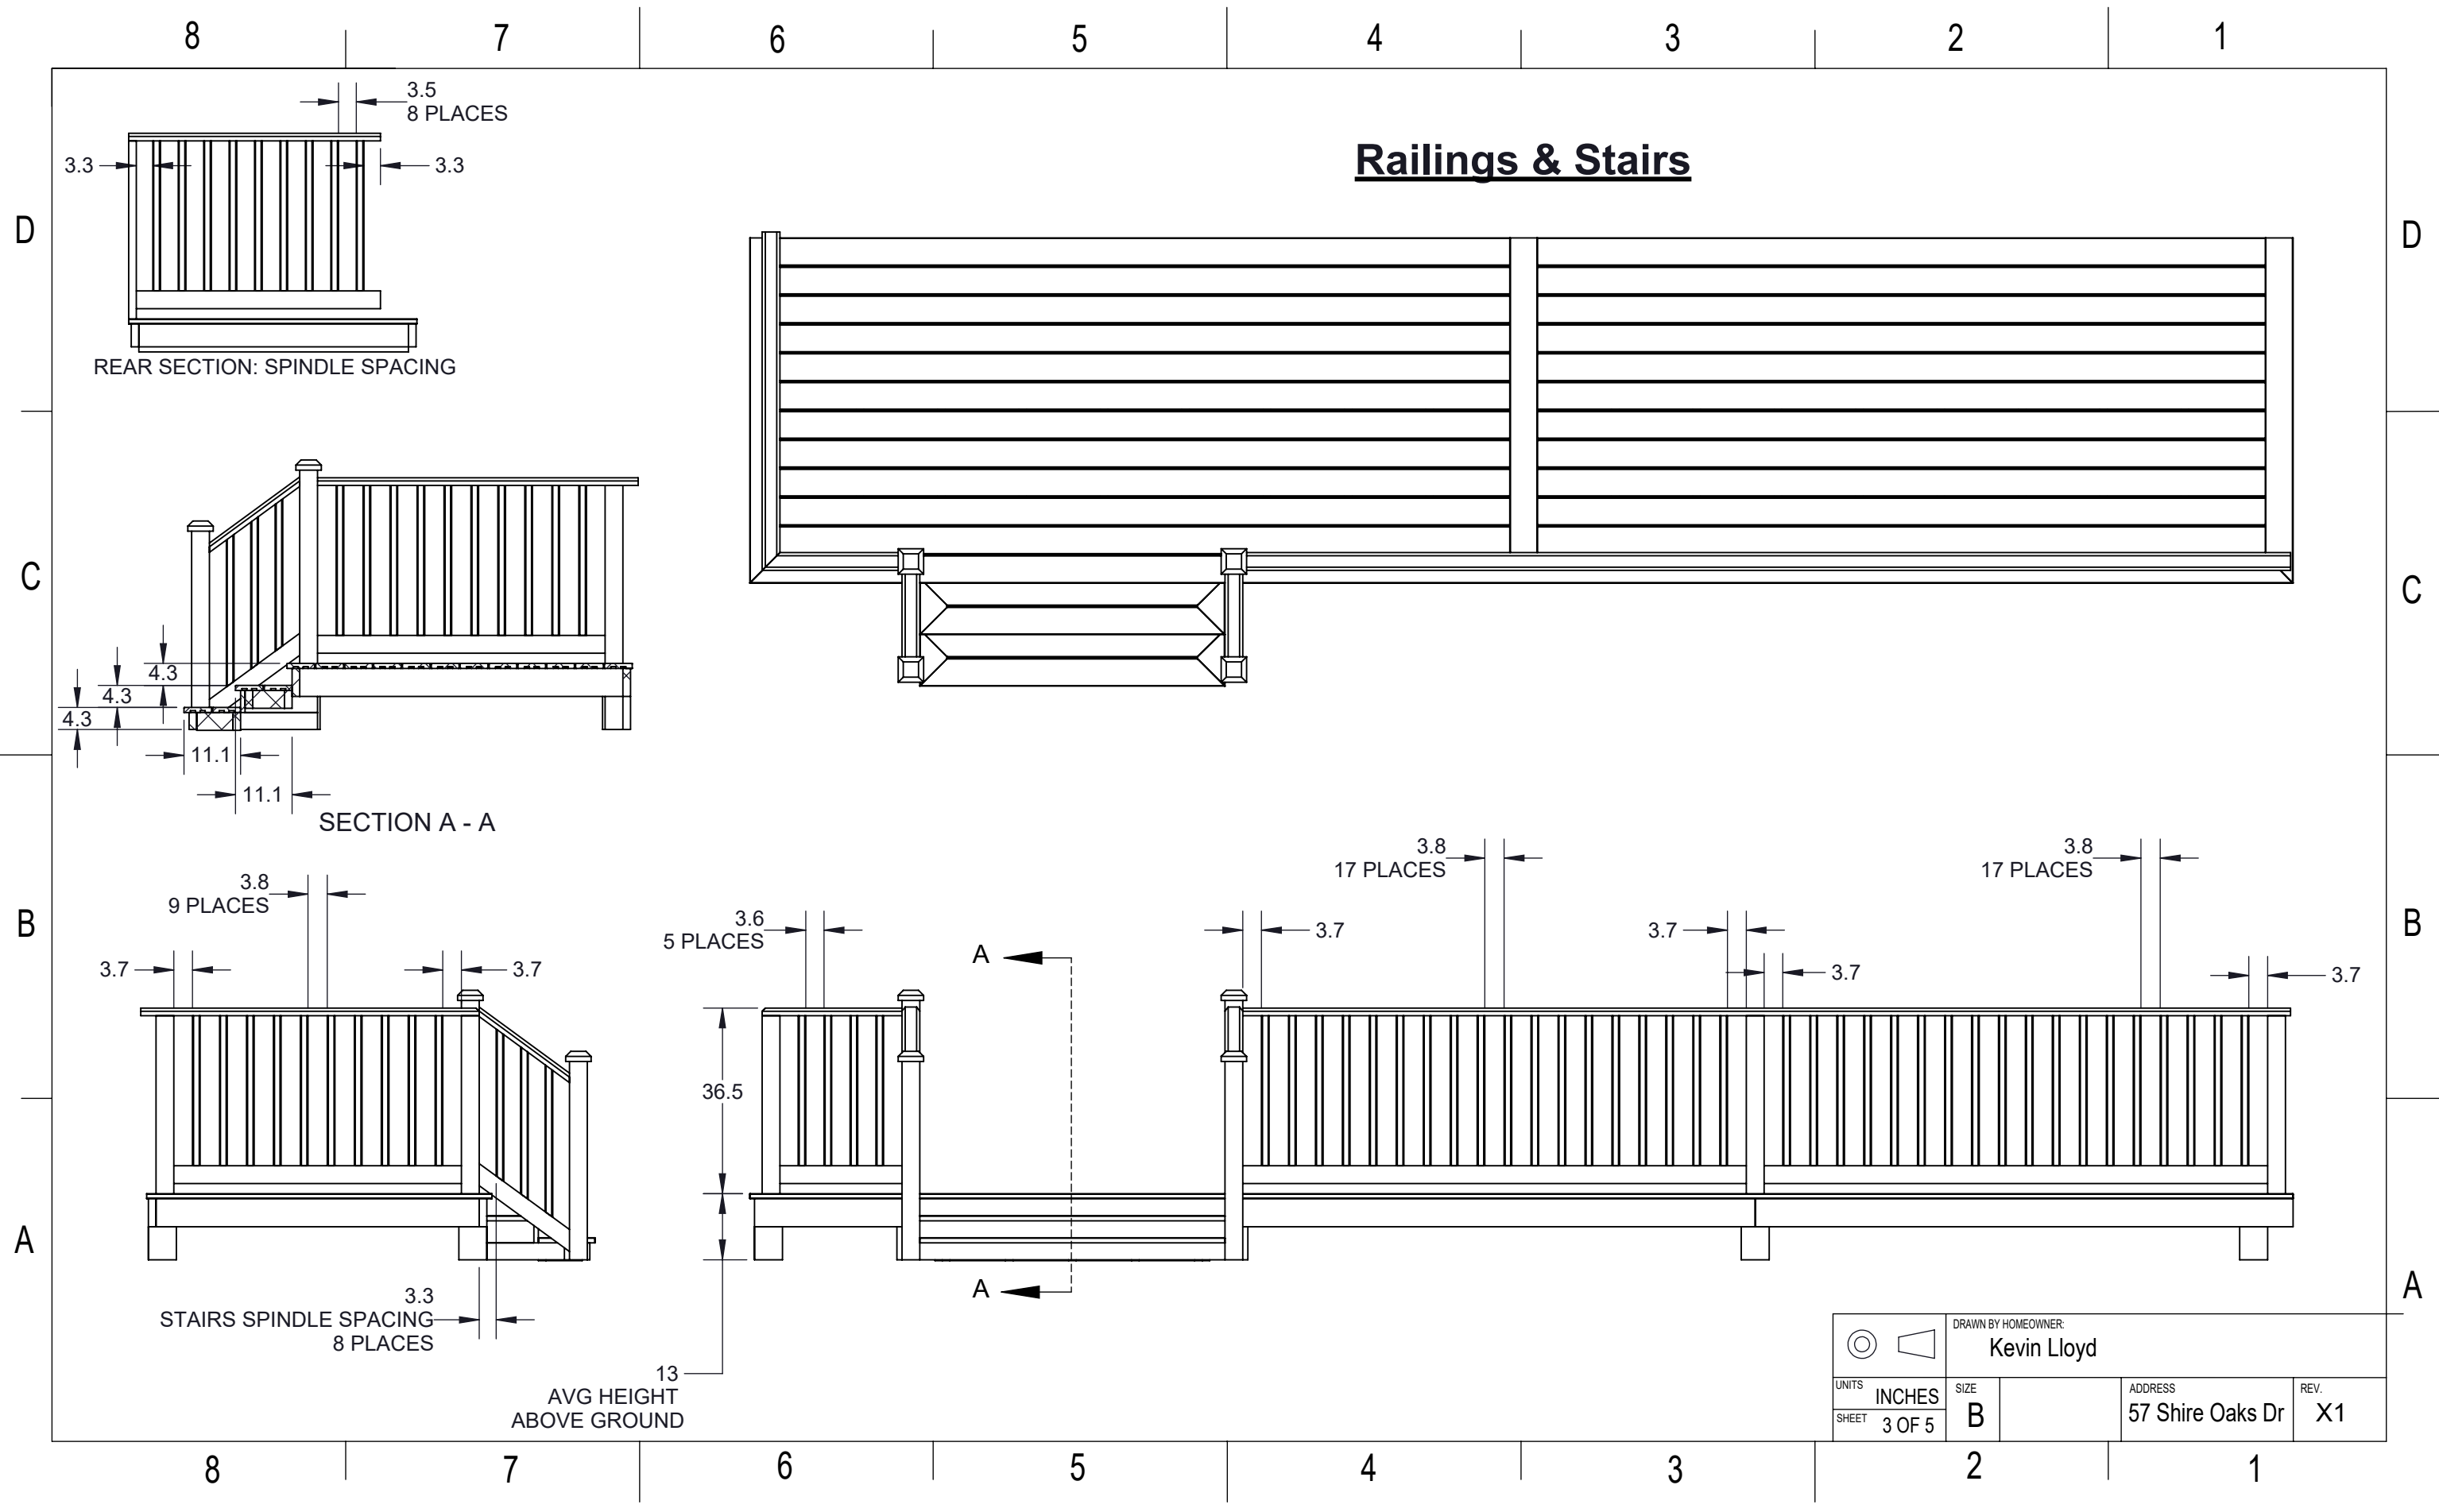

UNITS INCHES		DRAWN BY HOMEOWNER: Kevin Lloyd	
SHEET 3 OF 5		SIZE B	ADDRESS 57 Shire Oaks Dr
		REV. X1	

8

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

B

B

A

A



 		DRAWN BY HOMEOWNER:	
		Kevin Lloyd	
UNITS	INCHES	SIZE	
SHEET	4 OF 5	B	
		ADDRESS	REV.
		57 Shire Oaks Dr	X1

8

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D

D

C


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
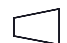
B

B

A

A

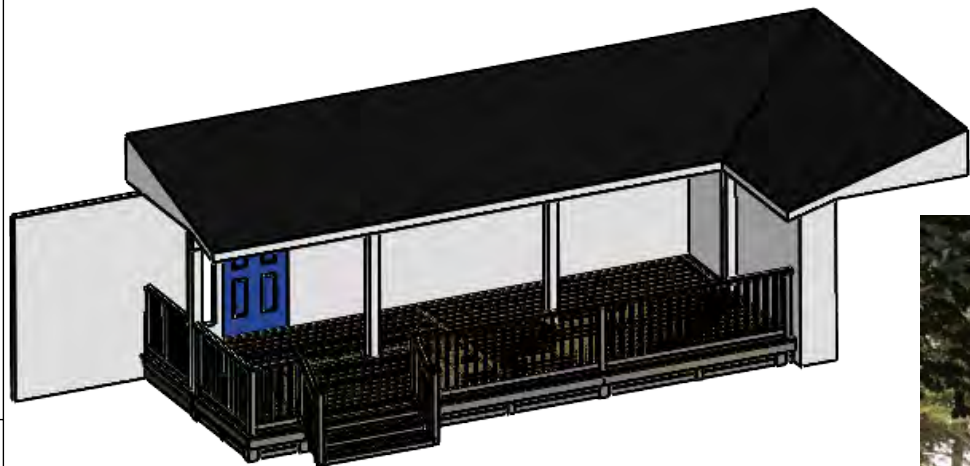

 		DRAWN BY HOMEOWNER:	
		Kevin Lloyd	
UNITS	INCHES	SIZE	ADDRESS
SHEET	5 OF 5	B	57 Shire Oaks Dr
			REV. X1

8

7

6


5

4

3

2

1

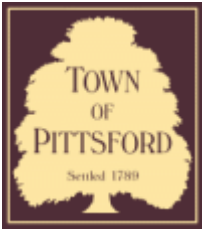

Town of Pittsford

Department of Public Works
11 South Main Street
Pittsford, New York 14534

Permit #
B22-000105

Phone: 585-248-6250
FAX: 585-248-6262

DESIGN REVIEW AND HISTORIC PRESERVATION BOARD REFERRAL OF APPLICATION

Property Address: 81 Knickerbocker Road PITTSFORD, NY 14534

Tax ID Number: 164.19-1-4.2

Zoning District: RN Residential Neighborhood

Owner: Reavey, Patrick

Applicant: Reavey, Patrick

Application Type:


- | | |
|---|---|
| <input checked="" type="checkbox"/> Residential Design Review
§185-205 (B) | <input type="checkbox"/> Build to Line Adjustment
§185-17 (B) (2) |
| <input type="checkbox"/> Commercial Design Review
§185-205 (B) | <input type="checkbox"/> Building Height Above 30 Feet
§185-17 (M) |
| <input type="checkbox"/> Signage
§185-205 (C) | <input type="checkbox"/> Corner Lot Orientation
§185-17 (K) (3) |
| <input type="checkbox"/> Certificate of Appropriateness
§185-197 | <input type="checkbox"/> Flag Lot Building Line Location
§185-17 (L) (1) (c) |
| <input type="checkbox"/> Landmark Designation
§185-195 (2) | <input type="checkbox"/> Undeveloped Flag Lot Requirements
§185-17 (L) (2) |
| <input type="checkbox"/> Informal Review | |

Project Description: The applicant is requesting design review for an addition of a 683 sf worth of additions including, Phase 1: second floor renovations including new roof line for master bedroom and bath. Remodel 2 existing baths and relocate laundry. Phase 2: including front bump out/entry way and moving kitchen, rebuilding and adding to sunroom in back.


Meeting Date: July 14, 2022



RN Residential Neighborhood Zoning

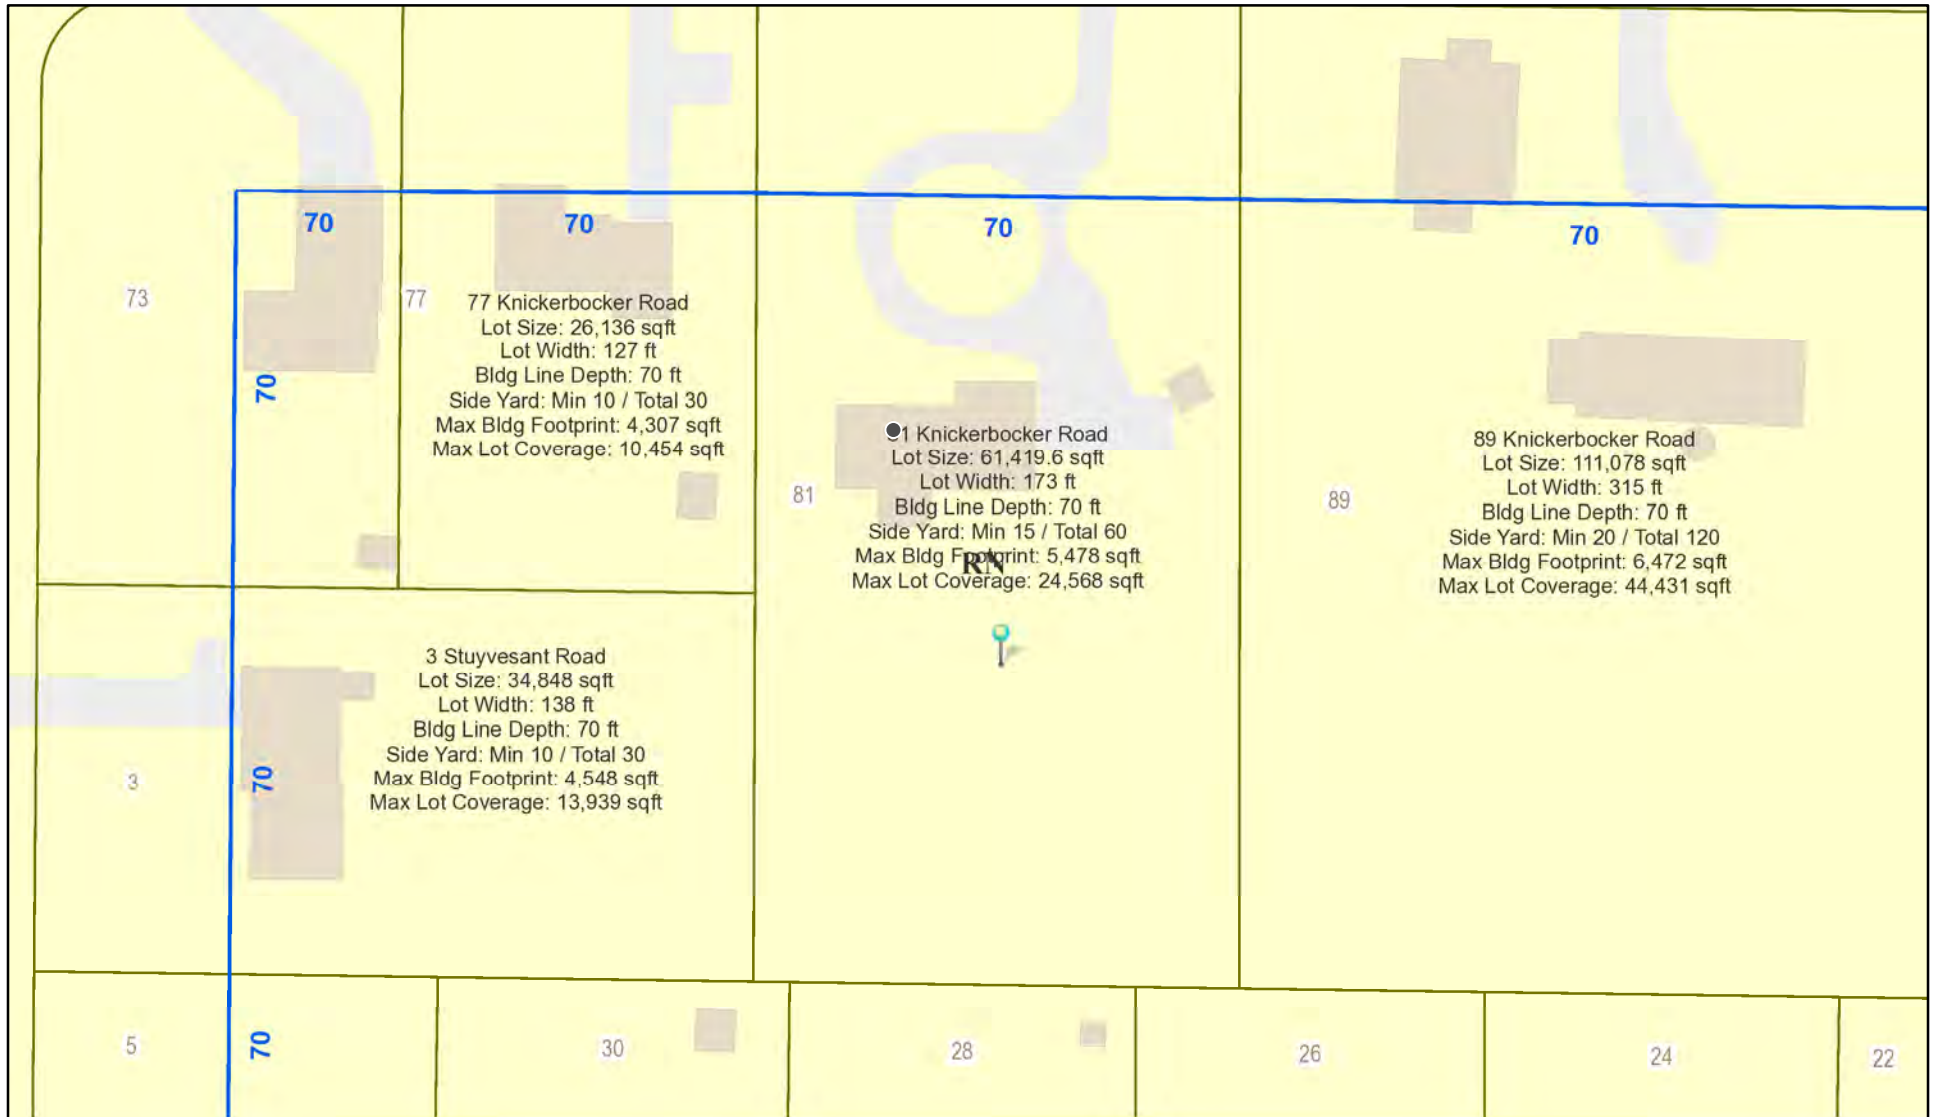


Printed June 30, 2022

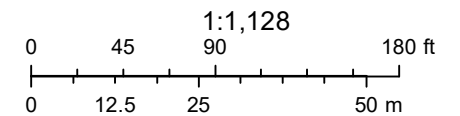

Town of Pittsford GIS

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Knickerbocker Rd

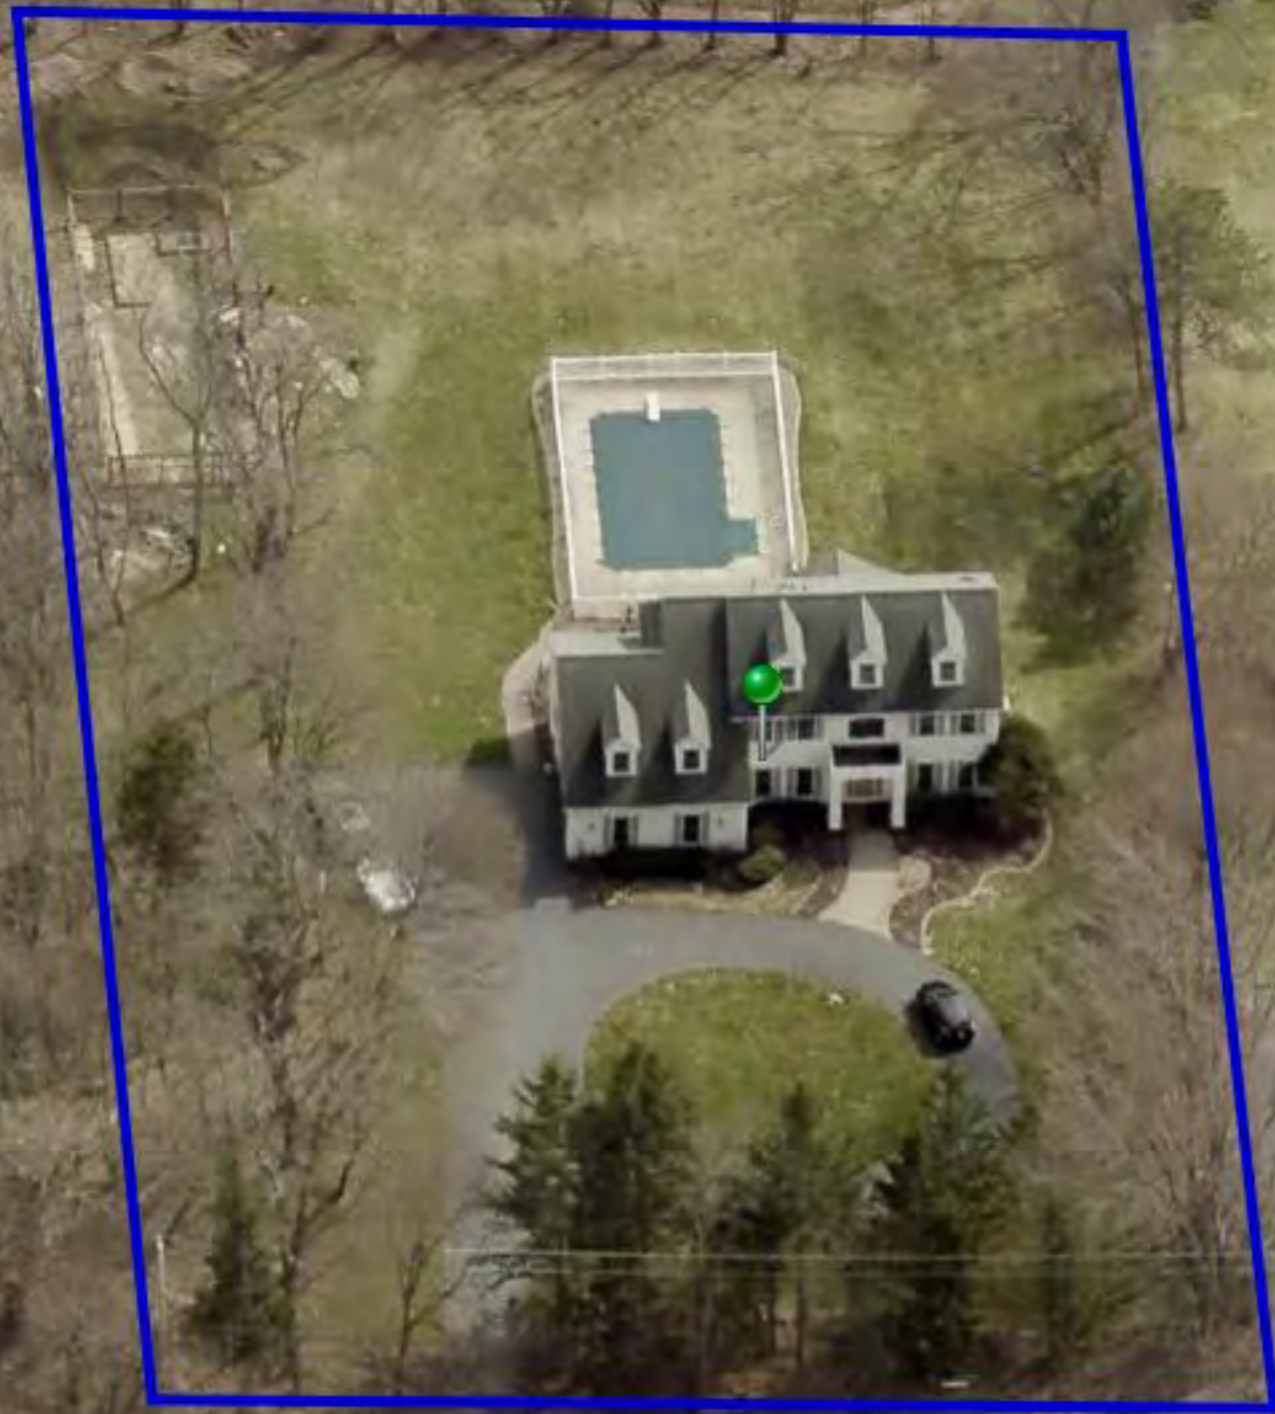04/03/2021

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REAVEY-CANNON RESIDENCE

81 KNICKERBOCKER ROAD, PITTSFORD, NY

OUTLINE SPECIFICATIONS

GENERAL CONDITIONS

PERMITS & APPROVALS: CONTRACTOR SHALL APPLY AND PAY FOR THE PERMITS FOR THEIR PORTION OF THE WORK ON THE ADDITIONS AND ALTERATIONS; THE CONTRACTOR SHALL ALSO OBTAIN OTHER REGD CONSTRUCTION INSPECTIONS AND APPROVALS FOR PORTIONS OF THE WORK SUCH AS THE ELECTRICAL, PLUMBING, & HVAC SYSTEMS, AND CERTIFICATE OF OCCUPANCY; PROVIDE COPIES OF SUCH APPROVALS TO THE OWNER.

WORK SCHEDULE: CONSTRUCTION WORK SHALL BEGIN UPON OWNER'S APPROVAL OF A CONSTRUCTION CONTRACT; CONTRACTOR SHALL DETERMINE WORK SCHEDULE WITH OWNER.

AGREEMENT & GENERAL CONDITIONS: CONTRACTOR SHALL PROVIDE A STANDARD CONSTRUCTION CONTRACT FOR OWNER'S APPROVAL.

PROJECT MEETINGS: CONTRACTORS SHALL MEET WITH THE OWNER ON A PERIODIC BASIS AND AS OTHERWISE NEEDED TO COORDINATE DETAILS OF THE CONSTRUCTION ACTIVITY.

SUBMITTALS & SHOP DRAWINGS: CONTRACTORS SHALL PROVIDE SUBMITTALS, SAMPLES, CATALOG EXCERPTS AND SHOP DRAWINGS FOR OWNER REVIEW PRIOR TO PERFORMING GIVEN ASPECTS OF THE WORK. THESE ASPECTS INCLUDE MILLWORK, DOORS & DOOR HARDWARE, WINDOWS, FLOOR & WALL FINISHES, PLUMBING FIXTURES, HVAC EQUIPMENT, ELECTRICAL LIGHTING & POWER FIXTURES, AND ANY OTHER ITEMS REQUESTED BY THE OWNER.

TEMPORARY BARRIERS: CONTRACTORS SHALL PROVIDE TEMPORARY BARRIERS AS NEEDED TO KEEP THE PUBLIC FROM ACCESS TO THE WORK AREA.

REMOVALS: REMOVE EXISTING CONSTRUCTION AS NEEDED TO CONSTRUCT THE ADDITION & ALTERATIONS SHOWN ON THESE DRAWINGS. REMOVAL INCLUDES DEMOLITION AND REMOVAL FROM SITE. DISPOSE OF IN A LEGAL MANNER. PROTECT EXISTING CONSTRUCTION TO REMAIN FROM WEATHER DURING CONSTRUCTION.

SECURITY: LIMIT ACCESS TO THE WORK AREA TO PERSONS INVOLVED IN THE WORK. PROVIDE SECURE STORAGE FOR CONSTRUCTION MATERIALS AND EQUIPMENT. SAFETY AT WORK AREA IS THE CONTRACTOR'S RESPONSIBILITY.

ON-SITE TEMPORARY FACILITIES: CONTRACTORS MAY TEMPORARILY PLACE ITEMS SUCH AS DUMPSTER, TOILET FACILITY, AND SECURE STORAGE CONTAINER ON SITE. CONTRACTOR SHALL OBTAIN MUNICIPAL APPROVALS FOR SUCH ITEMS AS NEEDED.

CLEANING: CONTRACTORS SHALL MAINTAIN THE RENOVATION AREA AND SITE IN AN ORDERLY CONDITION. FOR FINAL CLEANING, CONTRACTOR SHALL PROVIDE THE RENOVATION AREA AND SITE IN COMPLETED AND CLEAN CONDITION READY FOR OCCUPANCY BY THE OWNER.

SITE

SITE UTILITIES: LOCATE EXISTING SITE UTILITIES AS NEEDED TO CONSTRUCT ADDITIONS, SUCH AS ELECTRIC, GAS & WATER SERVICE. AVOID DAMAGE TO EXISTING SITE UTILITIES WHEN PERFORMING THE CONSTRUCTION WORK. CONTRACTORS SHALL REPAIR DAMAGE TO SITE UTILITIES CAUSED BY THEIR CONSTRUCTION ACTIVITY.

LAYING & PLANTINGS: RE-GRADE & RETURN DISTURBED AREAS TO MEET EXISTING ADJACENT CONTOURS. FINISH GRADE TO SLOPE AWAY FROM THE FOUNDATION WALL. EXISTING TREES AND PLANTINGS TO REMAIN TO EXTENT CONSTRUCTION WORK ALLOWS. NEW PLANTINGS SHALL BE PROVIDED BY THE OWNER SEPARATELY.

DRIVEWAY & WALKS: REPAIR EXISTING PAVEMENT AS NEEDED DUE TO DAMAGE OR REMOVAL FOR CONSTRUCTION ACTIVITIES.

SOILS BEARING: THE ASSUMED SOIL BEARING CAPACITY IS 2,500 P.S.F. IF UNSUITABLE SOILS ARE ENCOUNTERED OR SUSPECTED, NOTIFY OWNER & ARCHITECT FOR POSSIBLE FOUNDATION RE-DESIGN. SOILS TESTING, IF NEEDED, SHALL BE OWNER'S RESPONSIBILITY.

CONCRETE

CONC. FOOTINGS: NEW CONC. FOOTINGS, PROVIDE 3,000 TO 3,500 PSI CONCRETE DESIGN COMPRESSIVE STRENGTH @ 28 DAYS, WITH RE-BARS.

CONCRETE FLOORS: PROVIDE NEW CONCRETE FLOOR AT ADDITIONS PER NOTES AT PLANS & WALL SECTIONS. BASIS OF DESIGN IS TO CAREFULLY SAW-CUT EXISTING CONCRETE SLAB TO ALLOW FOR NEW FOUNDATION CONSTRUCTION. EXISTING PATIO SLAB TO REMAIN TO THE FULLEST EXTENT.

FILL: WHERE SOILS ARE UNSUITABLE FOR BEARING OF CONCRETE FOOTINGS & SLABS, EXCAVATE TO UNDISTURBED SUITABLE FIRM SOILS; PROVIDE ENGINEERED FILL; FILL INTENDED FOR BEARING SHALL BE INSTALLED IN 8" LIFTS & COMPACTED TO 95% COMPACTION, AS MEASURED BY MODIFIED PROCTOR TESTS.

METAL

STEEL: ASTM A-36 STRUCTURAL STEEL FOR NEW COLUMNS AND BEAMS. REINFORCING BARS SHALL BE GRADE 60 OR BETTER. RED OXIDE PRIMER.

WOOD AND PLASTICS

ROUGH CARPENTRY:
ROOF SHEATHING: APA CDX PLYWOOD OR OSB SHEATHING W/ 'H' CLIPS... 1/2" MIN. THK. SHEATHING @ 16" O.C. ROOF FRAMING, 5/8" THK. @ 24" O.C.
EXTERIOR WALLS: 1/2" APA EXTERIOR GRADE PLYWOOD OR OSB SHEATHING;
FLOOR SHEATHING: 3/4" THK. OSB SHEATHING, "ADVANTAGE" OR EQUAL;
2x6 WOOD STUDS AT 16" O.C. AT NEW EXTERIOR WALLS;
2x4 WOOD STUDS AT 16" O.C. INTERIOR WALLS, UNLESS INDICATED OTHERWISE

FRAMING LUMBER: FRAMING MEMBERS SHALL BE #2 HEM-FIR OR BETTER. FLOOR JOISTS MAY ALSO BE DOUGLAS FIR, OR TJI PLYWOOD JOISTS. BEAMS, HEADERS, JOISTS, AND RAFTERS AS NOTED ON THE DRAWINGS; PROVIDE WOOD BLOCKING BELOW CONCENTRATED LOADS SUCH AS POSTS; PROVIDE X-BRACING AT MIDSPAN OF WOOD FLOOR JOISTS. PROVIDE BLOCKING OR X-BRACING AT TJI JOISTS PER MANUF. RECOMMENDS. PROVIDE PRESERVATIVE PRESSURE TREATED WOOD WHEN IN CONTACT WITH MASONRY, CONCRETE OR WHEN EXPOSED TO THE WEATHER.

BEARING NOTE: IT'S THE INTENTION ON THESE DRAWINGS THAT CONCENTRATED LOADS, SUCH AS POSTS AND HEADERS, HAVE ADEQUATE BEARING TO THE FOUNDATION. IF THIS DOES NOT APPEAR TO BE THE CASE IN ANY INSTANCE DURING CONSTRUCTION, NOTIFY THE ARCHITECT PRIOR TO PROCEEDING.

ROOF TRUSSES: TRUSSES, IF ANY, SHALL BE DESIGNED BY THE SUPPLIER'S ENGINEER FOR ALL APPLICABLE LOADS PER THE BUILDING CODES OF NEW YORK. ROOF TRUSS DRAWINGS SHALL BEAR THE SEAL & SIGNATURE OF A N.Y.S. LICENSED ENGINEER. TRUSSES SHALL BE INSTALLED WITH TIE-DOWN CLIPS AT EACH TRUSS TO TOP OF WALL, TYP. TRUSSES SHALL BE RAISED HEEL TYPE TO ALLOW FULL INSULATION THICKNESS AT TOP OF WALLS. TRUSS DESIGN, CONNECTIONS, BRACING, ERECTION AND QUALITY SHALL CONFORM TO THE SPECS & RECOMMENDATIONS OF THE N.F.P.A. AND THE TRUSS PLATE INSTITUTE (T.P.I.) INCLUDING TEMPORARY AND PERMANENT BRACING.

INTERIOR TRIM: MATERIAL, SIZE, PROFILE AND FINISH OF NEW INTERIOR TRIM AT THE ADDITION AND ALTERATIONS SHALL GENERALLY MATCH TYPICAL EXISTING TRIM AT THE FIRST FLOOR OF THE RESIDENCE, INCLUDING WINDOW TRIM, DOOR TRIM, AND WALL BASE, OR SHALL BE AS DETERMINED WITH THE OWNER.

CLOSET SHELVING: PROVIDE RODS & SHELVES IN NEW CLOSETS AS DETERMINED WITH THE OWNER.

CABINETS: PROVIDE NEW CABINETS AND COUNTERS AS GENERALLY SHOWN ON THE DRAWINGS; PROVIDE SHOP DRAWINGS FOR OWNER APPROVAL.

THERMAL AND MOISTURE PROTECTION

AIR INFILTRATION BARRIER: TYVEK OR EQUAL HOUSE WRAP ON ALL NEW & RENOVATED EXTERIOR WALLS; INSTALL PER MANUFACTURER'S RECOMMENDATIONS.

INSULATION AT EXISTING BUILDING: EXISTING BUILDING EXTERIOR WALLS AND ROOF INSULATION TO REMAIN, UNLESS OTHERWISE NOTED; VERIFY EXISTING IS INTACT AND FILL IN WHERE IT IS NOT; AT NEW ATTIC INSULATION AREAS, INCLUDE VENT BAFFLES AT RAFTER SPACES AT EAVES TO ALLOW VENTILATION OF ATTIC AIR ABOVE INSULATION.

INSULATION AT ADDITIONS & FORMER GARAGE AREA:
SILL SEALER: INSULATION UNDER WOOD PLATES ON FOUNDATION WALLS;
GASKET TYPE SEALANTS AROUND OUTSIDE ELECTRICAL AND OTHER OUTLETS;
CAULK PERIMETER OF NEW DOORS, WINDOWS, & PIPE PENETRATIONS AT EXTERIOR;
R-21 MIN. FIBERGLASS FOIL FACE INSL. AT NEW EXTERIOR 2x6 WOOD STUD WALLS;
R-49 FIBERGLASS INSULATION ROLL OR BLOWN-IN AT NEW CEILING JOISTS;
R-30 FIBERGLASS INSULATION ROLL OR BLOWN-IN AT EXISTING CEILING JOISTS;
SPRAY FOAM INSULATION IS AN ACCEPTABLE ALTERNATIVE TO FIBERGLASS BATT;
SOUND ATTENUATING BATTS FULL HEIGHT IN NEW INTERIOR WALLS.

ROOF SHINGLES: REMOVE ROOFING AND FELT UNDER-LAYMENT TO PLYWOOD SHEATHING AT EXISTING ROOF WORK AREAS; PROVIDE NEW ASPHALT ROOF SHINGLES ON 15# MIN. REINFORCED ROOFING FELT; PROVIDE UNDER-LAYMENT OF GRACES "ICE & WATER SHIELD" OR EQUAL AT ALL EAVES AND VALLEYS AS REQUIRED BY BUILDING CODE.

ROOF GUTTERS & DOWNSPOUTS: REMOVE EXISTING GUTTERS & DOWNSPOUTS AS NECESSARY TO ALLOW FOR NEW CONSTRUCTION; PROVIDE HEAVY DUTY SEAMLESS PRE-FINISHED ALUMINUM GUTTERS; GENERALLY LOCATE DOWNSPOUTS AT OUTSIDE CORNERS, OR PROVIDE NEW DOWNSPOUT AT EXISTING LOCATIONS.

EXTERIOR SIDING: MATCH EXISTING SIDING & TRIM; FINAL SELECTION OF TYPE AND COLORS AS SELECTED WITH OWNER.

EXTERIOR TRIM: TRIM AS SHOWN ON EXTERIOR ELEVATIONS, INCLUDING AT EAVES, WINDOWS, DOORS, INSIDE & OUTSIDE BUILDING CORNERS, AND TOP OF WALL.

CAULKING & SEALANTS: CAULKING & SEALANTS... SILICONE BASED ACRYLIC IN COLOR TO MATCH ADJACENT MATERIALS.

DOORS, WINDOWS, AND GLAZING:

WINDOWS: NEW EXTERIOR WINDOWS SHALL BE LOW-E, ARGON GAS FILLED; INSULATED GLASS BY ANDERSEN OR APPROVED EQUAL; PROVIDE SCREENS FOR ALL OPERABLE WINDOWS; PROVIDE EXTENSION JAMBS TO SUIT WALL THICKNESS; HARDWARE AND INTERIOR & EXTERIOR FINISH ON SASH AND FRAMES TO MATCH EXISTING.

EXTERIOR DOORS: 1-3/4" FIBERGLASS INSULATED DOOR; COORDINATE FINAL SELECTION OF NEW DOORS WITH OWNER; HEAVY-DUTY WEATHER STRIPPING AT ALL EXTERIOR DOORS; HARDWARE SHALL BE HANDICAPPED USABLE MODELS INCLUDING LEVER TYPE DOOR HANDLE AND ALUMINUM DOOR SILL.

INTERIOR DOORS: INTERIOR WOOD DOORS TO MATCH EXISTING; FINAL SELECTION OF STYLE, MATERIAL AND FINISH AS SELECTED BY OWNER; SALVAGE & REUSE WHEN DETERMINED TO BE IN GOOD-EXCELLENT CONDITION.

DOOR HARDWARE: DOOR HARDWARE FINISH & STYLE TO MATCH EXISTING.

INTERIOR FINISHES

GYPSUM WALL BOARD: PROVIDE 5/8" THICK TYPE 'X' FOR ALL NEW GYPSUM WALL BOARD; EXCEPT WHERE WALLS OR CEILINGS ARE BEING PATCHED PROVIDE GYPSUM WALL BOARD TO MATCH EXISTING ADJACENT; MOISTURE RESISTANT TYPE IN ALL 'WET' LOCATIONS; TYPICAL APPLICATION: GLUE & SCREW TO FRAMING.

CEMENT BOARD: PROVIDE 1/2" THICK CEMENT BOARD SHEATHING AT WALLS & FLOORS TO RECEIVE TILE FINISH.

PAINTING: PAINT COLORS TO BE SELECTED BY OWNER; PRIMER PLUS (2) TWO COATS LATEX AT ALL CEILINGS & INTERIOR WALLS, U.N.O.; EGG-SHELL FINISH AT WALLS; SEMI-GLOSS FINISH AT INTERIOR DOOR & WINDOW FRAMES.

FINISHES PLAN: SEE FINISHES SCHEDULE FOR FURTHER FINISHES INFO.

MECHANICAL:

CODE COMPLIANCE: PLUMBING & HVAC WORK SHALL BE PROVIDED IN COMPLIANCE WITH THE CURRENT INTERNATIONAL BUILDING CODES WITH THE APPLICABLE NEW YORK STATE AMENDMENTS, AND OTHER APPLICABLE BUILDING CODES.

SPECIALTIES:

BATH ROOM ACCESSORIES: PROVIDE ACCESSORIES AT NEW BATH ROOMS AS INDICATED ON THE DRAWINGS & OUTLINE SPECS; COORD. W/ OWNER FOR SELECTION; PROVIDE WOOD BLOCKING IN WALLS WHERE NEEDED TO SUPPORT ACCESSORIES; EACH BATHROOM SHALL INCLUDE THE FOLLOWING ACCESSORIES:
 1. 24" WIDE X 36" HT. MIRROR AT EACH VANITY SINK.
 2. 1 TOILET PAPER DISPENSER.
 3. 1 1/4" DIA. STAINLESS STEEL SHOWER CURTAIN ROD.
 4. GRAB BARS AS INDICATED ON THE FLOOR PLAN.

WATER SUPPLY SYSTEM: 1/2" BRANCH LINES COPPER PIPING WITH SWEATED FITTINGS; ALL PLUMBING FIXTURES TO HAVE SHUT-OFFS; PROVIDE TWO NEW EXTERIOR HOSE BIBS AND ASSOCIATED SUPPLY WATER PIPING; HOSE BIBS SHALL BE FROST FREE TYP; ONE AT DECK, ONE AT SHOP.

WASTE WATER SYSTEM: PIPING MATERIALS & TIE-IN OF ALL PLUMBING LINES TO BE PER CODE. CONNECT NEW DRAINS TO EXISTING SANITARY DRAIN SYSTEM.

SITE SANITARY SYSTEM: CHECK FOR PROPER FUNCTIONING OF EXISTING SANITARY DRAIN SYSTEM; CLEAR LINES AS NEEDED WITH PLUMBER'S TOOLS; REPLACEMENT OF EXISTING SANITARY DRAIN SYSTEM OUTSIDE THE FOUNDATION WALLS IS NOT ANTICIPATED AS PART OF THIS CONSTRUCTION CONTRACT.

HVAC SYSTEMS: COORDINATE WITH HVAC CONTRACTOR TO VERIFY ADEQUACY OF EXISTING HVAC SYSTEM TO INCLUDE THE ADDITION; IF SO, EXTEND EXISTING HVAC SYSTEM INTO THE ADDITION; OTHERWISE PROVIDE NEW HVAC SYSTEMS FOR ADDITION; PROVIDE BALANCED SYSTEMS WITH SUPPLY AND RETURN DUCTWORK TO NEW ROOMS.

WATER HEATERS: REMOVE EXISTING HOT WATER HEATER; REPLACE WITH A 75 GALLON HOT WATER HEATER, EQUAL TO A RHEEM PERFORMANCE PLATINUM 12 YEAR WARRANTY 76,000 BTU NATURAL GAS UPRIGHT TANK TYPE WATER HEATER; CONNECT NEW PLUMBING FIXTURES TO WATER SUPPLY SYSTEMS.

BASIC DESCRIPTION OF WORK

-RESIDENCE ADDITION & ALTERATIONS-
 THE PROJECT IS ADDITIONS AND ALTERATIONS TO THE EXISTING RESIDENCE INCLUDING A NEW KITCHEN, ENTRANCE, AND MASTER BEDROOM EXPANSION OVER GARAGE, SUN ROOM, DEMOLITION AND NEW CONSTRUCTION AT FUTURE DATE.

-REMOVALS-
 REMOVE EXISTING CONSTRUCTION AS INDICATED ON THE DRAWINGS AND AS OTHERWISE NEEDED TO CONSTRUCT THE ADDITIONS AND ALTERATIONS.

-GENERAL CONSTRUCTION-
 WORK OF THIS CONTRACT IS GENERAL CONSTRUCTION, INCLUDING INTERIOR AND EXTERIOR WORK, HVAC, PLUMBING, ELECTRICAL, POWER & LIGHTING.

BUILDING DATA

BUILDING OCCUPANCY TYPE: R-1
 CONSTRUCTION CLASSIFICATION: TYPE V-B
 BUILDING HEIGHT: 38'-7" +/- AT WALKOUT BASEMENT
 AREA OF EXISTING BUILDING TO REMAIN: 4,791 S.F.
 AREA OF ADDITIONS: 693 S.F.
 BUILDING AREA WITH ADDITIONS: 5,480 S.F.

MATERIAL LEGEND

ENERGY CONSERVATION NOTICE:

THESE PLANS AND SPECIFICATIONS HAVE BEEN PREPARED BY UNDER THE DIRECTION OF THE UNDERSIGNED AND TO THE BEST OF THE UNDERSIGNED'S KNOWLEDGE, INFORMATION AND BELIEF MEET THE REQUIREMENTS OF THE LATEST EDITION OF THE BUILDING CODE OF NEW YORK STATE, THE ENERGY CONSERVATION CONSTRUCTION CODE OF NEW YORK STATE, INDUSTRIAL CODE RULE 96 AND CONSTRUCTION STANDARDS OF THE EDUCATION DEPARTMENT.

SIGNED: 11-5-2021 Revised 06-30-22
 DATE

SYMBOL LEGEND


	EXISTING SPOT ELEVATION		ROOM # 06 - RM. ELEV. IS DETAIL # 5 ON SHEET A-7
	FINISHED SPOT ELEVATION		DOOR NUMBER
	EXISTING CONTOUR TO BE REMOVED		COLUMN GRID LINES
	FINISHED CONTOUR		REVISION NUMBER
	PROPERTY LINE		CHANGE IN AREA OR FINISH
	FENCE		DIMENSION TO CENTER LINE OF GRID, PARTITION, OR MULLION
	EXISTING TREE TO BE PROTECTED		DIMENSION TO ROUGH WALL OR FACE OF STUD
	EXISTING TREE TO BE REMOVED		DIMENSION TO FINISH WALL SURFACE
	BENCHMARK, FLOOR ELEV. OR OTHER VERT. EL.		WINDOW WALL SYMBOL
	SANITARY SEWER		CEILING HEIGHT
	STORM SEWER		LIGHTING FIXTURES (TYPE AS SCHEDULED)
	WATER LINE		EXISTING DOOR AND FRAME TO BE REMOVED
	GAS LINE		EXISTING DOOR AND FRAME TO REMAIN
	ELECTRIC LINE		NEW DOOR AND FRAME
	DETAIL SECTION #A ON SHEET A-1		DOOR SIZE: 2 FOOT 6 INCH WIDE BY 6 FOOT 8 INCH HIGH
	BUILDING SECTION #A ON SHEET A-1		
	WALL OR DETAIL SECTION #B ON SHEET A-2		
	EXISTING CONSTRUCTION TO REMAIN		
	EXISTING CONSTRUCTION TO BE REMOVED		
	NEW PARTITION CONSTRUCTION		
	NEW MASONRY CONSTRUCTION		

ABBREVIATIONS

A.C.	AIR CONDITIONING	DN	DOWN	IP	IRON PIPE	R.O.B.	RUN OF BANK
A.C.T.	ACOUSTICAL GELING TILE	DO	DITTO, REPEAT, SAME	L.	LENGTH, LONG	R.V.	R-VALUE EQUALS
ACOUNT.	ACOUSTIC	DR	DOOR	LDR.	LEADER	SAN.	SANITARY (SEWER)
ADJ.	ADJACENT	DS	DOWNSPOUT	LAV.	LAVATORY	SCHED.	SCHEDULE
A.F.F.	ABOVE FINISHED FLOOR	DVNS.	DRAWING	L.V.V.	LONG LEG VERTICAL	SECT.	SECTION
AL.	ALTERATE	EA	EACH	MAX.	MAXIMUM	SEP.	SEPARATE
ALUM.	ALUMINUM	ELEC.	ELECTRIC	MECH.	MECHANICAL	S.S.T.	STRUCTURAL GLAZED
ANGLE	ANGLE	E.C.	ELECTRICAL CONTRACTOR	MTL.	METAL	SHT.	SHEET
APPR. EQ.	APPROVED EQUAL	ELEV.	ELEVATION	MANUF.	MANUFACTURER	SIM.	SIMILAR TO
APPROX.	APPROXIMATE	EQUIP.	EQUIPMENT	MIN.	MINIMUM	SPEC.	SPECIFICATION
ARCH.	ARCHITECT	EXIST.	EXISTING	MISC.	MISCELLANEOUS	SPR.	SPRINKLER
ASB.	ASBESTOS	EXH.	EXPOSED	M.O.	MASONRY OPENING	S.S.	SQUARE FEET
A.S.C.	ASBESTOS ABATEMENT	EXP.	EXTERIOR INSULATION & FINISH SYSTEM	MTD.	MOUNTED	S.S.	STAINLESS STEEL
CONTR.	CONTRACTOR	EXT.	EXTERIOR	N.A.	NOT APPLICABLE	STL.	STEEL
ASPH.	ASPHALT	EXT.	EXTERIOR	N.I.C.	NOT IN CONTRACT	STORM.	STORM (SEWER)
AUTO.	AUTOMATIC	EXT.	EXTERIOR	NO. #	NUMBER	STR.	STRUCTURAL
AVG.	AVERAGE	E.N.	EACH WAY	N.T.S.	NOT TO SCALE	SUSP.	SUSPENDED
BD.	BOARD	F.D.	FLOOR DRAIN	O.C.	ON CENTER	STRUC.	STRUCTURAL
BLDG.	BUILDING	F.E.C.	FIRE EXTINGUISHER CABINET	O.D.	OUTSIDE DIAMETER	S.T.L.V.	SHORT LEG VERTICAL
BLK.	BLOCK	F.F.	FINISHED FLOOR	OPNG.	OPENING		
BLK.G.	BLOCKING	FN.	FINISH	OPP.	OPPOSITE		
BOT.	BOTTOM	FX	FIXTURE	O.H.	OVERHEAD		
BRK.	BRICK	FL/FLR.	FLOOR	PART.	PARTITION		
BSMT.	BASEMENT	F.P.	FIREPROOF	P.C.	PLUMBING CONTRACTOR		
B.P.	BEARING PLATE	F.R.P.	FIBERGLASS REINFORCED	P.L.	PLASTER		
C.	COURSE	FT	FOOT, FEET	PLAS.	PLASTIC LAMINATE		
CAB.	CABINET	FTG.	FOOTING	PLMB.	PLUMBING		
CARP.	CARPET	GA.	GAUGE, GAGE	P.L.Y.W.D.	PLYWOOD		
C.B.	CHALKBOARD	GALV.	GALVANIZED	POLY.	POLYETHYLENE		
CEM.	CEMENT	G.C.	GENERAL CONTRACTOR	PRE-FAB.	PREFABRICATED		
C.M.T.	CERAMIC MOSAIC TILE	G.F.I.	GROUND FAULT INTERRUPTER	PREP.	PREPARATION		
C.W.T.	CERAMIC WALL TILE	GL.	GLASS	P.S.I.	POUNDS PER SQUARE INCH		
C.I.	CAST IRON	G.B.	GRAB BAR	P.S.F.	POUNDS PER SQUARE FOOT		
C.J.	CONTROL JOINT	GR.	GRADE	PTD.	PAINTED		
C.L.S.	CEILING	GYP BD. / G.Y.B.	GYPSUM WALLBOARD	P.V.C.	POLYVINYL		
CL.	CHANNEL	H.C.	HVAC CONTRACTOR	R.	RISER		
C.O.	CLEAN-OUT	HDWD.	HARDWOOD	RAD.	RADIUS		
COL.	COLUMN	HDWR.	HARDWARE	R.D.	ROOF DRAIN		
CONC.	CONCRETE	H.M.	HOLLOW METAL	RND.	ROUND		
C.M.U.	CONCRETE MASONRY UNIT	HORIZ.	HORIZONTAL	REF.	REFER TO		
CONN.	CONNECTION	HR.	HOUR	REFRIG.	REFRIGERATOR		
CONST.	CONSTRUCTION	HT.	HEIGHT	REG.	REGISTER		
CONT.	CONTINUOUS	HVAC	HEATING, VENTILATION & AIR CONDITIONING	RENF.	REINFORCE		
CONTR.	CONTRACTOR	H.V.	HOT WATER	REQD.	REQUIRED		
C.O.P.	COUNTER TOP	N.	NCH	RES.	RESULT		
CRS.	COURSES	LD.	LEADER	RET.	RETURN		
DET.	DETAIL	INSUL.	INSULATION	R.F.S.	ROOFING		
D.F.	DRAINING FOUNTAIN	INT.	INTERIOR	RM.	ROOM		
D.I.F.	DIAMETER						
D.M.	DIMENSION						
DISP.	DISPENSER						


DRAWING INDEX

A001	TITLE SHEET
A100	BASEMENT DEMO PLAN
A101	FIRST FLOOR DEMO
A102	SECOND FLOOR DEMO
A103	

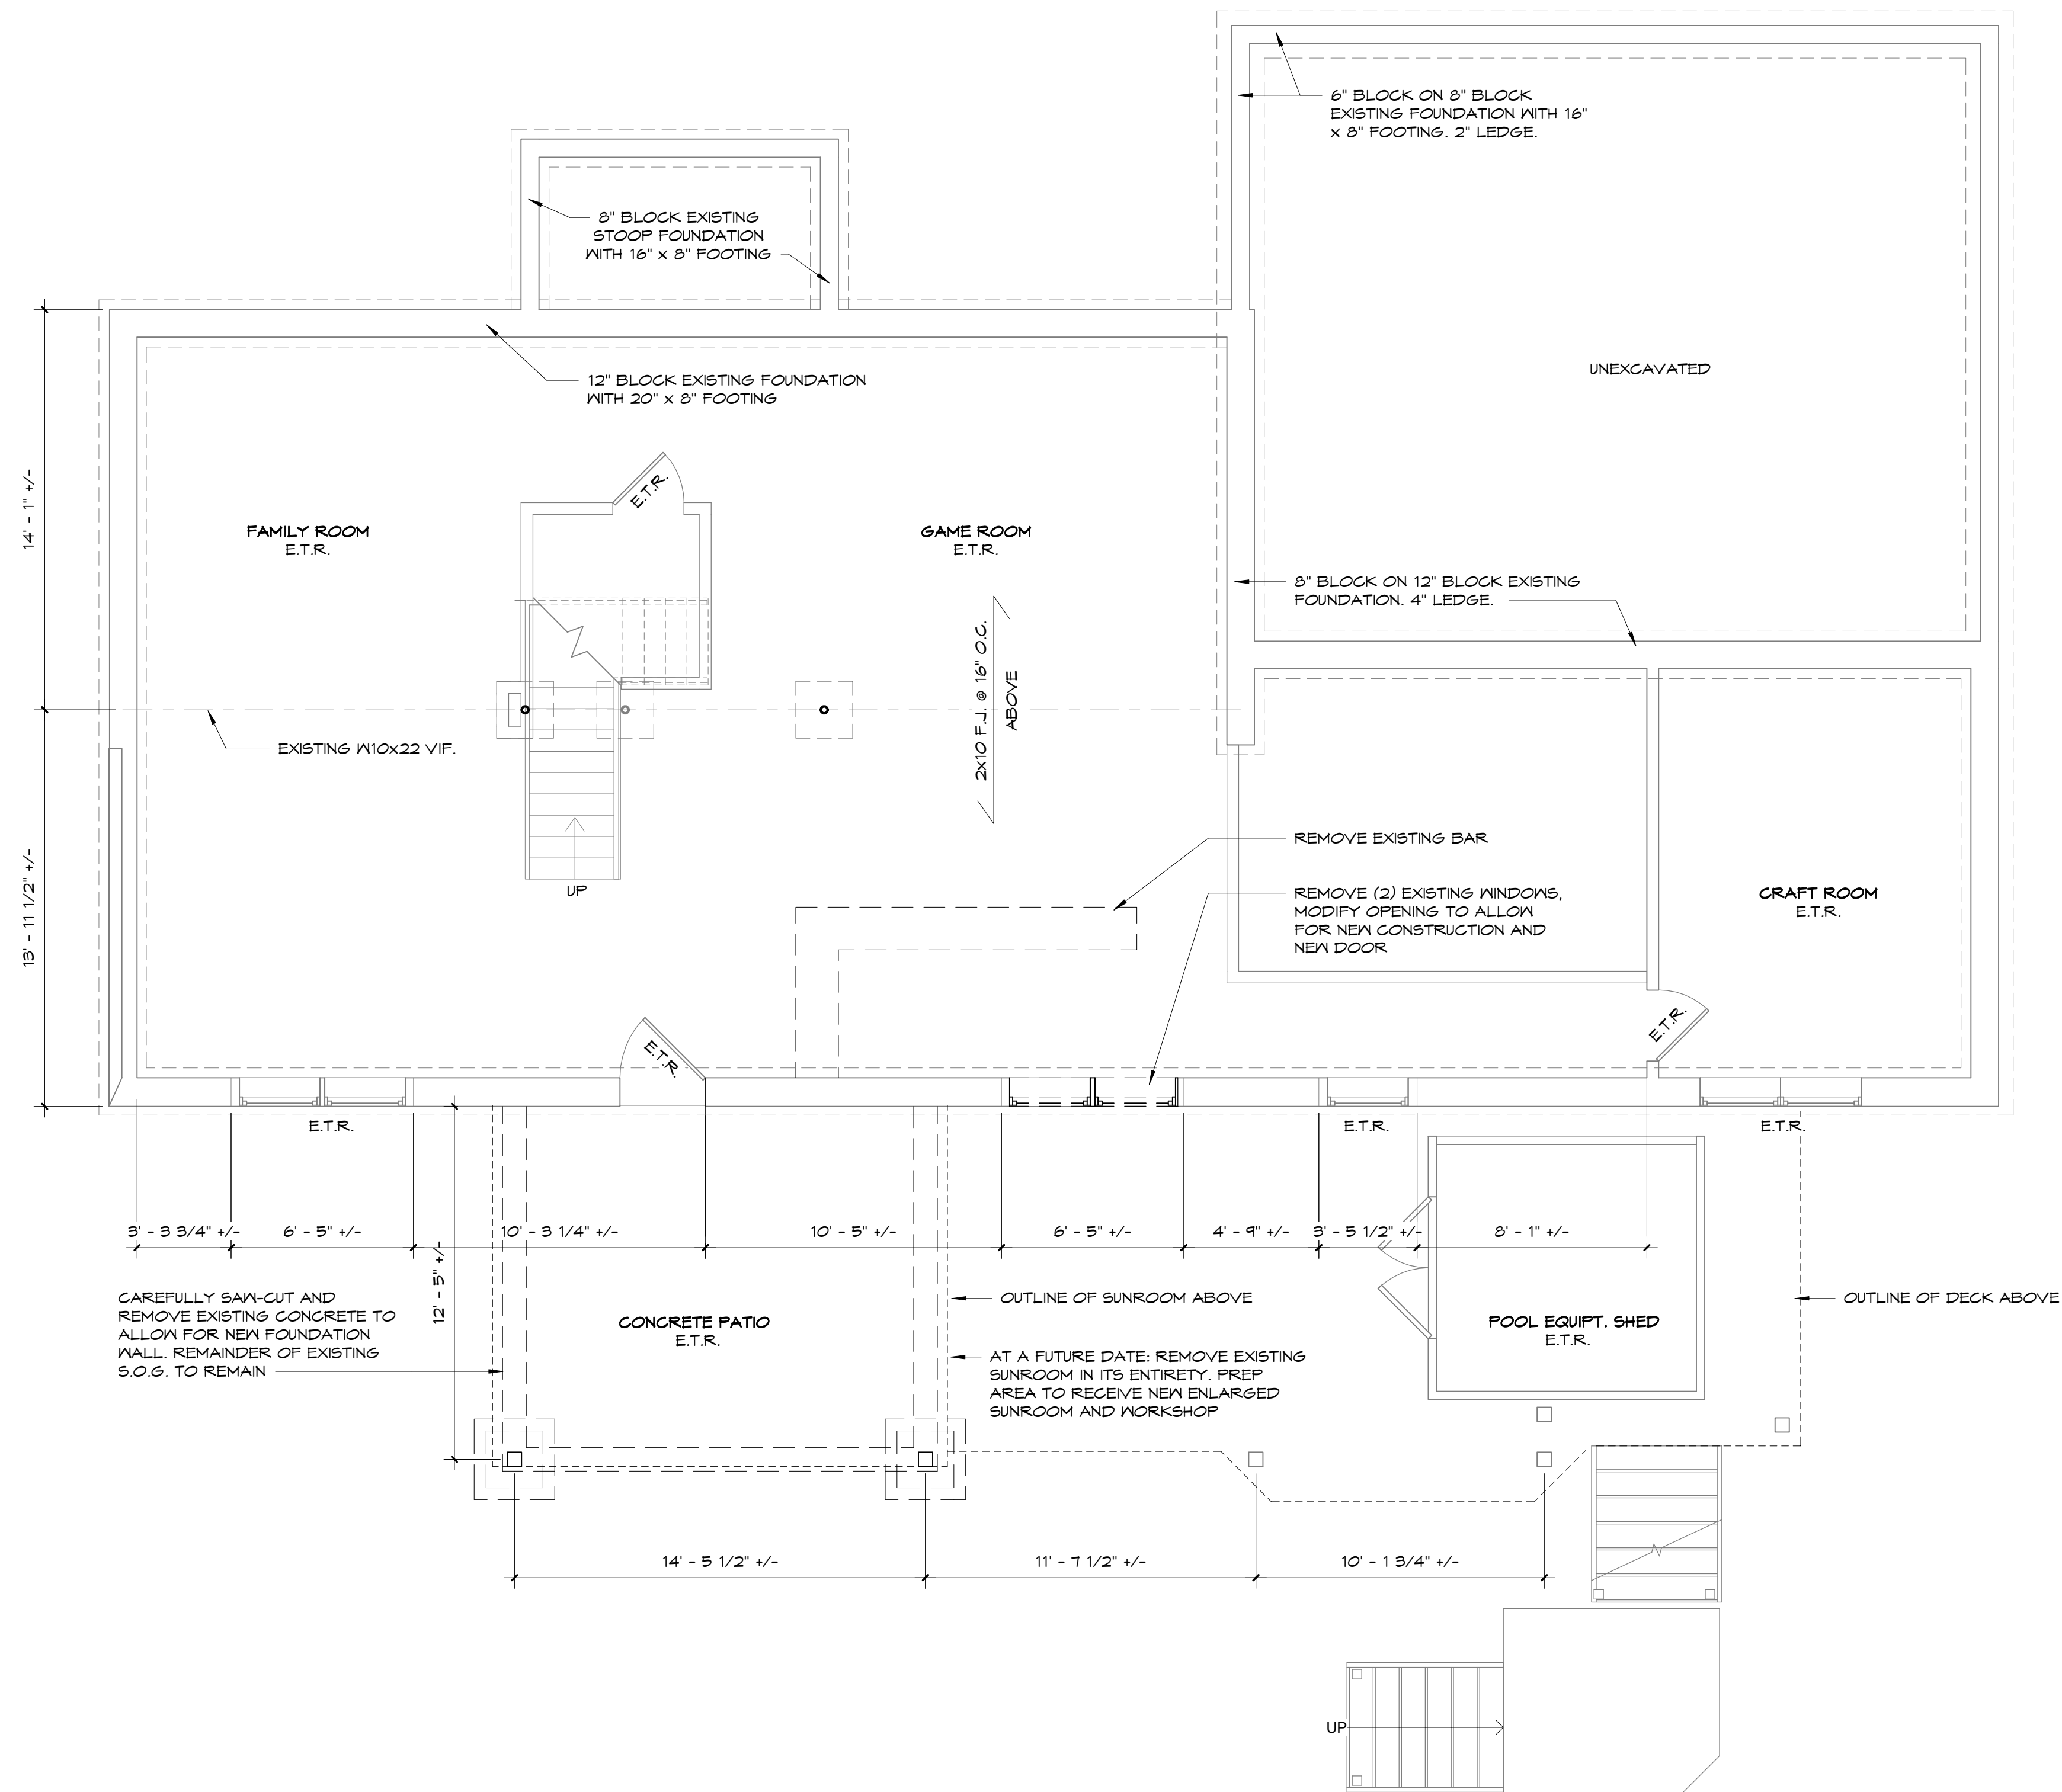

1 BASEMENT DEMOLITION PLAN
 1/4" = 1'-0"

PLAN LEGEND

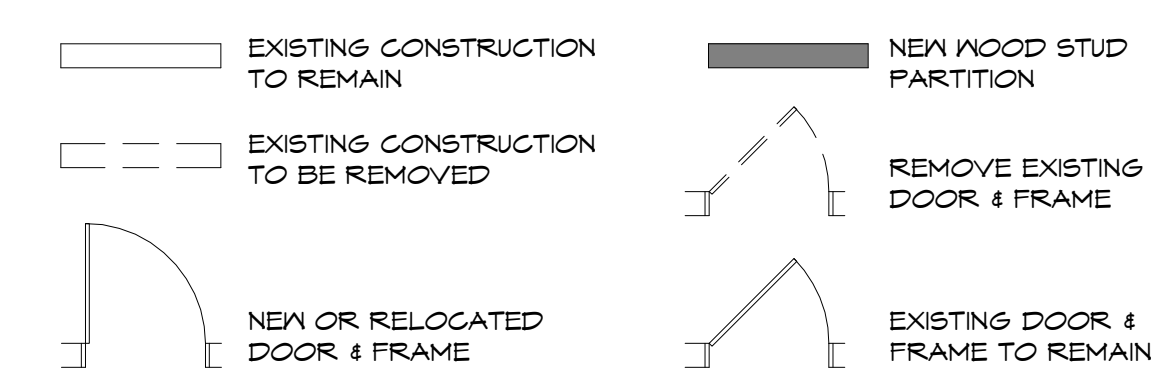

DEMOLITION GENERAL NOTES

- DEMOLITION: CONTRACTOR SHALL REMOVE AND DISPOSE OF EXISTING CONSTRUCTION AS INDICATED ON THE DEMOLITION PLANS AND AS OTHERWISE NEEDED TO PROVIDE THE ALTERATIONS AND ADDITIONS.
- REMOVE DEMOLISHED MATERIALS FROM THE WORK SITE, EXCEPT ITEMS TO BE REUSED OR TURNED OVER TO THE OWNER. DISPOSE OF REMOVED MATERIALS IN A LEGAL MANNER; KEEP THE WORK SITE AND SURROUNDING AREAS CLEANED ON A REGULAR BASIS.
- PROVIDE SHORING AND BRACING FOR ADEQUATE SUPPORT OF EXISTING CONSTRUCTION TO REMAIN PRIOR TO REMOVALS OF ANY STRUCTURE.
- PROVIDE TEMPORARY FENCING OR BARRIERS TO PREVENT THE PUBLIC FROM ACCESS TO THE WORK AREAS AND PROTECT EXISTING CONSTRUCTION. CONTRACTORS SHALL STORE TOOLS AND CONSTRUCTION MATERIALS IN LOCKED AREAS WHEN UNATTENDED BY CONSTRUCTION PERSONNEL.
- PATCH EXISTING FLOORS, CEILING AND WALLS IN AREAS WHERE REMOVALS ADJACENT TO EXISTING CONSTRUCTION TO REMAIN; PATCHING SHALL BE DONE WITH MATERIALS TO MATCH EXISTING ADJACENT.
- REMOVE EXISTING PLUMBING, HVAC AND ELECTRICAL ITEMS WHERE EXISTING CONSTRUCTION IS BEING REMOVED; REMOVE PORTIONS OF SUCH SYSTEMS WHICH WILL NO LONGER BE IN USE.
- MAINTAIN PROTECTION FROM WEATHER DURING DEMOLITION AND CONSTRUCTION TO AVOID DAMAGE TO EXISTING CONSTRUCTION.
- COORDINATION: DEMOLITION WORK WHICH PRODUCES NOISE, DUST, VAPORS, OR DISRUPTION OF UTILITIES, COORDINATE WITH THE OWNER.
- CONFORM TO APPLICABLE STATE AND LOCAL LAWS FOR DISPOSAL OF MATERIALS BEING REMOVED FROM THE SITE.



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REAVEY-CANNON RESIDENCE
 81 KNICKERBOCKER ROAD, PITTSFORD, NY
 FOR: PATRICK REAVEY & LISA CANNON


PROJECT NO.: 186201
 CHECKED BY: SBT/JFT
 DRAWN BY: KAS/SBT
 DATE: 08-12-2021

REVISIONS
 1 JUNE 30, 2022
 STANDING SEAM METAL ROOF, COLORS OF SIDING AND TRIM

ISSUED FOR CONSTRUCTION


SHEET NAME:
BASEMENT DEMO PLAN

SHEET No
A100

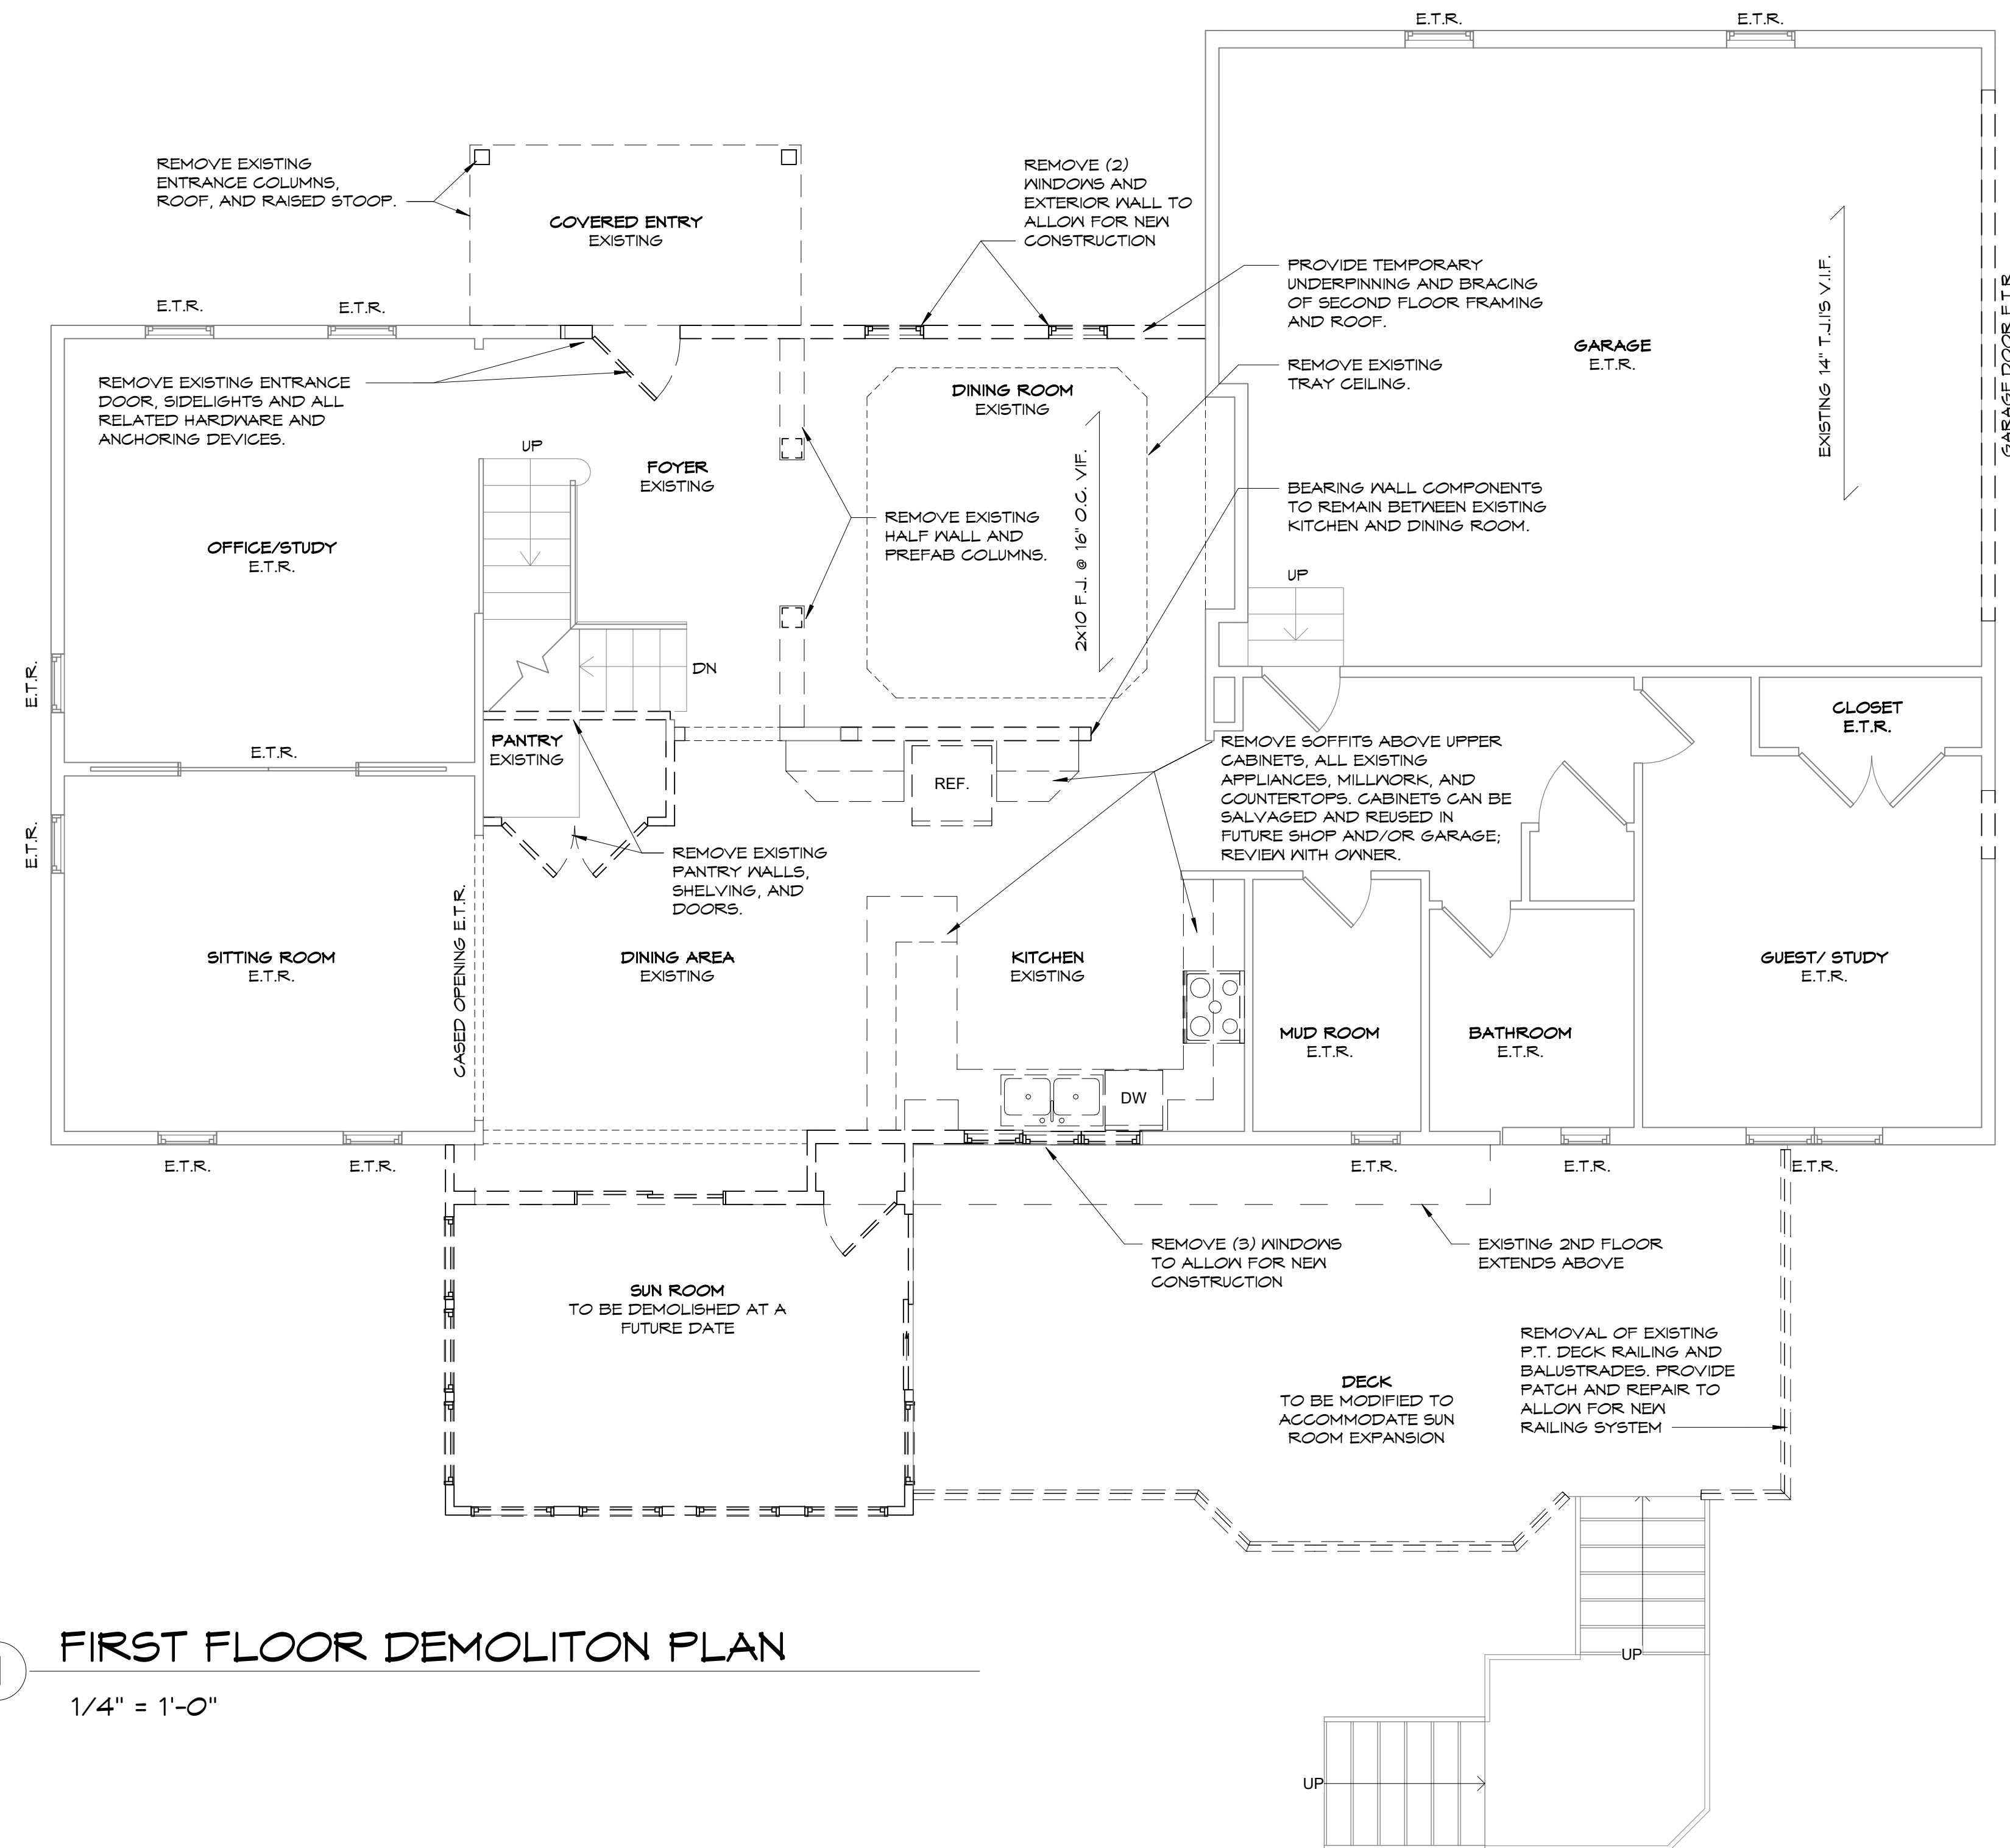

1 FIRST FLOOR DEMOLITION PLAN
1/4" = 1'-0"

PLAN LEGEND

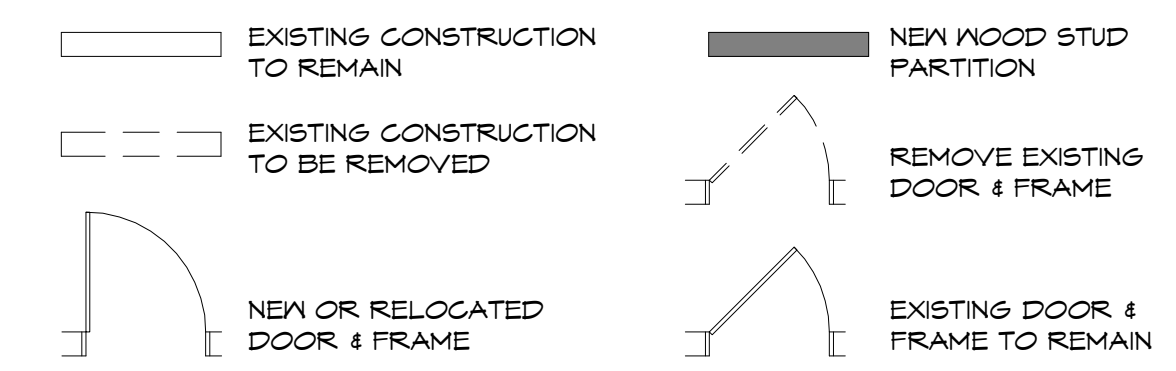

DEMOLITION GENERAL NOTES

- DEMOLITION: CONTRACTOR SHALL REMOVE AND DISPOSE OF EXISTING CONSTRUCTION AS INDICATED ON THE DEMOLITION PLANS AND AS OTHERWISE NEEDED TO PROVIDE THE ALTERATIONS AND ADDITIONS.
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- PROVIDE SHORING AND BRACING FOR ADEQUATE SUPPORT OF EXISTING CONSTRUCTION TO REMAIN PRIOR TO REMOVALS OF ANY STRUCTURE.
- PROVIDE TEMPORARY FENCING OR BARRIERS TO PREVENT THE PUBLIC FROM ACCESS TO THE WORK AREAS AND PROTECT EXISTING CONSTRUCTION. CONTRACTORS SHALL STORE TOOLS AND CONSTRUCTION MATERIALS IN LOCKED AREAS WHEN UNATTENDED BY CONSTRUCTION PERSONNEL.
- PATCH EXISTING FLOORS, CEILINGS AND WALLS IN AREAS WHERE REMOVALS ADJUT EXISTING CONSTRUCTION TO REMAIN; PATCHING SHALL BE DONE WITH MATERIALS TO MATCH EXISTING ADJACENT.
- REMOVE EXISTING PLUMBING, HVAC AND ELECTRICAL ITEMS WHERE EXISTING CONSTRUCTION IS BEING REMOVED; REMOVE PORTIONS OF SUCH SYSTEMS WHICH WILL NO LONGER BE IN USE.
- MAINTAIN PROTECTION FROM WEATHER DURING DEMOLITION AND CONSTRUCTION TO AVOID DAMAGE TO EXISTING CONSTRUCTION.
- COORDINATION: DEMOLITION WORK WHICH PRODUCES NOISE, DUST, VAPORS, OR DISRUPTION OF UTILITIES. COORDINATE WITH THE OWNER; SUCH WORK SHALL BE SCHEDULED DURING DAYTIME HOURS, PER LOCAL NOISE ORDINANCES.
- CONFORM TO APPLICABLE STATE AND LOCAL LAWS FOR DISPOSAL OF MATERIALS BEING REMOVED FROM THE SITE.



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REAVEY-CANNON RESIDENCE
81 KNICKERBOCKER ROAD, PITTSFORD, NY
FOR: PATRICK REAVEY & LISA CANNON


PROJECT NO.: 186201
CHECKED BY: SBT
DRAWN BY: SBT/KAS
DATE: 08-12-2021

REVISIONS
JUNE 30, 2022
STANDING SEAM METAL ROOF, COLORS OF SIDING AND TRIM

ISSUED FOR CONSTRUCTION


SHEET NAME:
FIRST FLOOR DEMO PLAN

SHEET No
A101

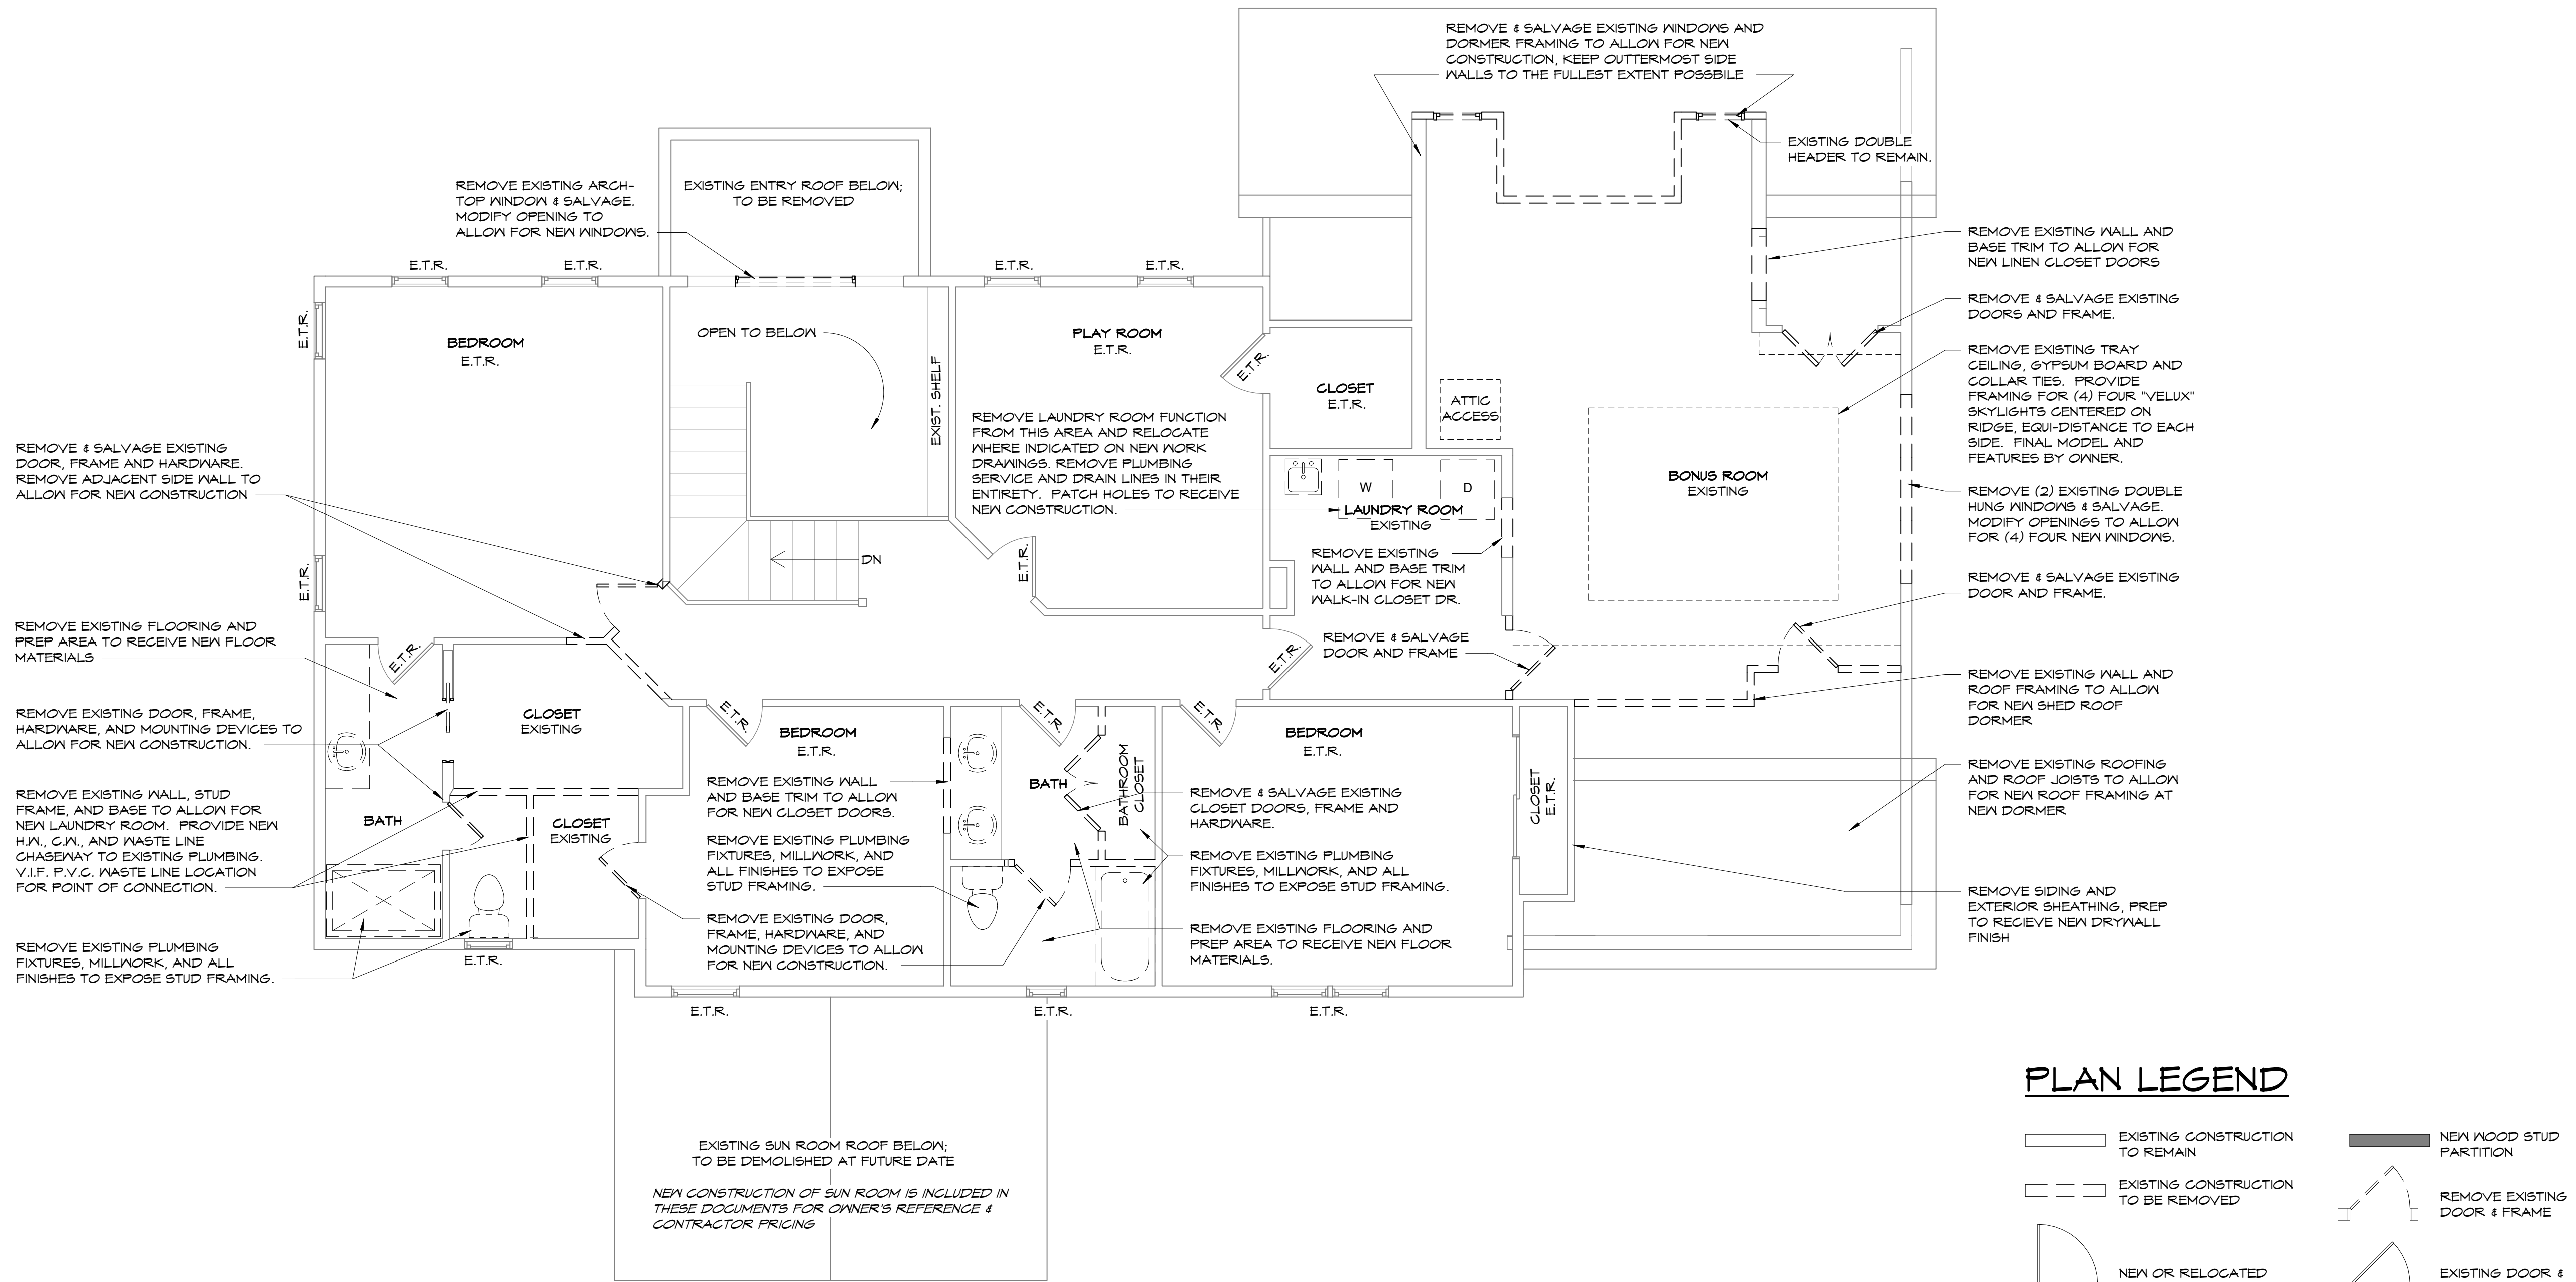

1 SECOND FLOOR DEMOLITION PLAN
 1/4" = 1'-0"

PLAN LEGEND

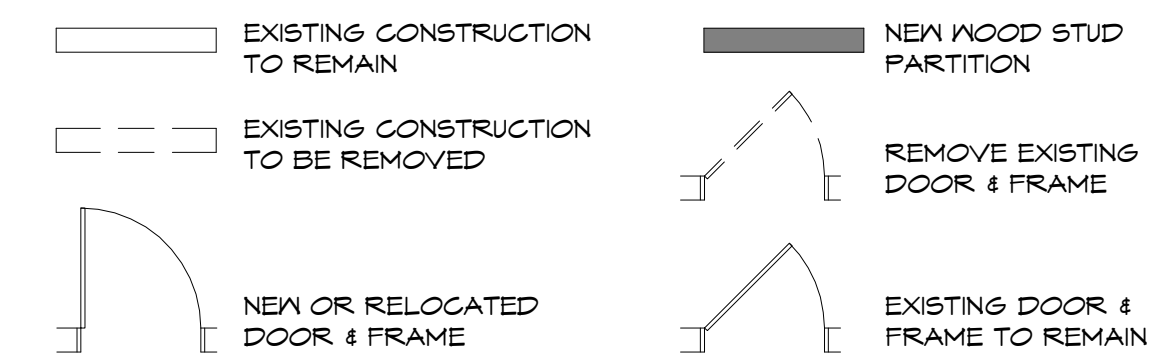

DEMOLITION GENERAL NOTES

- DEMOLITION: CONTRACTOR SHALL REMOVE AND DISPOSE OF EXISTING CONSTRUCTION AS INDICATED ON THE DEMOLITION PLANS AND AS OTHERWISE NEEDED TO PROVIDE THE ALTERATIONS AND ADDITIONS.
- REMOVE DEMOLISHED MATERIALS FROM THE WORK SITE, EXCEPT ITEMS TO BE REUSED OR TURNED OVER TO THE OWNER. DISPOSE OF REMOVED MATERIALS IN A LEGAL MANNER; KEEP THE WORK SITE AND SURROUNDING AREAS CLEANED ON A REGULAR BASIS.
- PROVIDE SHORING AND BRACING FOR ADEQUATE SUPPORT OF EXISTING CONSTRUCTION TO REMAIN PRIOR TO REMOVALS OF ANY STRUCTURE.
- PROVIDE TEMPORARY FENCING OR BARRIERS TO PREVENT THE PUBLIC FROM ACCESS TO THE WORK AREAS AND PROTECT EXISTING CONSTRUCTION. CONTRACTORS SHALL STORE TOOLS AND CONSTRUCTION MATERIALS IN LOCKED AREAS WHEN UNATTENDED BY CONSTRUCTION PERSONNEL.
- PATCH EXISTING FLOORS, CEILINGS AND WALLS IN AREAS WHERE REMOVALS ADJACENT EXISTING CONSTRUCTION TO REMAIN; PATCHING SHALL BE DONE WITH MATERIALS TO MATCH EXISTING ADJACENT.
- REMOVE EXISTING PLUMBING, HVAC AND ELECTRICAL ITEMS WHERE EXISTING CONSTRUCTION IS BEING REMOVED; REMOVE PORTIONS OF SUCH SYSTEMS WHICH WILL NO LONGER BE IN USE.
- MAINTAIN PROTECTION FROM WEATHER DURING DEMOLITION AND CONSTRUCTION TO AVOID DAMAGE TO EXISTING CONSTRUCTION.
- COORDINATION: DEMOLITION WORK WHICH PRODUCES NOISE, DUST, VAPORS, OR DISRUPTION OF UTILITIES, COORDINATE WITH THE OWNER; SUCH WORK SHALL BE SCHEDULED DURING DAYTIME HOURS, PER LOCAL NOISE ORDINANCES.
- CONFORM TO APPLICABLE STATE AND LOCAL LAWS FOR DISPOSAL OF MATERIALS BEING REMOVED FROM THE SITE.



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REAVEY-CANNON RESIDENCE
 81 KNICKERBOCKER ROAD, PITTSFORD, NY
 FOR: PATRICK REAVEY & LISA CANNON

PROJECT NO.: 186201
 CHECKED BY: SBT
 DRAWN BY: SBT/KAS
 DATE: 08-12-2021

REVISIONS
 JUNE 30, 2022
 STANDING SEAM METAL ROOF, COLORS OF SIDING AND TRIM

ISSUED FOR CONSTRUCTION

SHEET NAME:
SECOND FLOOR DEMO PLAN

SHEET No
A102



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REAVEY-CANNON RESIDENCE
 81 KNICKERBOCKER ROAD, PITTSFORD, NY
 FOR: PATRICK REAVEY & LISA CANNON


PROJECT NO.: 186201
 CHECKED BY: SBT
 DRAWN BY: KAS/SBT
 DATE: 08-12-2021

REVISIONS
 1 JUNE 30, 2022
 STANDING SEAM METAL ROOF, COLORS OF SIDING AND TRIM

ISSUED FOR CONSTRUCTION

SHEET NAME:
 BASEMENT/FOUNDATION PLAN

SHEET No
A103

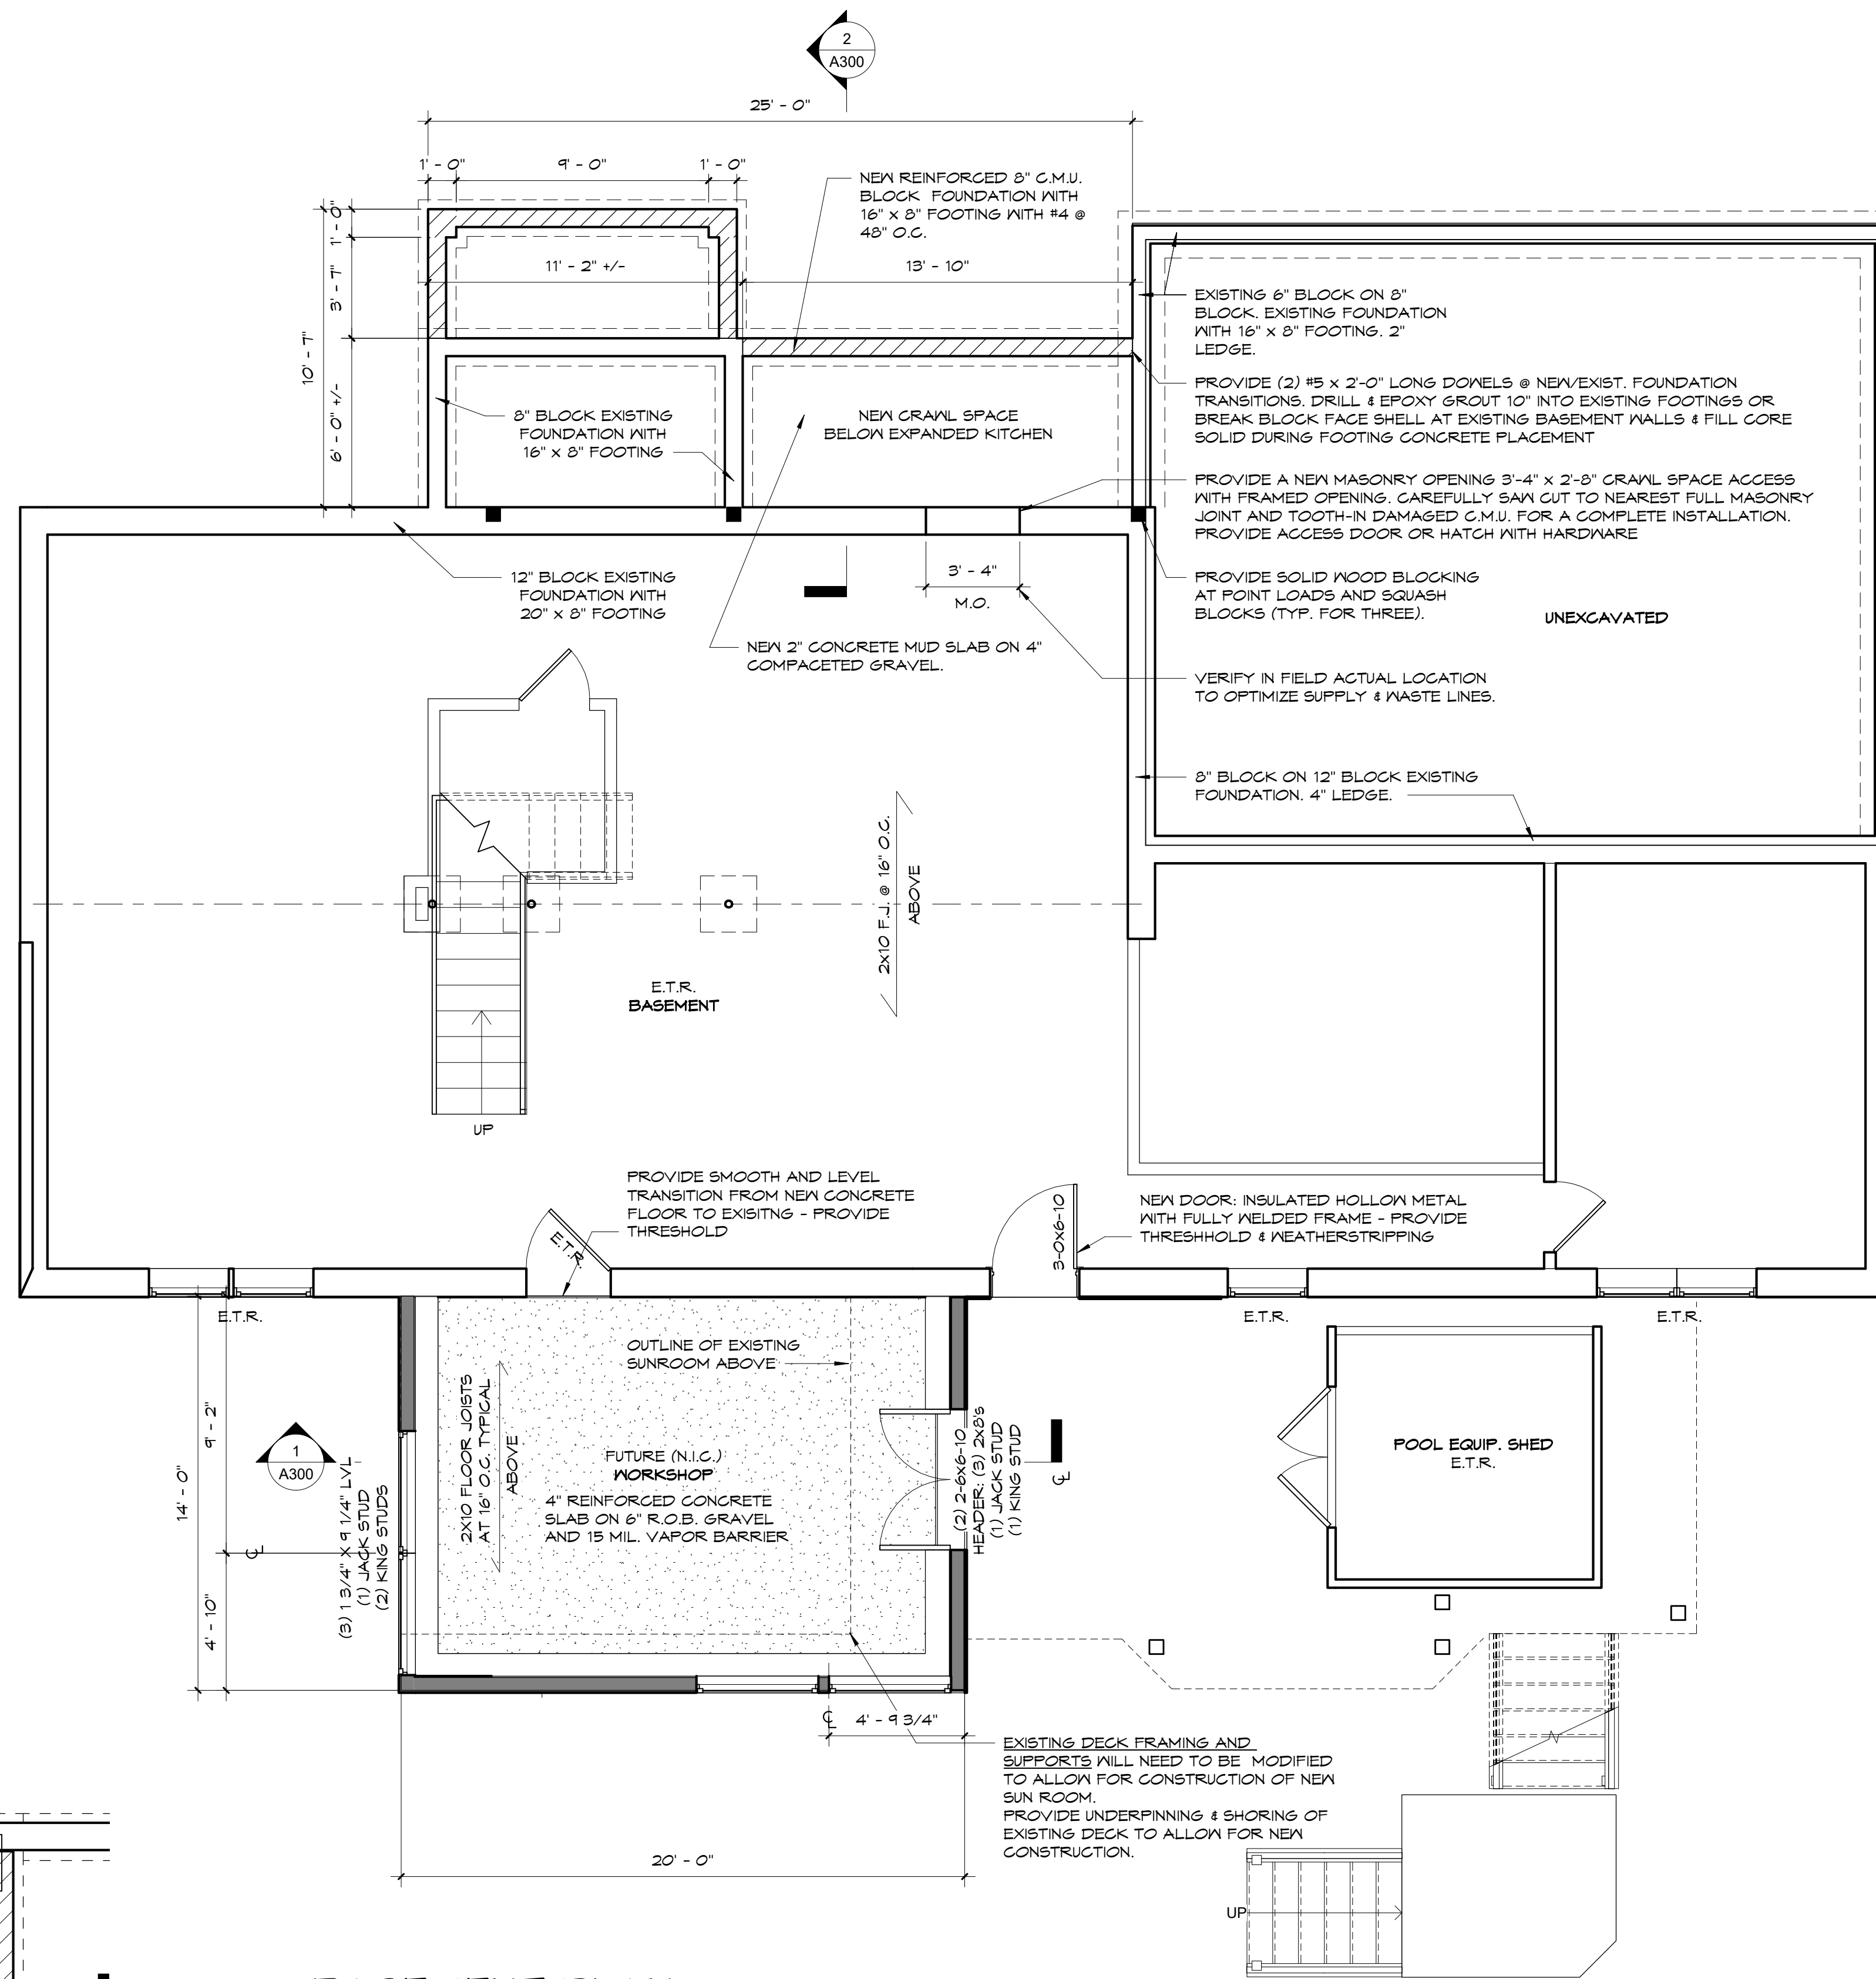

FINISHES GENERAL NOTES

- NEW WALLS TO BE PAINTED WITH ONE COAT PRIMER TWO COATS PAINT FULL HEIGHT; WALL PAINT SHALL BE EGGSHELL FINISH, EXCEPT SATIN FINISH AT BATHROOM WALLS.
- NEW DOOR & WINDOW INTERIOR TRIM SHALL MATCH TYP. EXISTING.
- PROVIDE 1 LAYER OF 5/8" TYPE 'X' THICK GYPSUM BOARD AT ALL NEW CEILINGS AND WALLS; AT PATCHED AREAS OF CEILINGS AND WALLS, PROVIDE GYPSUM BOARD TO MATCH ADJACENT; PAINT ALL CEILINGS WITH ONE COAT PRIMER AND TWO COATS PAINT; CEILINGS SHALL BE PAINTED WITH CEILING WHITE PAINT.
- THE FLOOR, CEILING & WALL FINISHES AT CLOSETS SHALL BE THE SAME AS THE ROOM WHERE THE CLOSETS ARE LOCATED.



FOUNDATION GENERAL NOTES

- CLEAR AND STRIP THE TOPSOIL AT THE BUILDING ADDITION AREA. STOCKPILE TOPSOIL NEEDED FOR LANDSCAPING. REMOVE EXCESS SOILS FROM THE SITE. REMOVAL AREAS THAT RUT, WEAVE, ROLL, OR ARE OTHERWISE DEEMED UNSUITABLE. EXCAVATION FOR THE FOUNDATIONS SHALL BE DONE BY A SHOVEL EQUIPPED WITH A DITCHING BUCKET TO LIMIT DISTURBANCE OF THE SOILS BEARING SURFACE.
- ONLY SITE SOIL THAT IS FREE OF ORGANIC DEBRIS CAN BE USED FOR STRUCTURAL FILL IF APPROVED BY THE ARCHITECT. OTHERWISE, USE IMPORTED GRANULAR MATERIAL SIMILAR IN GRADATION TO N.Y.S.D.O.T. ITEM 304.12 (CRUSHER RUN STONE) FOR STRUCTURAL FILL. PLACE FILL IN 8" MAXIMUM LIFTS COMPACTED TO AT LEAST 95% OF MAXIMUM DRY DENSITY AS DETERMINED BY MODIFIED PROCTOR METHOD, ASTM D-1557. STRUCTURAL FILL IS DEFINED AS ALL NEW FILL UNDER AND AROUND FOUNDATIONS, CONCRETE FLOOR SLABS, AND SIDEWALKS.
- FOOTINGS SHALL BEAR ON UNDISTURBED FIRM EARTH OR NEW COMPACTED STRUCTURAL FILL. THE EXISTING SOILS ARE CALCULATED TO BE MINIMUM 2,500 PSF BEARING CAPACITY. BOTTOM OF FOOTINGS SHALL BE AT 48" MINIMUM BELOW FINISH GRADE. CONTINUOUS CONCRETE FOOTINGS SHALL INCLUDE TWO #5 RE-BAR, LAP BARS 24" MIN. AND PROVIDE CORNER BARS.
- PROVIDE 6" OF GRANULAR MATERIAL, NYSDOT ITEM 304.2 (CRUSHER-RUN STONE), AND 11 MIL VAPOR BARRIER UNDER THE NEW CONCRETE SLAB; THE 11 MIL VAPOR BARRIER SHALL BE "BARRIER-BAG" OR "VAPORBLOCK" OR "STRATA VB-250" VAPOR BARRIER.
- PERFORM TRENCHING AND EXCAVATION IN ACCORDANCE WITH THE OCCUPATIONAL SAFETY AND HEALTH ADMINISTRATION (O.S.H.A.) REQUIREMENTS AND NEW YORK STATE BUILDING CODE STANDARDS. THE CONTRACTOR IS RESPONSIBLE FOR DETERMINING THE MEASURES REQUIRED IN MEETING THESE STANDARDS. CUT UNSUPPORTED TEMPORARY EXCAVATIONS TO A STABLE SLOPE, REMOVE WATER THAT ACCUMULATES IN OPEN EXCAVATIONS USING PUMPS PRIOR TO PROCEEDING WITH FURTHER EXCAVATION OR FOUNDATION CONSTRUCTION WORK.

GENERAL NOTES


- DIMENSIONS ON THE FOUNDATION PLANS ARE GENERALLY TO FACE OF CONCRETE MASONRY; DIMENSIONS ON OTHER FLOOR PLANS ARE TO FACE OF GYPSUM WALL BOARD OR MILLWORK, UNLESS INDICATED OTHERWISE.
- CONTRACTOR SHALL FIELD VERIFY EXISTING DIMENSIONS; REPORT DISCREPANCIES TO THE ARCHITECT PRIOR TO CONTINUING WITH ASSOCIATED PORTIONS OF THE WORK.
- ALL PENETRATIONS, OPENINGS & JOINTS IN SMOKE BARRIERS TO BE IN ACCORDANCE WITH BUILDING CODE OF NEW YORK STATE REQUIREMENTS REGARDING PENETRATIONS THROUGH SMOKE BARRIERS.
- PROVIDE SAFETY GLAZING AT HAZARDOUS LOCATIONS AS DESIGNATED BY SECTION 308.4 OF THE RESIDENTIAL CODE OF NYS, INCLUDING GLAZING IN DOORS AND AT THE WINDOWS IN THE NEW BATHROOM; COORDINATE WITH WINDOW AND DOOR SUPPLIERS REGARDING SAFETY GLAZING REQUIREMENTS.
- EACH NEW BEDROOM CLOSET SHALL INCLUDE A ROD & SHELF; VERIFY WITH OWNER FOR THE HEIGHT ABOVE FLOOR TO INSTALL THE ROD & SHELF.

PLAN LEGEND

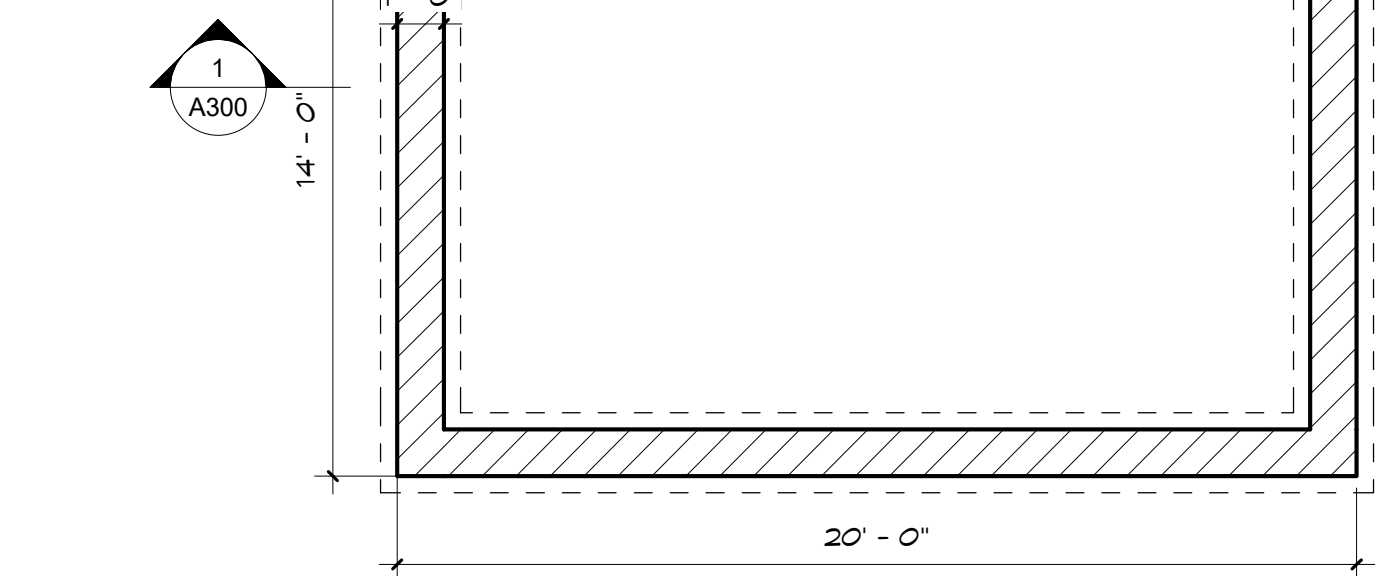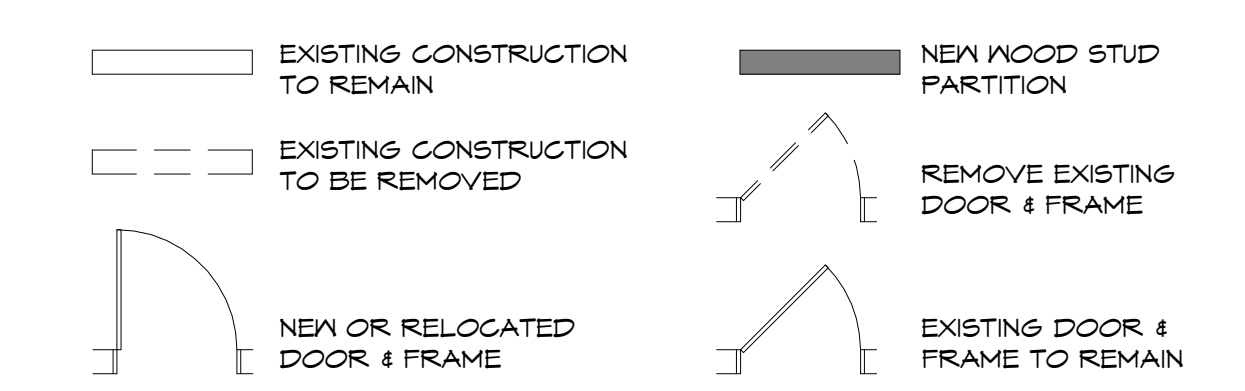


2 FOUNDATION PLAN - WORKSHOP
 1/4" = 1'-0"


1 BASEMENT PLAN
 1/4" = 1'-0"

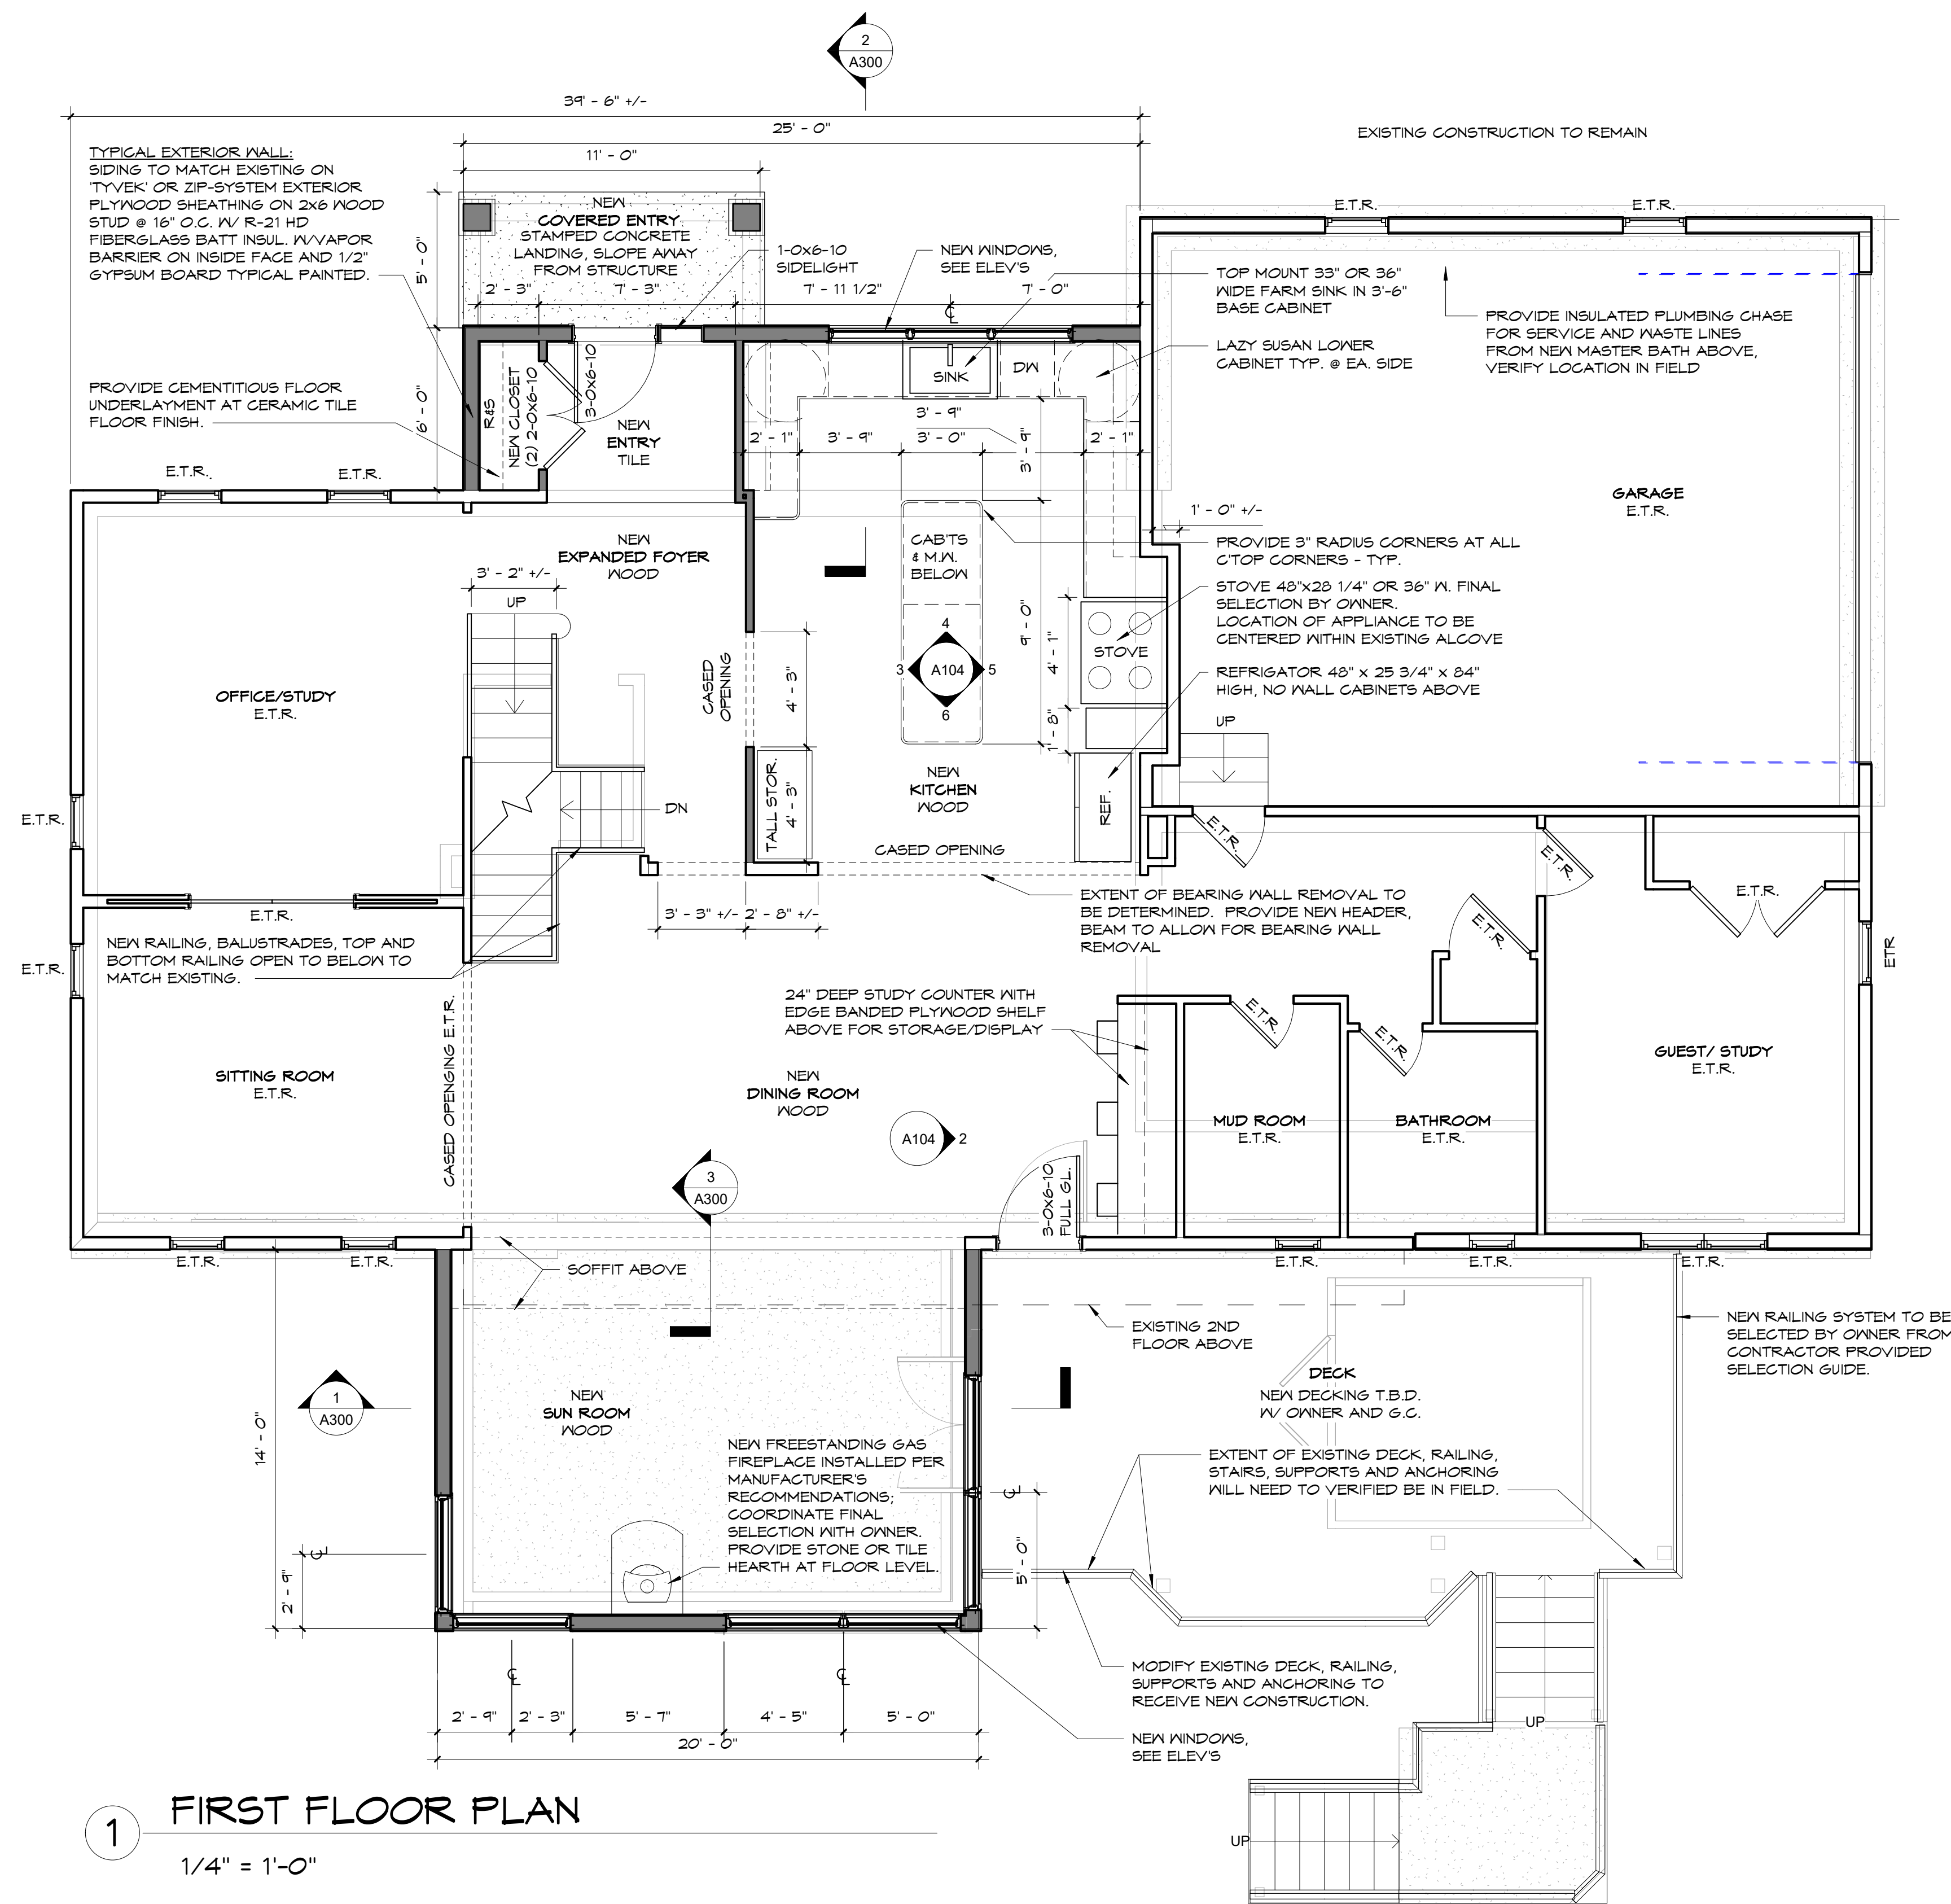


1 FIRST FLOOR PLAN
1/4" = 1'-0"

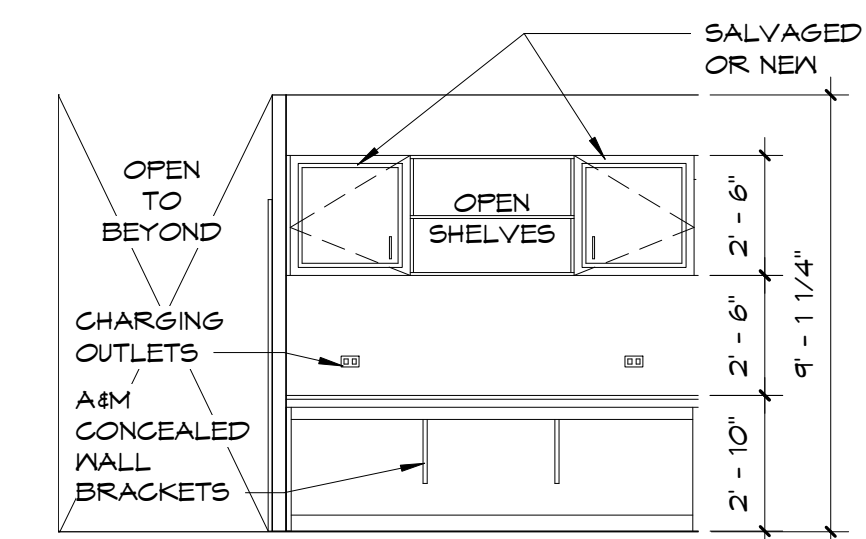


2 STUDY ELEV. 2
1/4" = 1'-0"

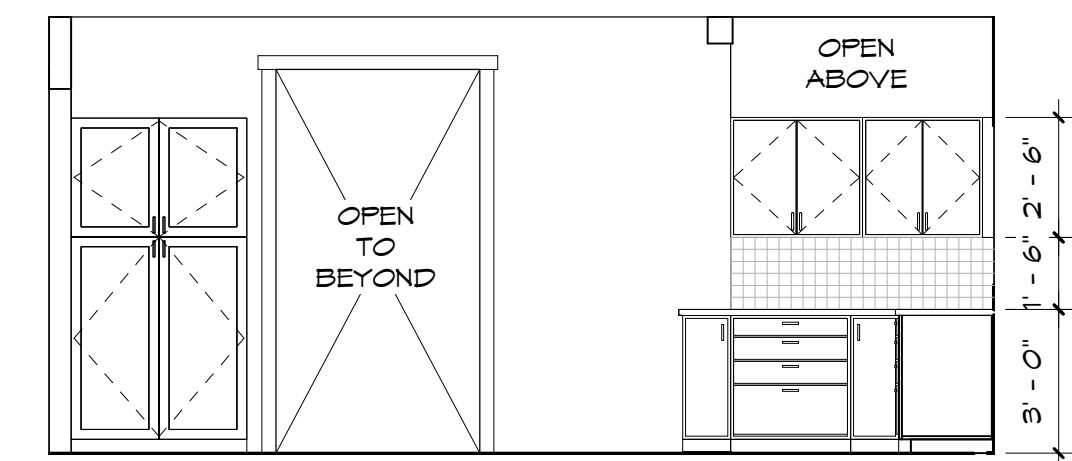


3 KITCH. ELEV. 3
1/4" = 1'-0"

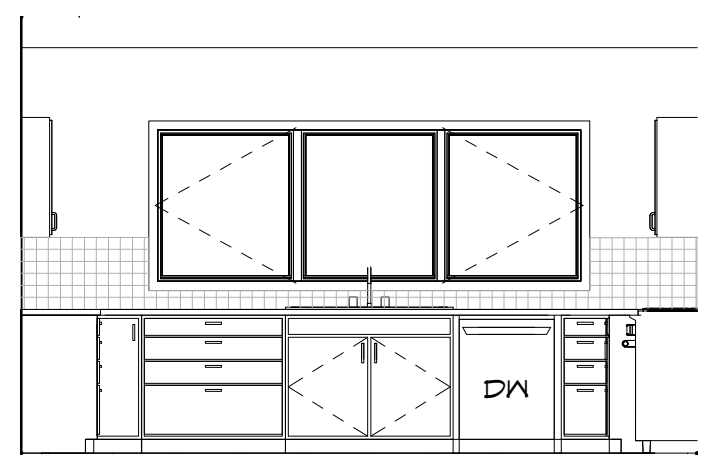


4 KITCH. ELEV. 4
1/4" = 1'-0"

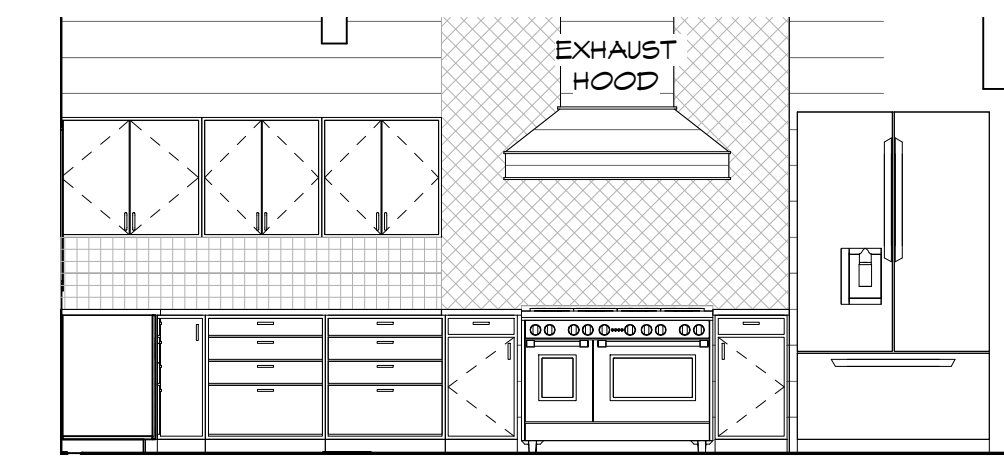

5 KITCH. ELEV. 5
1/4" = 1'-0"

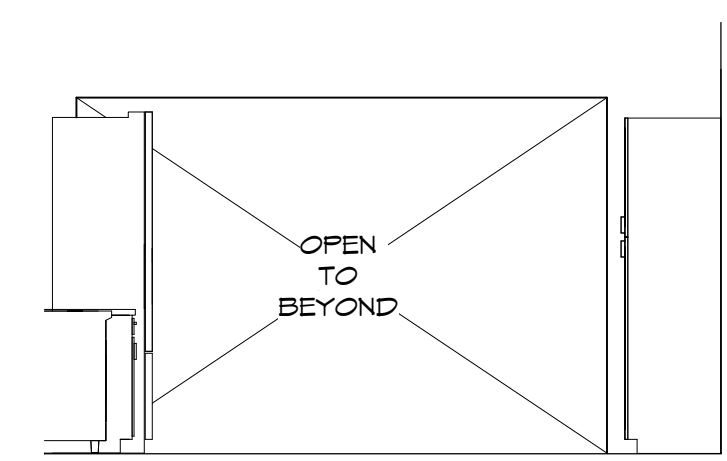

6 KITCH. ELEV. 6
1/4" = 1'-0"

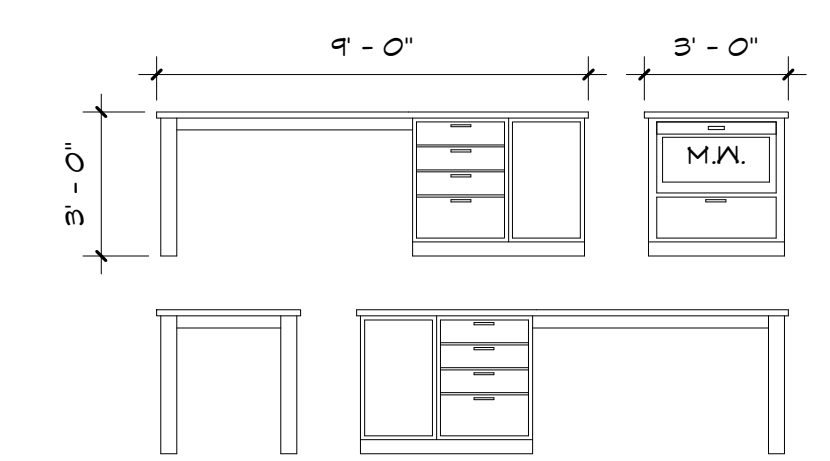

7 KITCHEN ISLAND
1/4" = 1'-0"


FINISHES GENERAL NOTES

1. NEW WALLS TO BE PAINTED WITH ONE COAT PRIMER TWO COATS PAINT FULL HEIGHT; WALL PAINT SHALL BE EGGSHELL FINISH, EXCEPT SATIN FINISH AT BATHROOM WALLS.
2. NEW DOOR & WINDOW INTERIOR TRIM SHALL MATCH TYP. EXISTING - U.N.O.
3. PROVIDE 1 LAYER OF 5/8" TYPE 'X' THICK GYPSUM BOARD AT ALL NEW CEILINGS AND WALLS; AT PATCHED AREAS OF CEILINGS AND WALLS, PROVIDE GYPSUM BOARD TO MATCH ADJACENT; PAINT ALL CEILINGS WITH ONE COAT PRIMER AND TWO COATS PAINT; CEILINGS SHALL BE PAINTED WITH CEILING WHITE PAINT.
4. THE FLOOR, CEILING & WALL FINISHES AT CLOSETS SHALL BE THE SAME AS THE ROOM WHERE THE CLOSETS ARE LOCATED.

GENERAL NOTES

1. DIMENSIONS ON THE FOUNDATION PLANS ARE GENERALLY TO FACE OF CONCRETE MASONRY; DIMENSIONS ON OTHER FLOOR PLANS ARE TO FACE OF GYPSUM WALL BOARD OR MILLWORK, UNLESS INDICATED OTHERWISE.
2. CONTRACTOR SHALL FIELD VERIFY EXISTING DIMENSIONS; REPORT DISCREPANCIES TO THE ARCHITECT PRIOR TO CONTINUING WITH ASSOCIATED PORTIONS OF THE WORK.
3. ALL PENETRATIONS, OPENINGS & JOINTS IN SMOKE BARRIERS TO BE IN ACCORDANCE WITH BUILDING CODE OF NEW YORK STATE REQUIREMENTS REGARDING PENETRATIONS THROUGH SMOKE BARRIERS.
4. PROVIDE SAFETY GLAZING AT HAZARDOUS LOCATIONS AS DESIGNATED BY SECTION 303.4 OF THE RESIDENTIAL CODE OF NYS, INCLUDING GLAZING IN DOORS AND AT THE WINDOWS IN THE NEW BATHROOM; COORDINATE WITH WINDOW AND DOOR SUPPLIERS REGARDING SAFETY GLAZING REQUIREMENTS.
5. EACH NEW BEDROOM CLOSET SHALL INCLUDE A ROD & SHELF; VERIFY WITH OWNER FOR THE HEIGHT ABOVE FLOOR TO INSTALL THE ROD & SHELF.

PLAN LEGEND

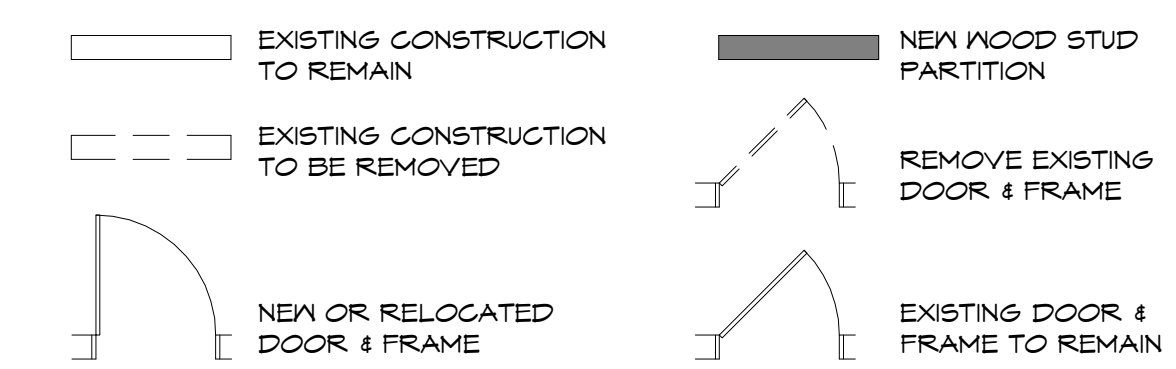

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REAVEY-CANNON RESIDENCE
81 KNICKERBOCKER ROAD, PITTSFORD, NY
FOR: PATRICK REAVEY & LISA CANNON

PROJECT NO.: 186201
CHECKED BY: SBT
DRAWN BY: SBT/KAS
DATE: 08-12-2021

REVISIONS
JUNE 30, 2022
STANDING SEAM METAL ROOF, COLORS OF SIDING AND TRIM

ISSUED FOR CONSTRUCTION

SHEET NAME:
FIRST FLOOR PLAN

SHEET NO

A104



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 81 KNICKERBOCKER ROAD, PITTSFORD, NY
 FOR: PATRICK REAVEY & LISA CANNON

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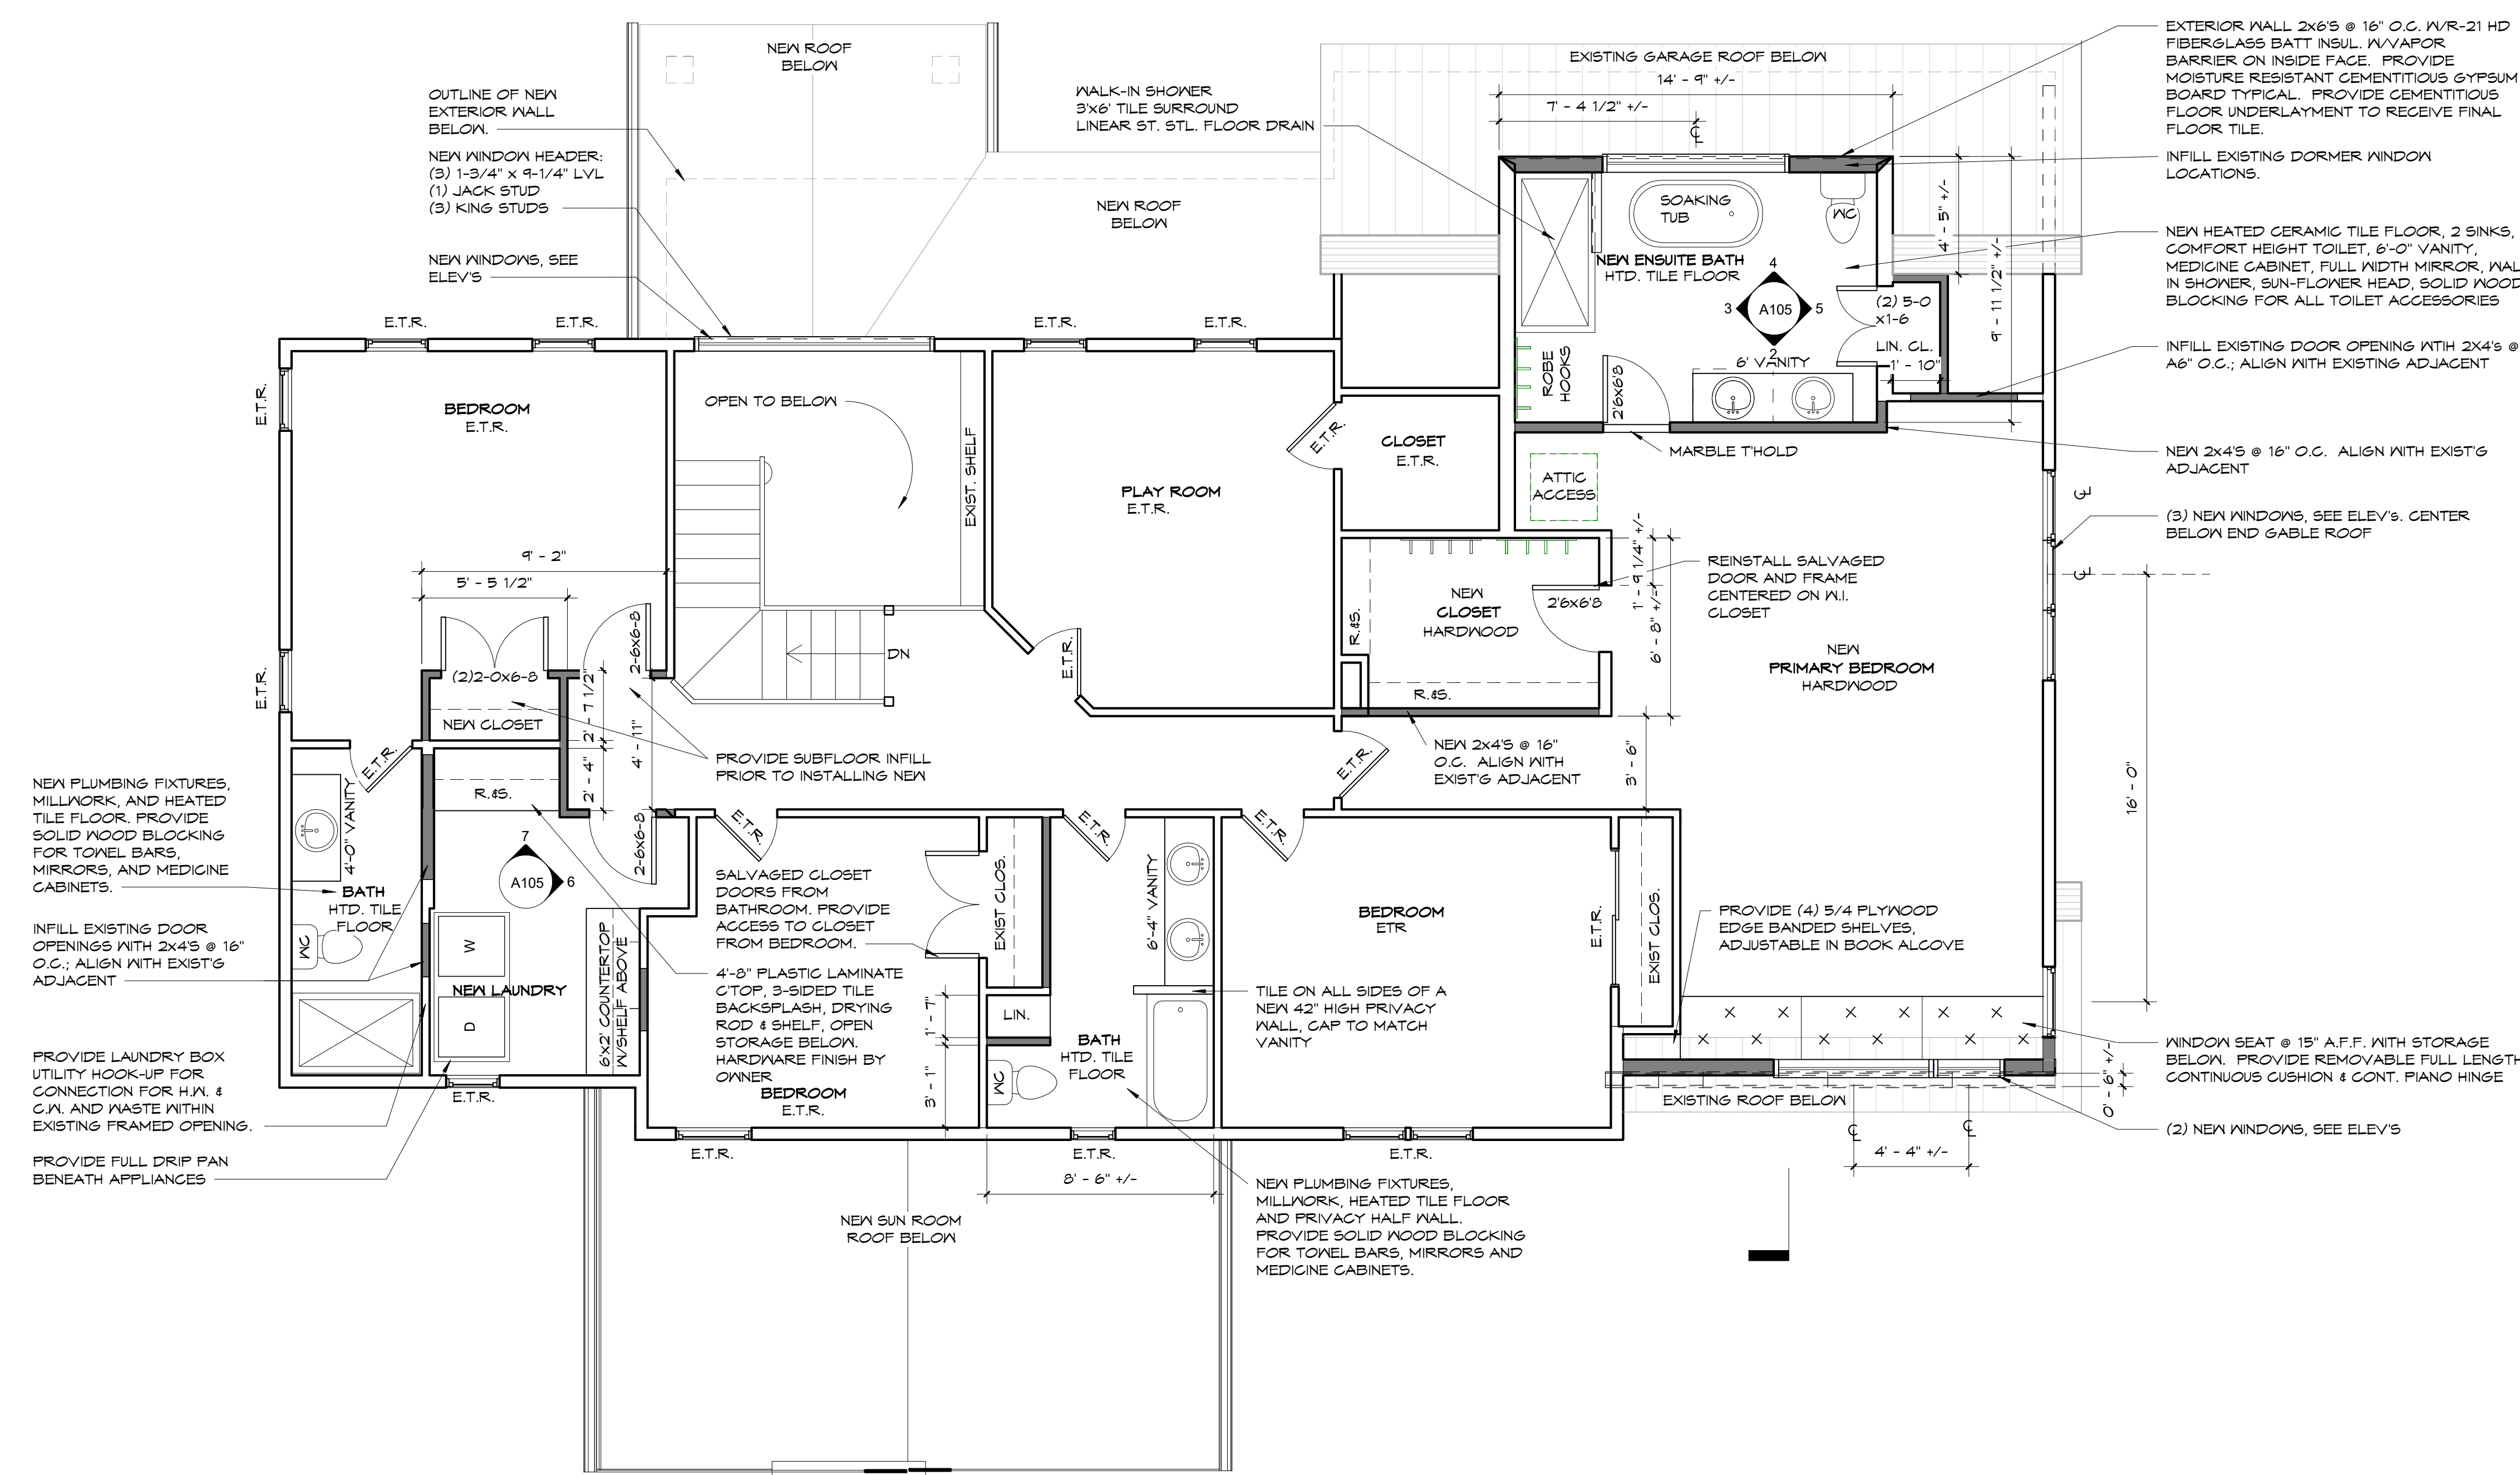
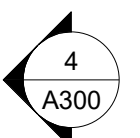
REVISIONS
 1 JUNE 30, 2022
 STANDING SEAM METAL ROOF, COLORS OF SIDING AND TRIM

ISSUED FOR CONSTRUCTION

SHEET NAME:
SECOND FLOOR PLAN

SHEET No

A105




FINISHES GENERAL NOTES

1. NEW WALLS TO BE PAINTED WITH ONE COAT PRIMER TWO COATS PAINT FULL HEIGHT; WALL PAINT SHALL BE EGGSHELL FINISH, EXCEPT SATIN FINISH AT BATHROOM WALLS.
2. NEW DOOR & WINDOW INTERIOR TRIM SHALL MATCH TYP. EXISTING.
3. PROVIDE 1 LAYER OF 5/8" TYPE 'X' THICK GYPSUM BOARD AT ALL NEW CEILINGS AND WALLS; AT PATCHED AREAS OF CEILINGS AND WALLS, PROVIDE GYPSUM BOARD TO MATCH ADJACENT; PAINT ALL CEILINGS WITH ONE COAT PRIMER AND TWO COATS PAINT; CEILINGS SHALL BE PAINTED WITH CEILING WHITE PAINT.
4. THE FLOOR, CEILING & WALL FINISHES AT CLOSETS SHALL BE THE SAME AS THE ROOM WHERE THE CLOSETS ARE LOCATED.

GENERAL NOTES


1. DIMENSIONS ON THE FOUNDATION PLANS ARE GENERALLY TO FACE OF CONCRETE MASONRY; DIMENSIONS ON OTHER FLOOR PLANS ARE TO FACE OF GYPSUM WALL BOARD OR MILLWORK, UNLESS INDICATED OTHERWISE.
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3. ALL PENETRATIONS, OPENINGS & JOINTS IN SMOKE BARRIERS TO BE IN ACCORDANCE WITH BUILDING CODE OF NEW YORK STATE REQUIREMENTS REGARDING PENETRATIONS THROUGH SMOKE BARRIERS.
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5. EACH NEW BEDROOM CLOSET SHALL INCLUDE A ROD & SHELF; VERIFY WITH OWNER FOR THE HEIGHT ABOVE FLOOR TO INSTALL THE ROD & SHELF.

PLAN LEGEND

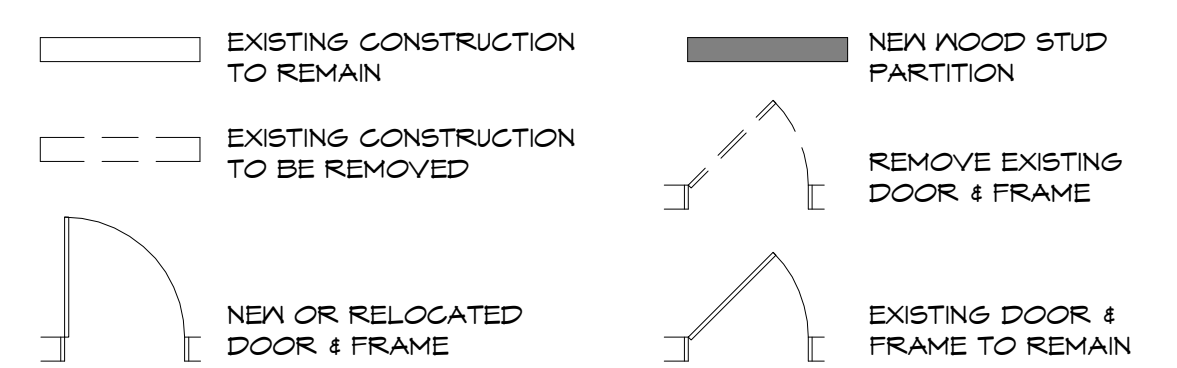


1 SECOND FLOOR PLAN


1/4" = 1'-0"

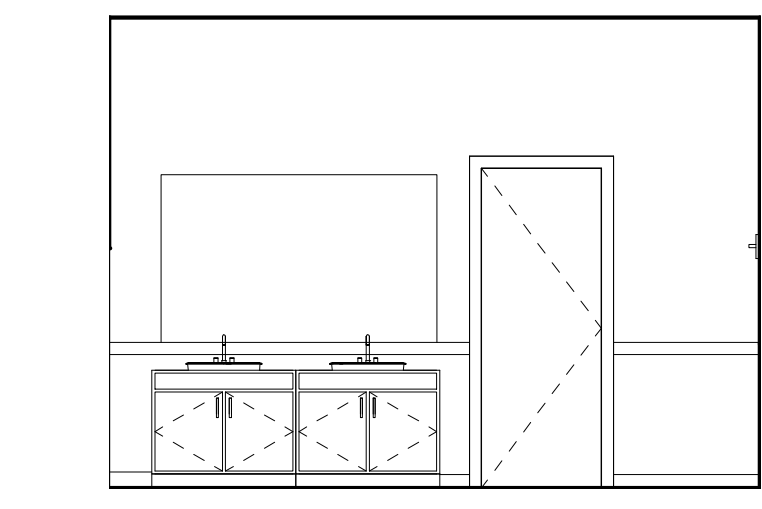


2 ENSUITE ELEV. 2
1/4" = 1'-0"

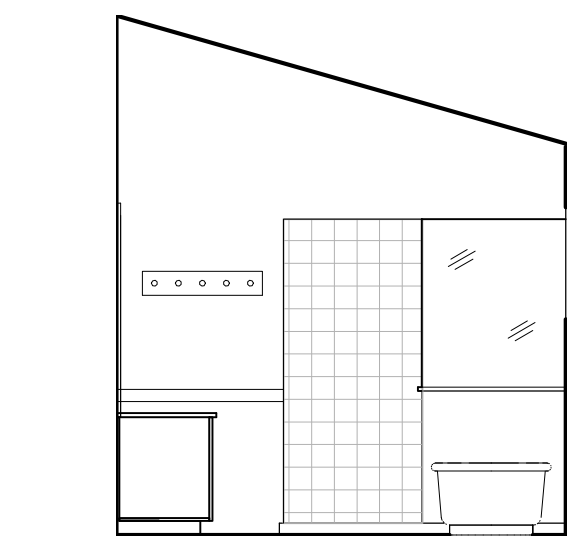


3 ENSUITE ELEV. 3
1/4" = 1'-0"

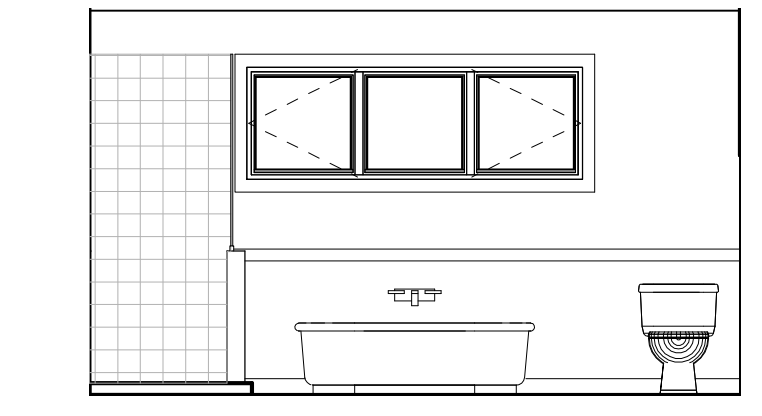


4 ENSUITE ELEV. 4
1/4" = 1'-0"

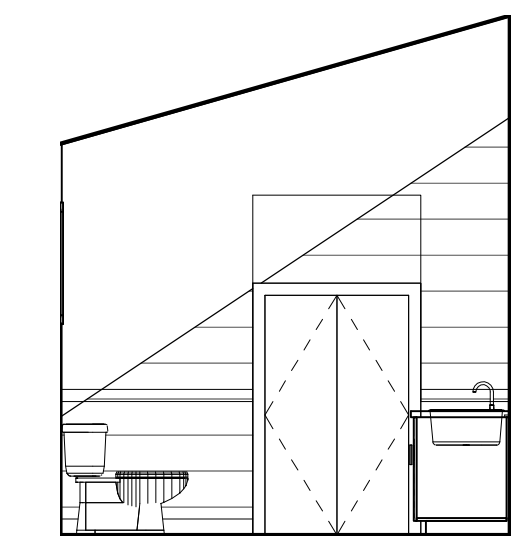


5 ENSUITE ELEV. 5
1/4" = 1'-0"

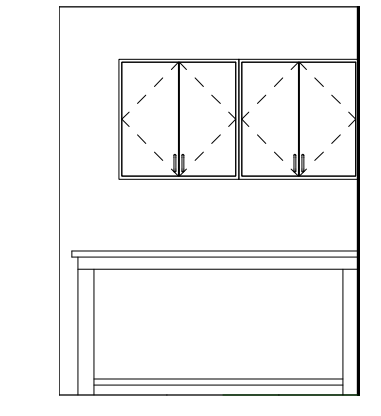

6 LAUND. ELEV. 6
1/4" = 1'-0"

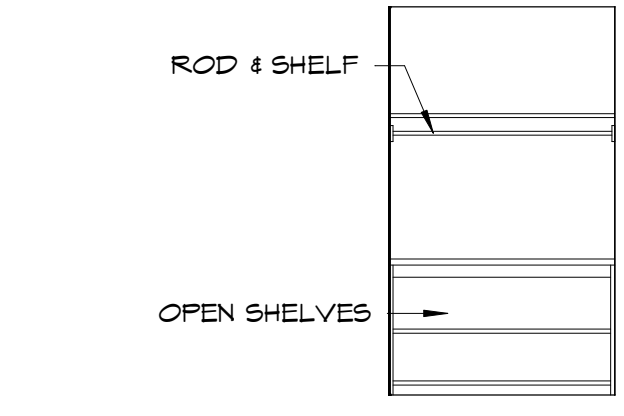

7 LAUND. ELEV. 7
1/4" = 1'-0"

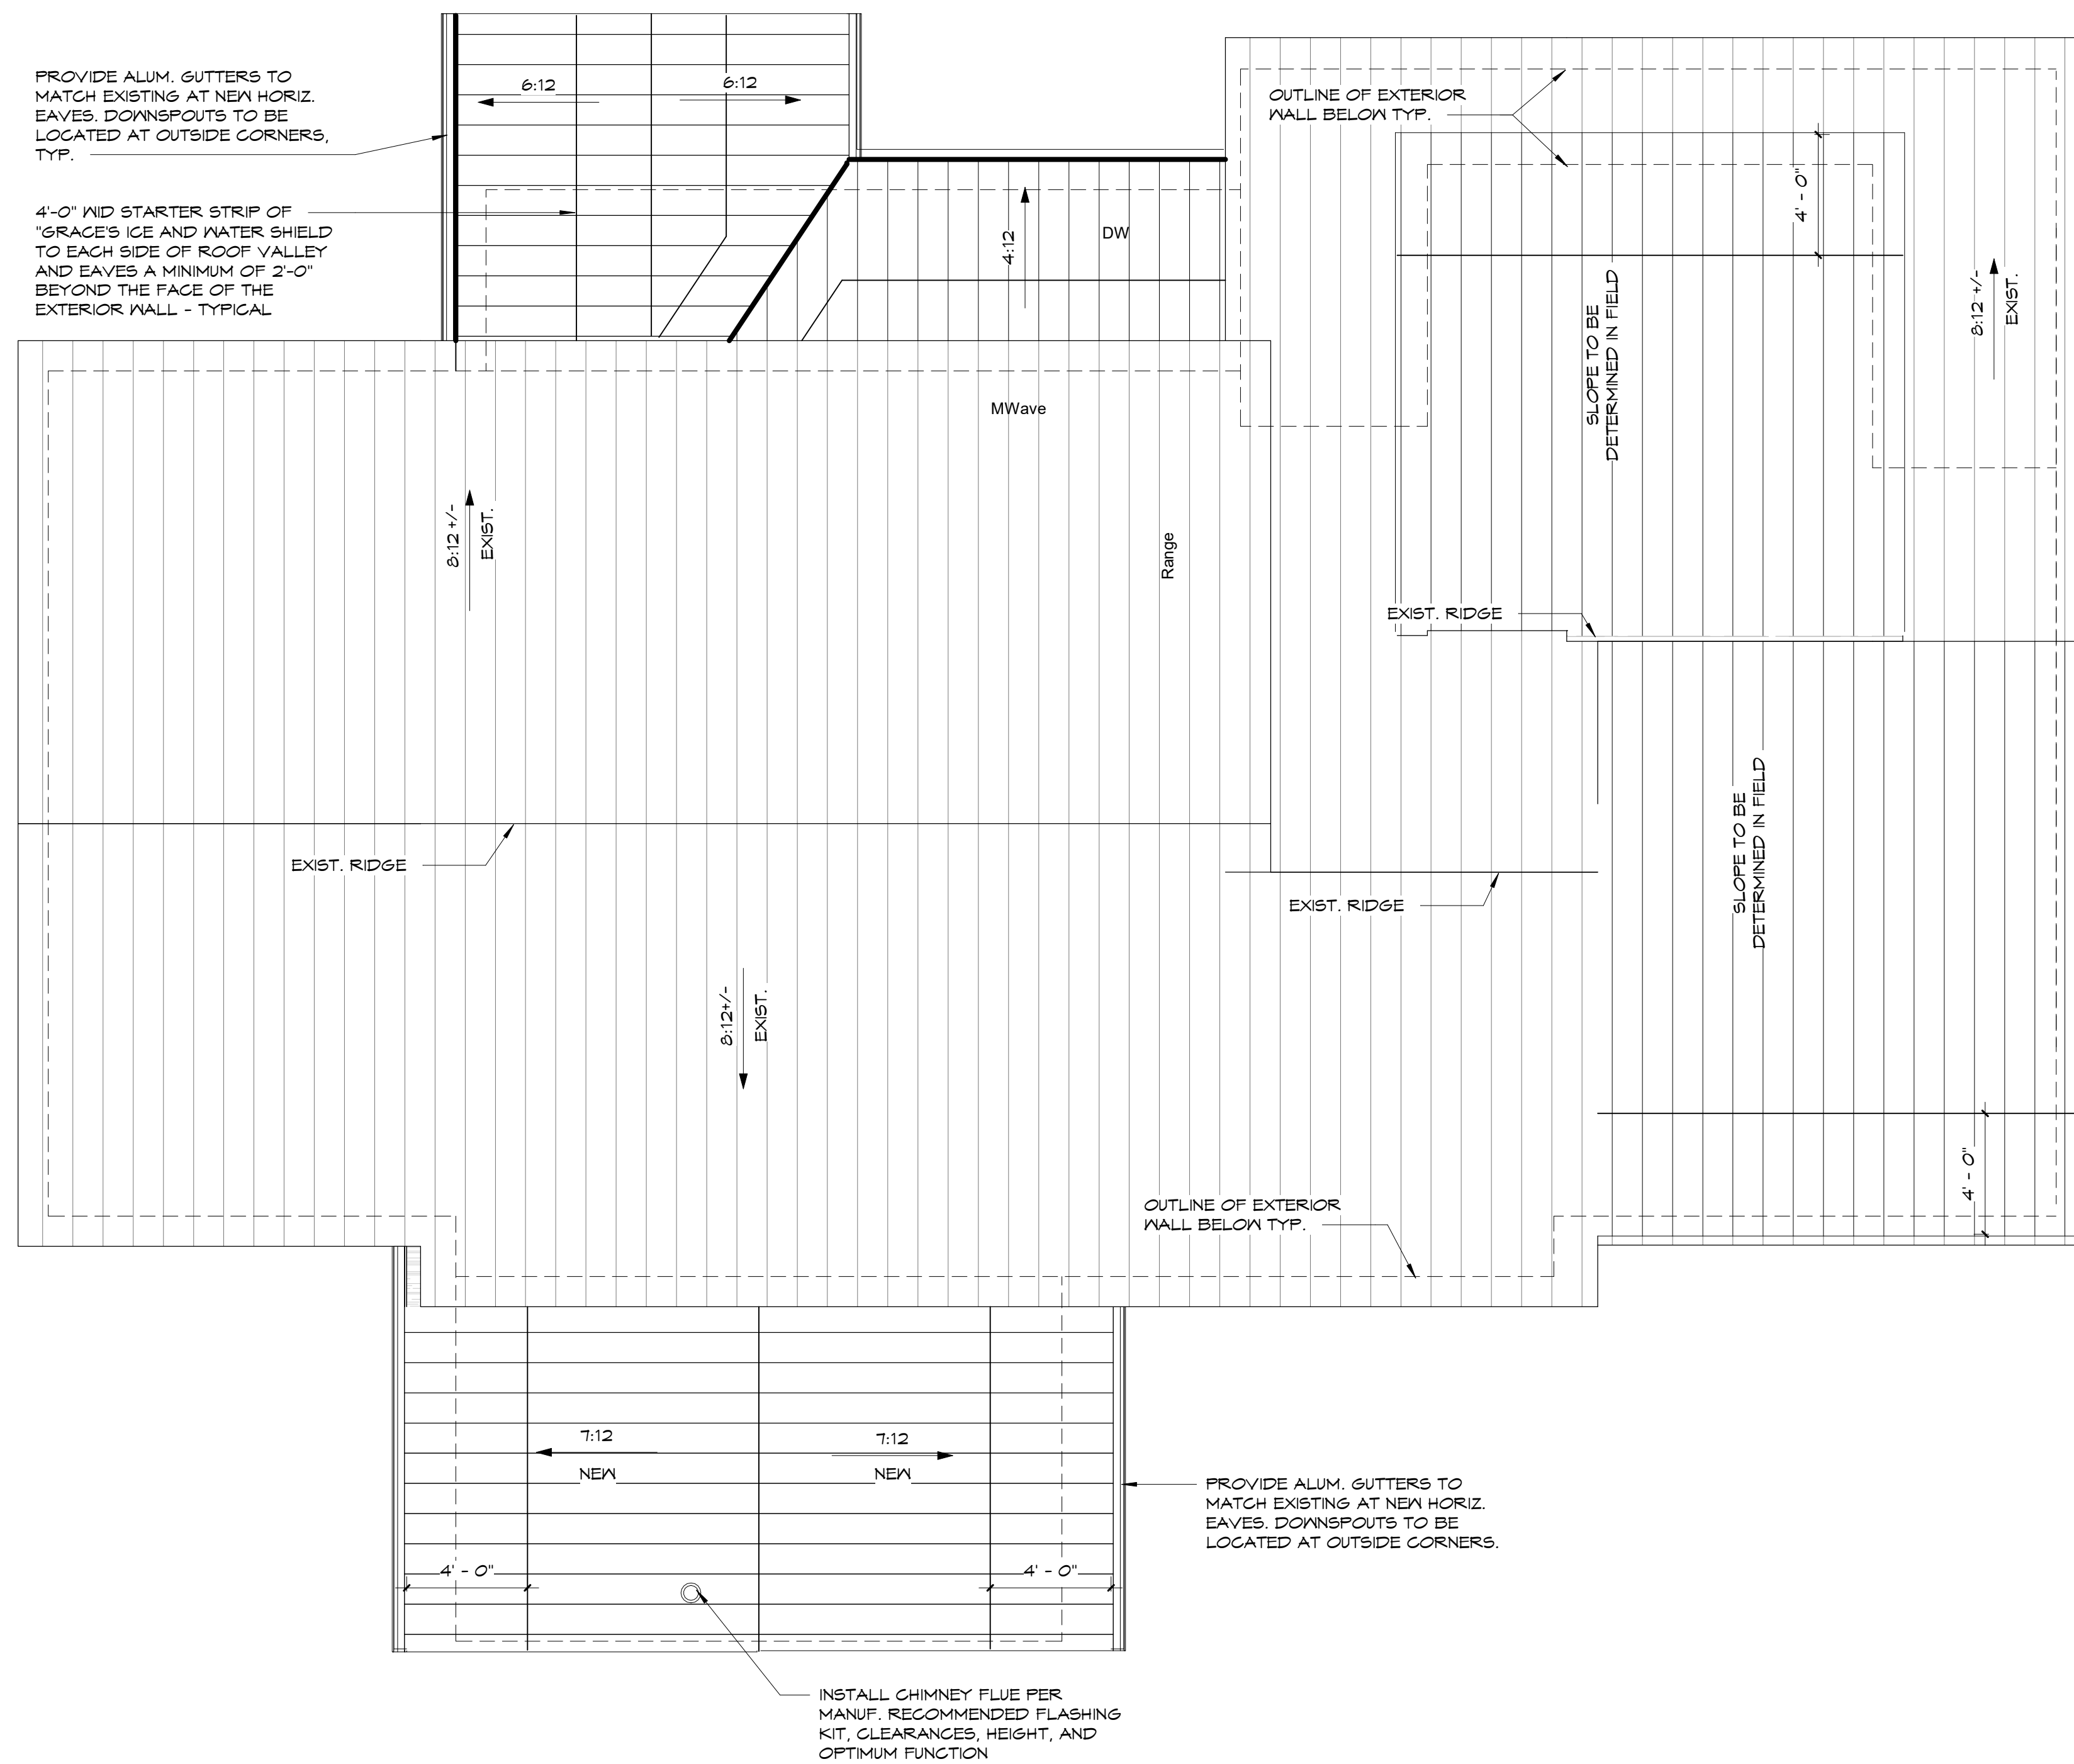

PROVIDE ALUM. GUTTERS TO MATCH EXISTING AT NEW HORIZ. EAVES. DOWNSPOUTS TO BE LOCATED AT OUTSIDE CORNERS, TYP.

4'-0" WID STARTER STRIP OF "GRACE'S ICE AND WATER SHIELD TO EACH SIDE OF ROOF VALLEY AND EAVES A MINIMUM OF 2'-0" BEYOND THE FACE OF THE EXTERIOR WALL - TYPICAL

OUTLINE OF EXTERIOR WALL BELOW TYP.

SLOPE TO BE DETERMINED IN FIELD

SLOPE TO BE DETERMINED IN FIELD

OUTLINE OF EXTERIOR WALL BELOW TYP.

PROVIDE ALUM. GUTTERS TO MATCH EXISTING AT NEW HORIZ. EAVES. DOWNSPOUTS TO BE LOCATED AT OUTSIDE CORNERS.

INSTALL CHIMNEY FLUE PER MANUF. RECOMMENDED FLASHING KIT, CLEARANCES, HEIGHT, AND OPTIMUM FUNCTION

1 ROOF PLAN
1/4" = 1'-0"



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REAVEY-CANNON RESIDENCE
81 KNICKERBOCKER ROAD, PITTSFORD, NY
FOR: PATRICK REAVEY & LISA CANNON


PROJECT NO.: 186201
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REVISIONS
1 JUNE 30, 2022
STANDING SEAM METAL ROOF, COLORS OF SIDING AND TRIM


ISSUED FOR CONSTRUCTION

SHEET NAME:
ROOF PLAN

SHEET No
A106

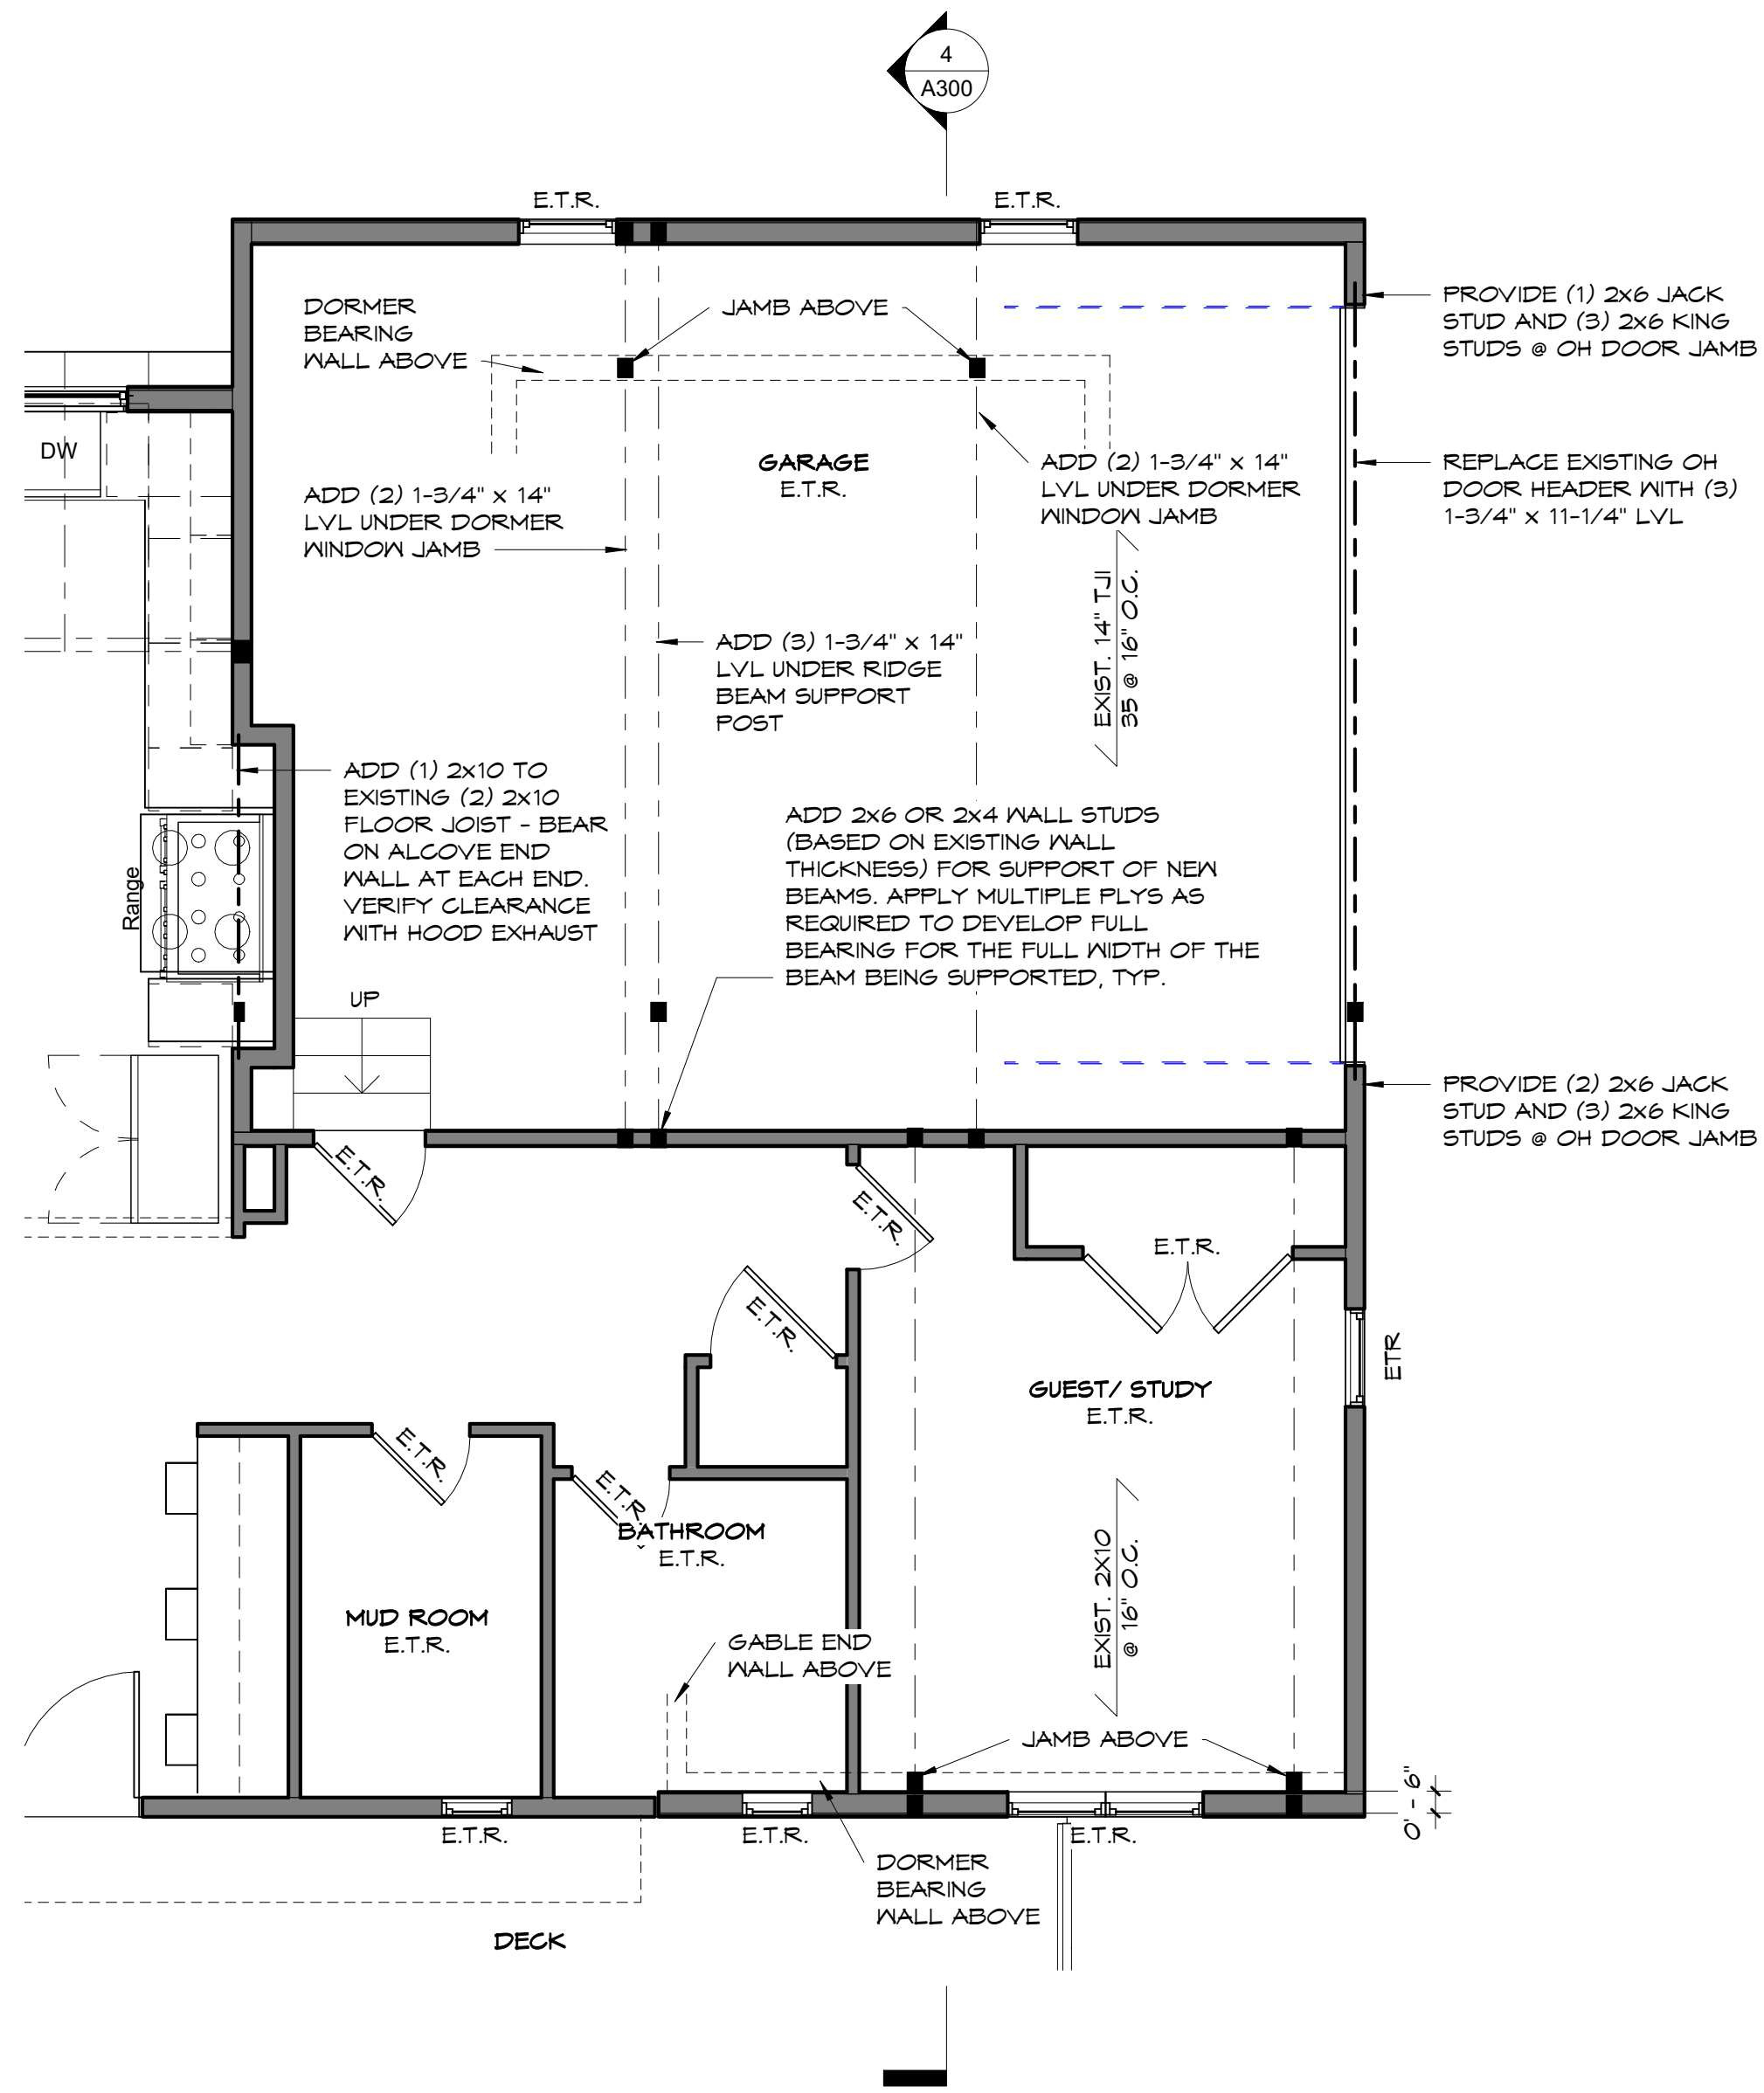

4 SECOND FLOOR FRAMING PLAN AT MASTER BEDROOM
1/4" = 1'-0"

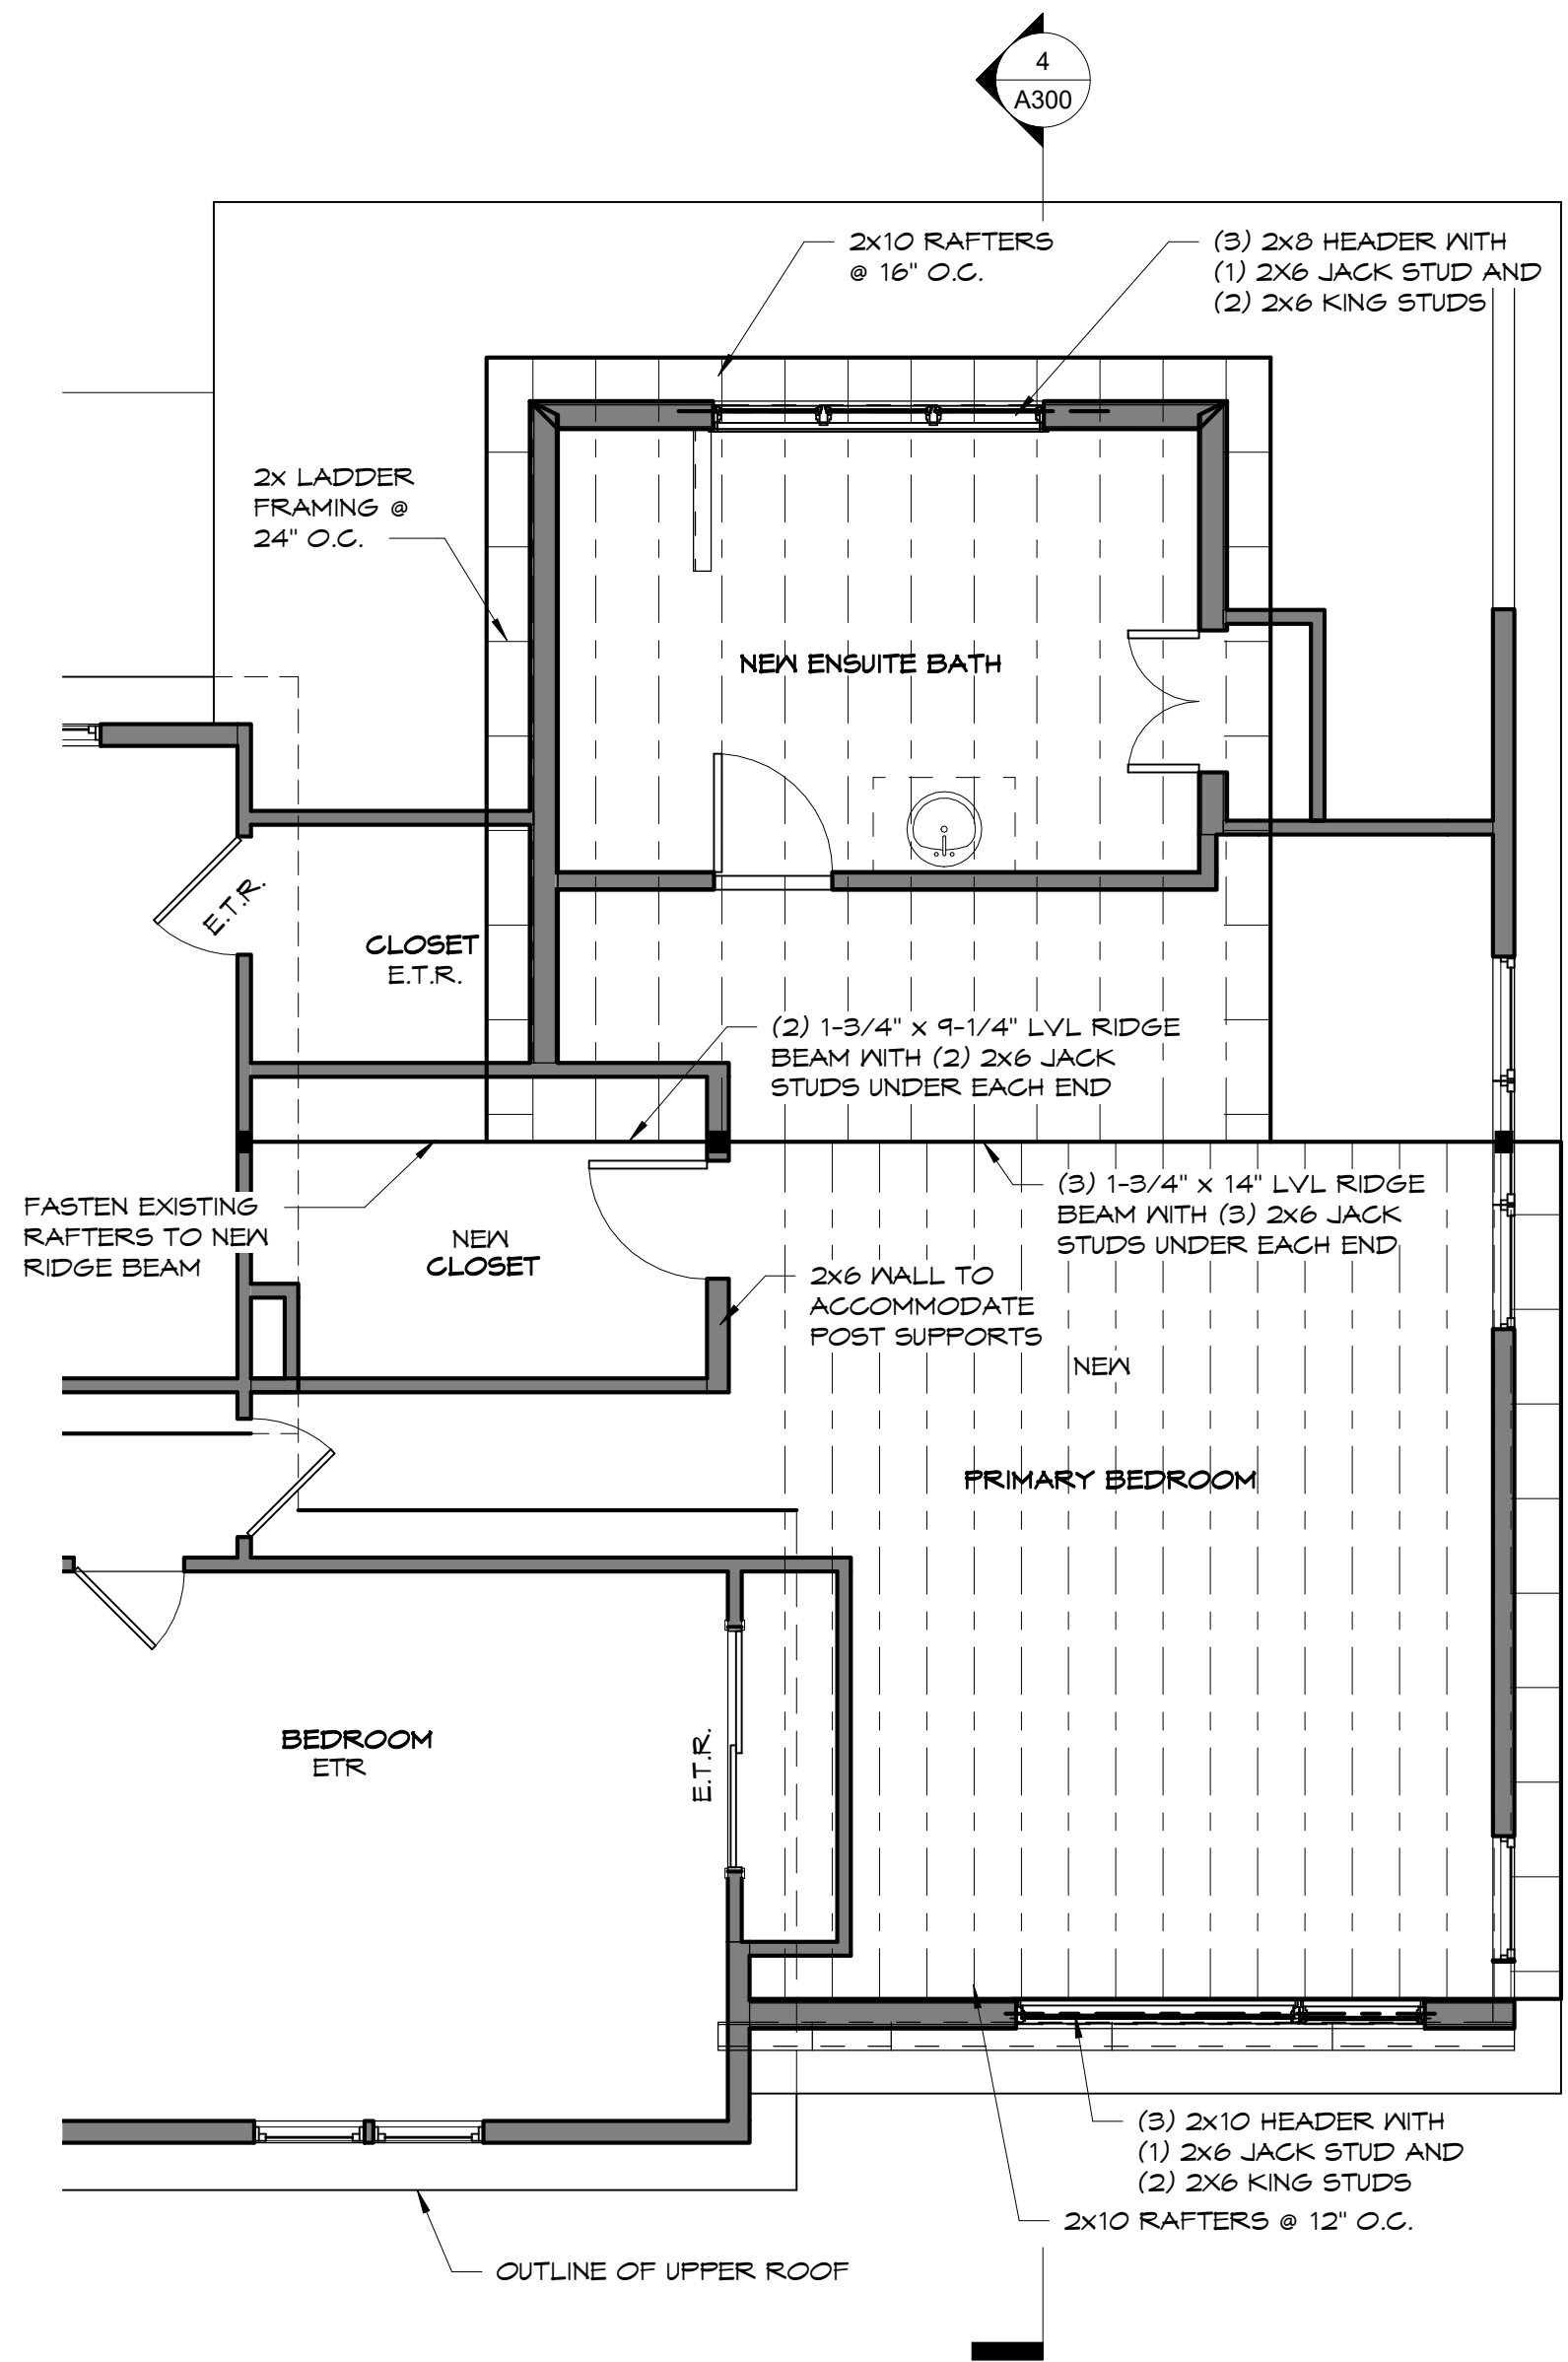

3 ROOF FRAMING PLAN AT MASTER BEDROOM
1/4" = 1'-0"


FRAMING GENERAL NOTES

1. PROVIDE WOOD STUDS SUPPORT POSTS IN WALLS DIRECTLY BELOW HEADERS & WOOD BEAMS; POSTS SHALL BE AT LEAST AS WIDE AS HEADER OR WOOD BEAM.
2. PROVIDE WOOD BLOCKING BELOW SUPPORT POSTS TO TRANSFER LOADS TO WOOD STUD WALLS, MASONRY FOUNDATION WALLS, OR STEEL BEAMS BELOW.
3. PROVIDE GALV. JOIST HANGERS OR FRAMING ANCHORS TO SECURELY CONNECT ABUTTING HEADERS OR WOOD BEAMS, AND TO CONNECT HEADERS AND WOOD BEAMS TO SUPPORT POSTS.
4. PROVIDE WOOD BLOCKING OR CROSS BRIDGING AT MIDSPAN OF WOOD FLOOR JOISTS. PROVIDE SAME AT TJI PLYWOOD JOISTS AT MIDSPAN, OR MORE OFTEN IF RECOMMENDED BY JOIST MANUFACTURER.


HEADER SCHEDULE

ROUGH OPENING WIDTH	HEADER SIZE	
	@ 2X4 WALL	@ 2X6 WALL
UP TO 3'-4"	(2) 2X6'S	(3) 2X6'S
UP TO 5'-4"	(2) 2X8'S	(3) 2X6'S
UP TO 7'-4"	(2) 2X10'S	(3) 2X8'S
UP TO 9'-4"	(2) 2X12'S	(3) 2X10'S


- HEADER NOTES:
1. PROVIDE HEADERS PER THIS HEADER SCHEDULE, UNLESS NOTED OTHERWISE ON PLANS.
 2. PROVIDE 1/2" THICK CONT. PLYWOOD LAYER BETWEEN 2X'S AT HEADERS AS NEEDED TO SUIT WALL THICKNESS.
 3. AT HEADERS GREATER THAN 8'-0" WIDTH, PROVIDE 2 CRIPPLE STUDS AT EACH END.

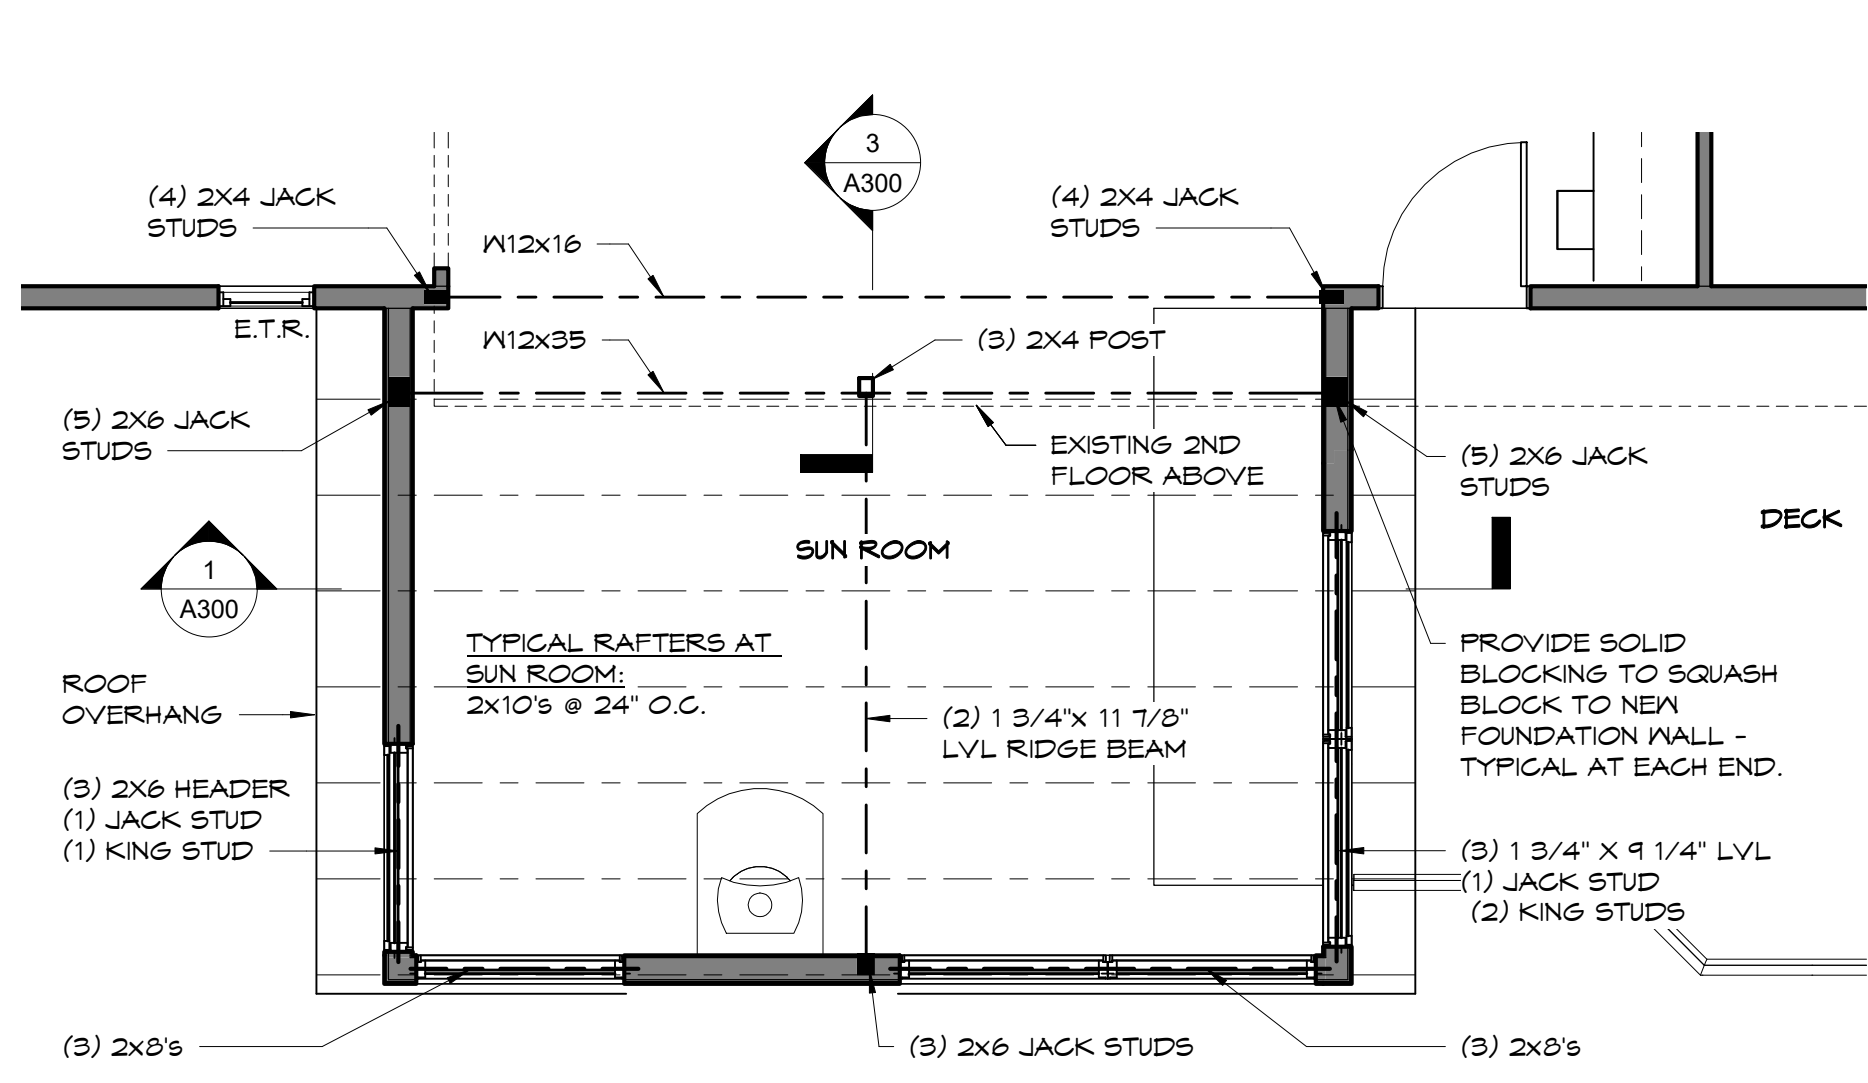

2 ROOF FRAMING PLAN AT SUN ROOM
1/4" = 1'-0"

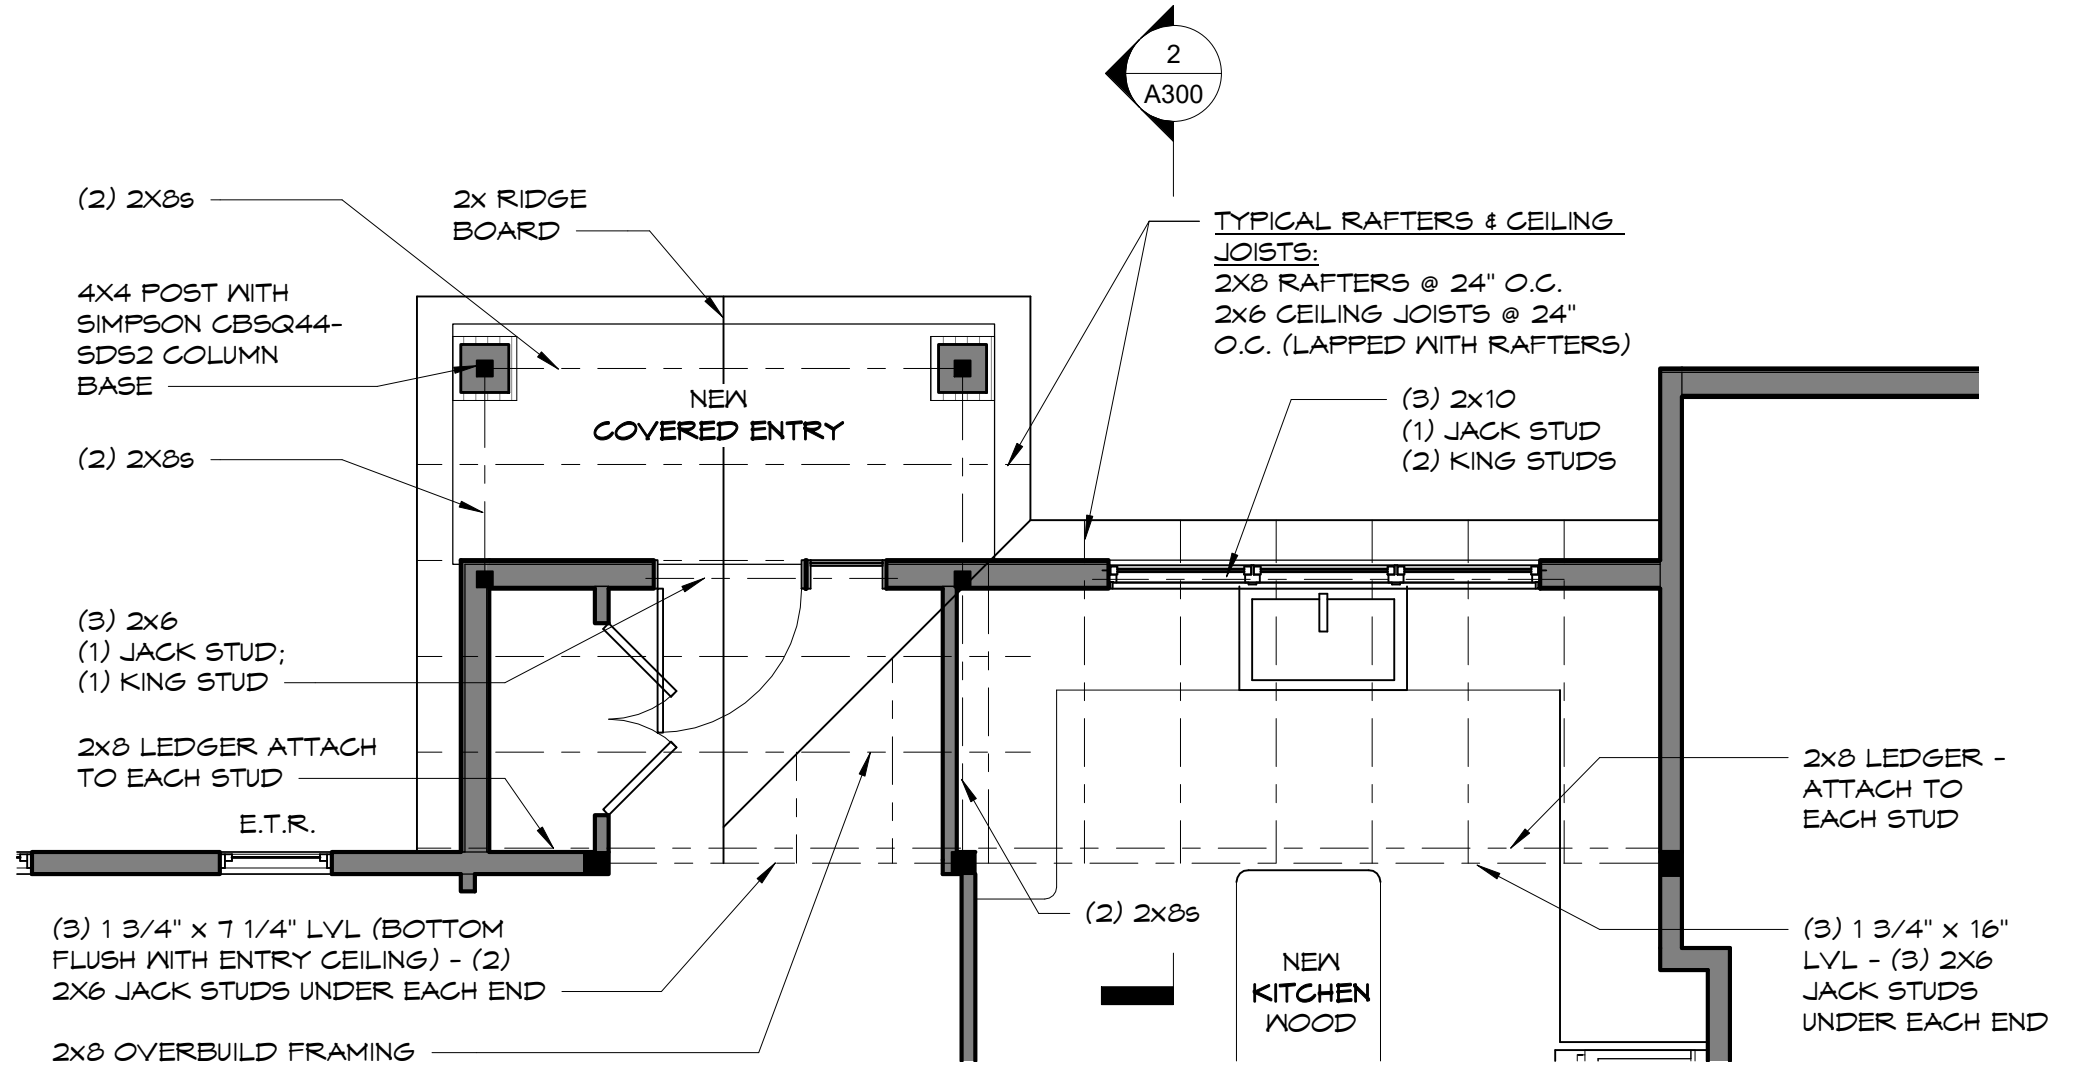

1 ROOF FRAMING PLAN AT ENTRY & KITCHEN ADDITIONS
1/4" = 1'-0"

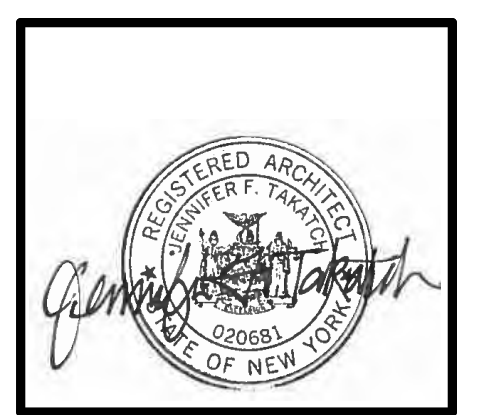

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REAVEY-CANNON RESIDENCE
81 KNICKERBOCKER ROAD, PITTSFORD, NY
FOR: PATRICK REAVEY & LISA CANNON

PROJECT NO.: 186201
CHECKED BY: SBT
DRAWN BY: KAS
DATE: 08-12-2021

REVISIONS
1 JUNE 30, 2022
STANDING SEAM METAL ROOF, COLORS OF SIDING AND TRIM


ISSUED FOR CONSTRUCTION

SHEET NAME:
FRAMING PLANS


SHEET No
A107



1 NORTH ELEVATION
1/4" = 1'-0"

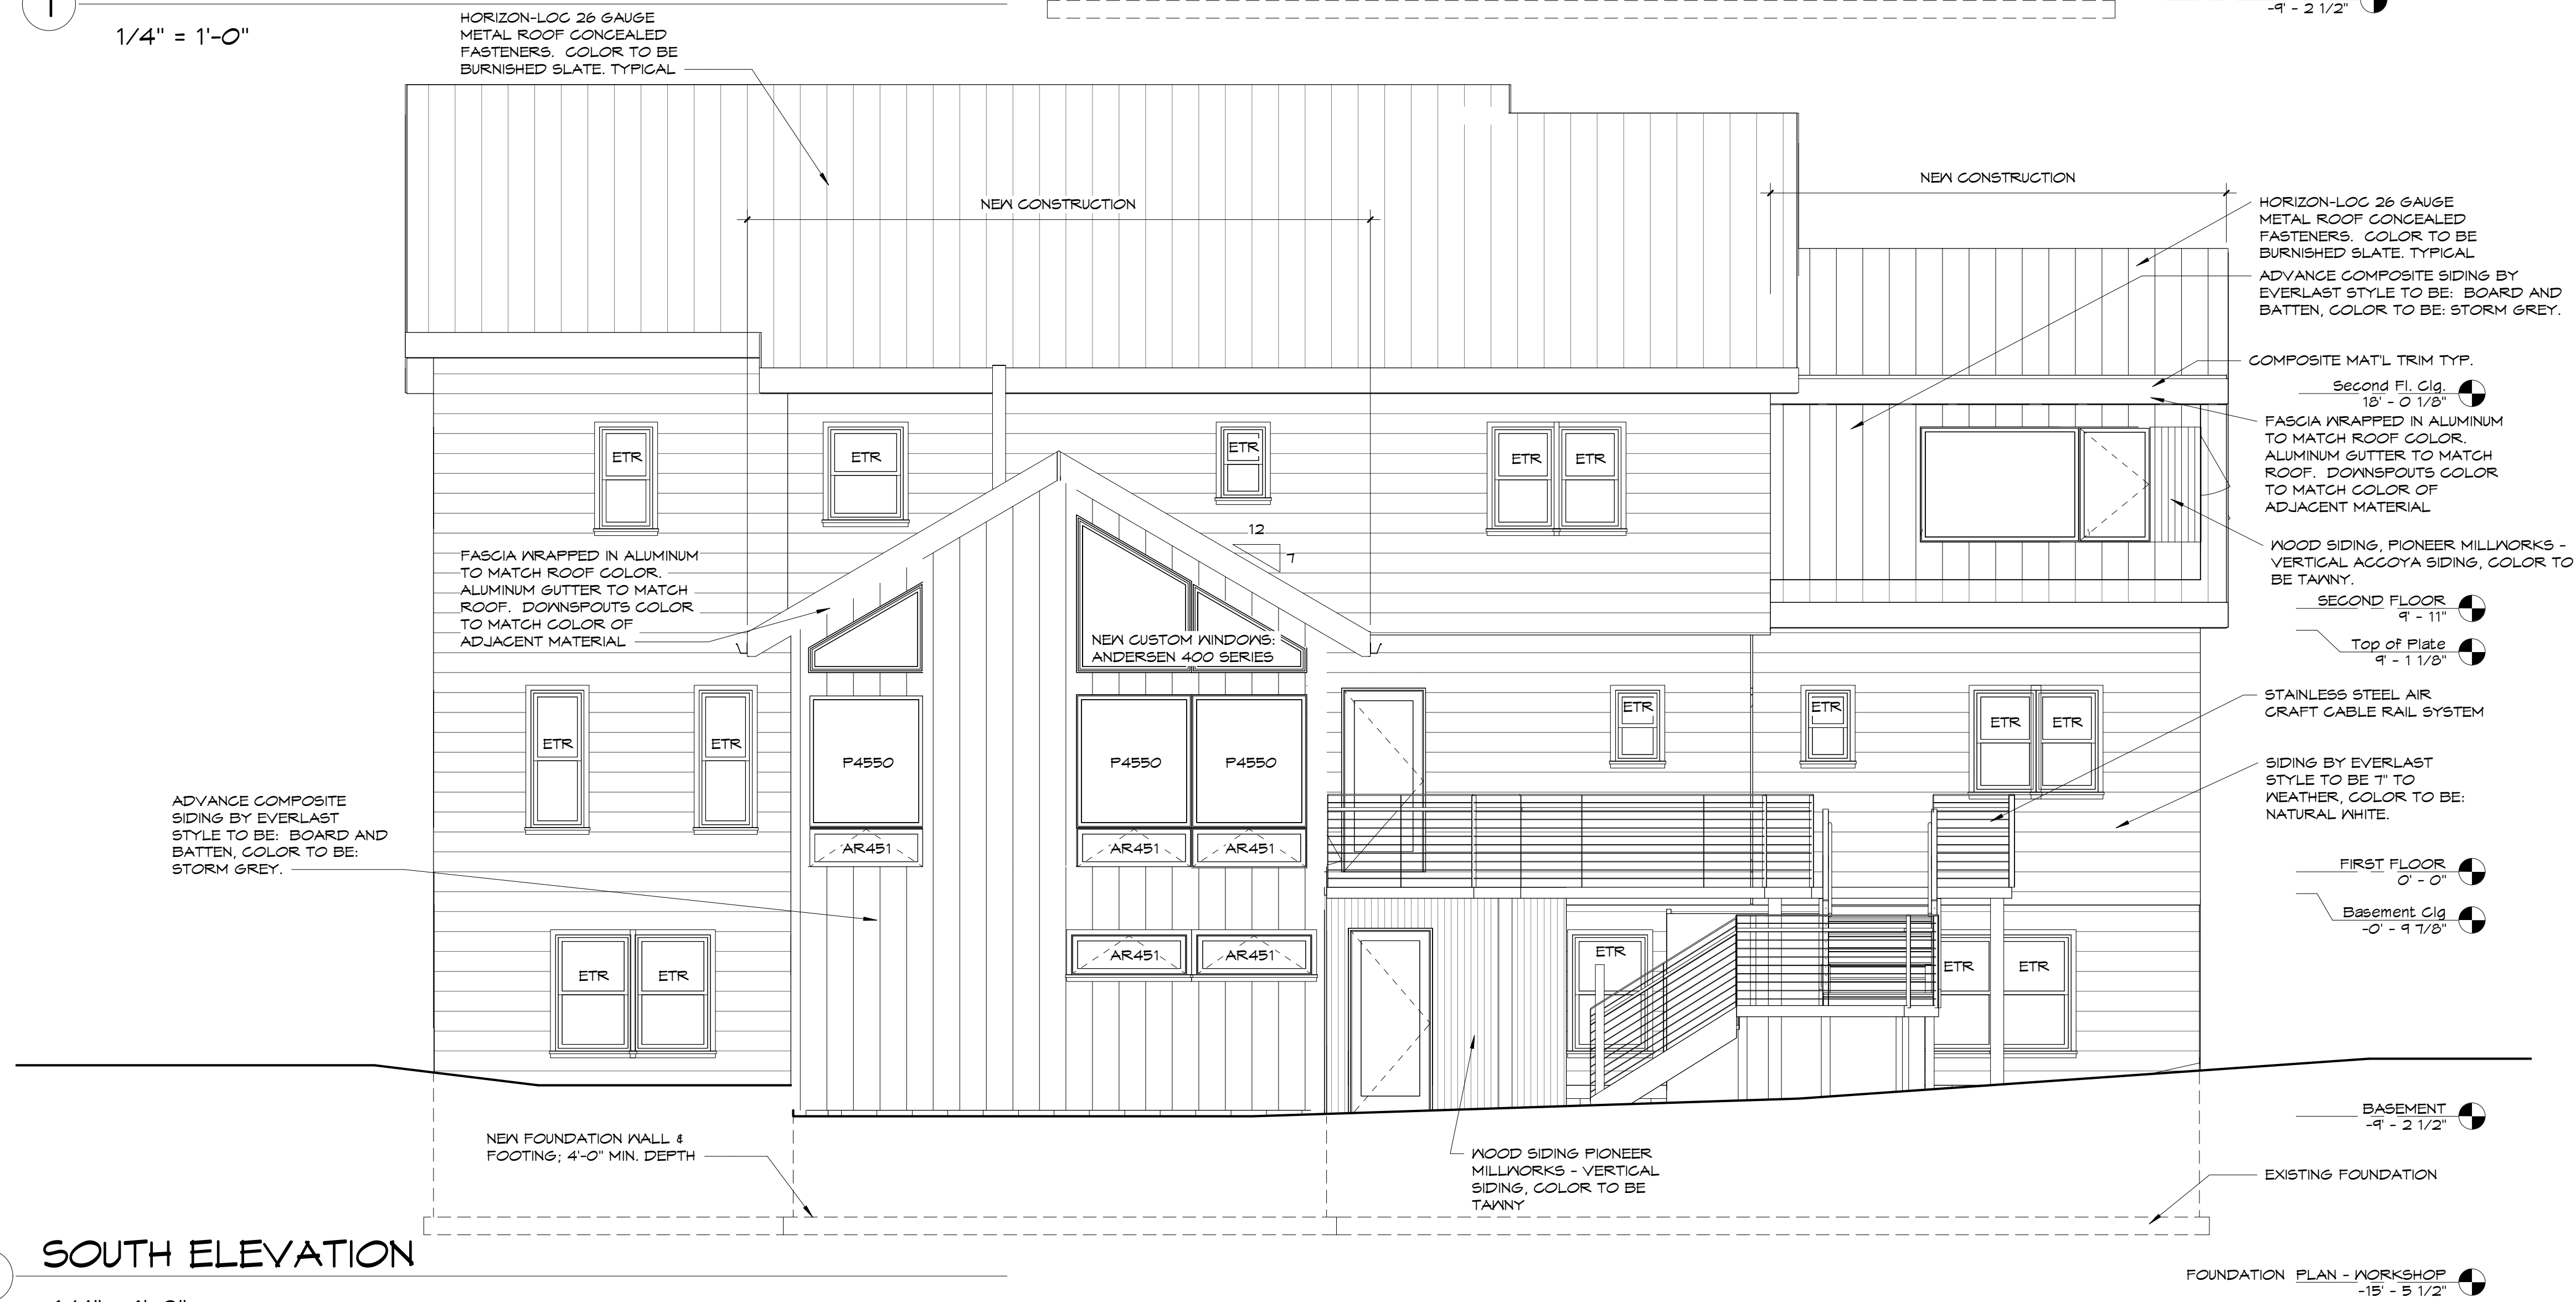

2 SOUTH ELEVATION
1/4" = 1'-0"

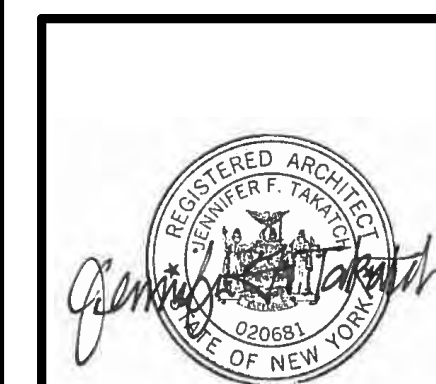

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REAVEY-CANNON RESIDENCE
81 KNICKERBOCKER ROAD, PITTSFORD, NY
FOR: PATRICK REAVEY & LISA CANNON


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CHECKED BY: SBT
DRAWN BY: KAS
DATE: 08-12-2021

REVISIONS
1 JUNE 30, 2022
STANDING SEAM METAL ROOF, COLORS OF SIDING AND TRIM


ISSUED FOR CONSTRUCTION

SHEET NAME:
EXTERIOR ELEVATIONS

SHEET No
A200

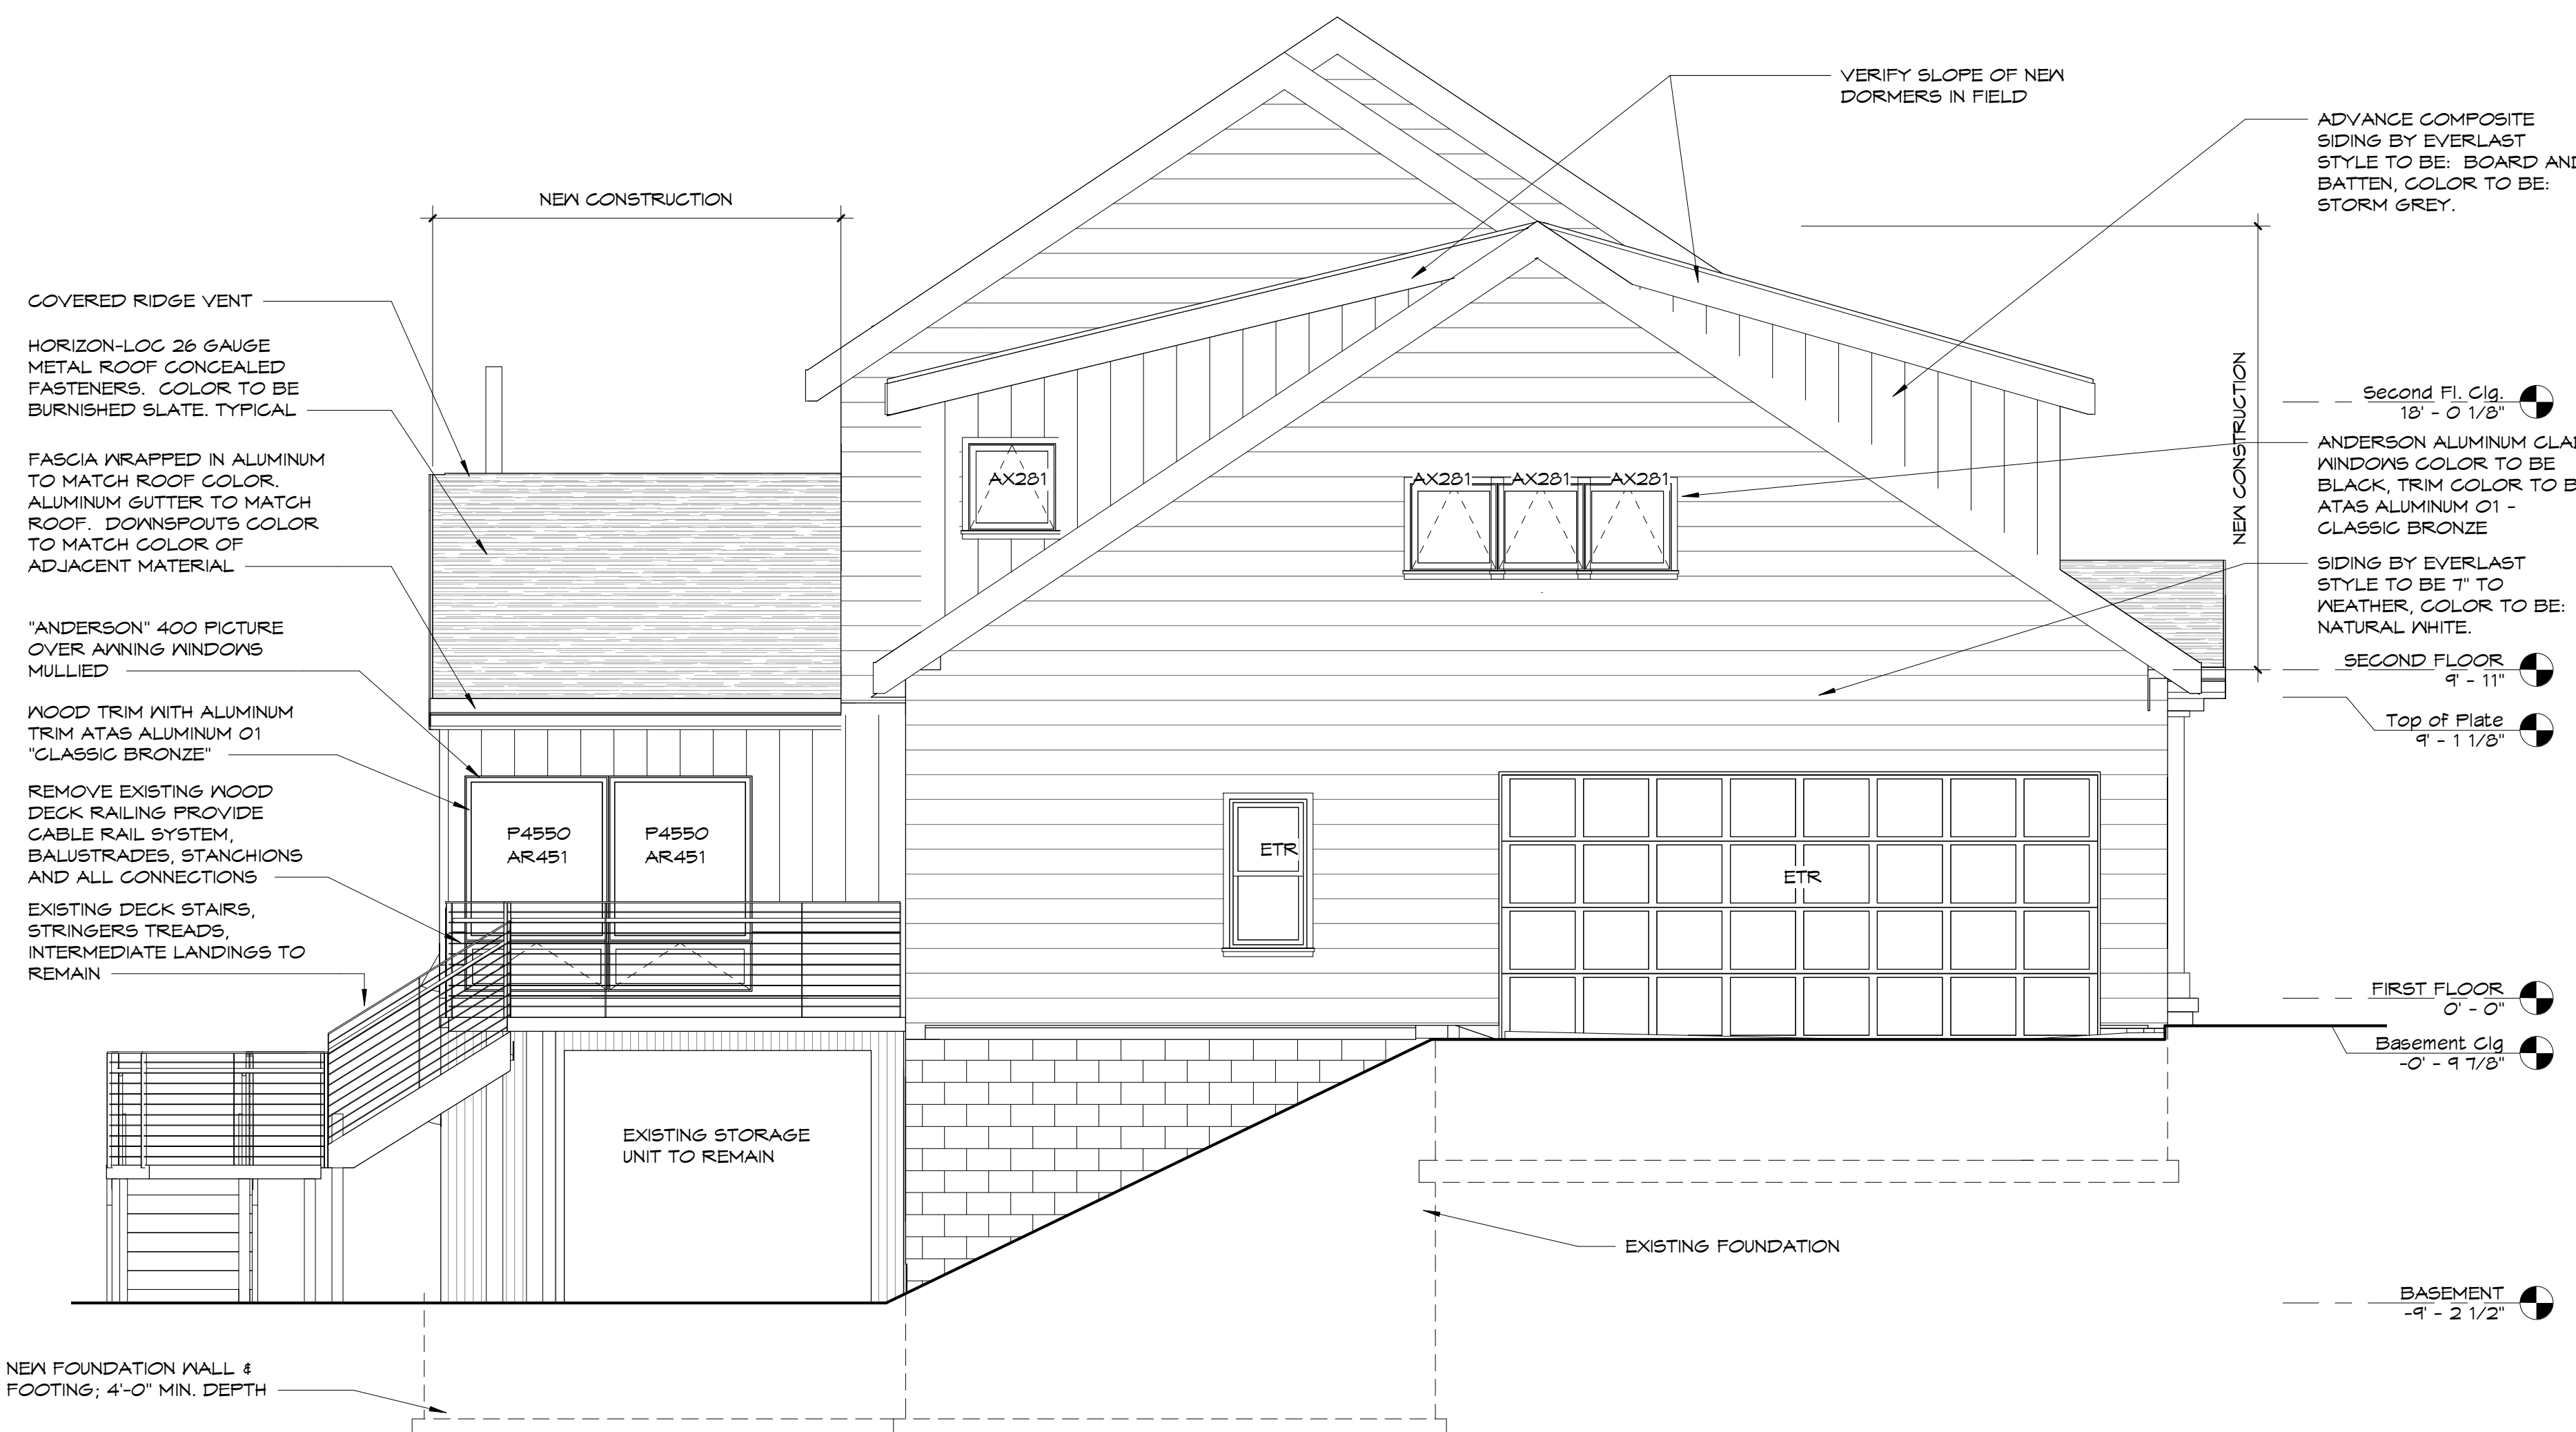

1 EAST ELEVATION
1/4" = 1'-0"

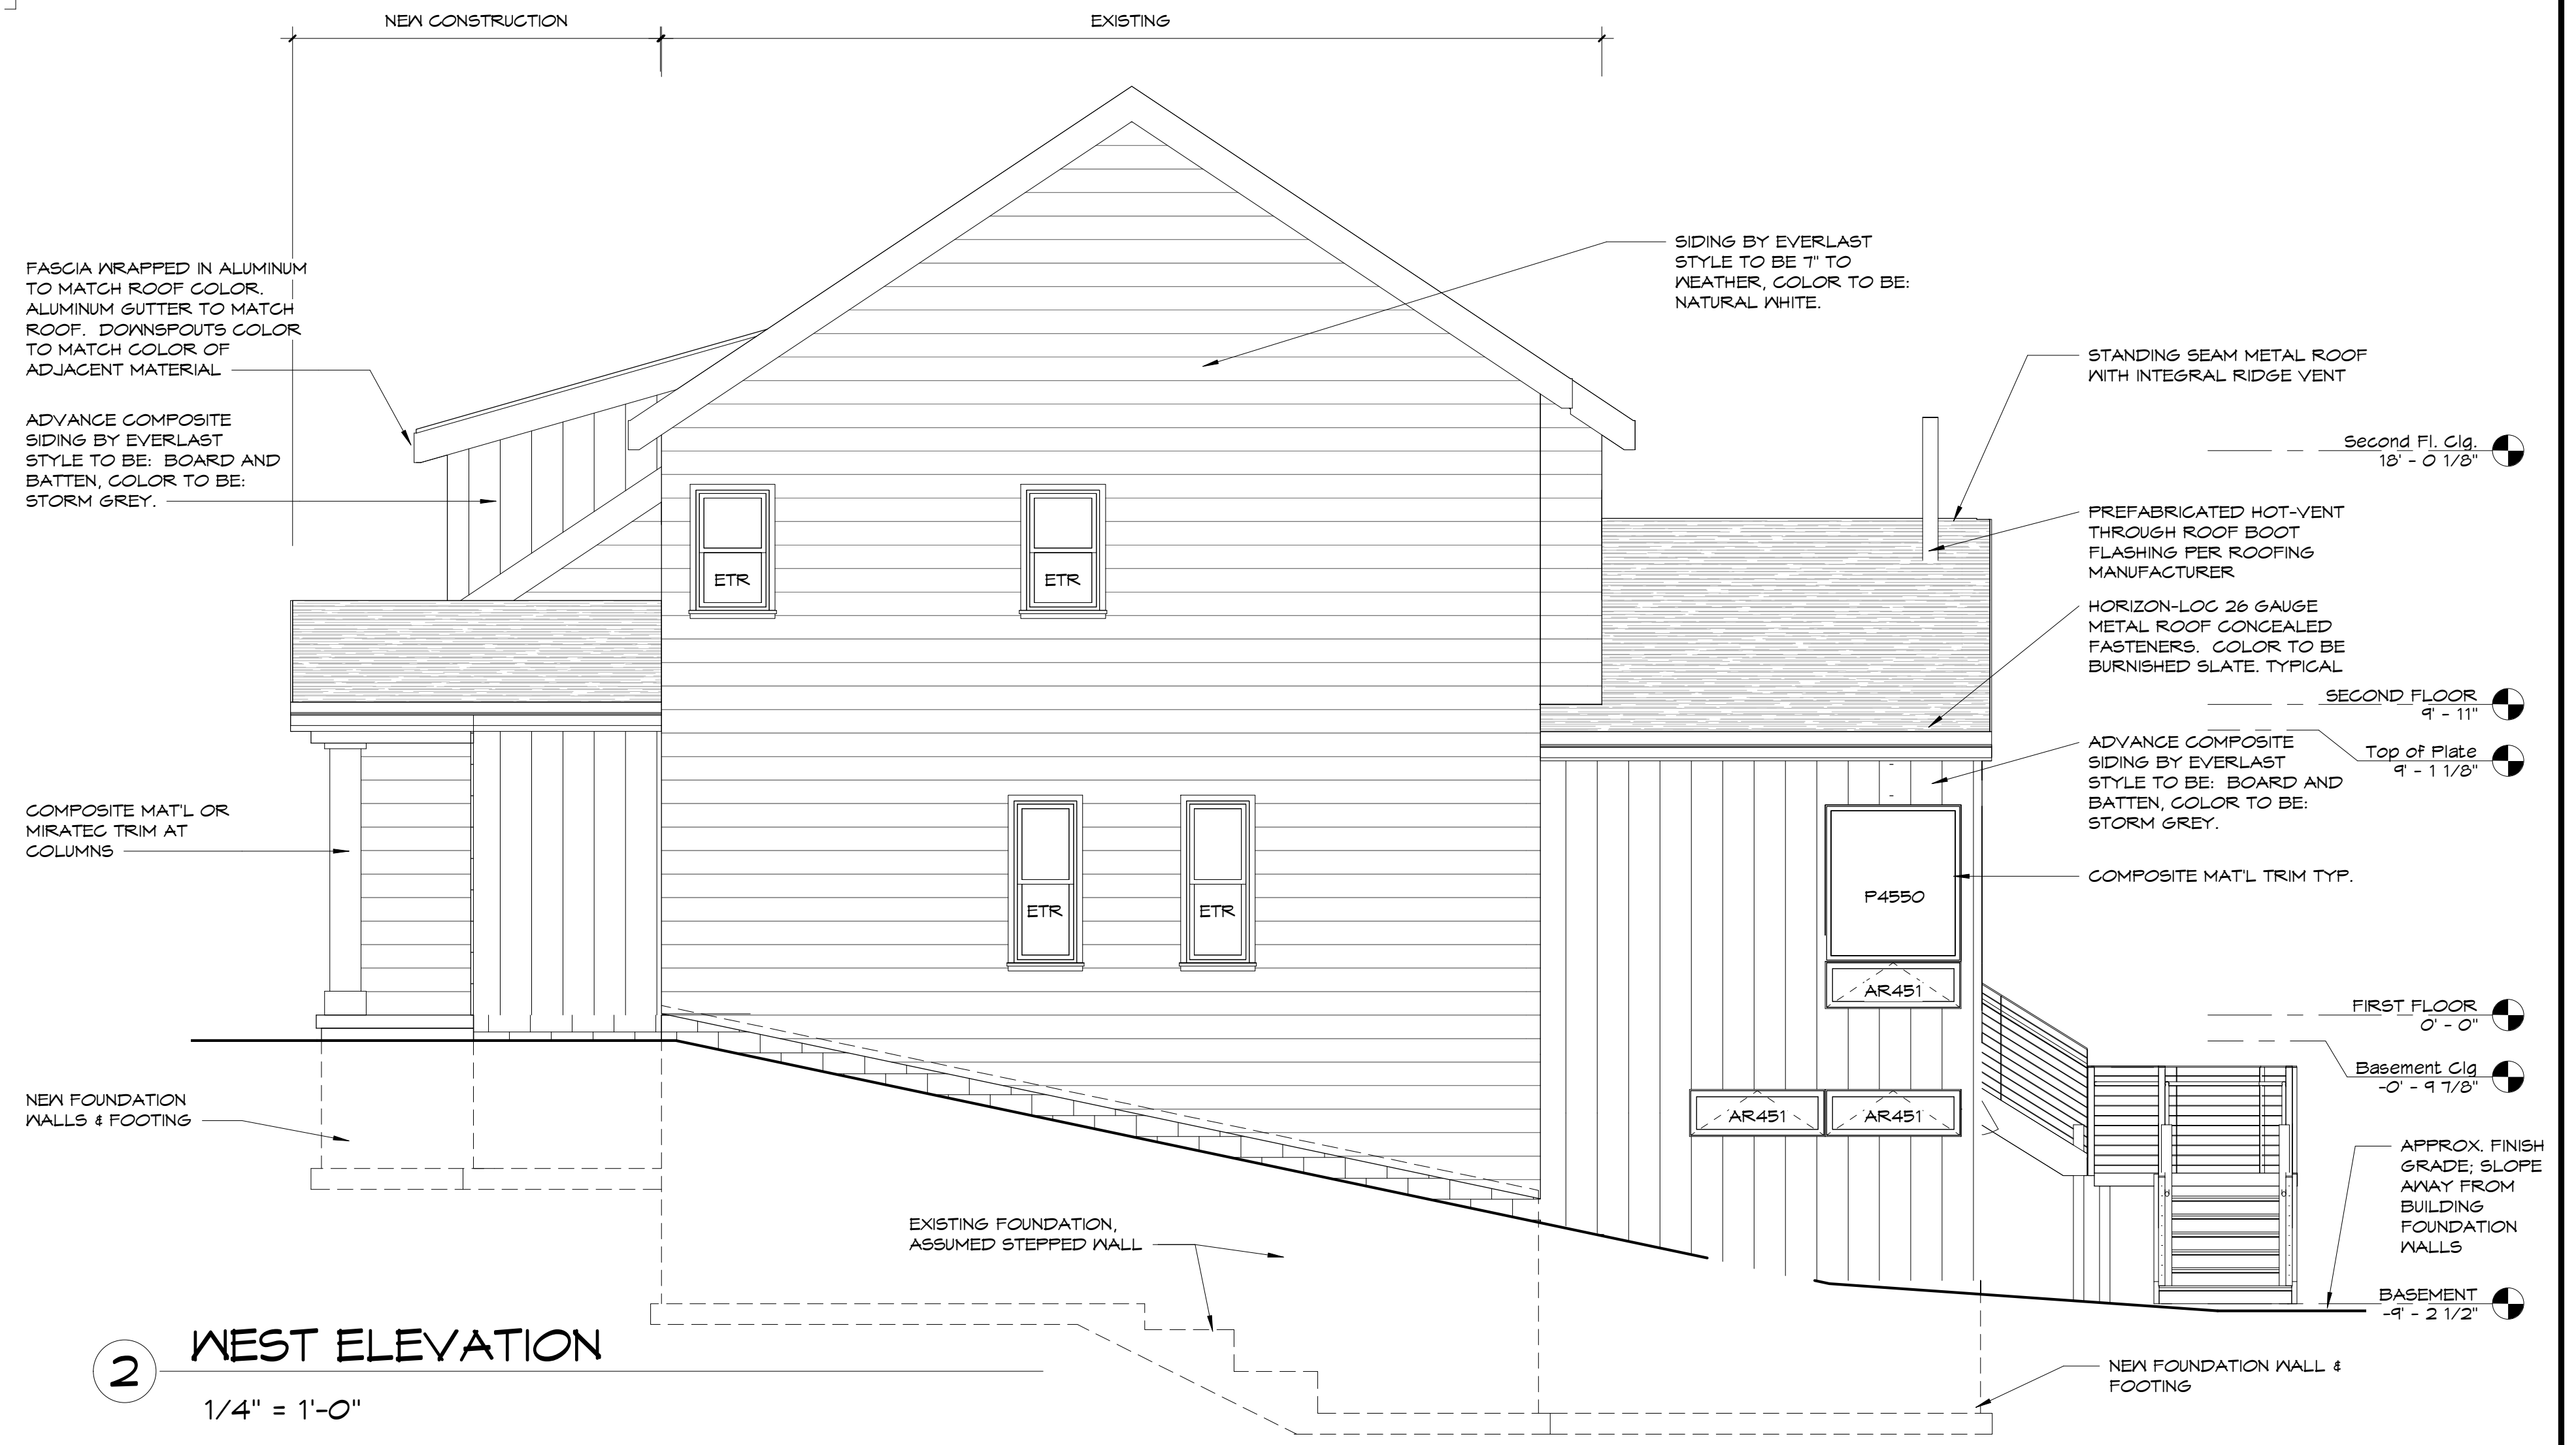

2 WEST ELEVATION
1/4" = 1'-0"



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REAVEY-CANNON RESIDENCE
81 KNICKERBOCKER ROAD, PITTSFORD, NY
FOR: PATRICK REAVEY & LISA CANNON

PROJECT NO.: 186201
CHECKED BY: SBT
DRAWN BY: KAS
DATE: 08-12-2021


REVISIONS
1 JUNE 30, 2022
STANDING SEAM METAL ROOF, COLORS OF SIDING AND TRIM

ISSUED FOR CONSTRUCTION


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EXTERIOR ELEVATIONS

SHEET No


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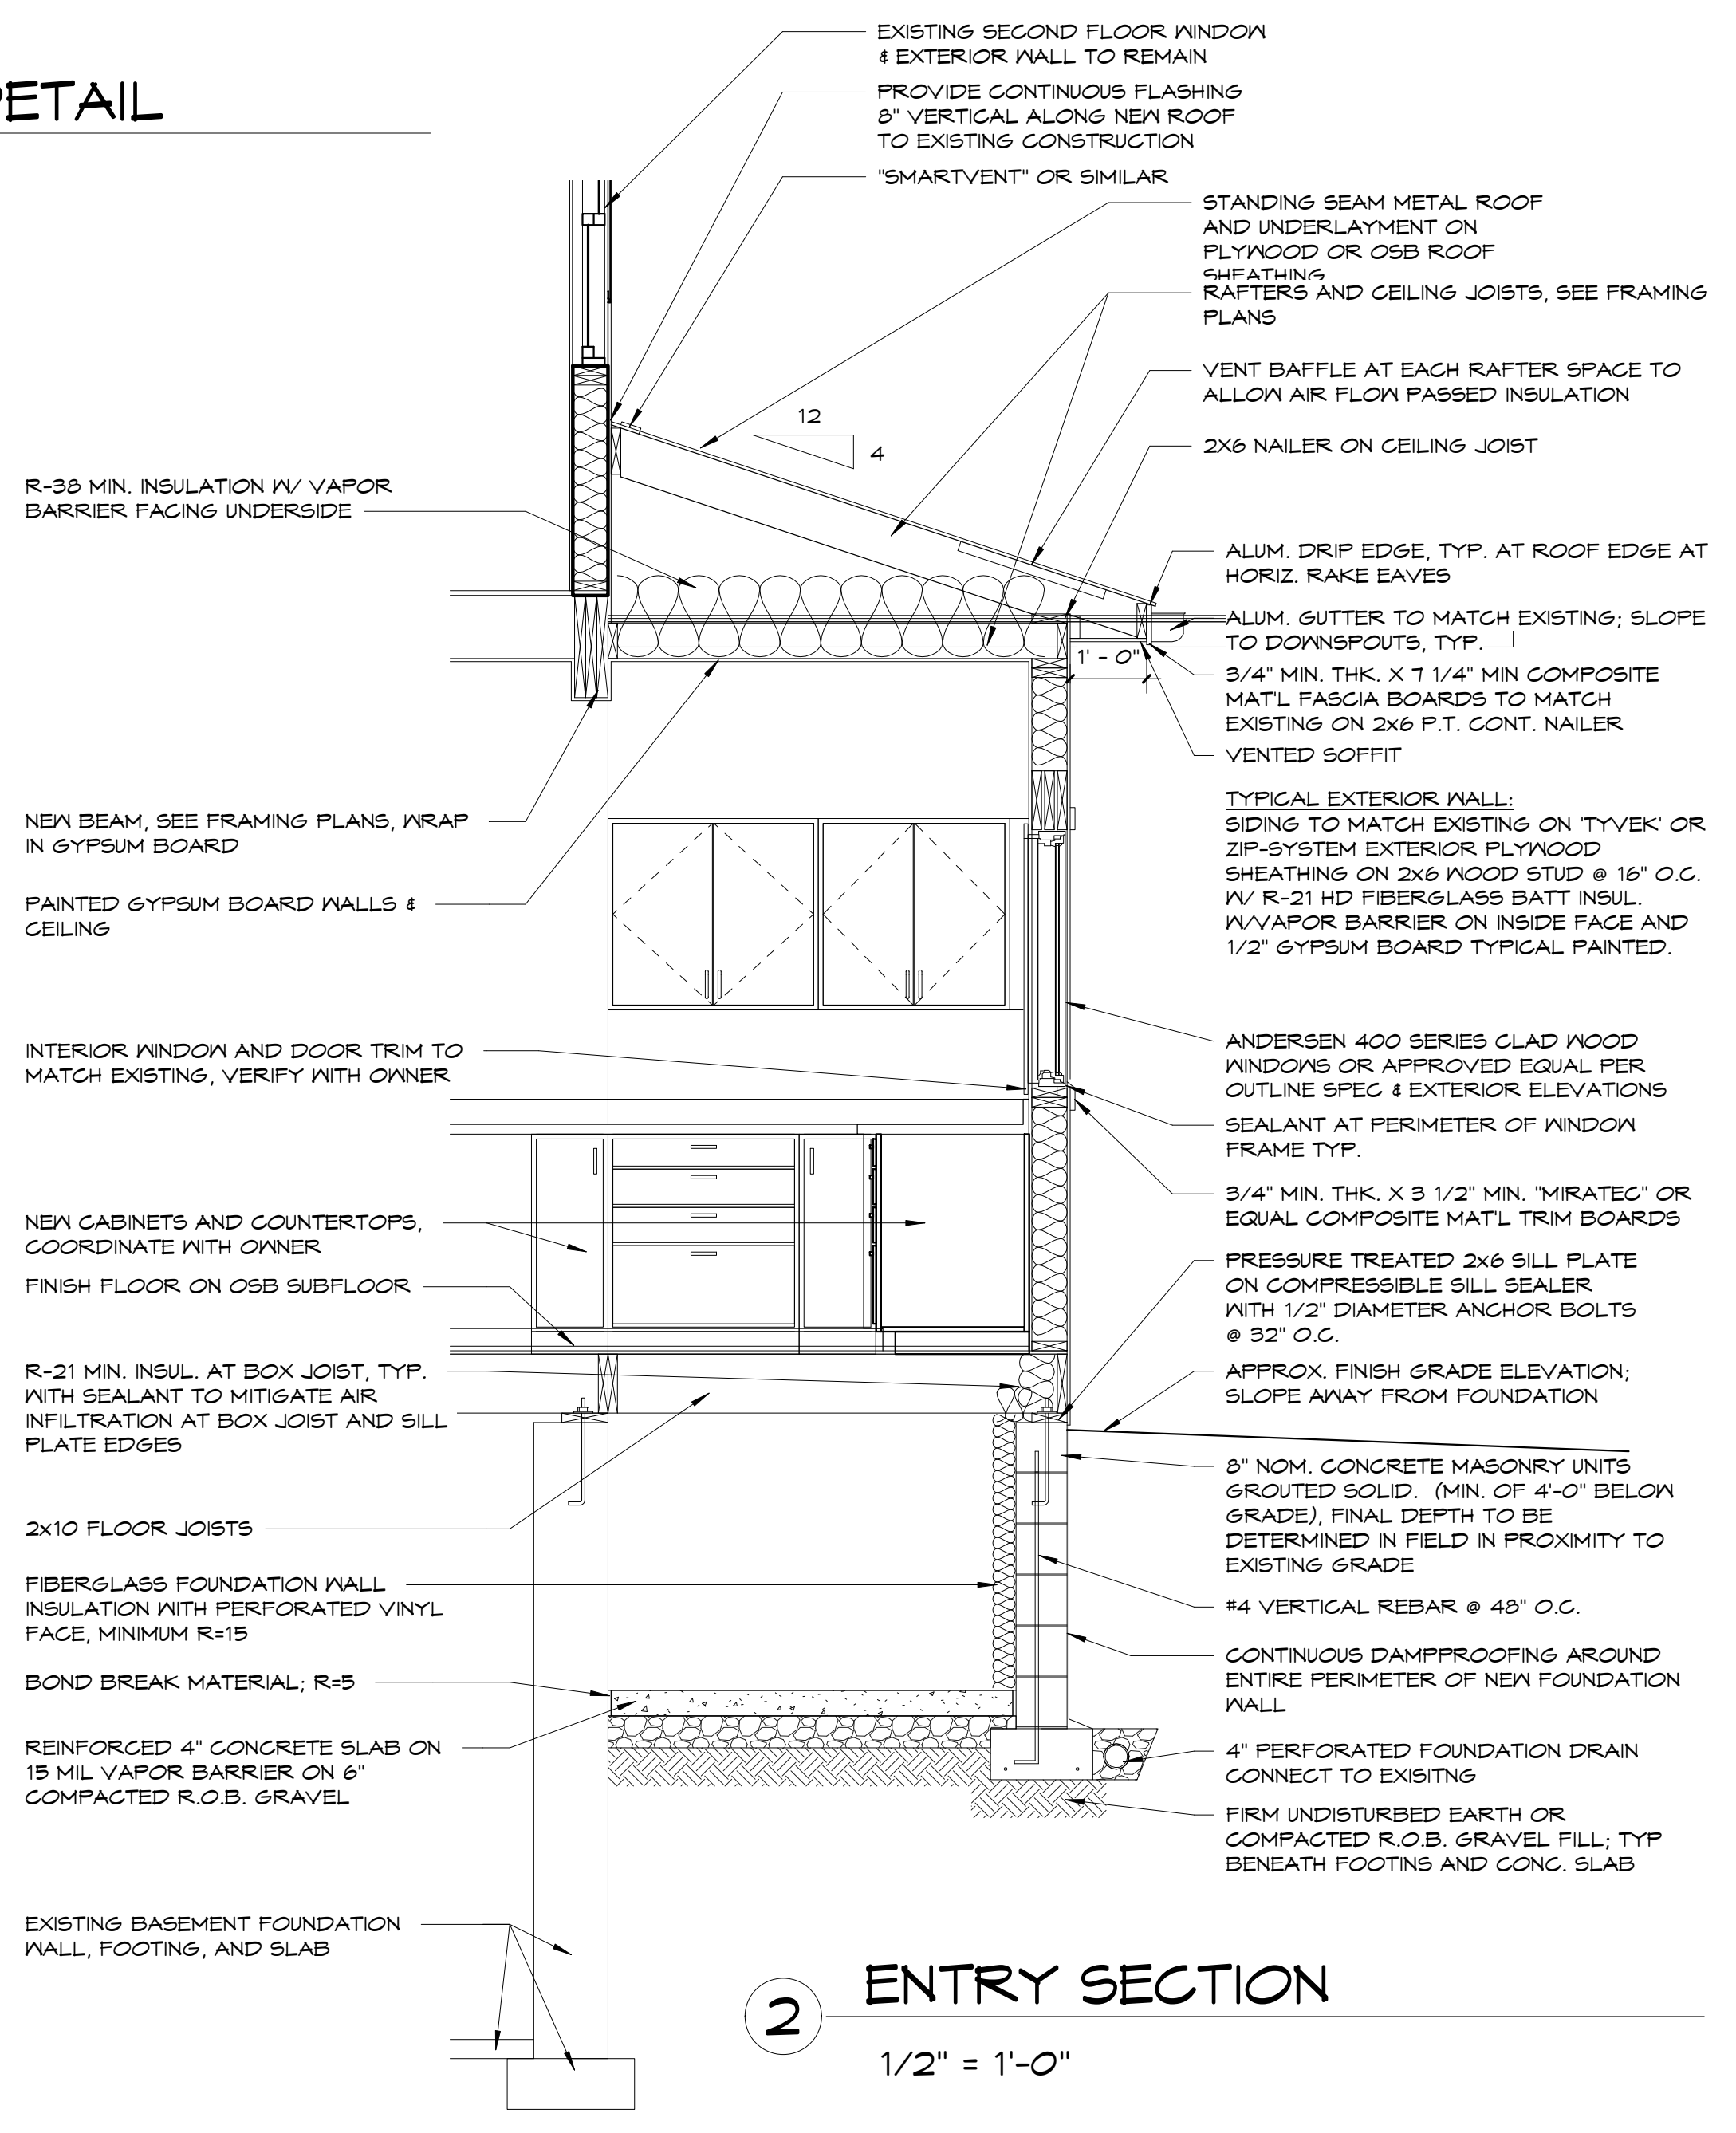
1 Sun Room Section
1/4" = 1'-0"

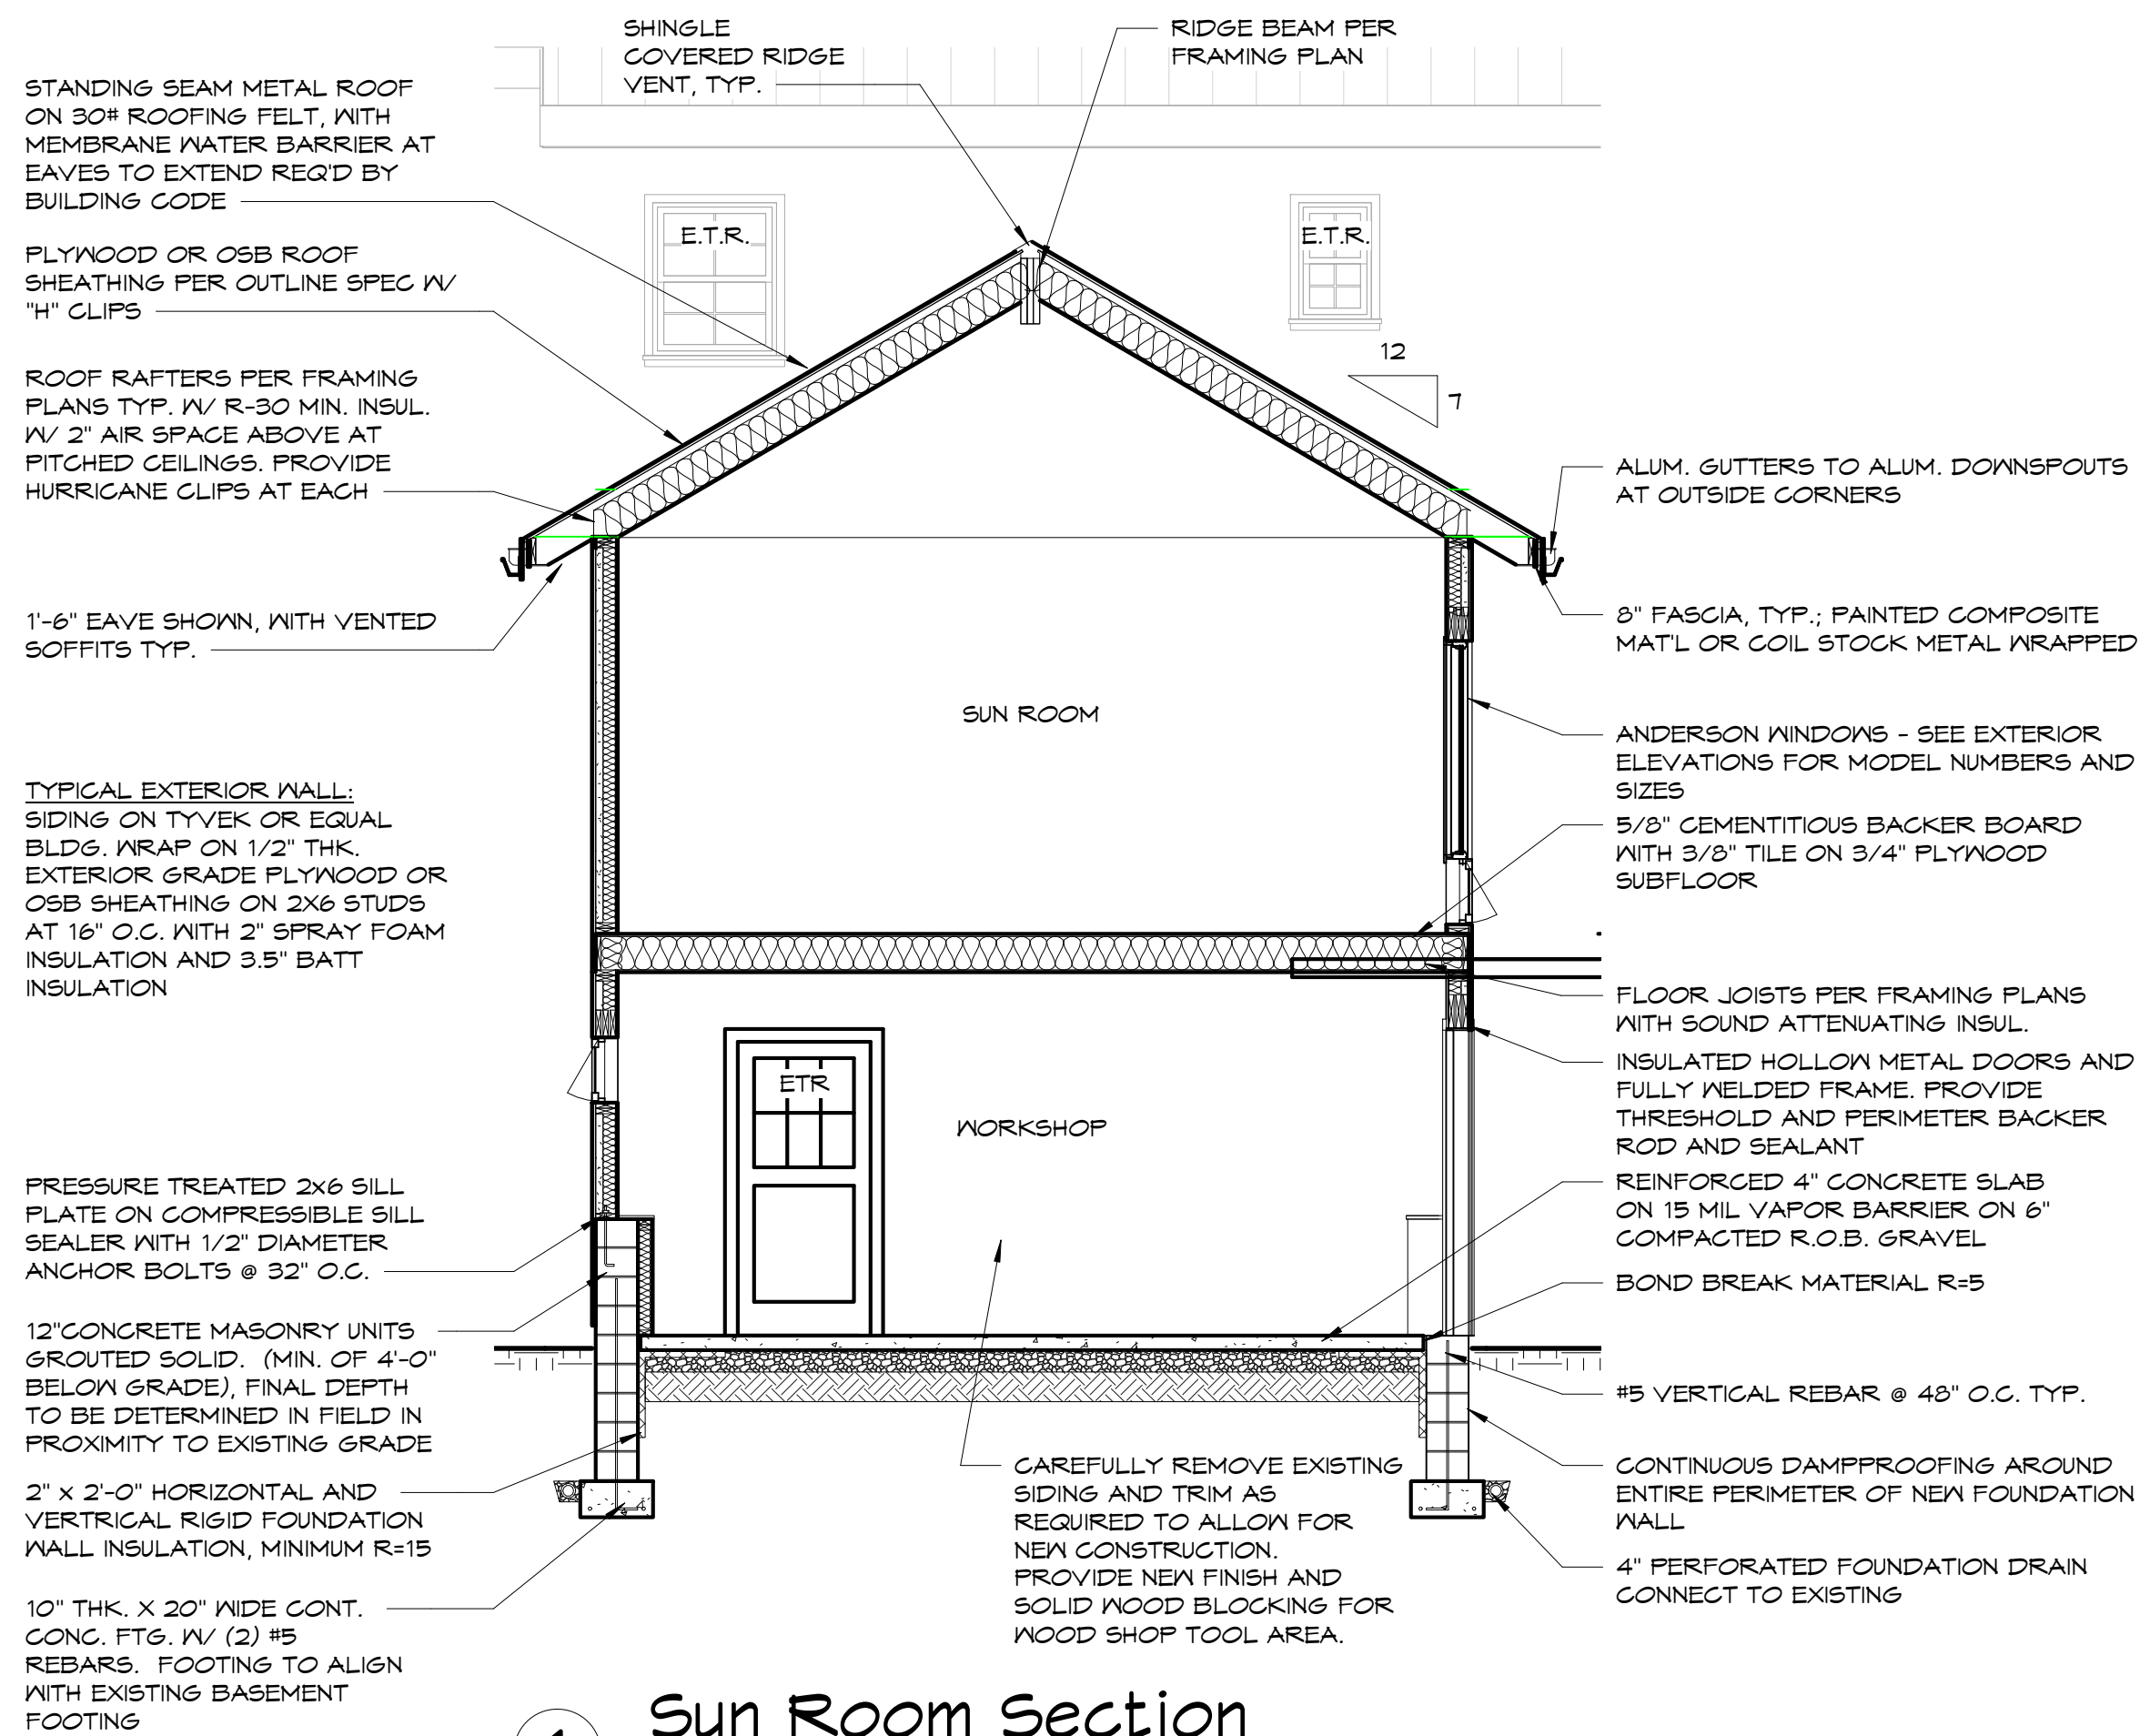

3 SUN ROOM FRAMING DETAIL
3/4" = 1'-0"

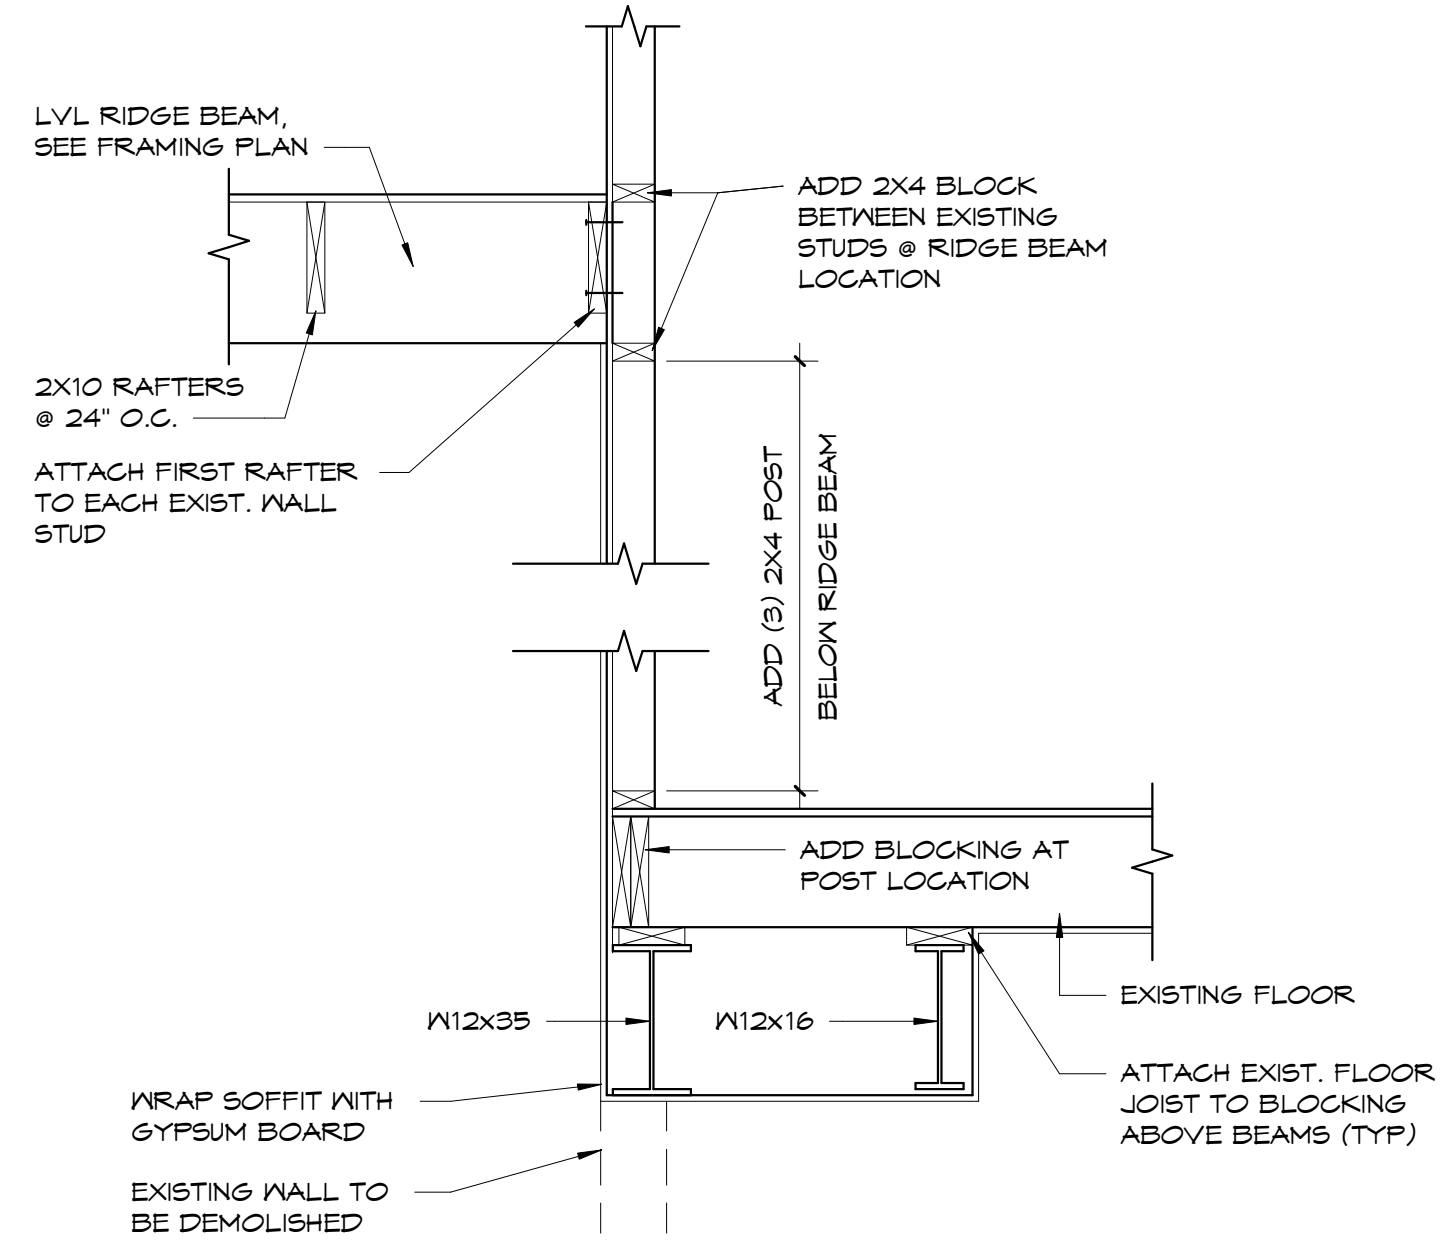

4 Master Bedroom Section
1/4" = 1'-0"

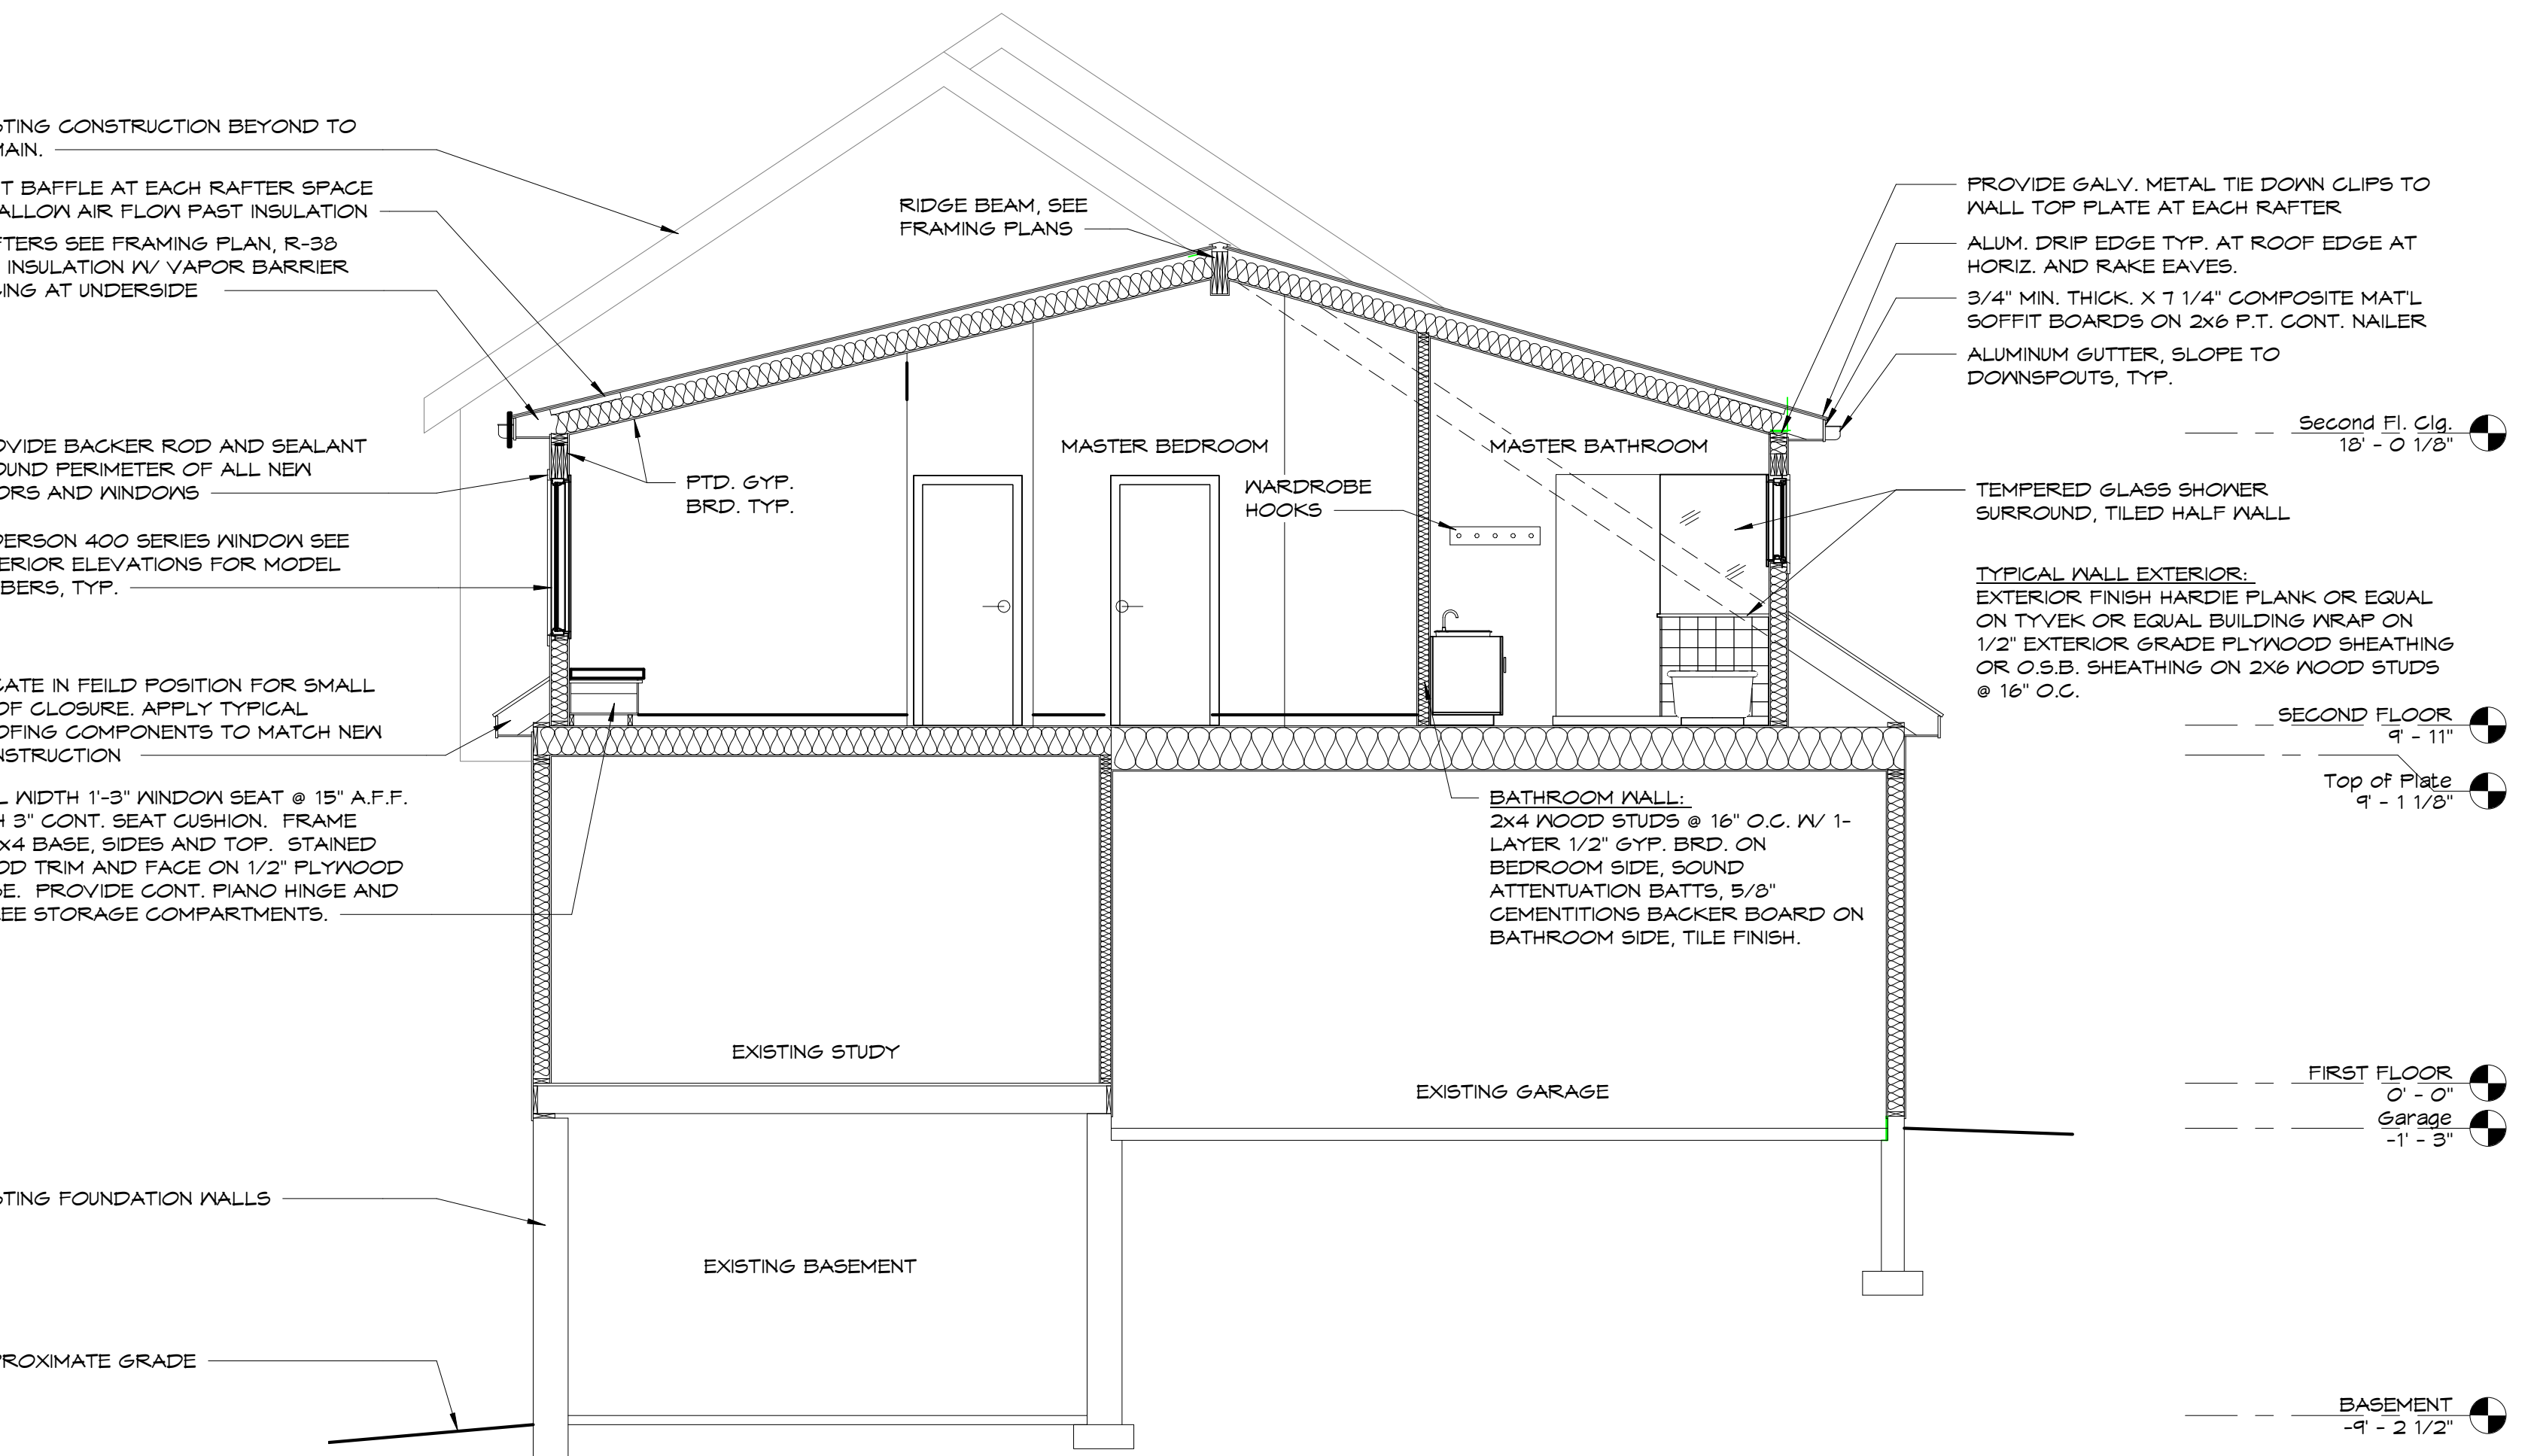

2 ENTRY SECTION
1/2" = 1'-0"



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REAVEY-CANNON RESIDENCE
81 KNICKERBOCKER ROAD, PITTSFORD, NY
FOR: PATRICK REAVEY & LISA CANNON


PROJECT NO.: 186201
CHECKED BY: SBT
DRAWN BY: KAS
DATE: 08-12-2021

REVISIONS
1 JUNE 30, 2022
STANDING SEAM METAL ROOF, COLORS OF SIDING AND TRIM

ISSUED FOR CONSTRUCTION

SHEET NAME:
SECTIONS

SHEET No
A300

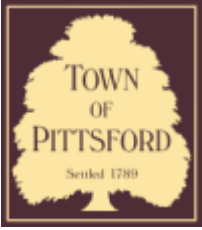

Town of Pittsford

Department of Public Works
11 South Main Street
Pittsford, New York 14534

Permit #
B22-000108

Phone: 585-248-6250
FAX: 585-248-6262

DESIGN REVIEW AND HISTORIC PRESERVATION BOARD REFERRAL OF APPLICATION

Property Address: 111 Mill Road PITTSFORD, NY 14534

Tax ID Number: 178.11-3-45

Zoning District: RN Residential Neighborhood

Owner: Franco, Philip

Applicant: Franco, Philip

Application Type:

- | | |
|---|---|
| <input checked="" type="checkbox"/> Residential Design Review
§185-205 (B) | <input type="checkbox"/> Build to Line Adjustment
§185-17 (B) (2) |
| <input type="checkbox"/> Commercial Design Review
§185-205 (B) | <input type="checkbox"/> Building Height Above 30 Feet
§185-17 (M) |
| <input type="checkbox"/> Signage
§185-205 (C) | <input type="checkbox"/> Corner Lot Orientation
§185-17 (K) (3) |
| <input type="checkbox"/> Certificate of Appropriateness
§185-197 | <input type="checkbox"/> Flag Lot Building Line Location
§185-17 (L) (1) (c) |
| <input type="checkbox"/> Landmark Designation
§185-195 (2) | <input type="checkbox"/> Undeveloped Flag Lot Requirements
§185-17 (L) (2) |
| <input type="checkbox"/> Informal Review | |

Project Description: The applicant is requesting design review for an addition of a 436 sf addition off the back of the existing house.


Meeting Date: July 14, 2022



RN Residential Neighborhood Zoning




Printed July 7, 2022

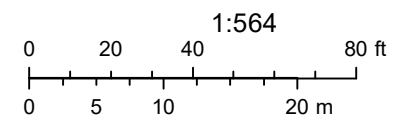

Town of Pittsford GIS

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Mill Rd

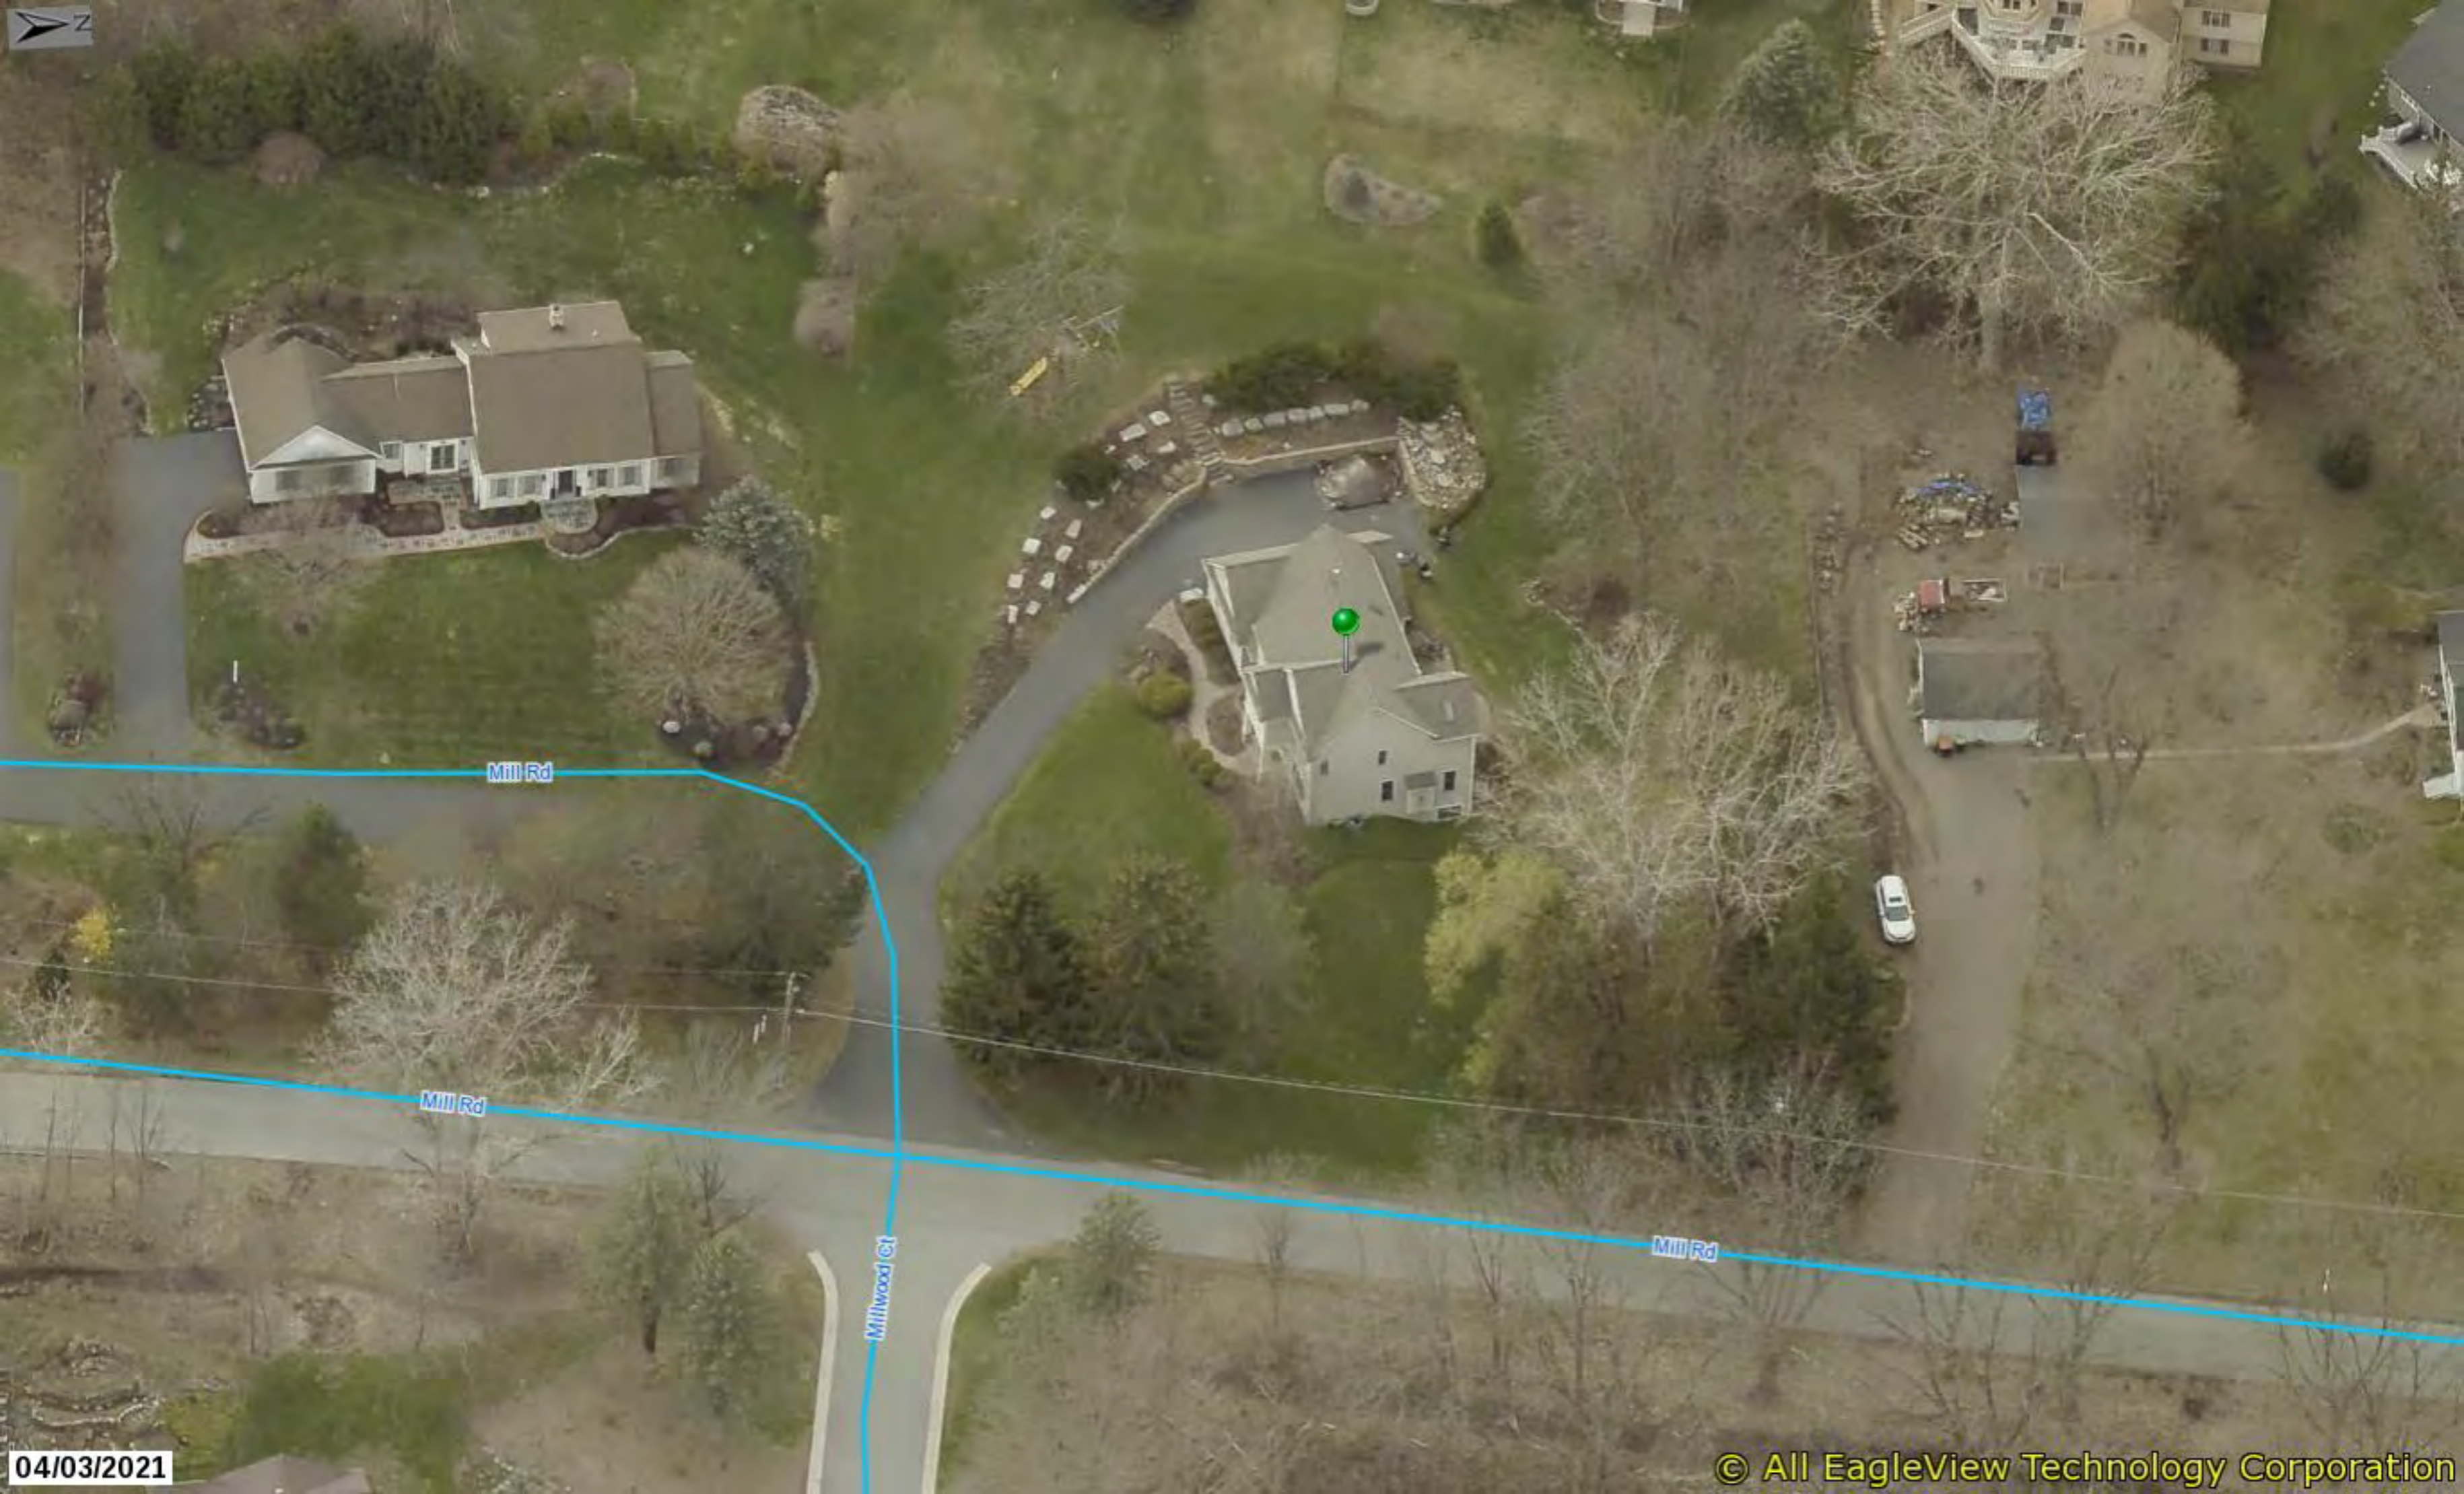Mill Rd

Millwood Ct

Mill Rd

04/03/2021

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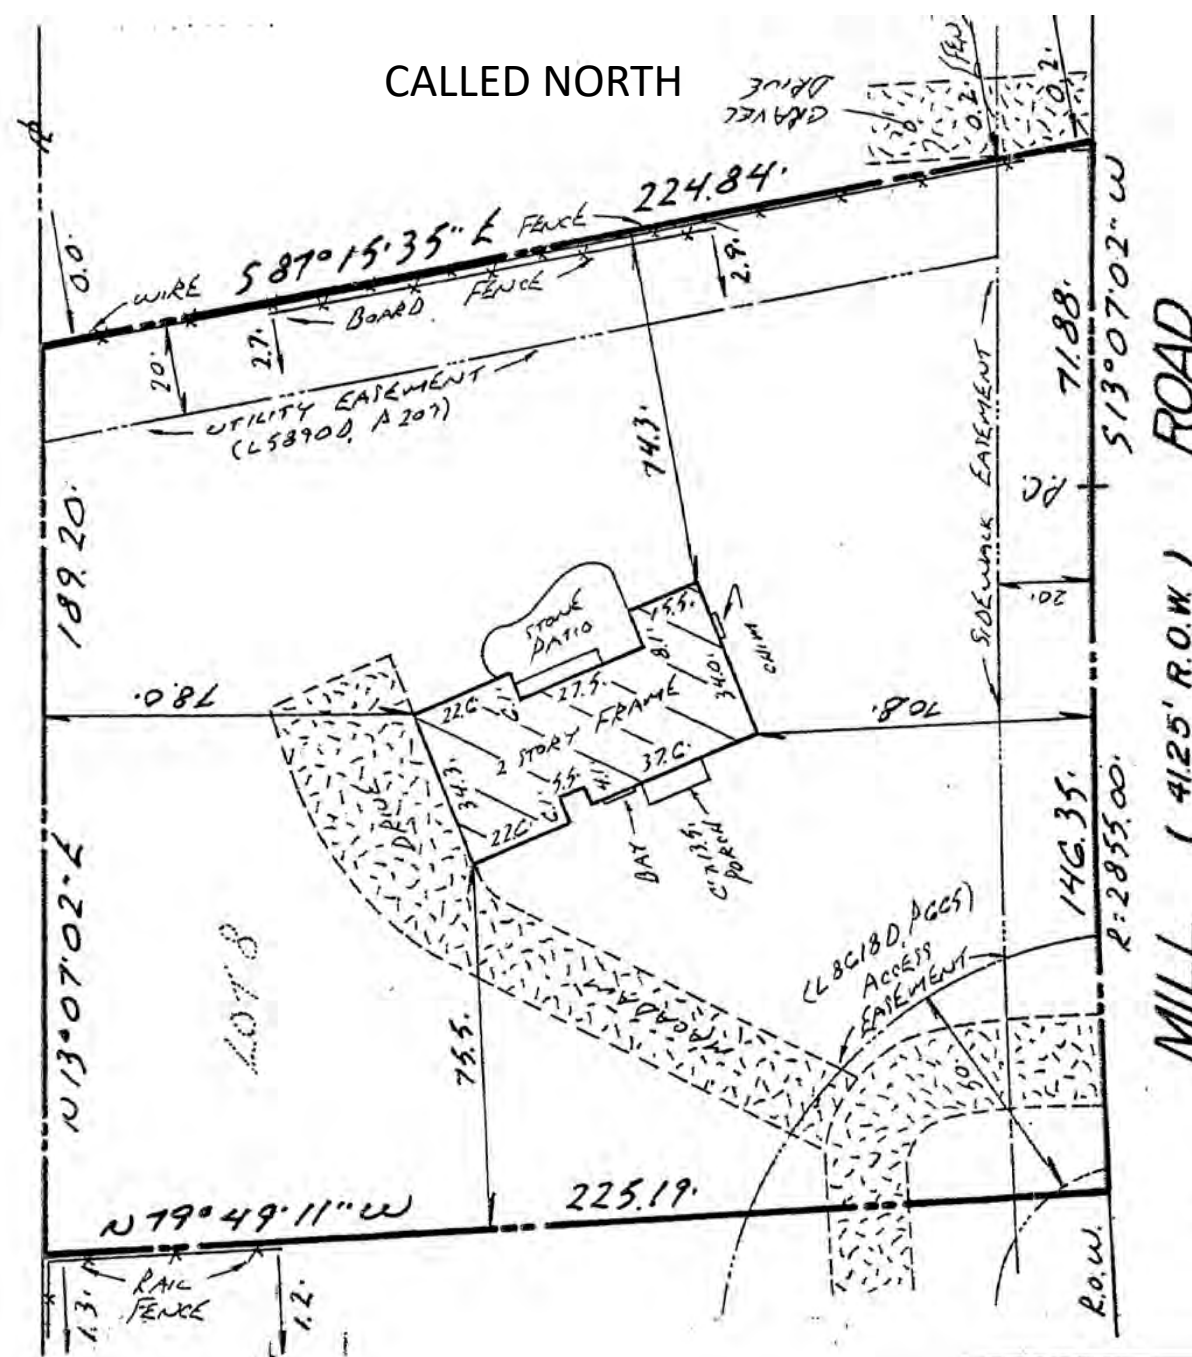
SOUTH ELEVATION



WEST-NW ELEVATION



WEST ELEVATION



SITE PLAN



EAST ELEVATION. (from Mill Rd)

Addition to Home
 111 Mill Road

Town of Pittsford
 County of Monroe


Owners:
 Phillip and Jill Franco

A-1

EXISTING CONTEXT

JULY 6, 2022

CALLED NORTH

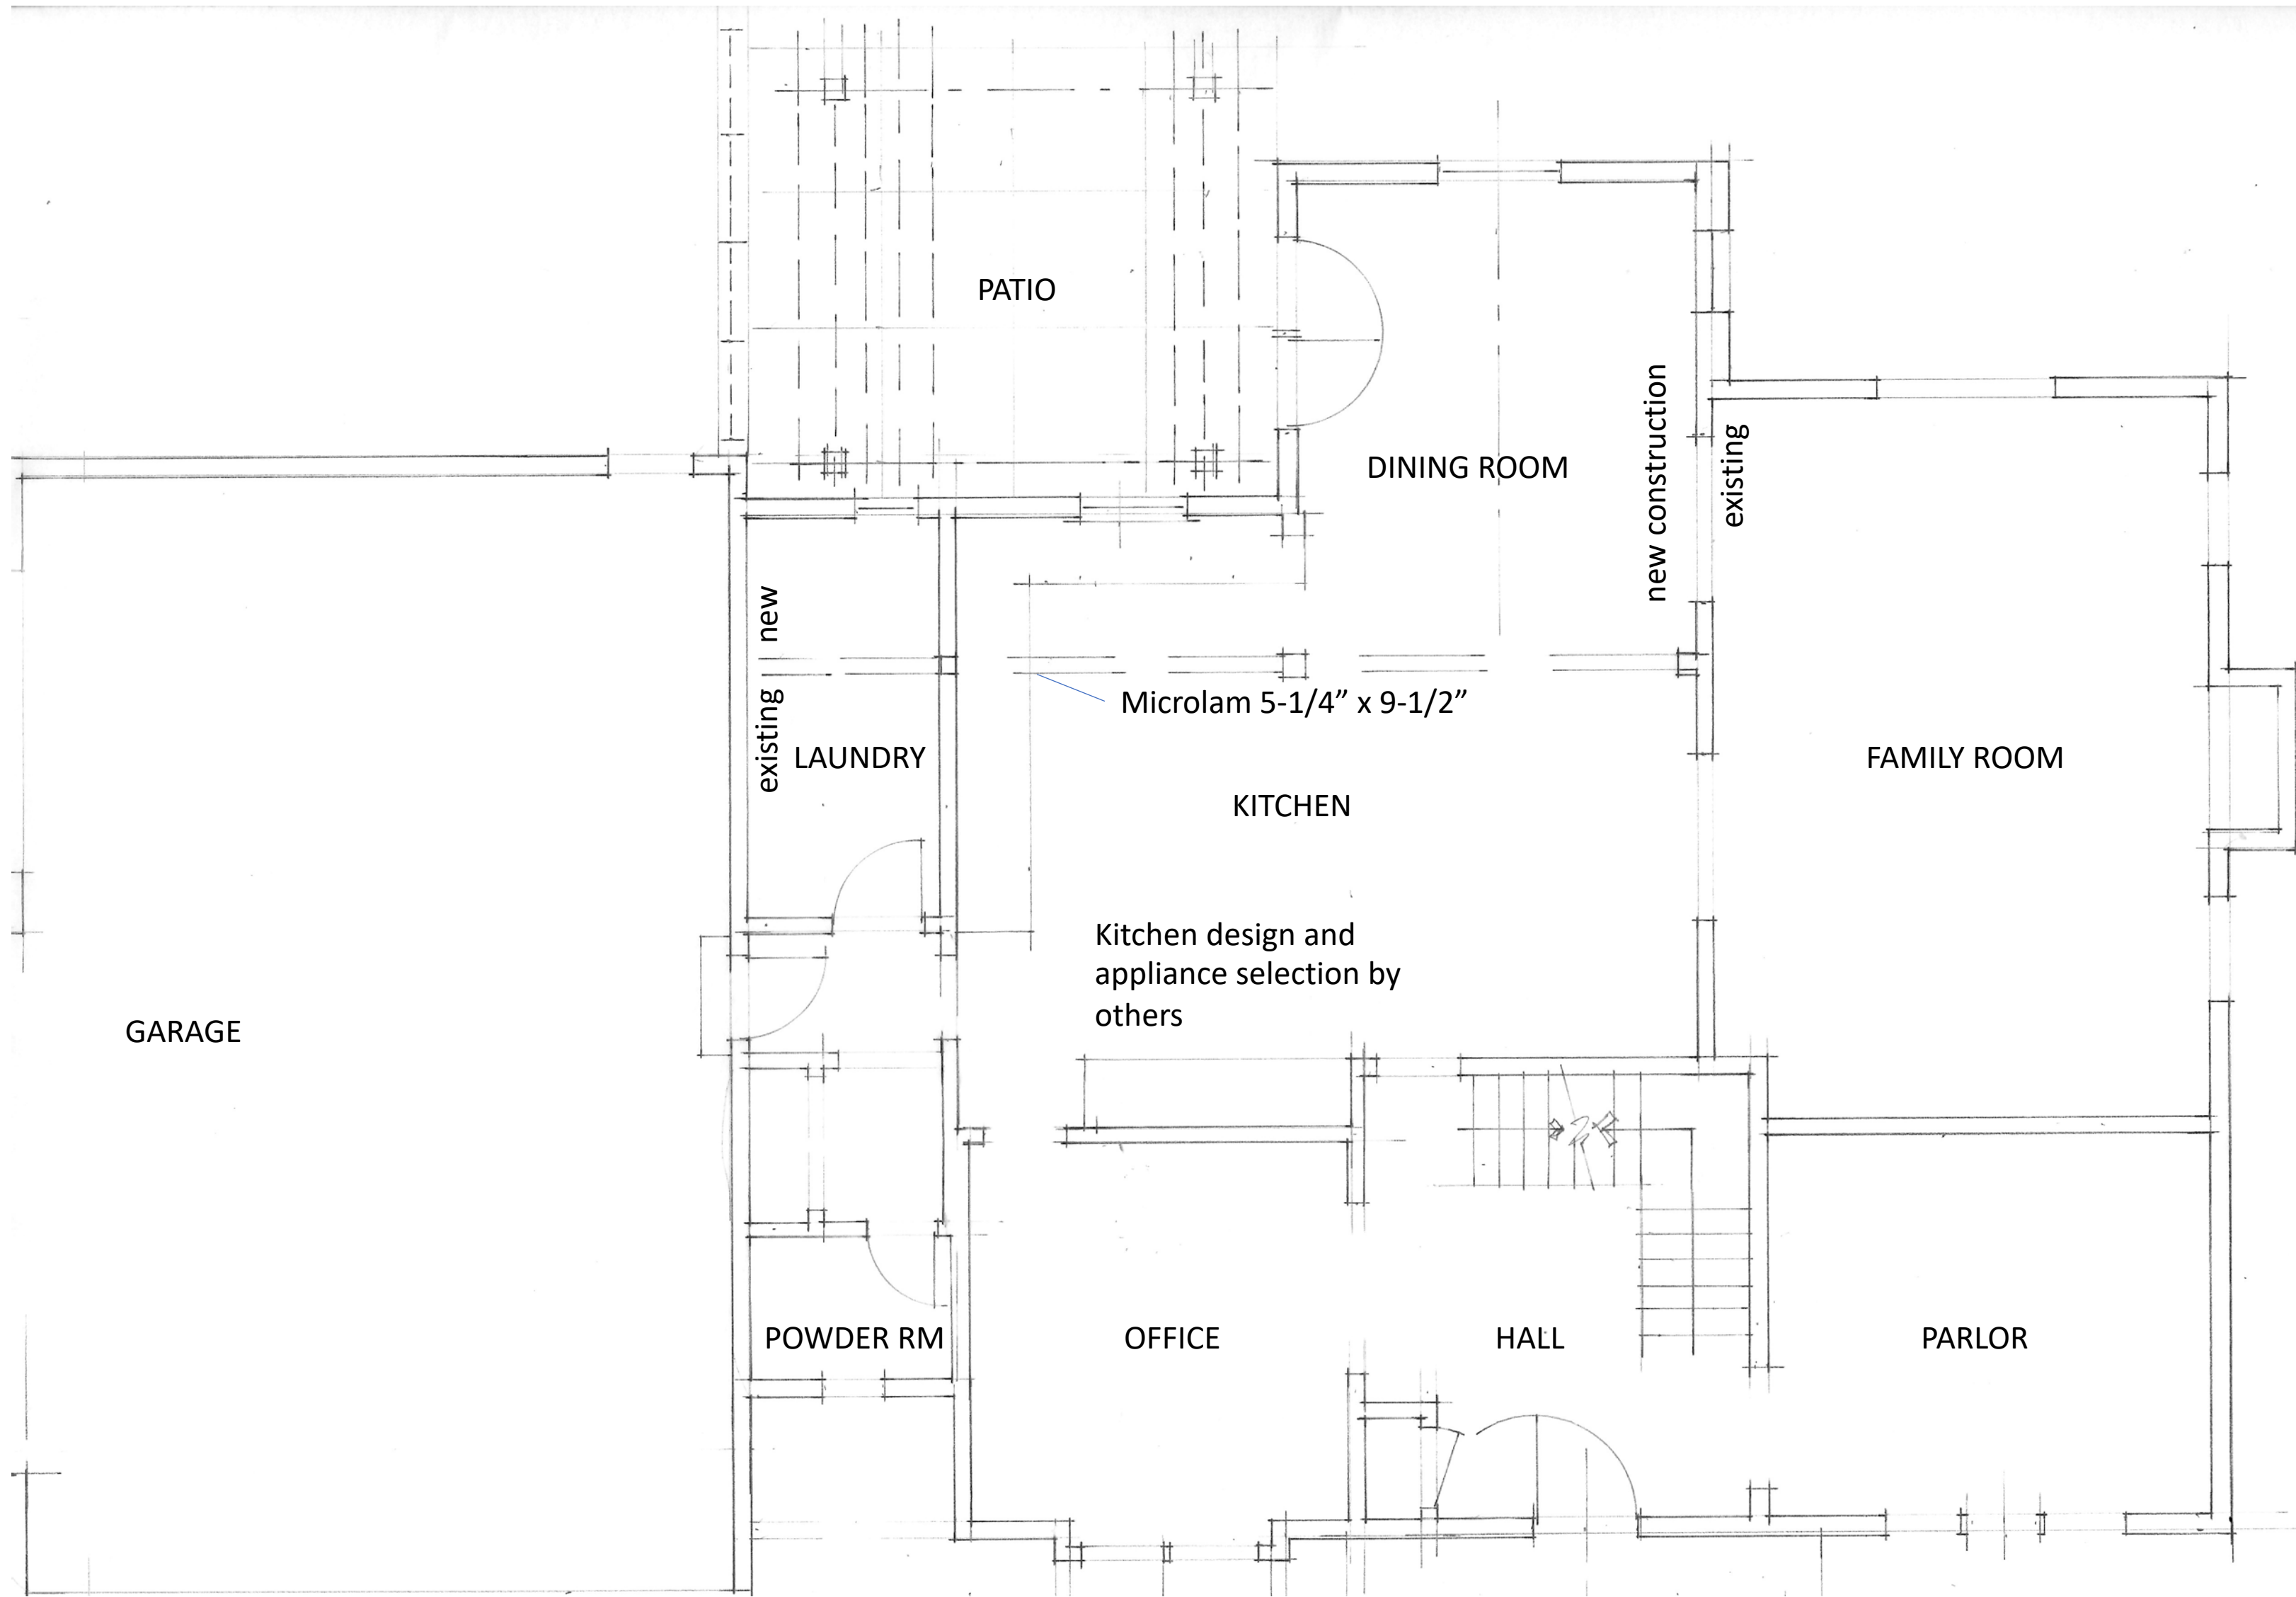

Addition to Home

111 Mill Road

Town of Pittsford

County of Monroe

Owners:
Phillip and Jill Franco

GARAGE

new
existing

LAUNDRY

Microlam 5-1/4" x 9-1/2"

KITCHEN

Kitchen design and
appliance selection by
others

POWDER RM

OFFICE

HALL

PARLOR

GROUND FLOOR PLAN

new construction


existing

FAMILY ROOM

A-2

PLANS

JULY 6, 2022

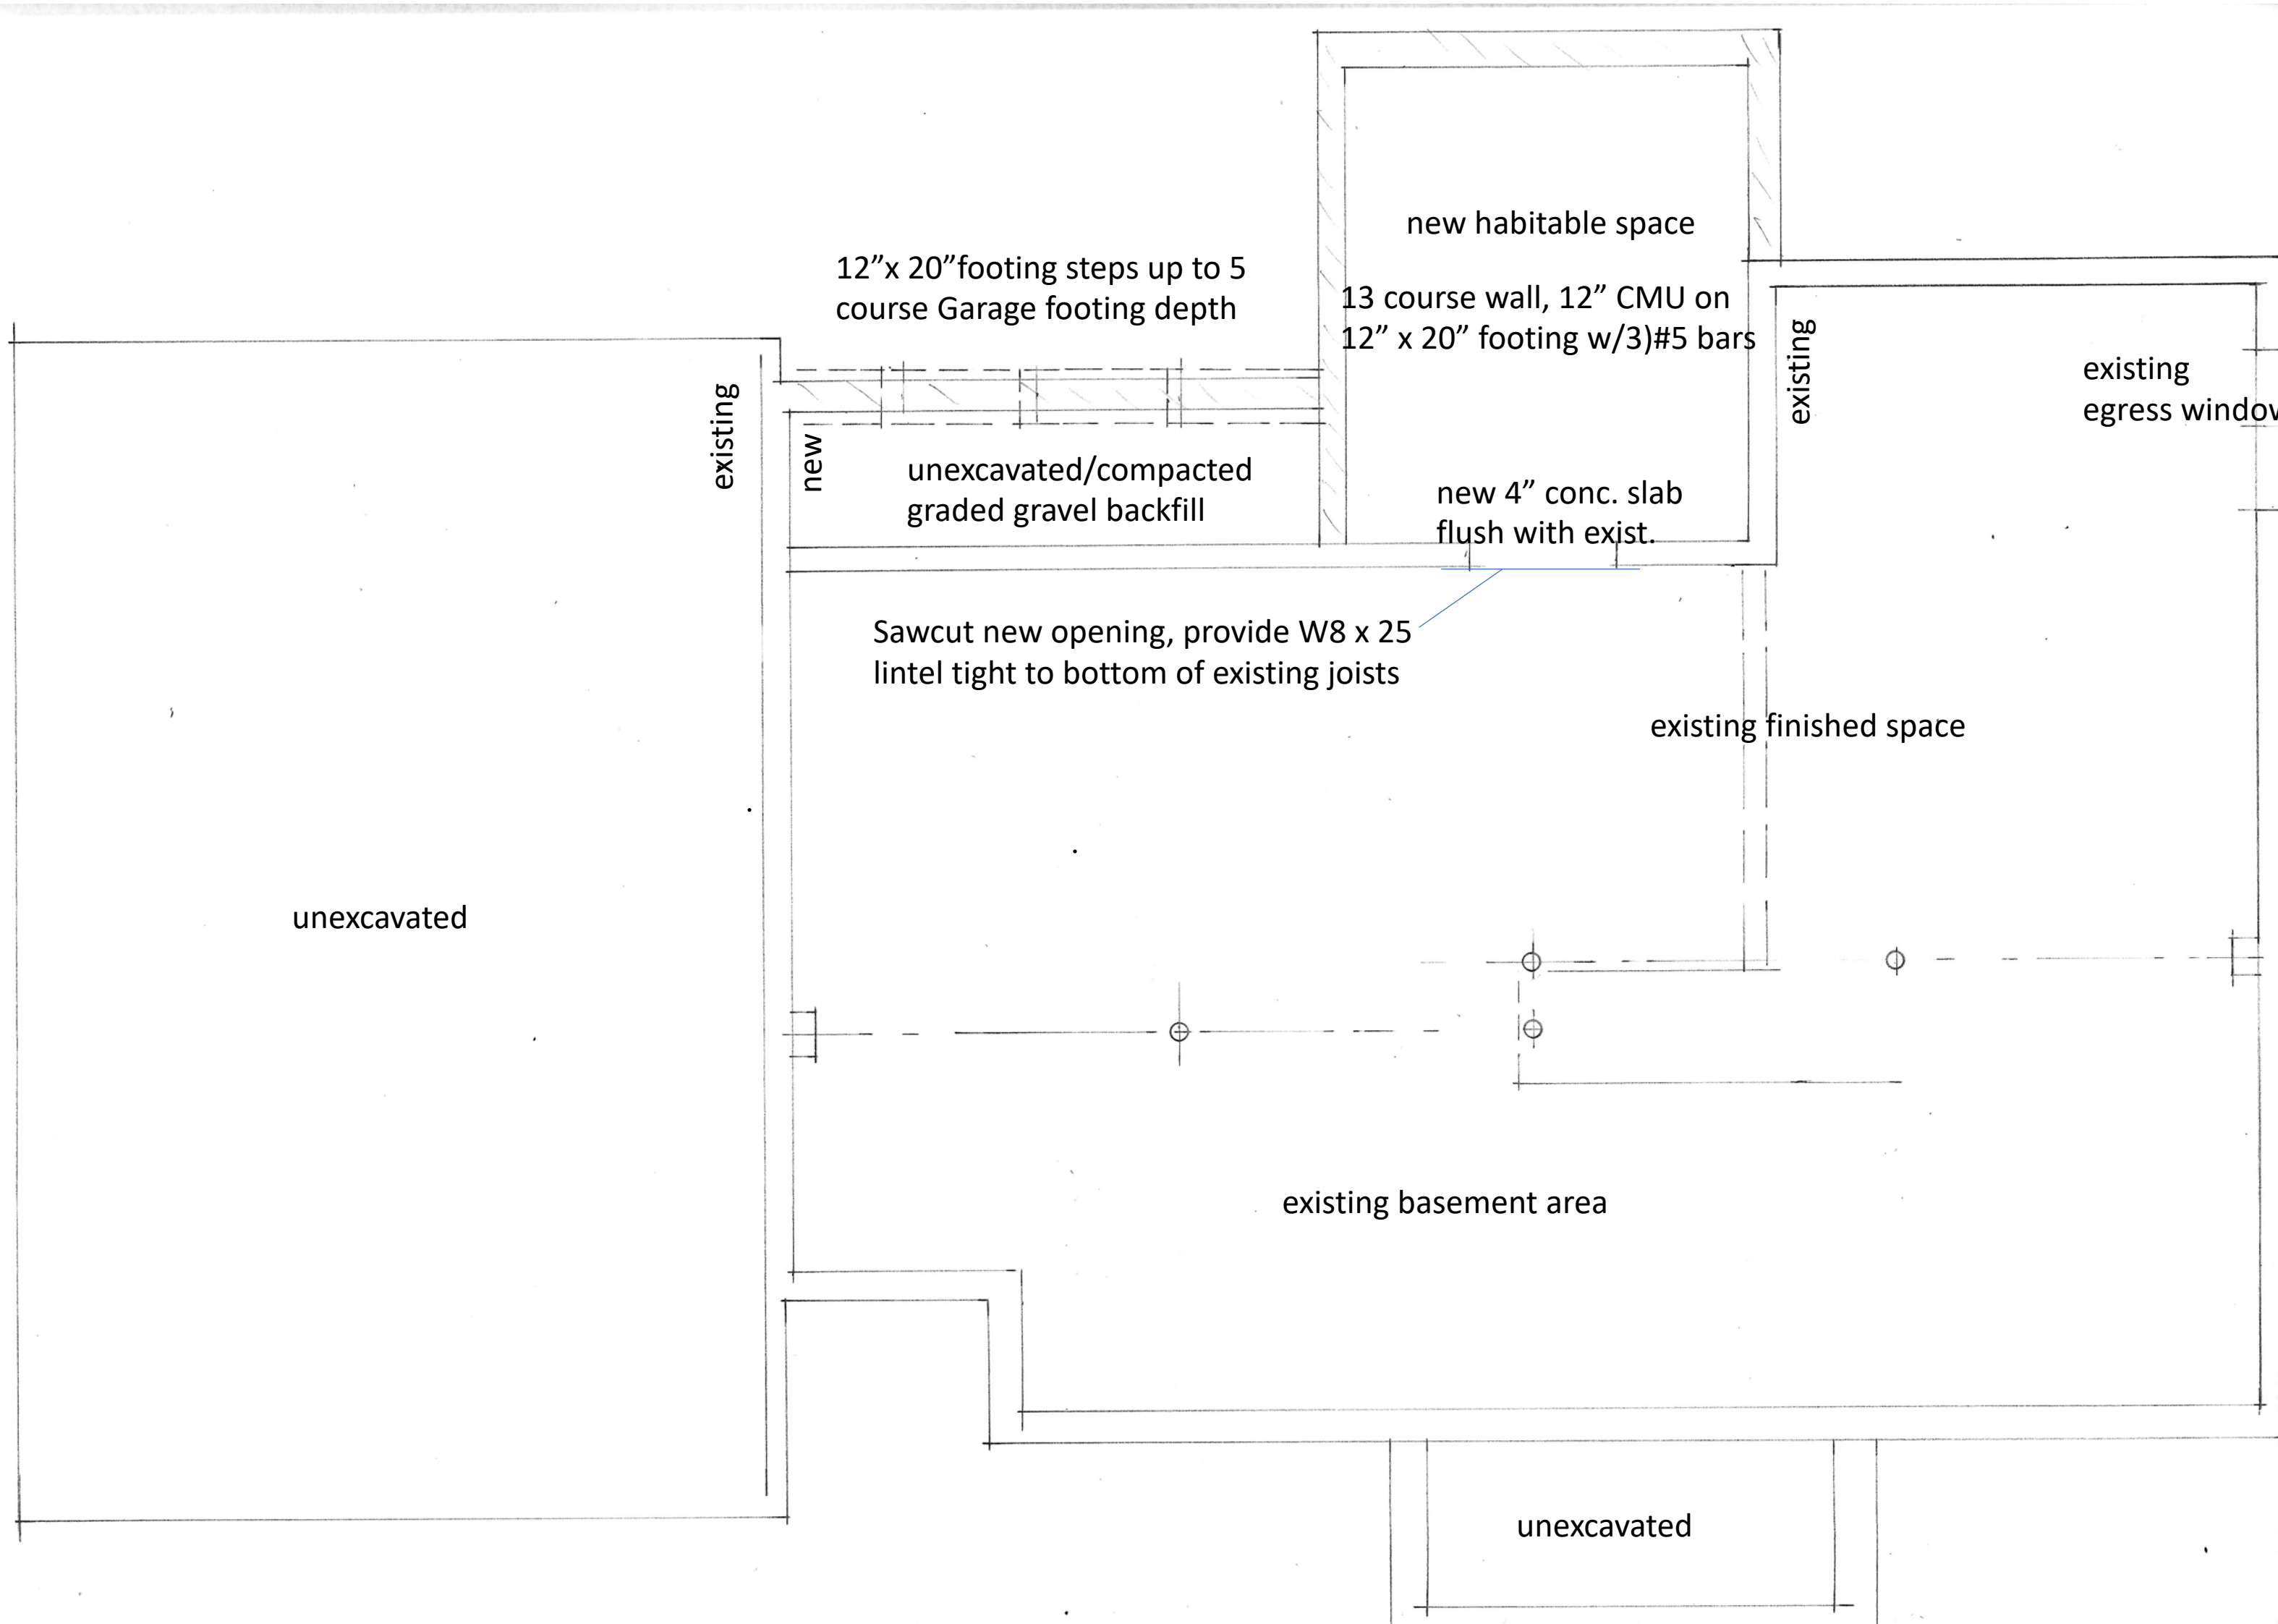

Addition to Home

111 Mill Road

Town of Pittsford

County of Monroe

Owners:
Phillip and Jill Franco

LOWER LEVEL PLAN

A-3

PLANS

JULY 6, 2022

Addition to Home
 111 Mill Road

Town of Pittsford
 County of Monroe

Owners:
 Phillip and Jill Franco



NORTH ELEVATION



UPSLOPE HOMES (FROM PATIO)




NORTH ELEVATION- EXISTING

A-4

ELEVATIONS

JULY 6, 2022

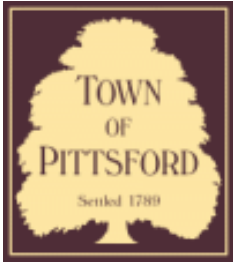

Town of Pittsford

Department of Public Works
11 South Main Street
Pittsford, New York 14534



Phone: 585-248-6250

FAX: 585-248-6262

DESIGN REVIEW AND HISTORIC PRESERVATION BOARD REFERRAL OF APPLICATION

Property Address: 54 Coventry Ridge ,

Tax ID Number:

Zoning District:

Owner: Clover St. Development Corp.

Applicant: Clover St. Development Corp.


Application Type:

- | | |
|---|---|
| <input checked="" type="checkbox"/> Residential Design Review
§185-205 (B) | <input type="checkbox"/> Build to Line Adjustment
§185-17 (B) (2) |
| <input type="checkbox"/> Commercial Design Review
§185-205 (B) | <input type="checkbox"/> Building Height Above 30 Feet
§185-17 (M) |
| <input type="checkbox"/> Signage
§185-205 (C) | <input type="checkbox"/> Corner Lot Orientation
§185-17 (K) (3) |
| <input type="checkbox"/> Certificate of Appropriateness
§185-197 | <input type="checkbox"/> Flag Lot Building Line Location
§185-17 (L) (1) (c) |
| <input type="checkbox"/> Landmark Designation
§185-195 (2) | <input type="checkbox"/> Undeveloped Flag Lot Requirements
§185-17 (L) (2) |
| <input type="checkbox"/> Informal Review | |


Project Description: Applicant is requesting design review for the construction of a two story single family home. The home will have approximately 4342 square feet of livable area and is located in the Coventry Ridge Subdivision.

Meeting Date: July 14, 2022

RN Residential Neighborhood Zoning

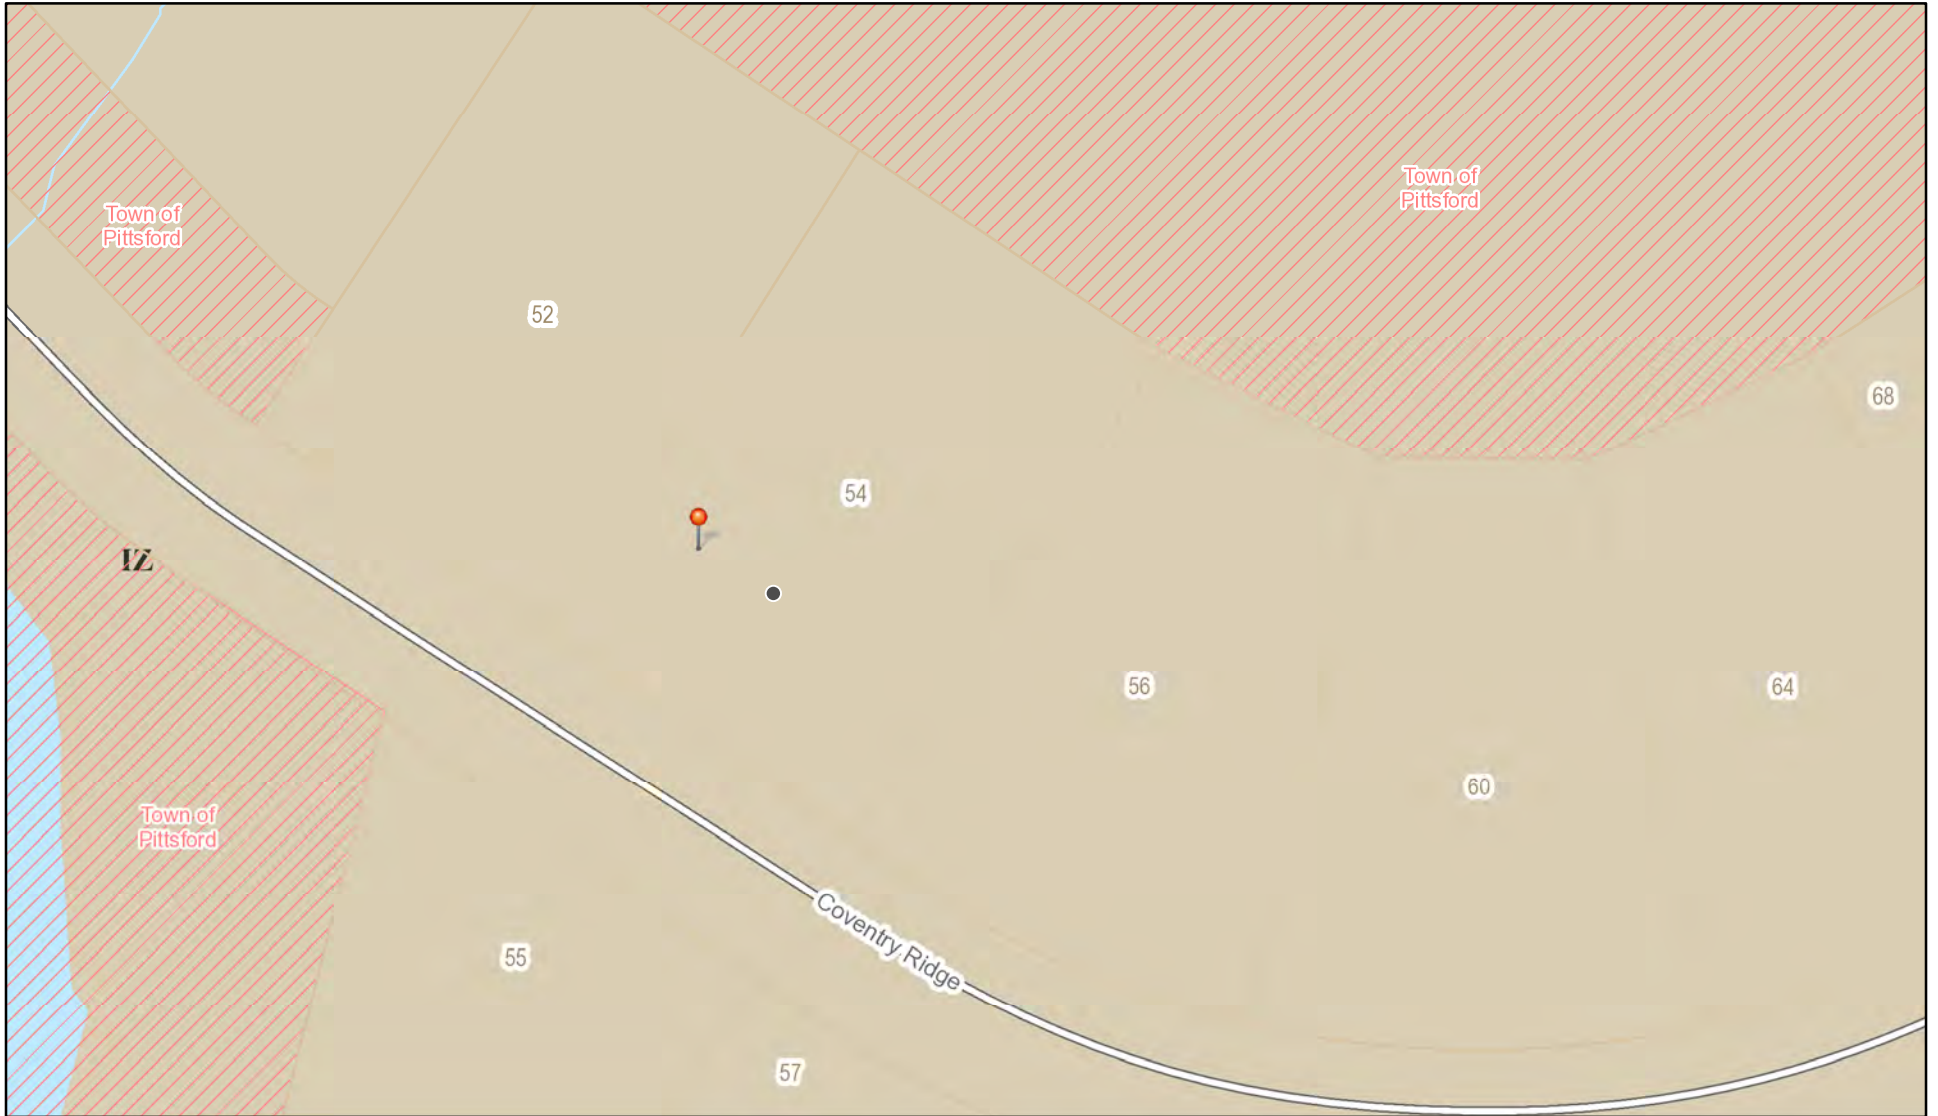

Printed July 6, 2022

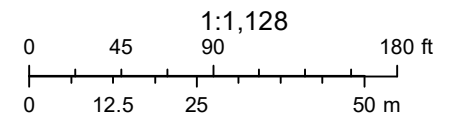

Town of Pittsford GIS

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SPEC HOME

LOT 48 COVENTRY RIDGE

PITTSFORD, NY

COVENTRY RIDGE BUILDING CORP.

PLAN 3566 / PROJECT 15346 E

SHEET INDEX

- C-1 COVER SHEET
- 1/6 FRONT & LEFT ELEVATIONS
- 2/6 REAR & RIGHT ELEVATIONS
- 3/6 FOUNDATION PLAN
- 4/6 FIRST FLOOR PLAN
- 5/6 SECOND FLOOR & ROOF PLAN
- 6/6 SECTIONS
- N-1 DETAILS
- N-2 REINFORCING NOTES

GENERAL NOTES:

THESE PLANS COMPLY WITH THE 2020 RESIDENTIAL CODE OF NEW YORK STATE (RCNYS) AND THE 2018 ENERGY CONSERVATION CONSTRUCTION CODE OF NEW YORK STATE (ECCCNY S).

COMPLIANCE METHOD: RESCHECK CERTIFICATE OR PRESCRIPTIVE

THESE PLANS ARE PROTECTED UNDER FEDERAL COPYRIGHT LAWS BY GREATER LIVING ARCHITECTURE. ANY UNAUTHORIZED REPRODUCTION OR MODIFICATION OF THESE PLANS IS A VIOLATION OF COPYRIGHT LAWS. CLIENT RIGHTS ARE LIMITED TO ONE-TIME USE FOR THE CONSTRUCTION OF THESE PLANS.

UNAUTHORIZED ALTERATIONS OR ADDITIONS TO THIS PLAN IS A VIOLATION OF THE NEW YORK STATE EDUCATION LAW, ARTICLE 145, SECTION 7209.

IT IS THE RESPONSIBILITY OF THE CONTRACTOR, BUILDER OR OWNER OF THIS BUILDING TO NOTIFY GREATER LIVING ARCHITECTURE OF ANY DEVIATION FROM THESE DRAWINGS.

CONTRACTOR TO BE RESPONSIBLE FOR COMPLIANCE WITH ALL APPLICABLE BUILDING/ ELECTRICAL/ MECHANICAL/ SANITARY AND ENERGY CONSERVATION CODES - STATE AND OR LOCAL.

CONTRACTOR TO BE RESPONSIBLE TO LOCAL BUILDING DEPARTMENT AND THAT DEPARTMENT'S INTERPRETATION OF THE BUILDING CODE SHOULD IT DIFFER FROM THESE PLANS.

CONTRACTOR TO BE RESPONSIBLE THAT BRAND NAME OF WINDOWS AND DOORS INSTALLED MEET NEW YORK STATE EXIT REQUIREMENTS.

IN THE EVENT OF ANY DISCREPANCIES BETWEEN PLANS, ELEVATIONS, AND/OR DETAILS, THE CONTRACTOR / SUB-CONTRACTOR SHALL CONTACT GREATER LIVING ARCHITECTURE BEFORE CONSTRUCTION FOR CLARIFICATION. IF GREATER LIVING ARCHITECTURE IS NOT CONTACTED, THE CONTRACTOR / SUB-CONTRACTOR WILL ASSUME FULL RESPONSIBILITY.

CONTRACTOR TO BE RESPONSIBLE FOR CONSTRUCTION MEANS, METHODS, TECHNIQUES, SEQUENCES, PROCEDURES AND SAFETY PRECAUTIONS/ PROGRAMS IN CONNECTION WITH THE WORK.

THESE DRAWINGS ARE NOT TO BE SCALED FOR DIMENSIONS - USE DIMENSIONS GIVEN.

THE CONTRACTOR/ OWNER SHALL REQUEST LOCATION OF ALL UTILITIES PRIOR TO ANY DIGGING.

THE CONTRACTOR SHALL INDEMNIFY THE OWNER AND OWNER'S AGENTS THROUGH ADEQUATE INSURANCE COVERAGE AGAINST ANY CLAIMS ARISING FROM INJURIES DURING CONSTRUCTION, OR FAILURE TO MAINTAIN SAFE CONDITIONS ON THE SITE.

THESE DRAWINGS HAVE BEEN PREPARED FOR STRUCTURAL REFERENCE ONLY. ELECTRICAL, MECHANICAL AND OTHER BUILDING SYSTEMS, IF REQUIRED, ARE TO BE DONE BY OTHERS

R806.2 MINIMUM VENT AREA. THE MINIMUM NET FREE VENTILATION AREA SHALL BE 1/30 OF THE AREA OF THE VENTED SPACE.

GAS PIPING SHALL BE INSTALLED IN ACCORDANCE WITH PART VI OF THE 2020 RCNYS. A SHUTOFF VALVE SHALL BE PROVIDED AHEAD OF EVERY GAS APPLIANCE OR OUTLET FOR A GAS CONNECTION. VALVES SHALL BE LOCATED IN THE SAME ROOM AS, & WITHIN 6' OF THE APPLIANCE. EXCEPT THAT VALVES FOR VENTED GAS FIREPLACES, INSERTS, LOGS & ROOM HEATERS MAY BE REMOTE FROM THE APPLIANCE WHERE PROVIDED WITH READY ACCESS. SUCH VALVES SHALL BE PERMANENTLY IDENTIFIED & SERVE NO OTHER EQUIPMENT. SHUTOFF VALVES SHALL BE INSTALLED IN ACCORDANCE W/ SECTION G242.0.

DRYER EXHAUST DUCTS SHALL HAVE A SMOOTH INTERIOR FINISH & BE CONSTRUCTED OF METAL HAVING A MINIMUM THICKNESS OF 0.0157" (NO. 28 GAUGE), & SHALL BE 4" NOMINAL IN DIAMETER. EXHAUST DUCTS SHALL TERMINATE ON THE OUTSIDE OF THE BUILDING AS PER MANUFACTURER'S INSTALLATION INSTRUCTIONS, BUT NOT LESS THAN 3' IN ANY DIRECTION FROM OPENINGS INTO BUILDINGS.

ENERGY EFFICIENCY:

R401.3 CERTIFICATE (MANDATORY) A PERMANENT CERTIFICATE COMPLETED SHALL BE COMPLETED BY THE BUILDER OR OTHER APPROVED PARTY, AND POSTED ON A WALL IN THE SPACE WHERE THE FURNACE IS LOCATED, A UTILITY ROOM OR AN APPROVED LOCATION INSIDE THE BUILDING.

R402.2.4 ATTIC ACCESS SHALL BE INSULATED WITH THE SAME R- VALUE AS THE ATTIC, WEATHER STRIPPED & LATCHED

R402.4 AIR LEAKAGE. THE BUILDING THERMAL ENVELOPE SHALL BE CONSTRUCTED TO LIMIT AIR LEAKAGE IN ACCORDANCE WITH THE REQUIREMENTS OF SECTIONS R402.4.1 THROUGH R402.4.5.

R402.4.1 BUILDING THERMAL ENVELOPE. THE BUILDING THERMAL ENVELOPE SHALL COMPLY WITH SECTIONS R402.4.1.1 AND R402.4.1.2. THE SEALING METHODS BETWEEN DISSIMILAR MATERIALS SHALL ALLOW FOR DIFFERENTIAL EXPANSION AND CONTRACTION.

R402.4.1.1 INSTALLATION. THE COMPONENTS OF THE BUILDING THERMAL ENVELOPE AS LISTED IN TABLE 402.4.1.1 SHALL BE INSTALLED IN ACCORDANCE WITH THE MANUFACTURER'S INSTRUCTIONS AND THE CRITERIA LISTED IN TABLE R402.4.1.1, AS APPLICABLE TO THE METHOD OF CONSTRUCTION, WHERE REQUIRED BY THE CODE OFFICIAL, AN APPROVED THIRD PARTY SHALL INSPECT ALL COMPONENTS AND VERIFY COMPLIANCE. SEE PAGE N-2 FOR TABLE.

R402.4.1.2 TESTING. THE BUILDING OR DUELLING UNIT SHALL BE TESTED AND VERIFIED AS HAVING AN AIR LEAKAGE RATE NOT EXCEEDING THREE AIR CHANGES PER HOUR. TESTING SHALL BE CONDUCTED IN ACCORDANCE WITH RESNET/ACC 380, ASTM E779, OR ASTM E1827 AND REPORTED AT A PRESSURE OF 0.2 INCH w.g. (50 PASCALS). TESTING SHALL BE PERFORMED AT ANY TIME AFTER CREATION OF ALL PENETRATIONS OF THE BUILDING THERMAL ENVELOPE. A WRITTEN REPORT OF THE TEST RESULTS SHALL BE SUPPLIED TO THE CODE OFFICIAL PRIOR TO RECEIPT OF A C OF O. THE CONTRACTOR SHALL BE RESPONSIBLE TO PROVIDE AN APPROVED PARTY INDEPENDENT OF THE INSULATION INSTALLER TO DO THE INSPECTIONS

DURING TESTING:

1. EXTERIOR WINDOWS AND DOORS, FIREPLACES AND STOVE DOORS SHALL BE CLOSED, BUT NOT SEALED, BEYOND THE INTENDED WEATHERSTRIPPING OR OTHER INFILTRATION CONTROL MEASURES.
2. DAMPERS INCLUDING EXHAUST, INTAKE, MAKEUP AIR, BACKDRAFT AND FLUE DAMPERS SHALL BE CLOSED, BUT NOT SEALED BEYOND INTENDED INFILTRATION CONTROL MEASURES.
3. INTERIOR DOORS, IF INSTALLED AT THE TIME OF THE TEST, SHALL BE OPEN.
4. EXTERIOR DOORS FOR CONTINUOUS VENTILATION SYSTEMS AND HEAT RECOVERY VENTILATORS SHALL BE CLOSED AND SEALED.
5. HEATING AND COOLING SYSTEMS, IF INSTALLED AT THE TIME OF REST, SHALL BE TURNED OFF.
6. SUPPLY AND RETURN REGISTERS, IF INSTALLED AT THE TIME OF REST, SHALL BE FULLY OPEN.

R402.4.5 RECESSED LIGHTING. RECESSED LUMINAIRES INSTALLED IN THE BUILDING THERMAL ENVELOPE SHALL BE SEALED TO LIMIT AIR LEAKAGE BETWEEN CONDITIONED AND UNCONDITIONED SPACES. RECESSED LUMINAIRES SHALL BE IC-RATED AND LABELED AS HAVING AN AIR LEAKAGE RATE OF NOT GREATER THAN 2.0 c.f.m (0.944 L/s) WHEN TESTED IN ACCORDANCE WITH ASTM E283 AT A PRESSURE DIFFERENTIAL OF 1.57 p.s.f. (75 Pa). RECESSED LUMINAIRES SHALL BE SEALED WITH A GASKET OR CAULKED BETWEEN THE HOUSING AND THE INTERIOR WALL OR CEILING COVERING.

R402.5 MAXIMUM FENESTRATION U-FACTOR & SHGC (MANDATORY). THE AREA-WEIGHTED AVERAGE MAXIMUM FENESTRATION U-FACTOR PERMITTED USING TRADEOFFS FROM SECT. R402.1.5 OR R405 SHALL BE .48 IN CLIMATE ZONES 4 & 5 AND 0.40 IN CLIMATE ZONES 6-8 FOR VERTICAL FENESTRATION, & 0.75 IN CLIMATE ZONES 4-8 FOR SKYLIGHTS. THE AREA-WEIGHTED AVERAGE MAXIMUM FENESTRATION SHGC PERMITTED USING TRADEOFFS FROM SECTION R405 IN CLIMATE ZONES 1-3 SHALL BE 0.50

R403.1.1 PROGRAMMABLE THERMOSTAT. THE THERMOSTAT CONTROLLING THE PRIMARY HEATING AND COOLING SYSTEM SHALL BE CAPABLE OF CONTROLLING THE HEATING AND COOLING SYSTEM ON A DAILY SCHEDULE TO MAINTAIN DIFFERENT TEMPERATURE SET POINTS AT DIFFERENT TIMES OF THE DAY. THIS THERMOSTAT SHALL INC. THE CAPABILITY TO SET BACK OR TEMP. OPERATE THE SYSTEM TO MAINTAIN ZONE TEMPERATURES DOWN TO 55 DEG OR UP TO 85 DEG. THE THERMOSTAT SHALL INITIALLY BE PROGRAMMED BY THE MANF. WITH A HEATING TEMP. SET POINT NO HIGHER THAN 70 DEG. & A COOLING TEMP. SET POINT NO LOWER THAN 78 DEG.

R403.1.2 HEAT PUMP SUPPLEMENTARY HEAT (MANDATORY). HEAT PUMPS HAVING SUPPLEMENTARY ELECTRIC- RESISTANCE HEAT SHALL HAVE CONTROLS THAT, EXCEPT DURING DEFROST, PREVENT SUPPLEMENTAL HEAT OPERATION WHEN THE HEAT PUMP COMPRESSOR CAN MEET THE HEATING LOAD.

R403.3.1 INSULATION (PRESCRIPTIVE) SUPPLY & RETURN DUCTS IN ATTICS SHALL BE INSULATED TO A MIN. OF R-8. WITH THE EXCEPTION OF DUCTS OR PORTIONS THEREOF LOCATED COMPLETELY INSIDE THE BUILDING THERMAL ENVELOPE.

R403.3.2 SEALING (MANDATORY). DUCTS, AIR HANDLERS AND FILTER BOXES SHALL BE SEALED. JOINTS AND SEAMS SHALL COMPLY WITH EITHER THE MECHANICAL CODE OF NEW YORK STATE (MCONYS) OR RCNYS, AS APPLICABLE.

R403.3.3 DUCT TESTING (MANDATORY). DUCTS SHALL BE PRESSURE TESTED TO DETERMINE AIR LEAKAGE BY ONE OF THE FOLLOWING METHODS:

1. ROUGH IN TEST: TOTAL LEAKAGE SHALL BE MEASURED WITH A PRESSURE DIFFERENTIAL OF 0.1 INCH w.g. (25 Pa) ACROSS THE SYSTEM, INCLUDING THE MANUFACTURER'S AIR HANDLER ENCLOSURE IF INSTALLED AT THE TIME OF THE TEST. ALL REGISTERS SHALL BE TAPED OR OTHERWISE SEALED DURING THE TEST.
2. POSTCONSTRUCTION TEST: TOTAL LEAKAGE SHALL BE MEASURED WITH A PRESSURE DIFFERENTIAL OF 0.1 INCH w.g. (25 Pa) ACROSS THE SYSTEM, INCLUDING THE MANUFACTURER'S AIR HANDLER ENCLOSURE. ALL REGISTERS SHALL BE TAPED OR OTHERWISE SEALED DURING THE TEST.

R403.3.5 BUILDING CAVITIES (MANDATORY). BUILDING FRAMING CAVITIES SHALL NOT BE USED AS DUCTS OR PLENUMS.

R403.4 MECHANICAL SYSTEM PIPING CAPABLE OF CARRYING FLUIDS ABOVE 105 DEGREES F OR BELOW 55 DEGREES F SHALL BE INSULATED TO A MINIMUM OF R-3.

R403.5.1 HEATED WATER CIRCULATION & TEMPERATURE MAINTENANCE SYSTEMS (MANDATORY). HEATED WATER CIRCULATION SYSTEMS SHALL BE IN ACCORDANCE WITH SECTION R403.5.1.1. HEAT TRACE TEMPERATURE MAINTENANCE SYSTEMS SHALL BE IN ACCORDANCE WITH SECTION R403.5.1.2. AUTOMATIC CONTROLS, TEMPERATURE SENSORS & PUMPS SHALL BE ACCESSIBLE. MANUAL CONTROLS SHALL BE READILY ACCESSIBLE.

R403.5.3 HOT WATER PIPE INSULATION (PRESCRIPTIVE). INSULATION FOR HOT WATER PIPE WITH A MIN. R-3 SHALL BE APPLIED TO THE FOLLOWING:

1. PIPING 3/4" AND LARGER IN NOMINAL DIAMETER.
2. PIPING SERVING MORE THAN ONE DUELLING UNIT.
3. PIPING LOCATED OUTSIDE THE CONDITIONED SPACE.
4. PIPING FROM THE WATER HEATER TO A DISTRIBUTION MANIFOLD.
5. PIPING LOCATED UNDER A FLOOR SLAB.
6. BURIED IN PIPING.
7. SUPPLY & RETURN PIPING IN RECIRCULATION SYSTEMS OTHER THAN DEMAND RECIRCULATION SYSTEMS

R403.6 MECHANICAL VENTILATION (MANDATORY). THE BUILDING SHALL BE PROVIDED WITH VENTILATION THAT MEETS THE REQUIREMENTS OF THE IRC OR IMC, AS APPLICABLE, OR WITH OTHER APPROVED MEANS OF VENTILATION. OUTDOOR AIR INTAKES AND EXHAUSTS SHALL HAVE AUTOMATIC OR GRAVITY DAMPERS THAT CLOSE WHEN THE VENTILATION SYSTEM IS NOT OPERATING

R403.6.1 WHOLE-HOUSE MECHANICAL VENTILATION SYSTEM FAN EFFICACY. MECHANICAL VENTILATION SYSTEM FANS SHALL MEET THE EFFICACY REQUIREMENTS OF TABLE R403.6.1.

R403.7 EQUIPMENT SIZING & EFFICIENCY RATING (MANDATORY). HEATING & COOLING EQUIPMENT SHALL BE SIZED IN ACCORDANCE W/ ACCA MANUAL S BASED ON BUILDING LOADS CALCULATED IN ACCORDANCE W/ ACCA MANUAL J OR OTHER APPROVED HEATING & COOLING CALCULATION METHODOLOGIES. NEW OR REPLACEMENT HEATING & COOLING EQUIPMENT SHALL HAVE A EFFICIENCY RATING EQUAL TO OR GREATER THAN THE MINIMUM REQUIRED BY FEDERAL LAW FOR THE GEOGRAPHIC LOCATION WHERE THE EQUIPMENT IS INSTALLED.

R404.1 LIGHTING EQUIPMENT (MANDATORY) A MINIMUM OF 90% OF THE LAMPS IN PERMANENTLY INSTALLED LIGHTING FIXTURES SHALL BE HIGH-EFFICACY LAMPS.

SITE WORK:

THESE PLANS HAVE BEEN PREPARED ACCORDING TO THE 2020 RCNYS AND IECC REQUIREMENTS TO SUIT A GENERAL RANGE OF CONDITIONS THAT MAY BE AFFECTED BY A PARTICULAR BUILDING SITE OR BUILDER/ OWNER CONTRACTUAL AGREEMENT. CONTRACTOR TO BE RESPONSIBLE TO ADAPT THESE PLANS TO SUIT THE NEEDS OF THE BUILDING ON SITE AS REQUIRED, PROVIDED THAT SUCH ADJUSTMENTS DO NOT VIOLATE THE CODE OR ALTER THE STRUCTURAL INTEGRITY OF THE BUILDING.

CONTRACTOR/ OWNER SHALL PERFORM EXPLORATORY EXCAVATION TO DETERMINE ACTUAL FIELD CONDITIONS AND NOTIFY THIS OFFICE OF THE FINDINGS TO ALLOW FOR DESIGN CHANGES PRIOR TO ACTUAL CONSTRUCTION. IT SHALL BE THE RESPONSIBILITY OF THE CONTRACTOR/ OWNER TO DEVELOP THE NECESSARY FOUNDATION SOIL TO SUSTAIN THE LOAD DESIGNS OF 2500 P.S.F. AND TO HIRE, IF NECESSARY, A SOILS ENGINEER TO INSPECT AND VERIFY SOIL CONDITIONS PRIOR TO POURING OF FOUNDATIONS.

THE CONTRACTOR, BUILDER OR OWNER SHALL NOTIFY GREATER LIVING ARCHITECTURE OF ANY UNUSUAL SITE CONDITIONS WHICH MAY AFFECT THE FOUNDATION, DRAINAGE OR STRUCTURAL MEMBERS INCLUDING REQUIREMENTS FOR ADDITIONAL DEPTH OF FOOTINGS, UNSTABLE SOIL CONDITIONS AND HIGH GROUND WATER TABLE.

NO SITE INSPECTIONS ARE TO BE MADE BY THIS OFFICE. CONTRACTOR TO BE RESPONSIBLE FOR MATERIALS AND WORKMANSHIP. SUBSTITUTIONS FOR MATERIALS SPECIFIED TO BE MADE WITH THE PERMISSION OF THE LOCAL BUILDING DEPT.

FOUNDATION:

THE BOTTOM OF ALL FOOTINGS SHALL BE AT LEAST 48" BELOW FINISHED GRADE & TO REST ON (ORIGINAL) UNDISTURBED SOIL & ASSUMED MINIMUM SOIL BEARING PRESSURE TO BE 2500 P.S.F. CONTRACTOR TO BE RESPONSIBLE FOR ALL SUBGRADE CONDITIONS.

BASEMENT/CELLAR WALLS AND FOOTING DESIGNS ASSUMED PARTIALLY SATURATED SOIL CONDITIONS TO THE FULL WALL DEPTH. SHOULD SATURATED CONDITIONS BE ENCOUNTERED, OUR OFFICE SHOULD BE CONTACTED FOR REVIEW AND POSSIBLE REVISIONS TO THE PLANS.

CONTRACTOR ASSUMES FULL RESPONSIBILITY FOR PROVIDING PROPER DRAINAGE SHOULD INTERMITTENT SPRINGS OR PERCHED WATER BE ENCOUNTERED.

POSITIVE DRAINAGE SHALL BE PROVIDED SO THAT FINISHED GRADE SLOPES AWAY FROM PERIMETER WALLS & FOOTINGS. CONTINUOUS 4" DIAM. PERFORATED DRAIN PIPE BE PLACED ALONG THE PERIMETER OF THE BASEMENT WALLS WHICH DRAINS TO THE SUMP PUMP. A MINIMUM OF 6" GRANULAR BASE SHALL BE PLACED OVER THE DRAIN TILE AND MINIMUM OF 2" UNDER THE TILE.

CONCRETE AND MASONRY FOUNDATION WALLS SHALL BE CONSTRUCTED AS SET FORTH AS PER TABLES ON N-2.

FIREPLACES:

VENTED GAS FIREPLACE SHALL BE LISTED, LABELED & INSTALLED IN ACCORDANCE WITH ANSI Z21.50, SECT. G2434 OF THE 2020 RCNYS & THE MANUFACTURER'S INSTRUCTIONS. INSTRUCTIONS SHALL BE AVAILABLE ON SITE FOR BUILDING INSPECTOR. APPLIANCE SHALL BE EQUIPPED WITH A FLAME SAFEGUARD DEVICE IN ACCORDANCE WITH SECT. G2431.

NEW WOOD-BURNING FIREPLACES SHALL HAVE TIGHT-FITTING FLUE DAMPERS OR DOORS, AND OUTDOOR COMBUSTION AIR, WHERE USING TIGHT-FITTING DOORS ON FACTORY BUILT FIREPLACES LISTED AND LABELED IN ACCORDANCE WITH UL 127, THE DOORS SHALL BE TESTED AND LISTED FOR THE FIREPLACE. WHERE USING TIGHT FITTING DOORS ON MASONRY FIREPLACES, THE DOORS SHALL BE LISTED AND LABELED IN ACCORDANCE WITH UL 907.

FRAMING:

WOOD ROOF TRUSSES ARE TO BE METAL PLATE CONNECTED WOOD CHORD, WOOD WEB TRUSSES. TRUSS LAYOUT IS SCHEMATIC ONLY. TRUSS MANUFACTURER SHALL BE RESPONSIBLE FOR THE DESIGN (INCLUDING SPACING) OF ALL TRUSSES. TRUSSES TO BE DESIGNED AND CERTIFIED BY AN ENGINEER LICENSED IN THE GOVERNING STATE.

PROVIDE ALL TEMPORARY BRACING AND SHORING TO AVOID EXCESSIVE STRESSES AND HOLD STRUCTURAL ELEMENTS IN PLACE DURING CONSTRUCTION.

UNDER ALL CONCEALED WOOD BEARING POSTS, PROVIDE ADDITIONAL WOOD BLOCKING AS REQUIRED IN FLOOR JOIST SPACE UNDER POST, TO ENSURE SOLID BEARING FROM HEADER OR BEAM DOWN TO FOUNDATION WALL.

ALL WINDOWS AND DOORS ARE TO BE FRAMED WITH MINIMUM (2)2X8 OR (3)2X6 HEADER UNLESS NOTED OTHERWISE.

BUILDER ASSUMES FULL RESPONSIBILITY FOR MAINTAINING THE STRUCTURAL INTEGRITY OF JOISTS, BEAMS OR STUDS WHICH ARE NOTCHED OR DRILLED TO ACCOMMODATE MECHANICAL OR ELECTRICAL LINES. SEE DETAILS ON PG. N-1 FOR ALLOWABLE DRILLING LOCATION ON BEAMS AND JOISTS.

ALL STRESS GRADE LUMBER CONSTRUCTION SHALL COMPLY WITH AITC TIMBER CONSTRUCTION STANDARDS LATEST EDITION. EACH PIECE SHALL BEAR THE STAMP OF A GRADING RULES AGENCY, APPROVED BY THE AMERICAN LUMBER STANDARDS COMMITTEE. GRADE LOSS RESULTING FROM EFFECTS OF WEATHER, HANDLING, STORAGE, RESAULING, OR DIVIDING LENGTHS WILL BE CAUSE FOR REJECTION.

ALL WOOD, IN CONTACT WITH CONCRETE OR EXPOSED TO THE ELEMENTS, SHALL BE PRESSURE TREATED OR OF A SPECIES SUITABLE FOR OUTDOOR USE. ALL FASTENER, JOIST HANGERS, & FLASHING SHALL BE HOT DIP GALVANIZED, STAINLESS STEEL, SILICON, BRONZE, OR COPPER, & SHALL BE APPROVED BY THE MANUFACTURER FOR USE W/ PRESSURE TREATED WOOD.

FLASHING IS REQUIRED IN THE FOLLOWING LOCATIONS: AT WALL & ROOF INTERSECTIONS & PROJECTING WOOD TRIM, TOP OF ALL EXTERIOR WINDOWS & DOOR OPENINGS, CHIMNEYS UNDER & AT ENDS OF MASONRY, WOOD OR METAL COPINGS & SILLS, & WHERE EXTERIOR PORTCHES, DECKS OR STAIRS ATTACH TO A WALL OR FLOOR ASSEMBLY OF WOOD-FRAMED CONSTRUCTION & BUILT-IN QUITCHES. FLASHINGS SHALL BE PROVIDED AS REQ'D. TO COMPLY WITH ALL OF SECT. R703.4 OF THE 2020 RCNYS.

STRUCTURAL COLUMNS SHALL BE RESTRAINED TO PREVENT LATERAL DISPLACEMENT AT THE BOTTOM END. WOOD COLUMNS SHALL NOT BE LESS IN NOMINAL SIZE THAN 4" X 4" & STEEL COLUMNS SHALL NOT BE LESS THAN 3" DIAM. STANDARD PIPE OR APPROVED EQUIVALENT.

STAIRWAY & GUARD REQUIREMENTS:

STAIRWAYS SHALL BE AT LEAST 36" WIDE. TREADS SHALL BE AT LEAST 9" DEEP PLUS 3/4" TO 1 1/4" NOSING FOR CLOSED RISER TYPE, OR 9" FOR OPEN RISER TYPE. RISERS SHALL BE NO MORE THAN 8 1/4" HIGH. STAIRS SHALL COMPLY WITH SECTION R311.7 OF THE 2020 RCNYS.

HANDRAILS SHALL BE PROVIDED ON AT LEAST ONE SIDE OF STAIRWAYS WITH FOUR OR MORE RISERS. TOP SURFACE OF HANDRAILS SHALL BE BETWEEN 34" & 36" ABOVE TREAD NOSING.

GUARDS SHALL BE LOCATED ALONG AN OPEN SIDE WALKING SURFACE THAT ARE LOCATED MORE THAN 30 INCHES MEASURED VERTICALLY TO THE FLOOR OR GRADE BELOW AT ANY POINT WITHIN 36 INCHES HORIZONTALLY TO THE EDGE OF THE OPEN SIDE. REQUIRED GUARDS SHALL NOT BE LESS THAN 36" IN HEIGHT MEASURED VERTICALLY ABOVE WALKING SURFACE.

REQUIRED GUARDS SHALL NOT HAVE OPENINGS FROM THE WALKING SURFACE TO THE REQUIRED GUARD HEIGHT THAT ALLOW THE PASSAGE OF A SPHERE 4 INCHES IN DIAMETER. AS PER SECTION 312.1.3 OF THE 2020 RCNYS.

GARAGE FIREPROOFING:

3/4 HOUR FIRE RESISTANCE RATING REQUIRED BETWEEN HOUSE & GARAGE CAN BE ACHIEVED WITH ONE LAYER 5/8" TYPE X DRYWALL ON GARAGE SIDE AND ONE LAYER 1/2" TYPE X DRYWALL ON THE HOUSE SIDE.

IF HORIZONTAL CONSTRUCTION IS USED TO SEPARATE THE GARAGE FROM LIVING AREA OR BONUS AREAS ABOVE, THEN ONE LAYER OF 5/8" TYPE X DRYWALL ON THE CEILING IS REQUIRED, WHERE THE HORIZONTAL CONSTRUCTION IS A FLOOR-CEILING ASSEMBLY, THE STRUCTURE SUPPORTING THE SEPARATION SHALL ALSO PROTECTED BY 5/8" TYPE X DRYWALL.

STRUCTURAL MATERIAL SPECIFICATIONS:


STRUCTURAL STEEL	ASTM A-36, Fy = 36 ksi
REINFORCED STEEL	ASTM A-615, Fy = 40 ksi
WIRE MESH	ASTM A-185, 6 x 6 - 10/10 W.W.M.
LUMBER	ALL STRUCTURAL MEMBERS, JOISTS, RAFTERS, ETC. TO BE #2 GRADE LUMBER (DOUGLAS FIR-LARCH, HEM-FIR, SOUTHERN PINE OR SPRUCE PINE-FIR) WITH A MIN. FIBER STRESS OF 850 P.S.I. UNLESS NOTED OTHERWISE
PLYWOOD	CDX, PANEL INDEX
LVL, PSL, LSL	Fb = 2600 Fv = 285 E x 10 ³ = 1.9 Fc = 750
MASONRY	ASTM C90, GRADE N-1, Fm = 1350 PSI
MORTAR	ASTM C270, TYPE S
GROUT	Fc = 2000 PSI ASTM C476
CONCRETE	Fc = 2500 PSI MIN. (FOOTINGS, BASEMENT SLAB) Fc = 3500 PSI MIN. (GARAGE SLAB, PORCH SLAB, & POURED FOUNDATION WALLS)
BOLTS	ASTM A307, Fy = 33 KSI

DESIGN CRITERIA: (FOR GREATER ROCHESTER AREA & ADJACENT COUNTIES)


LOCAL JURISDICTION DESIGN CRITERIA MAY VARY AND SHALL BE STRICTLY ADHERED TO	
1ST FLOOR LIVING AREA LIVE LOAD	40 P.S.F.
2ND FLOOR LIVING AREA LIVE LOAD	30 P.S.F.
1ST & 2ND FLOOR DEAD LOAD	15 P.S.F.
GROUND SNOW LOAD	40 P.S.F.
ROOF DEAD LOAD	10 P.S.F.
ALLOWABLE SOIL BEARING	2500 P.S.F. AT MINIMUM 42" BELOW FINISHED GRADE
WIND SPEED	115 MPH, EXPOSURE B
SEISMIC DESIGN	CATEGORY B
WEATHERING	SEVERE
FROST LINE DEPTH	42 INCHES
TERMITE DAMAGE	SLIGHT TO MODERATE
DECAY DAMAGE	NONE TO SLIGHT
WINTER DESIGN TEMPERATURE	1 DEGREE
ICE SHIELD UNDERLAYMENT	REQUIRED 24" INSIDE OF EXTERIOR WALL LINE
FLOOD HAZARD	FIRM - 2008
ROOF TIE DOWN REQUIREMENTS	R802.11, BASED UPON SPECIFIC ROOF DESIGN

TRUSS IDENTIFICATION:

IDENTIFICATION OF FLOOR AND ROOF TRUSS CONSTRUCTION SHALL BE PROVIDED BY SIGN OR SYMBOL & SHALL BE AFFIXED TO THE EXTERIOR WALL OF THE RESIDENTIAL STRUCTURE IN COMPLIANCE WITH 19 NYCRR PART 1264 & 1265. RESIDENTIAL STRUCTURES WITH TRUSS TYPE CONSTRUCTION, PRE-ENGINEERED WOOD CONSTRUCTION AND / OR TIMBER CONSTRUCTION.

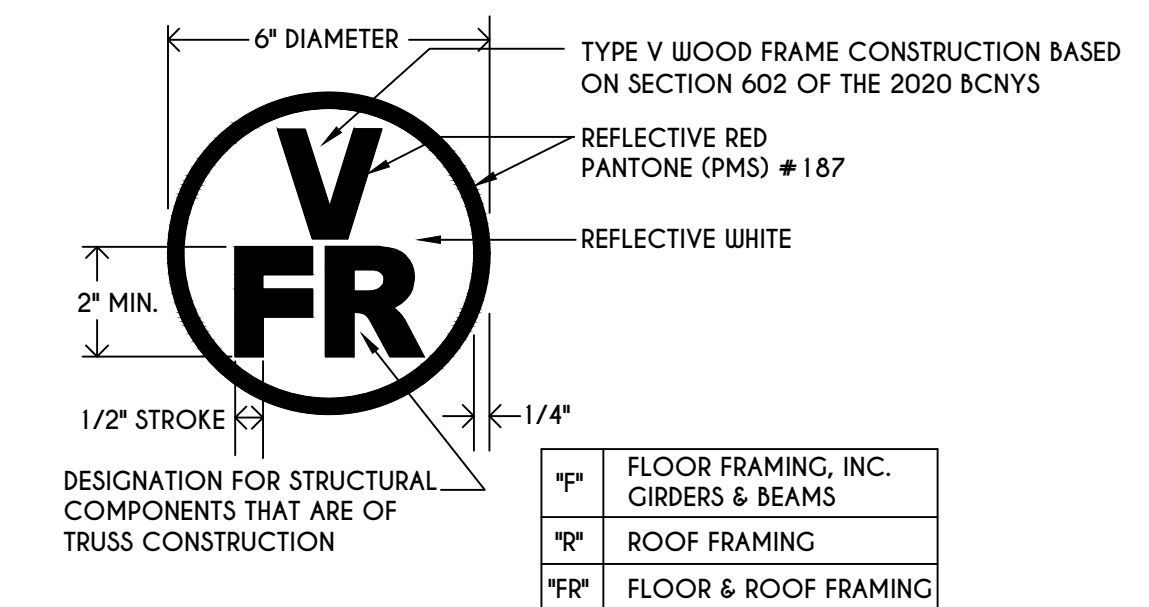

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DATE	BY	DESCRIPTION

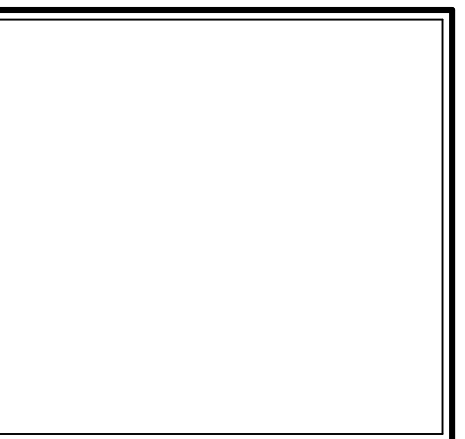CLIENT/LOCATION:

SPEC HOME
LOT 49 COVENTRY RIDGE
PITTSFORD, NY

BUILDER:


COVENTRY RIDGE
BUILDING CORP.

COVER PAGE

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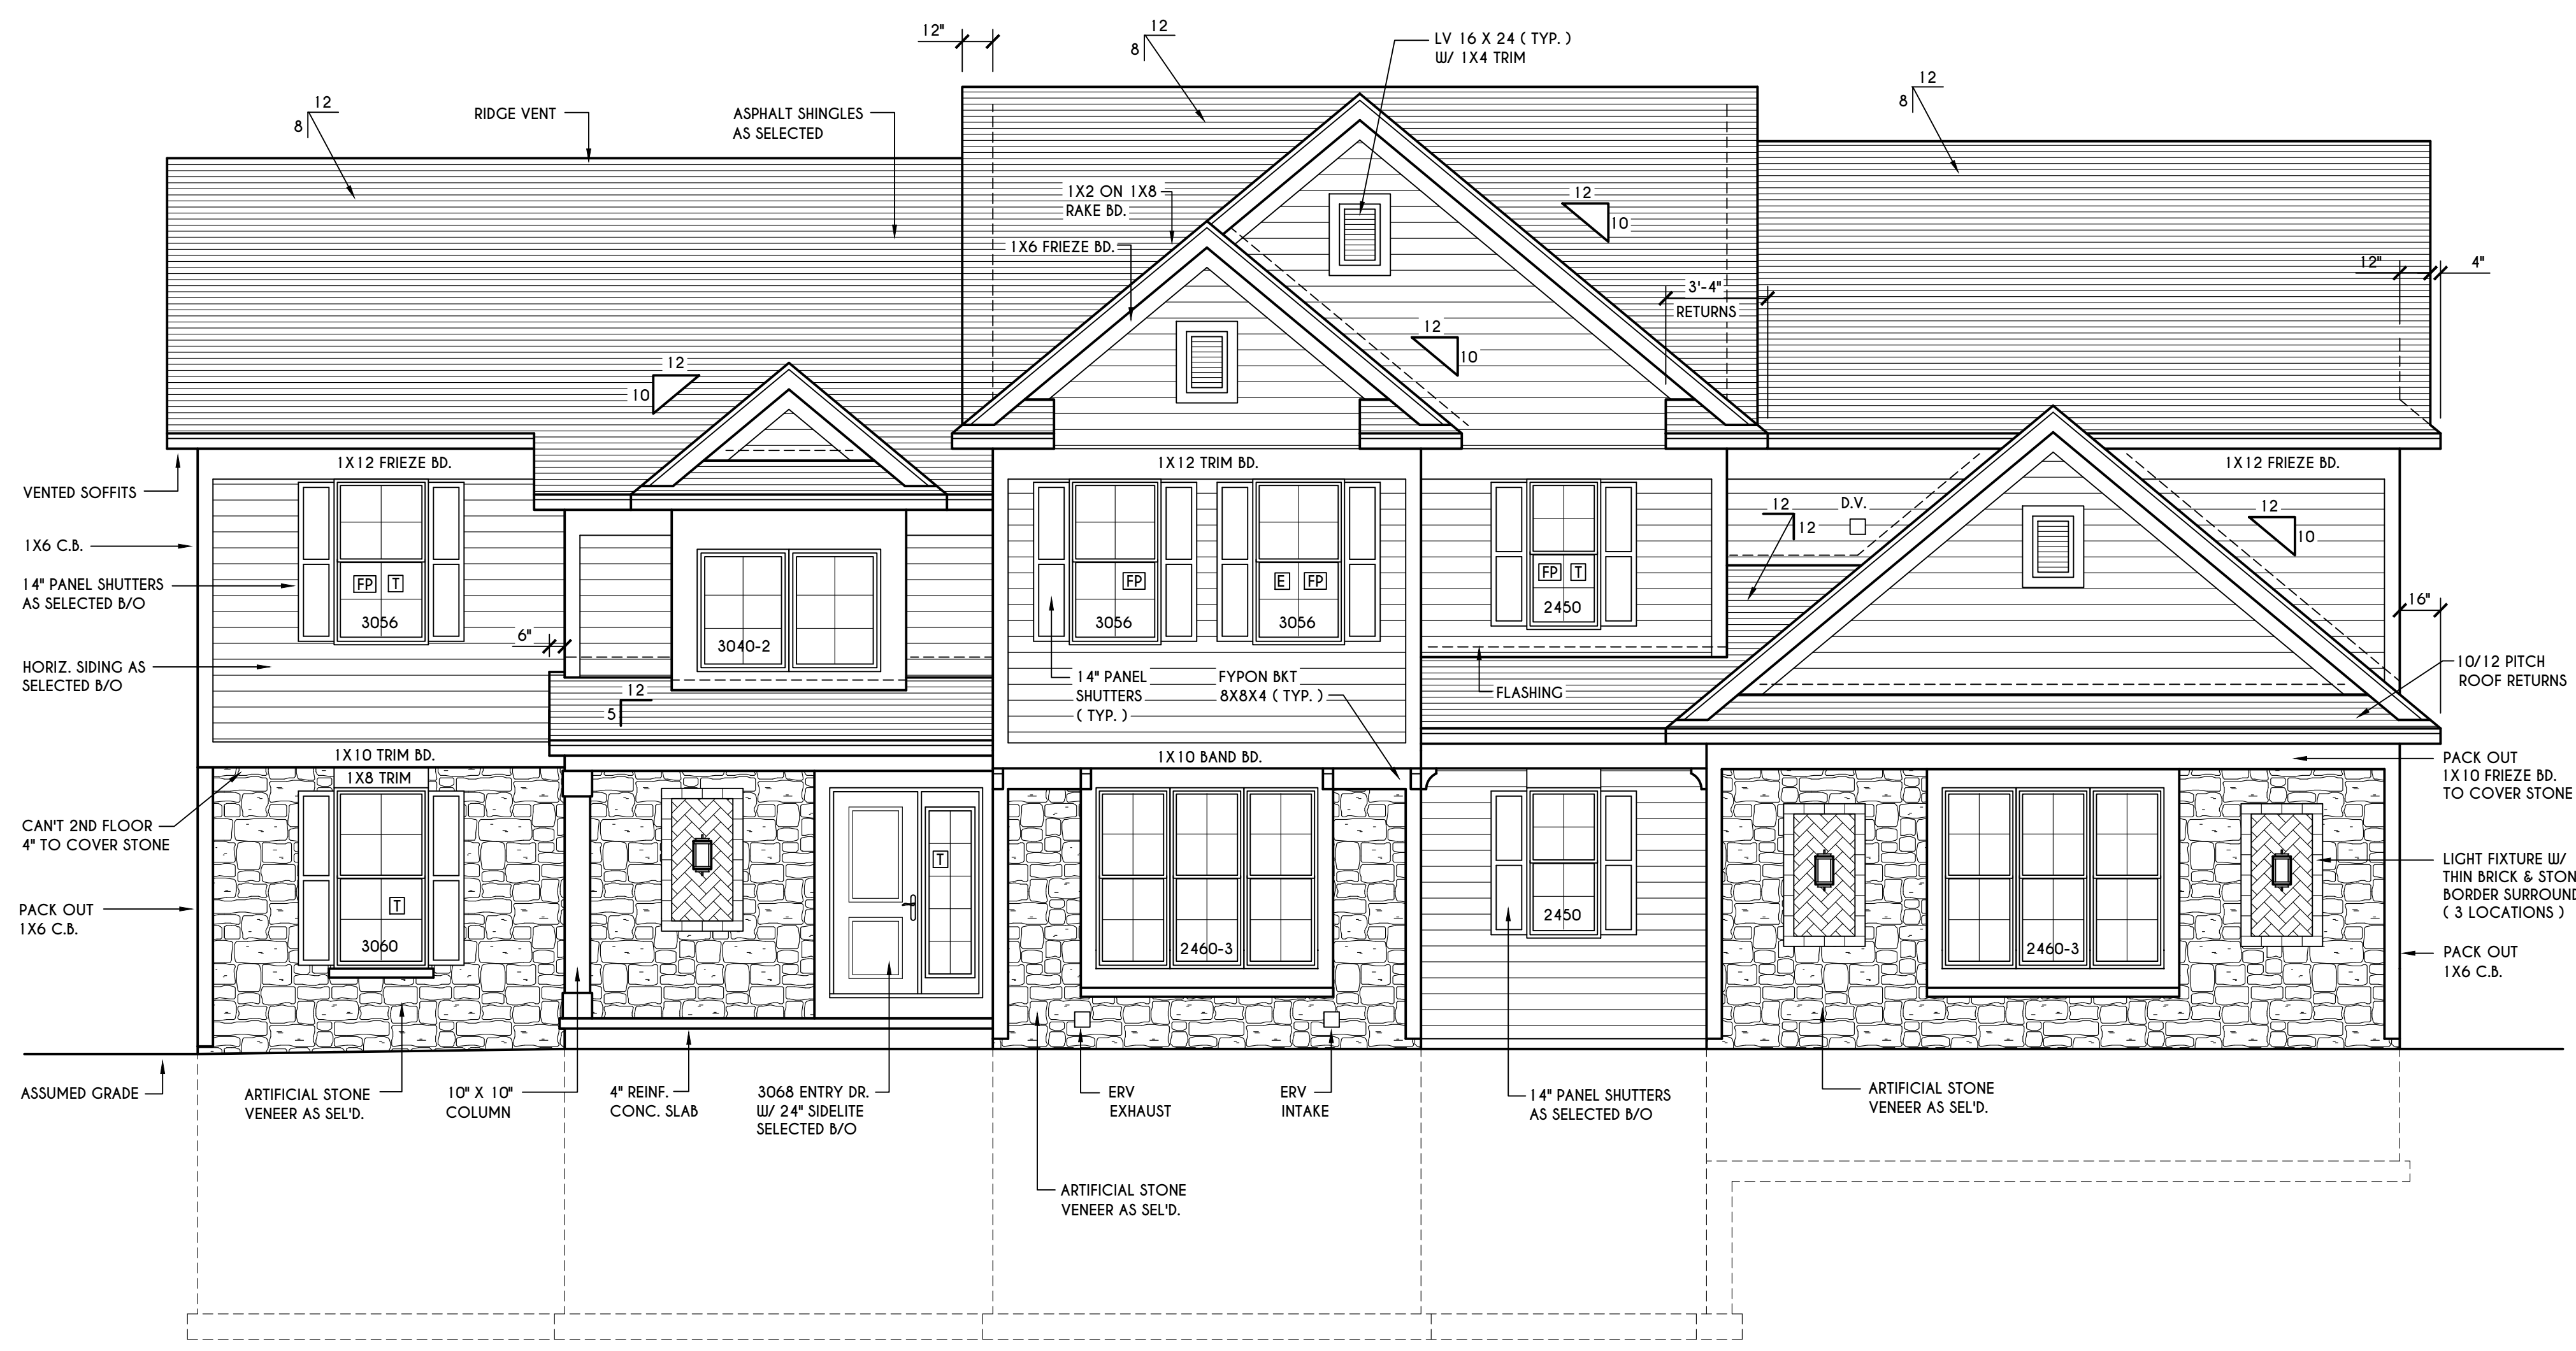
BUILDER:

COVENTRY RIDGE
 BUILDING CORP.


ELEVATIONS

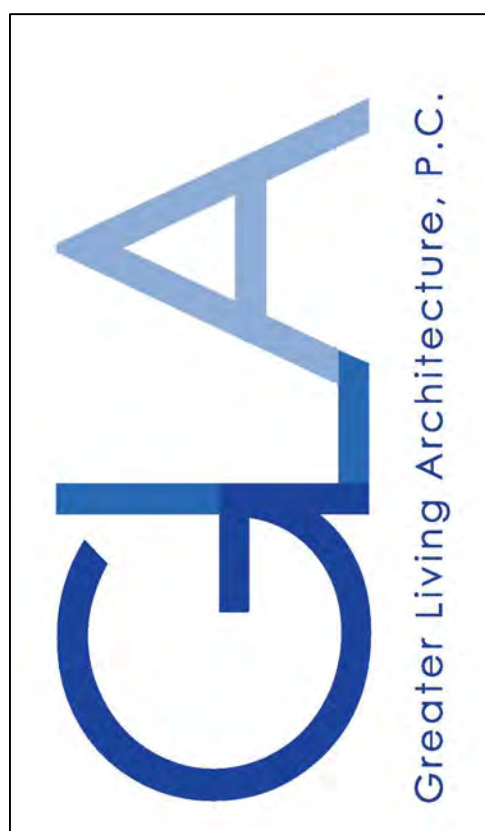GLA PLAN 3566

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HOUSE FOOTPRINT
 SCALE: 1" = 50'-0"



WINDOWS: VIVID SOLAR GAIN GLASS W/ ARGON
 U-FACTOR 0.30
 SHGC 0.54

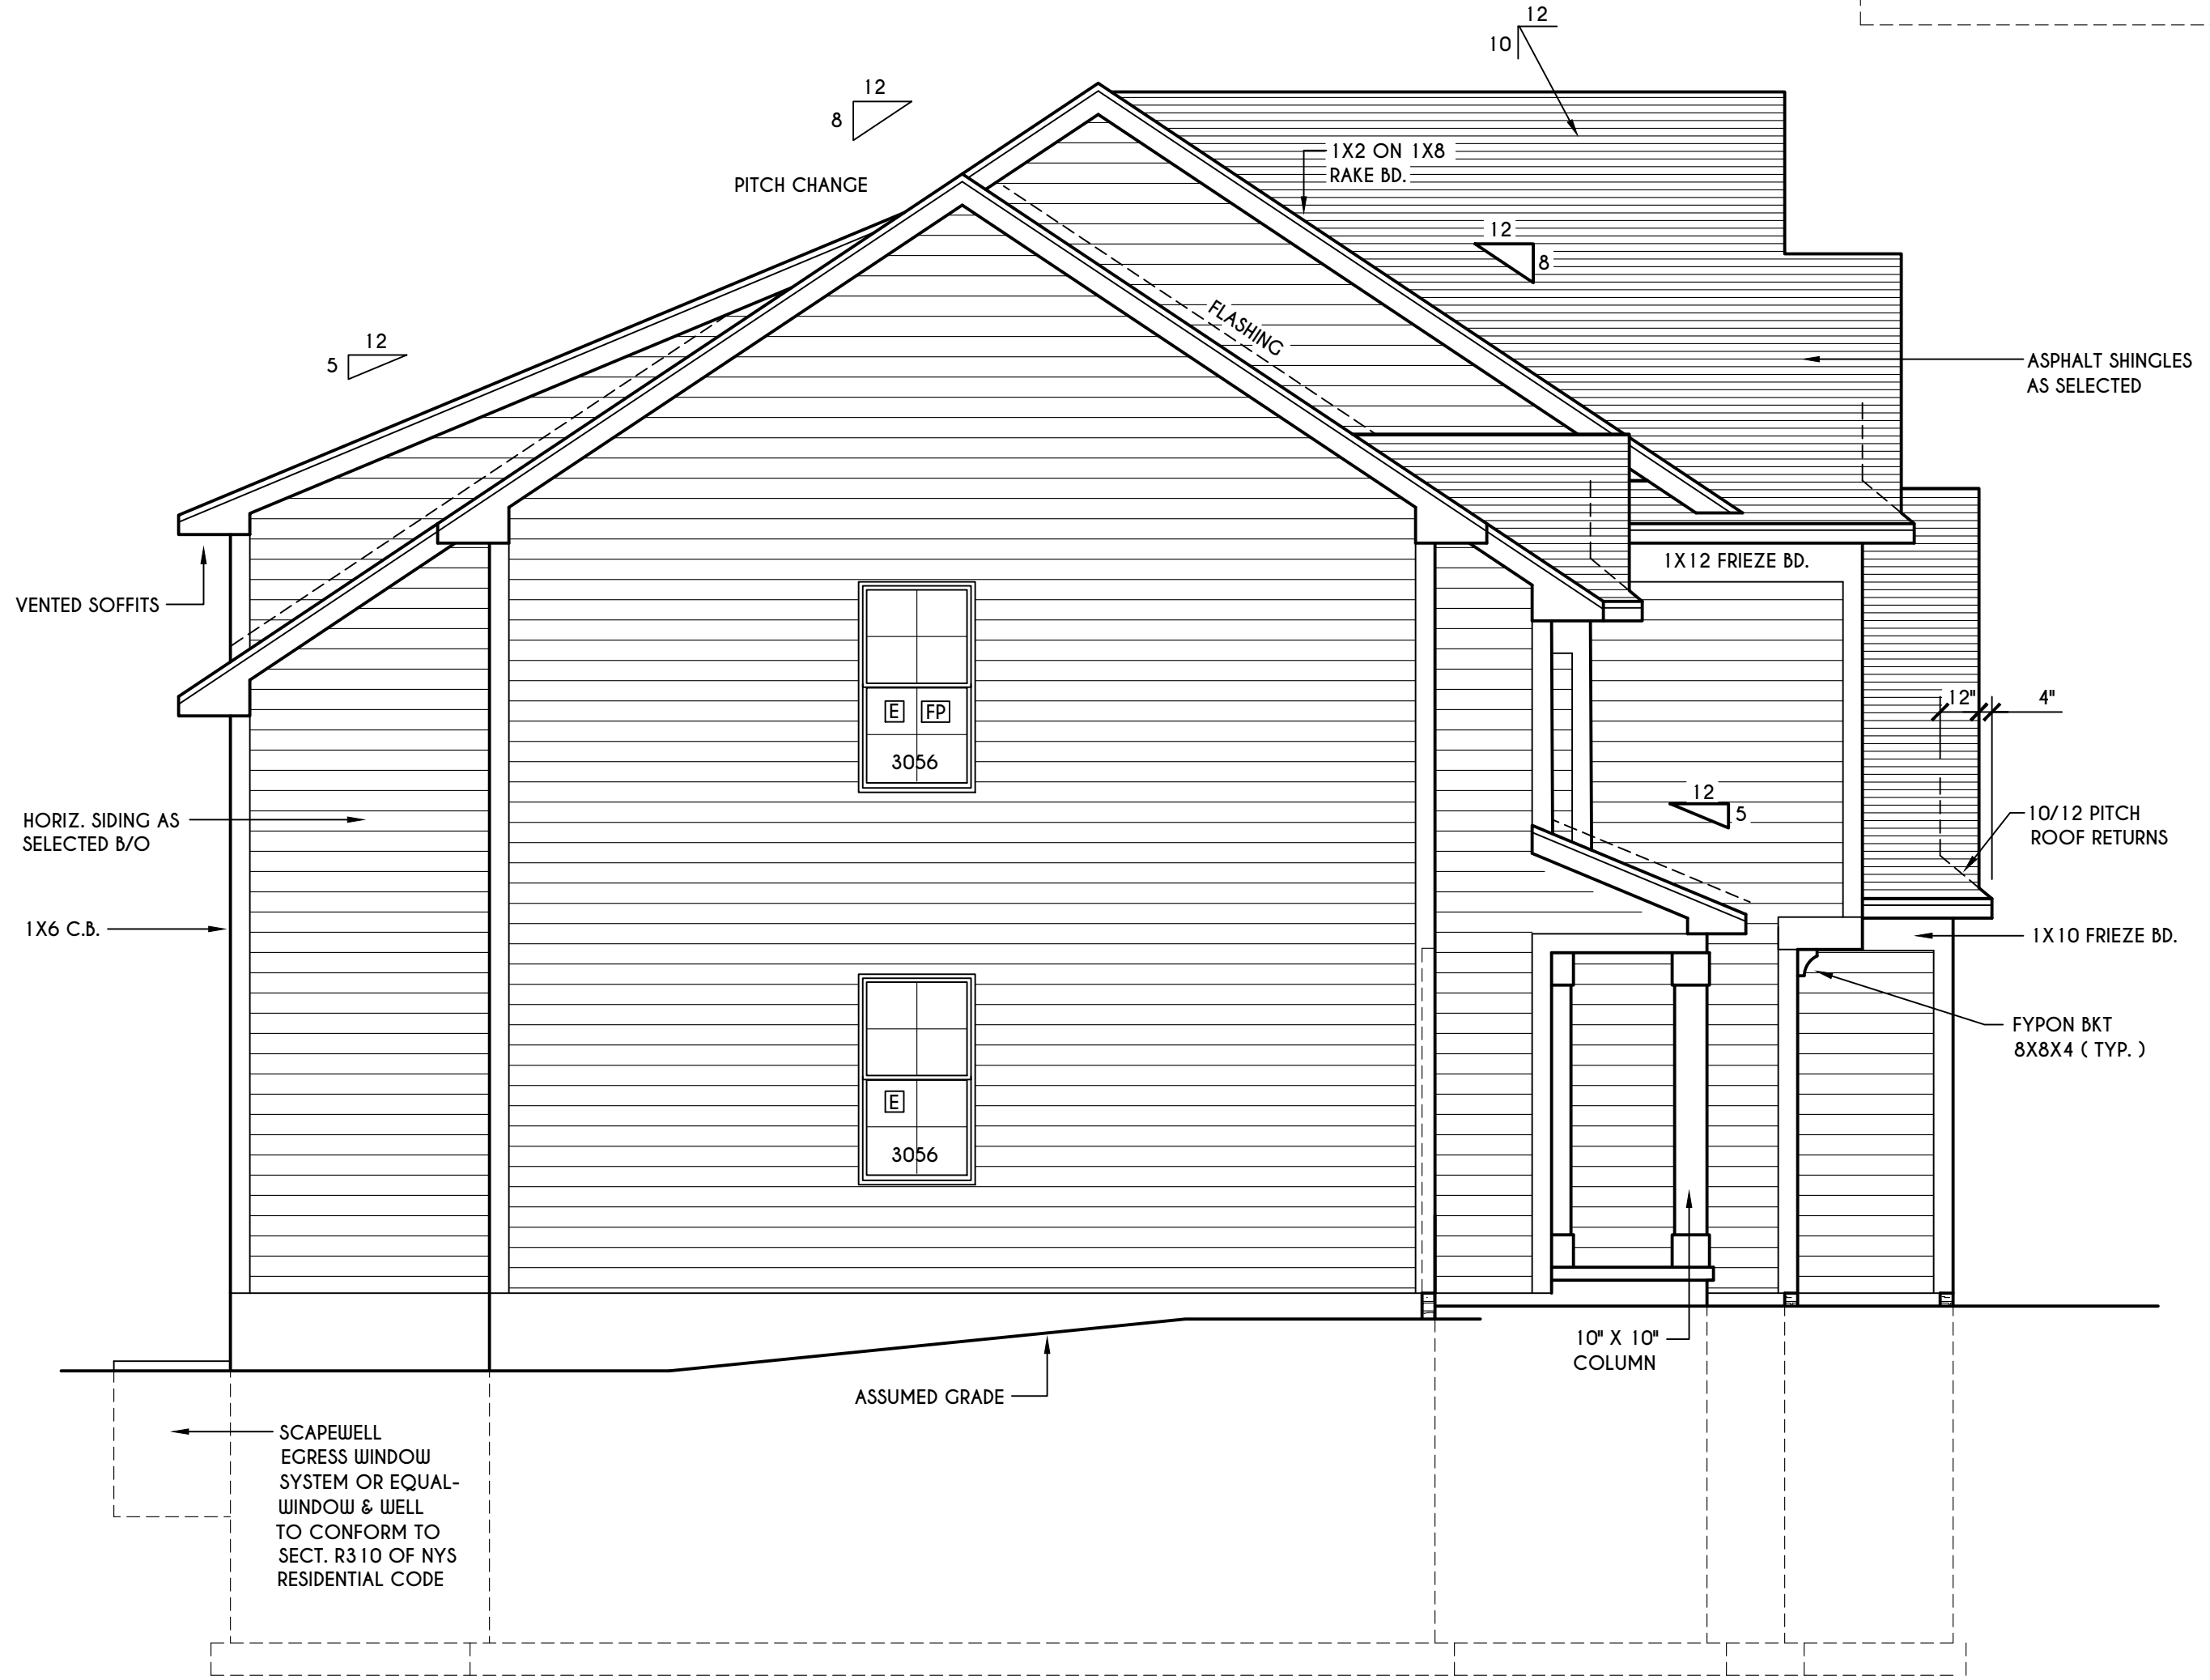DOORS: SELECTION BY OWNER

AIR INFILTRATION RATE FOR WINDOWS, SKYLIGHTS, & SLIDING DOORS TO BE NO MORE THAN 0.5 cfm/ft. & SLIDING DOORS NO MORE THAN 0.5 cfm/ft. AS PER SECT. R402.4.3 OF 2020 ECCNYS

WINDOW / DOOR LEGEND:
 [E] = MEETS OR EXCEEDS EGRESS REQUIREMENTS
 - CLEAR OPENING AREA OF 5.7 SQ.FT.
 - CLEAR OPENING WIDTH OF 20"
 - CLEAR OPENING HEIGHT OF 24" PER SECT. R310.1 OF 2020 RCNYS
 [T] = SPECIFIES THAT THIS FIXED OR OPERABLE UNIT REQUIRES SAFETY GLAZING PER SECT. R308.4 OF 2020 RCNYS
 [FP] = SPECIFIES THAT THIS OPERABLE WINDOW UNIT REQUIRES FACTORY APPLIED FALL PROTECTION PER SECT. R312.2 OF 2020 RCNYS

GENERAL NOTES:
 ALL RAKES ARE 12" & OVERHANGS ARE 16" UNLESS NOTED OTHERWISE
 4/12 PITCH ROOFS OR SHALLOWER TO HAVE 2 LAYERS 15# FELT
 BUILDER TO PROVIDE ROOF OR RIDGE VENTS AS PER CODE. THE MINIMUM NET FREE VENTILATION AREA SHALL BE 1/150 OF THE AREA OF THE VENTED SPACE (SECT. R806.2)
 CONTRACTOR TO CONTACT THIS OFFICE PRIOR TO CONSTRUCTION IF THE ASSUMED GRADE DEPICTED IS INACCURATE AND / OR WILL ALTER THE DESIGN AND / OR STRUCTURE NOTED.

MECHANICAL VENTILATION RATE:
 THIS PLAN AS DESIGNED REQUIRES (MIN) 1 CONTINUOUSLY RUN EXHAUST FAN CAPABLE OF (MIN) 90 cfm WITH A MANUAL OVERRIDE SWITCH AS PER SECTION M1505.4.2 OF 2020 RCNYS SEE TABLES M1505.4.3(1) & M1505.4.3(2) & M1505.4.4 (PAGE 1)

TABLE M1505.4.3 (1)
 CONTINUOUS WHOLE-HOUSE MECHANICAL VENTILATION SYSTEM AIRFLOW RATE REQUIREMENTS

DWELLING UNIT FLOOR AREA (square feet)	NUMBER OF BEDROOMS				
	0-1	2-3	4-5	6-7	> 7
< 1,500	30	45	60	75	90
1,501-3,000	45	60	75	90	105
3,001-4,500	60	75	90	105	120
4,501-6,000	75	90	105	120	135
6,001-7,500	90	105	120	135	150
> 7,500	105	120	135	150	165

FOR SI: 1 square foot=0.0929 m², 1 cubic foot per min=0.0004719 m³/s

TABLE M1505.4.3 (2)
 INTERMITTENT WHOLE-HOUSE MECHANICAL VENTILATION RATE FACTORS a,b

RUN-TIME PERCENTAGE IN EA. 4-HOUR SEGMENT	25%	33%	50%	66%	75%	100%
FACTOR c	4	3	2	1.5	1.3	1.0

a. For ventilation system run time values between those given, the factors are permitted to be determined by interpolation.
 b. Extrapolation beyond the table is prohibited.

TABLE M1505.4.4
 MINIMUM REQUIRED LOCAL EXHAUST RATES FOR ONE AND TWO-FAMILY DWELLINGS

AREA TO BE EXHAUSTED	EXHAUST RATES
KITCHENS	100 cfm INTERMITTENT OR 25 cfm CONTINUOUS
BATHROOMS-TOILET ROOMS	MECHANICAL EXHAUST CAPACITY OF 50 cfm INTERMITTENT OR 20 cfm CONTINUOUS

FOR SI: 1 CUBIC FT. PER MINUTE = 0.0004719 m³/s.

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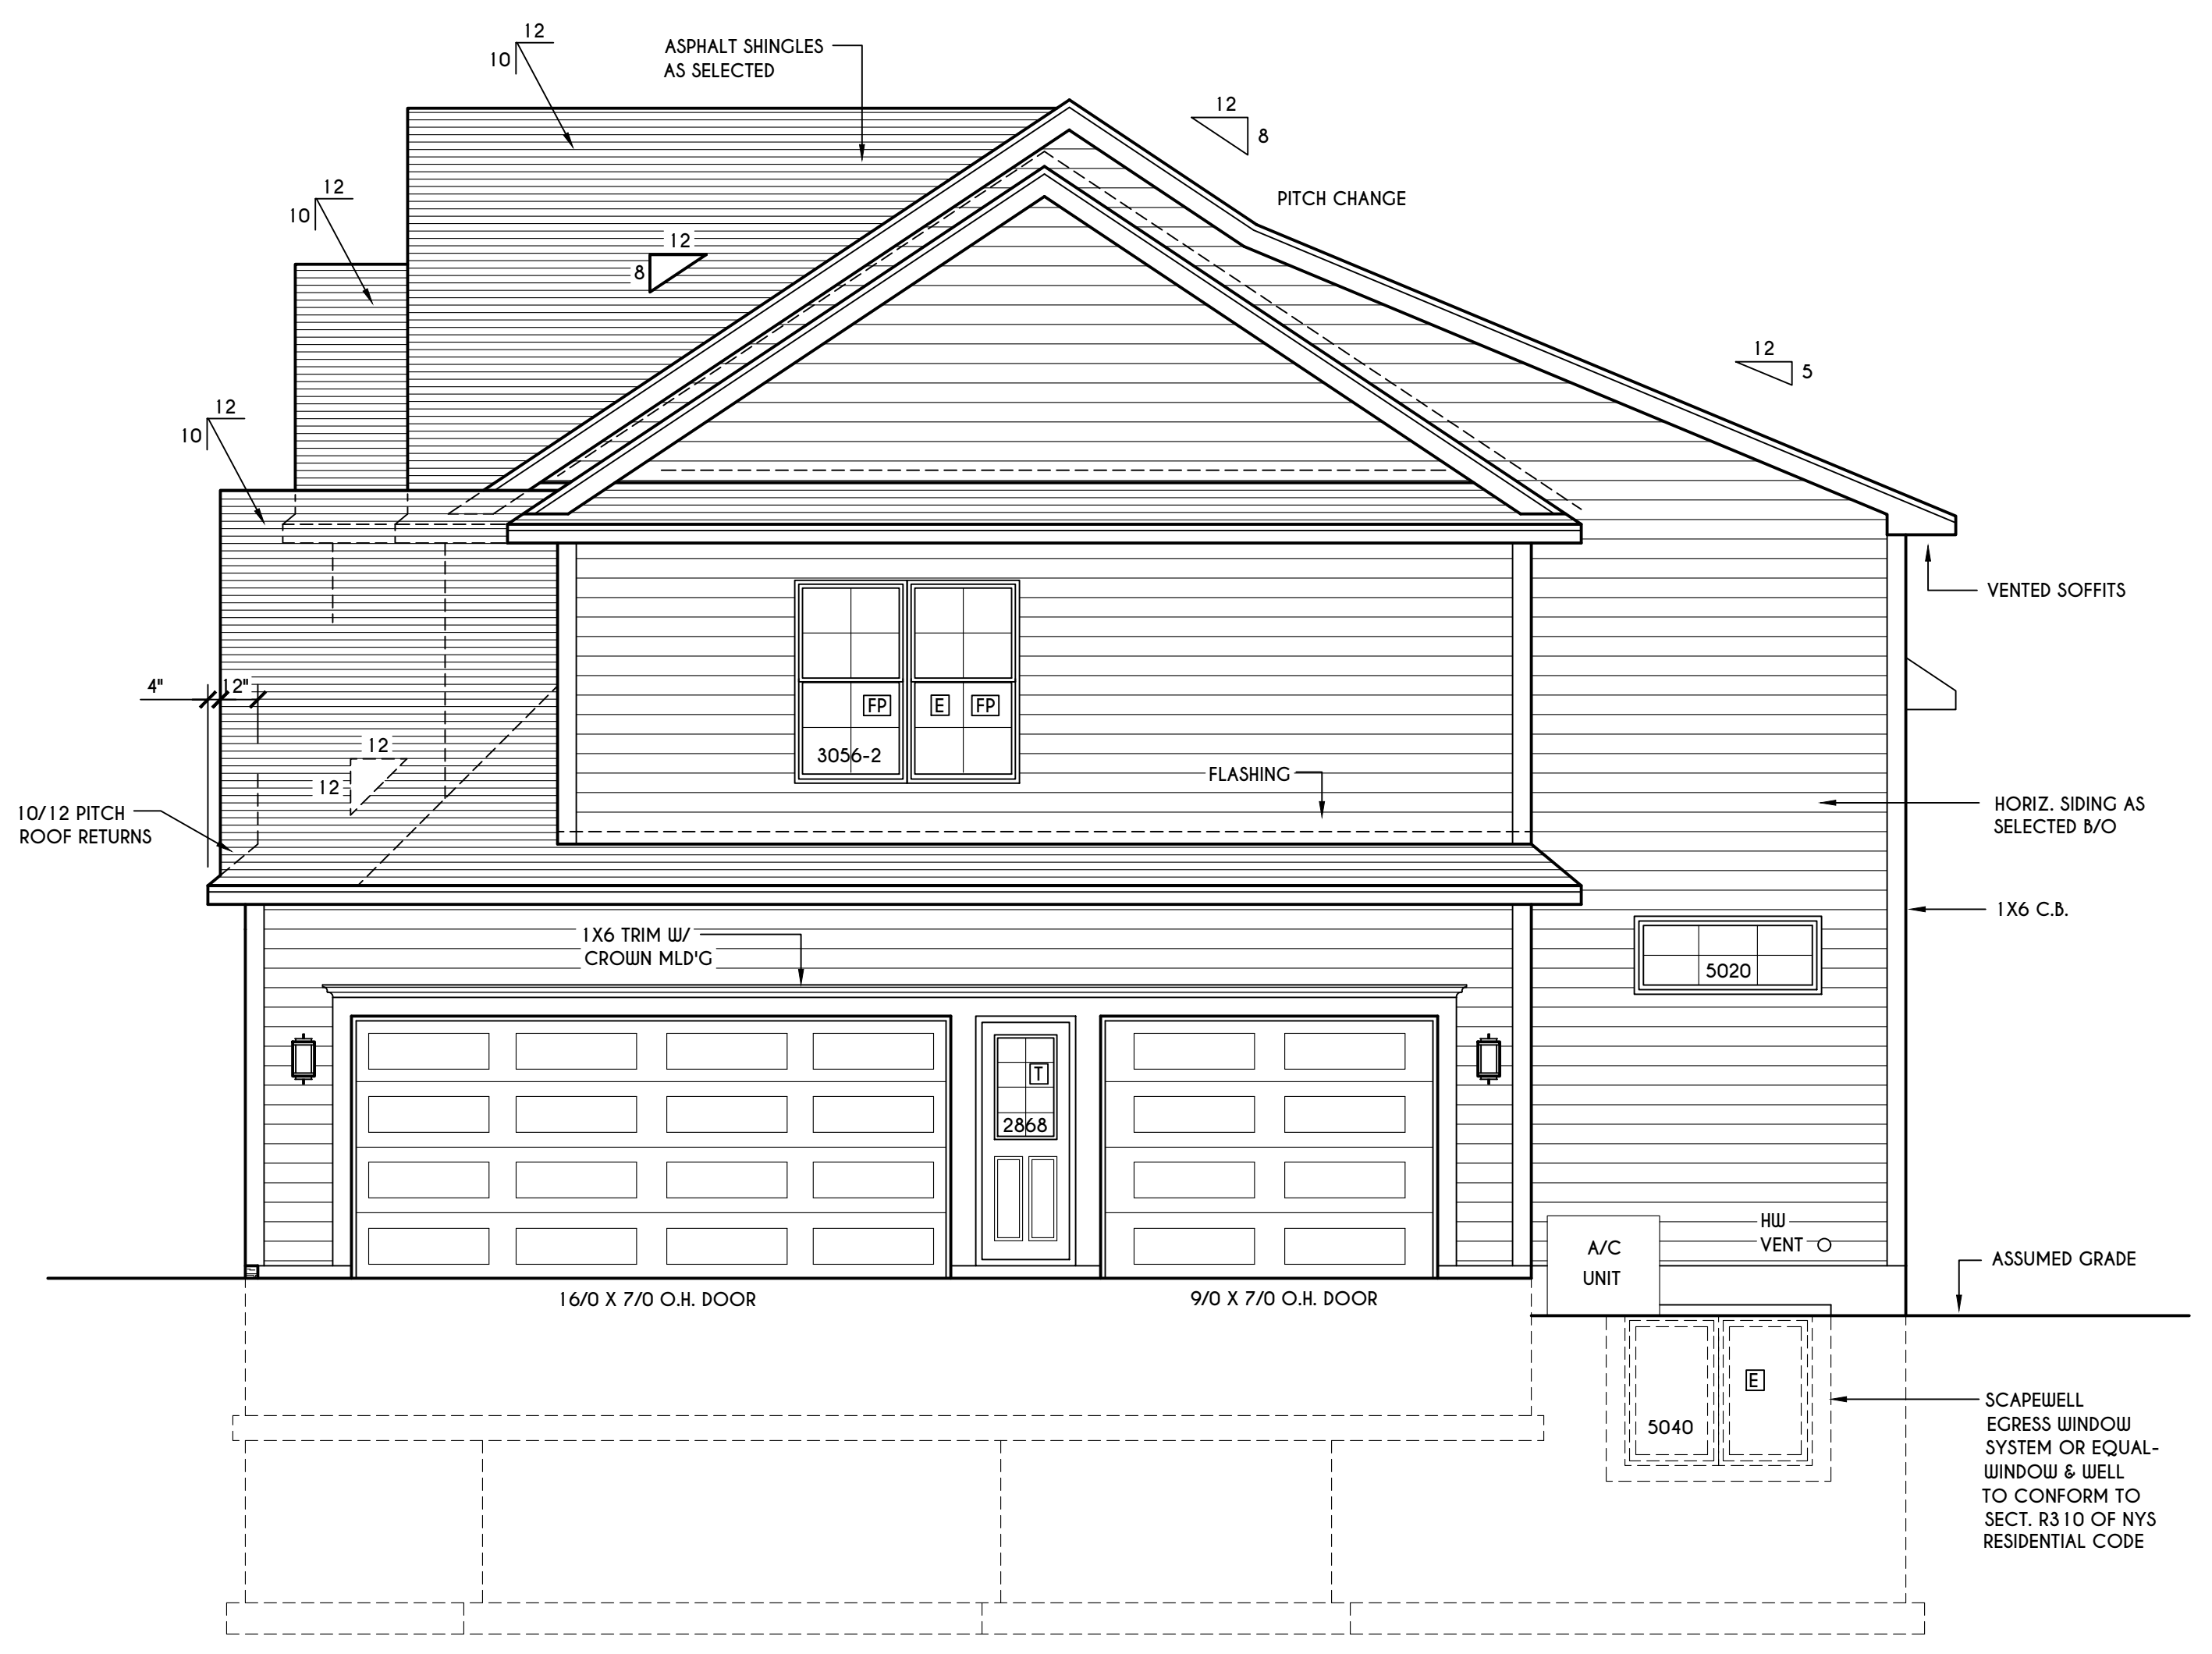
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 LOT 49 COVENTRY RIDGE
 PITTSFORD, NY

BUILDER:
 COVENTRY RIDGE
 BUILDING CORP.

ELEVATIONS


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RIGHT ELEVATION

SCALE: 1/4" = 1'-0"




REAR ELEVATION

SCALE: 1/4" = 1'-0"

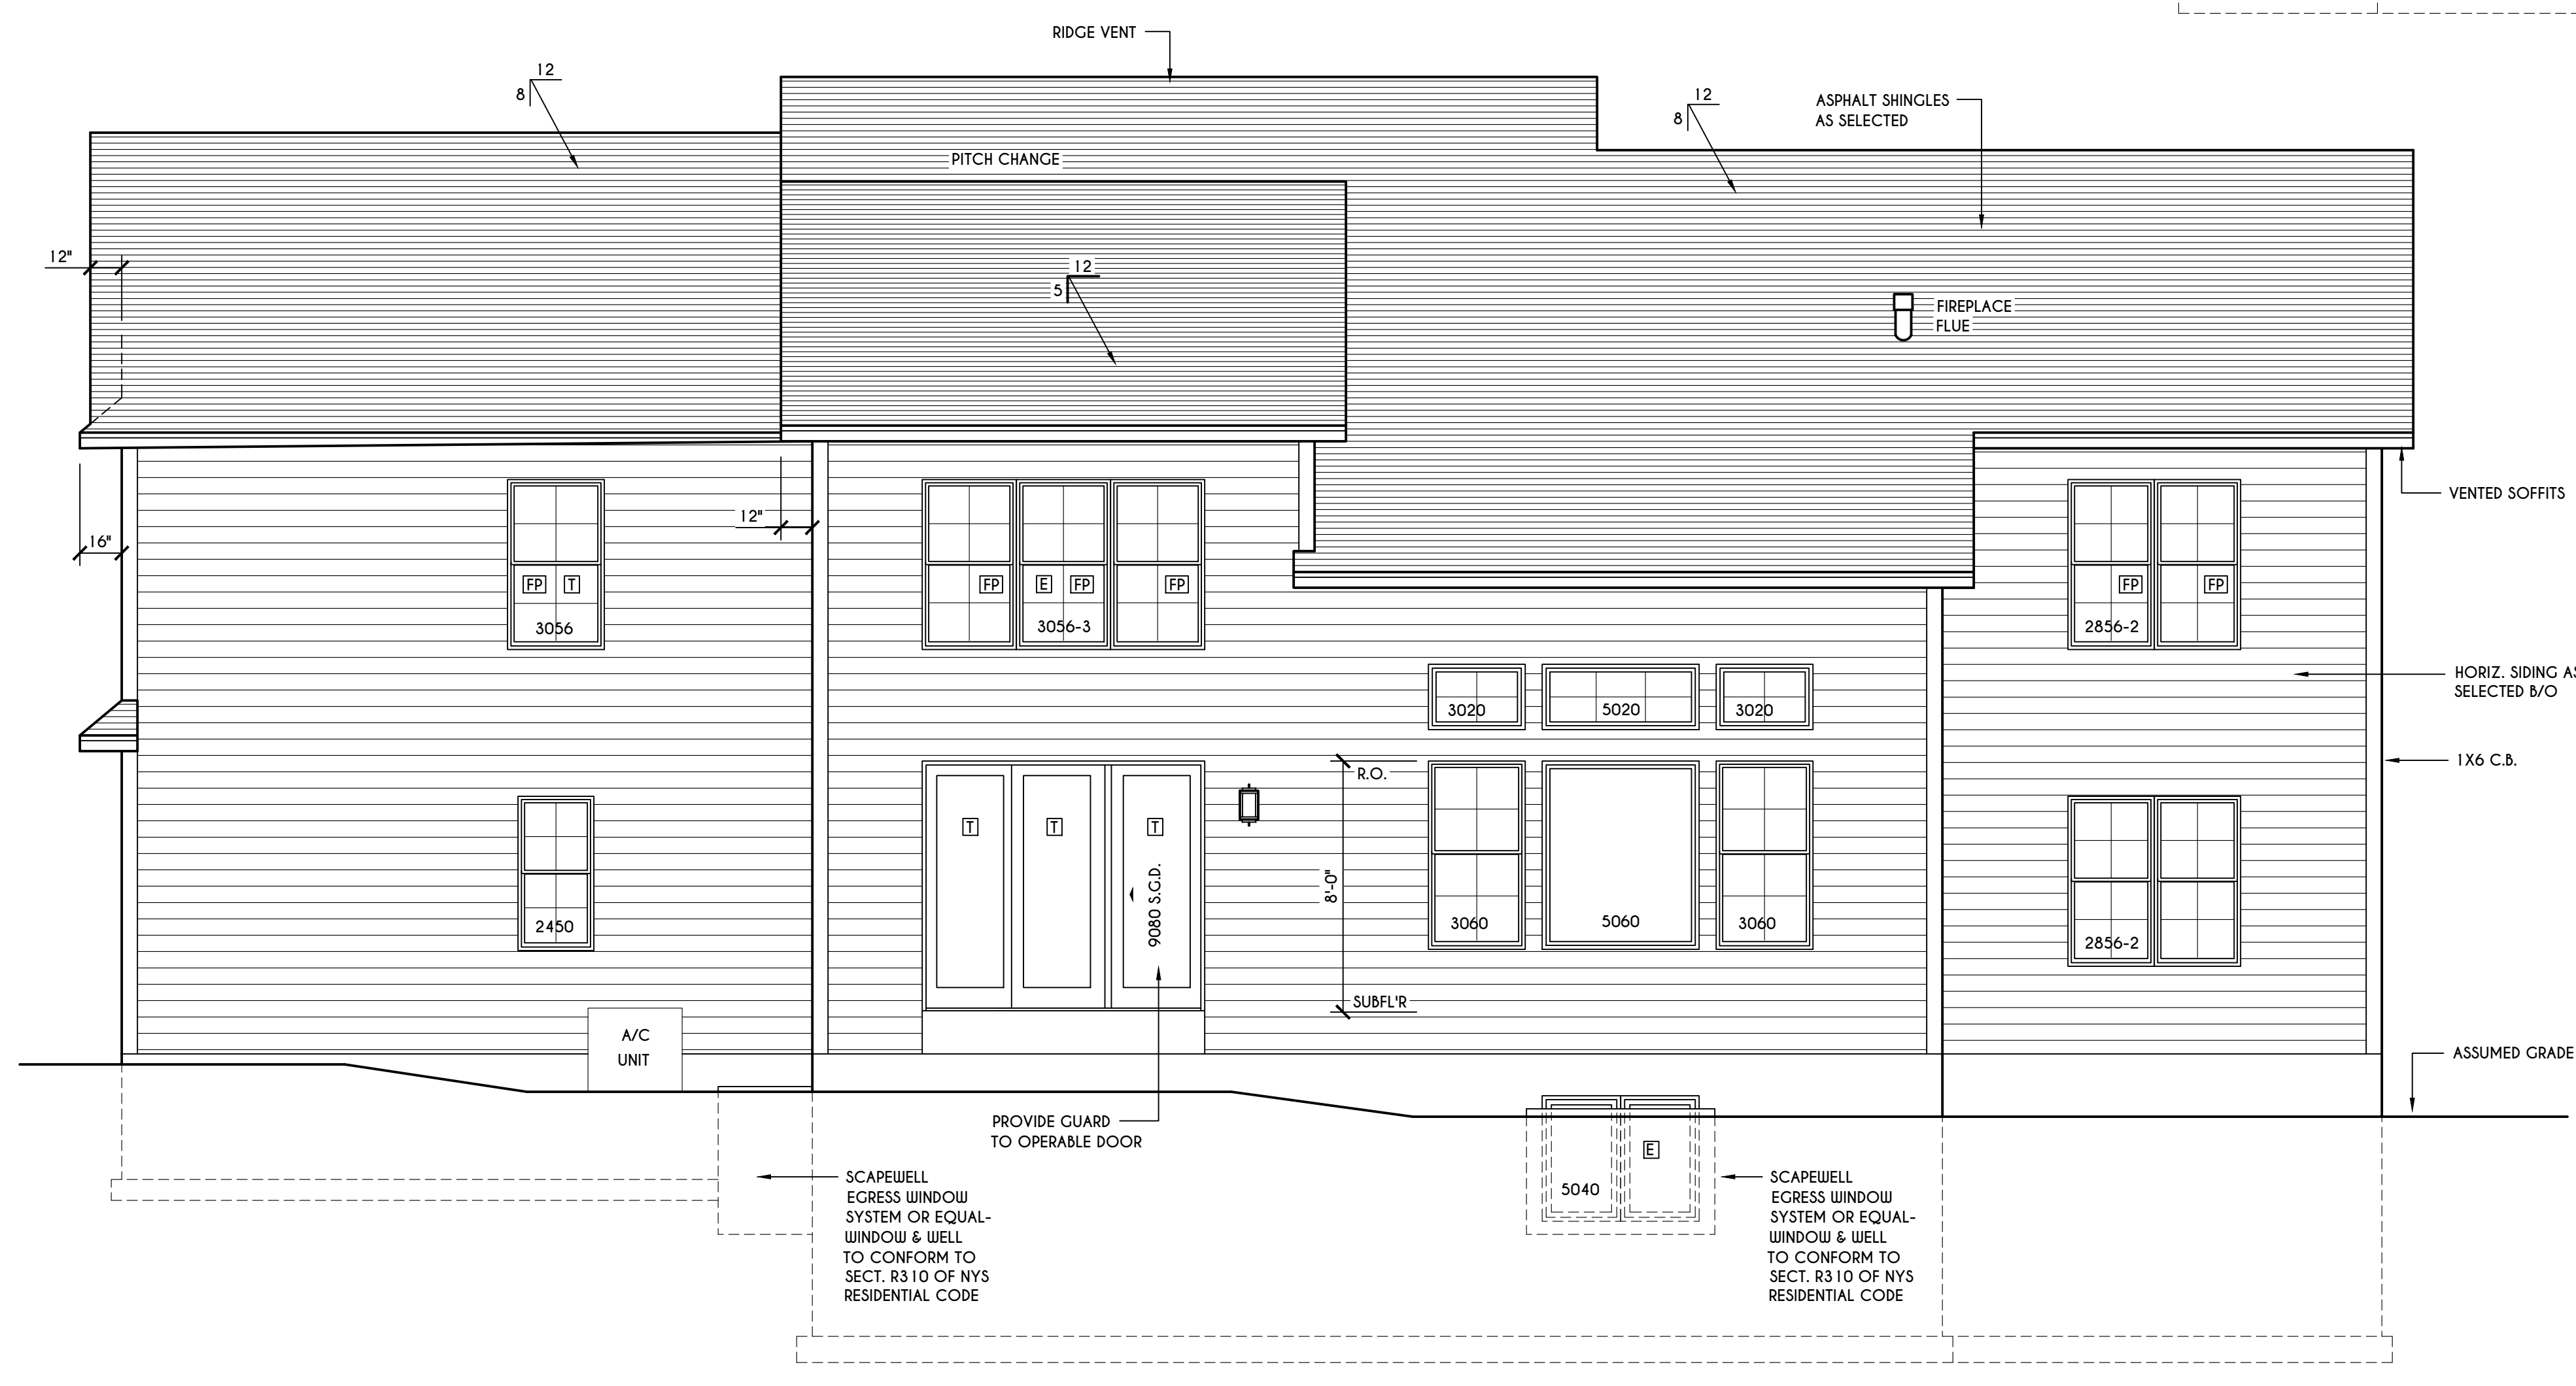WINDOWS:	U-FACTOR 0.30 SHGC 0.54	GENERAL NOTES:
DOORS:	SELECTION BY OWNER	ALL RAKES ARE 12" & OVERHANGS ARE 16" UNLESS NOTED OTHERWISE
WINDOW / DOOR LEGEND:		4/12 PITCH ROOFS OR SHALLOWER TO HAVE 2 LAYERS 15# FELT
[E]	- MEETS OR EXCEEDS EGRESS REQUIREMENTS - CLEAR OPENING AREA OF 5.7 SQ.FT. - CLEAR OPENING WIDTH OF 20" - CLEAR OPENING HEIGHT OF 24" PER SECT. R310.1 OF 2020 RCNYS	BUILDER TO PROVIDE ROOF OR RIDGE VENTS AS PER CODE - THE MINIMUM NET FREE VENTILATION AREA SHALL BE 1/150 OF THE AREA OF THE VENTED SPACE (SECT. R806.2)
[T]	- SPECIFIES THAT THIS FIXED OR OPERABLE UNIT REQUIRES SAFETY GLAZING PER SECT. R308.4 OF 2020 RCNYS	CONTRACTOR TO CONTACT THIS OFFICE PRIOR TO CONSTRUCTION IF THE ASSUMED GRADE DEPICTED IS INACCURATE AND / OR WILL ALTER THE DESIGN AND / OR STRUCTURE NOTED.
[FP]	- SPECIFIES THAT THIS OPERABLE WINDOW UNIT REQUIRES FACTORY APPLIED FALL PROTECTION PER SECT. R312.2 OF 2020 RCNYS	MECHANICAL VENTILATION RATE:
		THIS PLAN AS DESIGNED REQUIRES (MIN) 1 CONTINUOUSLY RUN EXHAUST FAN CAPABLE OF (MIN) 90 C.F.M. WITH A MANUAL OVERRIDE SWITCH AS PER SECTION M1505.4.2 OF 2020 RCNYS SEE TABLES M1505.4.3(1) & M1505.4.3(2) & M1505.4.4 (PAGE 1)

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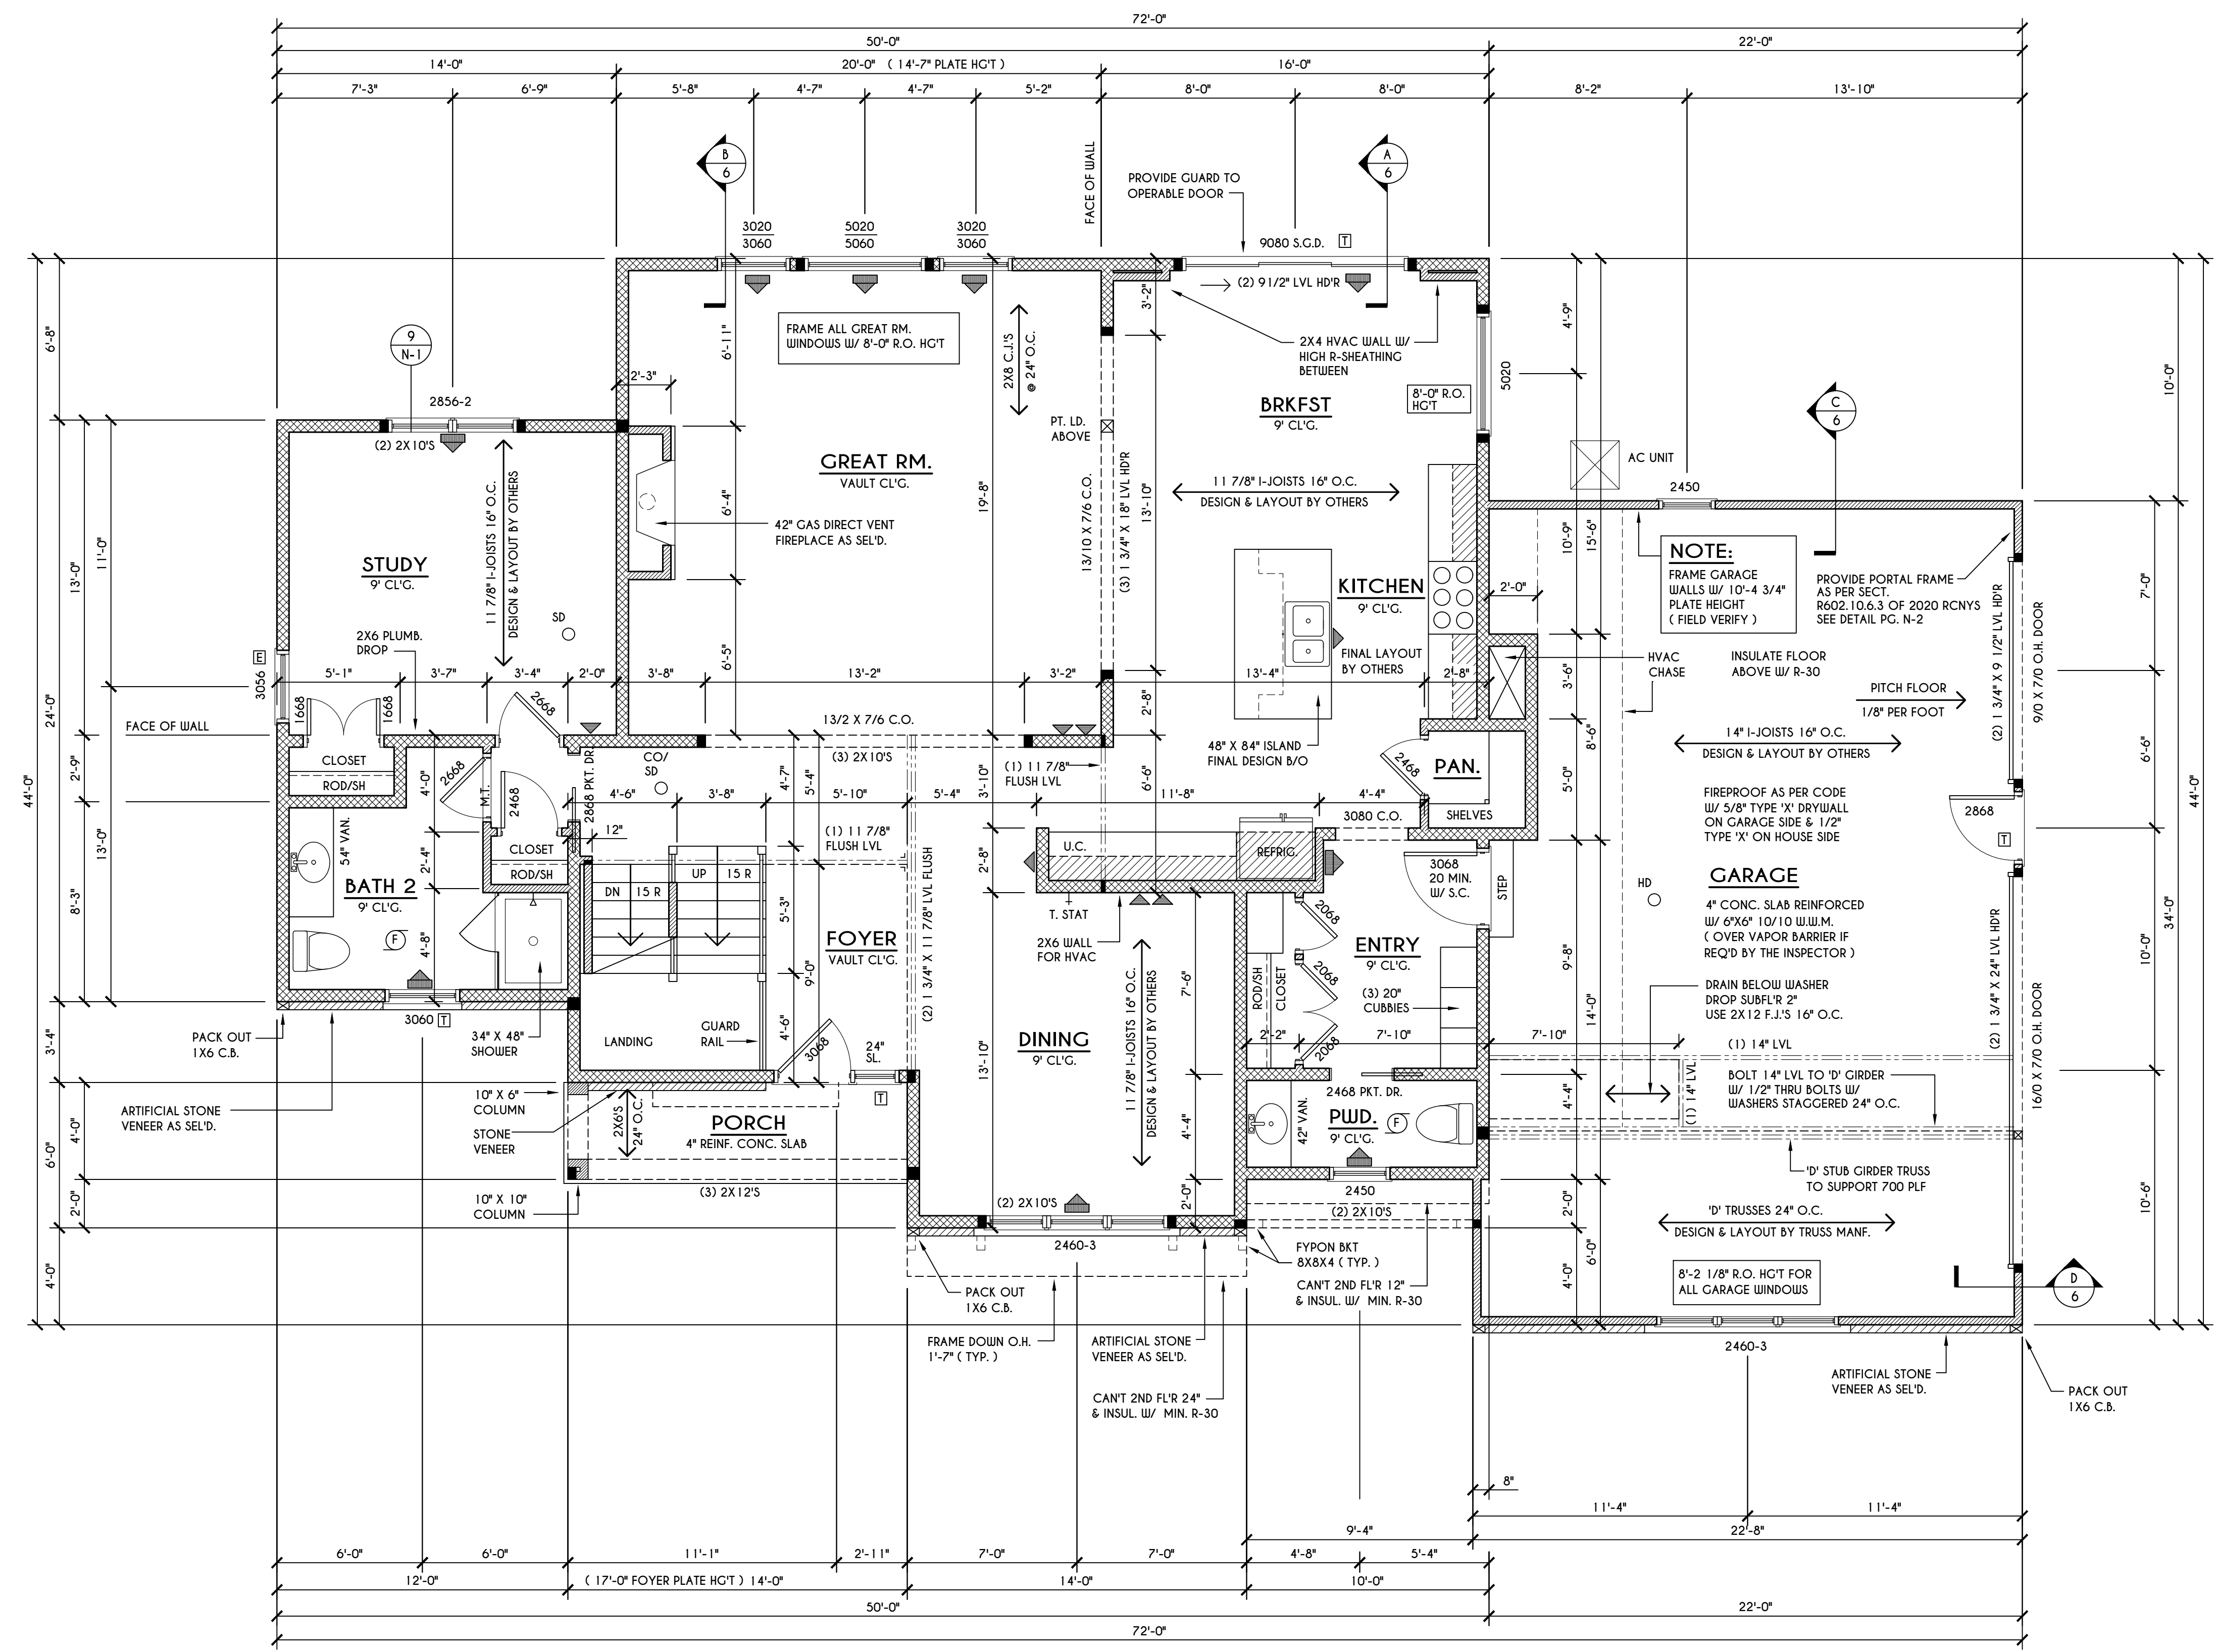
BUILDER:

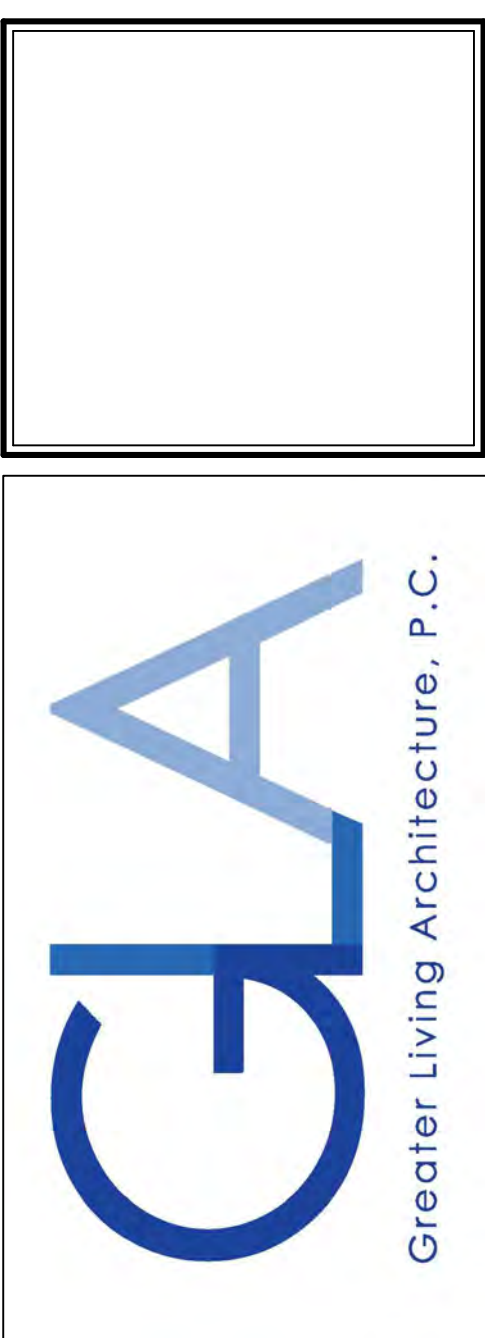COVENTRY RIDGE
 BUILDING CORP.

FIRST FLOOR PLAN

GLA PLAN 3566

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PROJECT: 15346E	sheet: 4 / 6



FIRST FLOOR PLAN

SCALE: 1/4" = 1'-0" 1701 SQ. FT.

FRAMING LEGEND:

- PROVIDE SOLID POSTING- GLUED & NAILED, EQUAL TO THE # OF HEADERS TO BE SUPPORTED- UNLESS NOTED OTHERWISE
- DROPPED HEADER
- FLUSH HEADER
- 2X4 STUDS @ 16" O.C.
- 2X6 STUDS @ 16" O.C.

GENERAL FIRST FLOOR PLAN NOTES:

FIRST FLOOR PLATE HGT TO BE 9'-1 1/8" (UNLESS NOTED OTHERWISE)
 ALL WINDOW R.O. HGT'S TO BE 7'-4" U.N.O.
 PROVIDE SOLID BLOCKING UNDER ALL BEARING POINTS DOWN TO FOUNDATION WALL
 PROVIDE DBL JACK STUDS EA. SIDE OF LOAD BEARING OPENINGS > / = 4'-0"
 ALL ANGLES TO BE 45 DEG. U.N.O.
 ALL EXTERIOR WINDOW & DOOR HEADERS TO HAVE MIN. R-3 INSUL. & TO BE MIN. (2) 2X8'S (U.N.O.)
 ALL APPLIANCES SHOWN TO BE BY OWNER OR AS PER CONTRACT BY BUILDER
 SMOKE (SD) & HEAT DETECTOR (HD), SHALL BE INSTALLED AS PER SECT. R314 OF 2020 RCNYS
 CARBON MONOXIDE ALARMS SHALL BE INSTALLED AS PER SECT. 9.15.33 FCNYS & BE WITHIN 10' OF ALL SLEEPING AREAS
 IF AN AUTOMATIC GARAGE DOOR OPENER IS PROVIDED, IT SHALL BE LISTED IN ACCORDANCE W/ UL 325
 THE AIR BARRIER INSTALLED AT EXTERIOR WALLS ADJACENT TO SHOWERS AND TUBS SHALL SEPARATE THEM FROM THE SHOWER OR TUBS.


WINDOW / DOOR LEGEND:

- MEETS OR EXCEEDS EGRESS REQUIREMENTS
 - CLEAR OPENING AREA OF 5.7 SQ.FT.
 - CLEAR OPENING WIDTH OF 20"
 - CLEAR OPENING HEIGHT OF 24"
 PER SECT. R310.2.1 OF 2020 RCNYS
- SPECIFIES THAT THIS FIXED OR OPERABLE UNIT REQUIRES SAFETY GLAZING PER SECT. R308.4 OF 2020 RCNYS
- SPECIFIES THAT THIS OPERABLE WINDOW UNIT REQUIRES FACTORY APPLIED FALL PROTECTION PER SECT. R312.2 OF 2020 RCNYS

ENGINEERED FLOOR JOIST NOTE:

ALL ENGINEERED FLOOR JOISTS TO BE DESIGNED BY & LAYOUT TO BE DONE BY MANUFACTURER TO THE SPECS BELOW:
 ALL LIVING AREA JOISTS TO BE DESIGNED FOR 55 P.S.F. TOTAL LOAD
 ALL SLEEPING AREA JOISTS TO BE DESIGNED FOR 45 P.S.F. TOTAL LOAD

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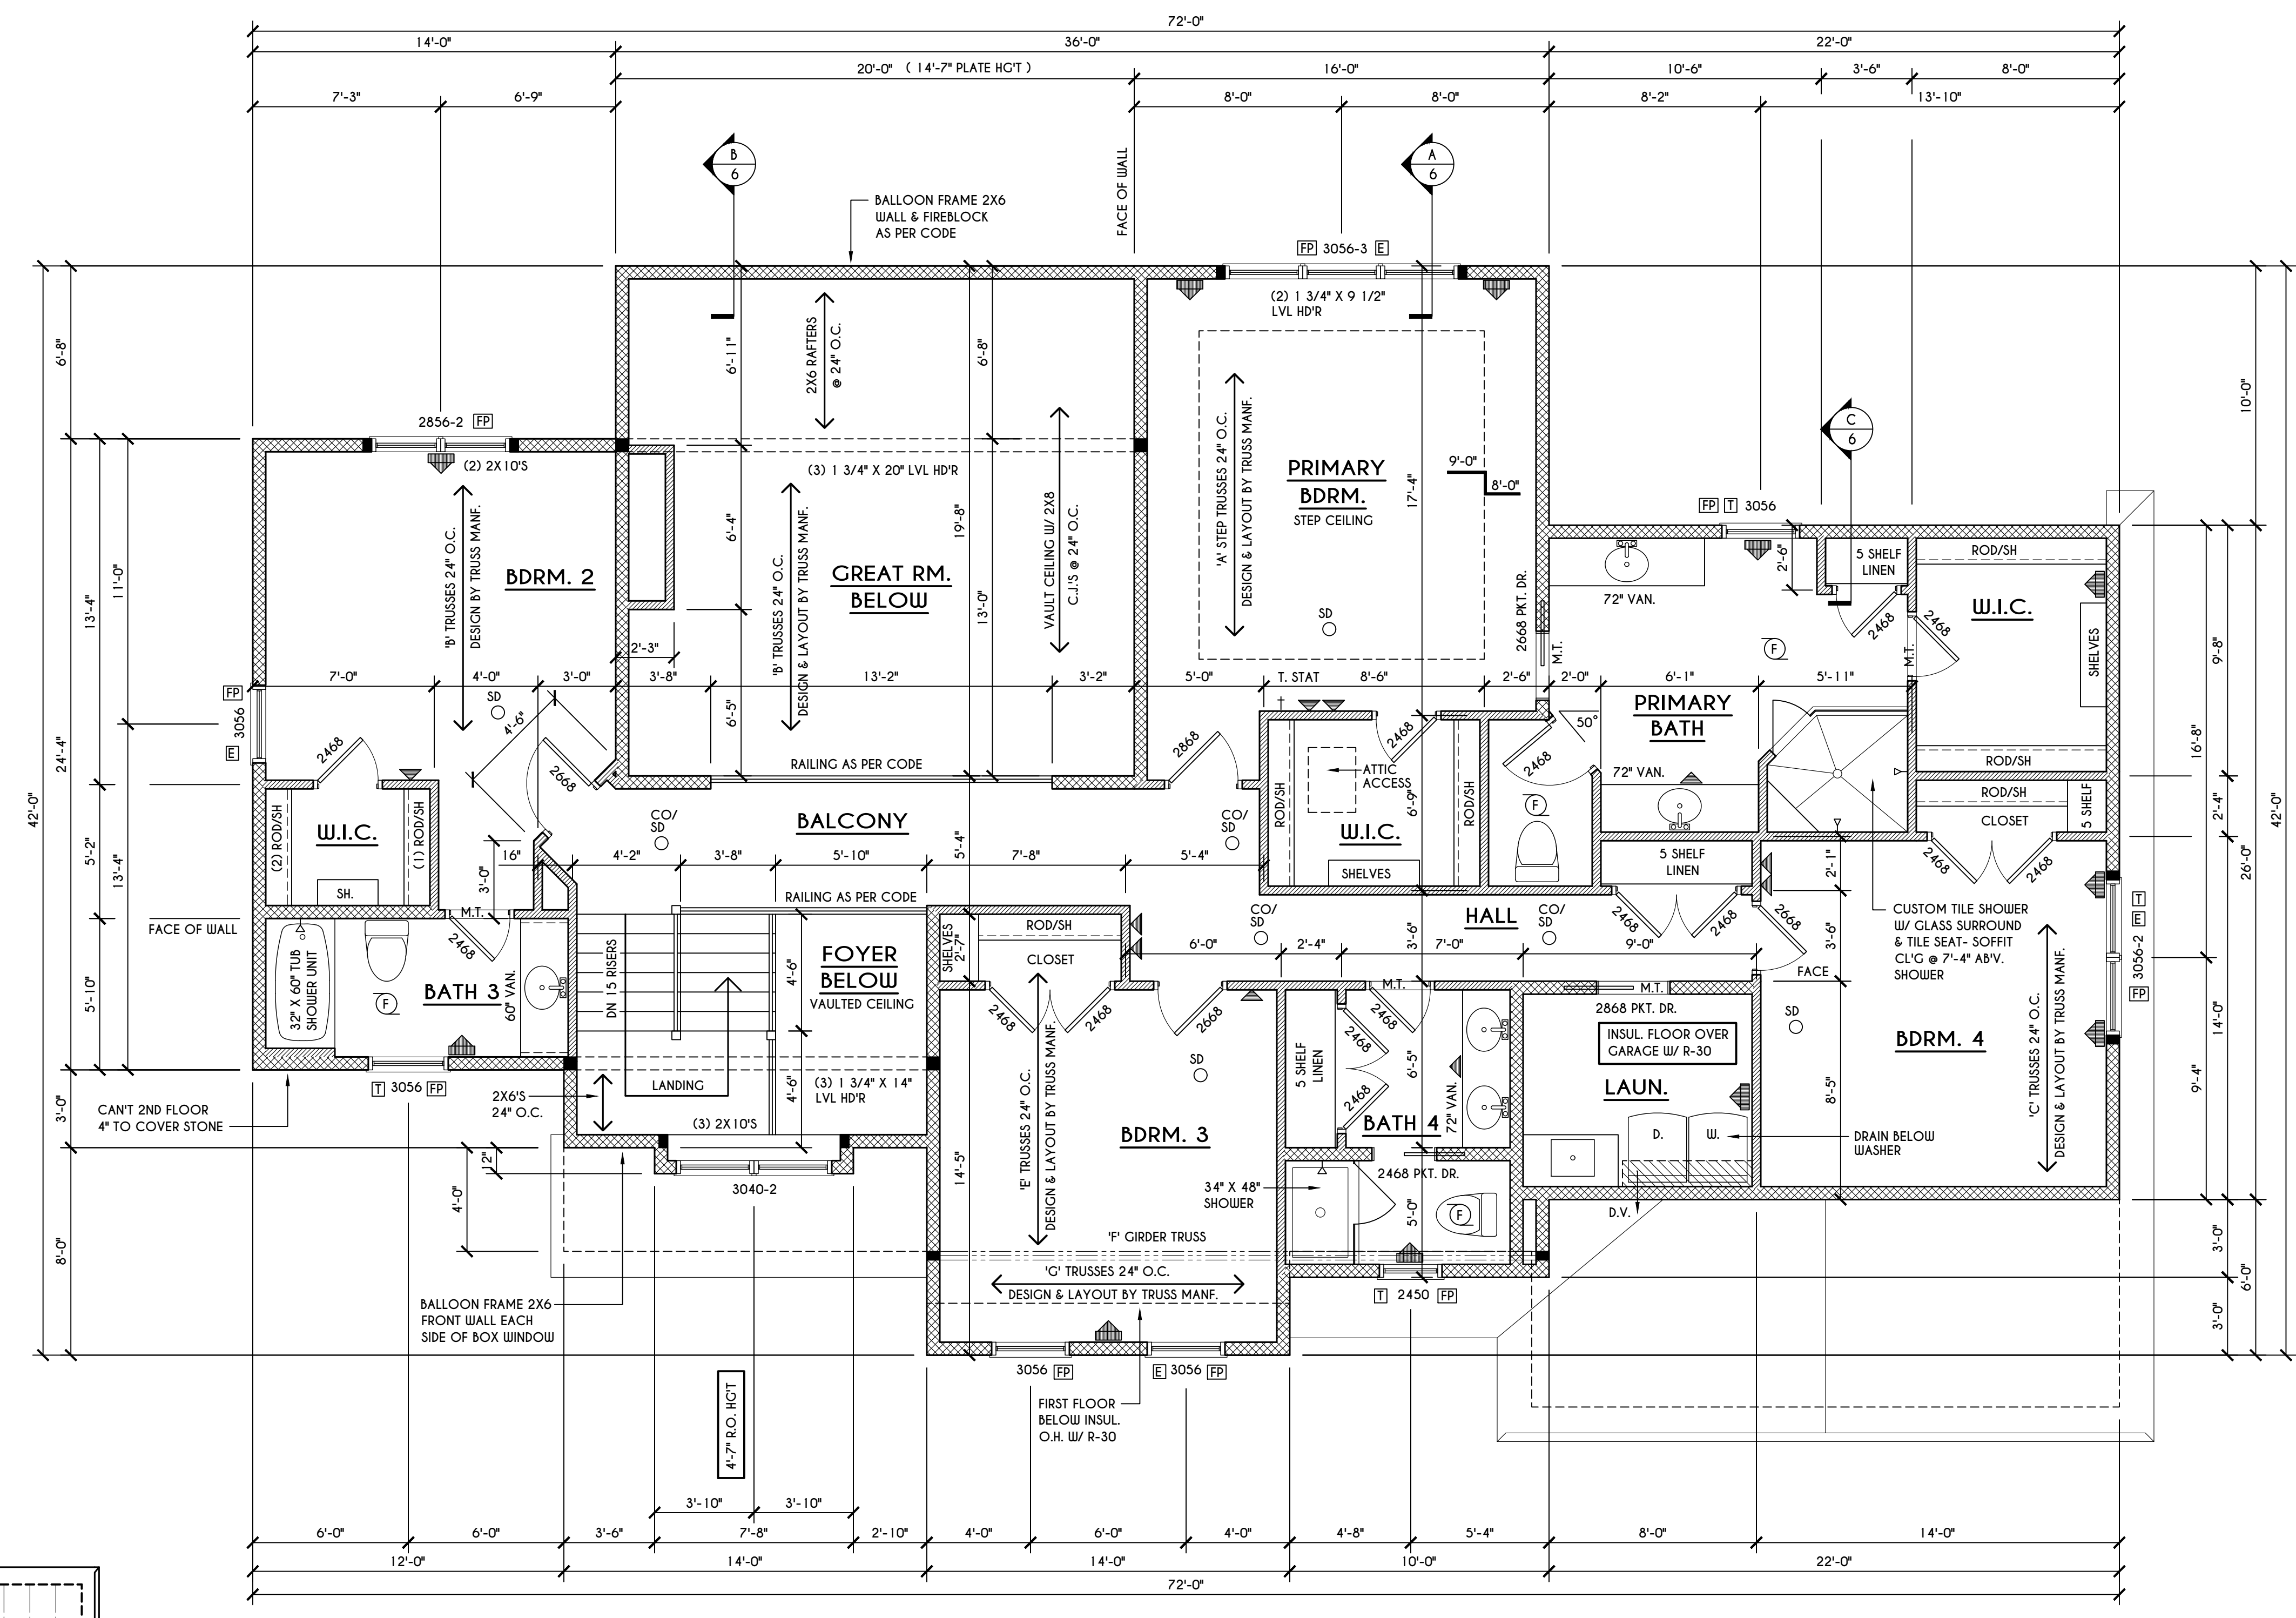
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 PITTSFORD, NY

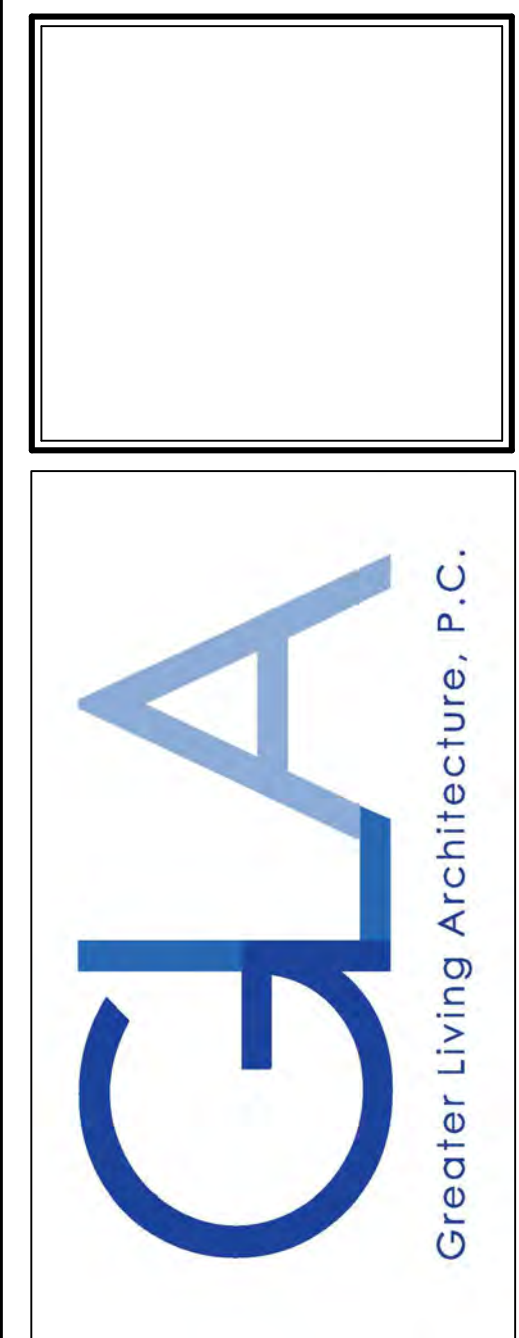BUILDER:
 COVENTRY RIDGE
 BUILDING CORP.

SECOND FLOOR PLAN

GLA PLAN 3566

drawn: CDK	checked: CSB
scale: AS NOTED	date: 6 / 22
PROJECT: 15346E	sheet: 5 6



SECOND FLOOR PLAN
 1865 SQ.FT.
 SCALE: 1/4" = 1'-0"

FRAMING LEGEND:


- PROVIDE SOLID POSTING- GLUED & NAILED, EQUAL TO THE # OF HEADERS TO BE SUPPORTED- UNLESS NOTED OTHERWISE
- DROPPED HEADER
- FLUSH HEADER
-
-

GENERAL SECOND FLOOR PLAN NOTES:


SECOND FLOOR PLATE HGT TO BE 8'-1 1/8" (UNLESS NOTED OTHERWISE)
 ALL WINDOW R.O. HGT'S TO BE 6'-10 1/2" U.N.O.
 PROVIDE SOLID BLOCKING UNDER ALL BEARING POINTS DOWN TO FOUNDATION WALL
 PROVIDE DBL JACK STUDS EA. SIDE OF LOAD BEARING OPENINGS > / = 4'-0"
 ALL ANGLES TO BE 45 DEG. U.N.O.
 ALL EXTERIOR WINDOW & DOOR HEADERS TO HAVE MIN. R-5 INSUL. & TO BE MIN. (2) 2X8'S (U.N.O.)
 ALL APPLIANCES SHOWN TO BE BY OWNER OR AS PER CONTRACT BY BUILDER
 SMOKE (SD) & HEAT DETECTOR (HD), SHALL BE INSTALLED AS PER SECT. R314 OF 2020 RCNYS
 CARBON MONOXIDE ALARMS SHALL BE INSTALLED AS PER SECT. R315.33 FCNYS & BE WITHIN 10' OF ALL SLEEPING AREAS
 THE AIR BARRIER INSTALLED AT EXTERIOR WALLS ADJACENT TO SHOWERS AND TUBS SHALL SEPARATE THEM FROM THE SHOWER OR TUBS.

WINDOW / DOOR LEGEND:


- MEETS OR EXCEEDS EGRESS REQUIREMENTS
 - CLEAR OPENING AREA OF 5.7 SQ.FT.
 - CLEAR OPENING WIDTH OF 20"
 - CLEAR OPENING HEIGHT OF 24"
 PER SECT. R310.2.1 OF 2020 RCNYS
- SPECIFIES THAT THIS FIXED OR OPERABLE UNIT REQUIRES SAFETY GLAZING PER SECT. R308.4 OF 2020 RCNYS
- SPECIFIES THAT THIS OPERABLE WINDOW UNIT REQUIRES FACTORY APPLIED FALL PROTECTION PER SECT. R312.2 OF 2020 RCNYS

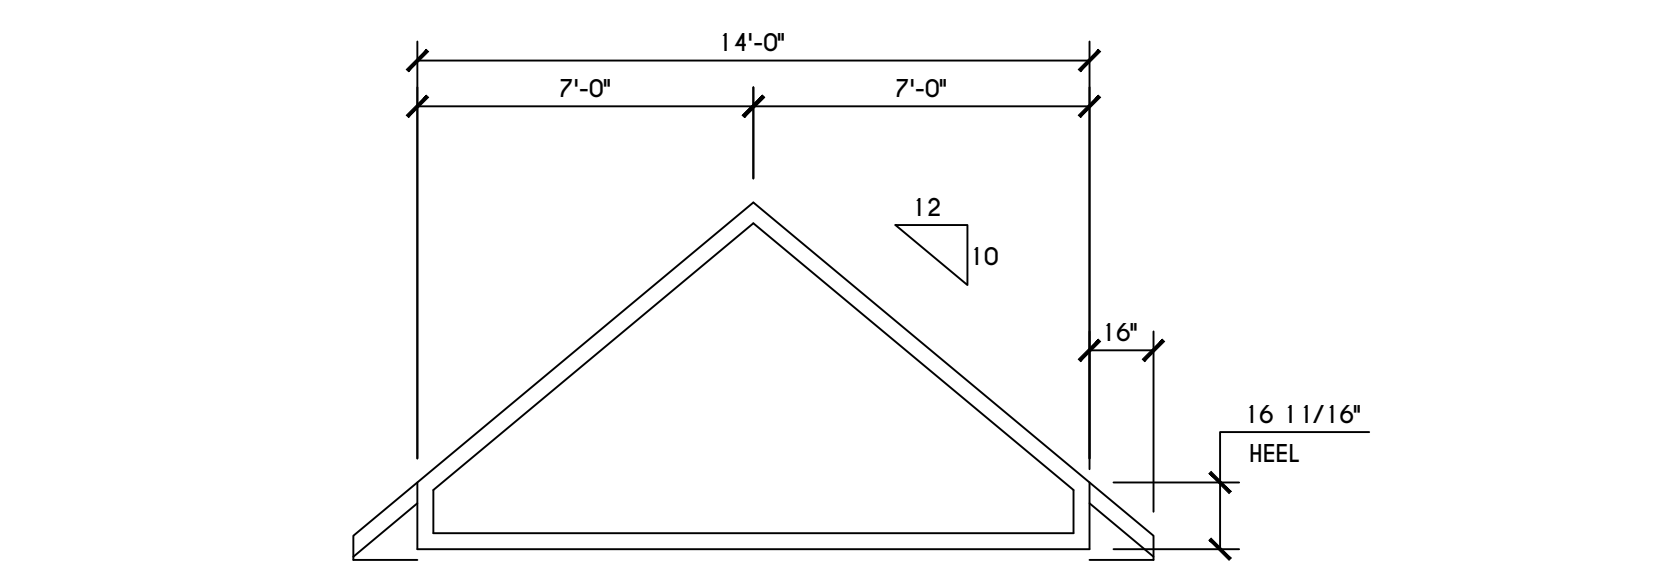


'G' TRUSS PROFILE
 SCALE: 1/4" = 1'-0"

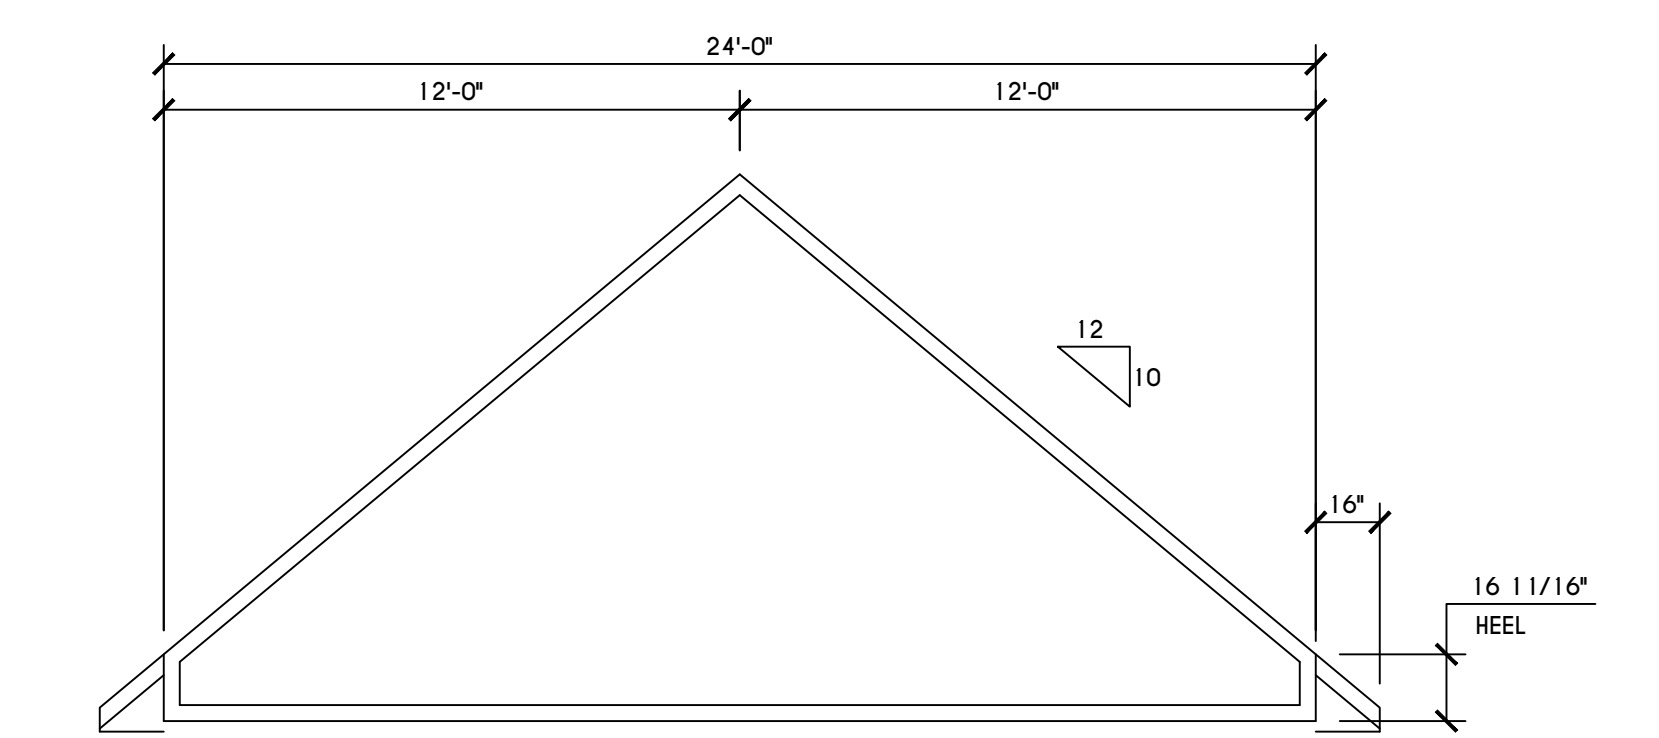

'F' TRUSS PROFILE
 SCALE: 1/4" = 1'-0"

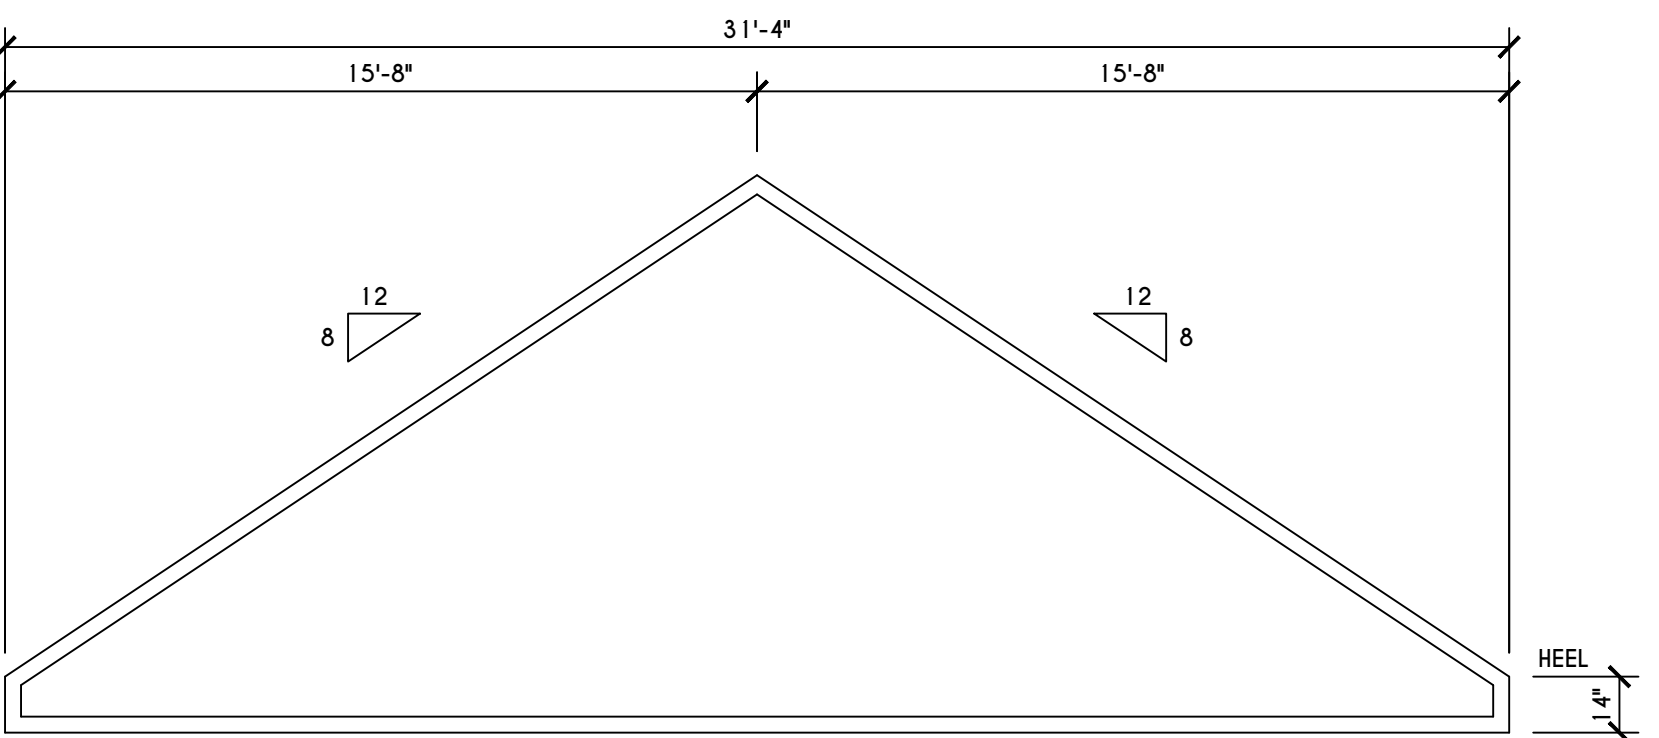

'E' TRUSS PROFILE
 SCALE: 1/4" = 1'-0"

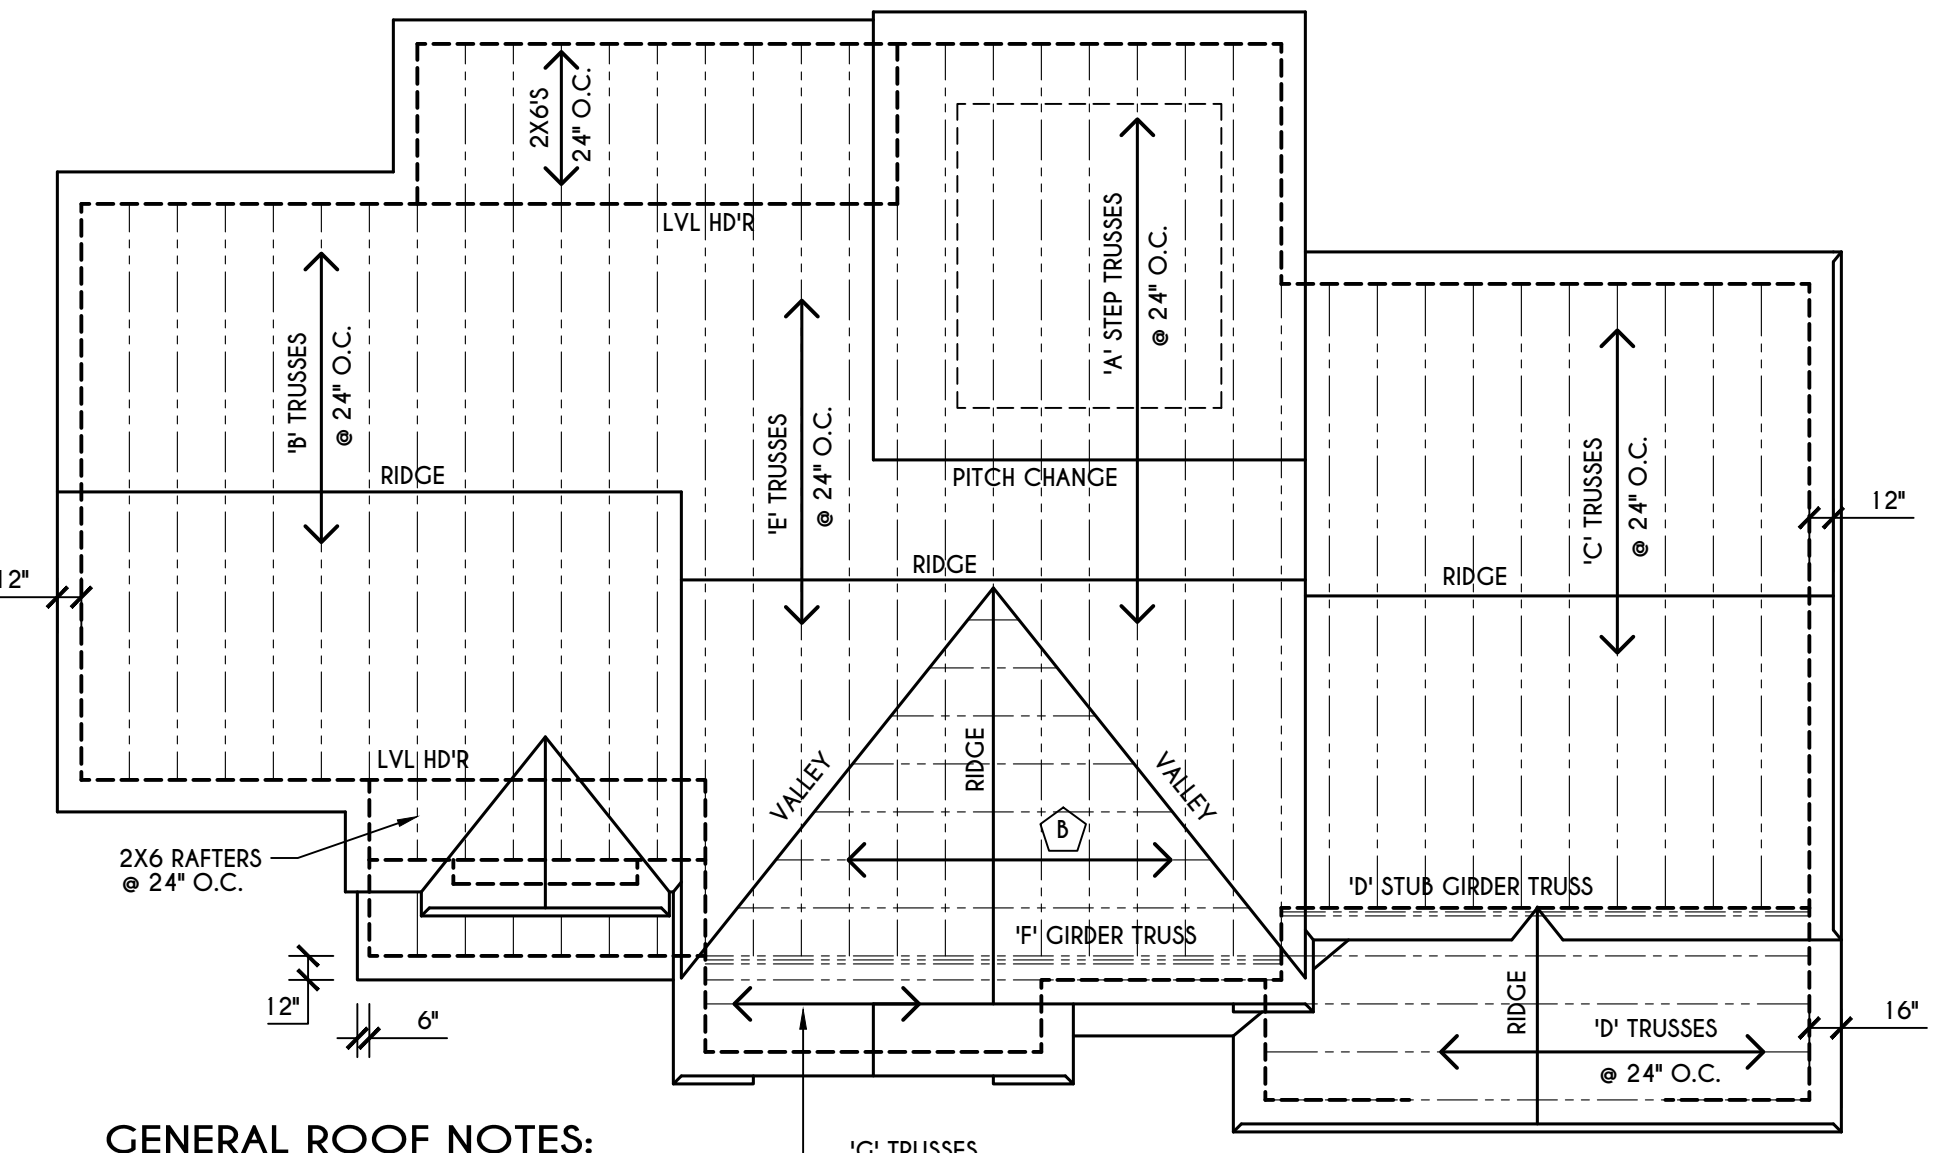


ROOF PLAN
 SCALE: 1/8" = 1'-0"

GENERAL ROOF NOTES:


ALL RAKES ARE 12" & OVERHANGS ARE 16" UNLESS NOTED OTHERWISE
 ALL NON-STRUCTURAL VALLEYS TO HAVE 2X12 SLEEPER ATTACHED TO PLYWOOD ROOF SHEATHING
 THIS FRAMING DIAGRAM IS INTENDED TO BE SCHEMATIC AND POSITION OF MEMBERS MAY BE ALTERED TO SUIT ACTUAL FIELD CONDITIONS
 4/12 PITCH ROOFS OR SHALLOWER TO HAVE 2 LAYERS 15# FELT

- 2X6 LAYOVER RAFTERS 24" O.C.
- 2X8 LAYOVER RAFTERS 24" O.C.

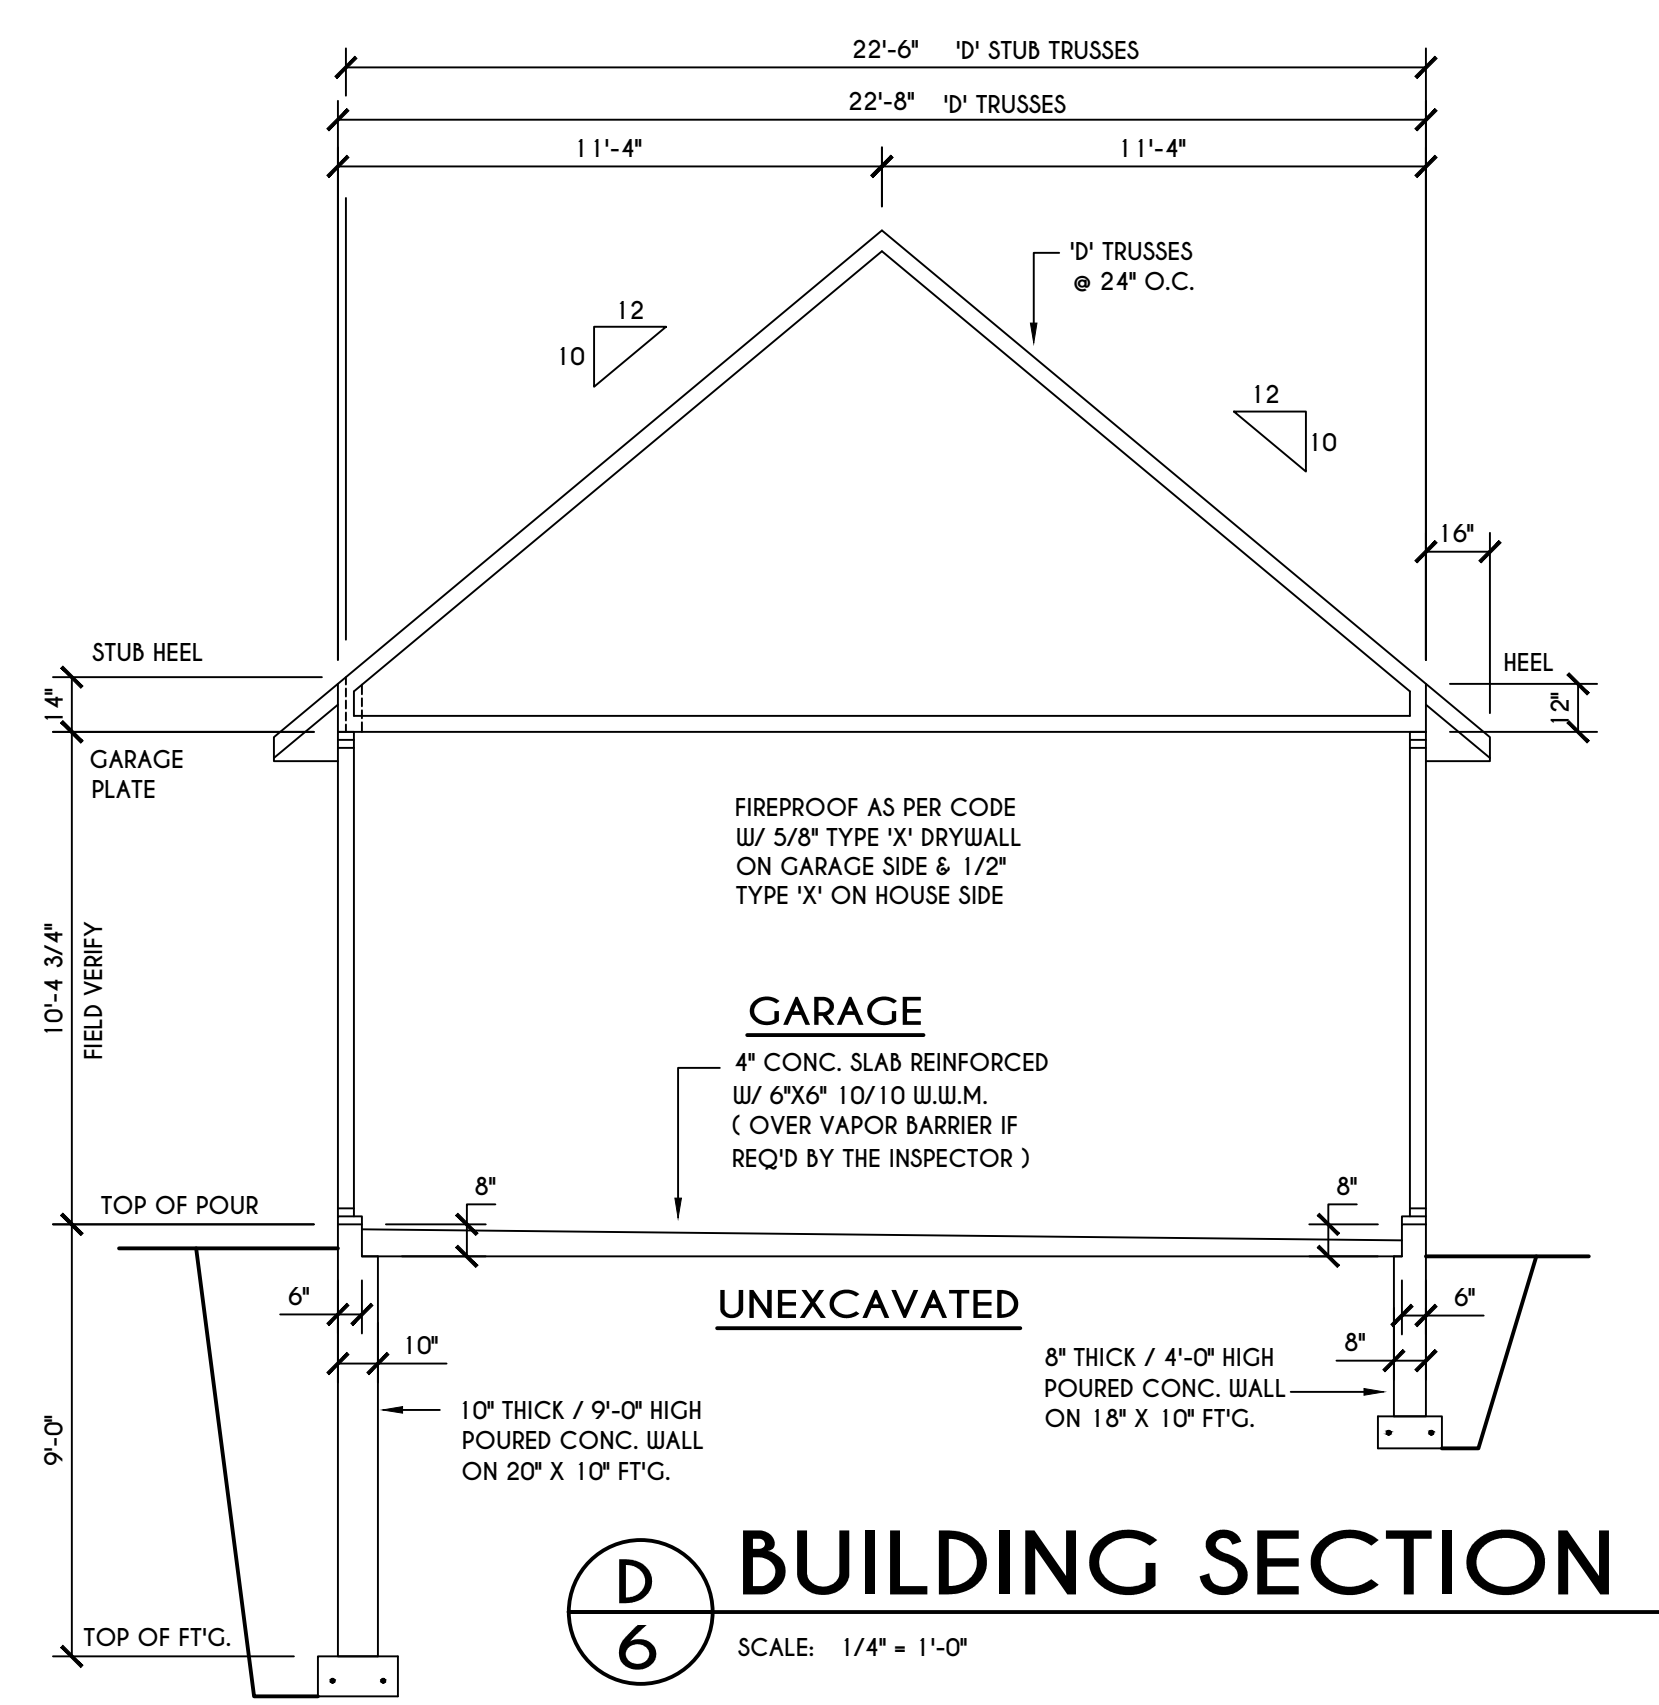


D BUILDING SECTION
SCALE: 1/4" = 1'-0"


TRUSS NOTES:
TRUSS PROFILE SHOWN FOR REFERENCE ONLY - MANUFACTURER IS RESPONSIBLE FOR CHORD LAYOUT AS REQ'D FOR DESIGN LOAD
TRUSS MANUFACTURER TO VERIFY ACTUAL LOAD AT GIRDER-TO-GIRDER CONNECTIONS & TO SPECIFY A MIN. METAL HANGER TO SUPP. THAT LOAD PROVIDE TRUSS BRACING AS INDICATED BY TRUSS DESIGNER

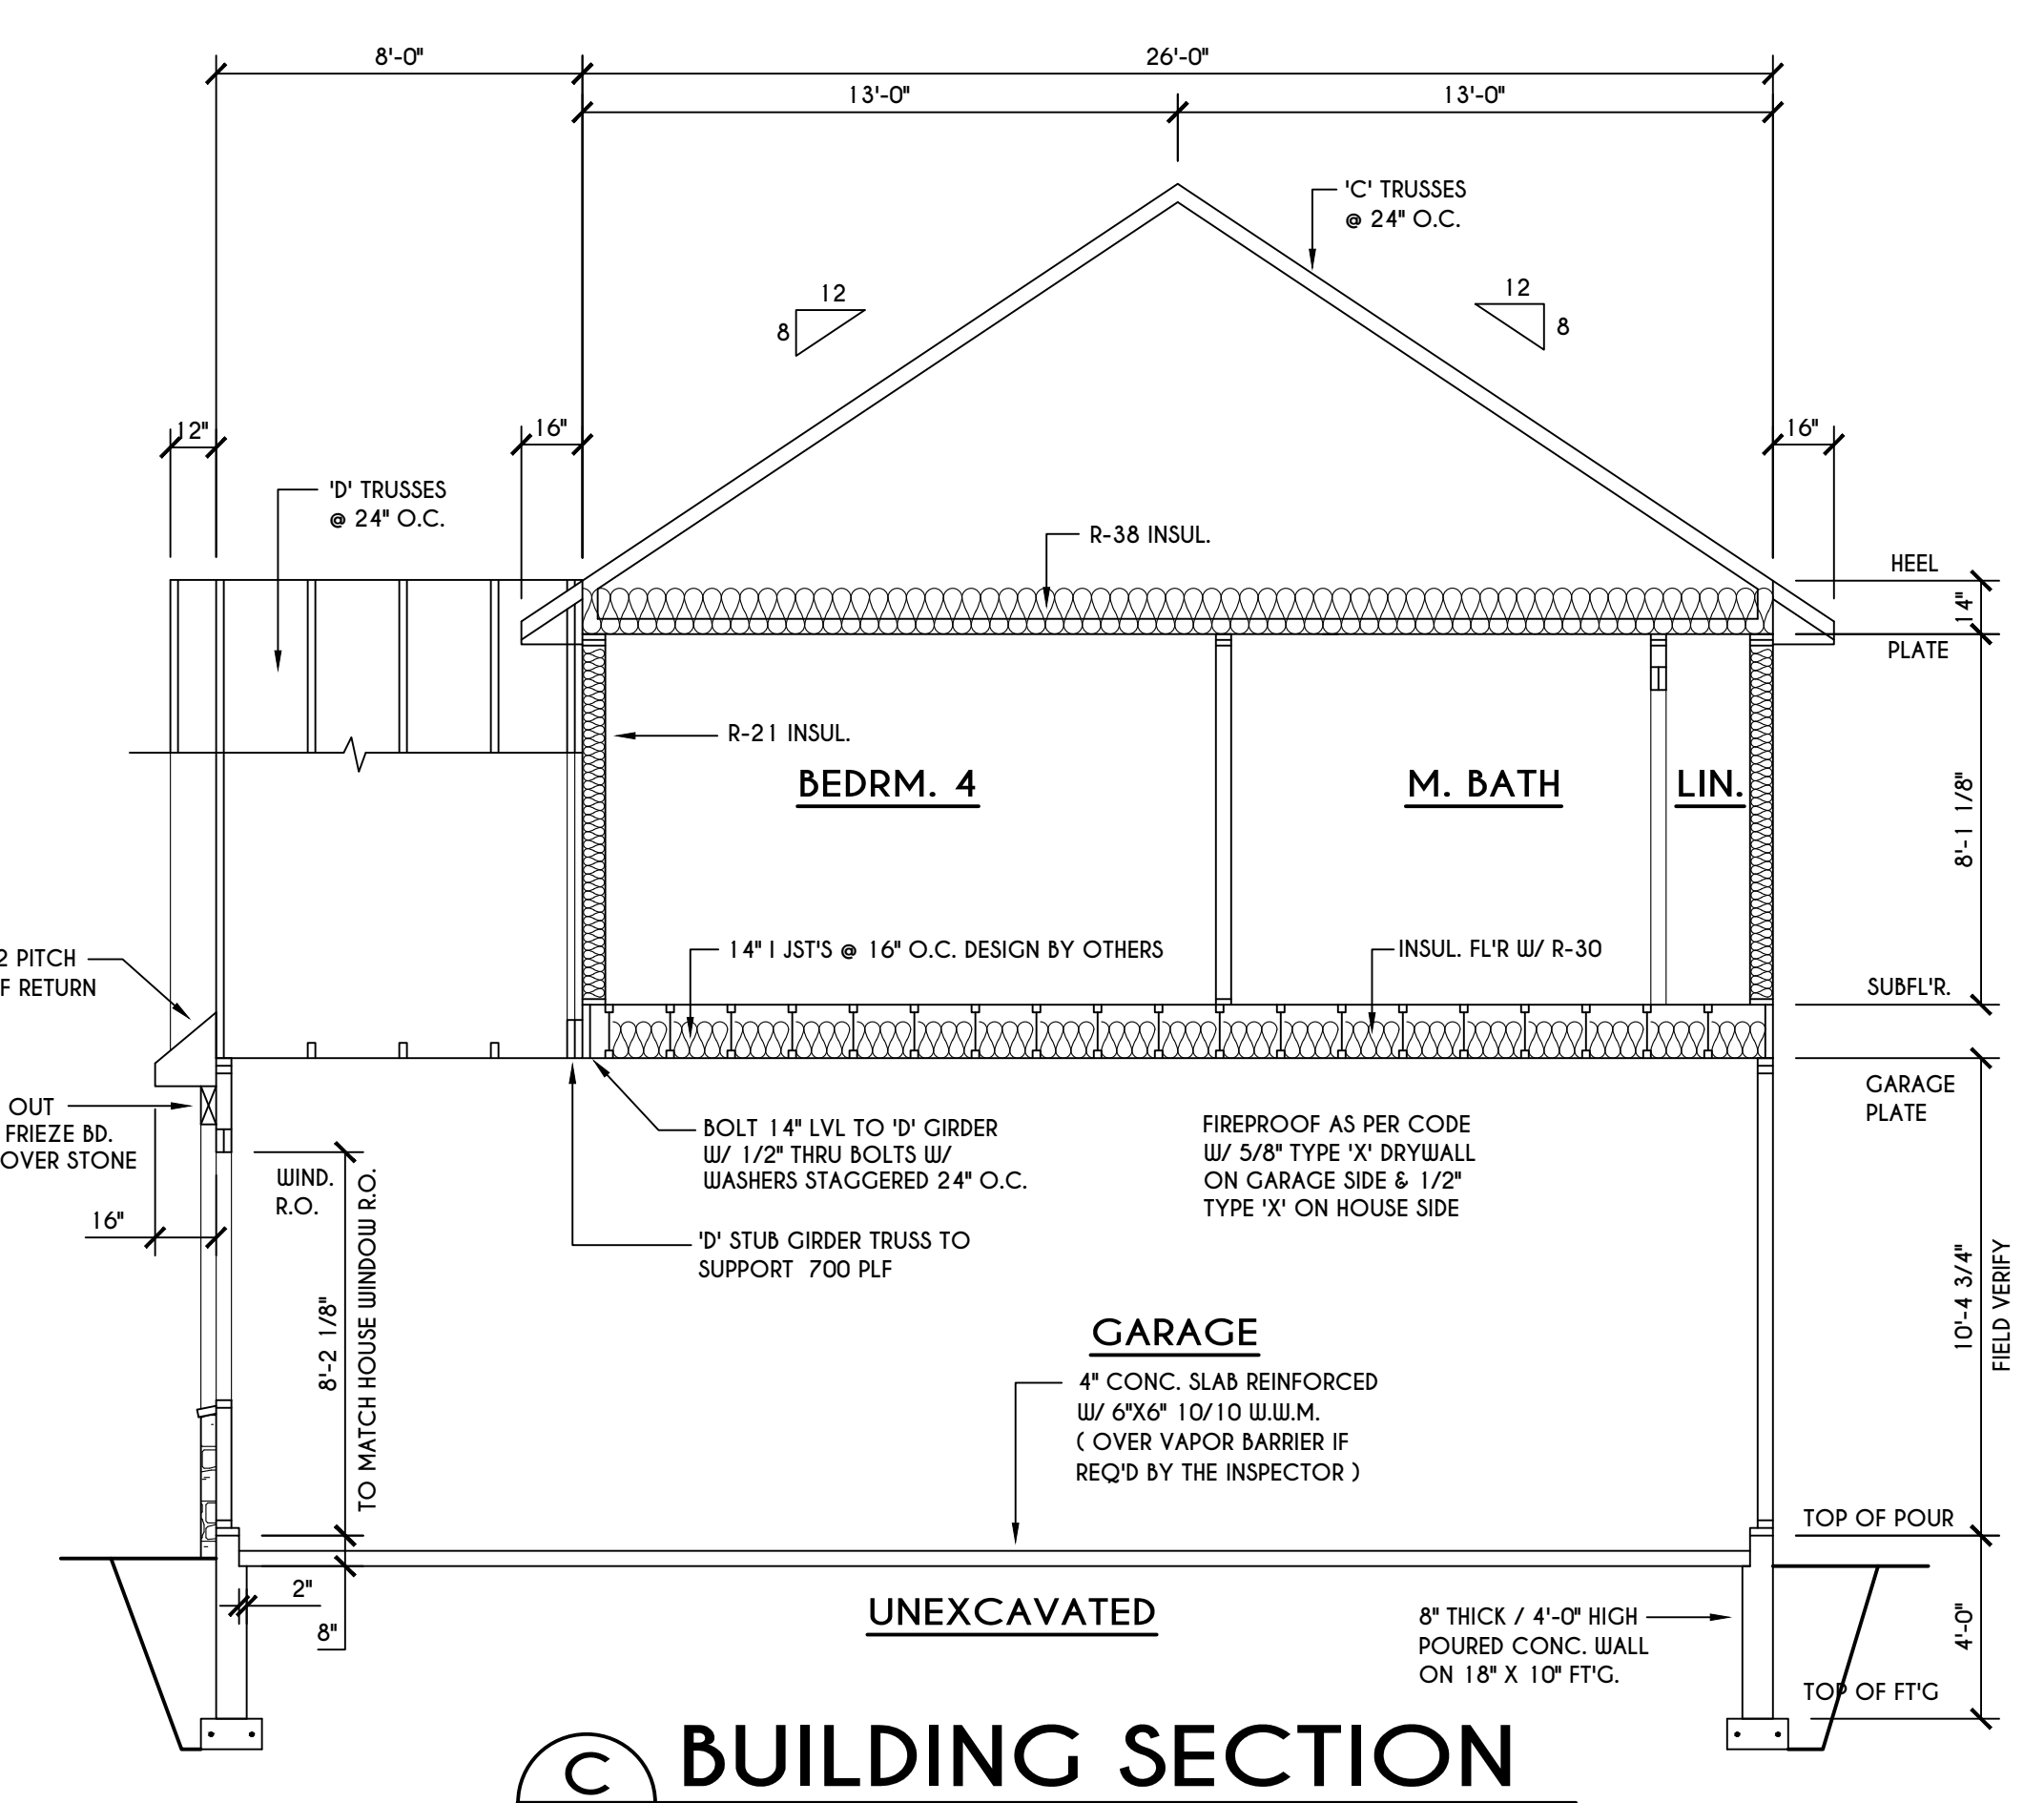

C BUILDING SECTION
SCALE: 1/4" = 1'-0"

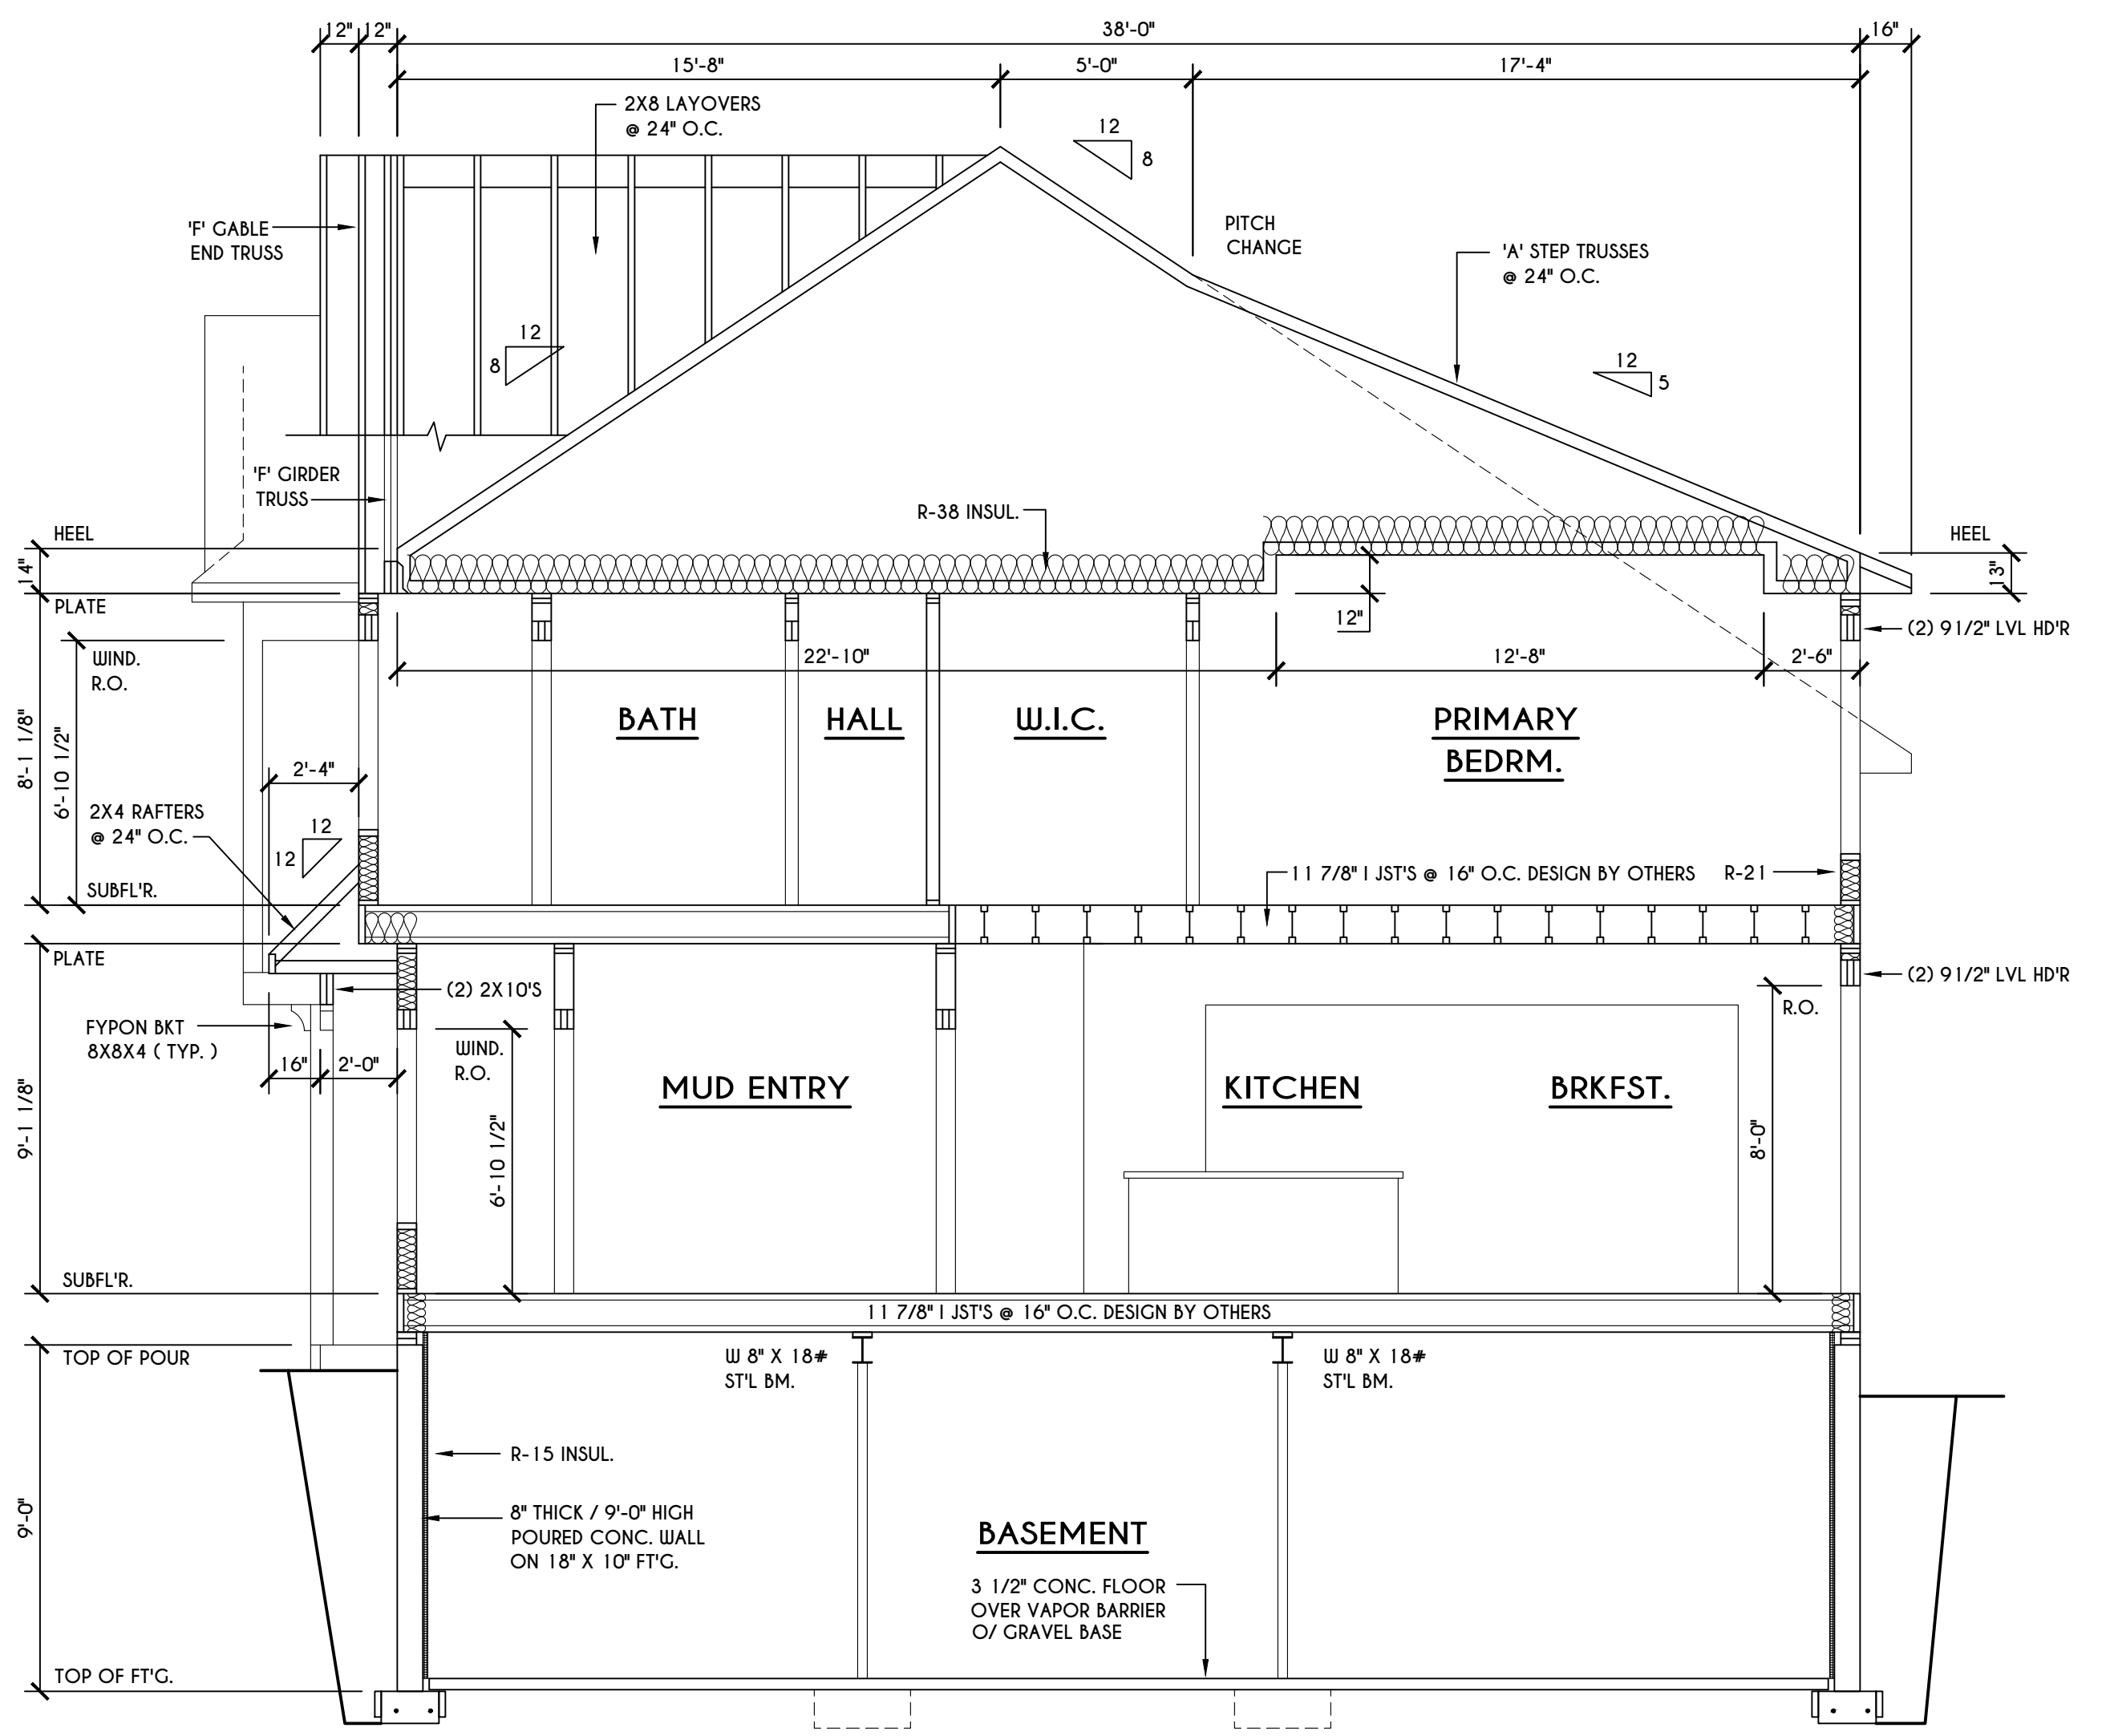


A BUILDING SECTION
SCALE: 1/4" = 1'-0"

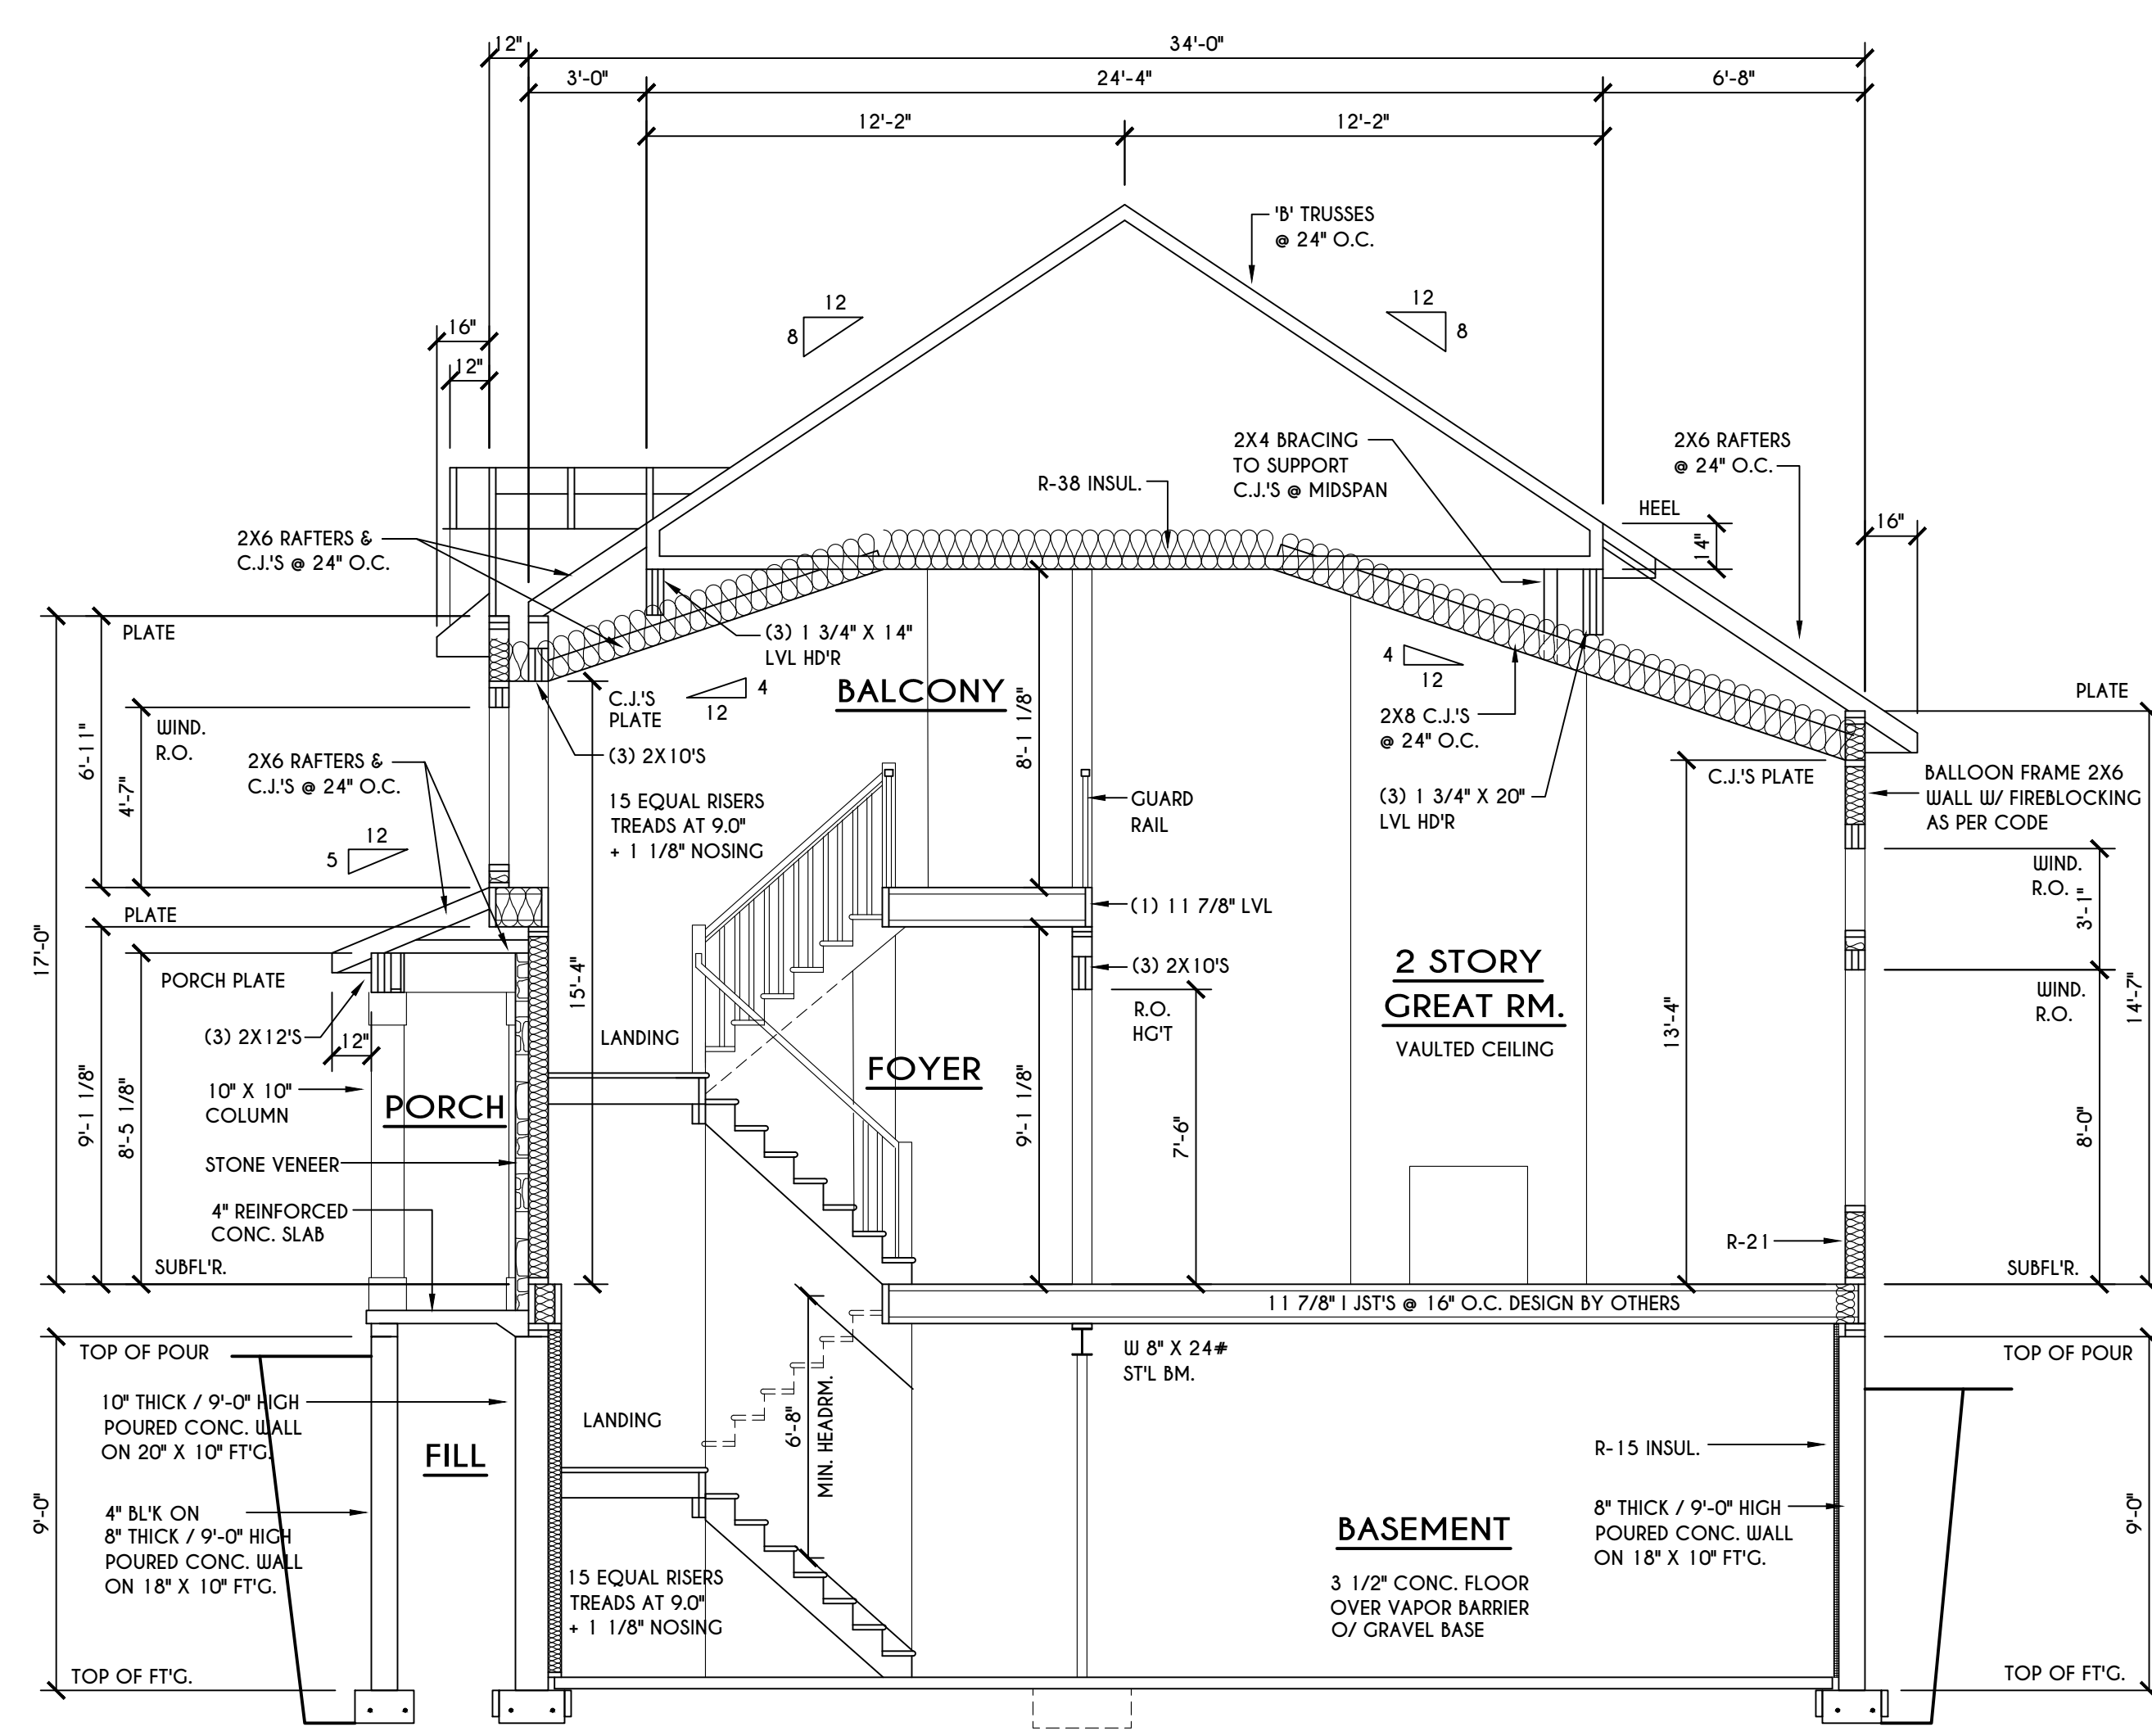

B BUILDING SECTION
SCALE: 1/4" = 1'-0"

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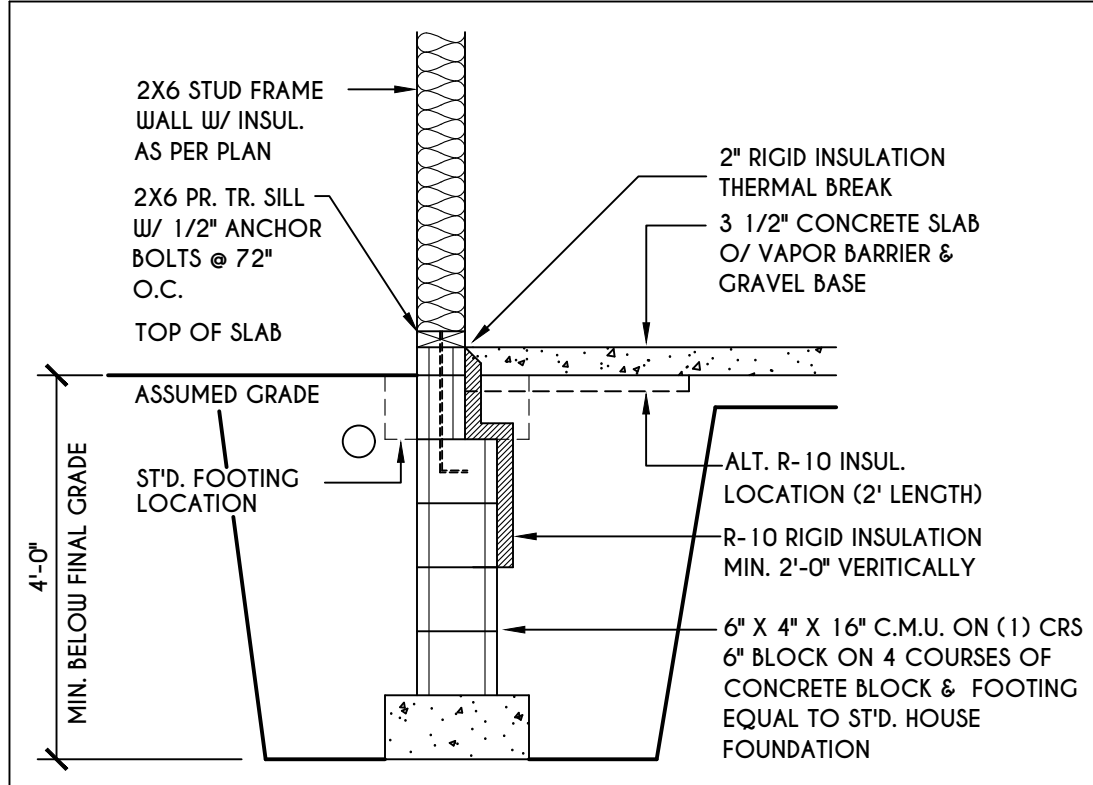
DATE	BY	DESCRIPTION

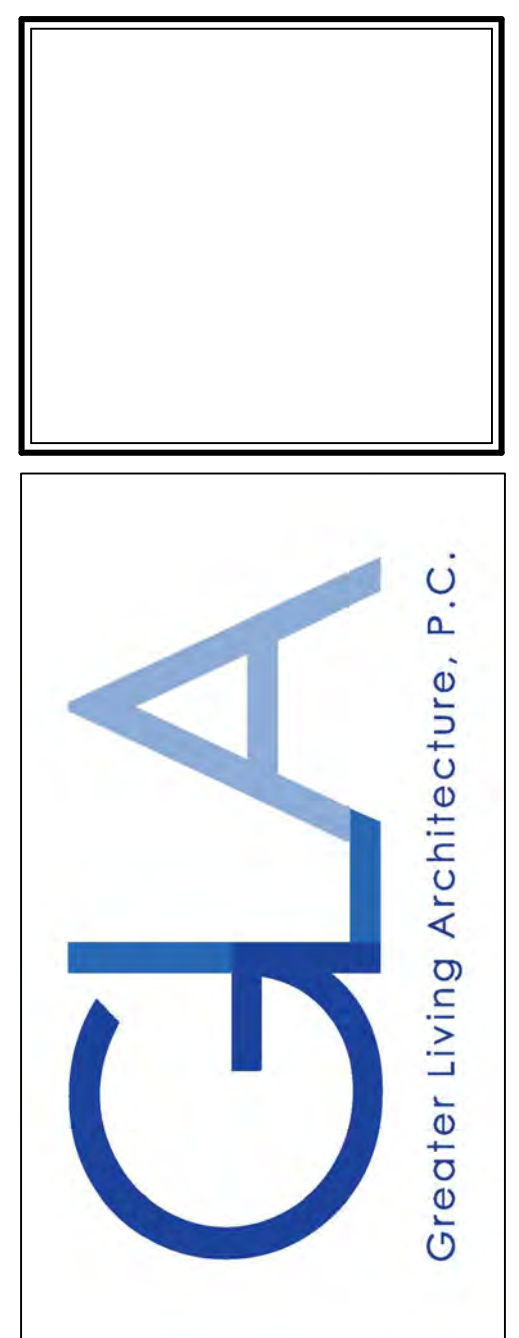CLIENT/LOCATION:
SPEC HOME
LOT 49 COVENTRY RIDGE
PITTSFORD, NY


BUILDER:
COVENTRY RIDGE
BUILDING CORP.

SECTIONS
GLA PLAN 3566


drawn: CDK	checked: CSB
scale: AS NOTED	date: 6 / 22
PROJECT: 15346E	sheet: 6 / 6




1
N-1
2X6 FRAME WALL ON C.M.U. WALK OUT DETAIL
SCALE: 1/2" = 1'-0"

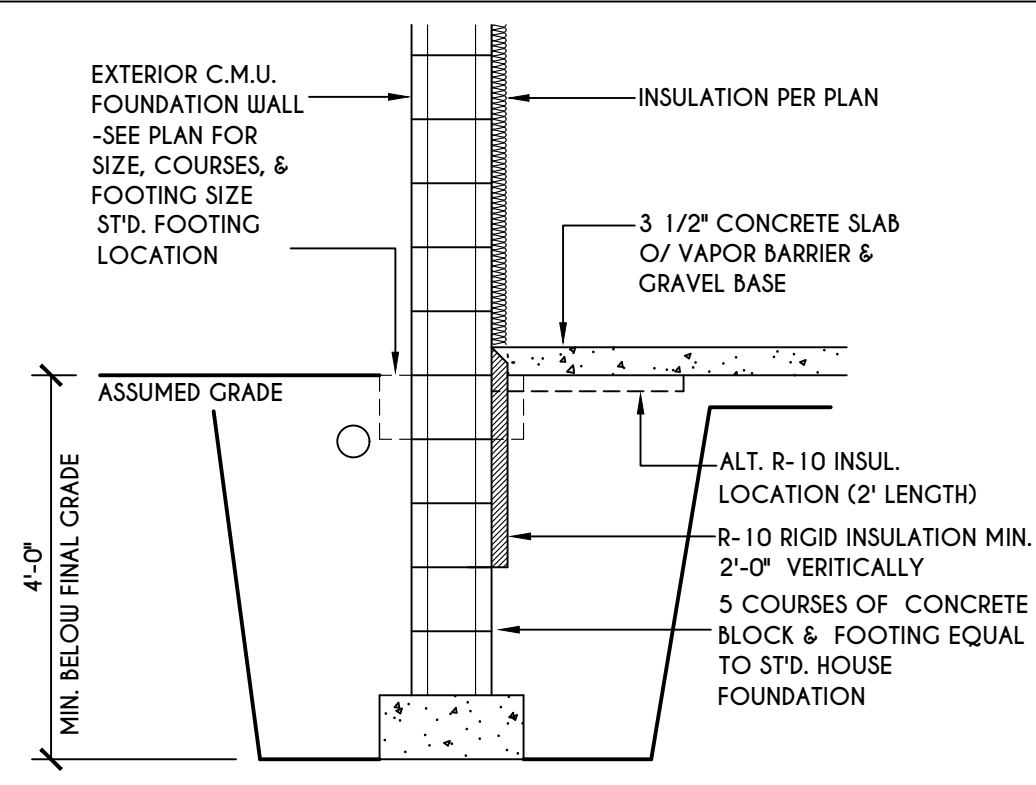


2
N-1
C.M.U. WALK OUT DETAIL
SCALE: 1/2" = 1'-0"

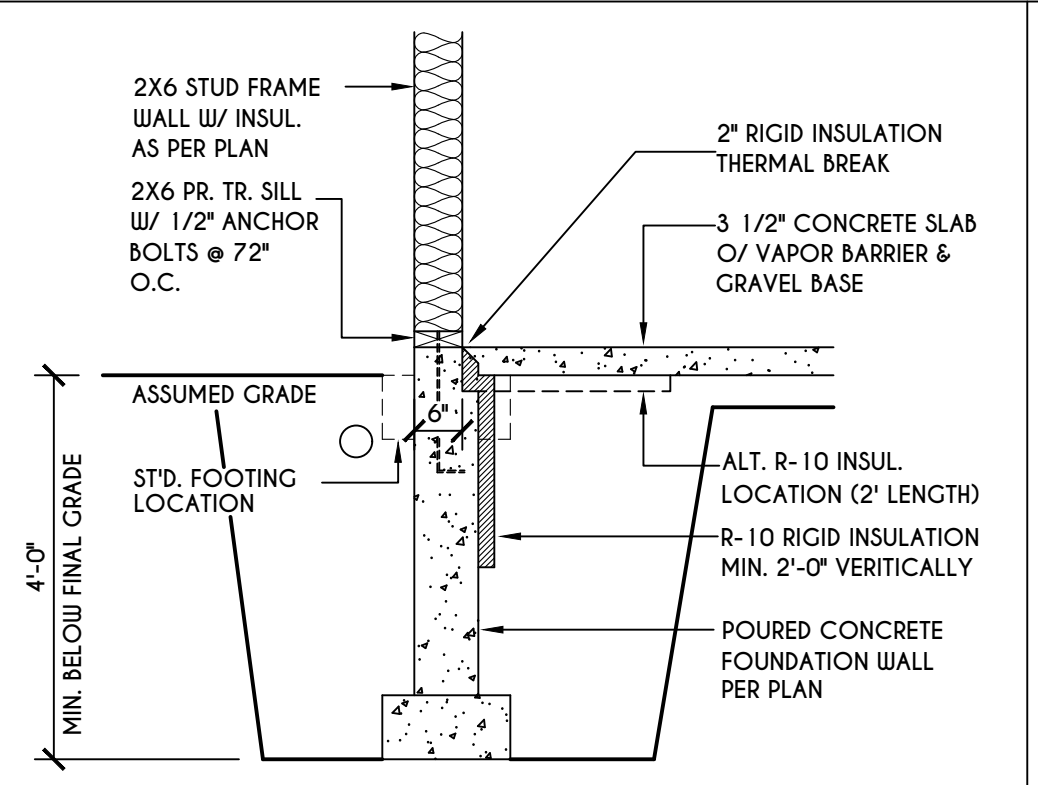


3
N-1
2X6 FRAME WALL ON POURED CONC. WALK OUT DETAIL
SCALE: 1/2" = 1'-0"

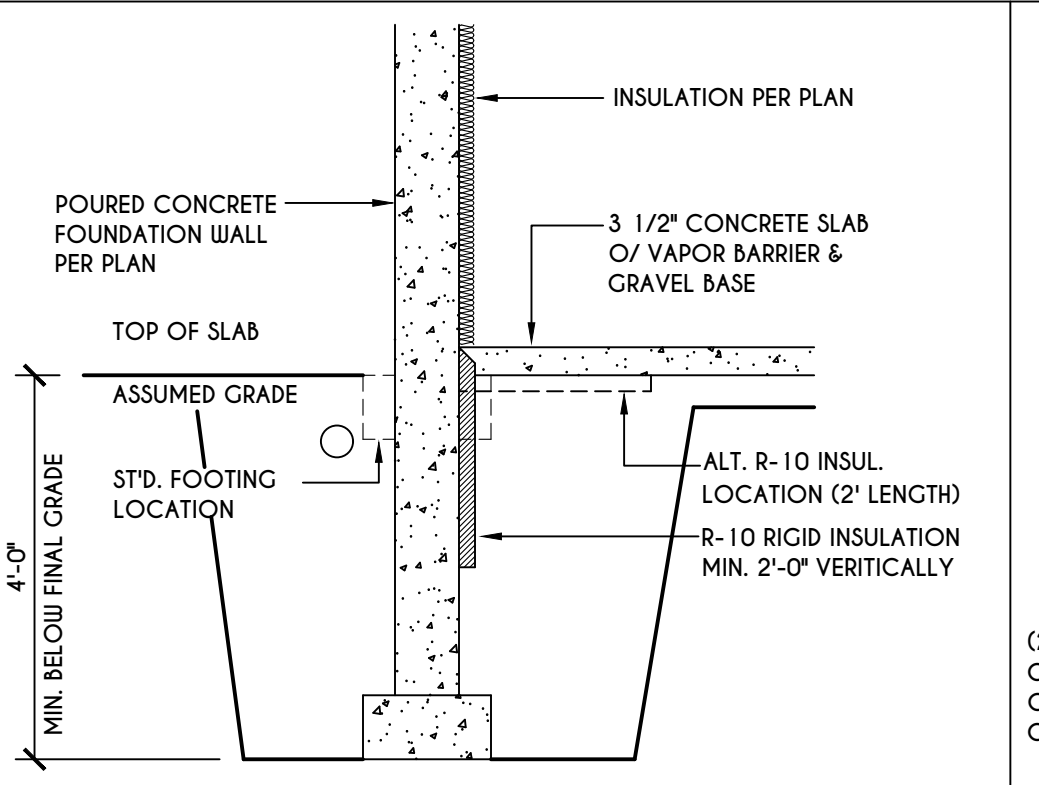


4
N-1
POURED CONC. WALK OUT DETAIL
SCALE: 1/2" = 1'-0"

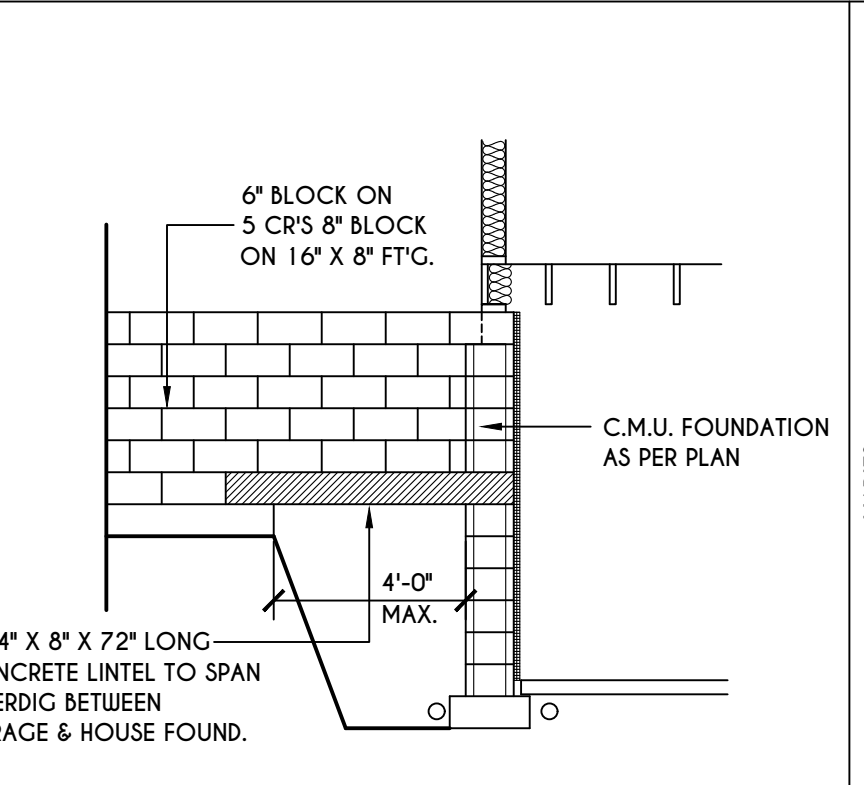


5
N-1
C.M.U. JUMP FOOTING DETAIL
SCALE: 1/4" = 1'-0"

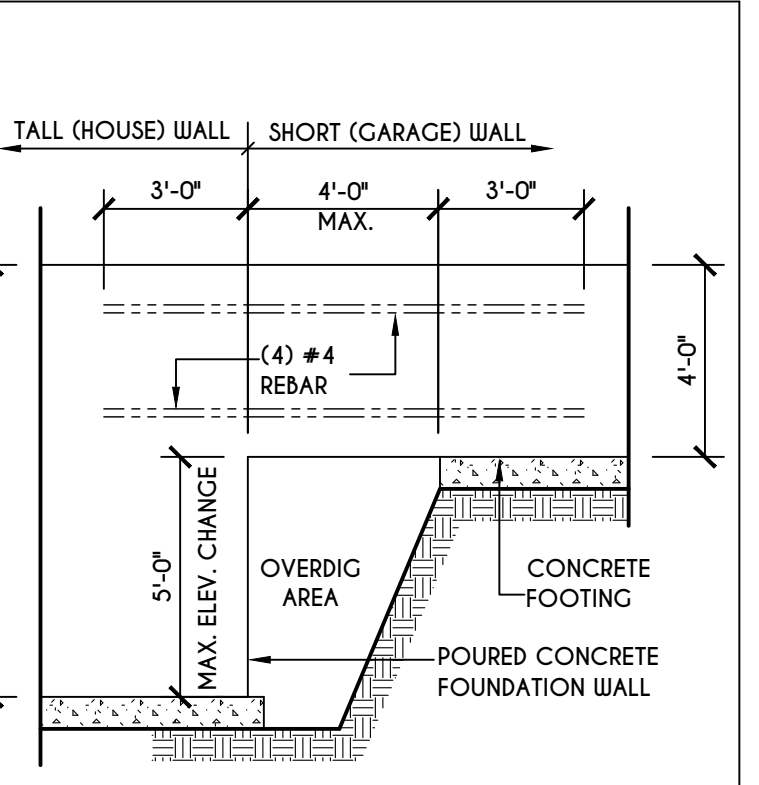


6
N-1
POURED WALL JUMP FOOTING DETAIL
SCALE: 1/4" = 1'-0"

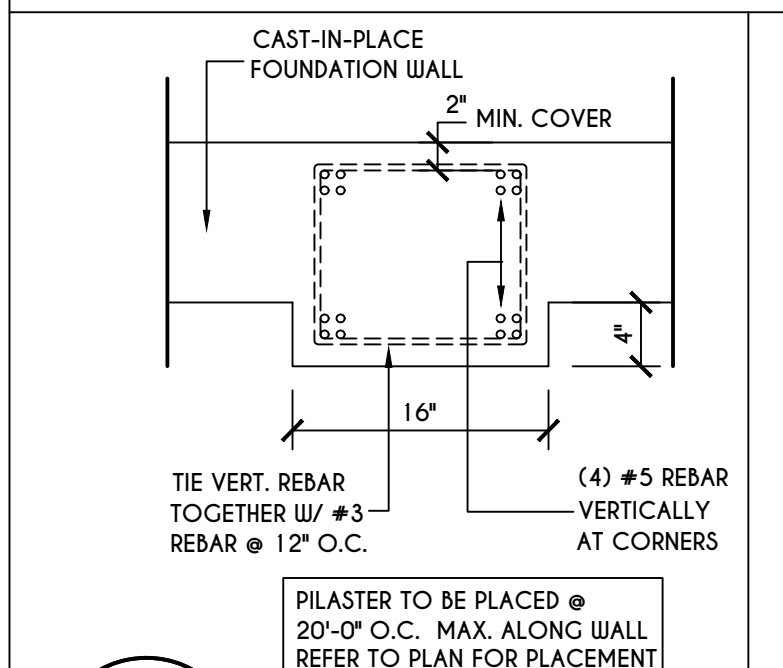


7
N-1
POURED WALL PILASTER DETAIL
SCALE: 1" = 1'-0"

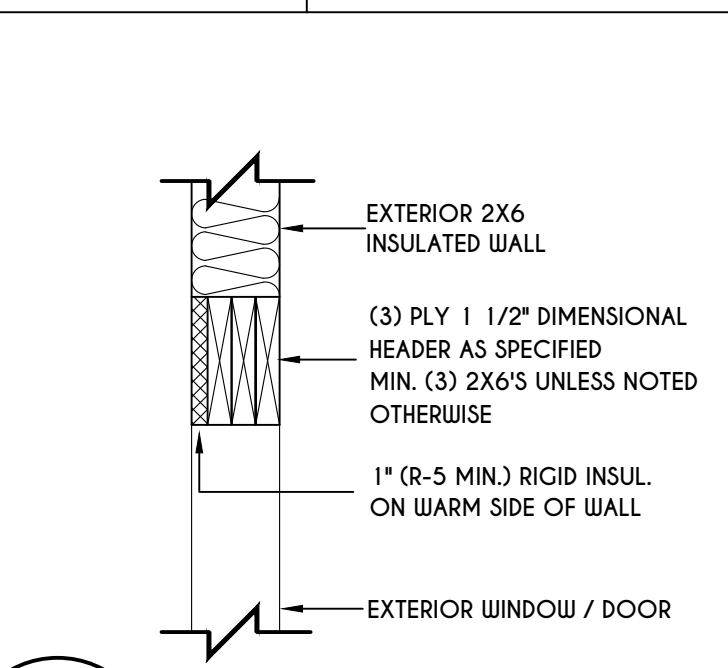


8
N-1
EXTERIOR INSULATED 3 PLY HEADER DETAIL
SCALE: 1" = 1'-0"

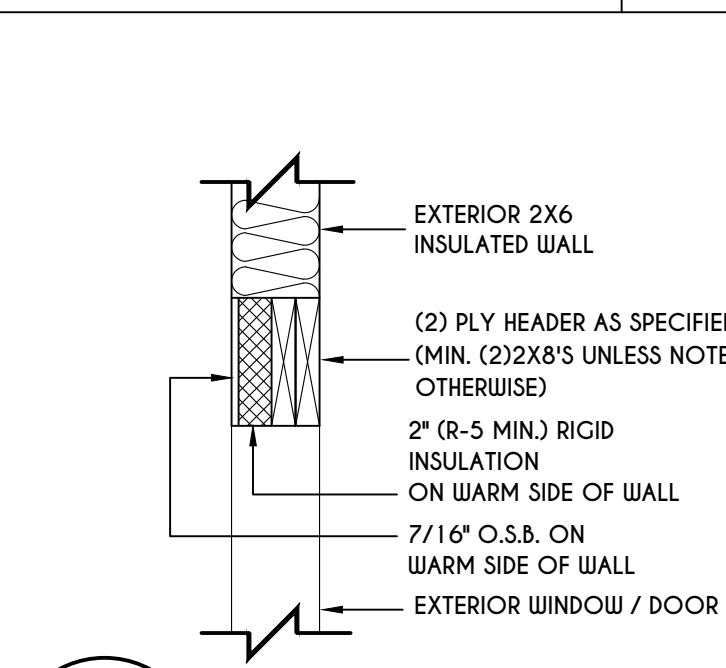


9
N-1
EXTERIOR INSULATED 2 PLY HEADER DETAIL
SCALE: 1" = 1'-0"

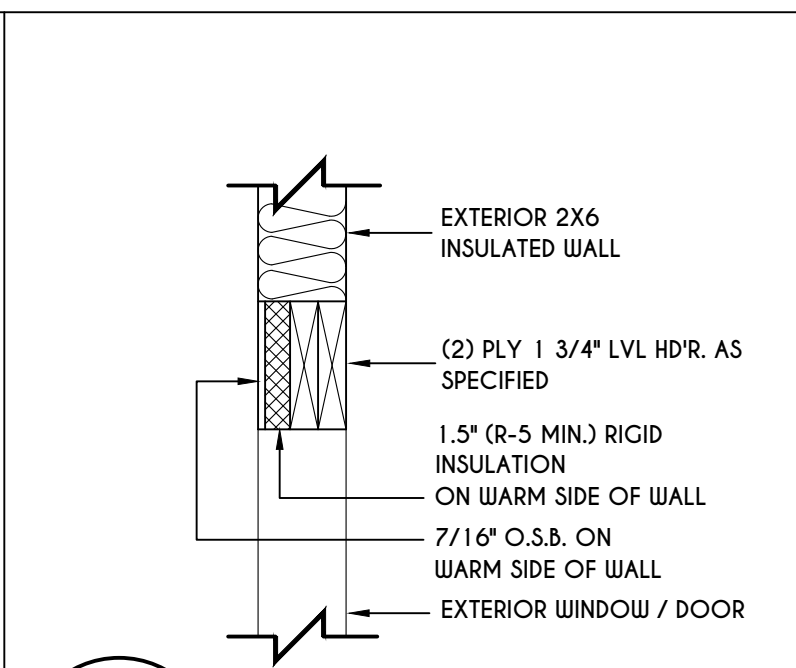


10
N-1
EXTERIOR INSULATED 2 PLY LVL HEADER DETAIL
SCALE: 1" = 1'-0"

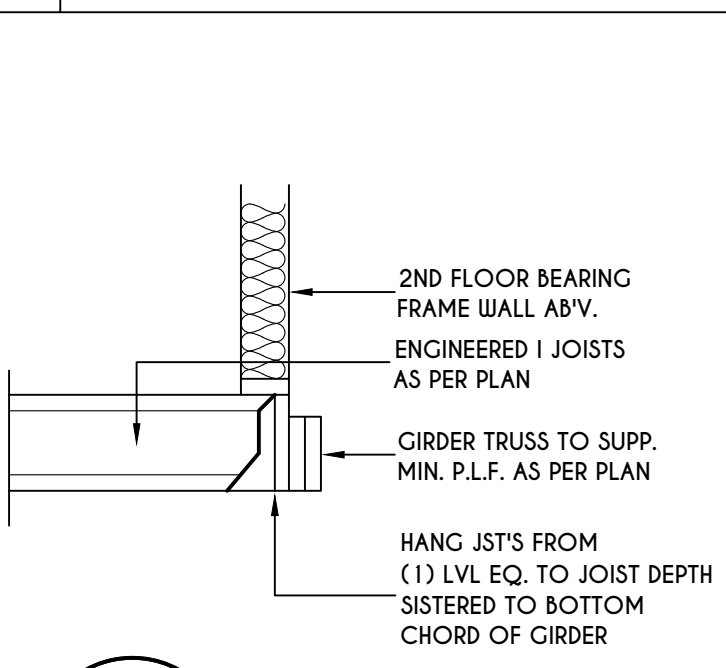


11
N-1
I JST / GIRDER DETAIL
SCALE: 1/2" = 1'-0"

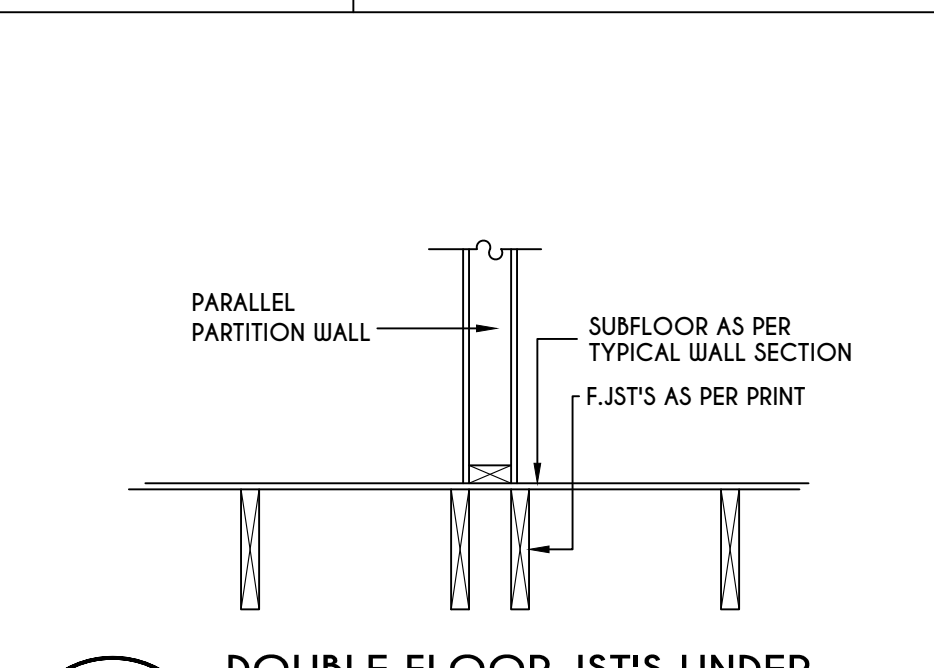


12
N-1
DOUBLE FLOOR JST'S UNDER PARALLEL PARTITION WALL DETAIL
N.T.S.

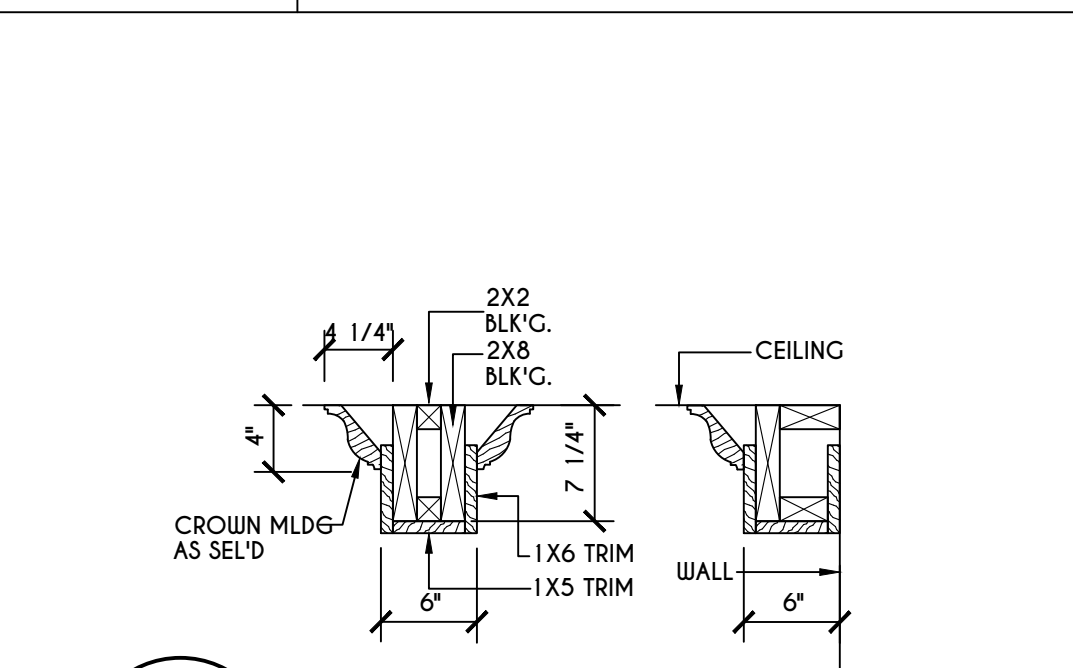


13
N-1
COFFERED BEAM DETAIL
N.T.S.

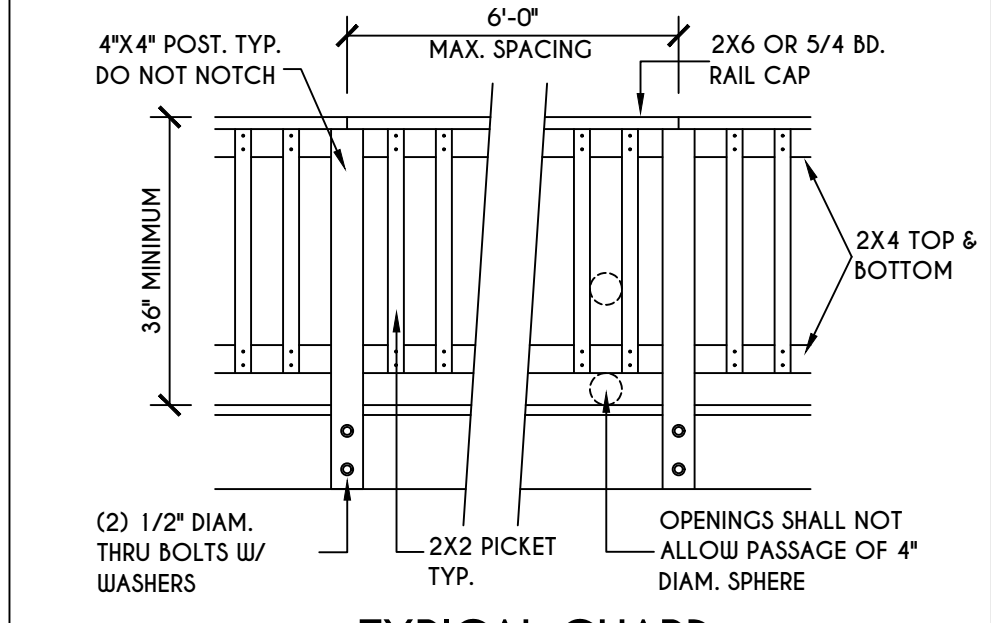

14
N-1
TYPICAL GUARD RAIL DETAIL
SCALE: 1/2" = 1'-0"
GUARD REQUIREMENTS AS PER R3 12 OF 2020 RCNYS

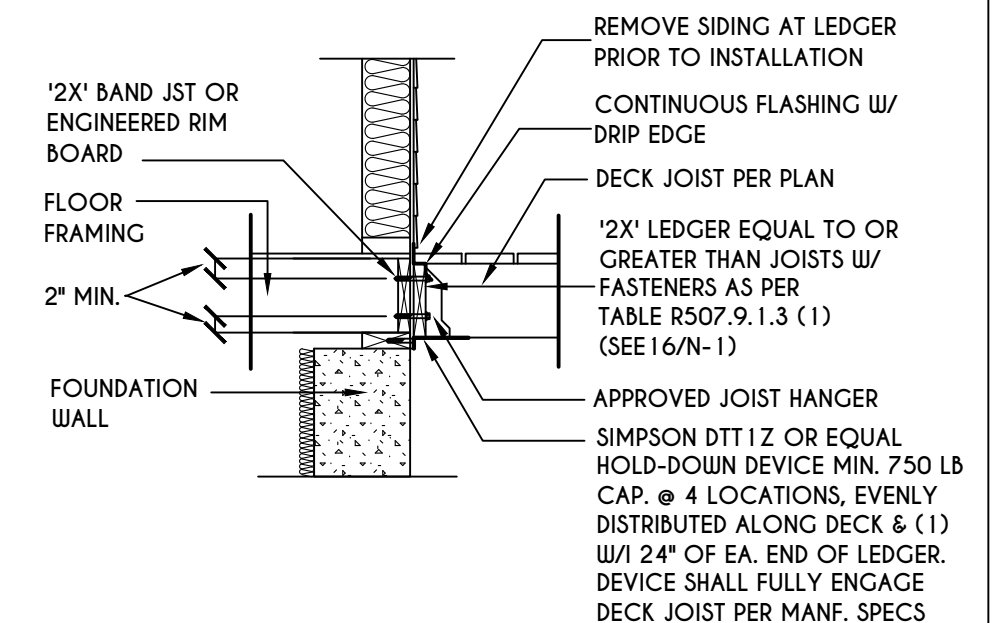


15
N-1
GENERAL ATTACHMENT OF DECK TO LEDGER BD & BAND BD.
SCALE: 1/2" = 1'-0"

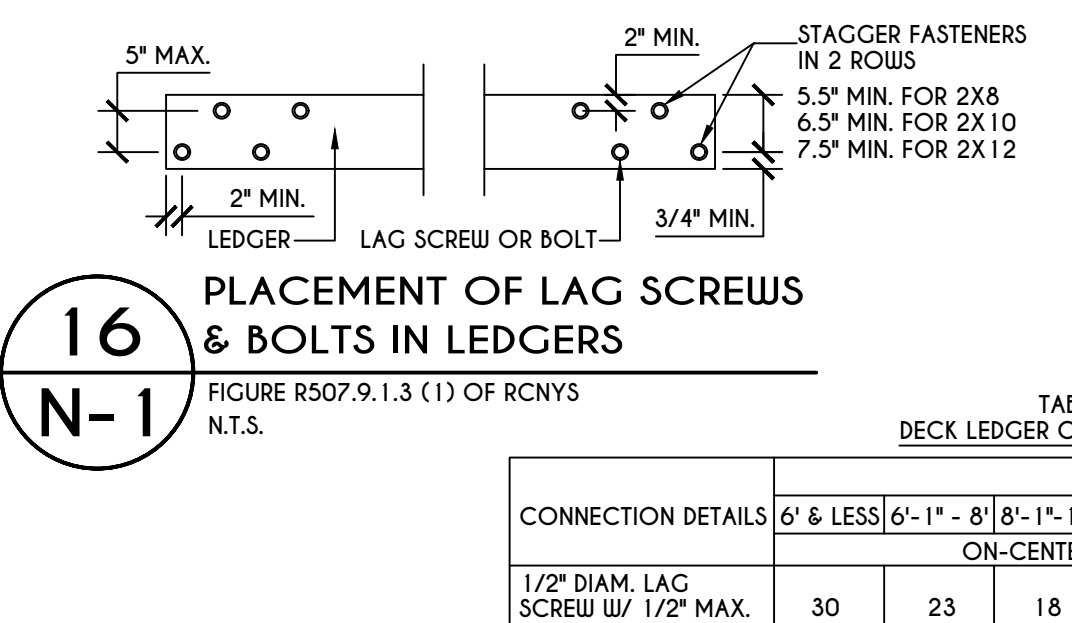

16
N-1
PLACEMENT OF LAG SCREWS & BOLTS IN LEDGERS
SCALE: 1/2" = 1'-0"

TABLE R507.9.1.3 (1) OF RCNYS
DECK LEDGER CONNECTION TO BAND JOIST
N.T.S.

CONNECTION DETAILS	JOIST SPAN						
	6' & LESS	6'-1" - 8'	8'-1" - 10'	10'-1" - 12'	12'-1" - 14'	14'-1" - 16'	16'-1" - 18'
1/2" DIAM. LAG SCREWS W/ 1/2" MAX. SHEATHING	30	23	18	15	13	11	10
1/2" DIAM. BOLT W/ 1/2" MAX. SHEATHING	36	36	34	29	24	21	19
1/2" DIAM. BOLT W/ 1" MAX. SHEATHING	36	36	29	24	21	18	16

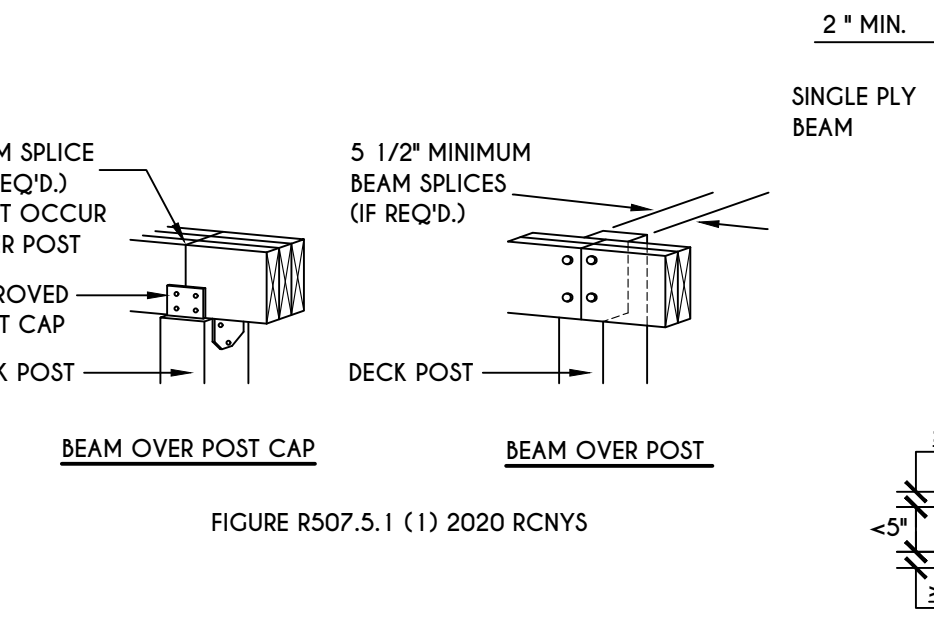


17
N-1
DECK BEAM TO DECK POST & NOTCHED POST-TO-BEAM CONNECTION
N.T.S.


TABLE R507.4
DECK POST HEIGHT

DECK POST SIZE	MAX. HEIGHT ^{a,b} (feet-inches)
4 x 4	6'-9"
4 x 6	8'
6 x 6	14'
8 x 8	14'


a. MEASURED TO UNDERSIDE OF BEAM
b. BASED ON 40 psf LIVE LOAD
c. THE MAXIMUM PERMITTED HEIGHT IS 8' FOR ONE-PLY & TWO-PLY BEAMS. THE MAXIMUM PERMITTED HEIGHT FOR THREE-PLY BEAMS ON POST CAP IS 6'-9"

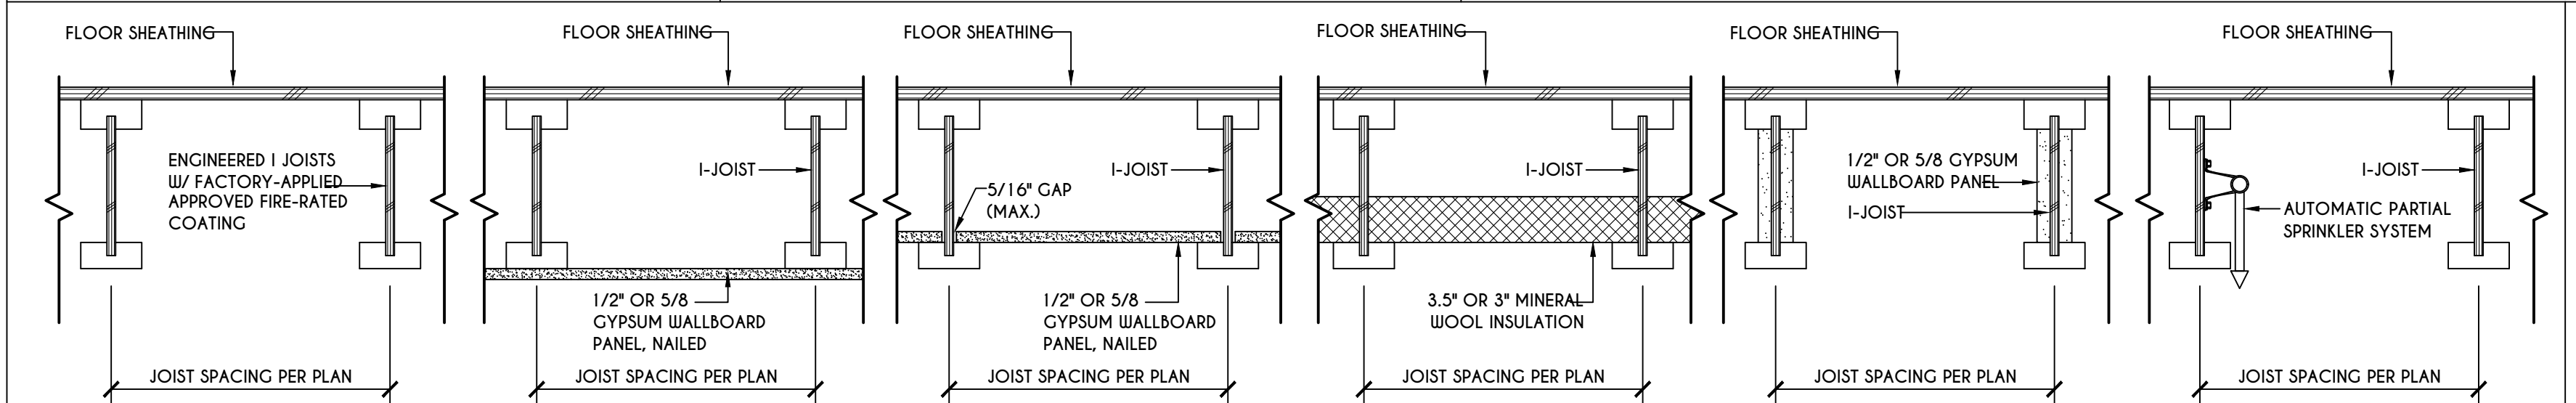


18
N-1
I-JOIST FLOOR SYSTEMS
FIRE RATED FLOOR ASSEMBLY
DETAILS AS PER APA FIRE PROTECTION OF FLOORS (FP-01) FOR COMPLIANCE WITH SECTION R302.13 OF RCNYS

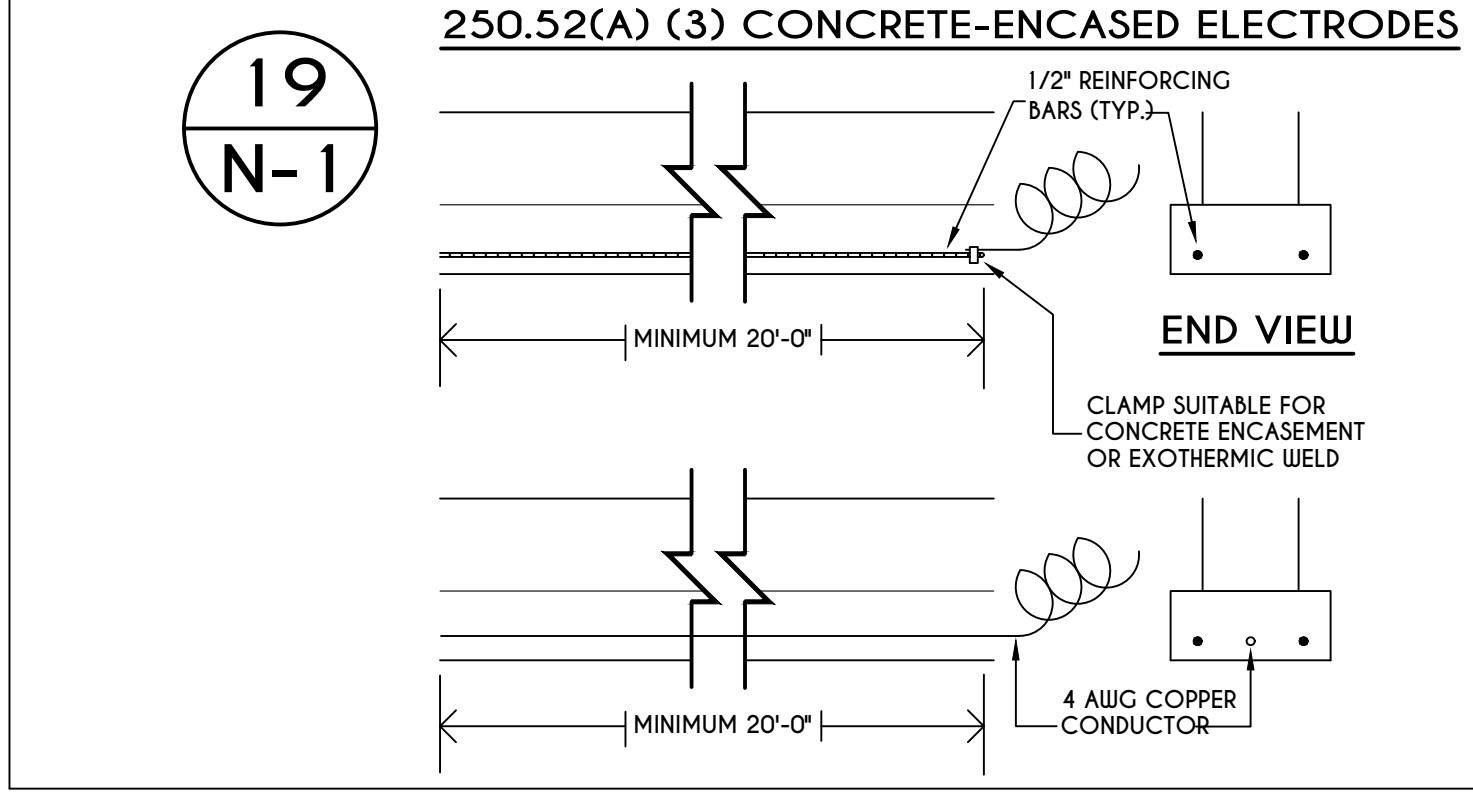


19
N-1
250.52(A) (3) CONCRETE-ENCASED ELECTRODES
SCALE: 1/2" = 1'-0"

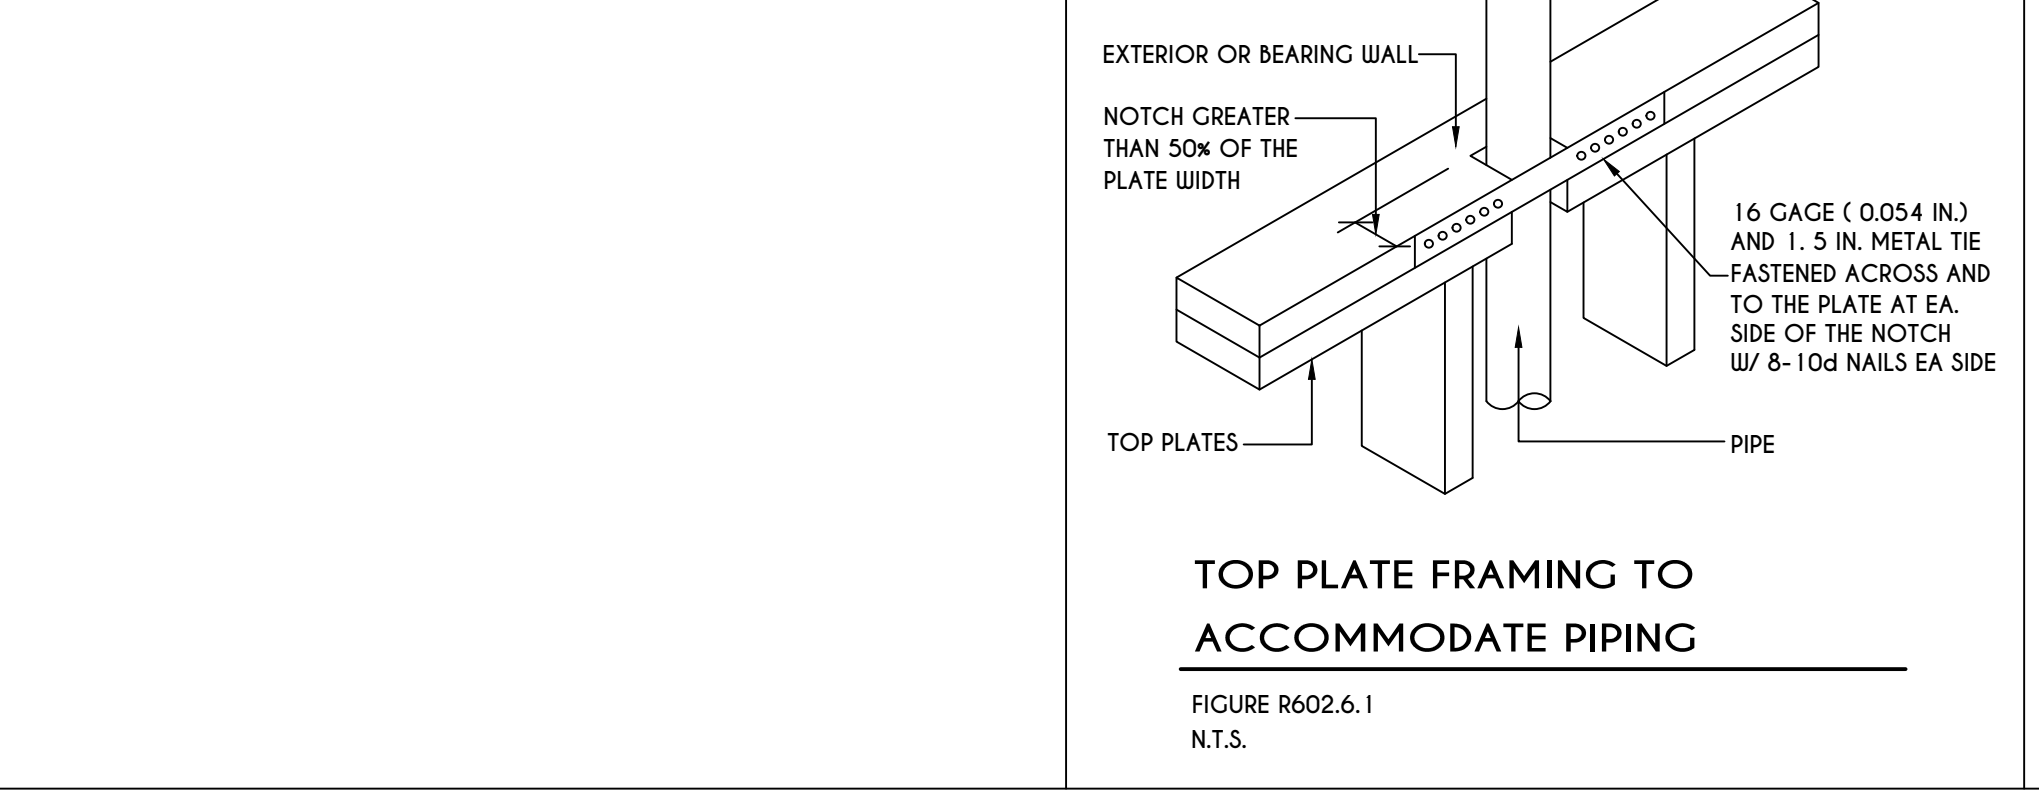


TOP PLATE FRAMING TO ACCOMMODATE PIPING
FIGURE R602.6.1
N.T.S.

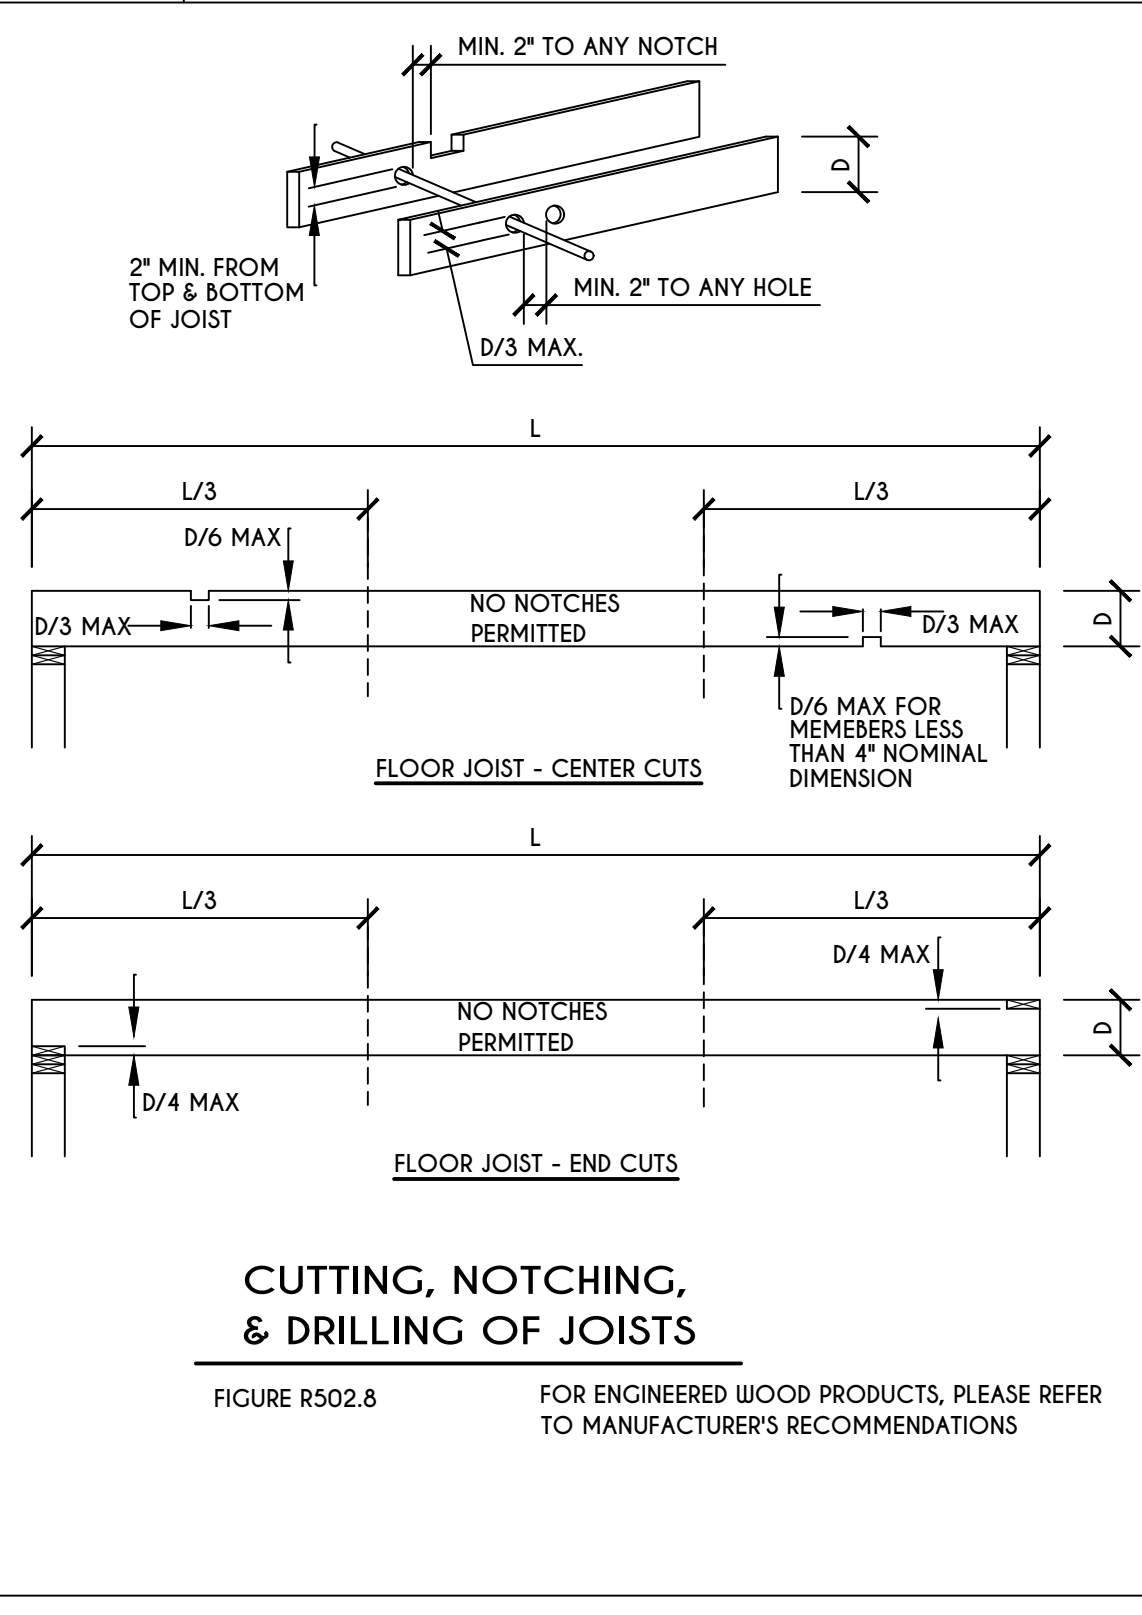

CUTTING, NOTCHING, & DRILLING OF JOISTS
FIGURE R502.8
FOR ENGINEERED WOOD PRODUCTS, PLEASE REFER TO MANUFACTURER'S RECOMMENDATIONS

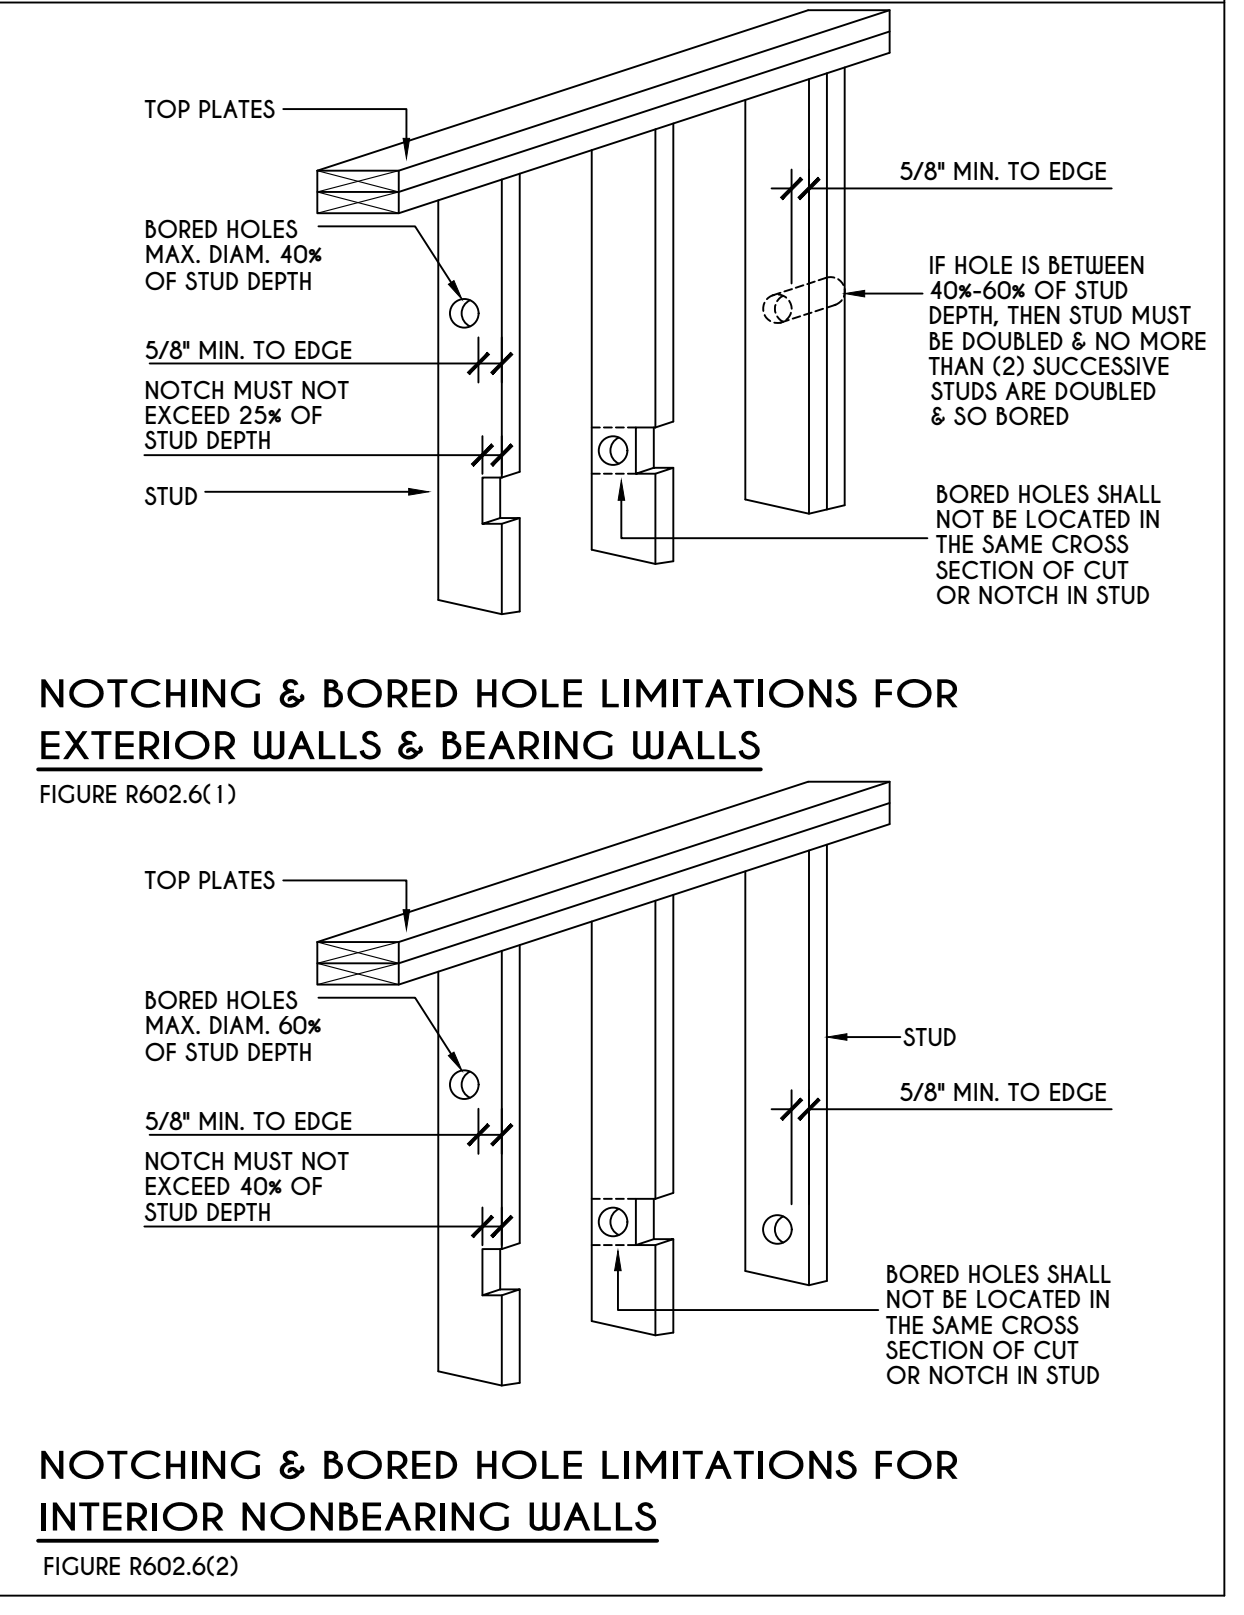


NOTCHING & BORED HOLE LIMITATIONS FOR EXTERIOR WALLS & BEARING WALLS
FIGURE R602.6(1)

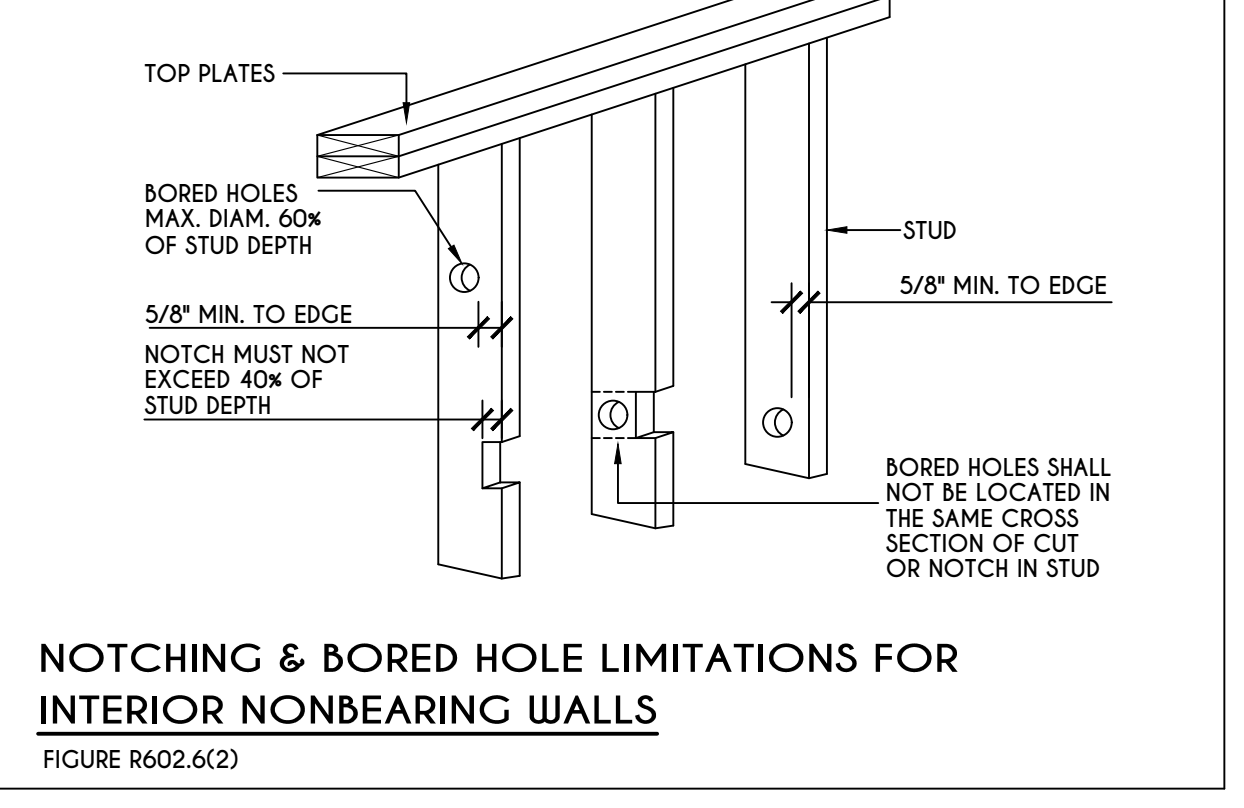

NOTCHING & BORED HOLE LIMITATIONS FOR INTERIOR NONBEARING WALLS
FIGURE R602.6(2)

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REVISIONS:

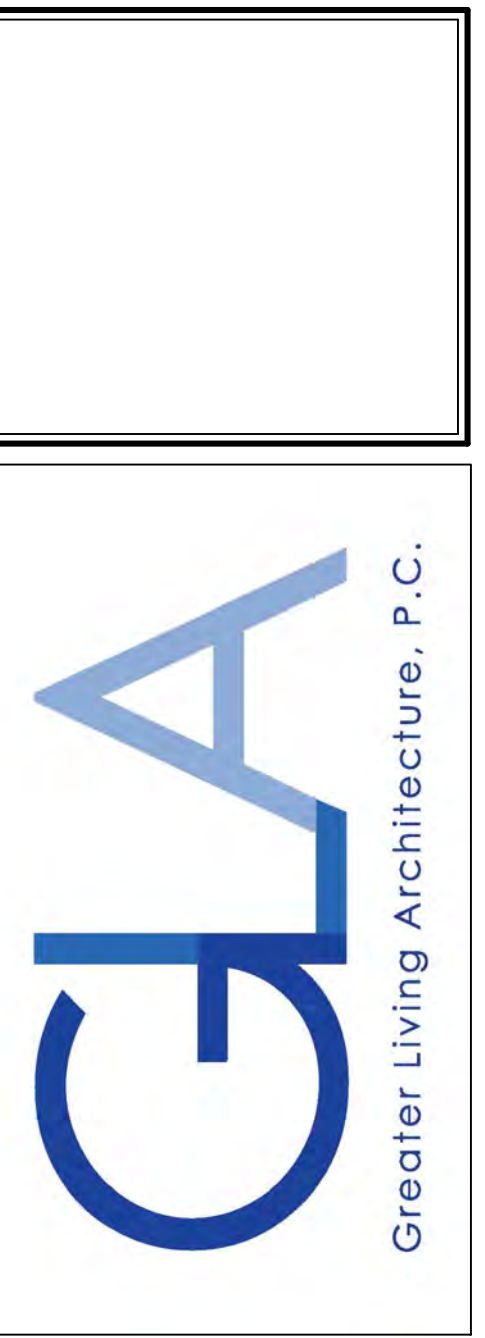DATE	BY	DESCRIPTION

CLIENT/LOCATION:

SPEC HOME
LOT 49 COVENTRY RIDGE
PITTSFORD, NY

BUILDER:

COVENTRY RIDGE
BUILDING CORP.

DETAILS
GLA PLAN 3566

drawn: CDK	checked: CSB
scale: AS NOTED	date: 6 / 22
PROJECT: 15346E	sheet: N 1

TABLE R404.1.1(2)

8-INCH MASONRY FOUNDATION WALLS WITH REINFORCING WHERE $d > 5$ INCHES ^{a, c, f}

WALL HEIGHT	HEIGHT OF UNBALANCED BACKFILL ^g	MINIMUM VERTICAL REINFORCEMENT AND SPACING (INCHES) ^{b, c}			
		SOIL CLASSES AND LATERAL SOIL LOAD ^d (psf PER FOOT BELOW GRADE)			
		GM, GP, SU, AND SP SOILS 30	GM, GS, SM-SC AND ML SOILS 45	SC, MK, ML-CL AND INORGANIC CL SOILS 60	
6'-8"	4' (OR LESS)	#4 @ 48" O.C.	#4 @ 48" O.C.	#4 @ 48" O.C.	
	5'	#4 @ 48" O.C.	#4 @ 48" O.C.	#4 @ 48" O.C.	
	6'-8"	#5 @ 48" O.C.	#5 @ 48" O.C.	#5 @ 48" O.C.	
7'-4"	4' (OR LESS)	#4 @ 48" O.C.	#4 @ 48" O.C.	#4 @ 48" O.C.	
	5'	#4 @ 48" O.C.	#4 @ 48" O.C.	#4 @ 48" O.C.	
	7'-4"	#5 @ 48" O.C.	#5 @ 48" O.C.	#5 @ 48" O.C.	
8'-0"	4' (OR LESS)	#4 @ 48" O.C.	#4 @ 48" O.C.	#4 @ 48" O.C.	
	5'	#4 @ 48" O.C.	#4 @ 48" O.C.	#4 @ 48" O.C.	
	6'	#4 @ 48" O.C.	#5 @ 48" O.C.	#5 @ 48" O.C.	
	8'-0"	#5 @ 48" O.C.	#5 @ 48" O.C.	#5 @ 32" O.C.	
8'-8"	4' (OR LESS)	#4 @ 48" O.C.	#4 @ 48" O.C.	#4 @ 48" O.C.	
	5'	#4 @ 48" O.C.	#4 @ 48" O.C.	#5 @ 48" O.C.	
	6'	#4 @ 48" O.C.	#5 @ 48" O.C.	#5 @ 48" O.C.	
	8'-8"	#5 @ 48" O.C.	#5 @ 32" O.C.	#5 @ 24" O.C.	
9'-4"	4' (OR LESS)	#4 @ 48" O.C.	#4 @ 48" O.C.	#4 @ 48" O.C.	
	5'	#4 @ 48" O.C.	#4 @ 48" O.C.	#5 @ 48" O.C.	
	6'	#4 @ 48" O.C.	#5 @ 48" O.C.	#5 @ 48" O.C.	
	9'-4"	#5 @ 48" O.C.	#5 @ 24" O.C.	#5 @ 16" O.C.	
10'-0"	4' (OR LESS)	#4 @ 48" O.C.	#4 @ 48" O.C.	#4 @ 48" O.C.	
	5'	#4 @ 48" O.C.	#4 @ 48" O.C.	#5 @ 48" O.C.	
	6'	#4 @ 48" O.C.	#5 @ 48" O.C.	#5 @ 48" O.C.	
	7'	#5 @ 48" O.C.	#5 @ 48" O.C.	#5 @ 32" O.C.	
	10'-0"	#5 @ 48" O.C.	#5 @ 32" O.C.	#5 @ 16" O.C.	

- a. MORTAR SHALL BE TYPE M OR S AND MASONRY SHALL BE LAID IN RUNNING BOND.
b. ALTERNATIVE REINFORCING BAR SIZES AND SPACINGS SHALL HAVE AN EQUIVALENT CROSS-SECTIONAL AREA OF REINFORCEMENT PER LINEAL FOOT OF WALL SHALL BE PERMITTED PROVIDED THE SPACING OF THE REINFORCEMENT DOES NOT EXCEED 72" IN SEISMIC DESIGN CATEGORIES A, B AND C, AND 48 INCHES IN SEISMIC DESIGN CATEGORIES DD, D1 AND D2.
c. VERTICAL REINFORCEMENT SHALL BE GRADE 60 MINIMUM. THE DISTANCE FROM THE FACE OF THE SOIL SIDE OF THE WALL TO THE CENTER OF VERTICAL REINFORCEMENT SHALL BE NOT LESS THAN 5 INCHES.
d. SOIL CLASSES ARE IN ACCORDANCE WITH THE UNIFIED SOIL CLASSIFICATION SYSTEM AND DESIGN LATERAL SOIL LOADS ARE FOR MOIST CONDITIONS WITHOUT HYDROSTATIC PRESSURE. REFER TO TABLE R404.1.
e. UNBALANCED BACKFILL HEIGHT IS THE DIFFERENCE IN HEIGHT BETWEEN THE EXTERIOR FINISH GROUND LEVEL AND THE LOWER OF THE TOP OF THE CONCRETE FOOTING THAT SUPPORTS THE FOUNDATION WALL OR THE INTERIOR FINISH GROUND LEVEL, WHERE AN INTERIOR CONCRETE SLAB-ON-GRADE IS PROVIDED AND IS IN CONTACT WITH THE INTERIOR SURFACE OF THE FOUNDATION WALL. MEASUREMENT OF THE UNBALANCED BACKFILL HEIGHT FROM THE EXTERIOR FINISH GROUND LEVEL TO THE TOP OF THE INTERIOR CONCRETE SLAB IS PERMITTED.
f. THE USE OF THIS TABLE SHALL BE PROHIBITED FOR SOIL CLASSIFICATIONS NOT SHOWN.

TABLE R404.1.1(3)

10-INCH MASONRY FOUNDATION WALLS WITH REINFORCING WHERE $d > 6.75$ INCHES ^{a, c, f}

WALL HEIGHT	HEIGHT OF UNBALANCED BACKFILL ^g	MINIMUM VERTICAL REINFORCEMENT AND SPACING (INCHES) ^{b, c}			
		SOIL CLASSES AND LATERAL SOIL LOAD ^d (psf PER FOOT BELOW GRADE)			
		GM, GP, SU, AND SP SOILS 30	GM, GS, SM-SC AND ML SOILS 45	SC, MK, ML-CL AND INORGANIC CL SOILS 60	
6'-8"	4' (OR LESS)	#4 @ 56" O.C.	#4 @ 56" O.C.	#4 @ 56" O.C.	
	5'	#4 @ 56" O.C.	#4 @ 56" O.C.	#4 @ 56" O.C.	
	6'-8"	#5 @ 56" O.C.	#5 @ 56" O.C.	#5 @ 56" O.C.	
7'-4"	4' (OR LESS)	#4 @ 56" O.C.	#4 @ 56" O.C.	#4 @ 56" O.C.	
	5'	#4 @ 56" O.C.	#4 @ 56" O.C.	#4 @ 56" O.C.	
	7'-4"	#5 @ 56" O.C.	#5 @ 56" O.C.	#5 @ 56" O.C.	
8'-0"	4' (OR LESS)	#4 @ 56" O.C.	#4 @ 56" O.C.	#4 @ 56" O.C.	
	5'	#4 @ 56" O.C.	#4 @ 56" O.C.	#4 @ 56" O.C.	
	6'	#4 @ 56" O.C.	#4 @ 56" O.C.	#5 @ 56" O.C.	
	8'-0"	#5 @ 56" O.C.	#5 @ 56" O.C.	#5 @ 32" O.C.	
8'-8"	4' (OR LESS)	#4 @ 56" O.C.	#4 @ 56" O.C.	#4 @ 56" O.C.	
	5'	#4 @ 56" O.C.	#4 @ 56" O.C.	#5 @ 56" O.C.	
	6'	#4 @ 56" O.C.	#5 @ 56" O.C.	#5 @ 56" O.C.	
	8'-8"	#5 @ 56" O.C.	#5 @ 32" O.C.	#5 @ 24" O.C.	
9'-4"	4' (OR LESS)	#4 @ 56" O.C.	#4 @ 56" O.C.	#4 @ 56" O.C.	
	5'	#4 @ 56" O.C.	#4 @ 56" O.C.	#5 @ 56" O.C.	
	6'	#4 @ 56" O.C.	#5 @ 56" O.C.	#5 @ 56" O.C.	
	9'-4"	#5 @ 56" O.C.	#5 @ 40" O.C.	#5 @ 24" O.C.	
10'-0"	4' (OR LESS)	#4 @ 56" O.C.	#4 @ 56" O.C.	#4 @ 56" O.C.	
	5'	#4 @ 56" O.C.	#4 @ 56" O.C.	#5 @ 56" O.C.	
	6'	#4 @ 56" O.C.	#5 @ 56" O.C.	#5 @ 56" O.C.	
	7'	#5 @ 56" O.C.	#5 @ 56" O.C.	#5 @ 48" O.C.	
	10'-0"	#5 @ 56" O.C.	#5 @ 48" O.C.	#5 @ 32" O.C.	

- a. MORTAR SHALL BE TYPE M OR S AND MASONRY SHALL BE LAID IN RUNNING BOND.
b. ALTERNATIVE REINFORCING BAR SIZES AND SPACINGS SHALL HAVE AN EQUIVALENT CROSS-SECTIONAL AREA OF REINFORCEMENT PER LINEAL FOOT OF WALL SHALL BE PERMITTED PROVIDED THE SPACING OF THE REINFORCEMENT DOES NOT EXCEED 72" IN SEISMIC DESIGN CATEGORIES A, B AND C, AND 48 INCHES IN SEISMIC DESIGN CATEGORIES DD, D1 AND D2.
c. VERTICAL REINFORCEMENT SHALL BE GRADE 60 MINIMUM. THE DISTANCE FROM THE FACE OF THE SOIL SIDE OF THE WALL TO THE CENTER OF VERTICAL REINFORCEMENT SHALL BE NOT LESS THAN 5 INCHES.
d. SOIL CLASSES ARE IN ACCORDANCE WITH THE UNIFIED SOIL CLASSIFICATION SYSTEM AND DESIGN LATERAL SOIL LOADS ARE FOR MOIST CONDITIONS WITHOUT HYDROSTATIC PRESSURE. REFER TO TABLE R404.1.
e. UNBALANCED BACKFILL HEIGHT IS THE DIFFERENCE IN HEIGHT BETWEEN THE EXTERIOR FINISH GROUND LEVEL AND THE LOWER OF THE TOP OF THE CONCRETE FOOTING THAT SUPPORTS THE FOUNDATION WALL OR THE INTERIOR FINISH GROUND LEVEL, WHERE AN INTERIOR CONCRETE SLAB-ON-GRADE IS PROVIDED AND IS IN CONTACT WITH THE INTERIOR SURFACE OF THE FOUNDATION WALL. MEASUREMENT OF THE UNBALANCED BACKFILL HEIGHT FROM THE EXTERIOR FINISH GROUND LEVEL TO THE TOP OF THE INTERIOR CONCRETE SLAB IS PERMITTED.
f. THE USE OF THIS TABLE SHALL BE PROHIBITED FOR SOIL CLASSIFICATIONS NOT SHOWN.

TABLE R404.1.1(4)

12-INCH MASONRY FOUNDATION WALLS WITH REINFORCING WHERE $d > 8.75$ INCHES ^{a, c, f}

WALL HEIGHT	HEIGHT OF UNBALANCED BACKFILL ^g	MINIMUM VERTICAL REINFORCEMENT AND SPACING (INCHES) ^{b, c}			
		SOIL CLASSES AND LATERAL SOIL LOAD ^d (psf PER FOOT BELOW GRADE)			
		GM, GP, SU, AND SP SOILS 30	GM, GS, SM-SC AND ML SOILS 45	SC, MK, ML-CL AND INORGANIC CL SOILS 60	
6'-8"	4' (OR LESS)	#4 @ 72" O.C.	#4 @ 72" O.C.	#4 @ 72" O.C.	
	5'	#4 @ 72" O.C.	#4 @ 72" O.C.	#4 @ 72" O.C.	
	6'-8"	#5 @ 72" O.C.	#5 @ 72" O.C.	#5 @ 72" O.C.	
7'-4"	4' (OR LESS)	#4 @ 72" O.C.	#4 @ 72" O.C.	#4 @ 72" O.C.	
	5'	#4 @ 72" O.C.	#4 @ 72" O.C.	#4 @ 72" O.C.	
	7'-4"	#5 @ 72" O.C.	#5 @ 72" O.C.	#5 @ 72" O.C.	
8'-0"	4' (OR LESS)	#4 @ 72" O.C.	#4 @ 72" O.C.	#4 @ 72" O.C.	
	5'	#4 @ 72" O.C.	#4 @ 72" O.C.	#4 @ 72" O.C.	
	6'	#4 @ 72" O.C.	#4 @ 72" O.C.	#5 @ 72" O.C.	
	8'-0"	#5 @ 72" O.C.	#5 @ 72" O.C.	#5 @ 64" O.C.	
8'-8"	4' (OR LESS)	#4 @ 72" O.C.	#4 @ 72" O.C.	#4 @ 72" O.C.	
	5'	#4 @ 72" O.C.	#4 @ 72" O.C.	#5 @ 72" O.C.	
	6'	#4 @ 72" O.C.	#5 @ 72" O.C.	#5 @ 72" O.C.	
	8'-8"	#5 @ 72" O.C.	#5 @ 72" O.C.	#5 @ 64" O.C.	
9'-4"	4' (OR LESS)	#4 @ 72" O.C.	#4 @ 72" O.C.	#4 @ 72" O.C.	
	5'	#4 @ 72" O.C.	#4 @ 72" O.C.	#5 @ 72" O.C.	
	6'	#4 @ 72" O.C.	#5 @ 72" O.C.	#5 @ 72" O.C.	
	9'-4"	#5 @ 72" O.C.	#5 @ 64" O.C.	#5 @ 48" O.C.	
10'-0"	4' (OR LESS)	#4 @ 72" O.C.	#4 @ 72" O.C.	#4 @ 72" O.C.	
	5'	#4 @ 72" O.C.	#4 @ 72" O.C.	#5 @ 72" O.C.	
	6'	#4 @ 72" O.C.	#5 @ 72" O.C.	#5 @ 72" O.C.	
	7'	#5 @ 72" O.C.	#5 @ 72" O.C.	#5 @ 64" O.C.	
	10'-0"	#5 @ 72" O.C.	#5 @ 64" O.C.	#5 @ 48" O.C.	

- a. MORTAR SHALL BE TYPE M OR S AND MASONRY SHALL BE LAID IN RUNNING BOND.
b. ALTERNATIVE REINFORCING BAR SIZES AND SPACINGS SHALL HAVE AN EQUIVALENT CROSS-SECTIONAL AREA OF REINFORCEMENT PER LINEAL FOOT OF WALL SHALL BE PERMITTED PROVIDED THE SPACING OF THE REINFORCEMENT DOES NOT EXCEED 72" IN SEISMIC DESIGN CATEGORIES A, B AND C, AND 48 INCHES IN SEISMIC DESIGN CATEGORIES DD, D1 AND D2.
c. VERTICAL REINFORCEMENT SHALL BE GRADE 60 MINIMUM. THE DISTANCE FROM THE FACE OF THE SOIL SIDE OF THE WALL TO THE CENTER OF VERTICAL REINFORCEMENT SHALL BE NOT LESS THAN 5 INCHES.
d. SOIL CLASSES ARE IN ACCORDANCE WITH THE UNIFIED SOIL CLASSIFICATION SYSTEM AND DESIGN LATERAL SOIL LOADS ARE FOR MOIST CONDITIONS WITHOUT HYDROSTATIC PRESSURE. REFER TO TABLE R404.1.
e. UNBALANCED BACKFILL HEIGHT IS THE DIFFERENCE IN HEIGHT BETWEEN THE EXTERIOR FINISH GROUND LEVEL AND THE LOWER OF THE TOP OF THE CONCRETE FOOTING THAT SUPPORTS THE FOUNDATION WALL OR THE INTERIOR FINISH GROUND LEVEL, WHERE AN INTERIOR CONCRETE SLAB-ON-GRADE IS PROVIDED AND IS IN CONTACT WITH THE INTERIOR SURFACE OF THE FOUNDATION WALL. MEASUREMENT OF THE UNBALANCED BACKFILL HEIGHT FROM THE EXTERIOR FINISH GROUND LEVEL TO THE TOP OF THE INTERIOR CONCRETE SLAB IS PERMITTED.
f. THE USE OF THIS TABLE SHALL BE PROHIBITED FOR SOIL CLASSIFICATIONS NOT SHOWN.

TABLE R404.1.2(8)

MINIMUM VERTICAL REINFORCEMENT FOR 6-, 8-, 10- AND 12-INCH NOMINAL FLAT BASEMENT WALLS ^{b, c, d, e, f, h, k, n, o}

MAXIMUM WALL HEIGHT (FEET)	MAXIMUM UNBALANCED BACKFILL HEIGHT (FEET)	MINIMUM VERTICAL REINFORCEMENT-BAR SIZE & SPACING (INCHES)											
		SOIL CLASSES ^a AND DESIGN LATERAL SOIL LOAD ^d (psf PER FOOT OF DEPTH)											
		GM, GP, SU, AND SP SOILS 30				GM, GS, SM-SC AND ML SOILS 45				SC, MK, ML-CL AND INORGANIC CL SOILS 60			
5	4	NR	NR	NR	NR	NR	NR	NR	NR	NR	NR	NR	NR
		NR	NR	NR	NR	NR	NR	NR	NR	NR	NR	NR	NR
6	5	NR	NR	NR	NR	NR	NR	NR	NR	NR	NR	NR	NR
		NR	NR	NR	NR	NR	NR	NR	NR	NR	NR	NR	NR
7	6	NR	NR	NR	NR	NR	NR	NR	NR	NR	NR	NR	NR
		NR	NR	NR	NR	NR	NR	NR	NR	NR	NR	NR	NR
8	7	NR	NR	NR	NR	NR	NR	NR	NR	NR	NR	NR	NR
		NR	NR	NR	NR	NR	NR	NR	NR	NR	NR	NR	NR
9	8	NR	NR	NR	NR	NR	NR	NR	NR	NR	NR	NR	NR
		NR	NR	NR	NR	NR	NR	NR	NR	NR	NR	NR	NR
10	9	NR	NR	NR	NR	NR	NR	NR	NR	NR	NR	NR	NR
		NR	NR	NR	NR	NR	NR	NR	NR	NR	NR	NR	NR

- a. SOIL CLASSES ARE IN ACCORDANCE WITH THE UNIFIED SOIL CLASSIFICATION SYSTEM. REFER TO TABLE R404.1.
b. TABLE VALUES ARE BASED ON REINFORCING BARS WITH A MINIMUM YIELD STRENGTH OF 60,000 PSI.
c. VERTICAL REINFORCEMENT SHALL BE GRADE 60 MINIMUM. THE DISTANCE FROM THE FACE OF THE SOIL SIDE OF THE WALL TO THE CENTER OF VERTICAL REINFORCEMENT SHALL BE NOT LESS THAN 5 INCHES.
d. NR INDICATES NO VERTICAL WALL REINFORCEMENT IS REQUIRED, EXCEPT FOR 6-INCH NOMINAL WALLS FORMED WITH STAY-IN-PLACE FORMING SYSTEMS IN WHICH CASE VERTICAL REINFORCEMENT SHALL BE NO. 4 @ 48 INCHES ON CENTER.
e. ALLOWABLE DEFLECTION CRITERION IS L/240, WHERE L IS THE UNSUPPORTED HEIGHT OF THE BASEMENT WALL IN INCHES.
f. INTERPOLATION IS NOT PERMITTED.
g. WHERE WALLS WILL REMAIN 4 FEET OR MORE OF UNBALANCED BACKFILL, THEY SHALL BE LATERALLY SUPPORTED AT THE TOP AND BOTTOM BEFORE BACKFILLING.
h. VERTICAL REINFORCEMENT SHALL BE LOCATED TO PROVIDE A COVER OF 1 1/4 INCHES MEASURED FROM THE INSIDE FACE OF THE WALL. THE CENTER OF THE STEEL SHALL NOT VARY FROM THE SPECIFIED LOCATION BY MORE THAN THE GREATER OF 10 PERCENT OF THE WALL THICKNESS OR 3/8 INCH.
i. CONCRETE COVERS FOR THE REINFORCEMENT MEASURED FROM THE INSIDE FACE OF THE WALL SHALL BE NOT LESS THAN 3/4 INCH. CONCRETE COVERS FOR REINFORCEMENT MEASURED FROM THE OUTSIDE FACE OF THE WALL SHALL BE NOT LESS THAN 1 1/2 INCHES FOR NO. 5 BARS AND SMALLER, AND NOT LESS THAN 2 INCHES FOR LARGER BARS.
j. DR. MEANS DESIGN IS REQUIRED IN ACCORDANCE WITH THE APPLICABLE BUILDING CODE, OR WHERE THERE IS NO CODE, IN ACCORDANCE WITH ACI 318.
k. CONCRETE SHALL HAVE A SPECIFIED COMPRESSIVE STRENGTH, f_c OF NOT LESS THAN 2,500 PSI AT 28 DAYS, UNLESS A HIGHER STRENGTH IS REQUIRED BY FOOTNOTE 1 OR 1a.
l. THE MINIMUM THICKNESS IS PERMITTED TO BE REDUCED 2 INCHES, PROVIDED THE MINIMUM SPECIFIED COMPRESSIVE STRENGTH OF CONCRETE, f_c IS 4,000 PSI.
m. A PLAN CONCRETE WALL WITH A MINIMUM NOMINAL THICKNESS OF 12 INCHES IS PERMITTED, PROVIDED MINIMUM SPECIFIED COMPRESSIVE STRENGTH OF CONCRETE, f_c IS 3,500 PSI.
n. SEE TABLE R602.3 FOR TOLERANCE FROM NOMINAL THICKNESS PERMITTED FOR FLAT WALLS.
o. THE USE OF THIS TABLE SHALL BE PROHIBITED FOR SOIL CLASSIFICATIONS NOT SHOWN.

TABLE R 402.4.1.1
AIR BARRIER AND INSULATION INSTALLATION

COMPONENT	AIR BARRIER CRITERIA	INSULATION INSTALLATION CRITERIA
GENERAL REQUIREMENTS	A CONTINUOUS AIR BARRIER SHALL BE INSTALLED IN THE BUILDING ENVELOPE. THE EXTERIOR THERMAL ENVELOPE CONTAINS A CONTINUOUS AIR BARRIER. BREAKS OR JOINTS IN THE AIR BARRIER SHALL BE SEALED. THE AIR BARRIER IN ANY DROPPED CEILING / SOFFIT SHALL BE ALIGNED WITH THE INSULATION AND ANY GAPS IN THE AIR BARRIER SHALL BE SEALED.	AIR-PERMEABLE INSULATION SHALL NOT BE USED AS A SEALING MATERIAL.
CEILING / ATTIC	ACCESS OPENINGS, DROP DOWN STAIRS, OR KNEE WALL DOORS TO UNCONDITIONED ATTIC SPACES SHALL BE SEALED.	THE INSULATION IN ANY DROPPED CEILING / SOFFIT SHALL BE ALIGNED WITH THE AIR BARRIER.
WALLS	THE JUNCTION OF THE FOUNDATION AND SILL PLATE SHALL BE SEALED. THE JUNCTION OF THE TOP PLATE AND THE TOP OF EXTERIOR WALLS SHALL BE SEALED. KNEE WALLS SHALL BE SEALED.	CAVITIES WITH CORNERS AND HEADERS OF FRAME WALLS SHALL BE INSULATED BY COMPLETELY FILLING THE CAVITY WITH A MATERIAL HAVING A THERMAL RESISTANCE OF R-3 PER INCH MINIMUM. EXTERIOR THERMAL ENVELOPE INSULATION FOR FRAMED WALLS SHALL BE INSTALLED IN SUBSTANTIAL CONTACT AND CONTINUOUS ALIGNMENT WITH THE AIR BARRIER.
WINDOWS, SKYLIGHTS AND DOORS	THE SPACE BETWEEN WINDOW / DOOR JAMBS AND FRAMING, AND SKYLIGHTS AND FRAMING SHALL BE SEALED.	
RIM JOISTS	RIM JOISTS SHALL INCLUDE THE AIR BARRIER.	RIM JOISTS SHALL BE INSULATED.
FLOORS (INCLUDING ABOVE GARAGE AND CANTILEVERED FLOORS)	THE AIR BARRIER SHALL BE INSTALLED AT ANY EXPOSED EDGE OF INSULATION.	FLOOR FRAMING CAVITY INSULATION SHALL BE INSTALLED TO MAINTAIN PERMANENT CONTACT WITH THE UNDERSIDE OF SUBFLOOR DECKING, OR FLOOR FRAMING CAVITY INSULATION SHALL BE PERMITTED TO BE IN CONTACT WITH THE TOP SIDE OF SHEATHING, OR CONTINUOUS INSULATION INSTALLED ON THE UNDERSIDE OF FLOOR FRAMING AND EXTENDS FROM THE BOTTOM TO THE TOP OF ALL PERIMETER FLOOR FRAMING MEMBERS.
CRACK SPACE WALLS	EXPOSED EARTH IN UNVENTED CRACK SPACES SHALL BE COVERED WITH A CLASS I VAPOR BARRIER WITH OVERLAPPING JOINTS TAPERED.	WHERE PROVIDED INSTEAD OF FLOOR INSULATION, INSULATION SHALL BE PERMANENTLY ATTACHED TO THE CRACKSPACE WALLS.
SHAFTS, PENETRATIONS	DUCT SHAFTS, UTILITY PENETRATIONS, AND FLUE SHAFTS OPENING THE EXTERIOR OR UNCONDITIONED SPACE SHALL BE SEALED.	BATTS IN NARROW CAVITIES SHALL BE CUT TO FIT, OR NARROW CAVITIES SHALL BE FILLED BY INSULATION THAT ON INSTALLATION READILY CONFORMS TO THE AVAILABLE CAVITY SPACE.
NARROW CAVITIES		BATTS IN NARROW CAVITIES SHALL BE CUT TO FIT, OR NARROW CAVITIES SHALL BE FILLED BY INSULATION THAT ON INSTALLATION READILY CONFORMS TO THE AVAILABLE CAVITY SPACE.
GARAGE SEPARATION	AIR SEALING SHALL BE PROVIDED BETWEEN THE GARAGE AND CONDITIONED SPACES.	
RECESSED LIGHTING	RECESSED LIGHT FIXTURES INSTALLED IN THE BUILDING THERMAL ENVELOPE SHALL BE SEALED TO THE DRYWALL.	RECESSED LIGHT FIXTURES INSTALLED IN THE BUILDING THERMAL ENVELOPE SHALL BE AIR TIGHT AND IC RATED.
PLUMBING AND WIRING		BATT INSULATION SHALL BE CUT NEATLY TO FIT AROUND WIRING AND PLUMBING IN EXTERIOR WALLS, OR INSULATION THAT ON INSTALLATION READILY CONFORMS TO AVAILABLE SPACE SHALL EXTEND BEHIND PIPING AND WIRING.
SHOWER / TUB ON EXTERIOR WALL	THE AIR BARRIER INSTALLED AT EXTERIOR WALLS ADJACENT TO SHOWERS AND TUBS SHALL SEPARATE THEM FROM THE SHOWERS AND TUBS.	EXTERIOR WALLS ADJACENT TO SHOWERS AND TUBS SHALL BE INSULATED.
ELECTRICAL / PHONE BOX ON EXTERIOR WALLS	THE AIR BARRIER SHALL BE INSTALLED BEHIND ELECTRICAL OR COMMUNICATION BOXES OR AIR-SEALED BOXES SHALL BE INSTALLED.	
HVAC REGISTER BOOTS	HVAC REGISTER BOOTS THAT PENETRATE BUILDING THERMAL ENVELOPE SHALL BE SEALED TO THE SUBFLOOR OR DRYWALL.	
CONCEALED SPRINKLERS	WHEN REQUIRED TO BE SEALED, CONCEALED FIRE SPRINKLERS SHALL ONLY BE SEALED IN A MANNER THAT IS RECOMMENDED BY THE MANUFACTURER. CALLING OR OTHER ADHESIVE SEALANTS SHALL NOT BE USED TO FILL VOIDS BETWEEN FIRE SPRINKLER COVER PLATES AND WALL OR CEILING.	

a. IN ADDITION, INSPECTION OF LOG WALLS SHALL BE IN ACCORDANCE WITH THE PROVISIONS OF ICC-403.

R401.4 SOIL TESTS.

WHERE QUANTIFIABLE DATA CREATED BY ACCEPTED SOIL SCIENCE METHODOLOGIES INDICATE EXPANSIVE, COMPRESSIBLE, SHIFTING OR OTHER QUESTIONABLE SOIL CHARACTERISTICS ARE LIKELY TO BE PRESENT, THE BUILDING OFFICIAL SHALL DETERMINE WHETHER TO REQUIRE A SOIL TEST TO DETERMINE THE SOIL'S CHARACTERISTICS AT A PARTICULAR LOCATION. THIS TEST BE DONE BY AN APPROVED AGENCY USING AN APPROVED METHOD.

R401.4.1 GEOTECHNICAL EVALUATION.

IN LIEU OF A COMPLETE GEOTECHNICAL EVALUATION, THE LOAD-BEARING VALUES IN TABLE R401.4.1 SHALL BE ASSUMED.

TABLE R401.4.1


PRESUMPTIVE LOAD-BEARING VALUES OF FOUNDATION MATERIALS

CLASS OF MATERIALS	LOAD-BEARING PRESSURE (pounds per square foot)
CRYSTALLINE BEDROCK	12,000
SEDIMENTARY & FOLIATED ROCK	4,000
SANDY GRAVEL AND/OR GRAVEL (GM & GP)	3,000
SAND, SILTY SAND, CLAYEY SAND, SILTY GRAVEL AND CLAYEY GRAVEL (SU, SP, SM, SC, GM & GC)	2,000
CLAY, SANDY CLAY, SILTY CLAY, CLAYEY SILT, SILT AND SANDY SILT (CL, ML, MH, & CH)	1,500 ^b

- a. WHERE SOIL TESTS ARE REQUIRED BY SECTION R401.4, THE ALLOWABLE BEARING CAPACITIES OF THE SOIL SHALL BE PART OF THE RECOMMENDATIONS.
b. WHERE THE BUILDING OFFICIAL DETERMINES THAT IN-PLACE SOILS WITH AN ALLOWABLE BEARING CAPACITY OF LESS THAN 1,500 psf ARE LIKELY TO BE PRESENT AT THE SITE, THE ALLOWABLE BEARING CAPACITY SHALL BE DETERMINED BY A SOILS INVESTIGATION.

UNIFIED SOIL CLASSIFICATION SYSTEM

UNIFIED SOIL CLASSIFICATION SYSTEM SYMBOL	SOIL DESCRIPTION
GM	WELL-GRADED GRAVELS, GRAVEL SAND MIXTURES, LITTLE OR NO FINES
GP	POORLY GRADED GRAVELS OR GRAVEL SAND, LITTLE OR NO FINES
SU	WELL-GRADED SANDS, LITTLE OR NO FINES
SP	POORLY GRADED SANDS OR GRAVELLY SANDS, LITTLE OR NO FINES
GM	SILTY GRAVELS, GRAVEL-SAND-SILT MIXTURES
SM	SILTY SAND, SAND-SILT MIXTURES
GC	CLAYEY GRAVELS, GRAVEL-SAND-CLAY MIXTURES
SC	CLAYEY SANDS, SAND-CLAY MIXTURE MIXTURES
ML	INORGANIC SILTS & VERY FINE SANDS, ROCK FLOUR, SILTY OR CLAYEY FINE SANDS OR CLAYEY SILTS WITH SLIGHT PLASTICITY
CL	INORGANIC CLAYS OF LOW TO MEDIUM PLASTICITY, GRAVELLY CLAYS, SANDY CLAYS, SILTY CLAYS, LEAN CLAYS
CH	INORGANIC CLAYS OF HIGH PLASTICITY, FAT CLAYS
MH	INORGANIC SILTS, MICACEOUS OR DIATOMACEOUS FINE SANDY OR SILTY SOILS, ELASTIC SILTS
OL	ORGANIC SILTS & ORGANIC SILTY CLAYS OF LOW PLASTICITY
OH	ORGANIC CLAYS OF MEDIUM TO HIGH PLASTICITY, ORGANIC SILTS
PT	PEAT & OTHER HIGHLY

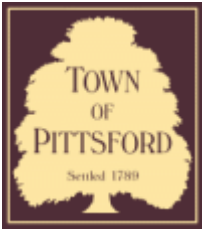

Town of Pittsford

Department of Public Works
11 South Main Street
Pittsford, New York 14534

Permit #
C22-000038

Phone: 585-248-6250
FAX: 585-248-6262

DESIGN REVIEW AND HISTORIC PRESERVATION BOARD REFERRAL OF APPLICATION

Property Address: 3500 East Avenue ROCHESTER, NY 14618

Tax ID Number: 138.14-1-13.1

Zoning District: RN Residential Neighborhood

Owner: 3500 East Avenue, LLC

Applicant: 3500 East Avenue, LLC

Application Type:

- | | |
|--|---|
| <input type="checkbox"/> Residential Design Review
§185-205 (B) | <input type="checkbox"/> Build to Line Adjustment
§185-17 (B) (2) |
| <input checked="" type="checkbox"/> Commercial Design Review
§185-205 (B) | <input type="checkbox"/> Building Height Above 30 Feet
§185-17 (M) |
| <input type="checkbox"/> Signage
§185-205 (C) | <input type="checkbox"/> Corner Lot Orientation
§185-17 (K) (3) |
| <input type="checkbox"/> Certificate of Appropriateness
§185-197 | <input type="checkbox"/> Flag Lot Building Line Location
§185-17 (L) (1) (c) |
| <input type="checkbox"/> Landmark Designation
§185-195 (2) | <input type="checkbox"/> Undeveloped Flag Lot Requirements
§185-17 (L) (2) |
| <input type="checkbox"/> Informal Review | |

Project Description: Applicant is requesting design review for the construction of 2 detached garages, 2490 sq ft per garage, that will be located on the Kilbourne Place on East property.

Meeting Date: July 14, 2022



Kilburn Place on East
HANSON ARCHITECTS



Brightford Heights Rd

Interstate 490 Westbound

Interstate 490 Westbound

Interstate 490 Eastbound

East Ave

Driveway

East Ave

ABBREVIATIONS

AB ANCHOR BOLT	L LENGTH/LONG
ADJ ADJACENT	LN LINEAR
AFT ABOVE FINISHED FLOOR	LLV LONG LEG VERTICAL
ALUM ALUMINUM	LLV LONG LEG VERTICAL
ALT ALTERNATE	LONG LONGITUDINAL
APPROX APPROXIMATELY	LT LIGHT
ARCH ARCHITECTURAL	
ASPH ASPHALT	
AVG AVERAGE	
BET BETWEEN	MAS MASONRY
BIT BITUMINOUS	MAX MAXIMUM
BLDG BUILDING	MECH MECHANICAL
BLK BLOCK	MED MEDIUM
BLKG BLOCKING	MEM MEMBER
BM BEAM (BENCHMARK)	MEMB MEMBER
BTM BOTTOM	MET METAL
BRK BRICK	MFR MANUFACTURER
BSMT BASEMENT	MNHLE MANHOLE
BUR BUILT-UP-ROOF	MIN MINIMUM
	MISC MISCELLANEOUS
	MO MASONRY OPENING
CB CATCH BASIN	
CEM CEMENT	N NORTH
CFR CURB FOOT (FEET)	NF NEAR FACE
CI CAST IRON	NC NOT IN CONTRACT
CLG CLEARING	NO NUMBER
CLR CLEAR	NOM NOMINAL
CMU CONCRETE MASONRY UNIT	NORM NORMAL
CO CLEAN OUT (COMPANY)	NTS NOT TO SCALE
COL COLUMN	OC ON CENTER(S)
CONC CONCRETE	OD OUTSIDE DIAMETER
CONN CONNECTION	OFF OFFICE
CONST CONSTRUCTION	OH OVERHEAD
CONT CONTINUOUS	OPG OPENING
CONTR CONTRACTOR	OPP OPPOSITE
CORR CORRIDOR (CORRUGATED)	
CTR CENTER	PART PARTITION
CY CUBIC YARD(S)	PAVT PAVEMENT
	PCC PRE CAST CONCRETE
DET DETAIL	PERF PERFORATED
DF DRINKING FOUNTAIN	PERM PERMANENT
DIA DIAMETER	PLATE PLATE
DIA2 DIAGONAL	PLBG PLUMBING
DIM DIMENSION	PLWD PLUMBWOOD
DS DOWN SPOUT	PSF POUNDS PER SQUARE FOOT
DWD DRAWING	PSI POUNDS PER SQUARE INCH
DWL DWEL	PVC POLYVINYL CHLORIDE
E EAST	RAD RADIUS
EA EACH	RD ROOF DRAIN
EC EPOXY COATED	REF REFERENCE
EF EACH FACE	REF REINFORCED(D), (ING)
EL ELEVATION	REQ REQUIRED
ELEC ELECTRICAL	REV REVISION(S), REVISED
ELEV ELEVATOR	ROU ROUGH OPENING
EQ EQUAL	ROW RIGHT-OF-WAY
EQUIP EQUIPMENT	
EST ESTIMATED	S SOUTH
ETR EXISTING TO REMAIN	S/S STAINLESS STEEL
EW EACH WAY	SAN SANITARY
EXIST EXISTING	SCH SCHEDULE
EXP EXPANSION (EXPAND)	SEC SECTION
EXT EXTERIOR	SF SQUARE FOOT (FEET)
	SIM SIMILAR
FDN FOUNDATION	SPEC SPECIFICATION(S)
FF FINISHED FLOOR	SQ SQUARE
FIN FINISHED	STRT STREET
FL FLANGE	STD STANDARD
FLASH FLASHING	STEEL STEEL
FLEX FLEXIBLE	STR STRUCTURE(AL)
FLO FLOORING	SQ SQUARE YARD
FOC FACE OF CONCRETE	SYM SYMMETRICAL
FOM FACE OF MASONRY	
FOW FACE OF WALL	T TREAD (TOP)
FP FIRE PROTECTION	T&G TONGUE AND GROOVE
FT FOOT OR FEET	TEMP TEMPORARY
FTG FOOTING	THK THICK
FUT FUTURE	TRANS TRANSVERSE
	TYP TYPICAL
GA GALVE	UNEX UNEXCAVATED
GALV GALVANIZED	UNO UNLESS NOTED OTHERWISE
GEN GENERAL CONTRACTOR	VAR VARIES(A)BLE
GEN GENERAL	VERT VERTICAL
GNB Gypsum WALL BOARD	
HB HOSE BE	W WEST (WIDE)
HC HOLLOW CORE	W/O WITHOUT
HDR HANDRAILED	WD WOOD
HGT HEIGHT	WP WATERPROOF(ING)
HM HOLLOW METAL	WF WEIGHT
HOR HORIZONTAL	WFLD WELDED WIRE FABRIC
HVAC HEATING/VENTILATING/ AIR CONDITIONING	& AND
	Ø DIAMETER OR ROUND
ID INSIDE DIAMETER	% PERCENT
IN INCH OR INCHES	° ANGLE
INSUL INSULATE(D),(ION)	CL CENTERLINE
INT INTERIOR	NUM NUMBER (BEFORE), POUND (AFTER)
INV INVERT	PL PROPERTY LINE
J JOIST	
JT JOINT	

GENERAL NOTES:

- THE CONTRACTOR SHALL CAREFULLY REVIEW THE CONTRACT DOCUMENTS AND INFORM THE PROJECT ARCHITECT OF ANY INCONSISTENCIES OR INADEQUATE DESCRIPTIONS OF WORK PRIOR TO THE SUBMITTAL OF BIDS.
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- DURING CUTTING, PATCHING AND REMOVAL OF WORK, CLEAN AND PROTECT WORK IN PROGRESS, ADJOINING WORK, AND EXISTING CONSTRUCTION ON A BASIS OF CONTINUOUS MAINTENANCE.
- ALL SALVAGEABLE ITEMS NOTED ON DRAWINGS SHALL BE DELIVERED TO THE FACILITIES AREA, EXCEPT AS OTHERWISE DIRECTED BY OWNER. ITEMS THAT ARE NOTED ON THE DRAWINGS FOR REUSE SHALL BE PROTECTED, HANDLED, STORED, AND REINSTALLED IN LOCATIONS INDICATED AND OPERATE CONSISTENT WITH THAT PRIOR TO WORK.
- REMOVE AND DISPOSE OF ALL DEBRIS, RUBBISH AND OTHER WASTE MATERIALS RESULTING FROM WORK OF THIS PROJECT.
- PROVIDE ALL BLOCKING, FURRING, AND SHIMMING NECESSARY FOR INSTALLATION AND COMPLETION OF WORK.
- ALL NEW WORK SHALL BE PLUMB, LEVEL, AND SQUARE. SCRIBE AND MAKE FIT ALL NEW WORK TO EXISTING.
- THE CONTRACTOR SHALL INFORM THE PROJECT ARCHITECT, PRIOR TO THE SUBMISSION OF BID, OF ANY ITEMS OR QUANTITY OF ITEMS NOT SPECIFIED OR REFERENCED ON THE DRAWINGS BUT REQUIRED FOR THE COMPLETION OF THE WORK. FAILURE TO DO SO WILL NOT RELIEVE THE CONTRACTOR FROM PROVIDING ALL WORK AS REQUIRED TO COMPLETE PROJECT REQUIREMENTS.

BUILDING CODE INFORMATION

DESCRIPTION OF WORK: THE OBJECTIVE IS TO PROVIDE A WOOD FRAMED PRIVATE GARAGE BUILDING ADJACENT TO NEW APARTMENT COMPLEX. APARTMENT COMPLEX PREVIOUSLY APPROVED UNDER SEPARATED PERMIT APPLICATION

STANDARDS: 2020 BUILDING CODE OF NEW YORK STATE.

ANSI A117.1-2003

COMPLIANCE NOTE:
To the best of my knowledge, information, and belief, the plans and specifications are in accordance with the applicable requirements of the IBC w/ NYS supplements and the IECC.

David J. Hanlon
David J. Hanlon

OCCUPANCY CLASSIFICATION: GROUP U - UTILITY AND MISCELLANEOUS (PRIVATE GARAGE) (502)

BUILDING HEIGHT: (504)

TABULAR (504.3 & 504.4): 40'-0" / 1 stories

PROPOSED HEIGHT: 18'-7" / 1 stories

BUILDING AREA: (506)

ALLOWABLE AREA (TABLE 506.2): 9,000 SQ. FT. (NON-SPRINKLERED)

PROPOSED BUILDING AREA: 1,245 SQ. FT (OVERALL BUILDING)

CONSTRUCTION TYPE CLASSIFICATION: VB CONSTRUCTION (602)

FIRE ALARMS: (901) AUTOMATIC SMOKE OR AUTOMATIC HEAT DETECTION SHALL BE REQUIRED PER CODE SECTION (NYSBC) 901.2 FINAL DRAWINGS SHALL BE PROVIDED UNDER SEPARATE COVER AND PRIOR TO COMMENCEMENT OF SCOPE OF WORK.

KILBOURN PLACE GARAGES

PITTSFORD, NY


ENERGY CODE COMPLIANCE:

THE ENERGY CODE COMPLIANCE FOR THE GARAGE BUILDING @ KILBOURN PLACE APARTMENTS IS NOT APPLICABLE BECAUSE IT IS AN UNCONDITIONED SPACE


LIST OF DRAWINGS:

- C1 COVER SHEET
- A1 FLOOR PLAN
- A2 REFLECTED CEILING PLAN
- A3 BLDG ELEVATIONS
- A4 BLDG SECTIONS
- A5 WALL SECTIONS


TRUSS IDENTIFICATION SIGNAGE:

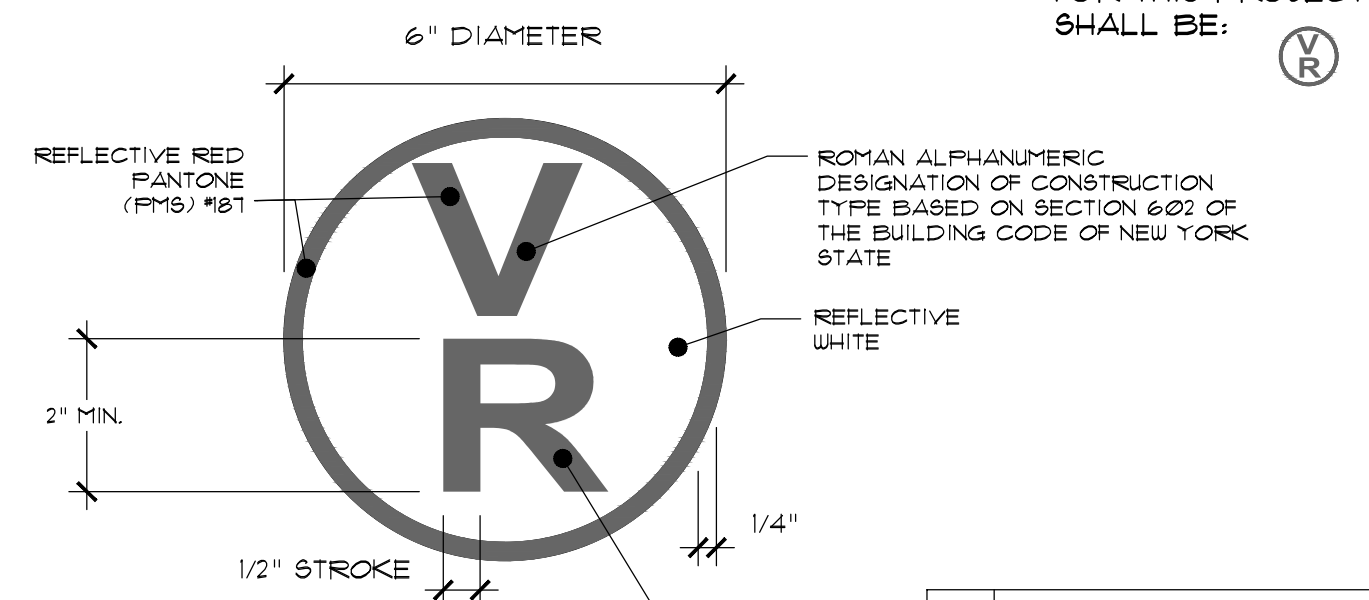

SIGN LOCATION	SIGN PLACEMENT
EXTERIOR BUILDING ENTRANCE DOORS, EXTERIOR EXIT DISCHARGE DOORS, AND EXTERIOR ROOF ACCESS DOORS TO A STAIRWAY	ATTACHED TO THE DOOR OR ATTACHED TO A SIDELIGHT OR THE FACE OF THE BUILDING, NOT MORE THAN 12 INCHES (305 MM) HORIZONTALLY FROM THE LATCH SIDE OF THE DOOR JAMB, AND NOT LESS THAN 42 INCHES (1067 MM) NOR MORE THAN 60 INCHES (1524 MM) ABOVE THE ADJOINING WALKING SURFACE.
MULTIPLE CONTIGUOUS EXTERIOR BUILDING ENTRANCE OR EXIT DISCHARGE DOORS	ATTACHED AT EACH END OF THE ROW OF DOORS AND AT A MAXIMUM HORIZONTAL DISTANCE OF 12 FEET (3.65M) BETWEEN SIGNS, AND NOT LESS THAN 42 INCHES (1067 MM) NOR MORE THAN 60 INCHES (1524 MM) ABOVE THE ADJOINING WALKING SURFACE
FIRE DEPARTMENT HOSE CONNECTIONS	ATTACHED TO THE FACE OF THE BUILDING, NOT MORE THAN 12 INCHES (305 MM) HORIZONTALLY FROM THE CENTER LINE OF THE FIRE DEPARTMENT HOSE CONNECTION, AND NOT LESS THAN 42 INCHES (1067 MM) NOR MORE THAN 60 INCHES (1524 MM) ABOVE THE ADJOINING WALKING SURFACE

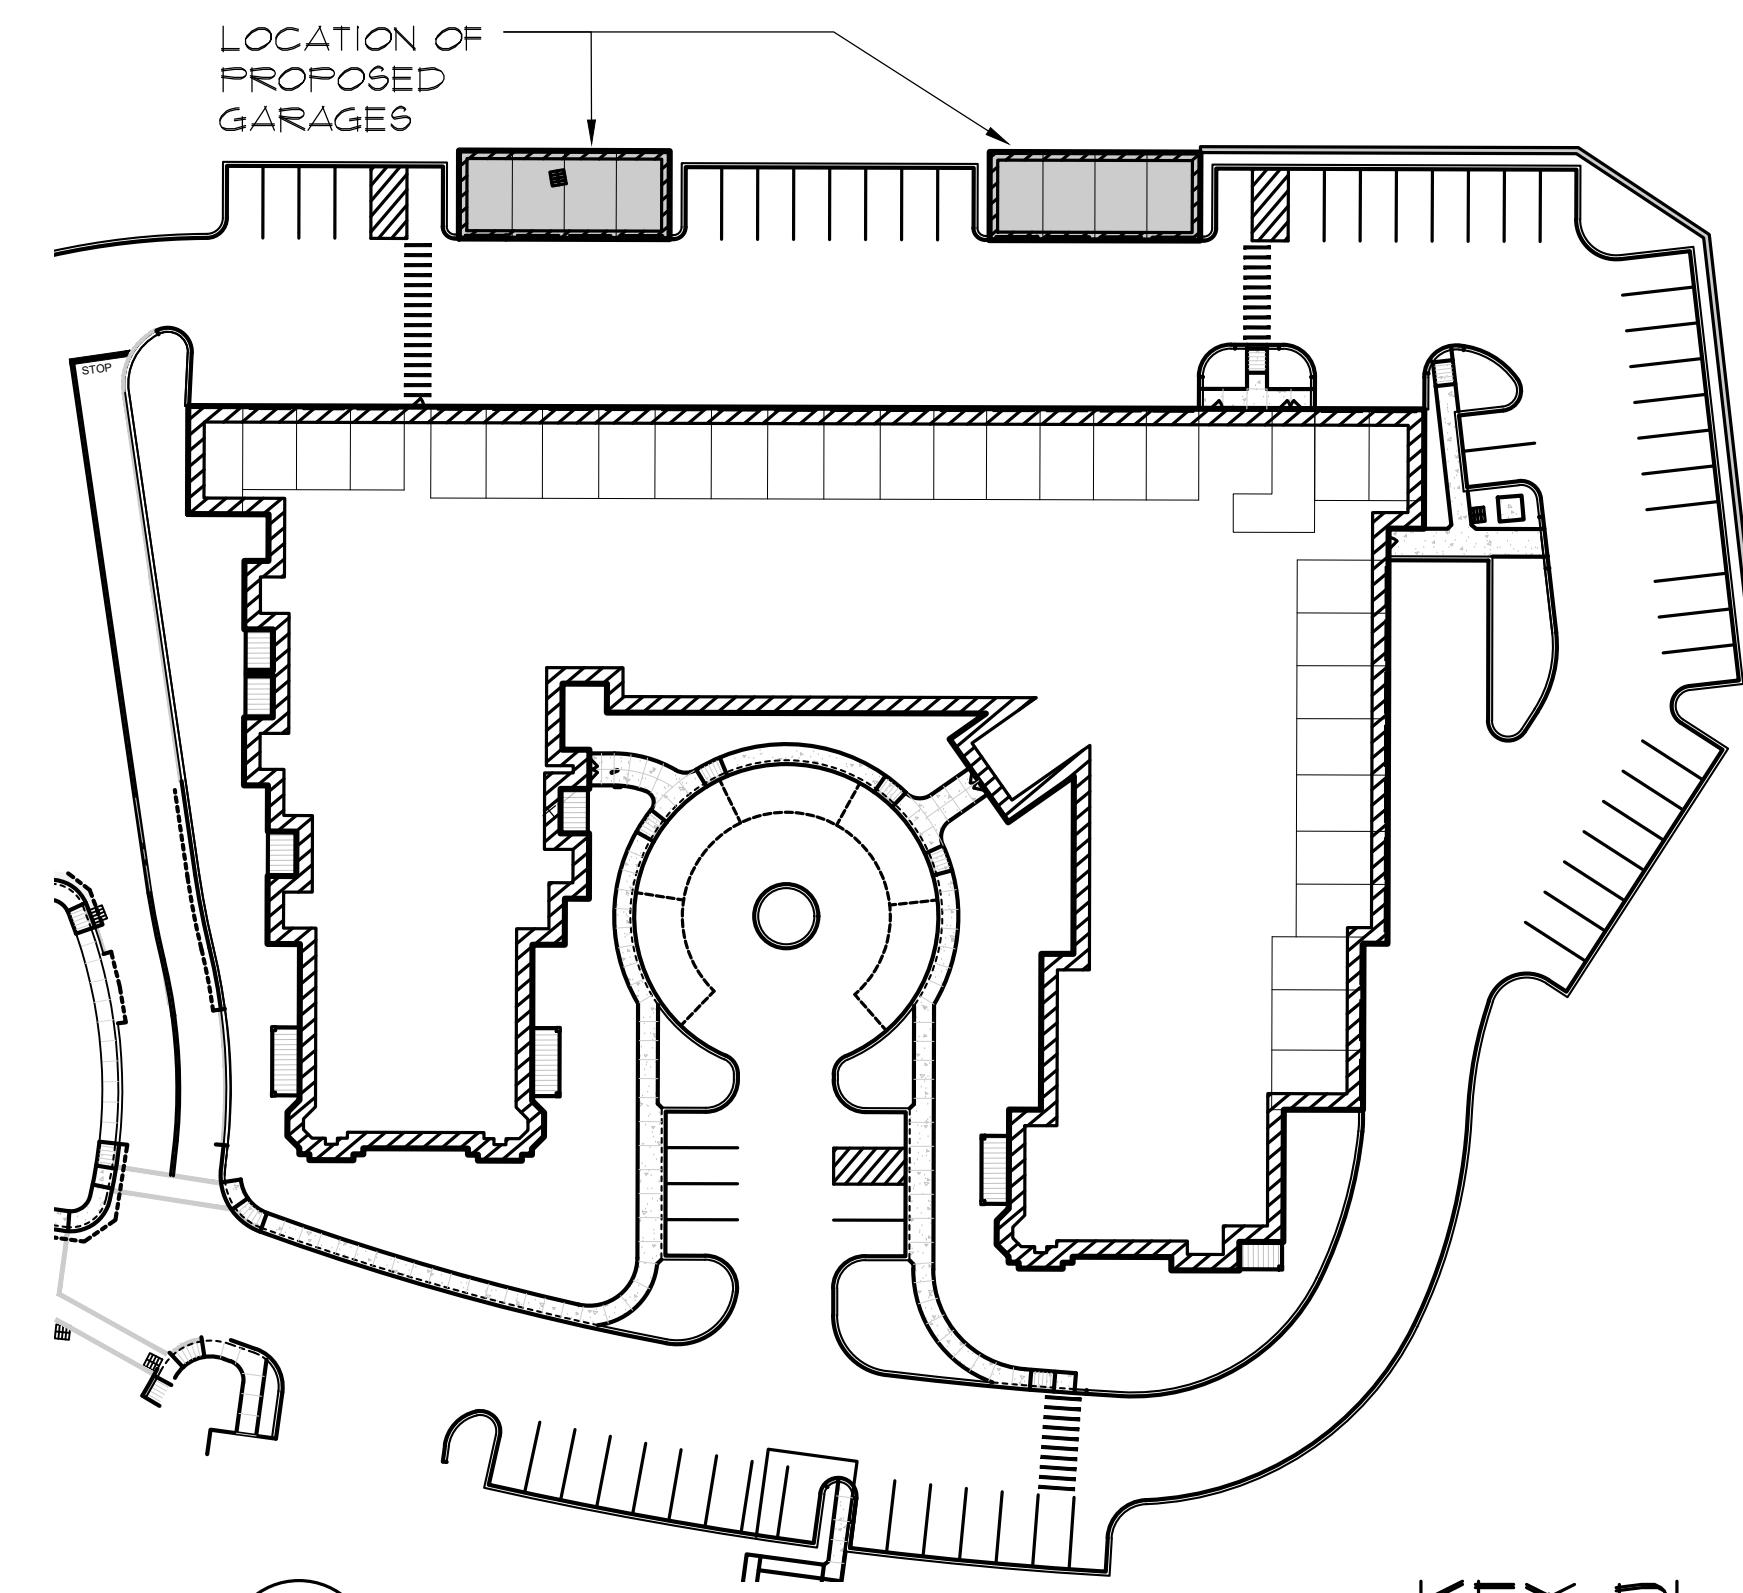

KEY PLAN
SCALE: 1/8"=1'-0"

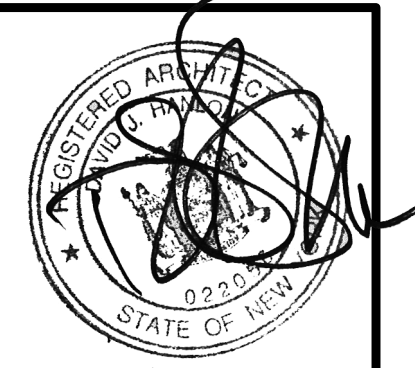

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**KILBOURN PLACE APARTMENTS
BUILD 1 - GARAGE**

PITTSFORD, NEW YORK

REVISED:

ISSUED FOR PERMIT
DATE: 6-10-22
COVER SHEET

DRAWING TITLE:

C1


SHEET NO:
PROJECT NO: 21-226



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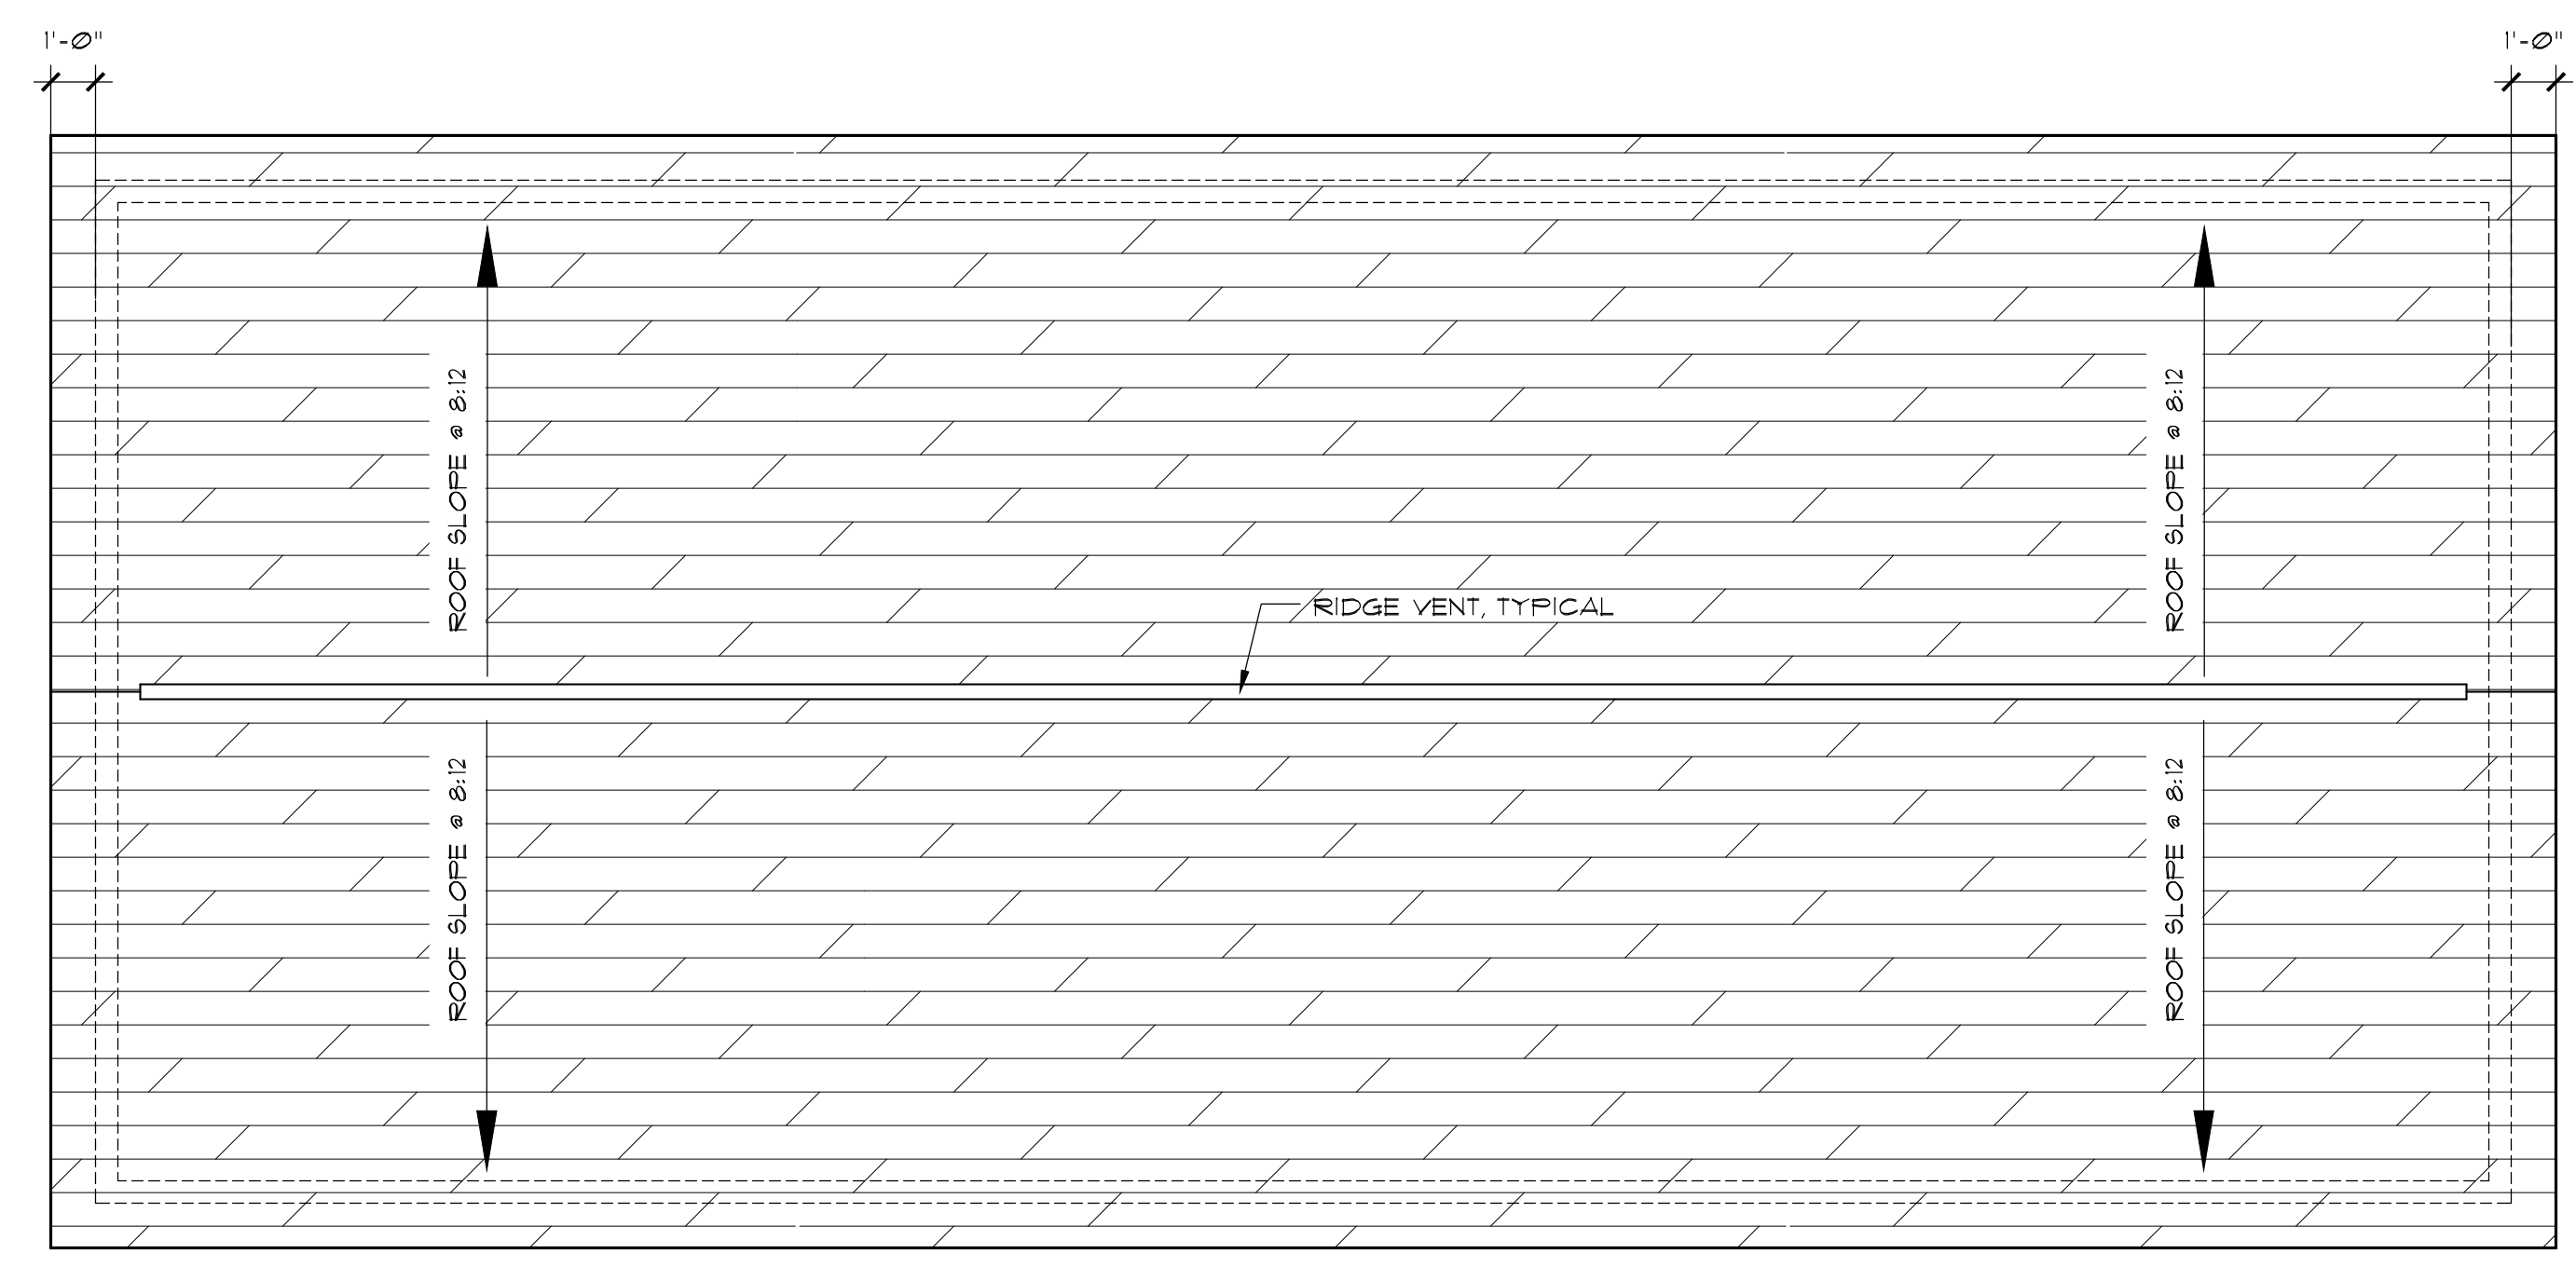
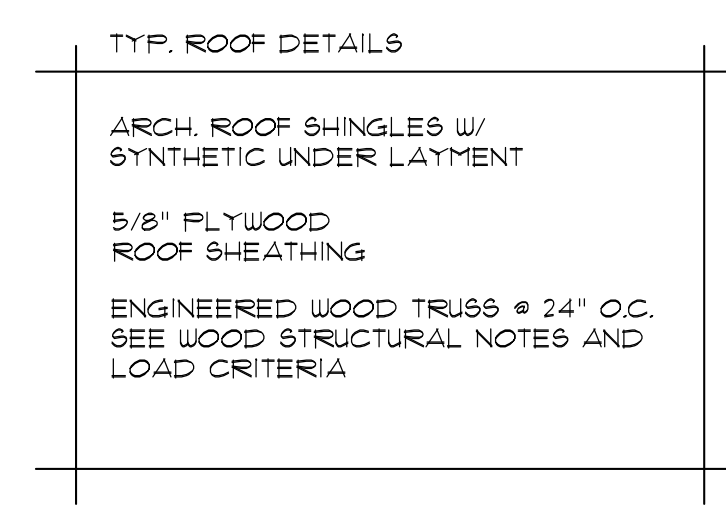
**KILBOURN PLACE APARTMENTS
 BUILDING 1 - GARAGE**
 PITTSFORD, NEW YORK

REVISED:
 ISSUED FOR PERMIT
 DATE: 6-10-22
 FLOOR & ROOF PLAN
 DRAWING TITLE:
 SHEET NO. **A1**
 PROJECT NO. 21-226

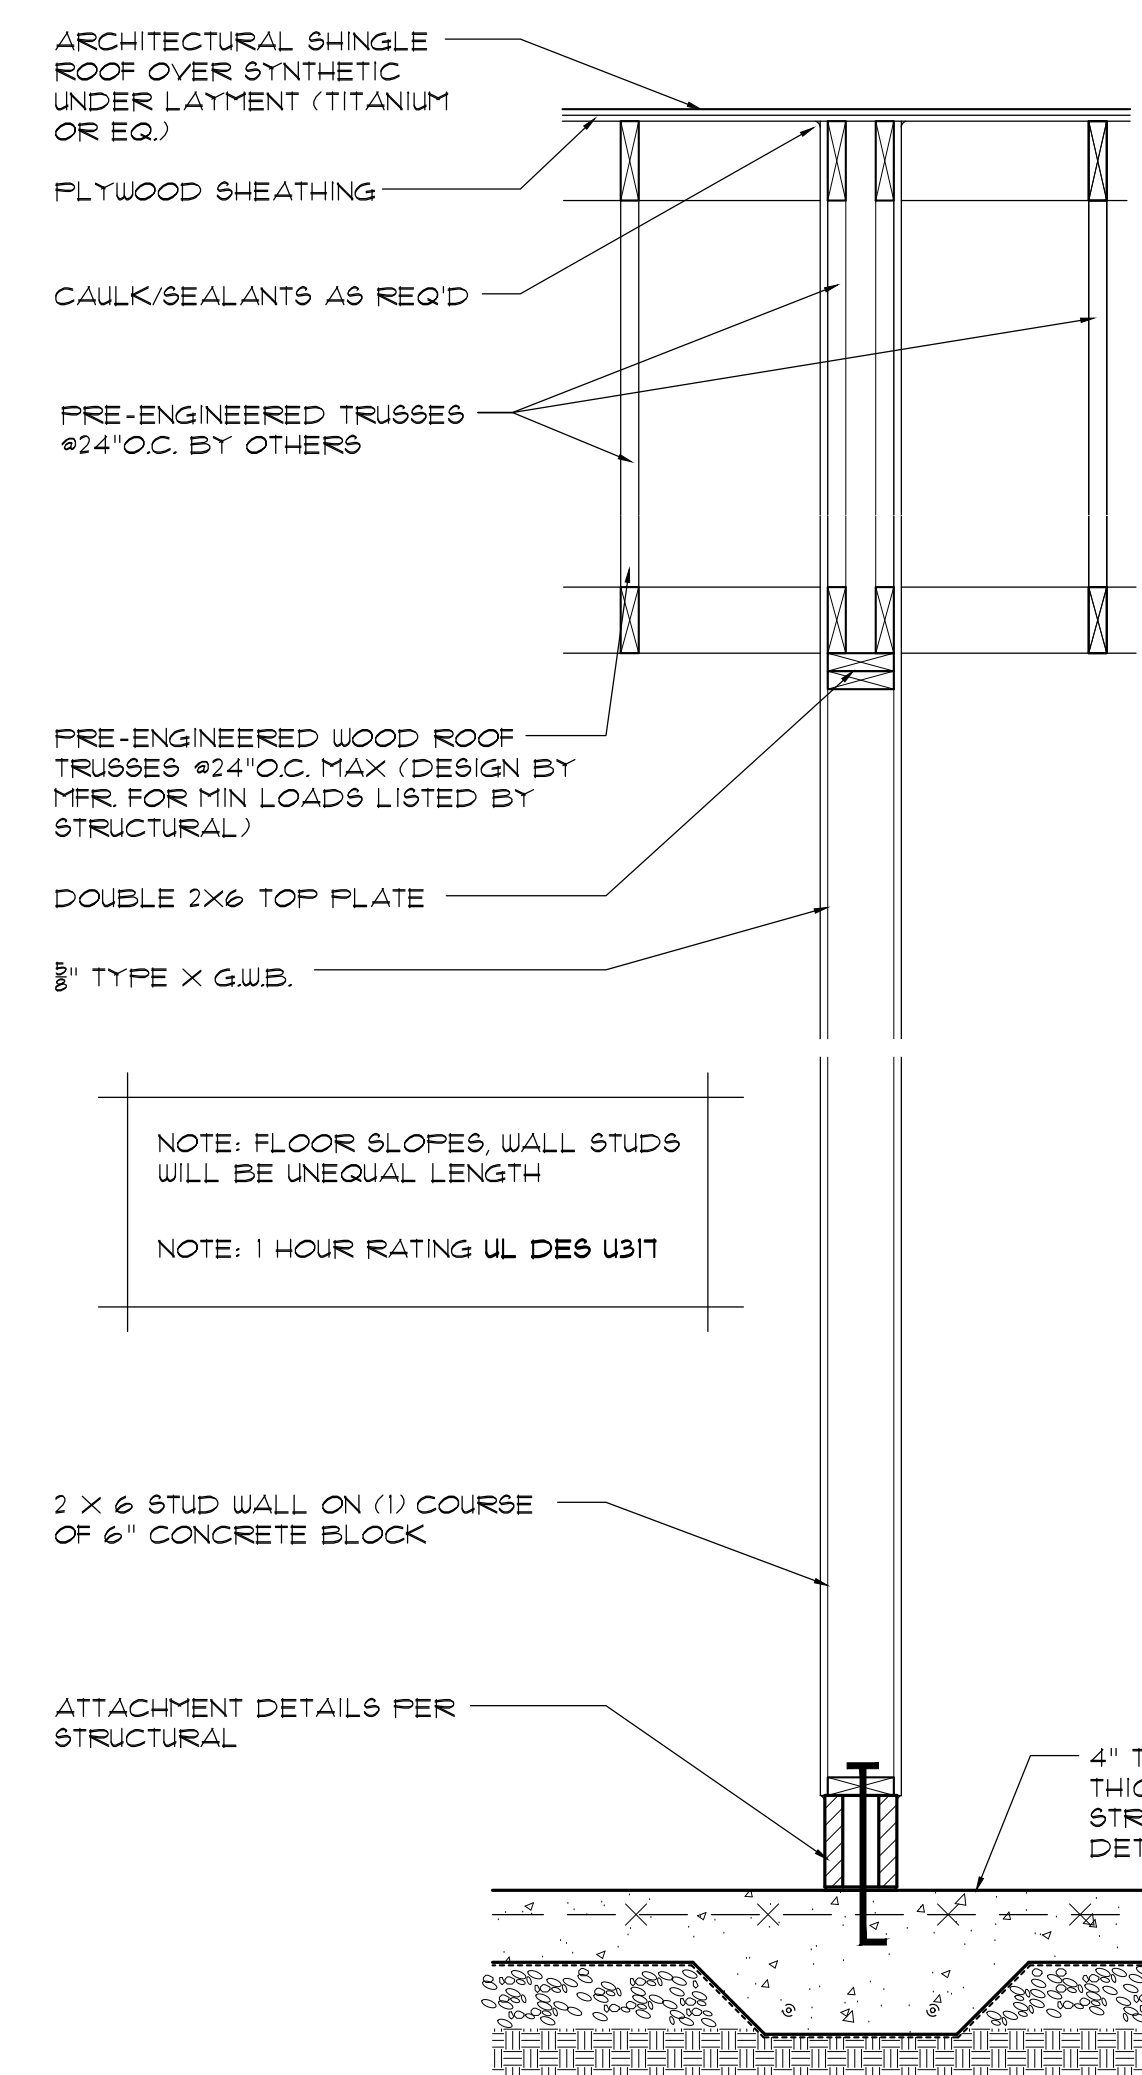


NOTE: FLOOR SLOPES, WALL STUDS WILL BE UNEQUAL LENGTH
 NOTE: 1 HOUR RATING UL DES U317

UNLESS NOTED OTHERWISE:
 UNLESS NOTED OTHERWISE, ROOF FRAMING SHALL BE ENGINEERED WOOD ROOF TRUSSES. COORDINATE W/ STRUCTURAL ENGINEER & TRUSS SUPPLIER ALL FINAL TRUSS DETAILS, SHAPES, AND DESIGN LOAD REQUIREMENTS.
 FINAL GUTTER AND DOWN SPOUT LOCATIONS TO BE VERIFIED IN FIELD - COORD W/ GC, OWNER, & ARCHITECT.



ROOF PLAN
 SCALE: 1/4"=1'-0"


WALL TYPE 'A'
 SCALE: 3/4"=1'-0"

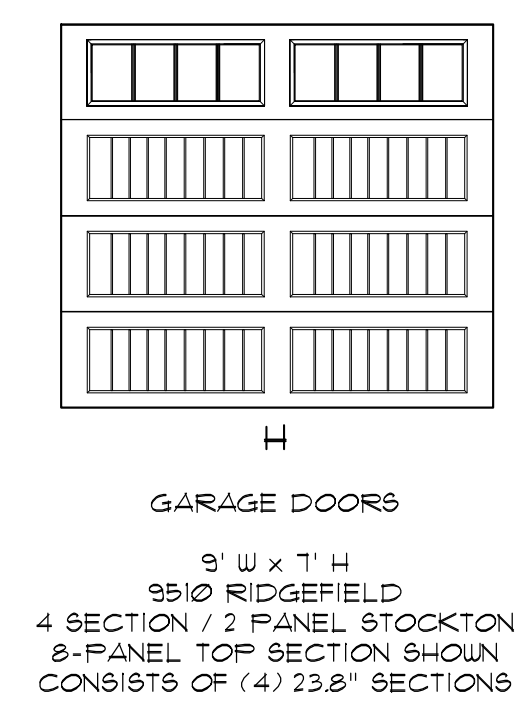

DOOR SCHEDULE							
NO.	SIZE	DOOR		FRAME		LABEL	REMARKS
		MAT.	ELEV.	MAT.	HDRURE FUNCTION (SEE NOTE 4)		
GD-2	9'-0" x 7'-0"			H			OVERHEAD DOOR, PROVIDE OPENER


- FLOOR PLAN GENERAL NOTES:**
- F.E.C. : FIRE EXTINGUISHER CABINET (OR WALL HUNG EXTINGUISHER) LOCATION, MOUNTING HEIGHT TO THE TOP OF THE CABINET SHALL BE APPROX. 40" AFF.-COORDINATED WITH SELECTED UNIT. GC SHALL REVIEW FINAL LOCATIONS WITH FIRE MARSHAL PRIOR TO EXTINGUISHER MOUNTING INSTALLATION.
 - REFER TO ELECTRICAL DRAWINGS (PROVIDED BY OTHERS) FOR ALL FIRE ALARM TYPES AND LOCATIONS, EXIT SIGNAGE AND EMERGENCY LIGHTING LAYOUTS.
 - FIRE ALARM SYSTEM SHALL BE INSTALLED PER NYSBC.
 - ALL DIMENSIONS TO BE TAKEN FROM FACE OF WALL. REFER TO PARTITION TYPES FOR ACTUAL DIMENSIONS
 - CONTRACTOR SHALL PROVIDE BLOCKING AS REQUIRED FOR ALL EQPT. INSTALLATION.

- FIRST FLOOR PLAN KEY NOTES:**
- SEALED CONCRETE TREATMENT ON EXISTING CONCRETE FLOOR TO BE COORDINATED B/W LANDLORD & TENANT
 - TRUSS PLACARD TO BE SHOWN ON ELECTRICAL BOX. FINAL LOCATION OF ELECTRICAL BOX T.B.D.

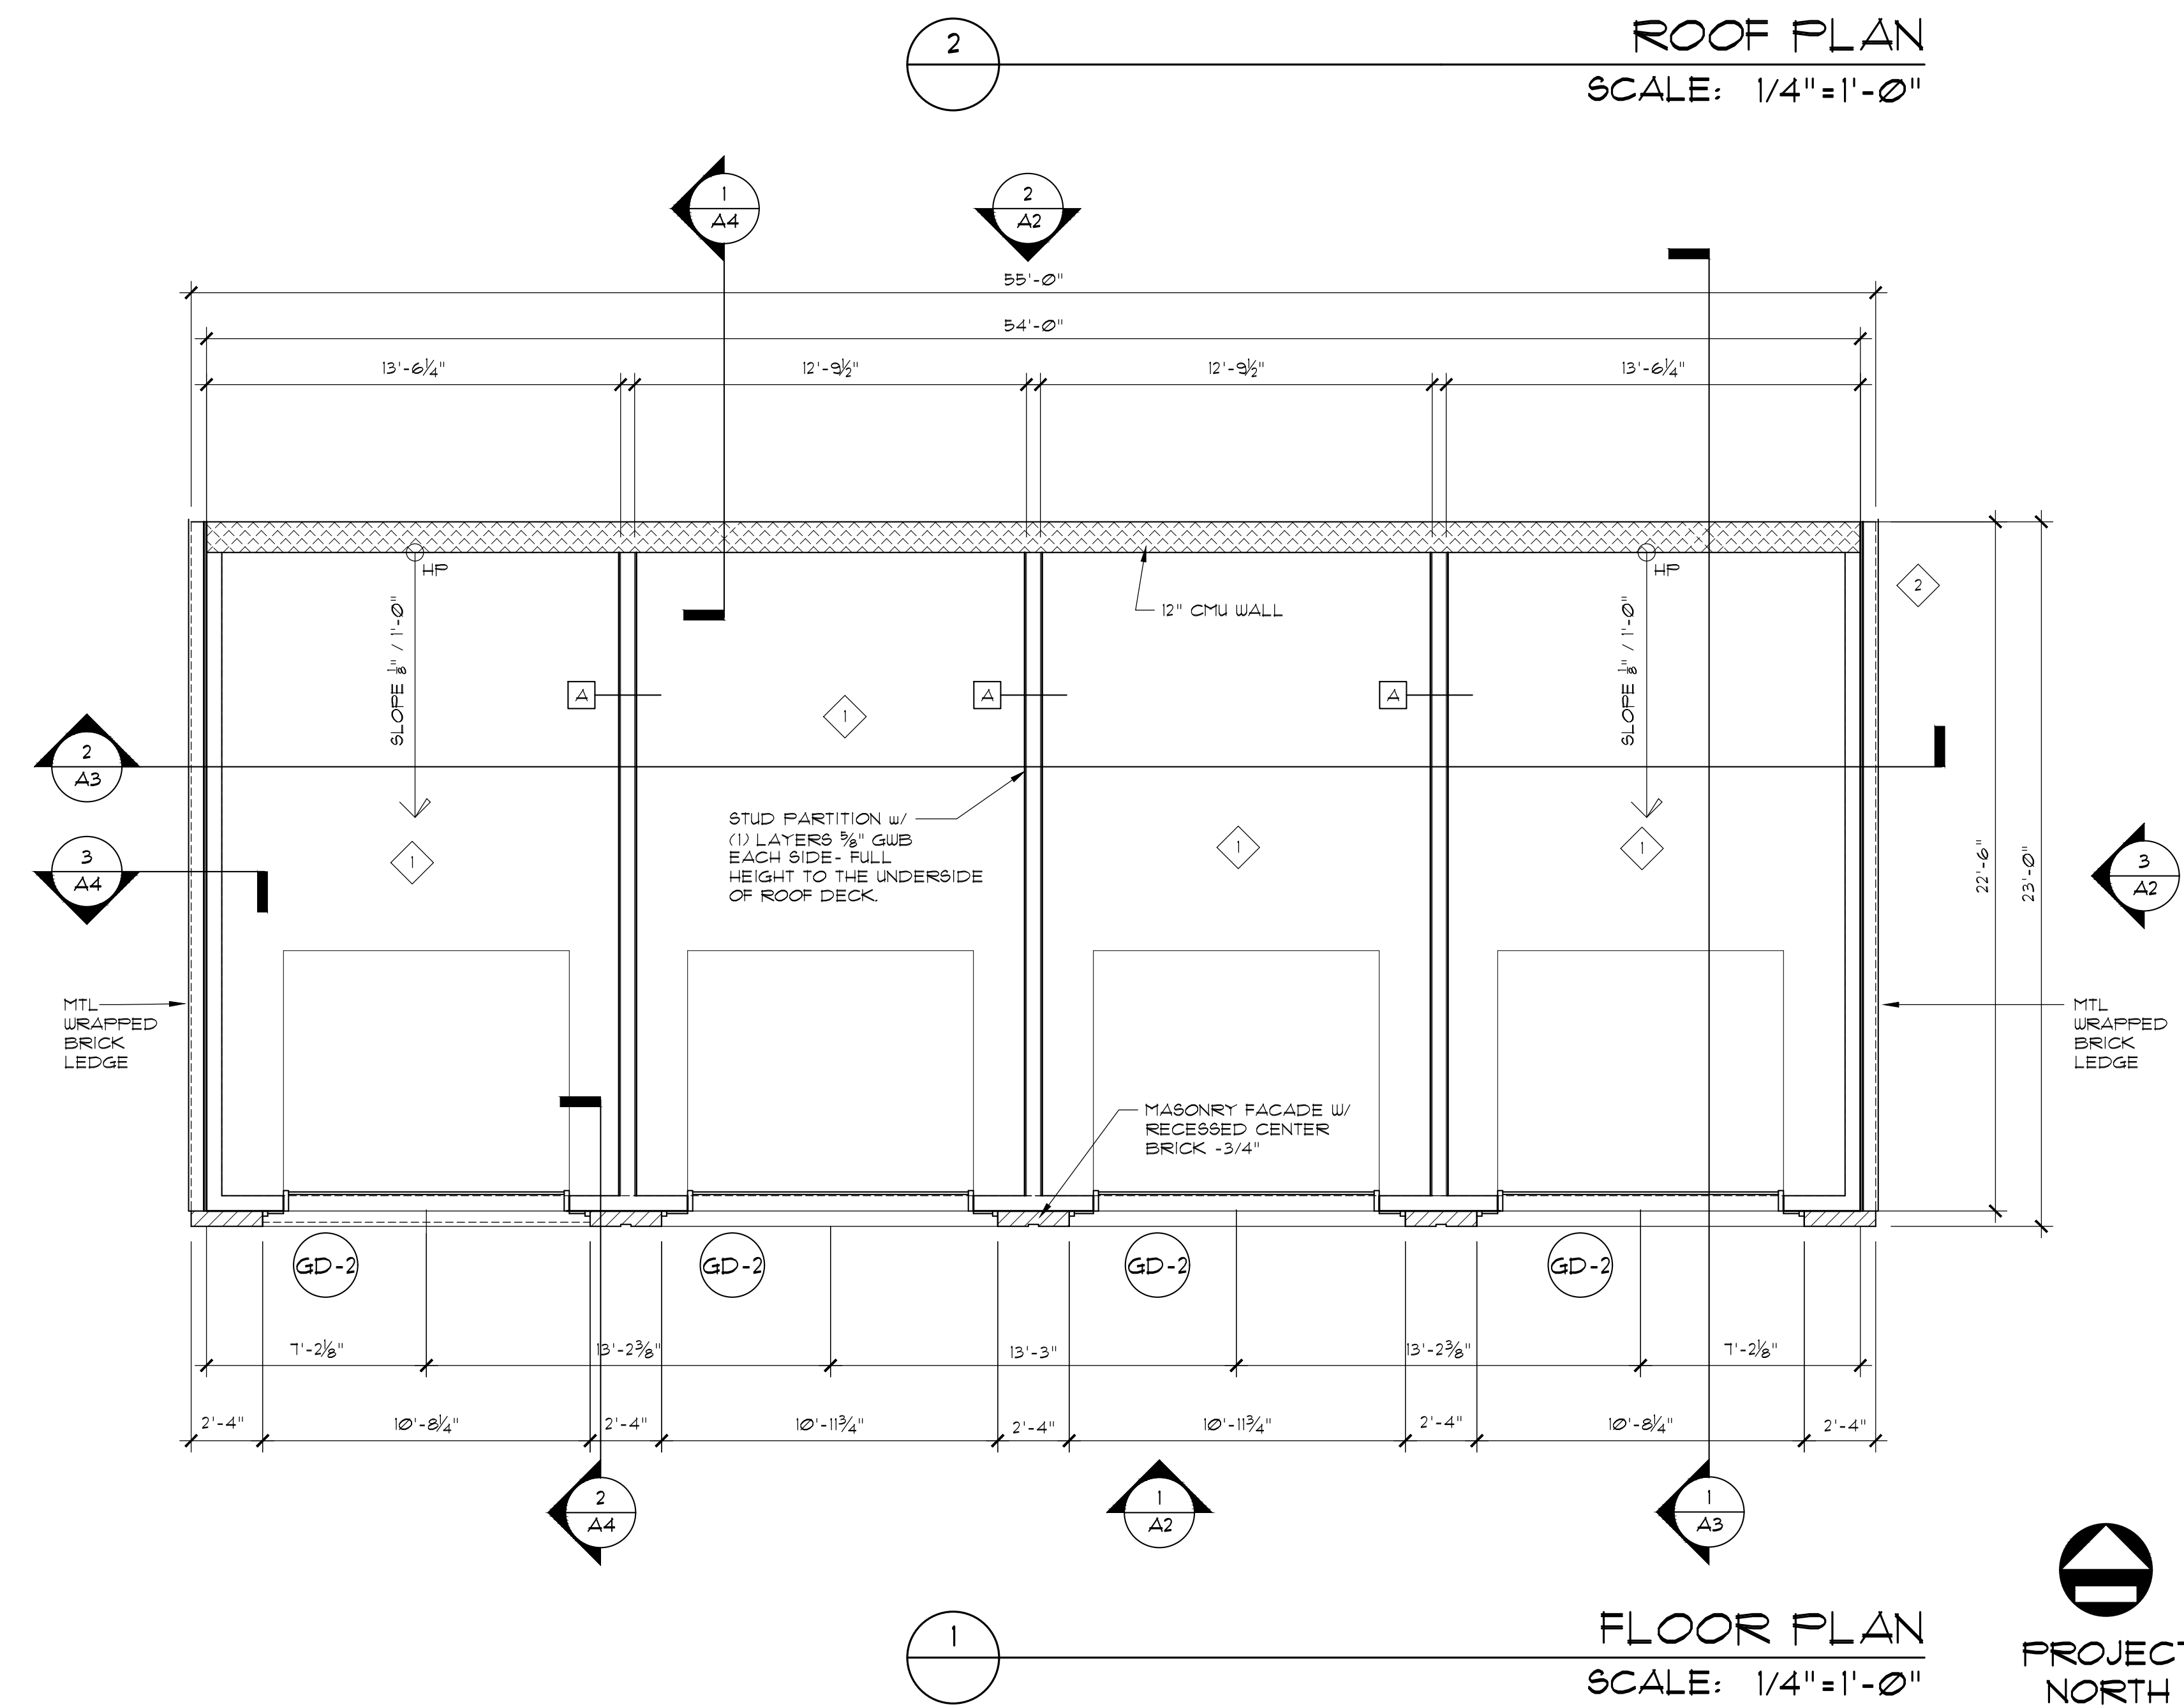

FLOOR PLAN
 SCALE: 1/4"=1'-0"



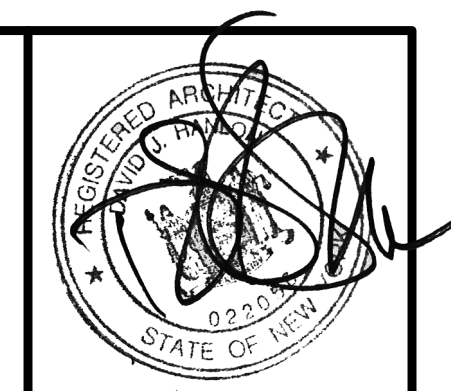

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**KILBOURN PLACE APARTMENTS
 BUILDING 1 - GARAGE**
 PITTSFORD, NEW YORK

REVISED:
 ISSUED FOR PERMIT
 DATE: 6-10-22
 REFLECTED CEILING PLAN
 DRAWING TITLE:
 SHEET NO. **A2**
 PROJECT NO. 21-226



CEILING / LIGHT FIXTURE LEGEND:

- 4' LED LINEAR TUBE LIGHT FIXTURES. FINAL PLACEMENT & TYPE PER OWNER
- RECEPTACLES @ CEILINGS - G.C. TO COORDINATE FINAL LOCATIONS & QUANTITIES

FINAL FIRE ALARM COMPONENTS & DESIGN LAYOUT TO BE VERIFIED BY OTHERS. THE INFORMATION SHOWN IS FOR REFERENCE ONLY AND SHALL BE REVIEWED BY OWNER AND GC PRIOR TO FINAL PLACEMENT.


REFLECTED CEILING PLAN NOTES:

1. ALL LIGHTING TEMPERATURE TO BE 3500K UNO
2. OMITTED
3. ALL OUTLET PLATES AND SWITCHES TO BE WHITE UNO
4. ALL FIXTURE HEIGHTS TO BE CONFIRMED BEFORE INSTALLATION
5. THIS DRAWING DEPICTS LIGHTING LAYOUTS FOR DESIGN PURPOSES & DECORATIVE FIXTURES. CONTRACTOR TO EVALUATE & PROVIDE LIGHT LEVELS IN ALL PUBLIC AREAS. REFER TO PAINT SCHEDULE FOR LIGHT REFLECTANCIES OR REFER TO ELECTRICAL ENGINEER.
6. ALIGN LIGHTS WHEREVER POSSIBLE.
7. COORDINATE TRADES TO ASSURE ALL DEVICES ALIGN EITHER VERTICALLY OR HORIZONTALLY. KEEP DEVICES CLOSE TO DOOR FRAMES OR CORNERS & AWAY FROM CENTER OF WALLS.
8. VERIFY ALL OUTLET HEIGHTS AND LOCATIONS WITH OWNERS.
9. REFER TO HVAC/ MECHANICAL, ELECTRICAL & FIRE PROTECTION DRAWINGS FOR ASSOCIATED WORK.
10. PROVIDE OCCUPANCY SENSORS PER ENERGY CODE G405.2.1.
11. EXTERIOR LIGHTING OR POWER REQUIREMENTS TO BE DETERMINED BY OTHERS.

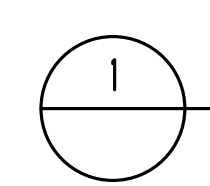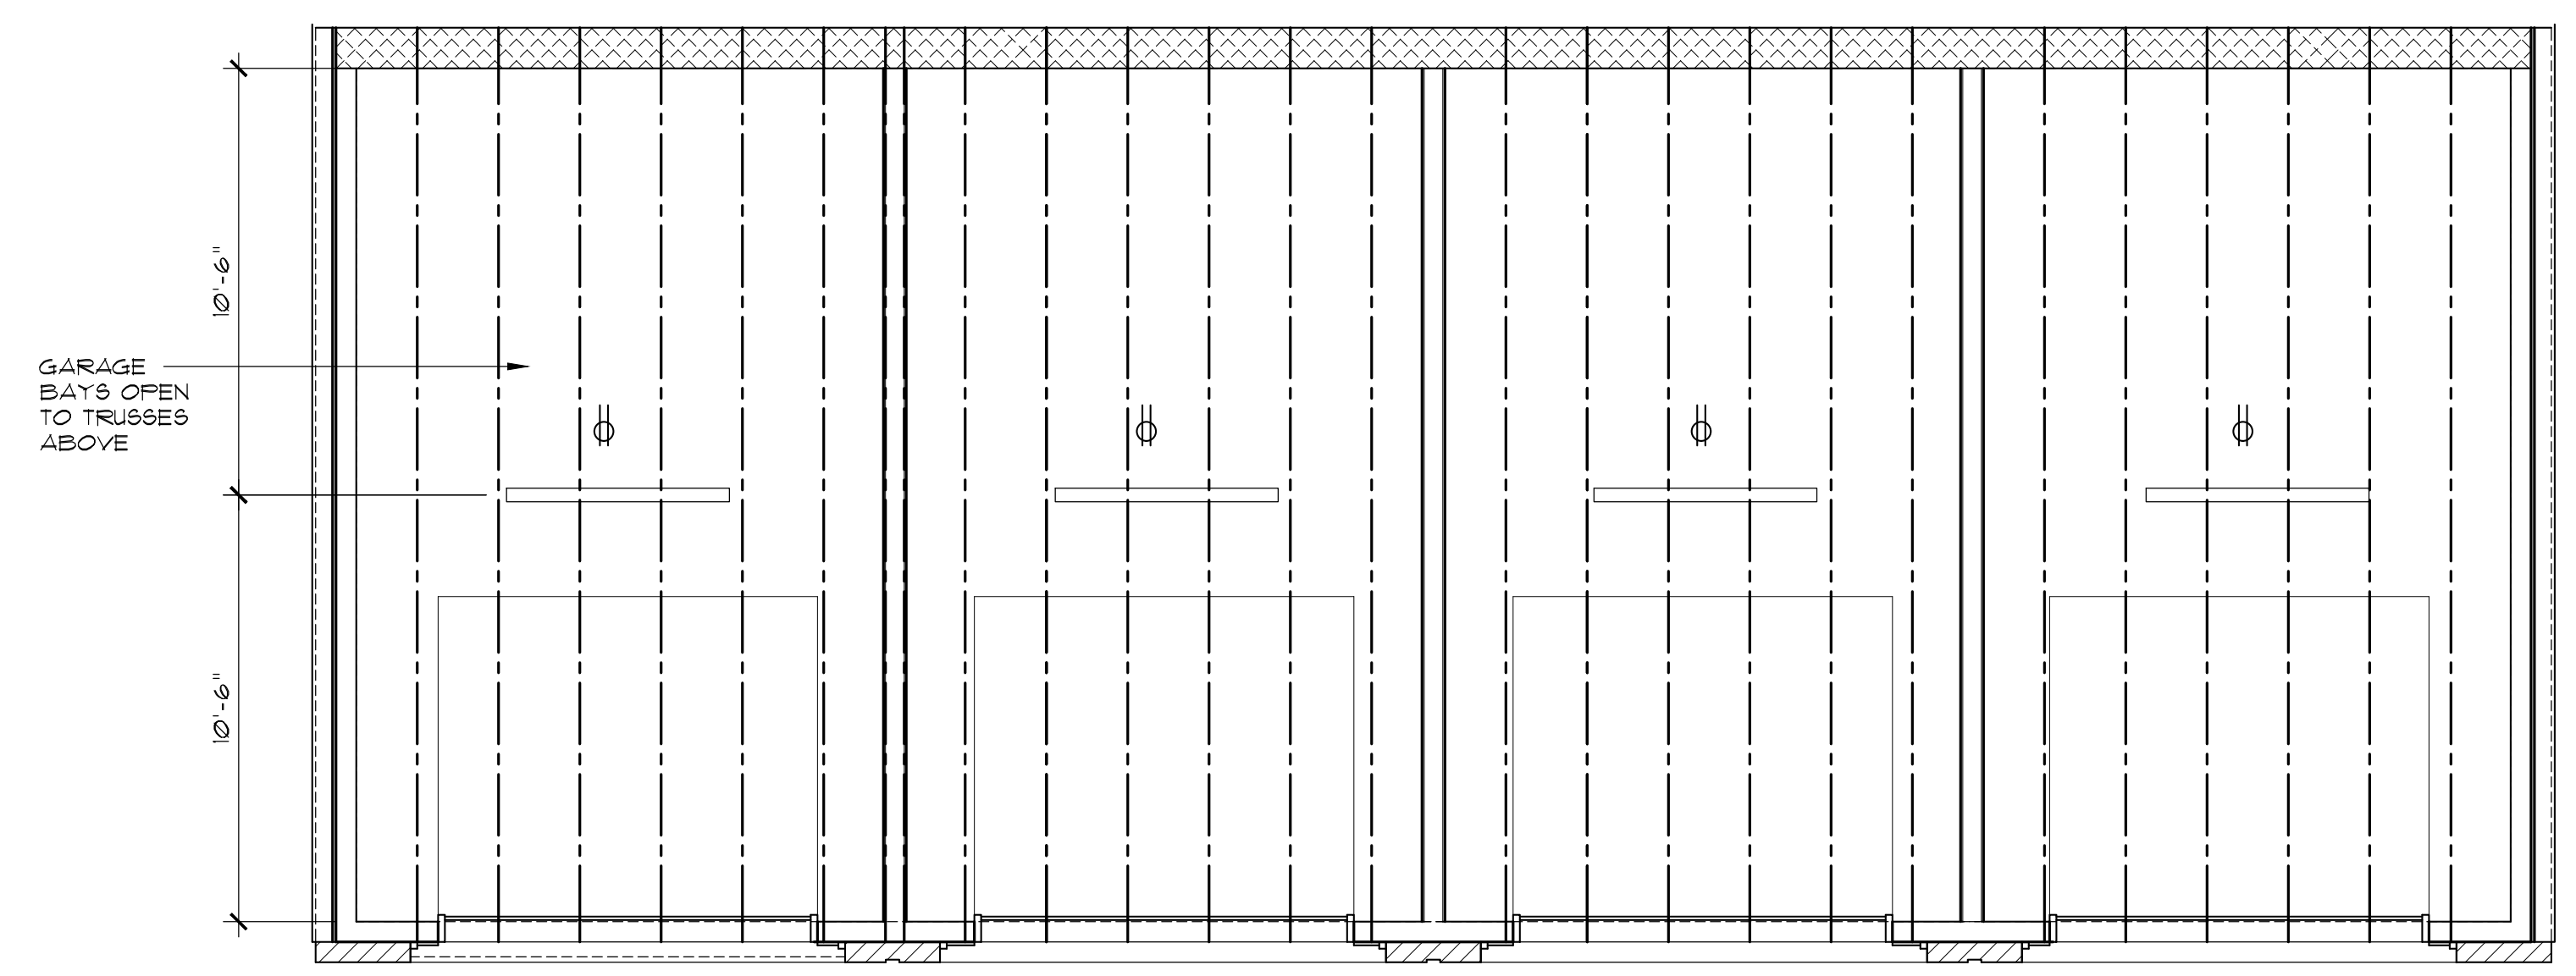

REFLECTED CEILING PLAN
 SCALE: 1/4"=1'-0"



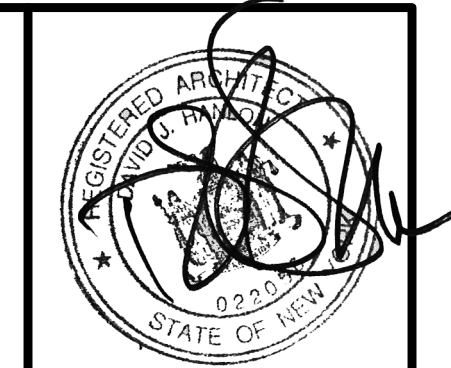

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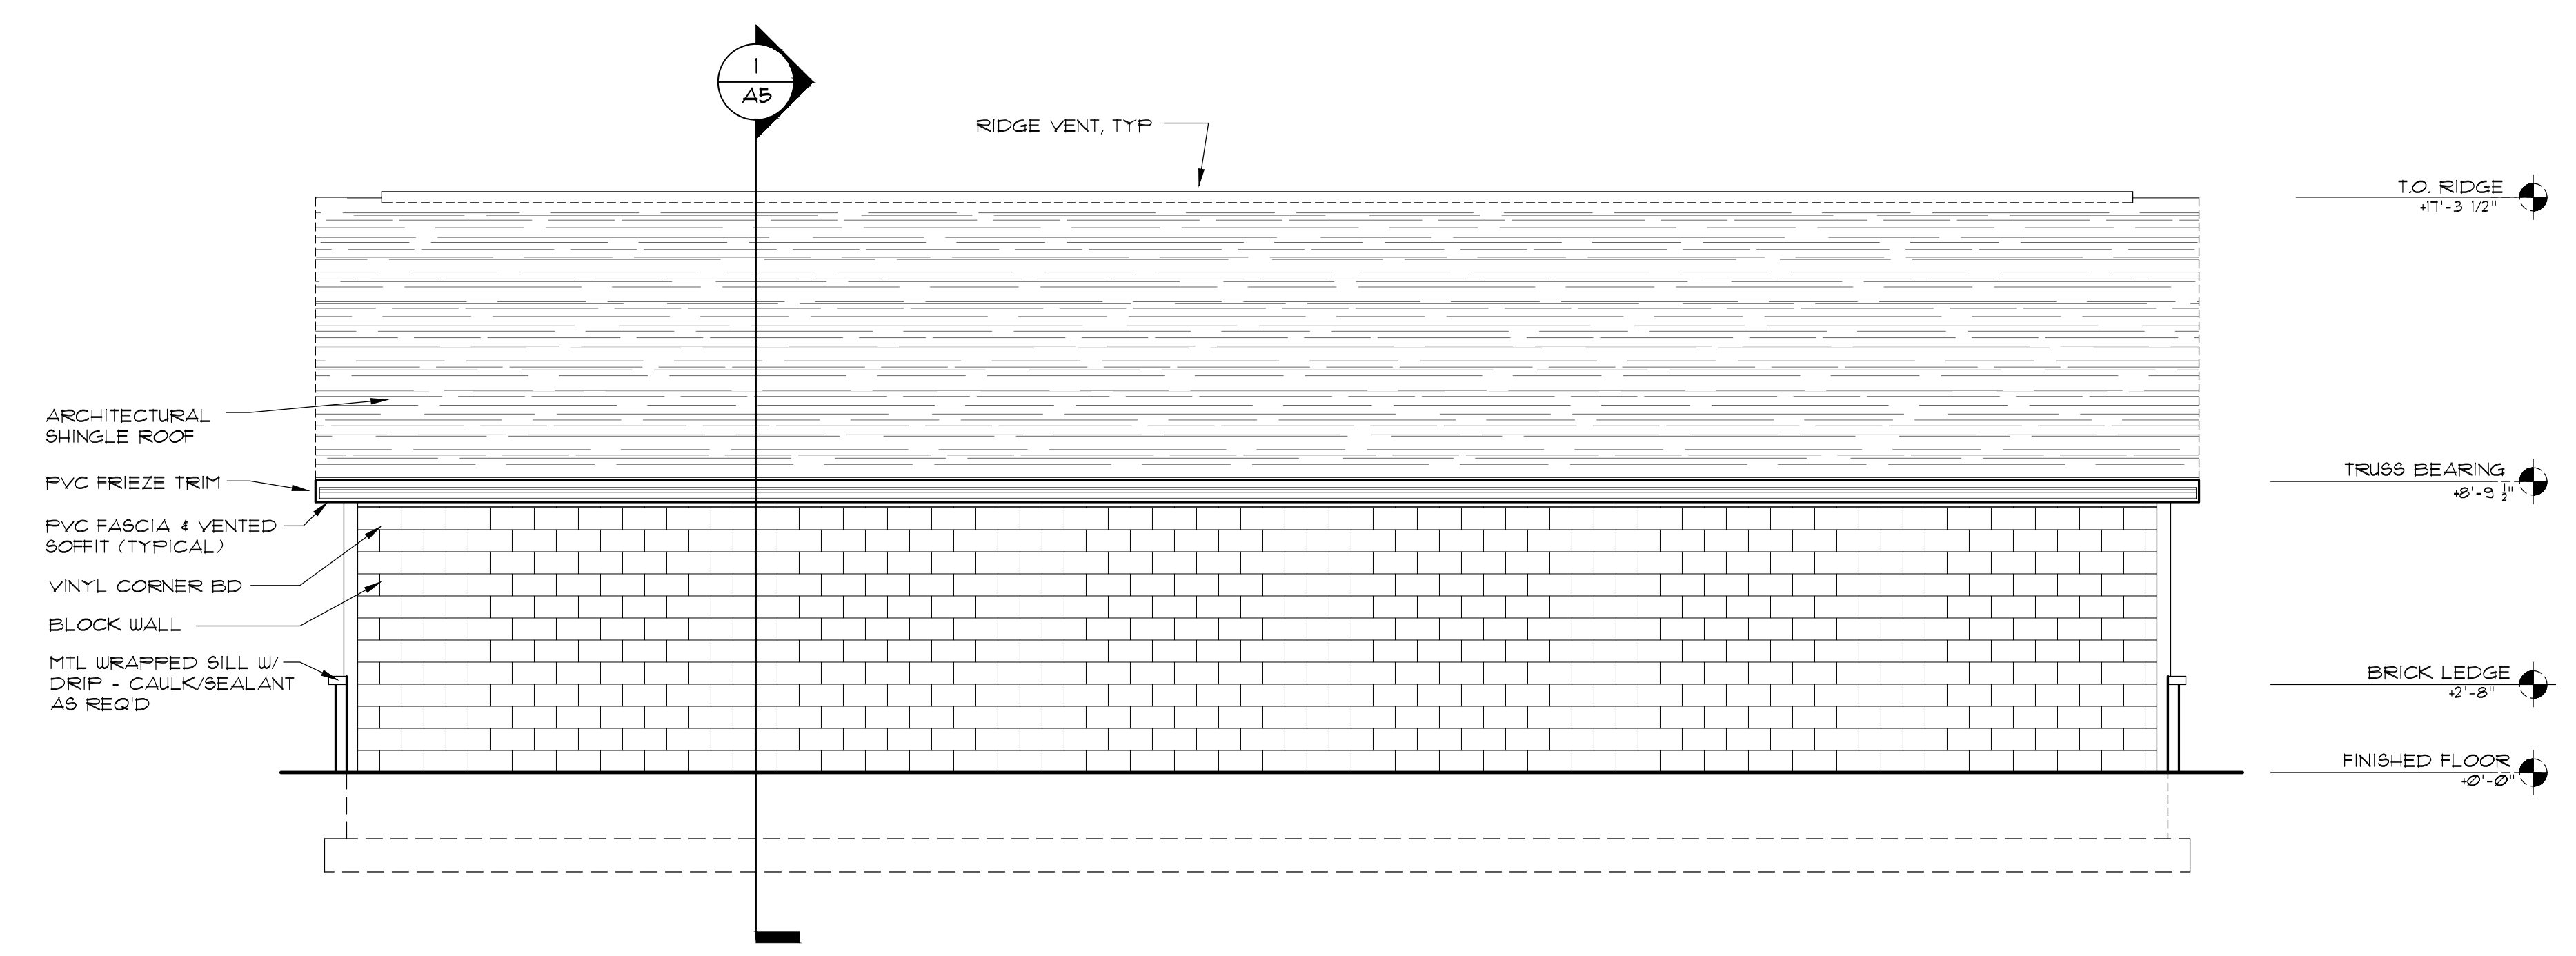
**KILBOURN PLACE APARTMENTS
 BUILDING 1 - GARAGE**
 PITTSFORD, NEW YORK

REVISED:
 ISSUED FOR PERMIT
 DATE: 6-10-22
 GARAGE ELEVATIONS
 DRAWING TITLE:
A3
 SHEET NO.
 PROJECT NO: 21-226


EXTERIOR FINISH LEGEND:

B-B	BRICK B- FULL BED MASONRY VENEER- WATSONTOWN BRICK COMPANY IRON SPOT FRIT SERIES- BELVIDERE
FC-A	FIBER CEMENT LAP SIDING COLOR: 'NIGHT GRAY'
FC-B	FIBER CEMENT LAP SIDING COLOR: 'COBBLESTONE'
R-A	ARCHITECTURAL ROOF SHINGLES


ALL TRIM, FASCIAS, & SOFFITS TO BE PAINTED PVC TRIM BOARDS & PANELS, UNLESS NOTED OTHERWISE.





2 REAR ELEVATION
 SCALE: 1/4"=1'-0"

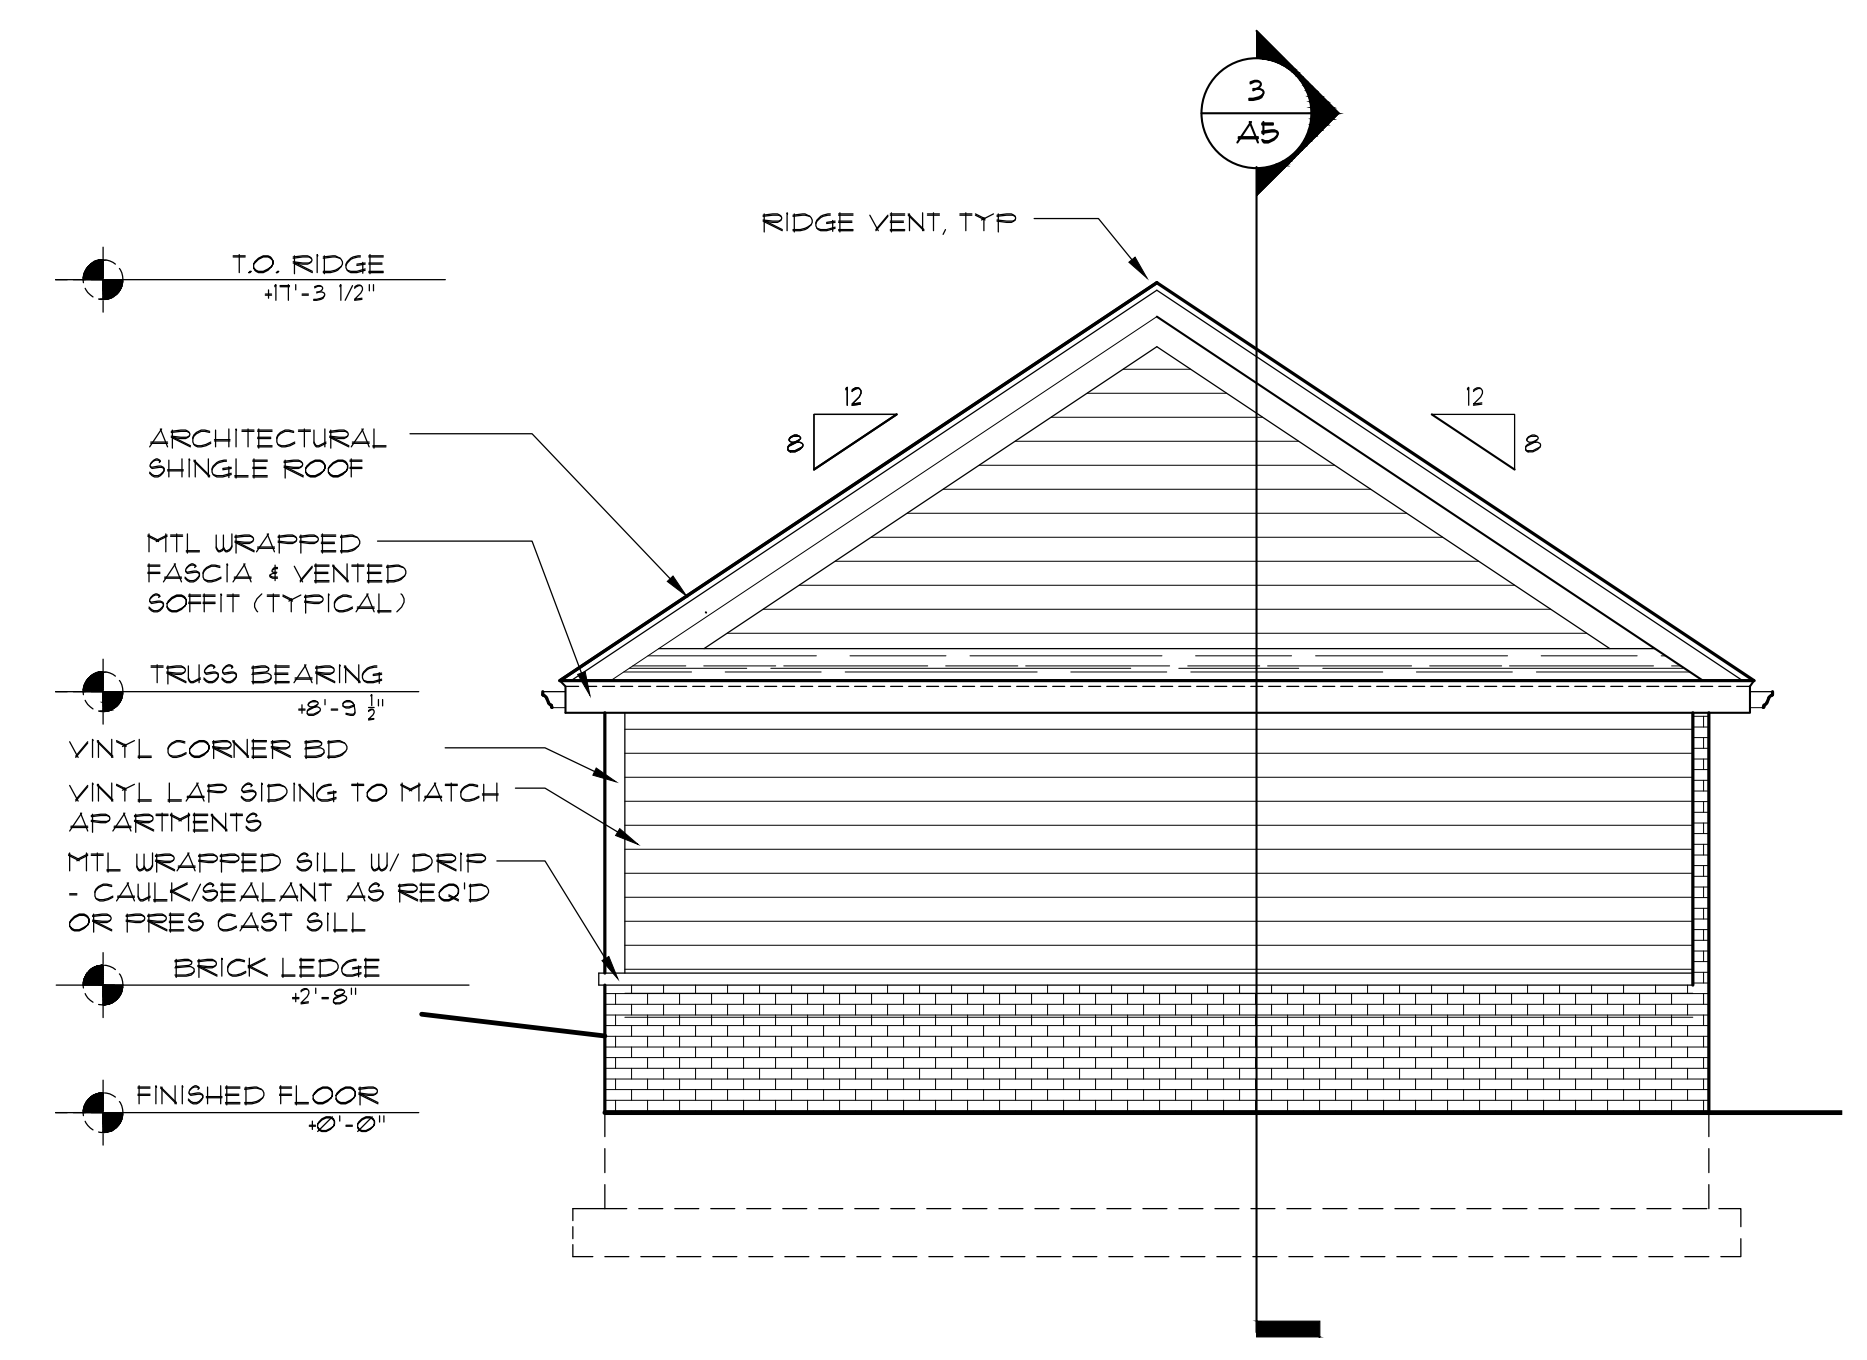


3 SIDE ELEVATION
 SCALE: 1/4"=1'-0"

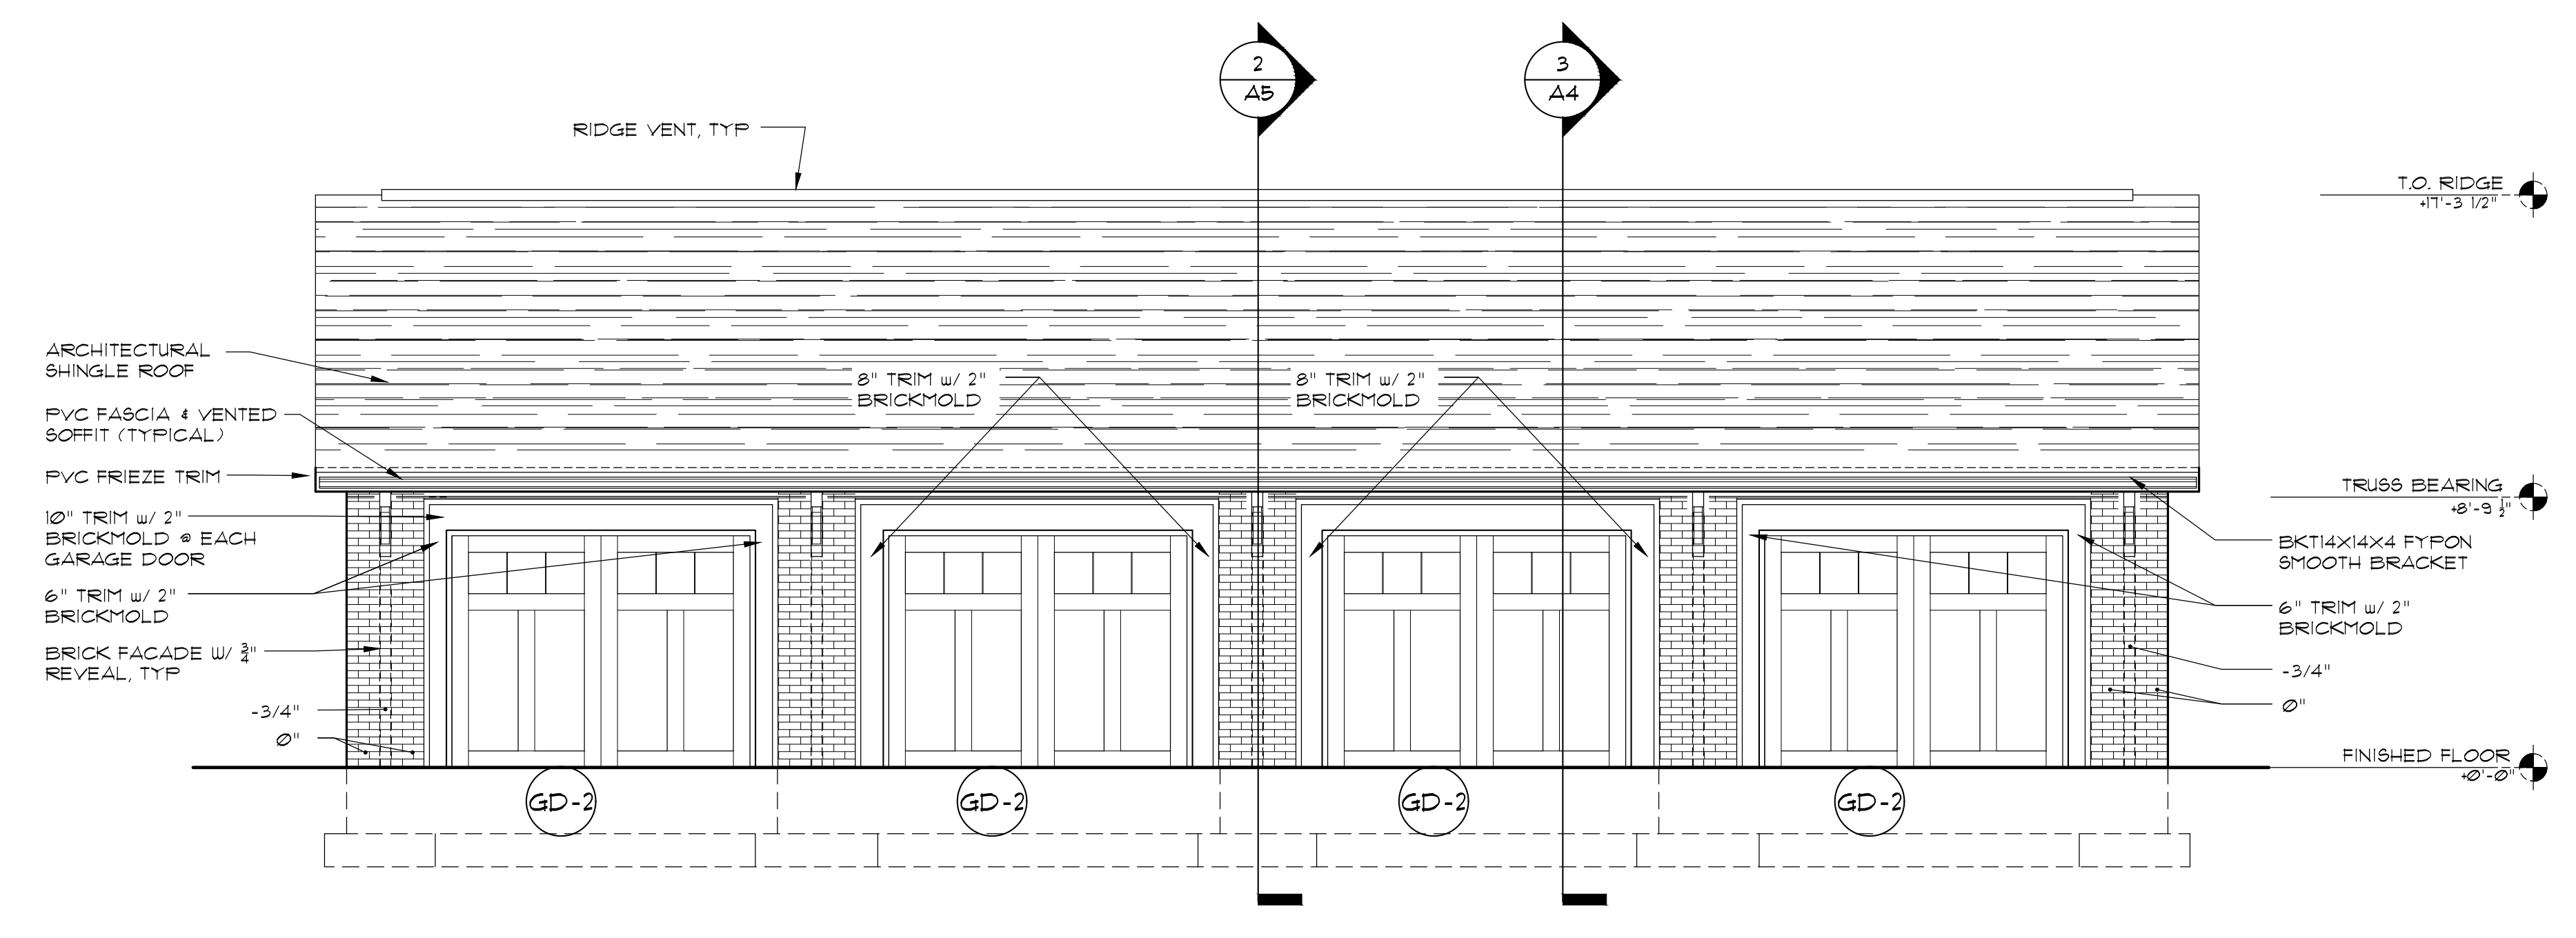


1 FRONT ELEVATION
 SCALE: 1/4"=1'-0"

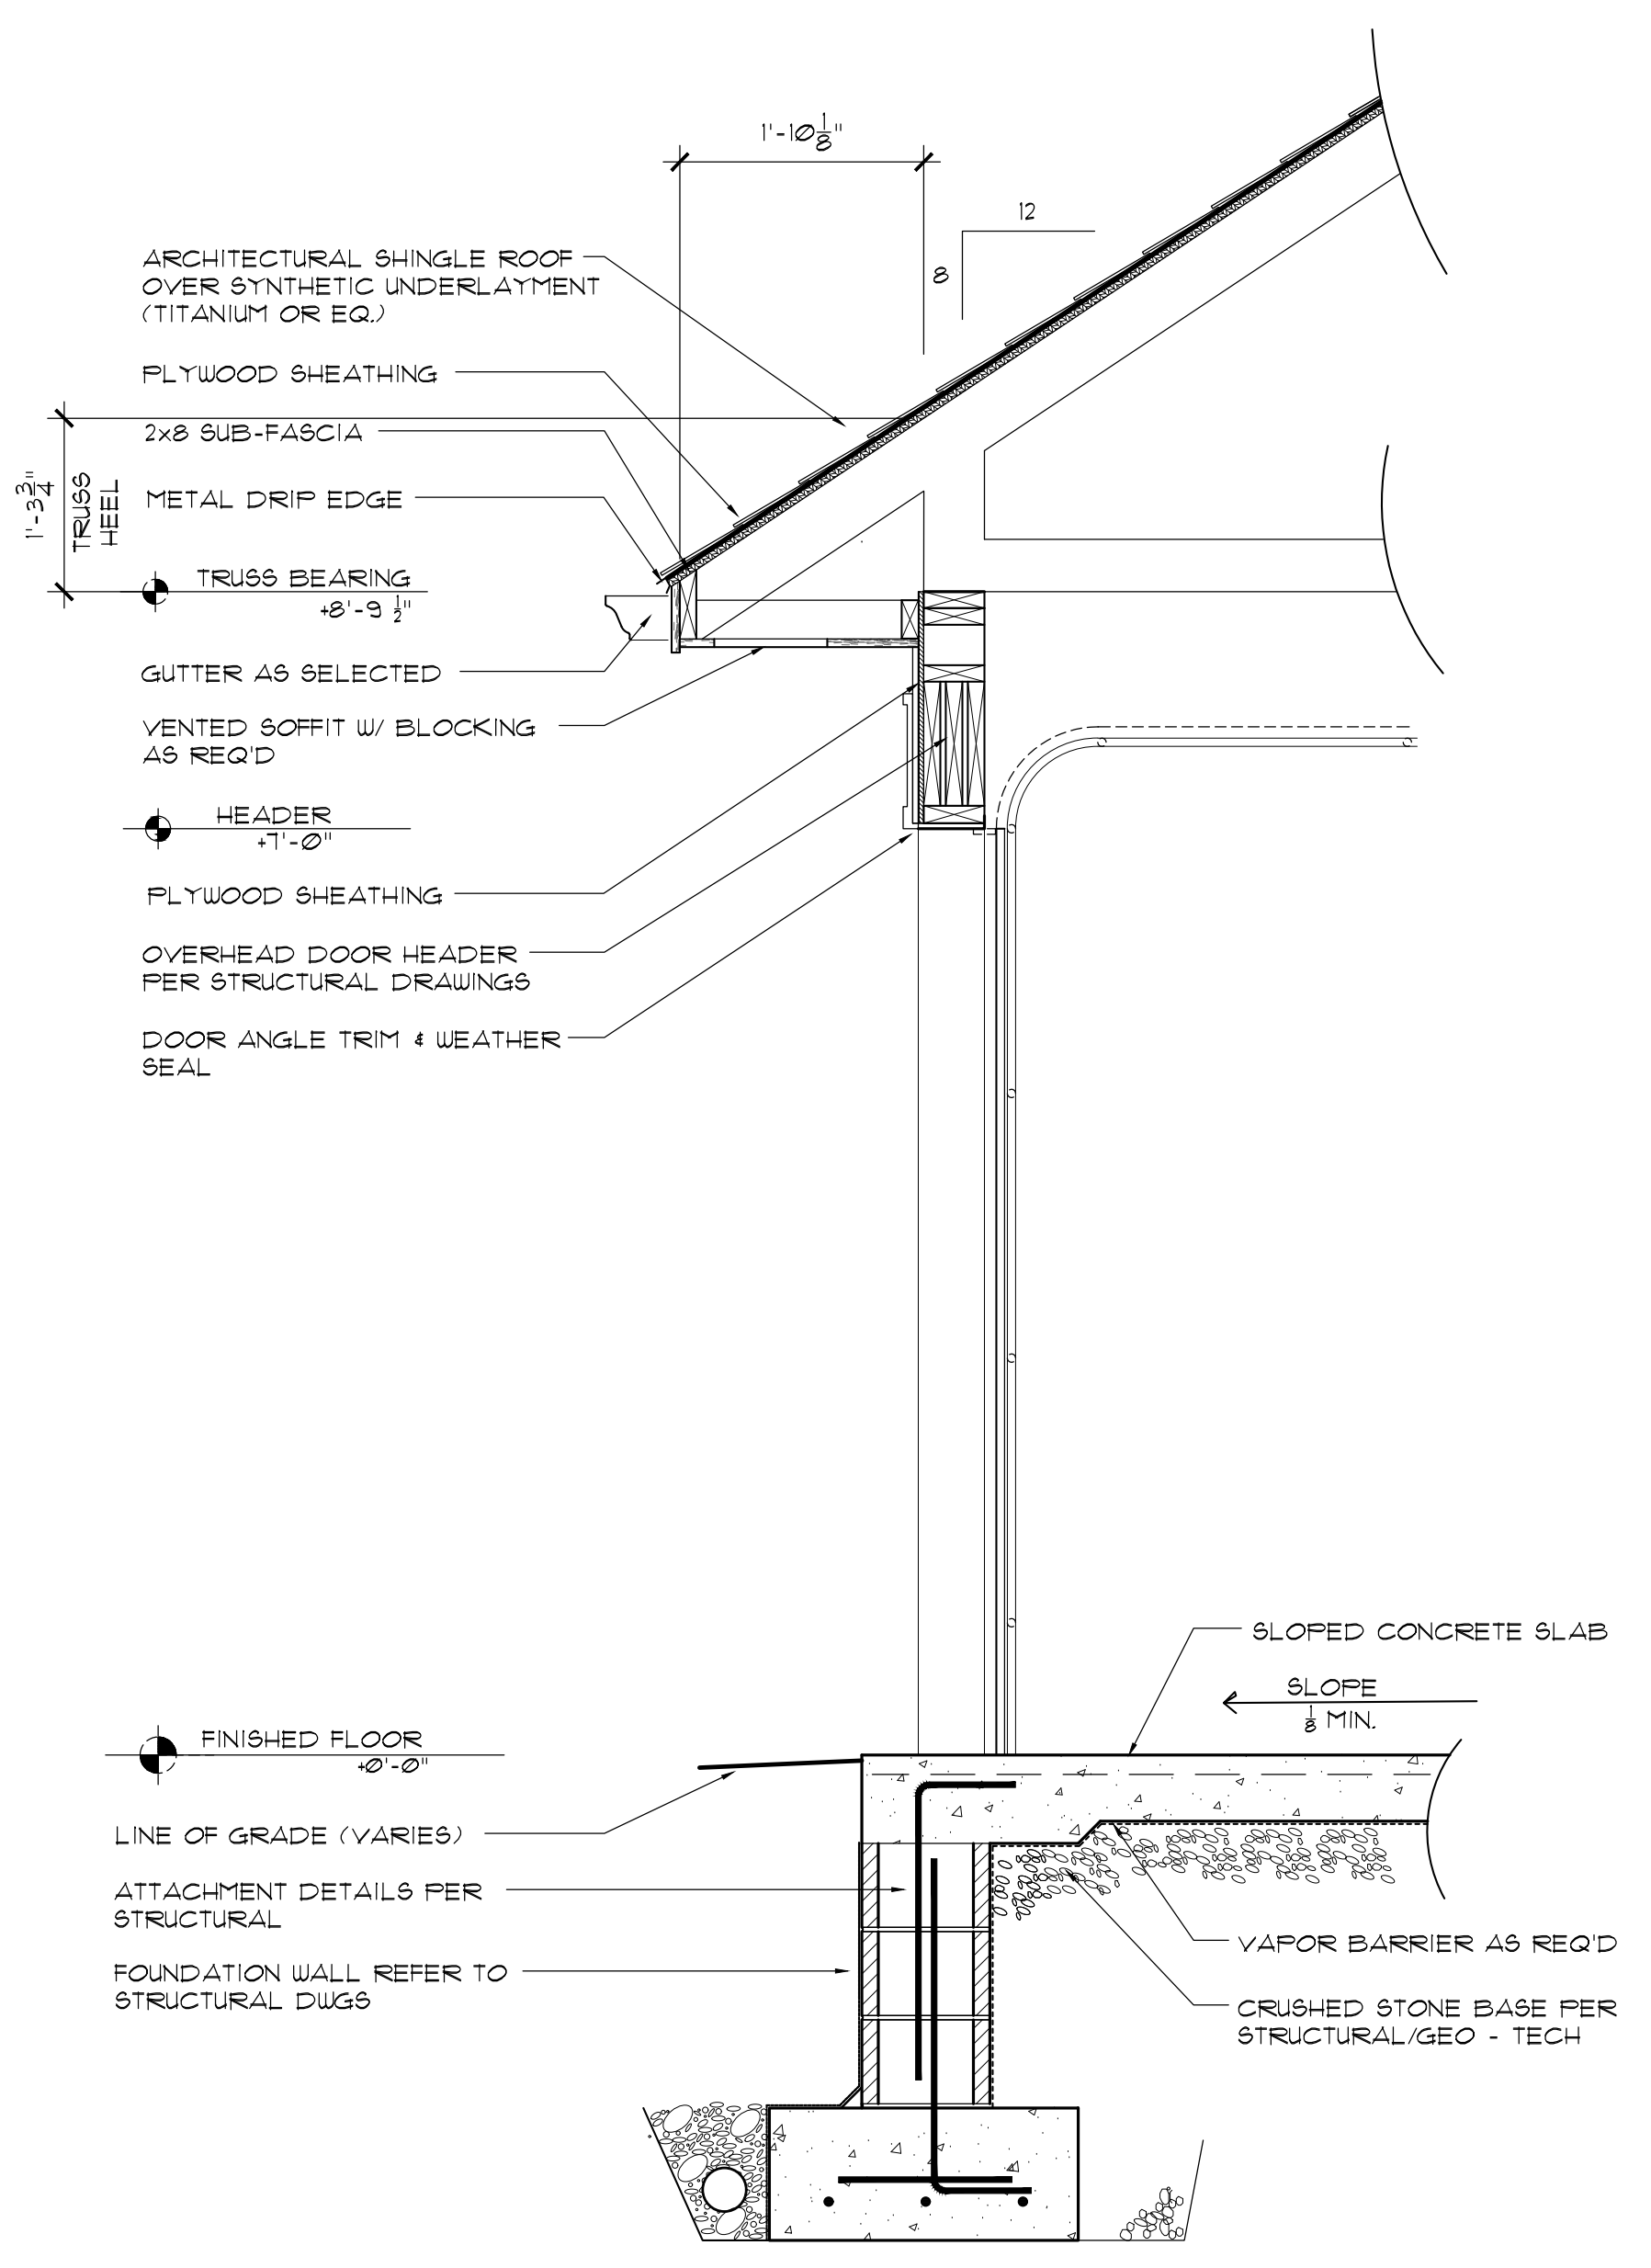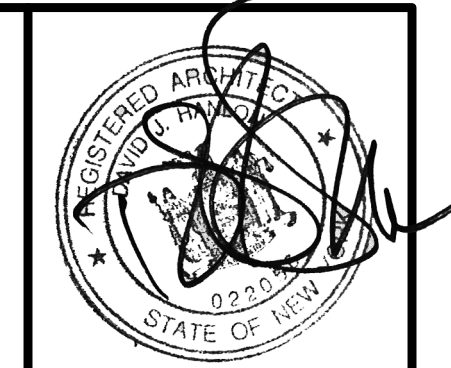


3 WALL SECTION
 SCALE: 3/4"=1'-0"

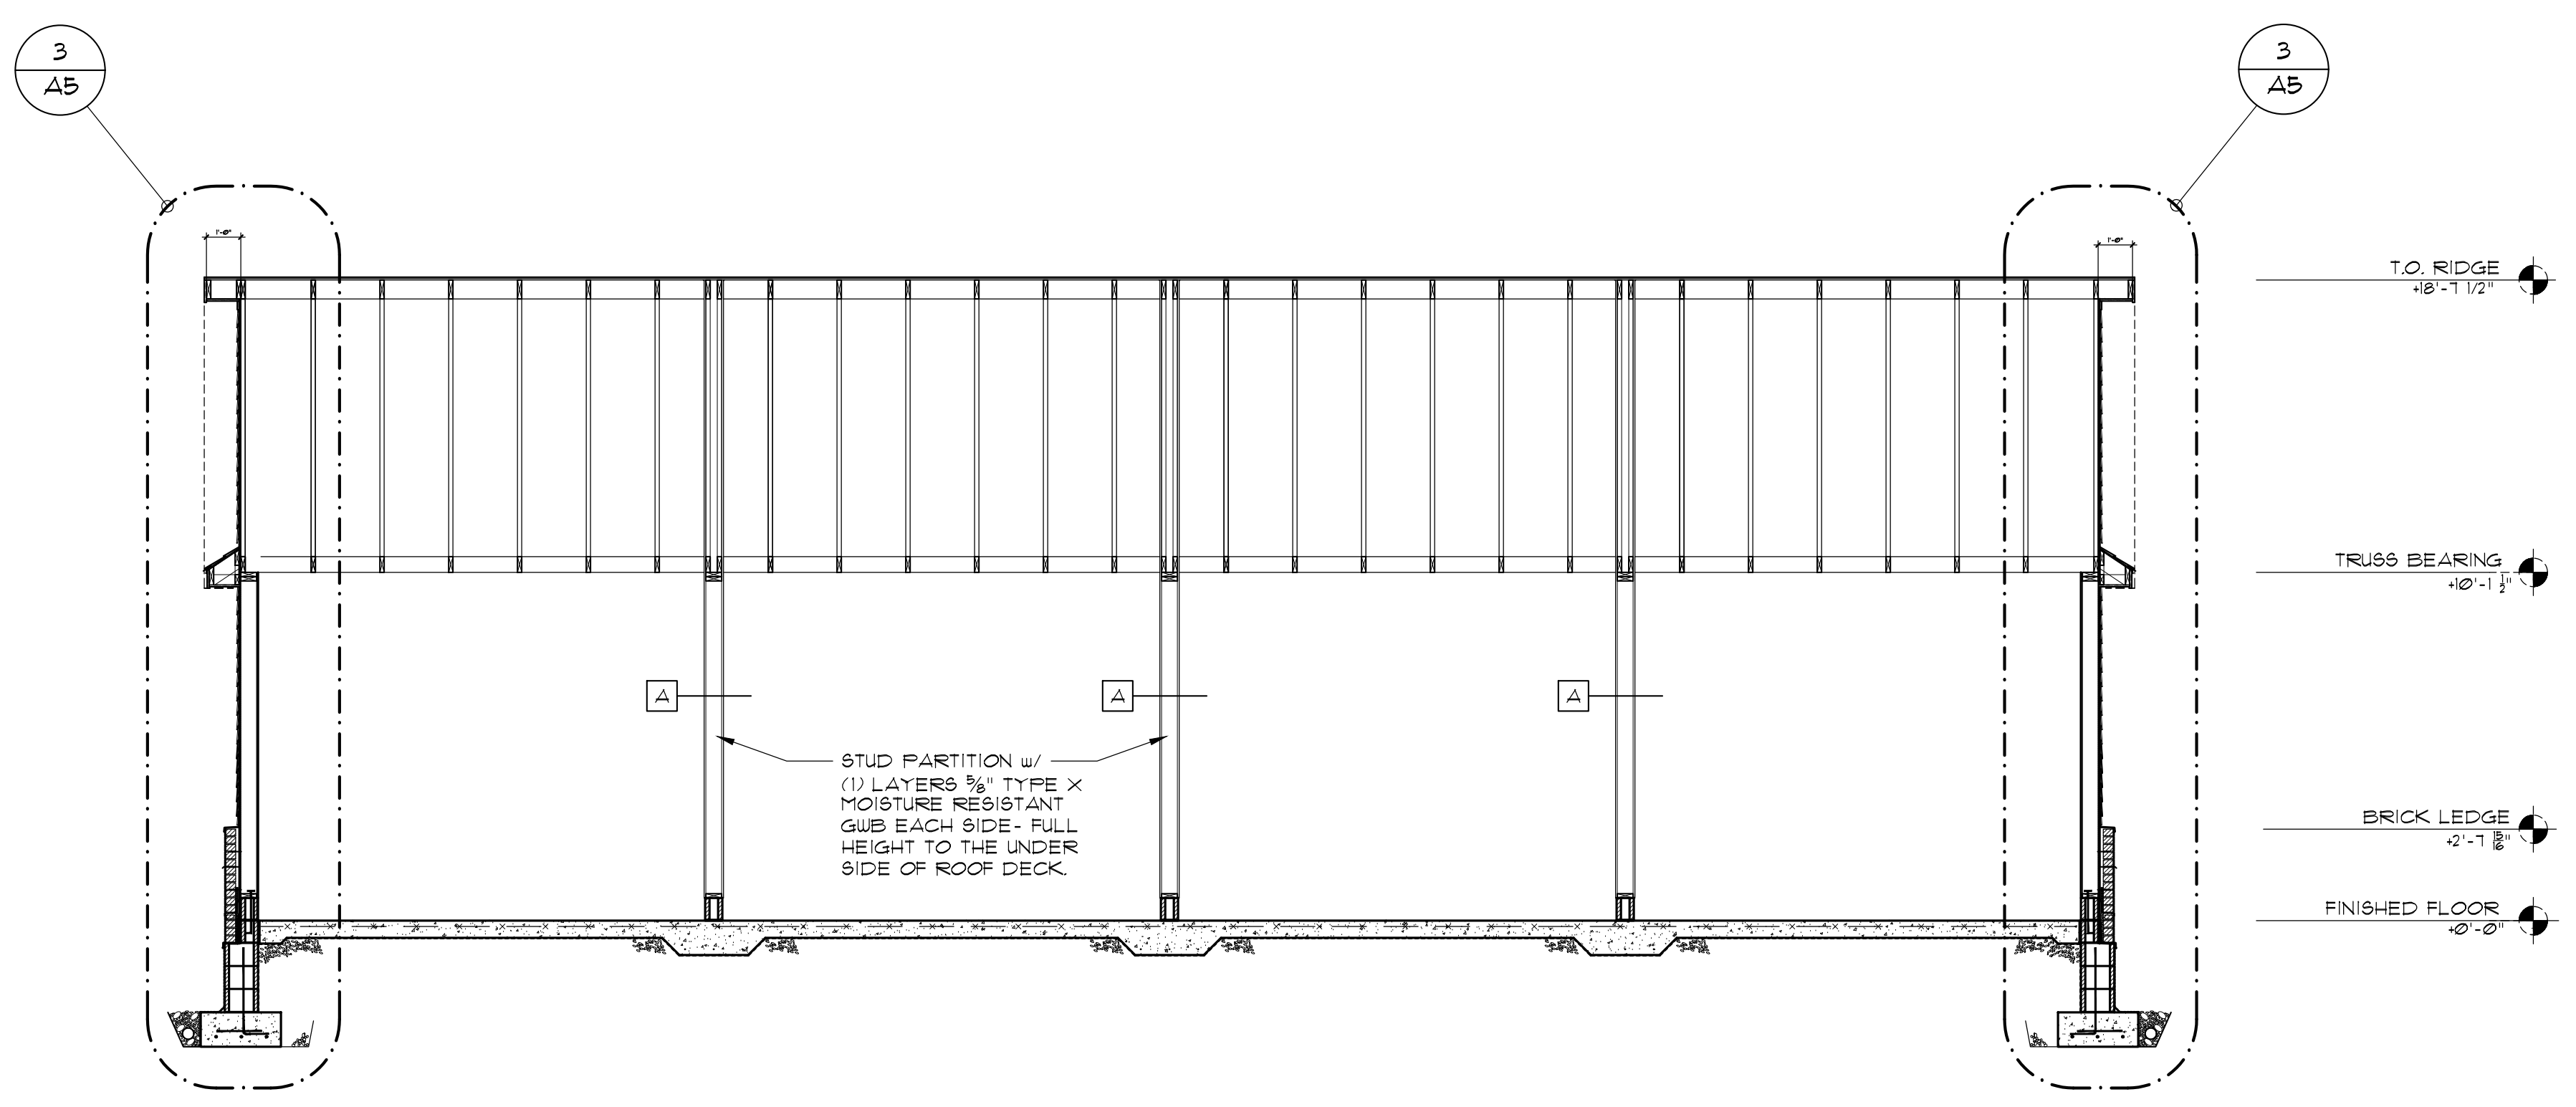

2 BUILDING SECTION
 SCALE: 1/4"=1'-0"

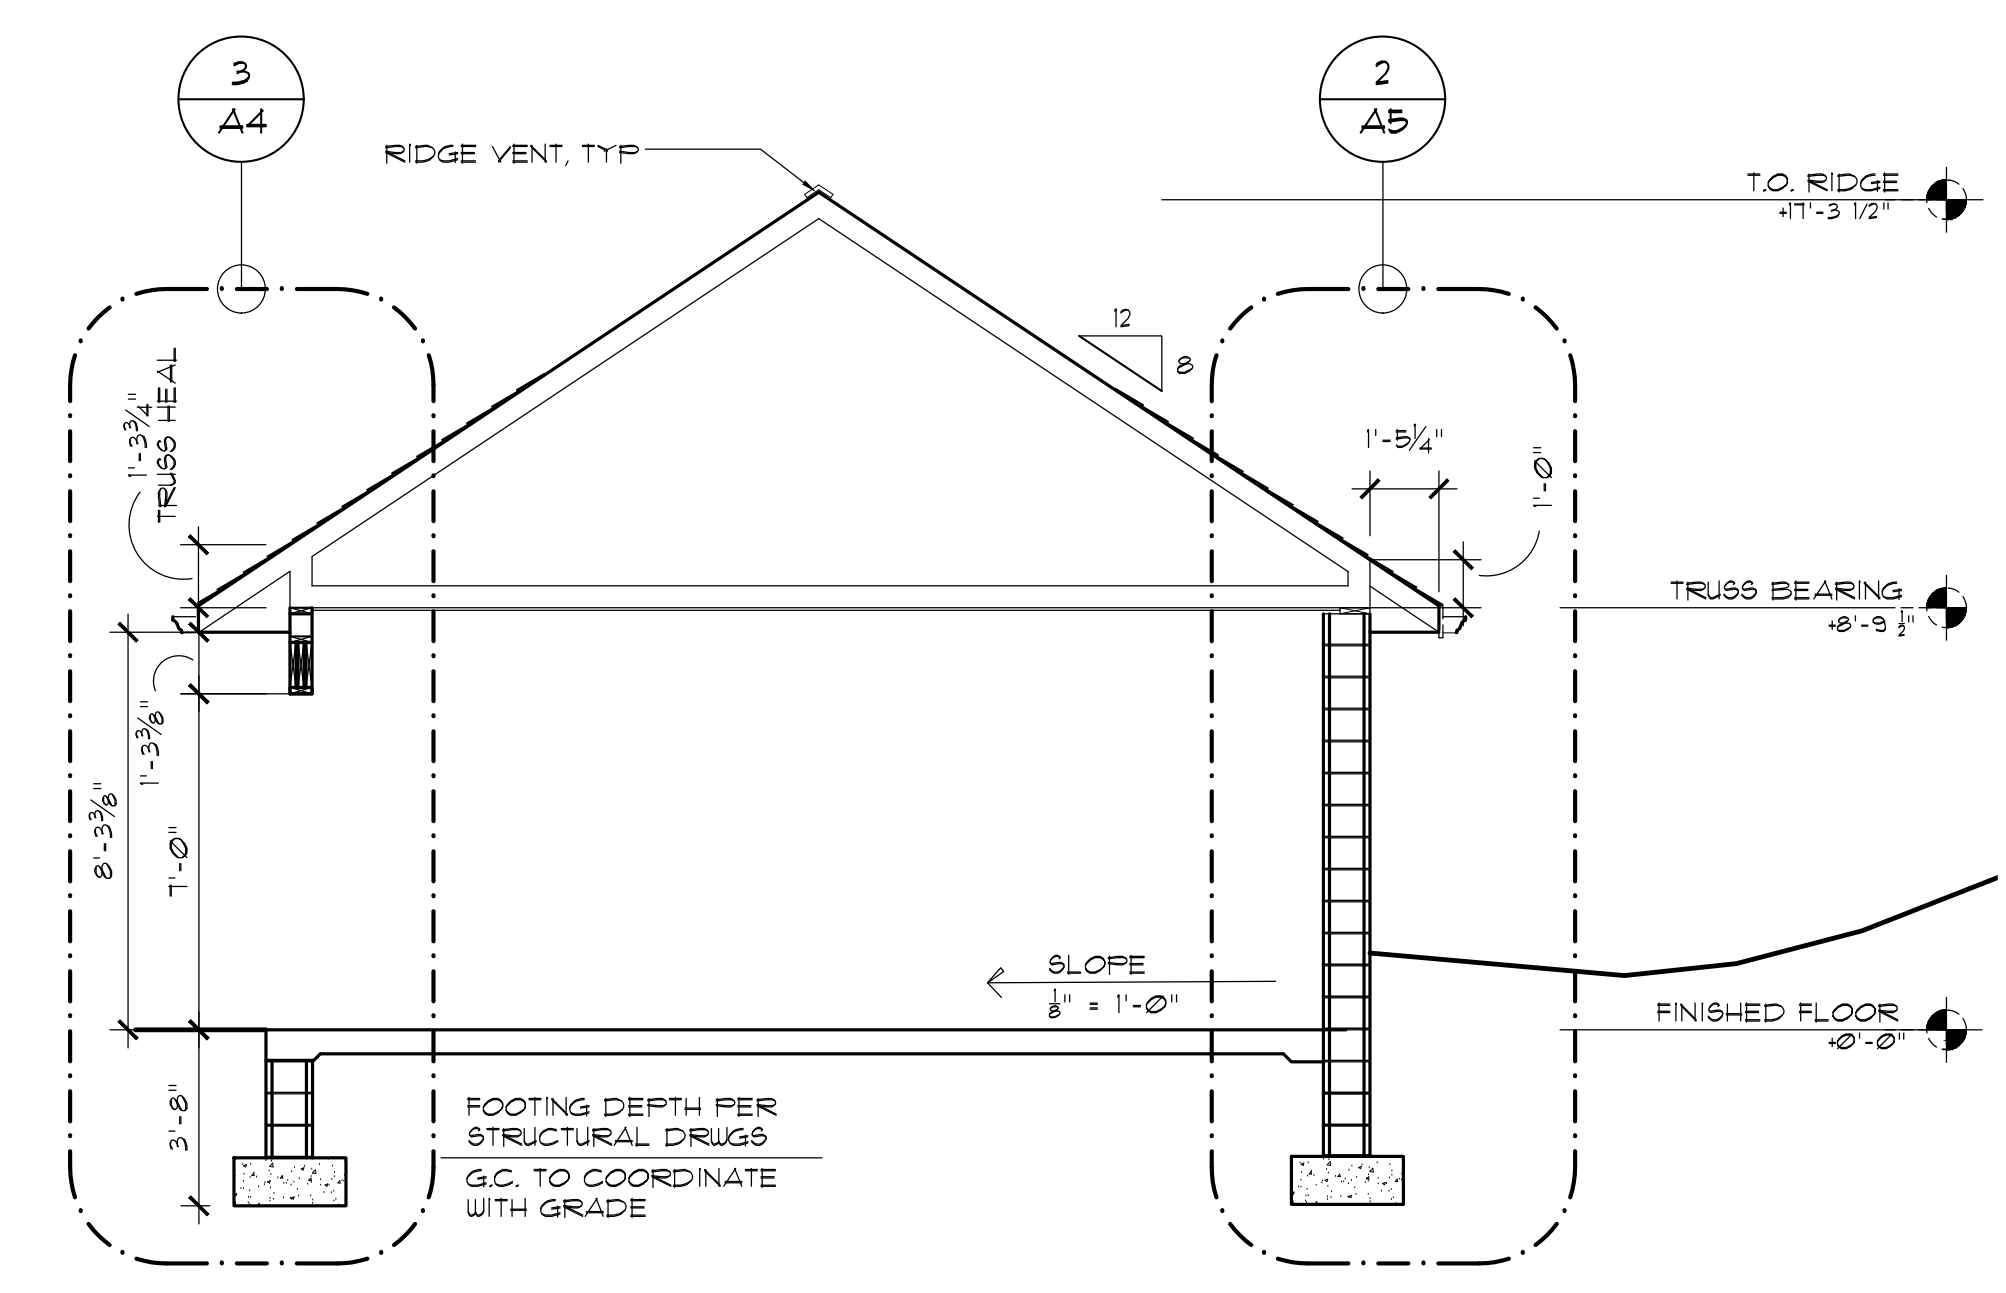


1 BUILDING SECTION
 SCALE: 1/4"=1'-0"

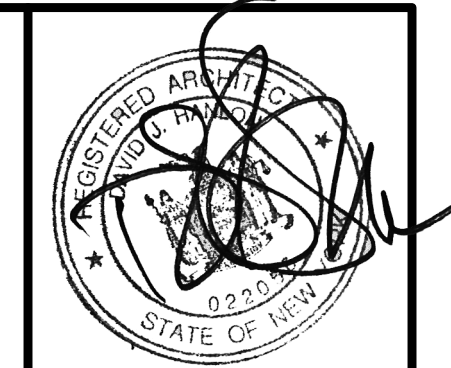


**KILBOURN PLACE APARTMENTS
 BUILDING 1 - GARAGE**
 PITTSFORD, NEW YORK

REVISED:
 ISSUED FOR PERMIT
 DATE: 6-10-22
 WALL SECTIONS


DRAWING TITLE:
A5
 SHEET NO.
 PROJECT NO: 21-226

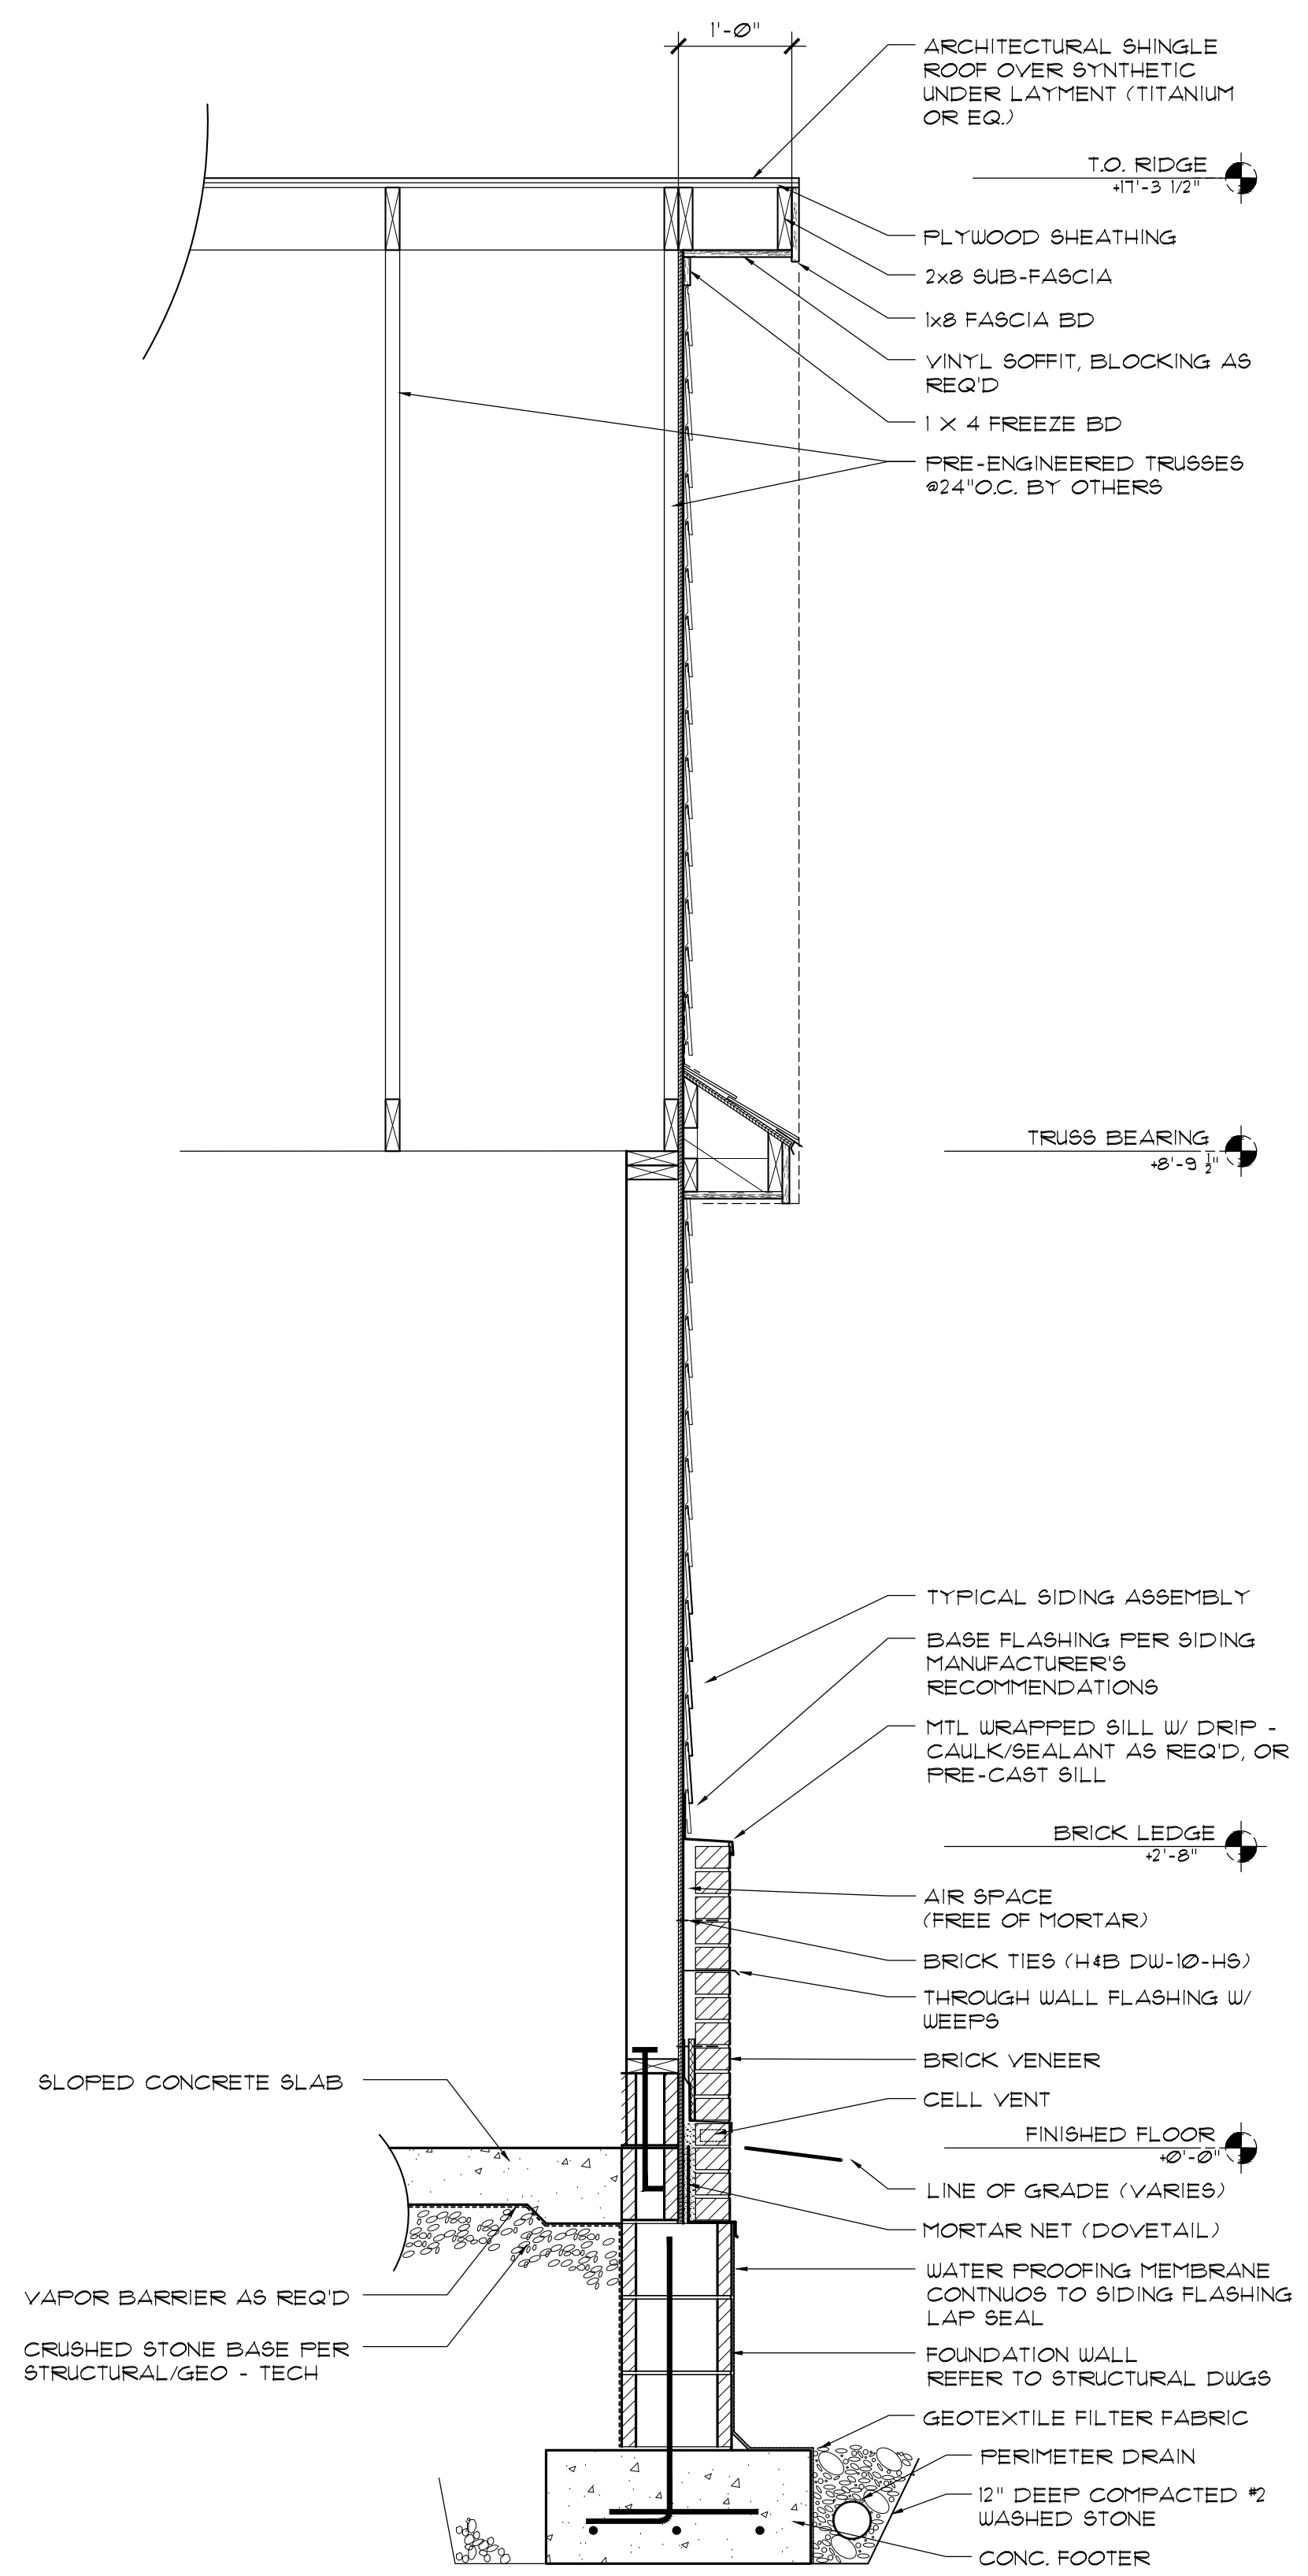

3 WALL SECTION
 SCALE: 3/4" = 1'-0"

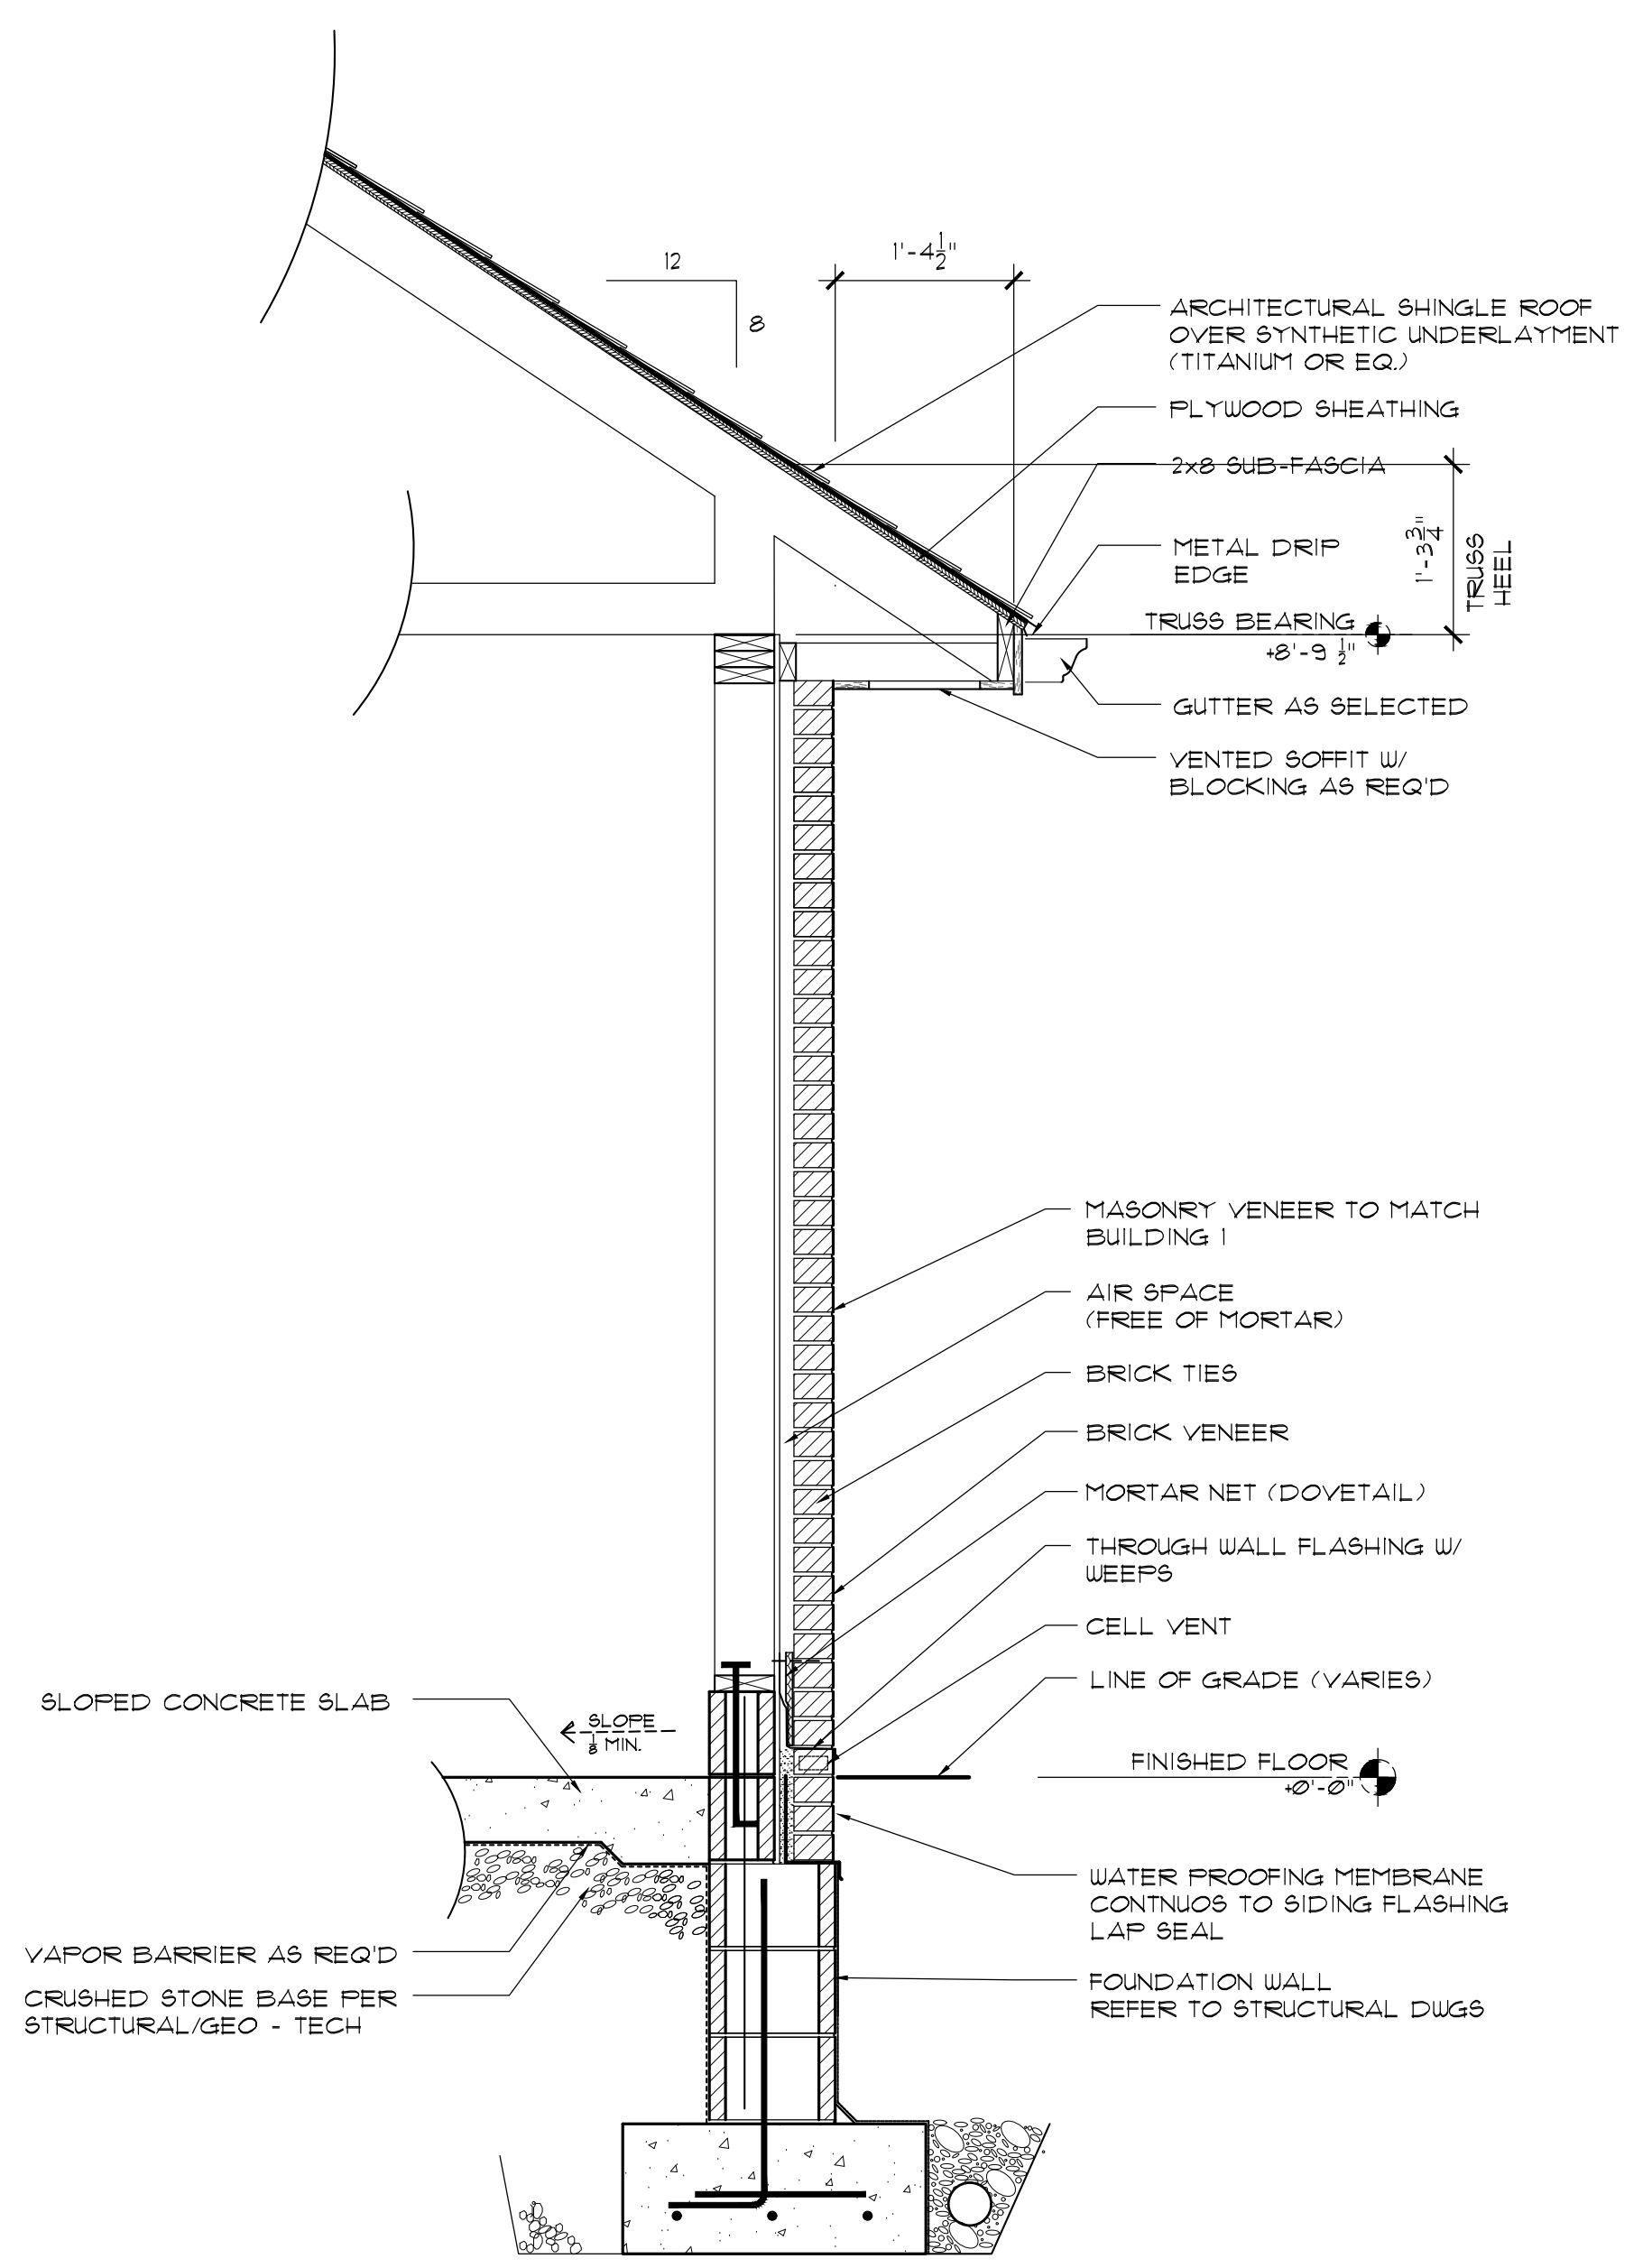

2 WALL SECTION
 SCALE: 3/4" = 1'-0"

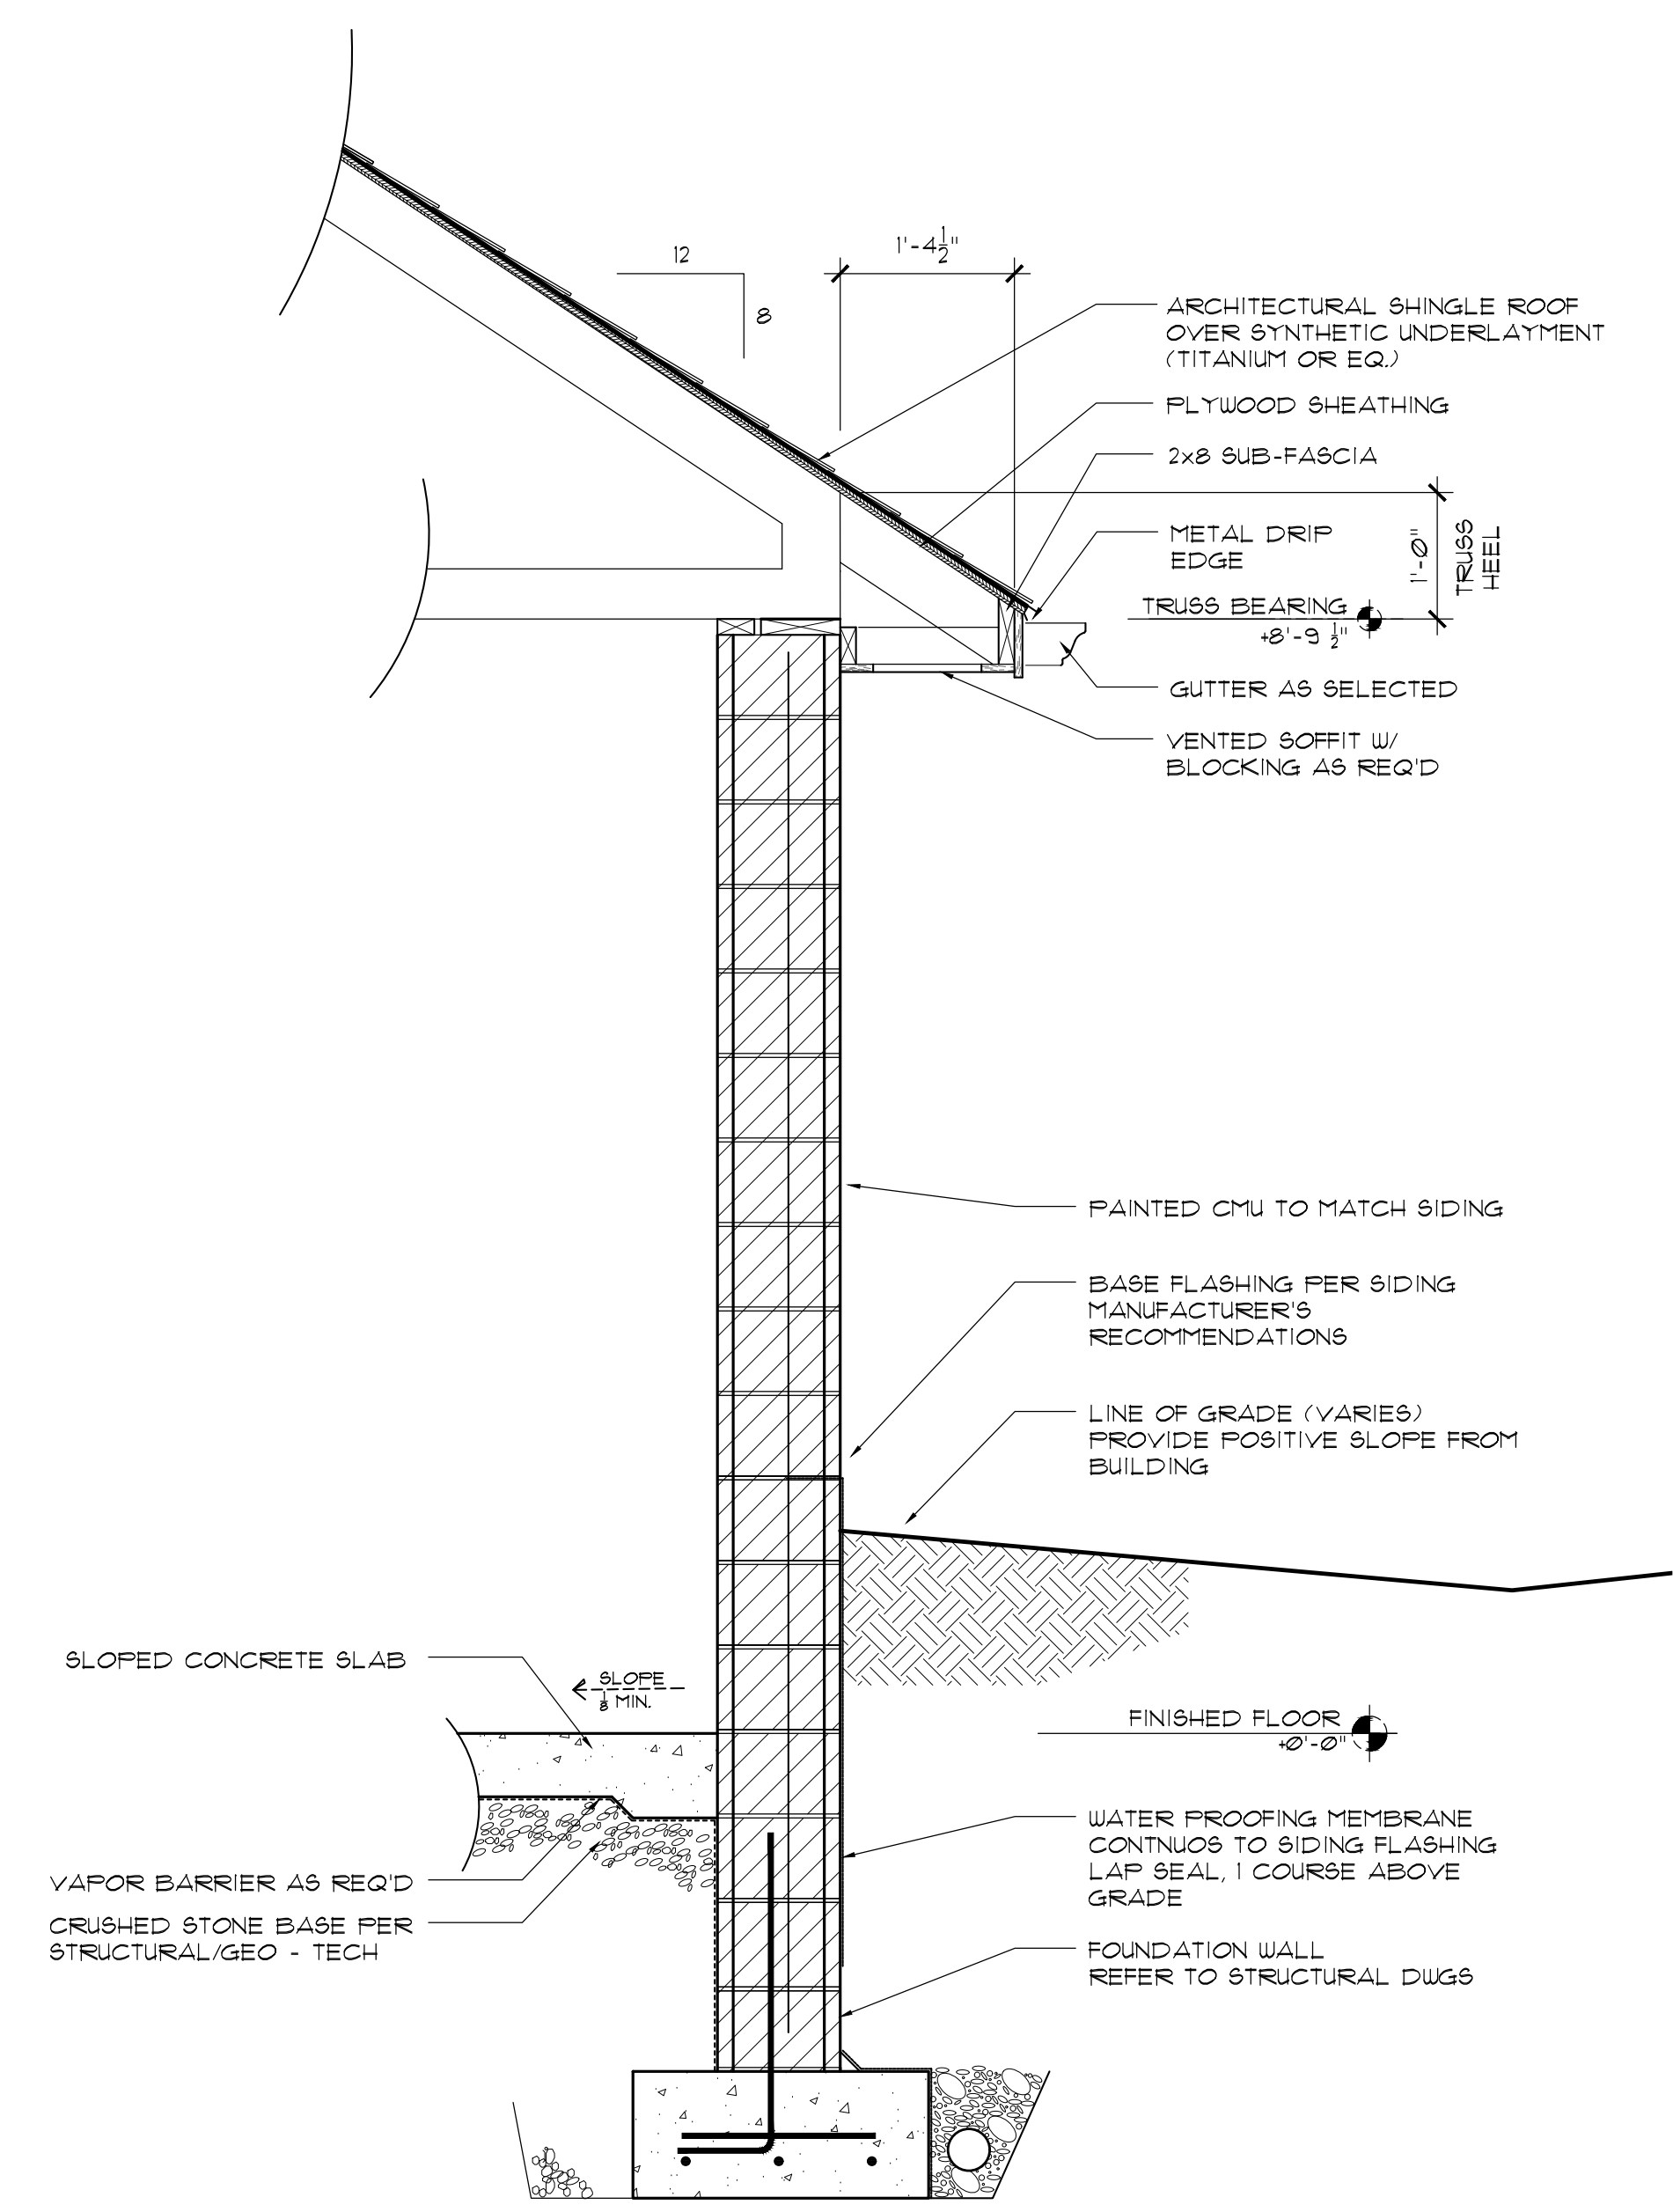

1 WALL SECTION
 SCALE: 3/4" = 1'-0"

ABBREVIATIONS

AB ANCHOR BOLT	L LENGTH/LONG
ADJ ADJACENT	LN LINEAR
AFF ABOVE FINISHED FLOOR	LH LONG LEG HORIZONTAL
ALUM ALUMINUM	LV LONG LEG VERTICAL
ALT ALTERNATE	LVG LONGitudinal
APPROX APPROXIMATELY	LOU LOWER
ARCH ARCHITECTURAL	LT LIGHT
ASPH ASPHALT	
Avg AVERAGE	
BET BETWEEN	MAS MASONRY
BIT BITUMINOUS	MAX MAXIMUM
BLDG BUILDING	MECH MECHANICAL
BLK BLOCK	MED MEDIUM
BLKG BLOCKING	MEM MEMBER
BM BEAM (BENCHMARK)	MEMB MEMBRANE
BTM (B) BOTTOM	MET METAL
BRK BRICK	MFR MANUFACTURER
BSMT BASEMENT	MNL MANHOLE
BUR BUILT-UP-ROOF	MIN MINIMUM
	MISC MISCELLANEOUS
	MO MASONRY OPENING
CB CATCH BASIN	N NORTH
CEM CEMENT	NF NEAR FACE
CF CURB FOOT (FEET)	NC NOT IN CONTRACT
CI CAST IRON	NO NUMBER
CLG CEILING	NOM NOMINAL
CLR CLEAR	NORM NORMAL
CMU CONCRETE MASONRY UNIT	NTS NOT TO SCALE
CO CLEAN OUT (COMPANY)	OC ON CENTER(S)
CSLUMY CONCRETE	OD OUTSIDE DIAMETER
CONC CONCRETE	OFF OFFICE
CONN CONNECTION	OH OVERHEAD
CONST CONSTRUCTION	OPNG OPENING
CONT CONTINUOUS	OPP OPPOSITE
CONTR CONTRACTOR	
CORR CORROD (CORRUGATED)	
COR CENTER	PART PARTITION
CY CUBIC YARD(S)	PAVT PAVEMENT
	PCC PRE CAST CONCRETE
DET DETAIL	PERF PERFORATED
DF DRINKING FOUNTAIN	PERM PERMANENT
DIA DIAMETER	PLG PLUMBING
DIAG DIAGONAL	PLWD PLYWOOD
DM DIMENSION	PSF POUNDS PER SQUARE FOOT
DN DOWN	PSI POUNDS PER SQUARE INCH
DS DOWN SPOUT	PVC POLYVINYL CHLORIDE
DWG DRAWING	
DWL DOWEL	
E EAST	RAD RADIUS
EA EACH	RDF ROOF DRAIN
EC EPOXY COATED	REF REFERENCE
EF EACH FACE	REFR REINFORCED, (ING)
EL ELEVATION	REQ REQUIRED
ELEC ELECTRICAL	REV REVISIONS, REVISED
ELEV ELEVATOR	RO ROUGH OPENING
EQ EQUAL	ROW RIGHT-OF-WAY
EQUIP EQUIPMENT	
EST ESTIMATED	S SOUTH
ETR EXISTING TO REMAIN	S/S STAINLESS STEEL
EW EACH WAY	SAN SANITARY
EXST EXISTING	SCH SCHEDULE
EXP EXPANSION (EXPAND)	SEC SECTION
EXT EXTERIOR	SF SQUARE FOOT (FEET)
	SIM SIMILAR
FDN FOUNDATION	SPEC SPECIFICATION(S)
FF FINISHED FLOOR	SQ SQUARE
FIN FINISH	ST STREET
FLSH FLASHING	STD STANDARD
FLEX FLEXIBLE	STR STRUCTURE(AL)
FLX FLOORING	SQY SQUARE YARD
FCC FACE OF CONCRETE	SY SYMMETRY(CAL)
FOM FACE OF MASONRY	
FW FACE OF WALL	T TREAD (TOP)
FP FIRE PROTECTION	T&G TONGUE AND GROOVE
FT FOOT OR FEET	TEMP TEMPORARY
FTG FOOTING	THK THICK
FUT FUTURE	TRANS TRANSVERSE
	TYP TYPICAL
GA GAUGE	UNEX UNEXCAVATED
GALV GALVANIZED	UNO UNLESS NOTED OTHERWISE
GEN GENERAL CONTRACTOR	VAR VARIES(ABLE)
GEN GENERAL	VERT VERTICAL
OSB OSBUM WALL BOARD	
	W WEST (WIDE)
HB HOSE BIB	W/ WITH
HC HOLLOW CORE	W/O WITHOUT
HCP HANDICAPPED	W/ WATERPROOFED(ING)
HDR HEADER	WT WEIGHT
HGT HEIGHT	WV WELDED WIRE FABRIC
HM HOLLOW METAL	
HOR HORIZONTAL	
HVAC HEATING/VENTILATING/ AIR CONDITIONING	
	AND
ID INSIDE DIAMETER	Ø DIAMETER OR ROUND
IN INCH OR INCHES	PERCENT
INSUL INSULATE(D),(ION)	ANGLE
INT INTERIOR	CENTERLINE
INV INVERT	NUMBER (BEFORE), POUND (AFTER)
JT JOIST	PROPERTY LINE

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ANSI A117.1-2003

COMPLIANCE NOTE:
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David J. Hanlon
David J. Hanlon

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PROPOSED HEIGHT: 10'-7" / 1 stories

BUILDING AREA: (506)
ALLOWABLE AREA (TABLE 506.2): 9,000 SQ. FT. (NON-SPRINKLERED)
PROPOSED BUILDING AREA: 1,240 SQ. FT (OVERALL BUILDING)

CONSTRUCTION TYPE CLASSIFICATION: VB CONSTRUCTION (602)

FIRE ALARMS: (901)
AUTOMATIC SMOKE OR AUTOMATIC HEAT DETECTION SHALL BE REQUIRED PER CODE SECTION (NYSBC) 901.2 FINAL DRAWINGS SHALL BE PROVIDED UNDER SEPARATE COVER, AND PRIOR TO COMMENCEMENT OF SCOPE OF WORK.

KILBOURN PLACE 6-BAY GARAGES

PITTSFORD, NY


ENERGY CODE COMPLIANCE:

THE ENERGY CODE COMPLIANCE FOR THE GARAGE BUILDING @ KILBOURN PLACE APARTMENTS IS NOT APPLICABLE BECAUSE IT IS AN UNCONDITIONED SPACE

LIST OF DRAWINGS:

- C1 COVER SHEET
- A1 FLOOR PLAN
- A2 REFLECTED CEILING PLAN
- A3 BLDG ELEVATIONS
- A4 BLDG SECTIONS
- A5 WALL SECTIONS

TRUSS IDENTIFICATION SIGNAGE:

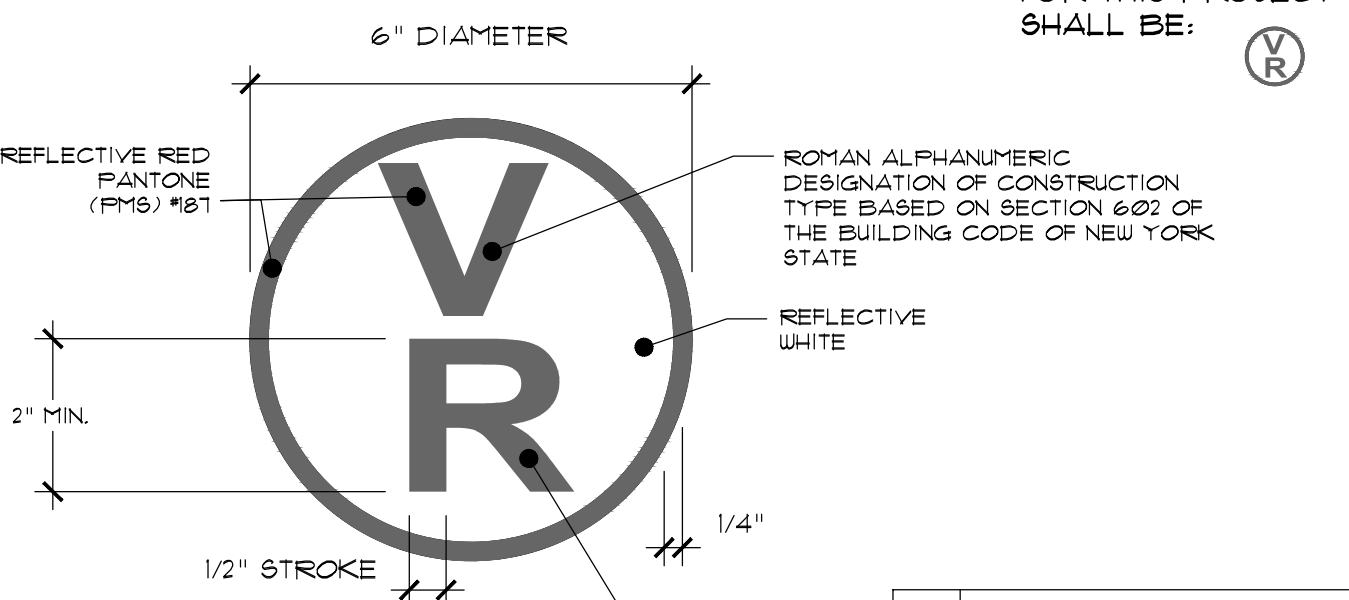


REQUIRED SIGNAGE FOR THIS PROJECT SHALL BE:




'F'	FLOOR FRAMING, INCLUDING GIRDERS AND BEAMS
'R'	ROOF FRAMING
'FR'	FLOOR AND ROOF FRAMING

SIGN LOCATION	SIGN PLACEMENT
EXTERIOR BUILDING ENTRANCE DOORS, EXTERIOR EXIT DISCHARGE DOORS, AND EXTERIOR ROOF ACCESS DOORS TO A STAIRWAY	ATTACHED TO THE DOOR OR ATTACHED TO A SIDELIGHT OR THE FACE OF THE BUILDING, NOT MORE THAN 12 INCHES (305 MM) HORIZONTALLY FROM THE LATCH SIDE OF THE DOOR JAMB, AND NOT LESS THAN 42 INCHES (1067 MM) NOR MORE THAN 60 INCHES (1524 MM) ABOVE THE ADJOINING WALKING SURFACE.
MULTIPLE CONTIGUOUS EXTERIOR BUILDING ENTRANCE OR EXIT DISCHARGE DOORS	ATTACHED AT EACH END OF THE ROW OF DOORS AND AT A MAXIMUM HORIZONTAL DISTANCE OF 12 FEET (3.65M) BETWEEN SIGNS, AND NOT LESS THAN 42 INCHES (1067 MM) NOR MORE THAN 60 INCHES (1524 MM) ABOVE THE ADJOINING WALKING SURFACE
FIRE DEPARTMENT HOSE CONNECTIONS	ATTACHED TO THE FACE OF THE BUILDING, NOT MORE THAN 12 INCHES (305 MM) HORIZONTALLY FROM THE CENTER LINE OF THE FIRE DEPARTMENT HOSE CONNECTION, AND NOT LESS THAN 42 INCHES (1067 MM) NOR MORE THAN 60 INCHES (1524 MM) ABOVE THE ADJOINING WALKING SURFACE

LOCATION OF PROPOSED GARAGES

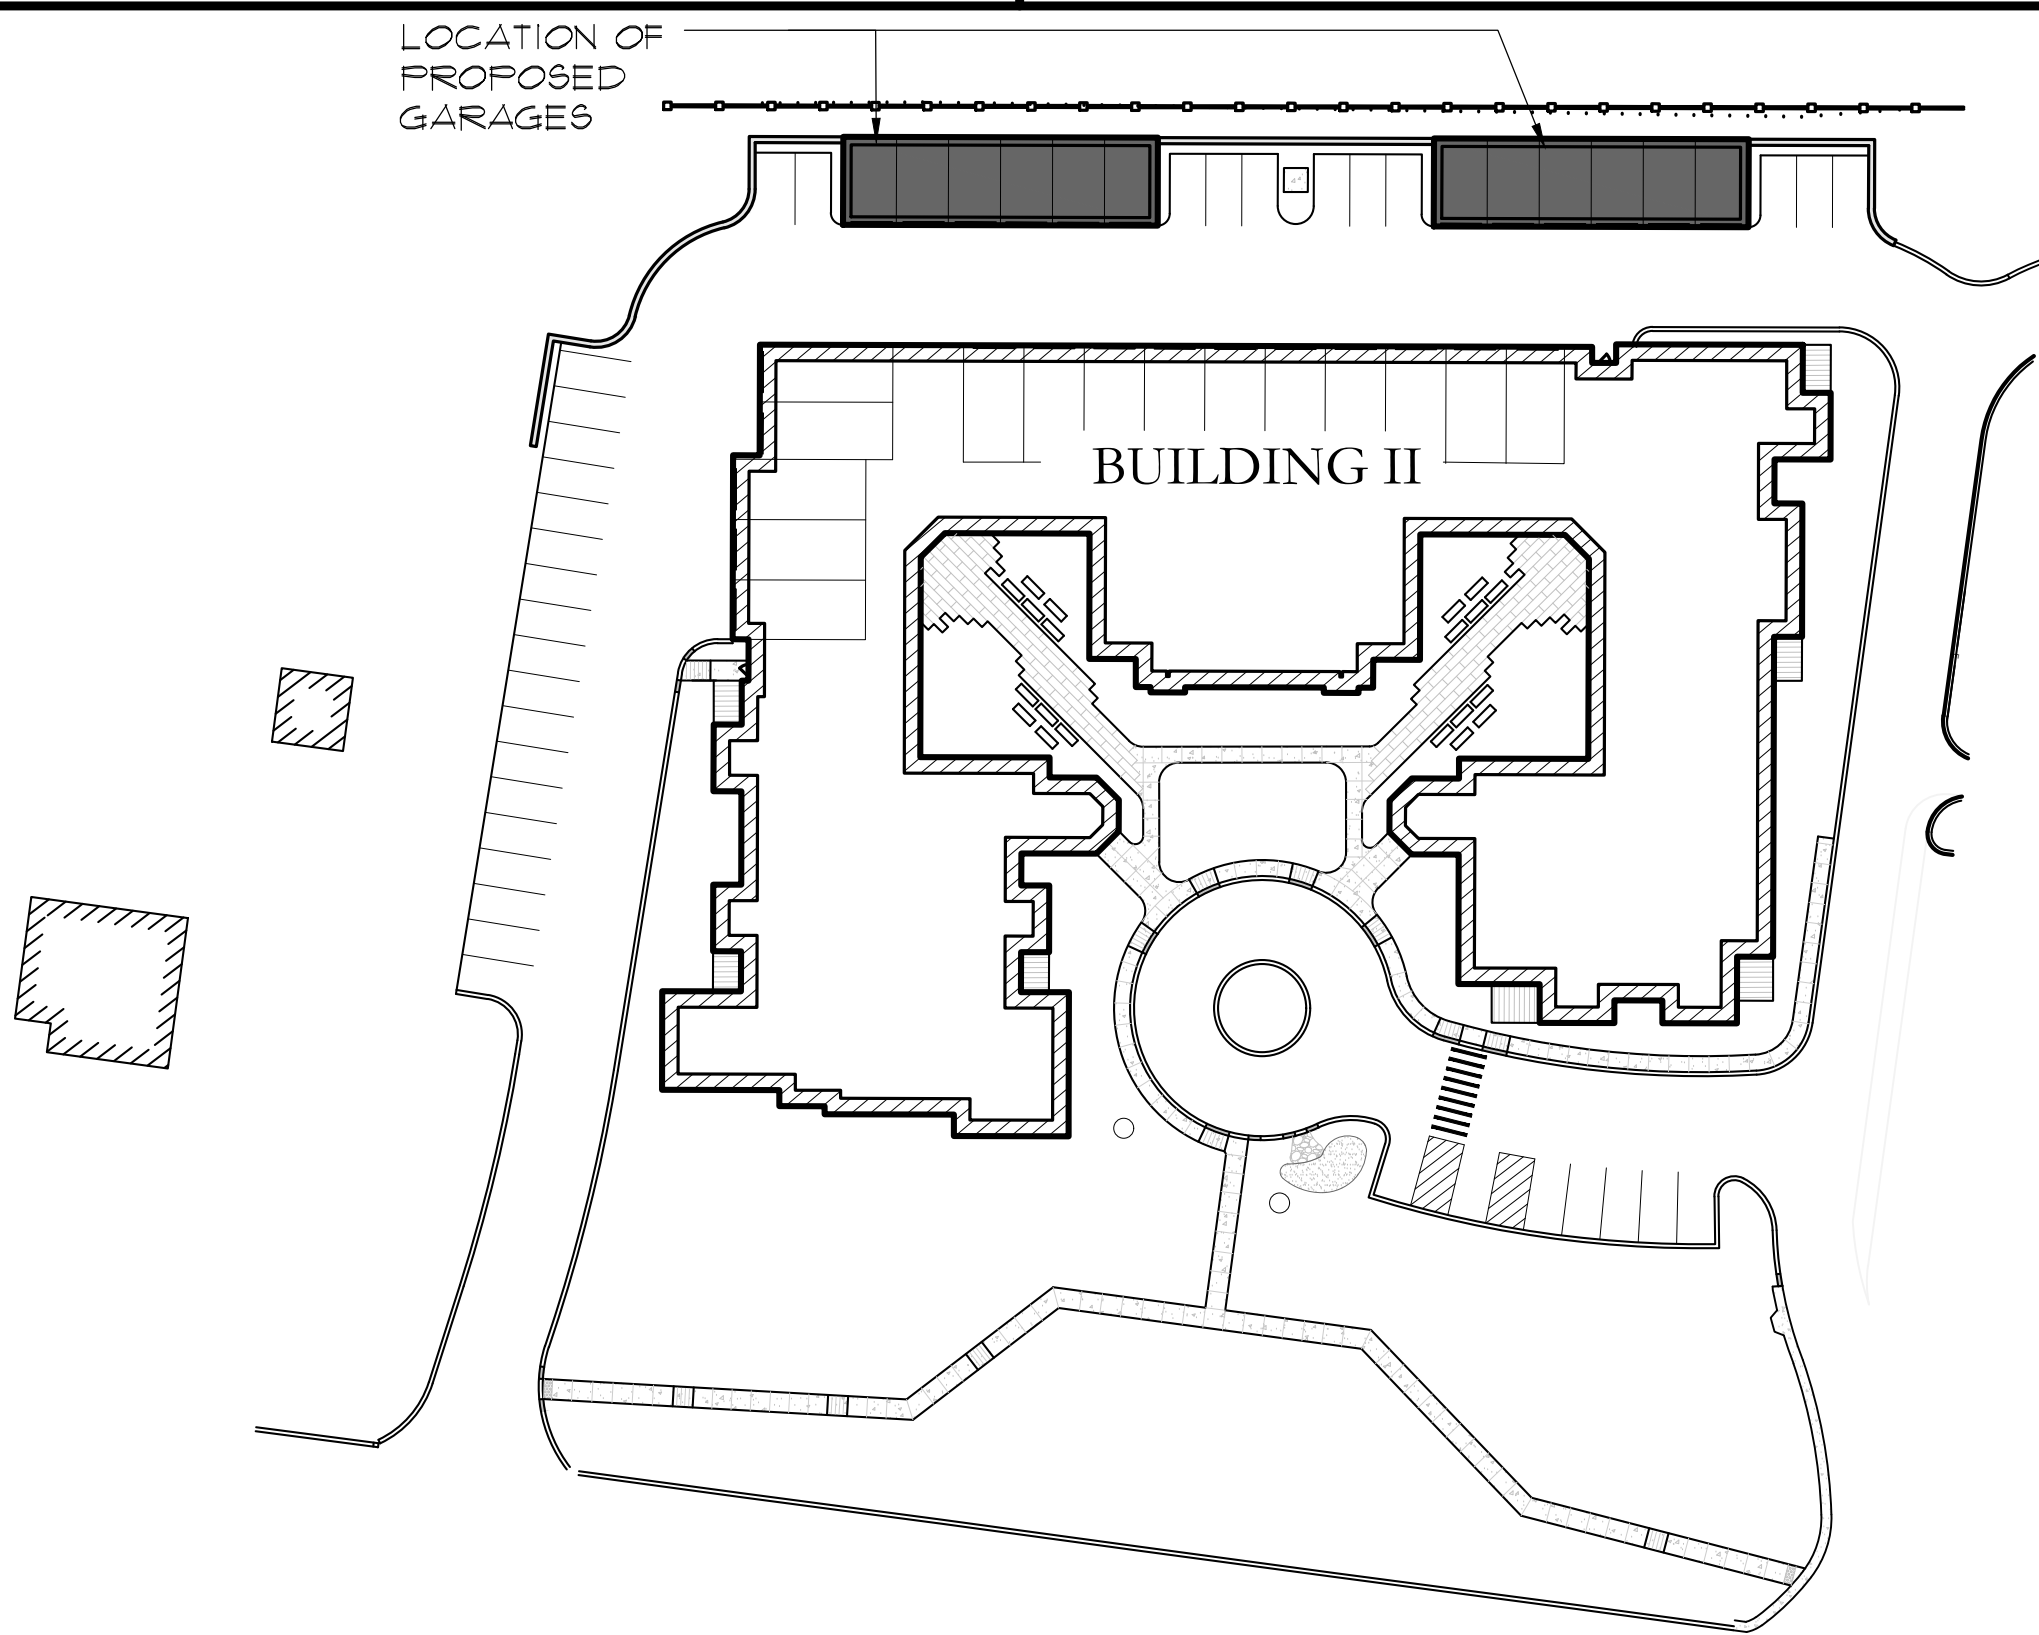

KEY PLAN
SCALE: 1/8"=1'-0"

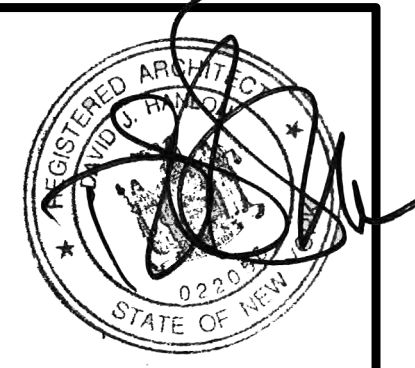

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**KILBOURN PLACE APARTMENTS
BUILDING 2 - GARAGE**
PITTSFORD, NEW YORK

REVISION:
ISSUED FOR PERMIT
DATE: 6-17-22


COVER SHEET

DRAWING TITLE:

C1

SHEET NO:

PROJECT NO: 21-226

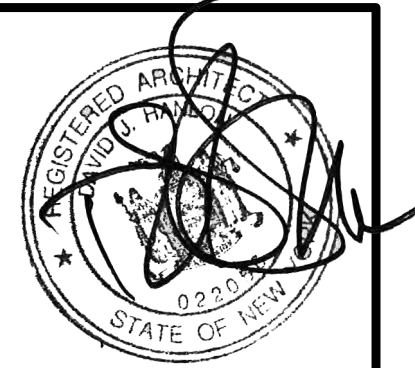


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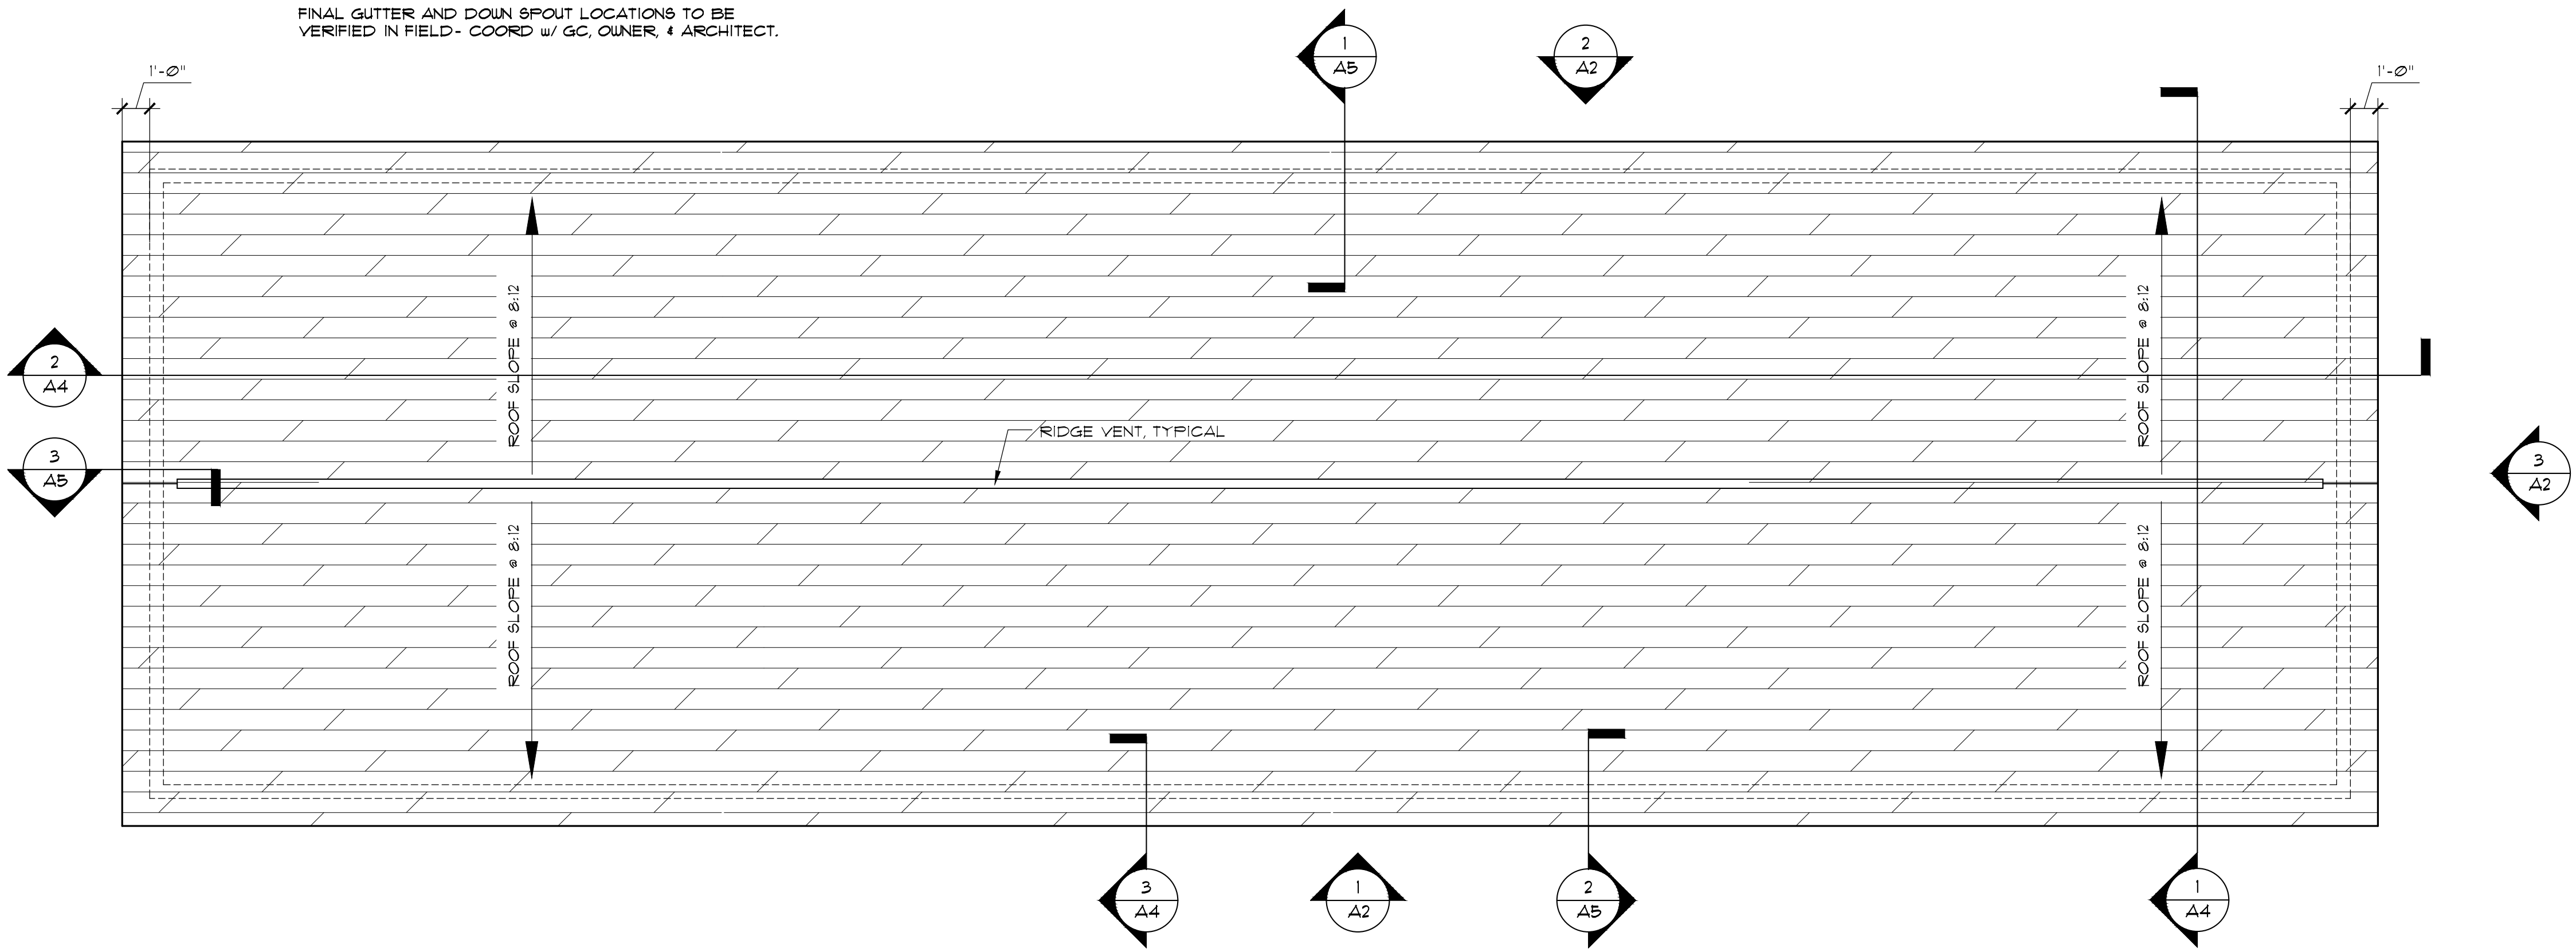
**KILBOURN PLACE APARTMENTS
 BUILDING 2 - GARAGE**
 PITTSFORD, NEW YORK

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 FLOOR & ROOF PLAN
 DRAWING TITLE:
 SHEET NO. **A1**
 PROJECT NO. 21-226

UNLESS NOTED OTHERWISE:
 UNLESS NOTED OTHERWISE, ROOF FRAMING SHALL BE ENGINEERED WOOD ROOF TRUSSES. COORDINATE W/ STRUCTURAL ENGINEER & TRUSS SUPPLIER ALL FINAL TRUSS DETAILS, SHAPES, AND DESIGN LOAD REQUIREMENTS.
 FINAL GUTTER AND DOWN SPOUT LOCATIONS TO BE VERIFIED IN FIELD- COORD W/ GC, OWNER, & ARCHITECT.

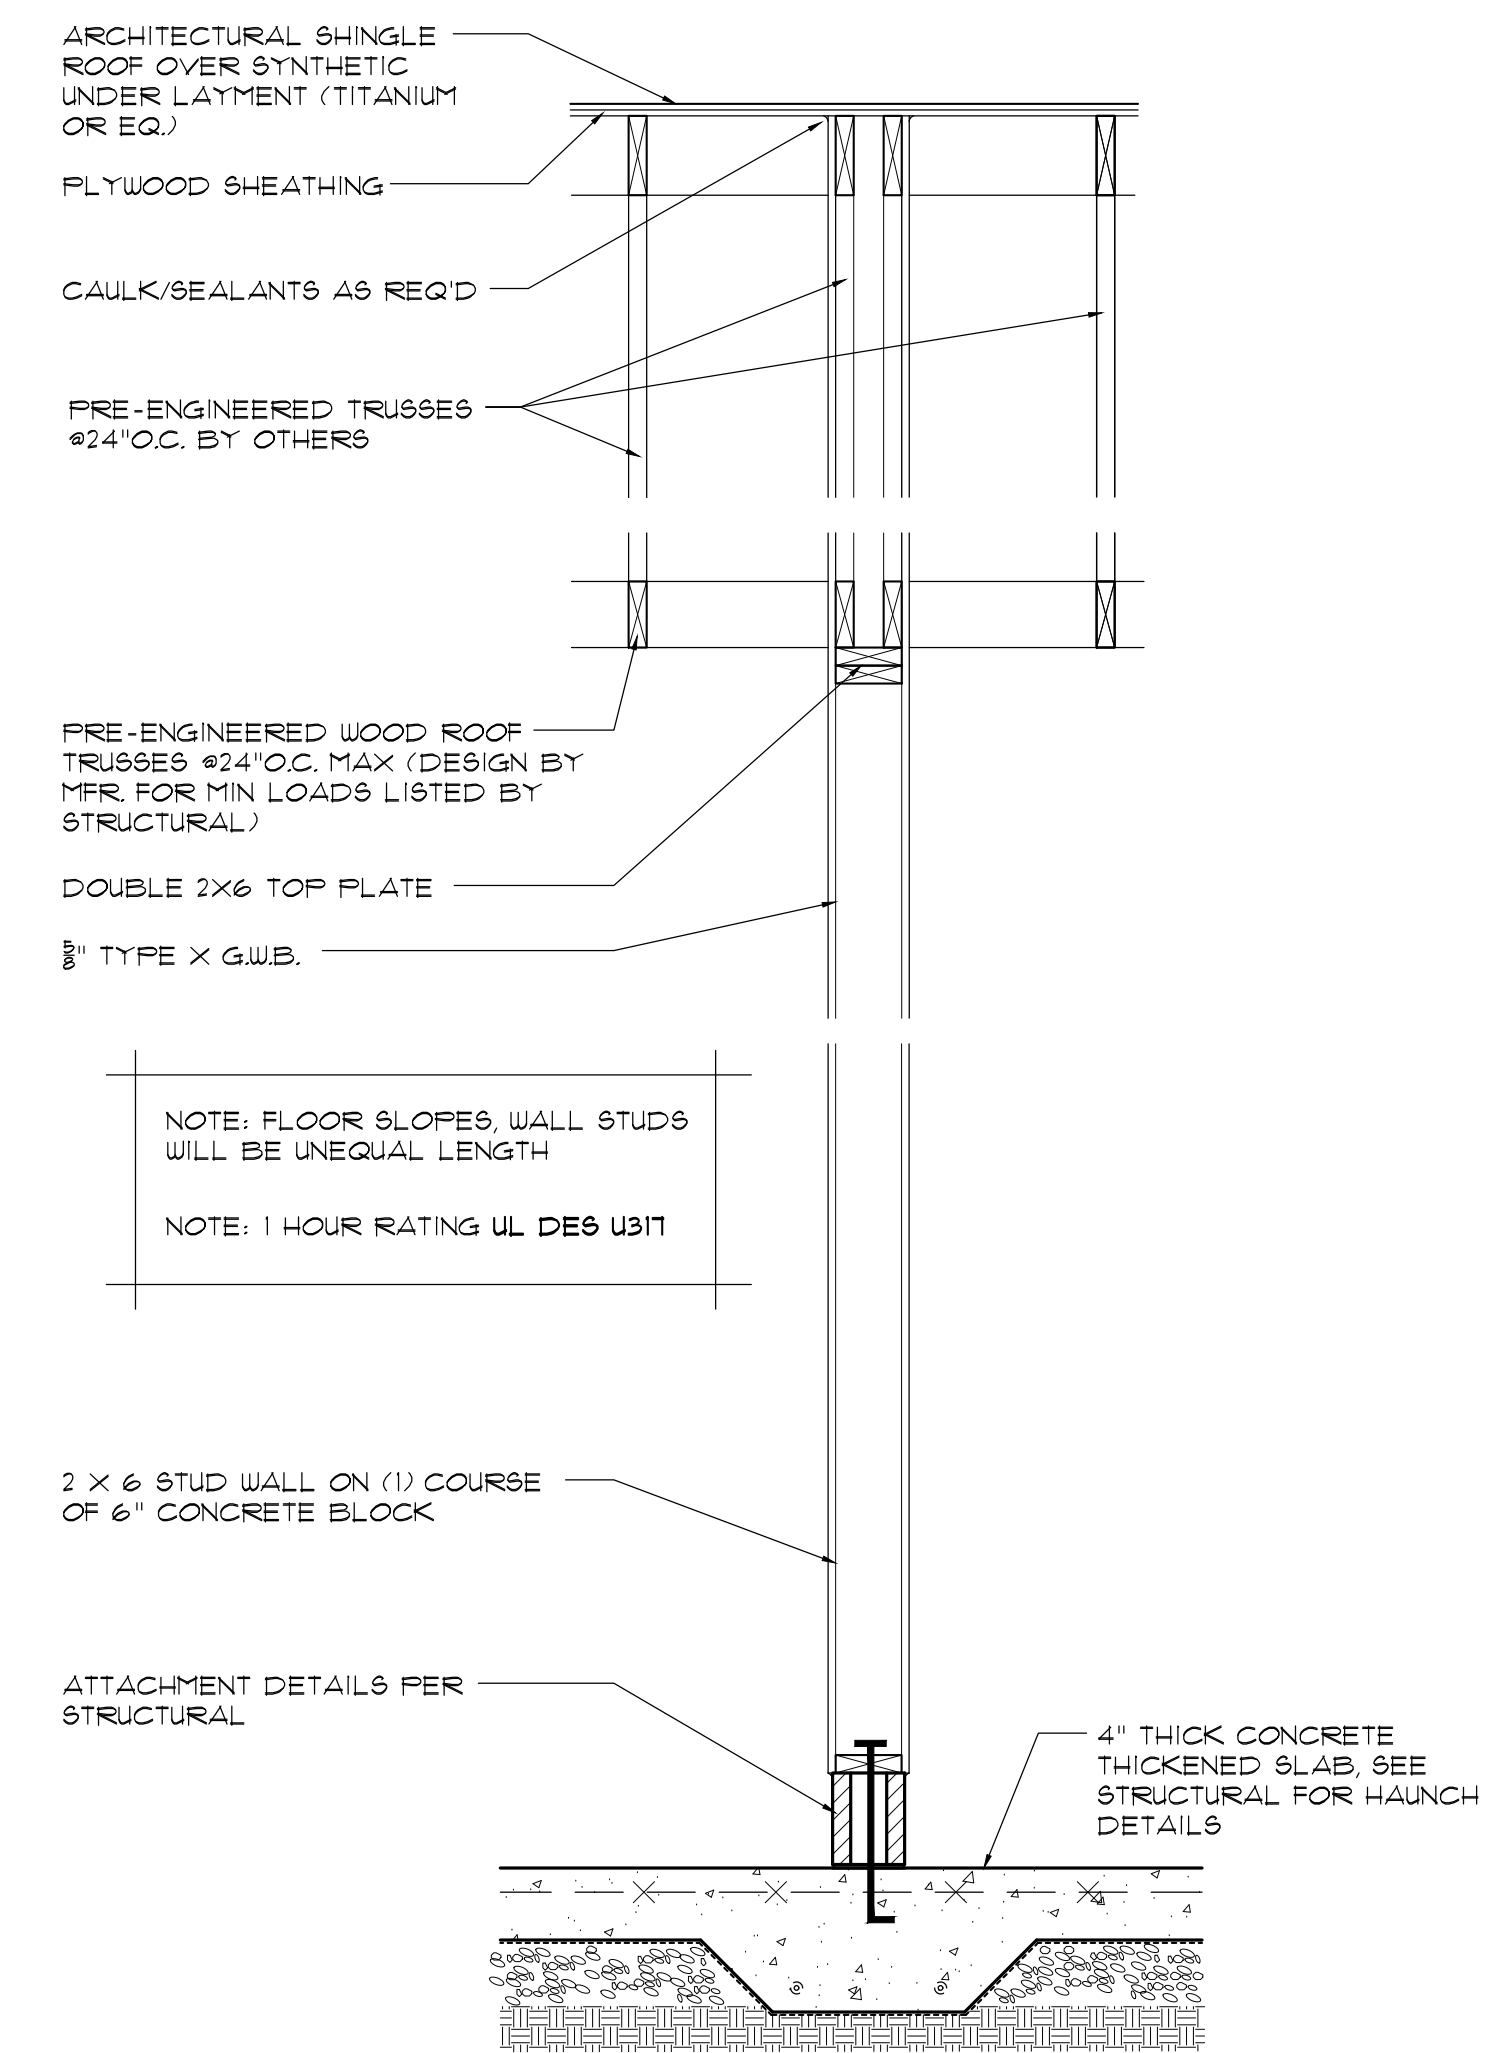


WALL TYPE 'A'
 SCALE: 3/4"=1'-0"




ROOF PLAN
 SCALE: 1/4"=1'-0"

DOOR SCHEDULE

NO.	SIZE	DOOR		FRAME MAT.	HOURS FUNCTION SEE NOTE 4	LABEL	REMARKS
		MAT.	ELEV.				
GD-2	9'-0"x7'-0"		H				OVHD. PROVIDE OPENER

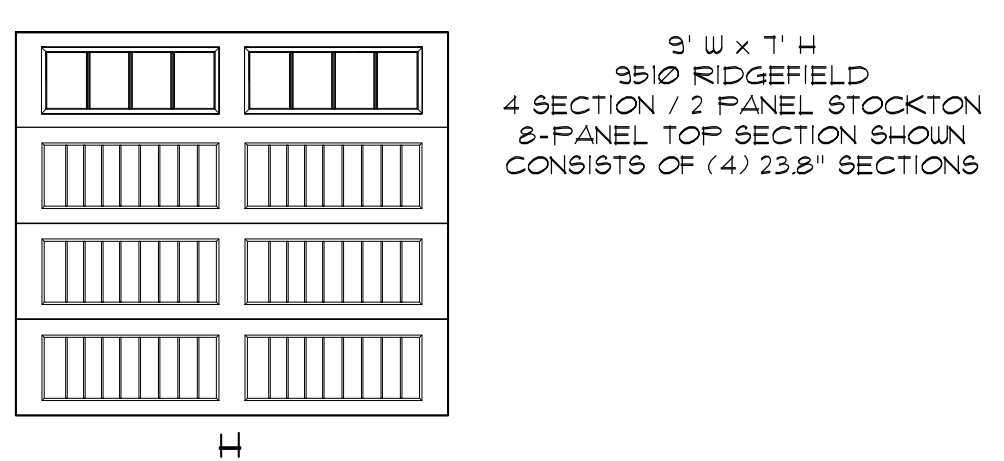


- FLOOR PLAN GENERAL NOTES:**
- F.E.C.: FIRE EXTINGUISHER CABINET (OR WALL HUNG EXTINGUISHER) LOCATION. MOUNTING HEIGHT TO THE TOP OF THE CABINET SHALL BE APPROX. 40" AFF. COORDINATED WITH SELECTED UNIT. GC SHALL REVIEW FINAL LOCATIONS WITH FIRE MARSHAL PRIOR TO EXTINGUISHER MOUNTING INSTALLATION.
 - REFER TO ELECTRICAL DRAWINGS (PROVIDED BY OTHERS) FOR ALL FIRE ALARM TYPES AND LOCATIONS, EXIT SIGNAGE AND EMERGENCY LIGHTING LAYOUTS.
 - FIRE ALARM SYSTEM SHALL BE INSTALLED PER NYSBC.
 - ALL DIMENSIONS TO BE TAKEN FROM FACE OF WALL. REFER TO PARTITION TYPES FOR ACTUAL DIMENSIONS.
 - CONTRACTOR SHALL PROVIDE BLOCKING AS REQUIRED FOR ALL EQPT. INSTALLATION.
- FIRST FLOOR PLAN KEY NOTES:**
- SEALED CONCRETE TREATMENT ON EXISTING CONCRETE FLOOR TO BE COORDINATED B/W LANDLORD & TENANT
 - TRUSS PLACARD TO BE SHOWN ON ELECTRICAL BOX. FINAL LOCATION OF ELECTRICAL BOX T.B.D.

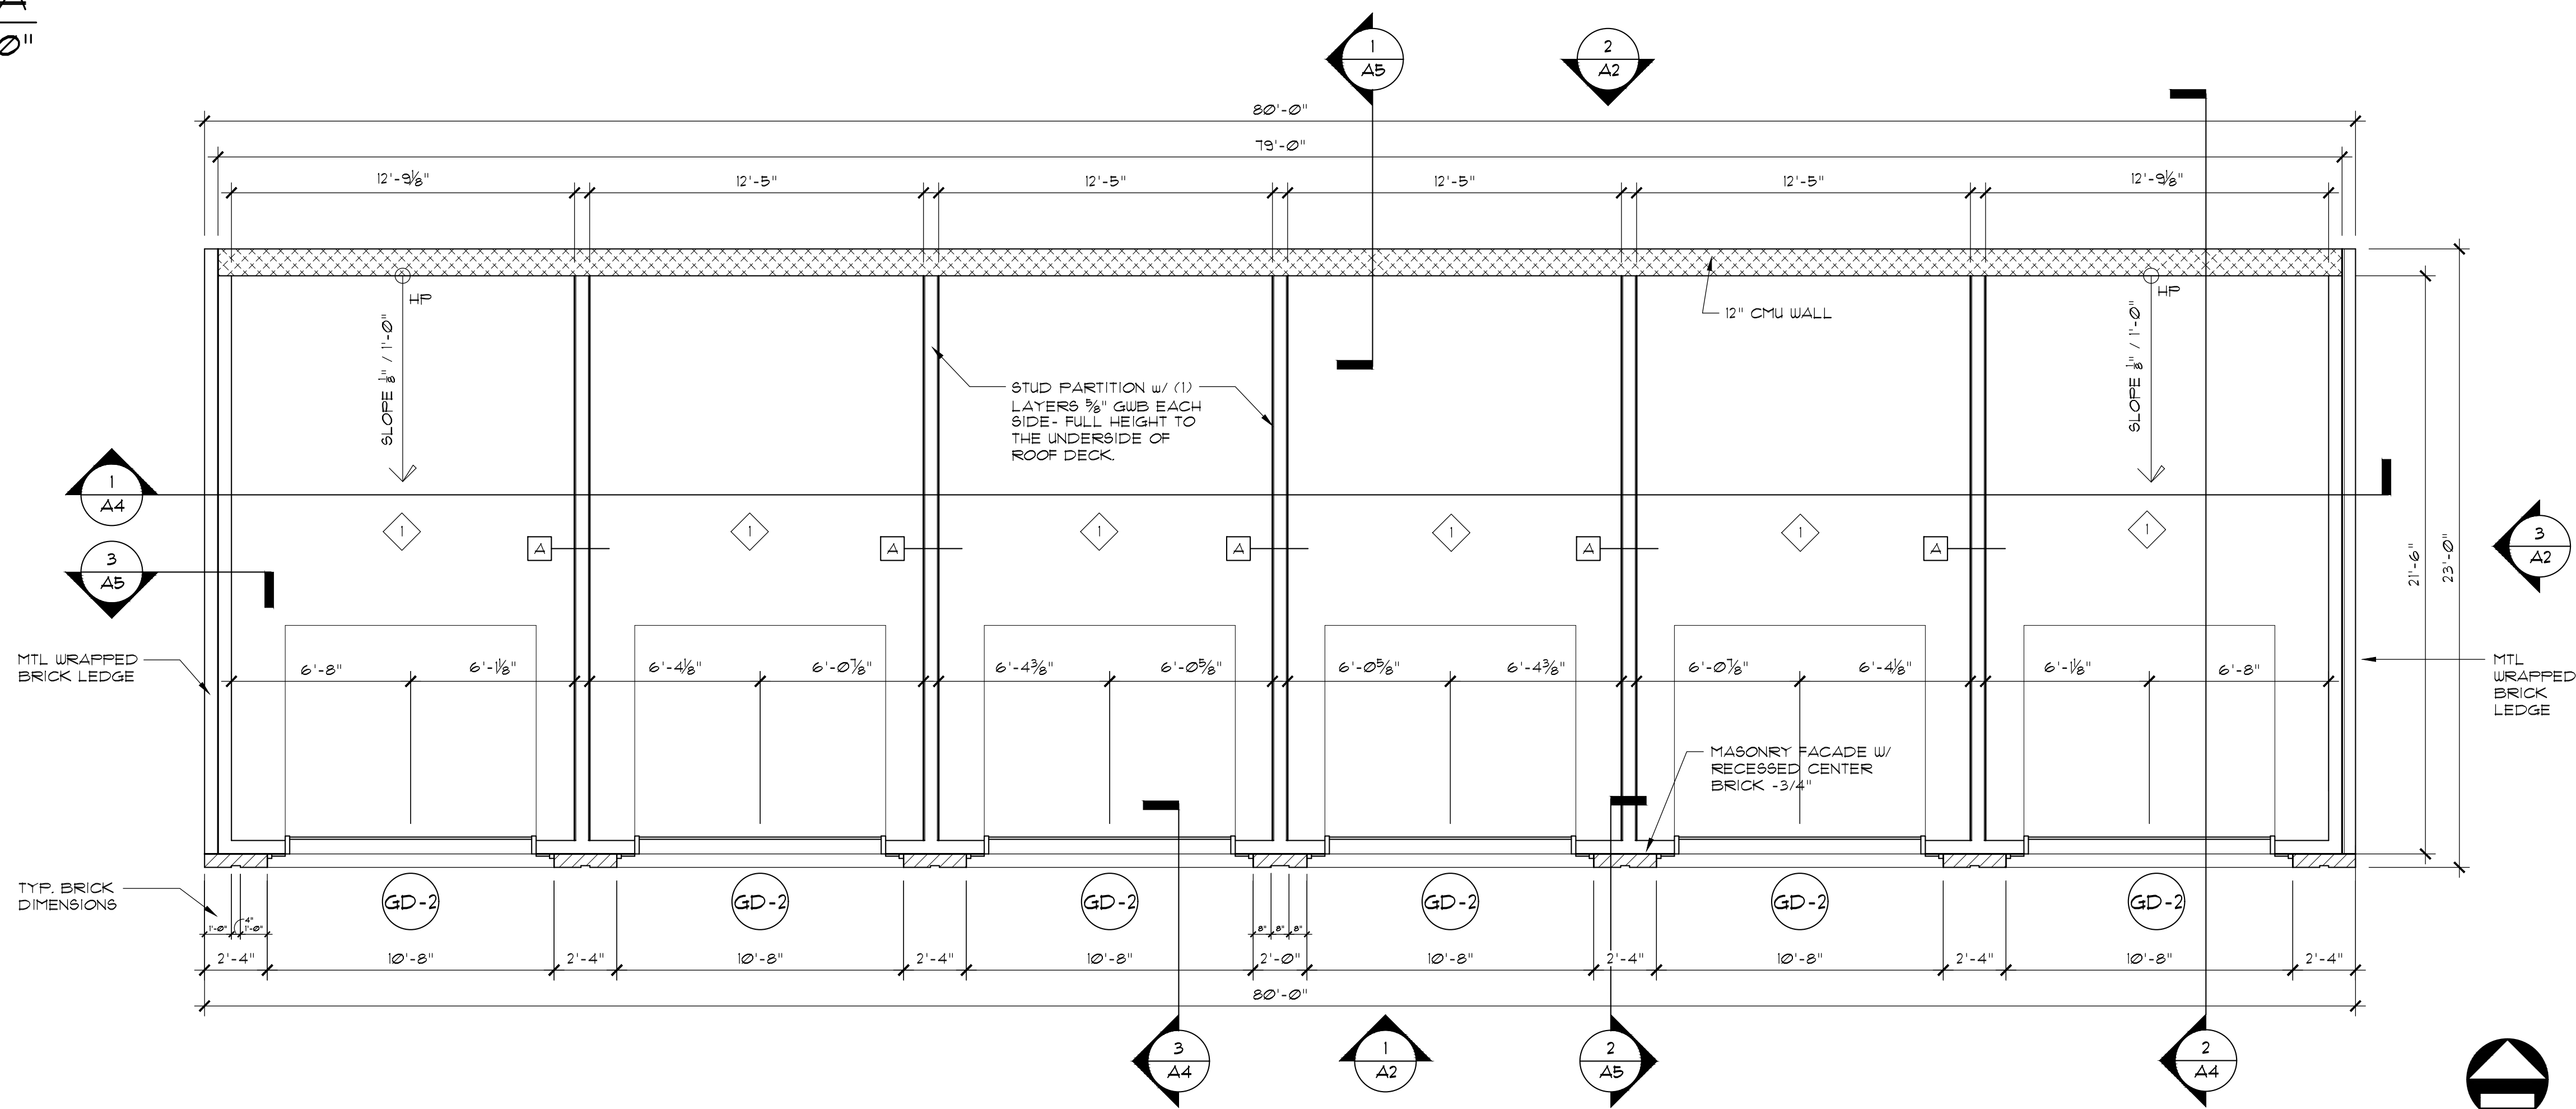

FLOOR PLAN
 SCALE: 1/4"=1'-0"



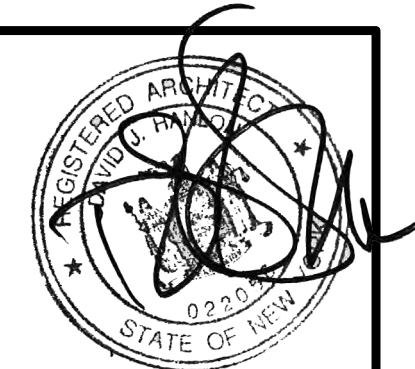

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**KILBOURN PLACE APARTMENTS
 BUILDING 2 - GARAGE**
 PITTSFORD, NEW YORK

REVISED:

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REFLECTED CEILING
 PLAN



DRAWING TITLE:

A2

SHEET NO:

PROJECT NO: 21-226

CEILING / LIGHT FIXTURE LEGEND:

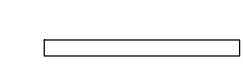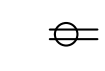
-  4' LED LINEAR TUBE LIGHT FIXTURES. FINAL PLACEMENT & TYPE PER OWNER
-  RECEPTACLES @ CEILINGS - G.C. TO COORDINATE FINAL LOCATIONS & QUANTITIES

FINAL FIRE ALARM COMPONENTS & DESIGN LAYOUT TO BE VERIFIED BY OTHERS. THE INFORMATION SHOWN IS FOR REFERENCE ONLY AND SHALL BE REVIEWED BY OWNER AND GC PRIOR TO FINAL PLACEMENT.

REFLECTED CEILING PLAN NOTES:

1. ALL LIGHTING TEMPERATURE TO BE 3500K UNO
2. OMITTED
3. ALL OUTLET PLATES AND SWITCHES TO BE WHITE UNO
4. ALL FIXTURE HEIGHTS TO BE CONFIRMED BEFORE INSTALLATION
5. THIS DRAWING DEPICTS LIGHTING LAYOUTS FOR DESIGN PURPOSES & DECORATIVE FIXTURES. CONTRACTOR TO EVALUATE & PROVIDE LIGHT LEVELS IN ALL PUBLIC AREAS. REFER TO PAINT SCHEDULE FOR LIGHT REFLECTANCIES OR REFER TO ELECTRICAL ENGINEER.
6. ALIGN LIGHTS WHEREVER POSSIBLE.
7. COORDINATE TRADES TO ASSURE ALL DEVICES ALIGN EITHER VERTICALLY OR HORIZONTALLY. KEEP DEVICES CLOSE TO DOOR FRAMES OR CORNERS & AWAY FROM CENTER OF WALLS.
8. VERIFY ALL OUTLET HEIGHTS AND LOCATIONS WITH OWNERS.
9. REFER TO HVAC/MECHANICAL, ELECTRICAL & FIRE PROTECTION DRAWINGS FOR ASSOCIATED WORK.
10. PROVIDE OCCUPANCY SENSORS PER ENERGY CODE G405.2.1.
11. EXTERIOR LIGHTING OR POWER REQUIREMENTS TO BE DETERMINED BY OTHERS.


GARAGE BAYS OPEN TO TRUSSES ABOVE

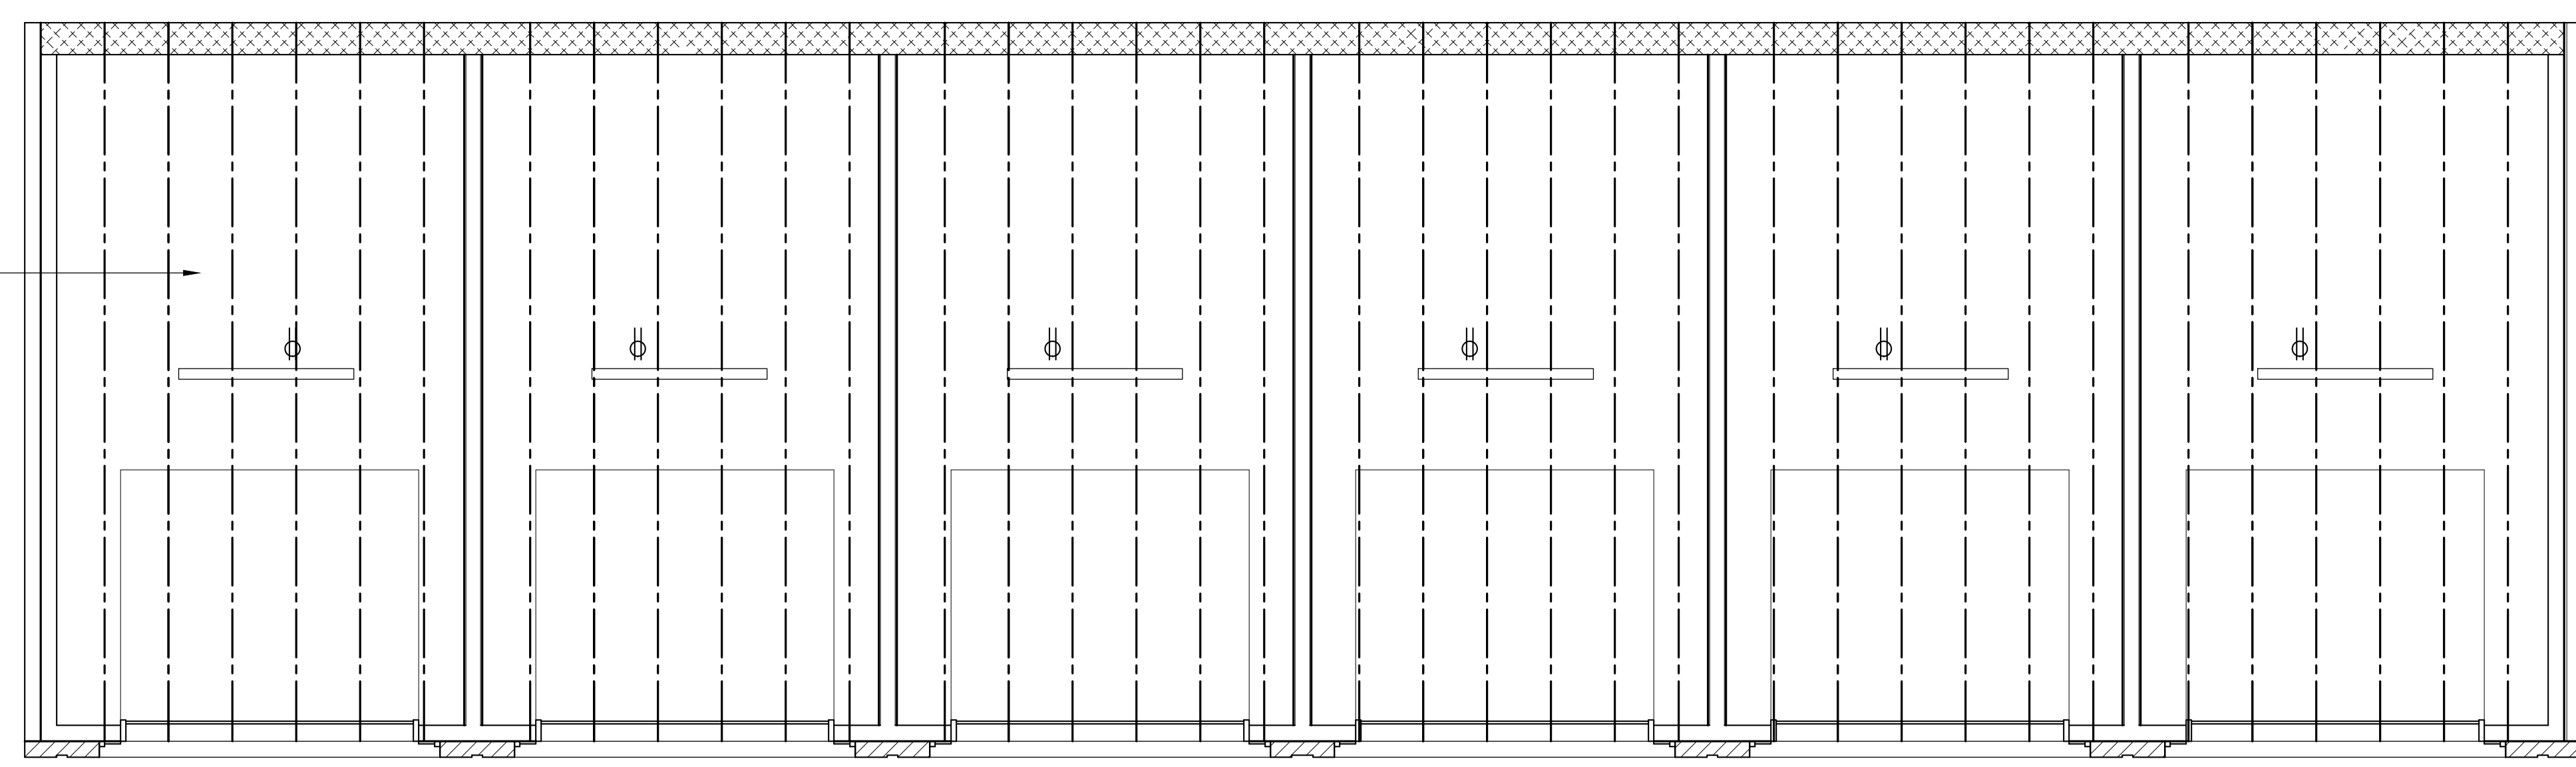

1

REFLECTED CEILING PLAN
 SCALE: 1/4"=1'-0"




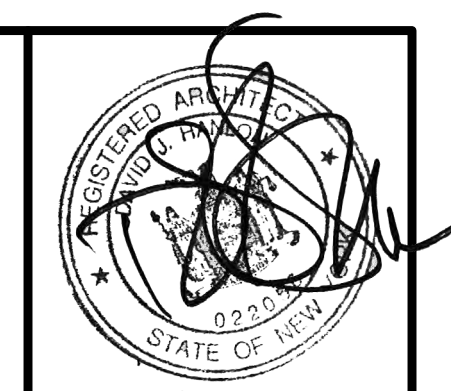


EXTERIOR FINISH LEGEND:

B-B	BRICK B- FULL BED MASONRY VENEER- WATSONTOWN BRICK COMPANY IRON SPOT FRIT SERIES- BELVIDERE
FC-A	FIBER CEMENT LAP SIDING COLOR: 'NIGHT GRAY'
FC-B	FIBER CEMENT LAP SIDING COLOR: 'COBBLESTONE'
R-A	ARCHITECTURAL ROOF SHINGLES


ALL TRIM, FASCIAS, & SOFFITS TO BE PAINTED
 PVC TRIM BOARDS & PANELS,
 UNLESS NOTED OTHERWISE.

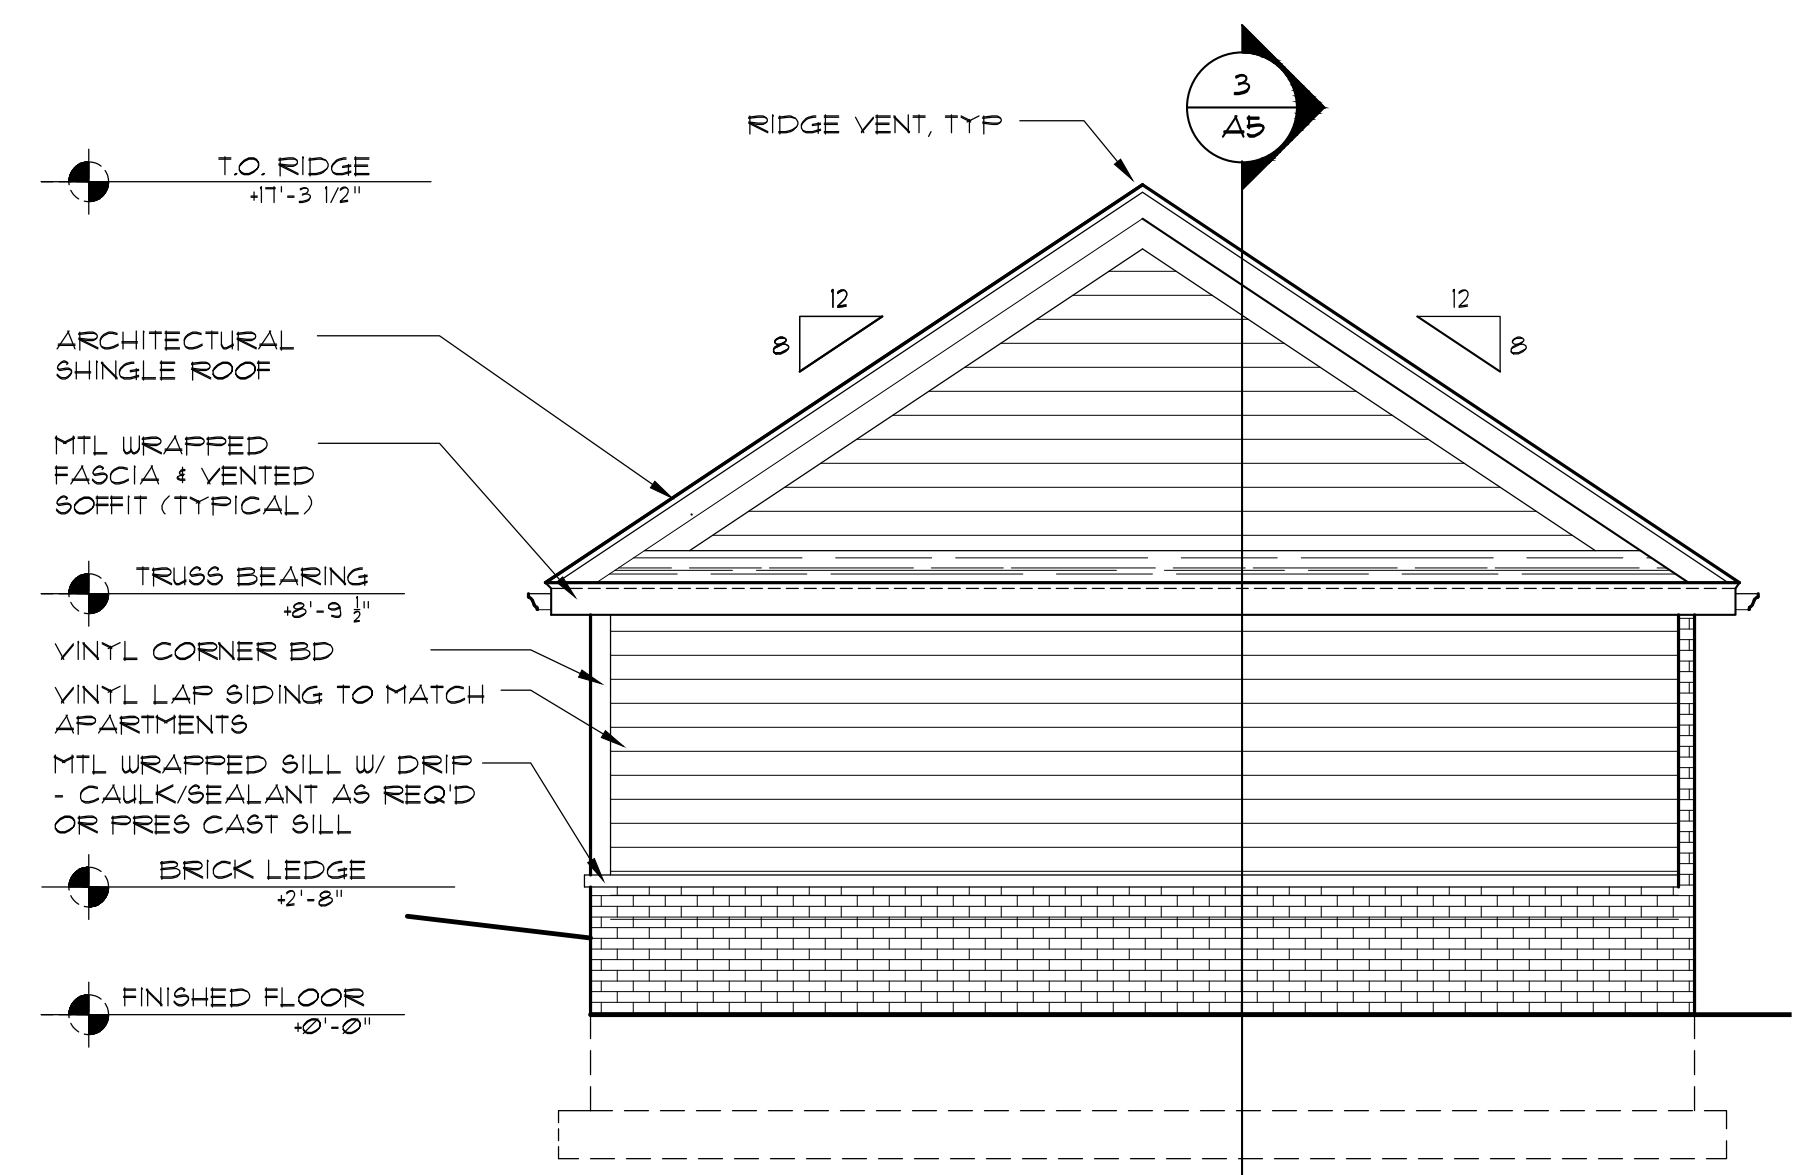


3 SIDE ELEVATION
 SCALE: 1/4"=1'-0"

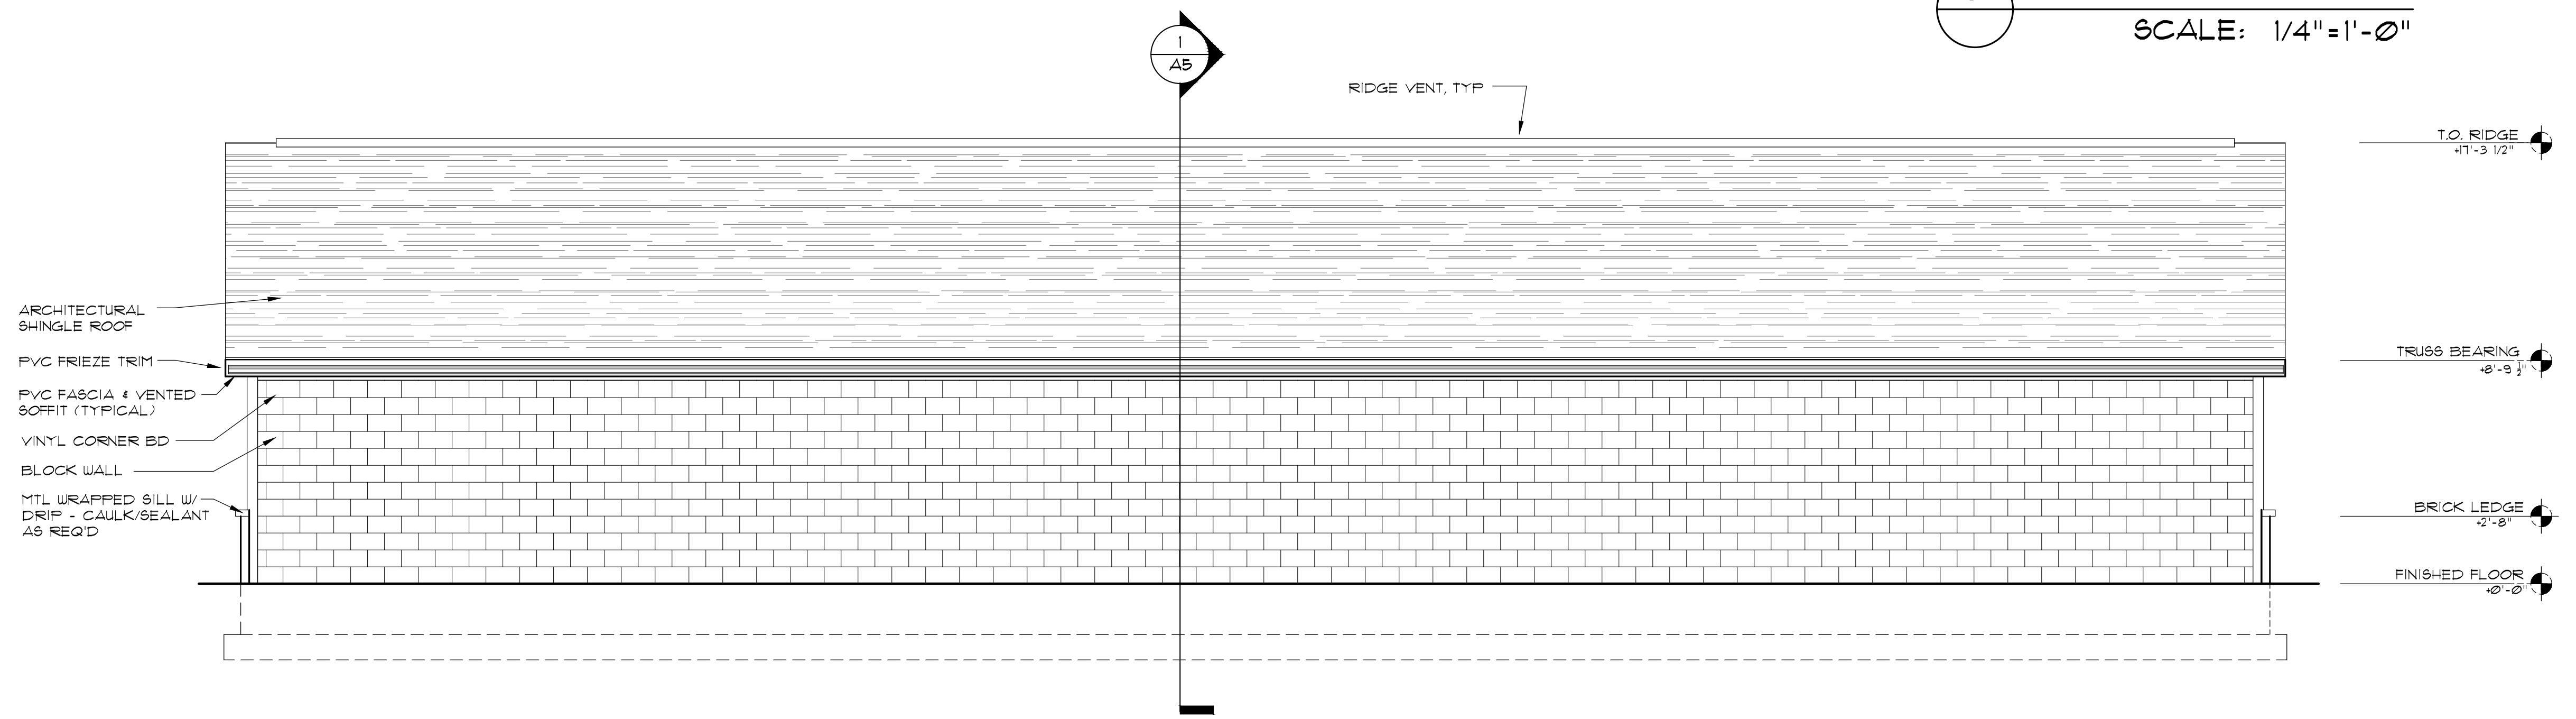

2 REAR ELEVATION
 SCALE: 1/4"=1'-0"

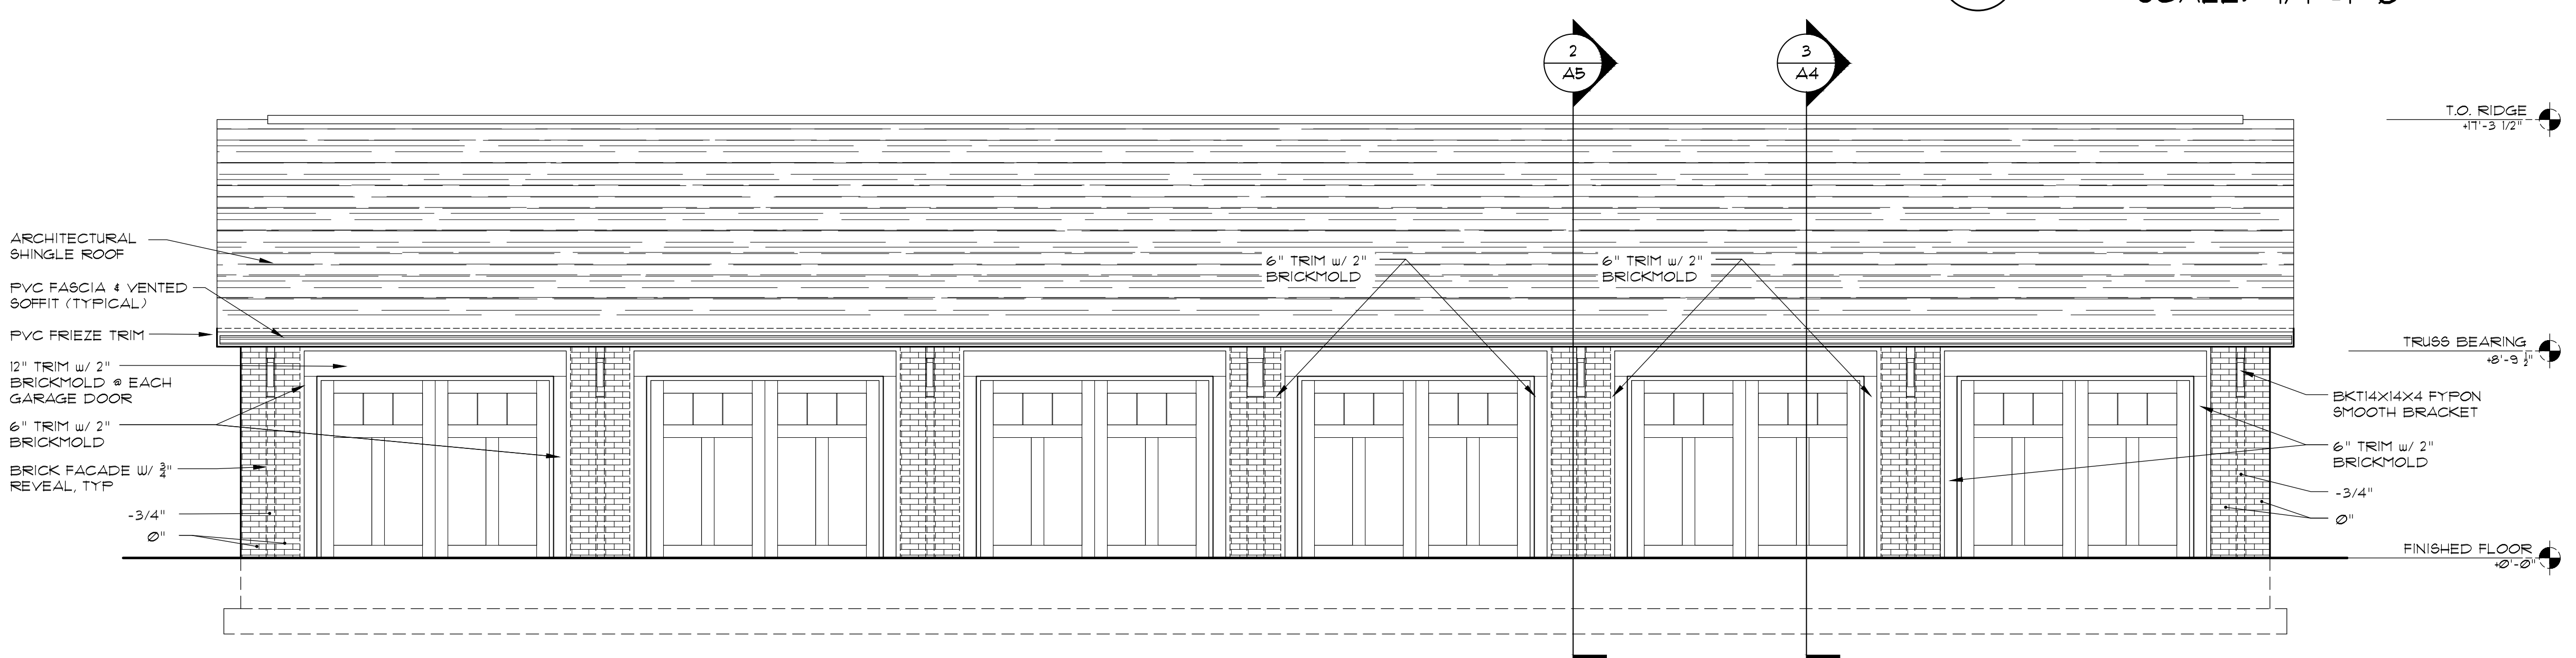


1 FRONT ELEVATION
 SCALE: 1/4"=1'-0"

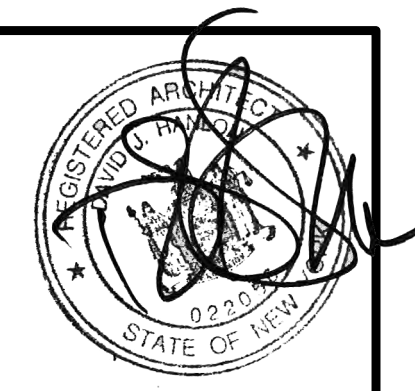


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**KILBOURN PLACE APARTMENTS
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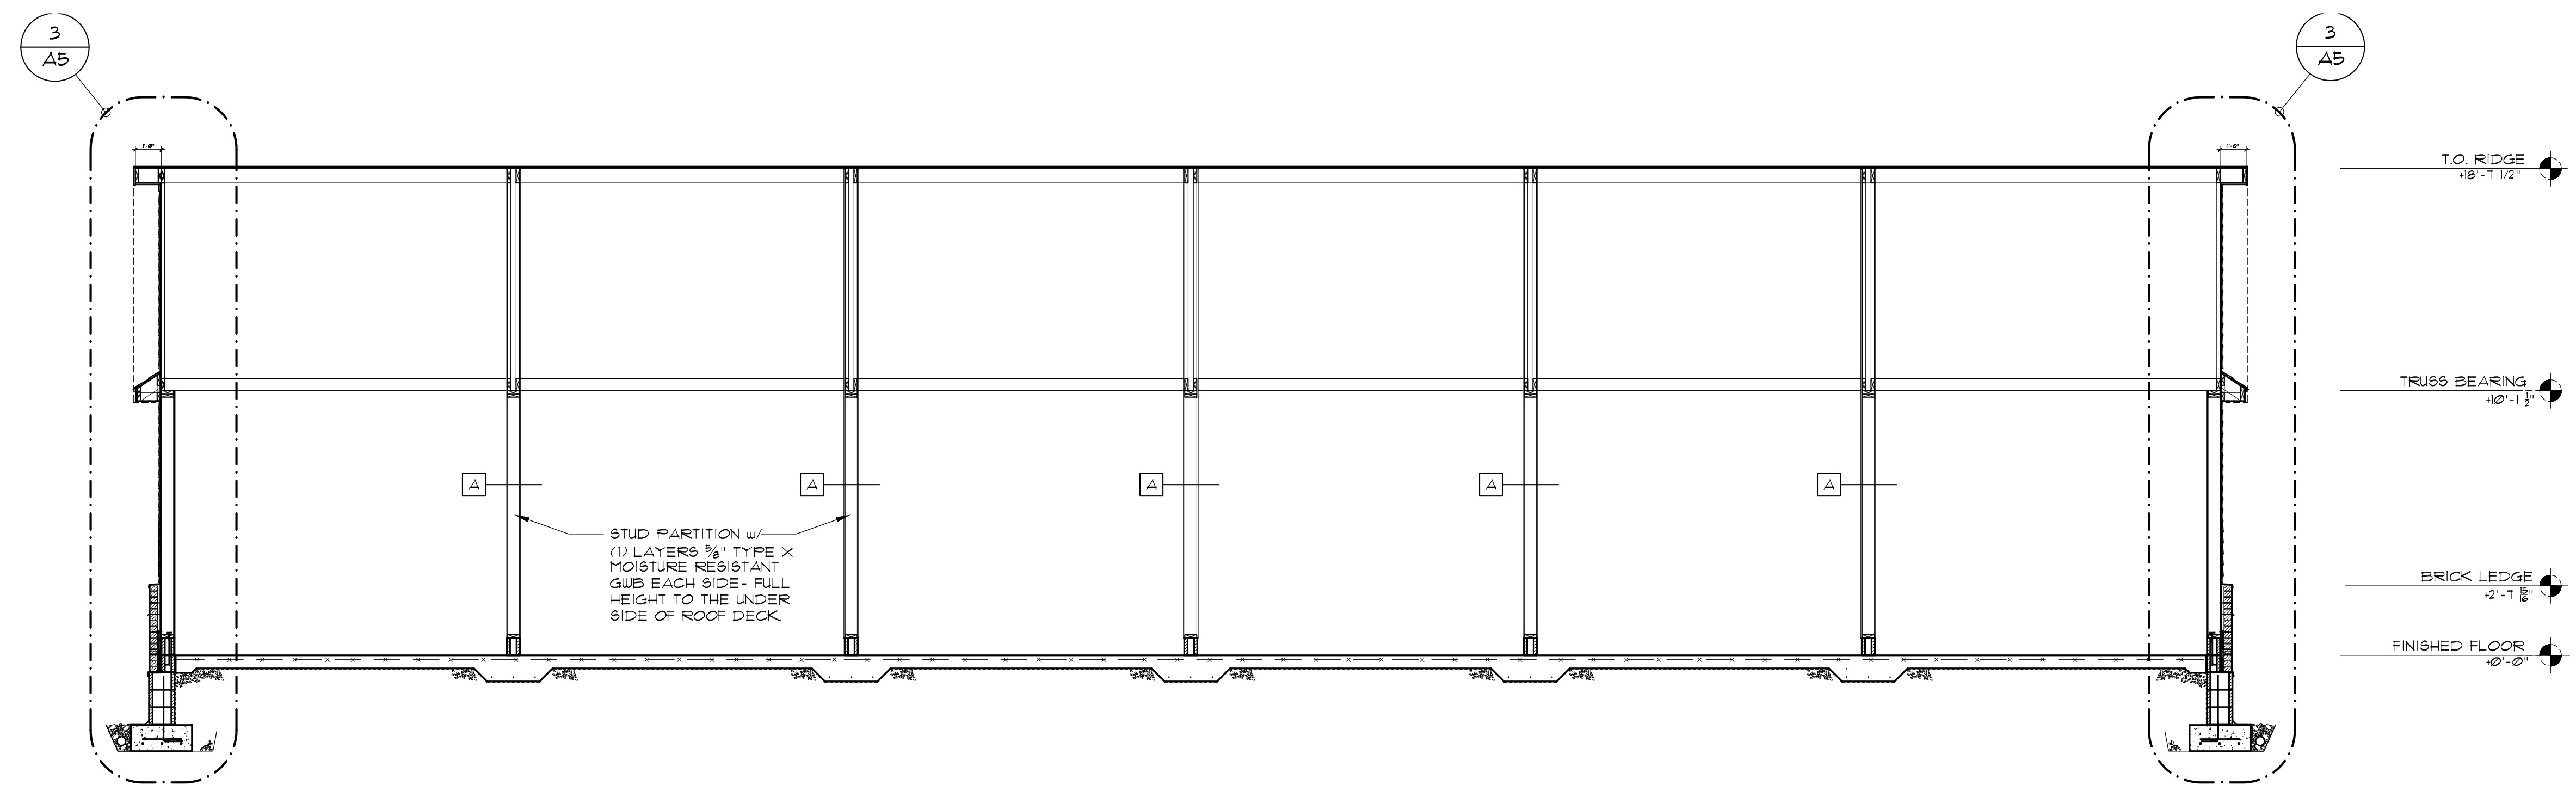
REVISED:
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 BUILDING SECTIONS
 DRAWING TITLE:
A4
 SHEET NO:
 PROJECT NO: 21-226




3 WALL SECTION
 SCALE: 3/4" = 1'-0"

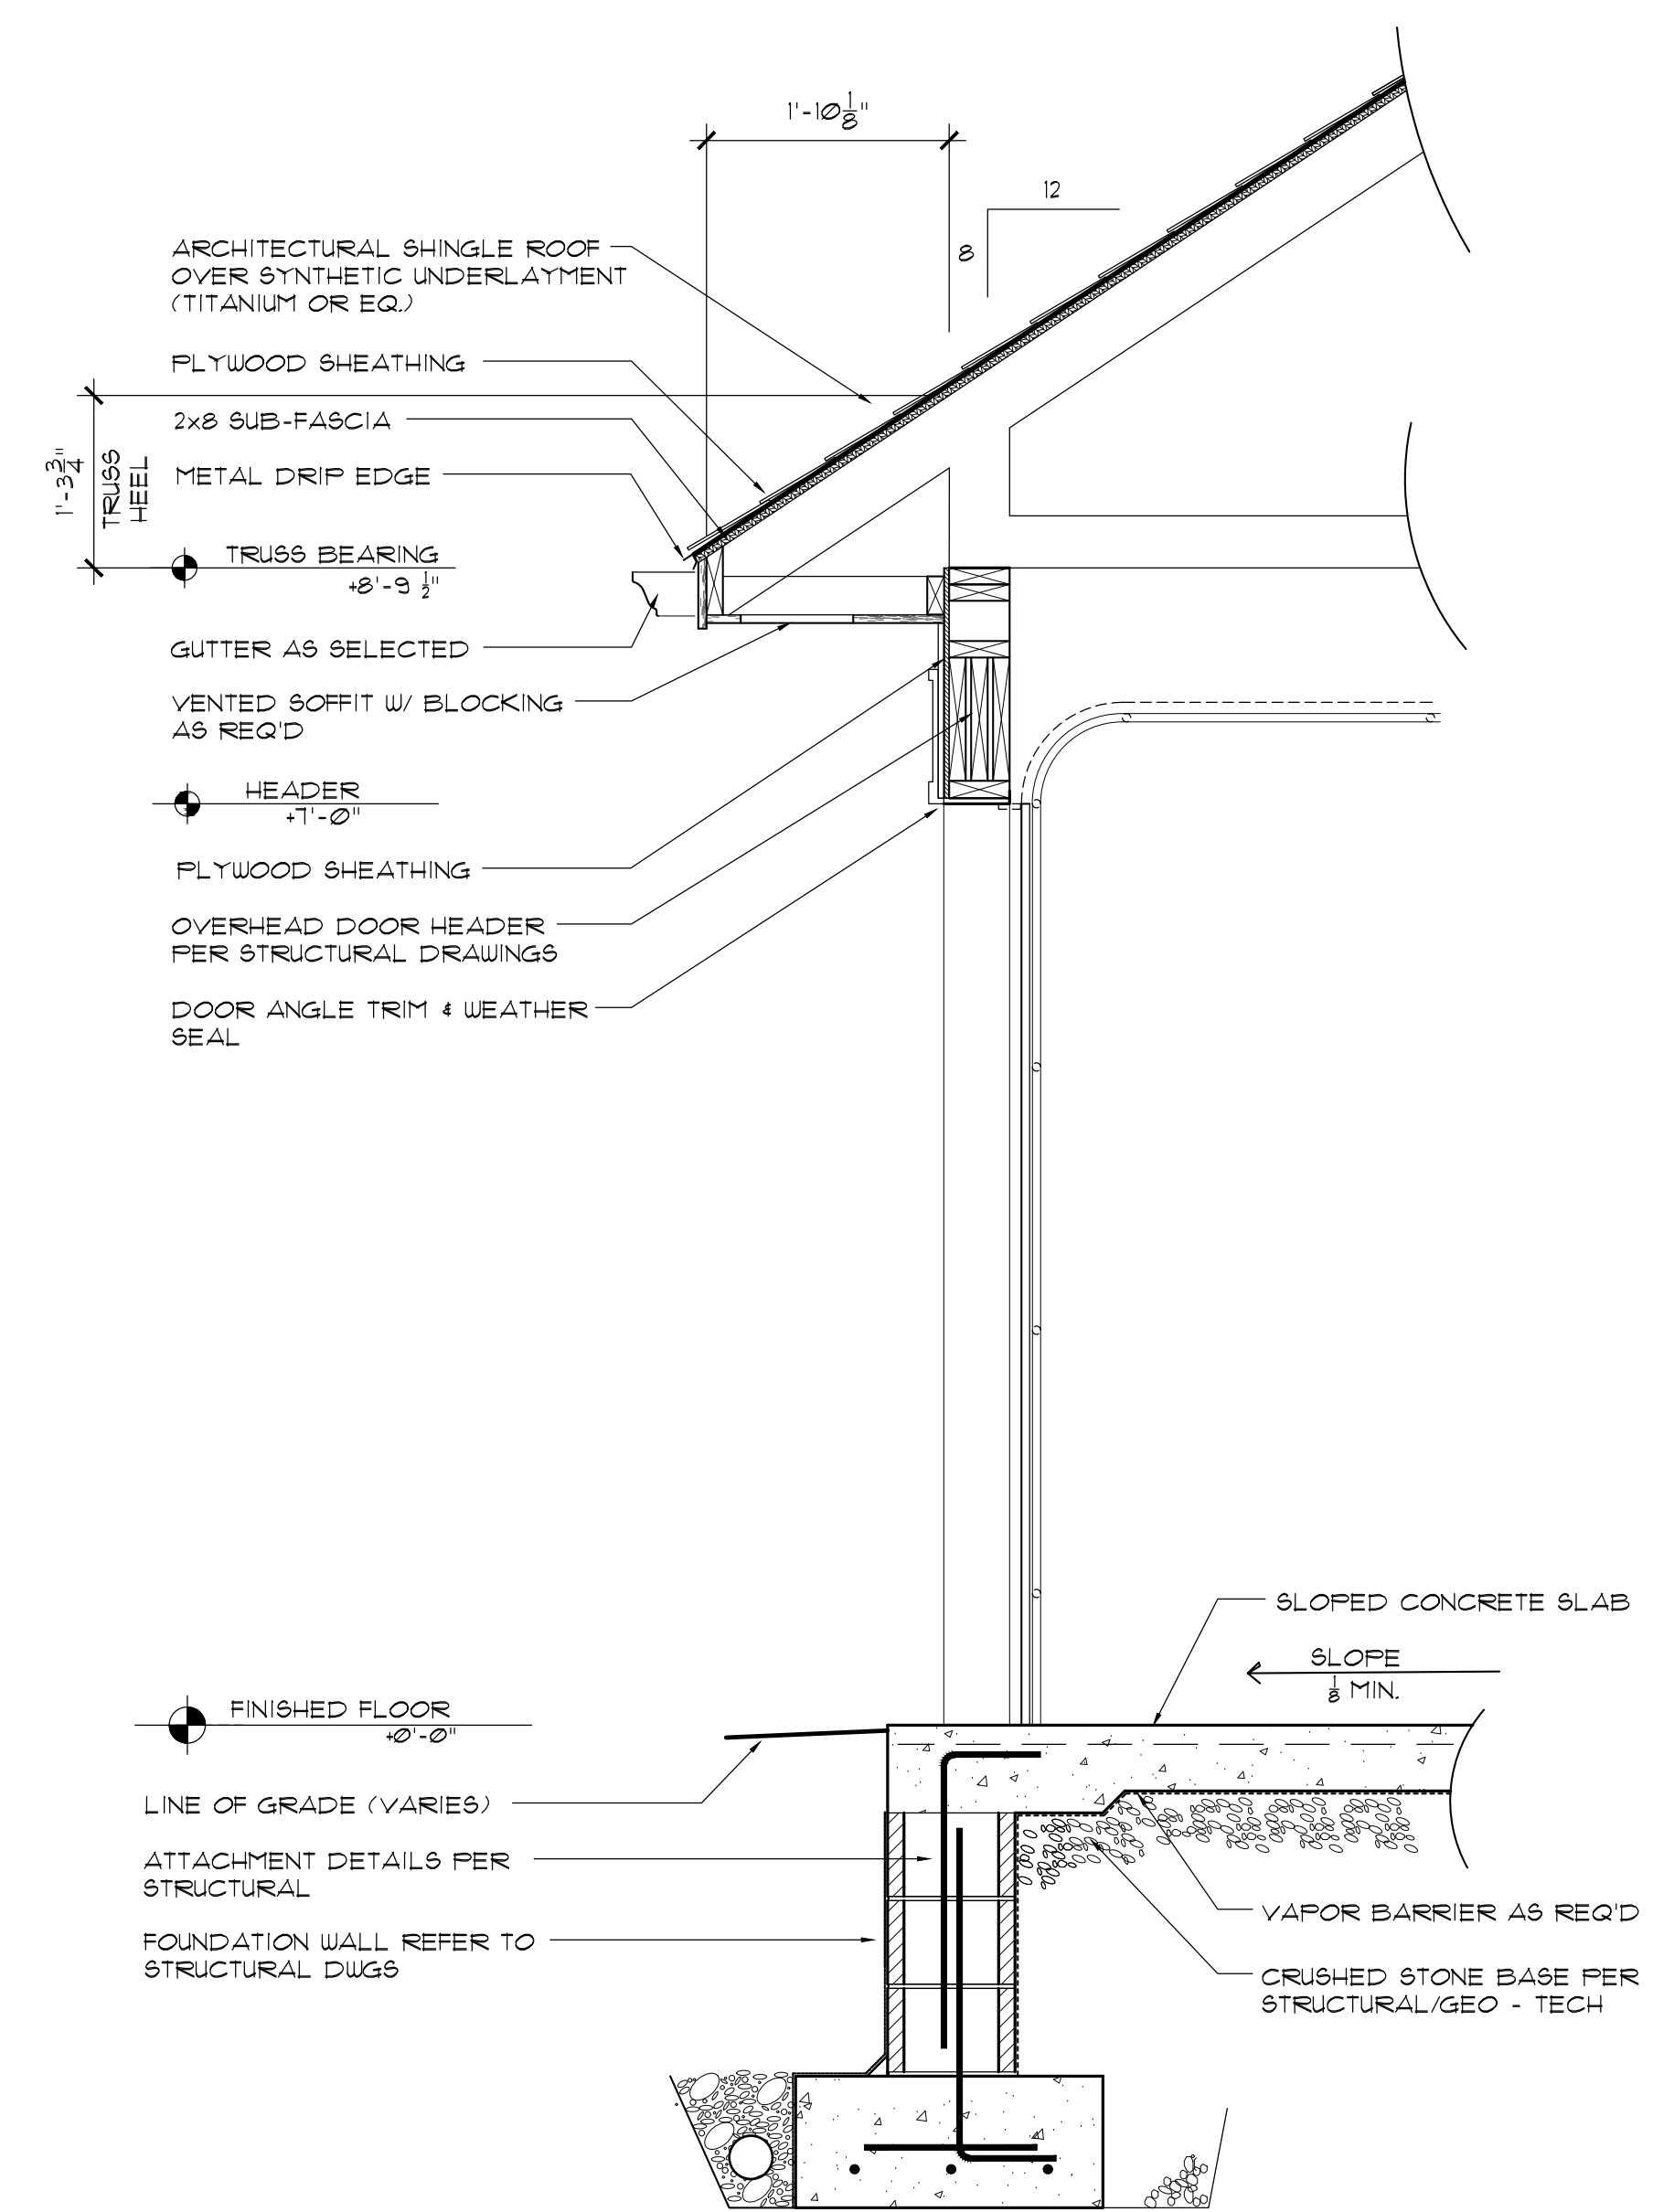

2 BUILDING SECTION
 SCALE: 1/4" = 1'-0"

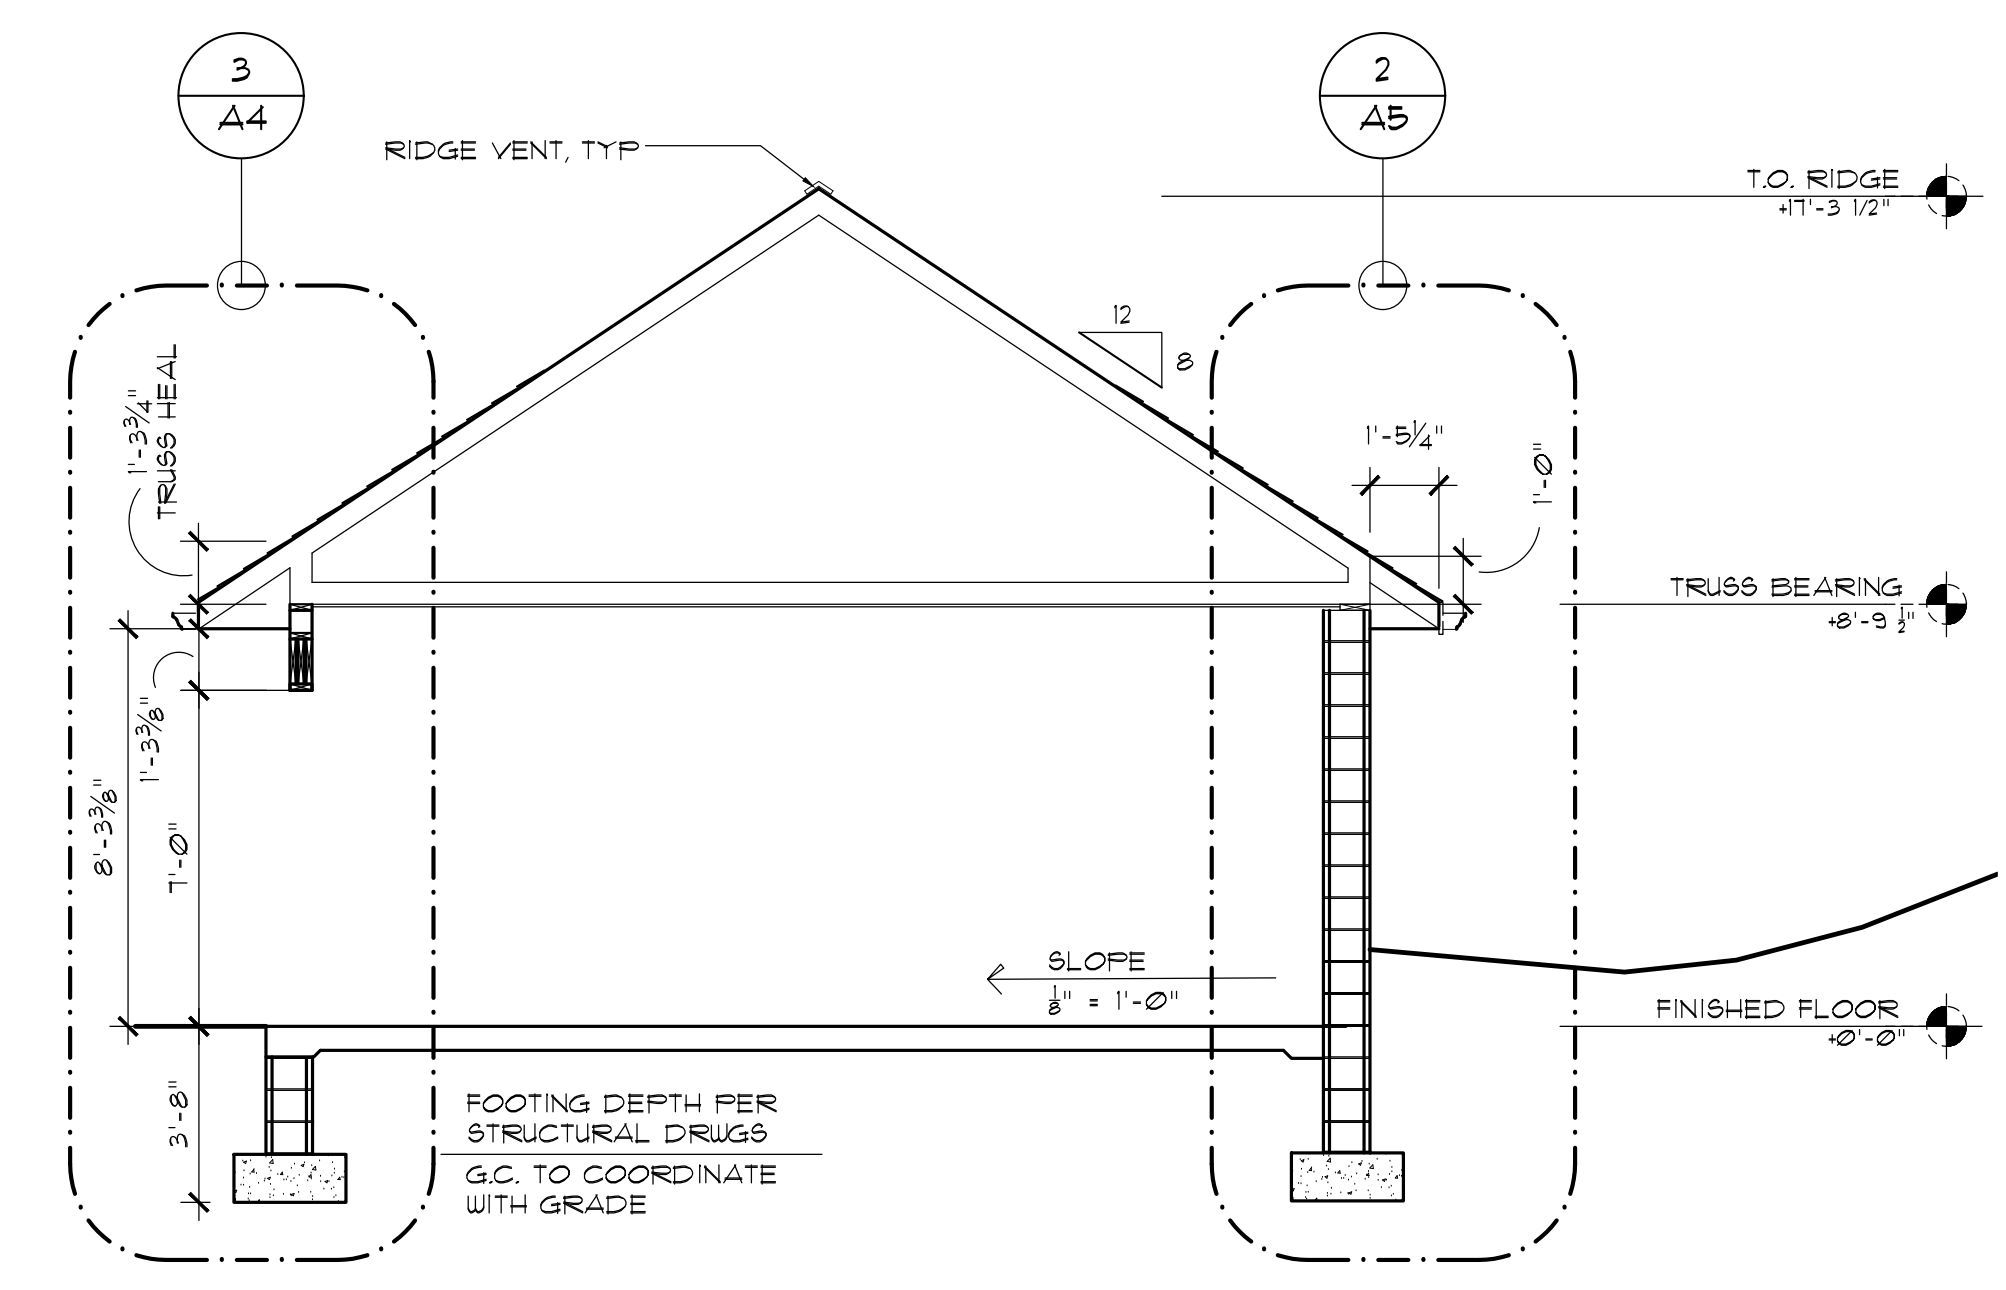

1 BUILDING SECTION
 SCALE: 1/4" = 1'-0"

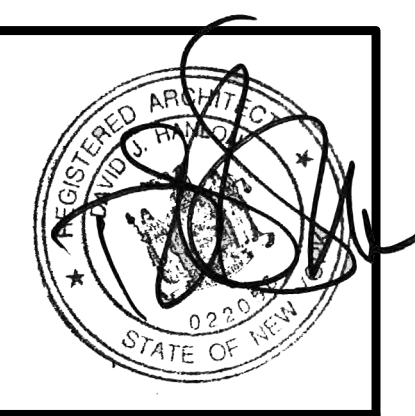

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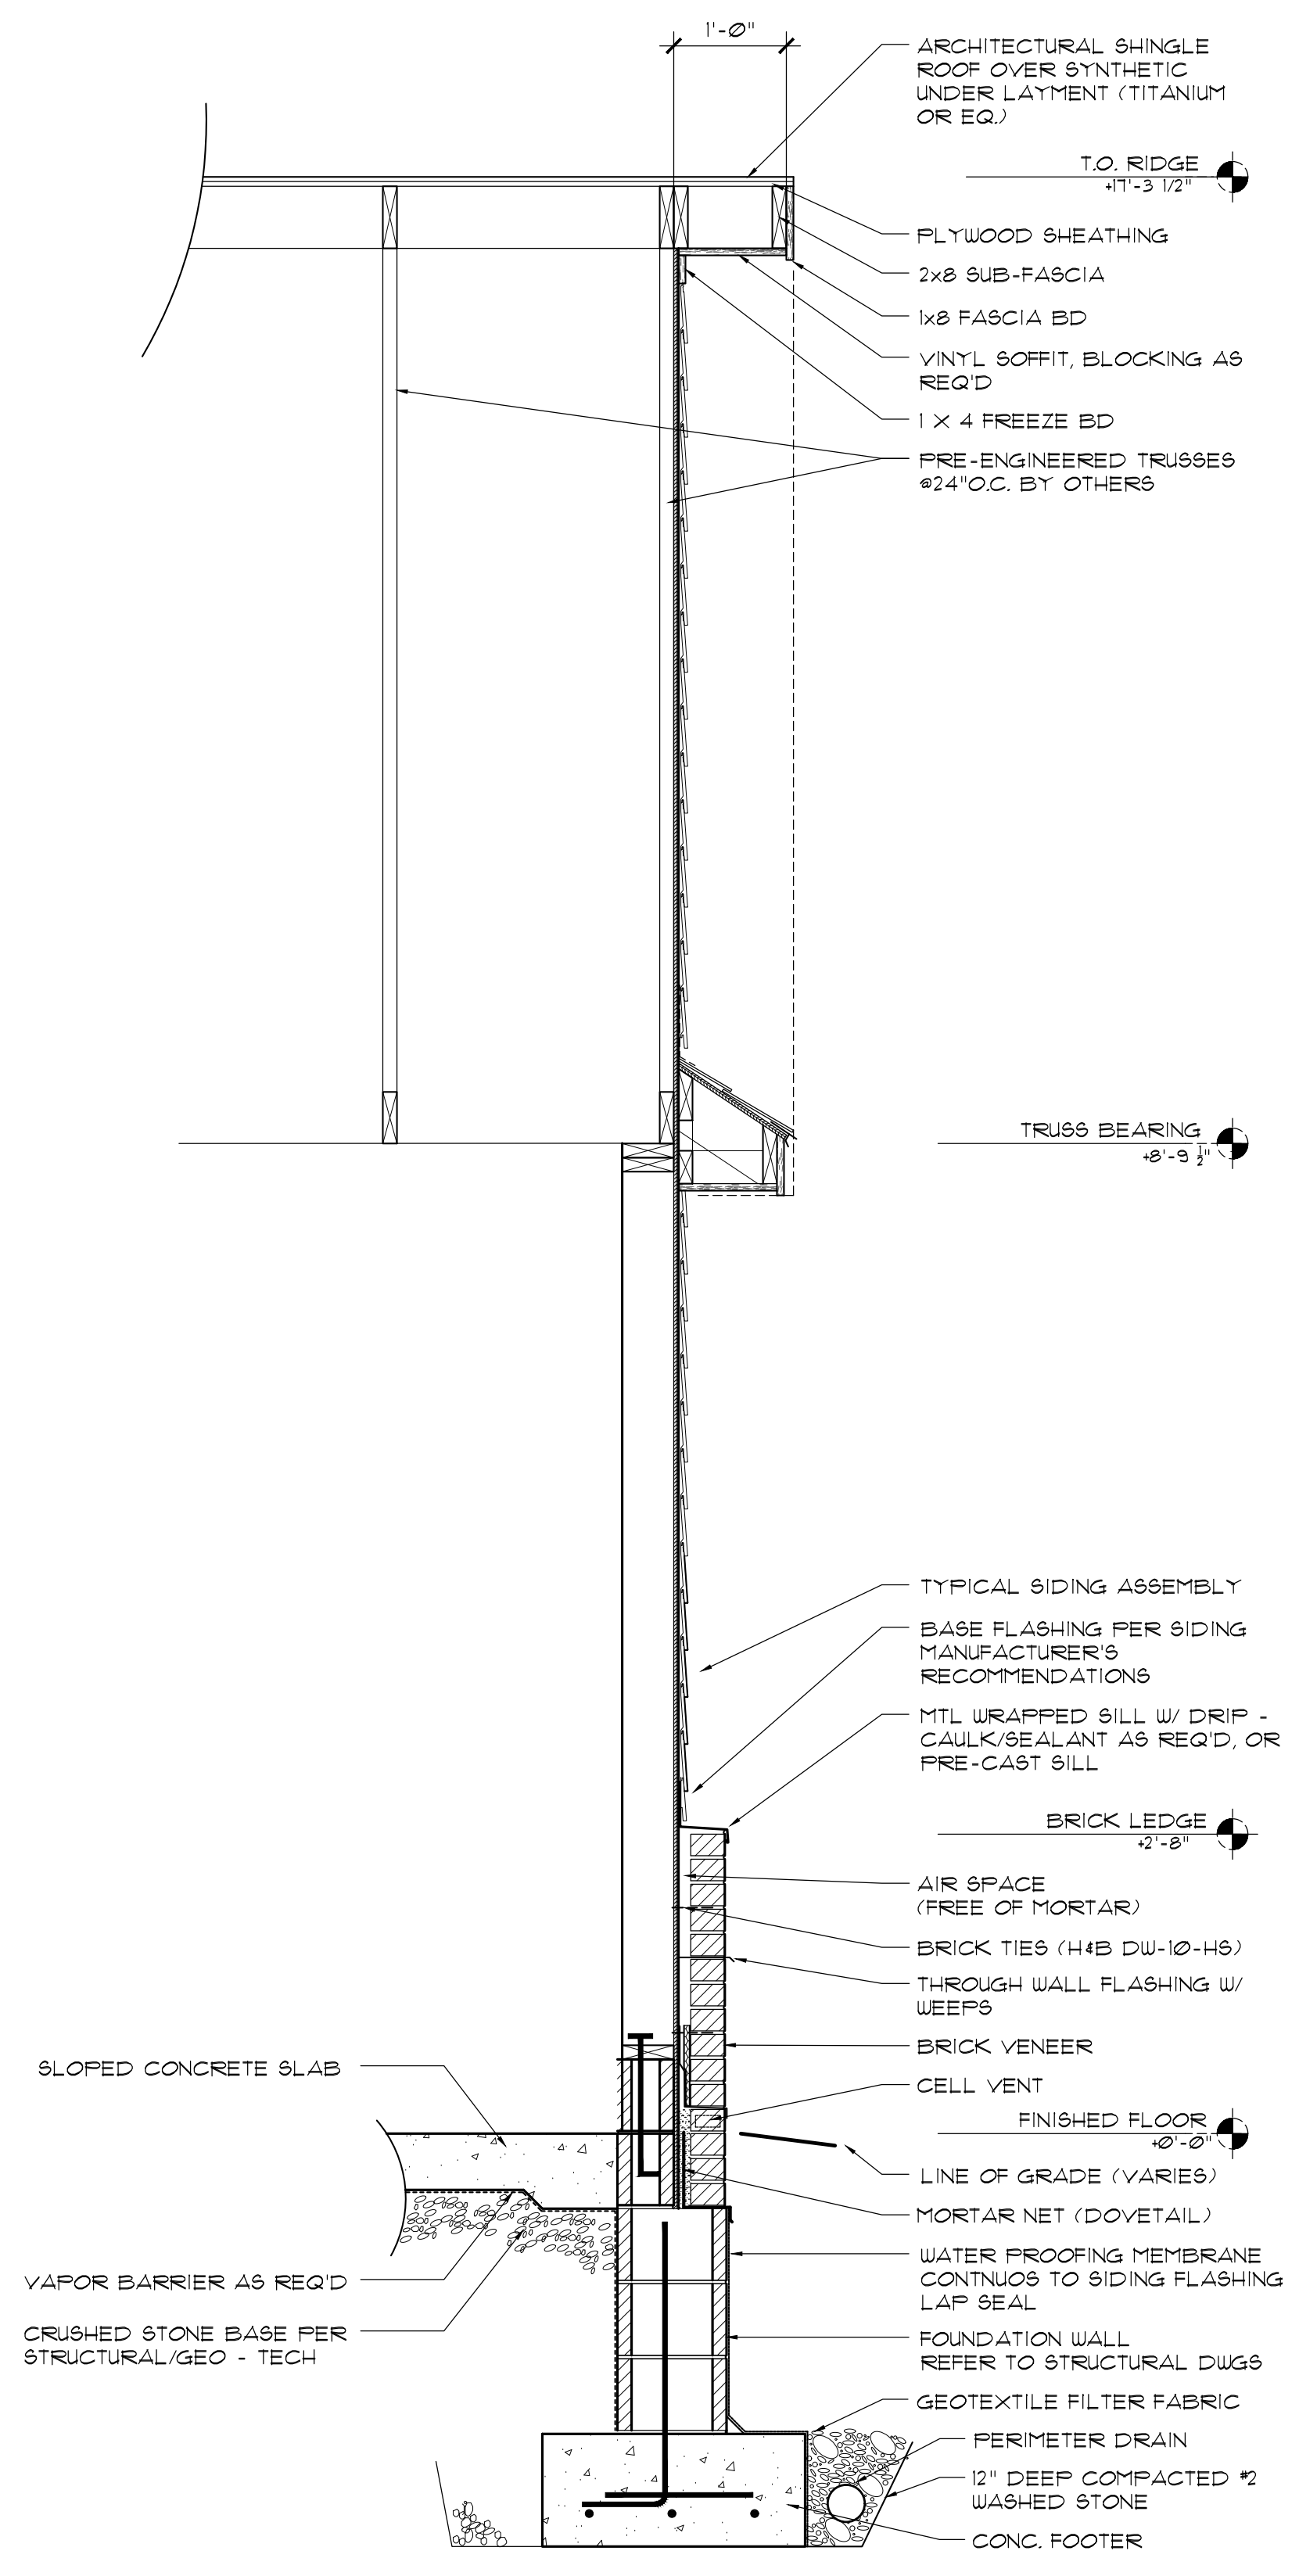
WALL SECTIONS

DRAWING TITLE:


A5

SHEET NO:


PROJECT NO: 21-226



3 WALL SECTION
 SCALE: 3/4"=1'-0"

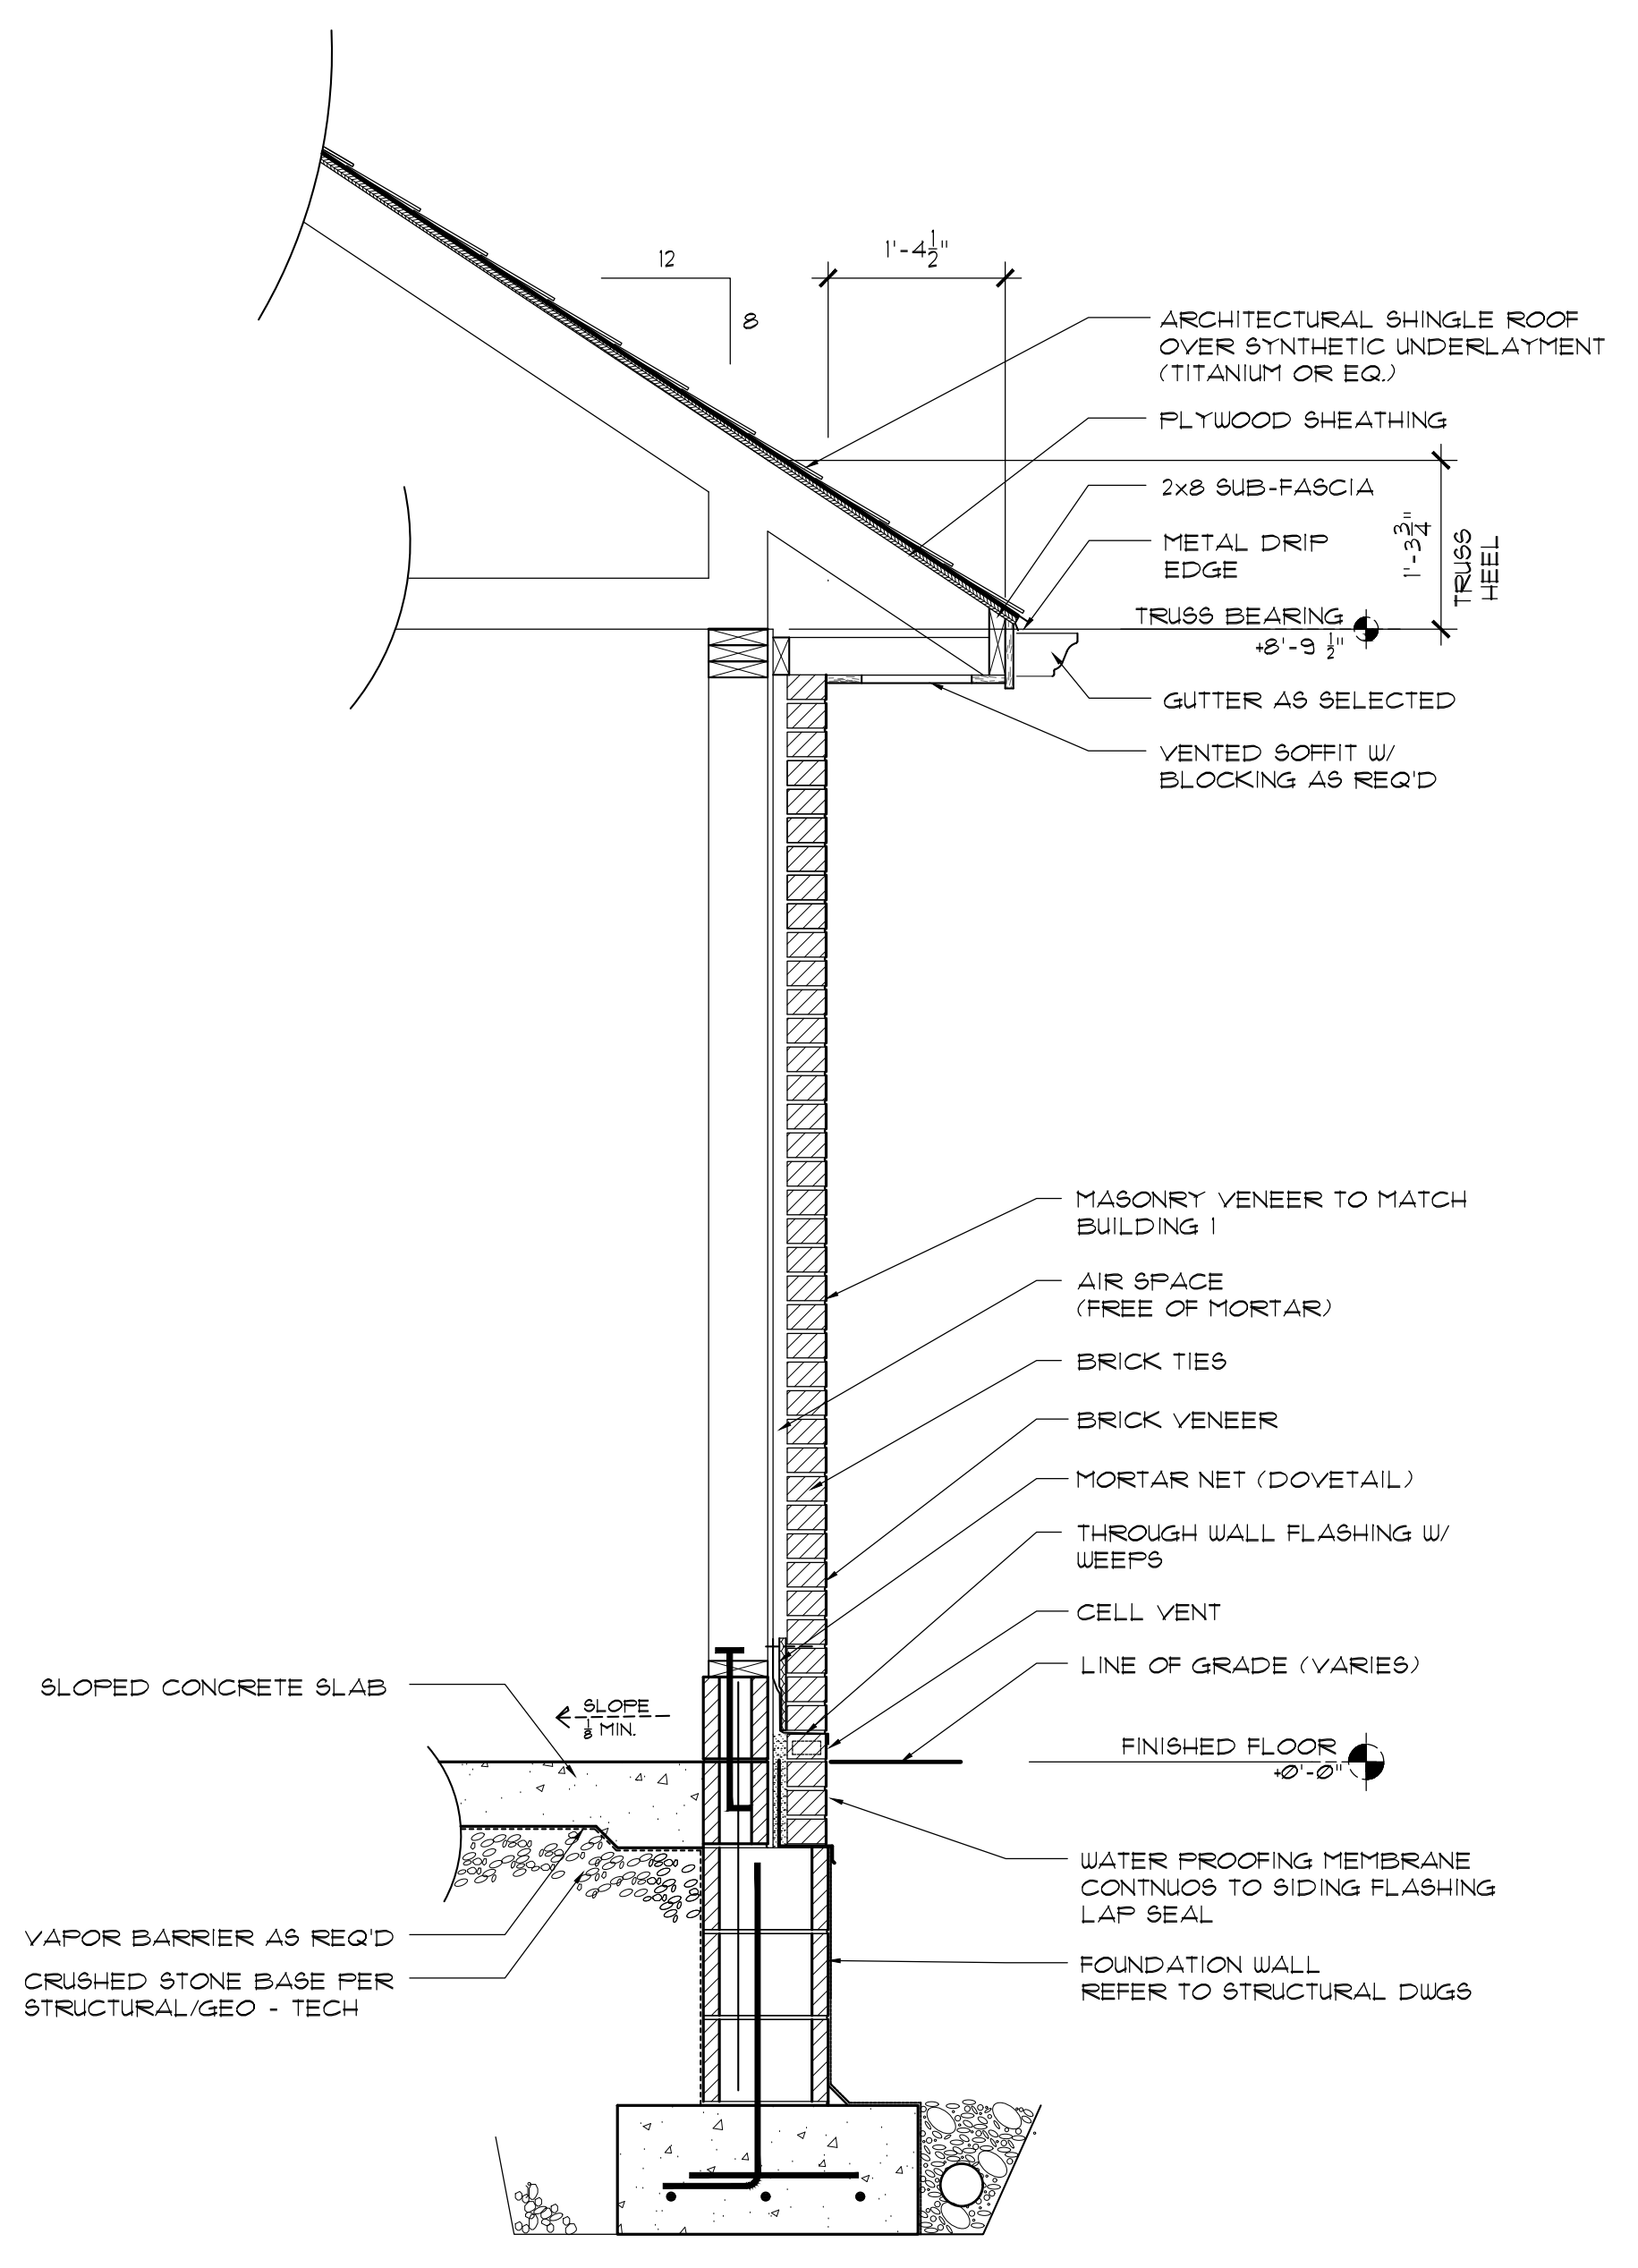

2 WALL SECTION
 SCALE: 3/4"=1'-0"

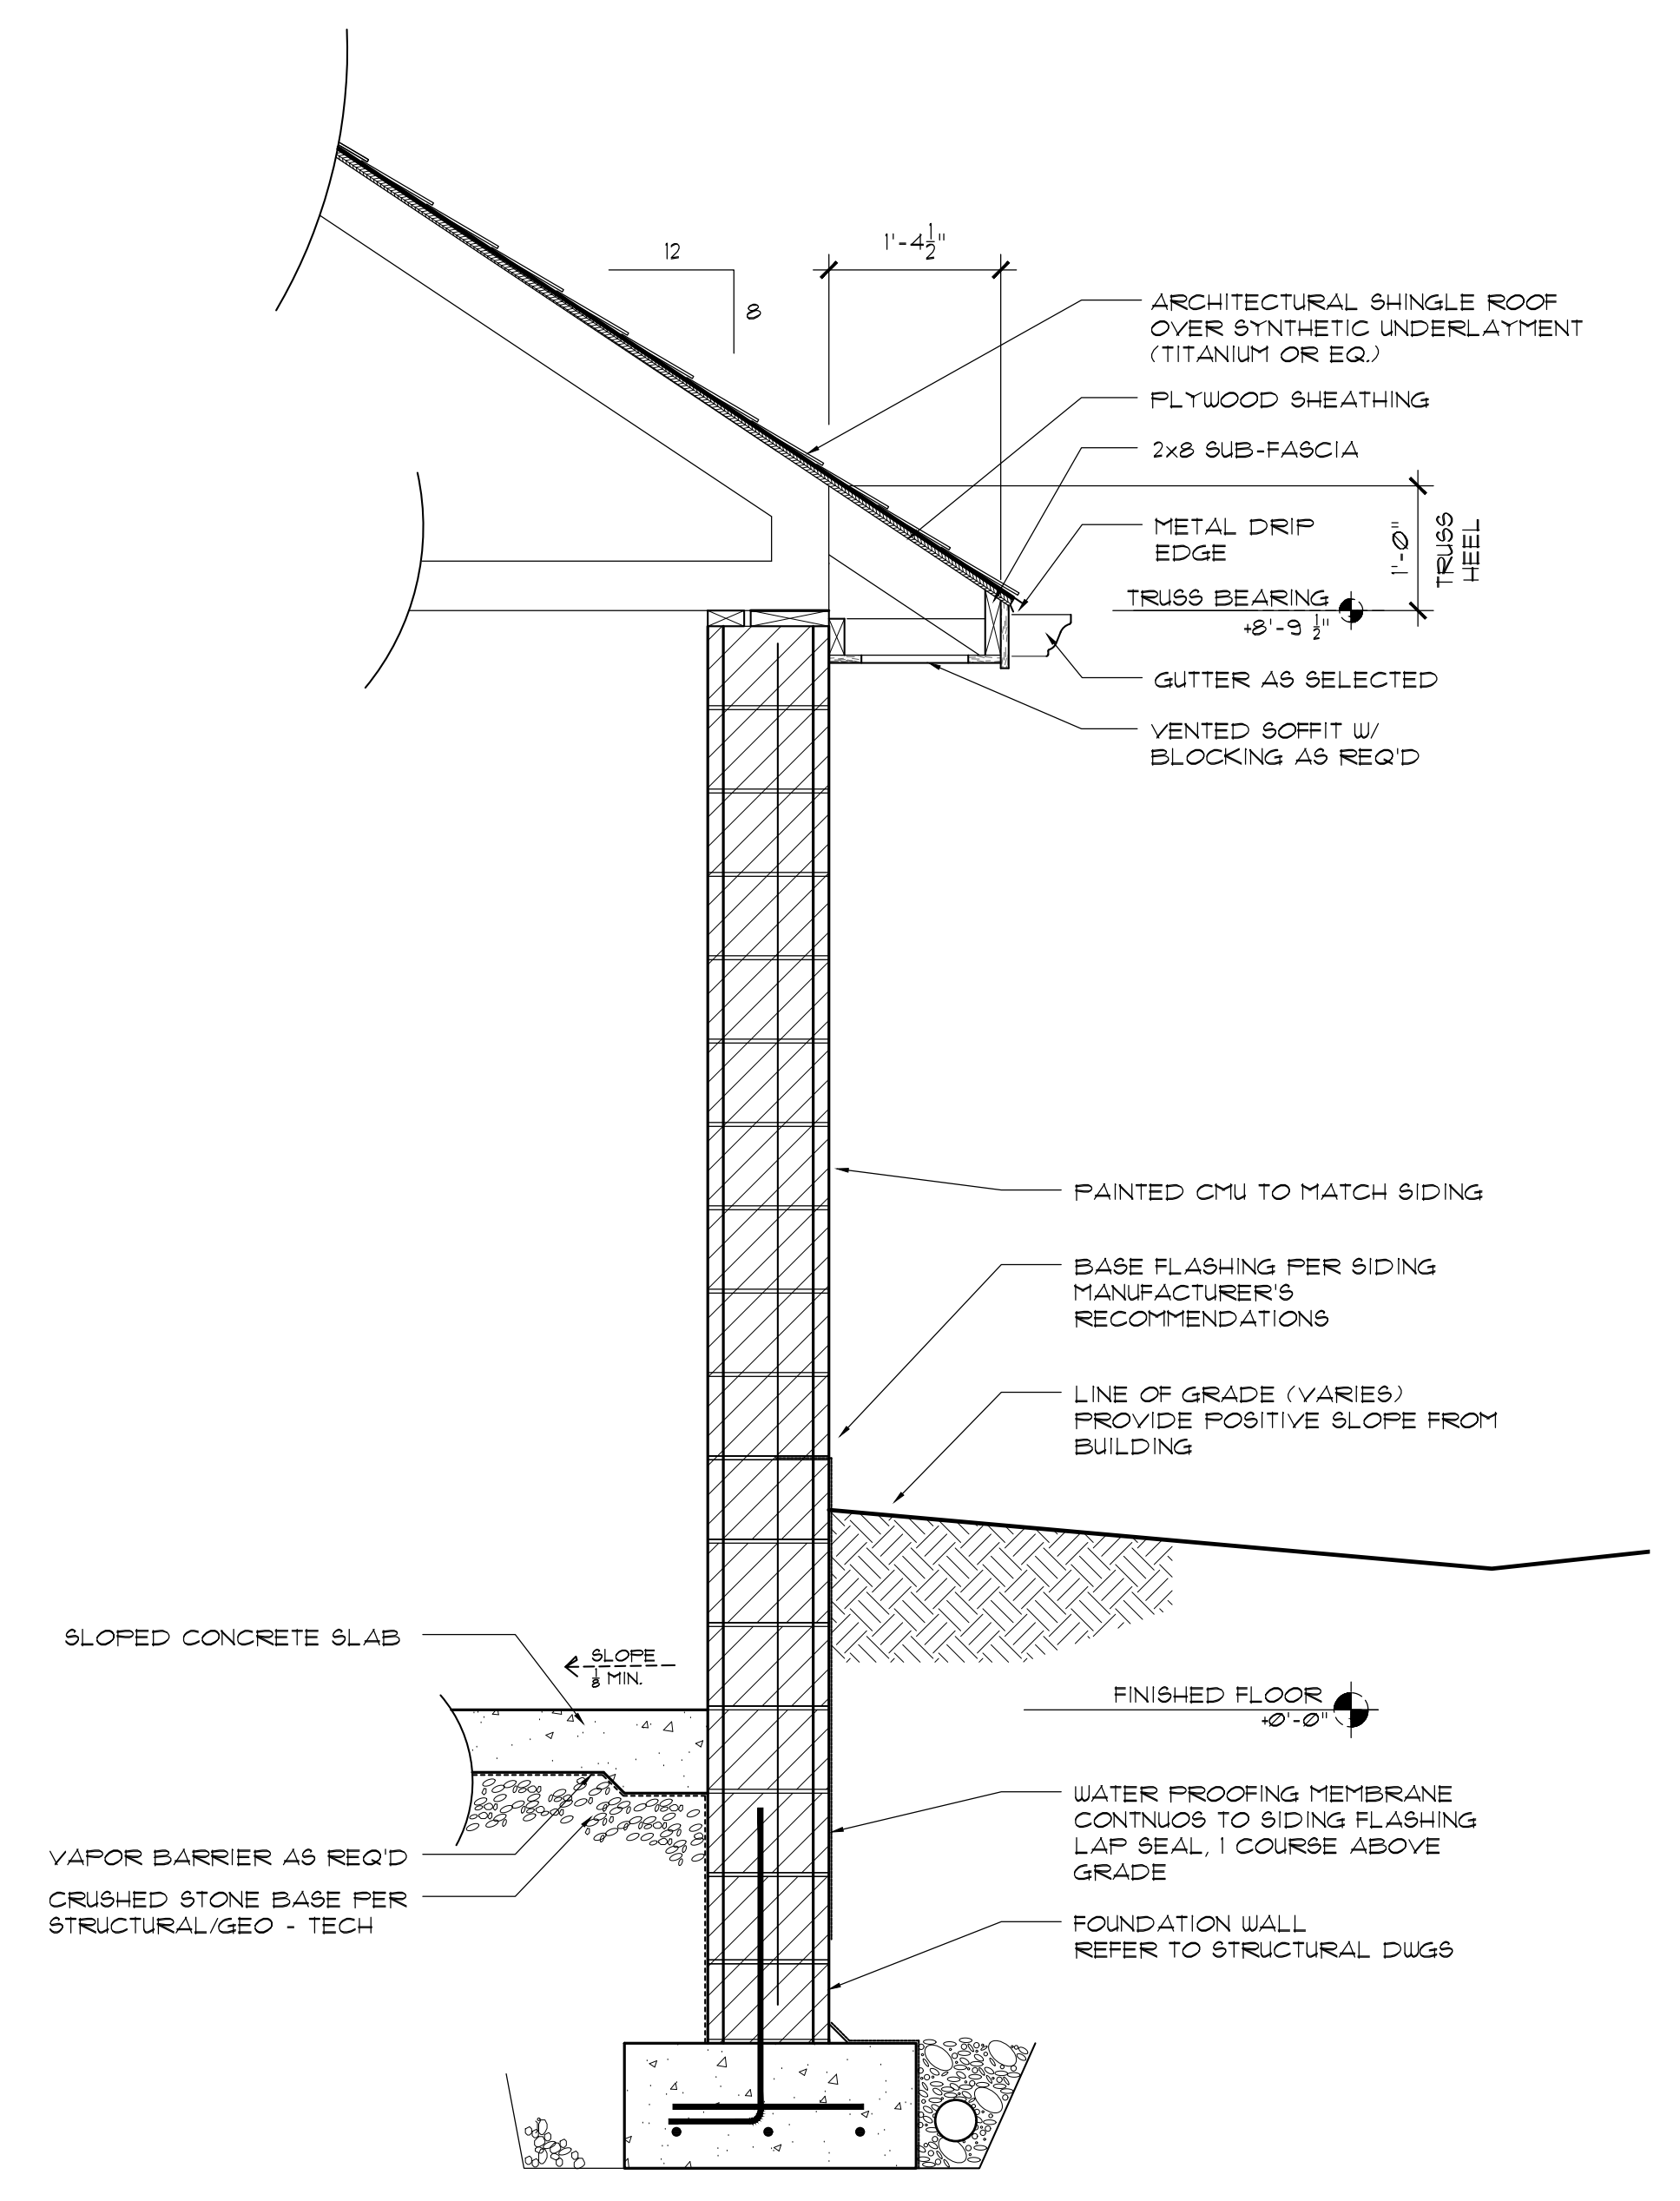

1 WALL SECTION
 SCALE: 3/4"=1'-0"

BASIC TENSION LAP SPLICES—CLASS B&C
(GRADE 60 BARS — NORMAL WEIGHT CONCRETE — BARS OTHER THAN TOP BARS)

BAR SIZE	$f'_c = 3000\text{psi}$	$f'_c = 4000\text{psi}$	$f'_c = 5000\text{psi}$
	SPLICE	SPLICE	SPLICE
#3	1'-4"	1'-4"	1'-4"
#4	1'-5"	1'-4"	1'-4"
#5	1'-9"	1'-8"	1'-8"
#6	2'-1"	2'-0"	2'-0"
#7	2'-10"	2'-6"	2'-4"
#8	3'-9"	3'-3"	3'-0"
#9	4'-9"	4'-2"	3'-8"
#10	6'-4"	5'-2"	4'-8"
#11	7'-5"	6'-5"	5'-4"

TENSION LAP SPLICES—CLASS B&C FOR TOP BARS
(GRADE 60 BARS — NORMAL WEIGHT CONCRETE)

BAR SIZE	$f'_c = 3000\text{psi}$	$f'_c = 4000\text{psi}$	$f'_c = 5000\text{psi}$
	SPLICE	SPLICE	SPLICE
#3	1'-4"	1'-4"	1'-4"
#4	1'-10"	1'-10"	1'-10"
#5	2'-3"	2'-3"	2'-3"
#6	2'-11"	2'-9"	2'-9"
#7	4'-0"	3'-5"	3'-2"
#8	5'-3"	4'-7"	4'-1"
#9	6'-8"	5'-9"	5'-2"
#10	8'-6"	7'-4"	6'-6"
#11	10'-4"	9'-0"	8'-0"

1/4" TENSION DEVELOPMENT LENGTH
(GRADE 60 BARS — NORMAL WEIGHT CONCRETE)

BAR SIZE	$f'_c = 3000\text{psi}$	$f'_c = 4000\text{psi}$	$f'_c = 5000\text{psi}$
	ld TOP	ld BOT	ld TOP
#3	1'-1"	1'-0"	1'-1"
#4	1'-5"	1'-0"	1'-5"
#5	1'-9"	1'-3"	1'-9"
#6	2'-3"	1'-7"	2'-1"
#7	3'-1"	2'-2"	2'-6"
#8	4'-0"	2'-11"	3'-2"
#9	5'-2"	3'-8"	4'-0"
#10	6'-6"	4'-8"	5'-0"
#11	8'-0"	5'-8"	6'-2"


1/4" TENSION DEVELOPMENT (EMBEDMENT) LENGTH FOR STANDARD END HOOKS
(GRADE 60 BARS—NORMAL WEIGHT CONCRETE—GENERAL USE)

BAR SIZE	$f'_c = 3000\text{psi}$	$f'_c = 4000\text{psi}$	$f'_c = 5000\text{psi}$
	ldh	ldh	ldh
#3	8"	7"	6 1/2"
#4	11"	9 1/2"	8 1/2"
#5	14"	12"	10 1/2"
#6	1'-5"	1'-3"	12 1/2"
#7	1'-7"	1'-5"	1'-3"
#8	1'-10"	1'-7"	1'-5"
#9	2'-1"	1'-10"	1'-7"
#10	2'-4"	2'-0"	1'-10"
#11	2'-7"	2'-3"	2'-0"


TOLERANCES IN PLACEMENT OF REINFORCEMENT

REINFORCED CONCRETE		
EFFECTIVE DEPTH d, (INCHES)	TOLERANCE ON d, (INCHES)	TOLERANCE ON MINIMUM COVER ON REINFORCEMENTS, (INCHES)
d ≤ 8	± 3/8	-3/8
d > 8	± 1/2	-1/2

REINFORCED MASONRY		
EFFECTIVE DEPTH d, (INCHES)	TOLERANCE ON d, (INCHES)	TOLERANCE ON MINIMUM COVER ON REINFORCEMENTS, (INCHES)
d ≤ 8	± 1/2	-3/8
8 < d ≤ 24	± 1	-1/2
d > 24	± 1 1/4	-1/2

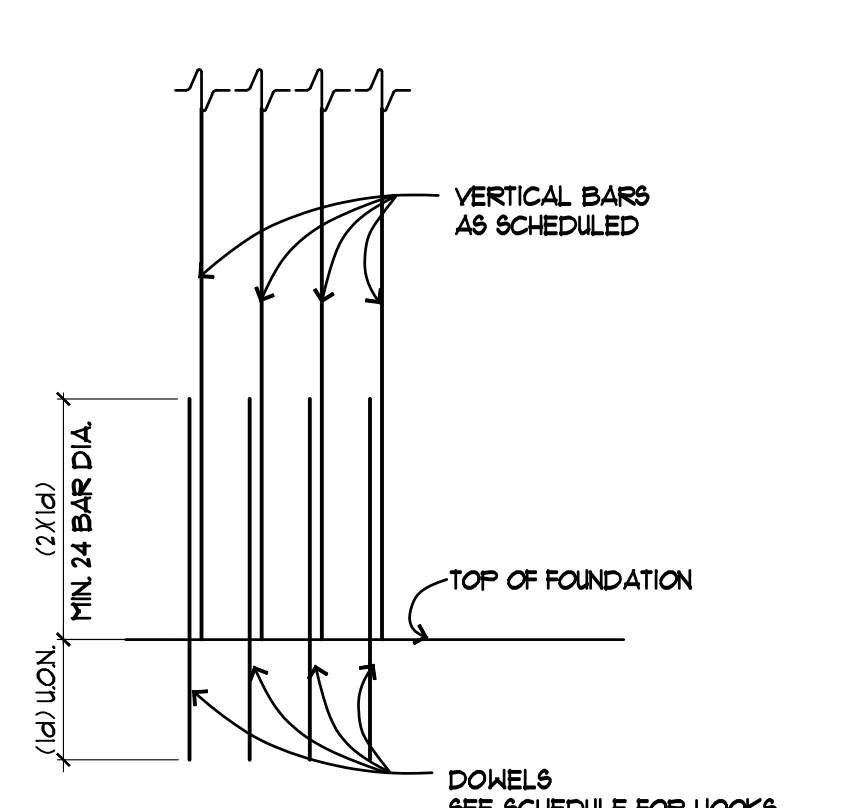

1 BAR SPLICE @ FOUNDATION
NT.S. FILE:

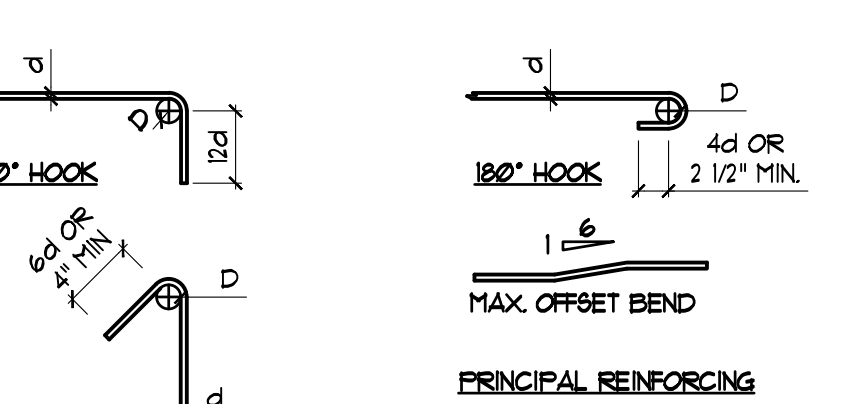


2 BAR BENDS
NT.S. FILE:


TIE OR STIRRUP
NOTE: 1. ALL BENDS SHALL BE MADE COLD.
2. FOR 'D' ETC. SEE CRSI HANDBOOK GOVERNING EDITION.

BAR DIA.	MIN 'D'
#3	1 1/2"
#4	2"
#5	2 1/2"
#6	3"
#7	3 1/2"
#8	4"
#9	4 1/2"
#10	5"
#11	5 1/2"


3 SLAB CONTROL JOINT DETAIL
NT.S. FILE:

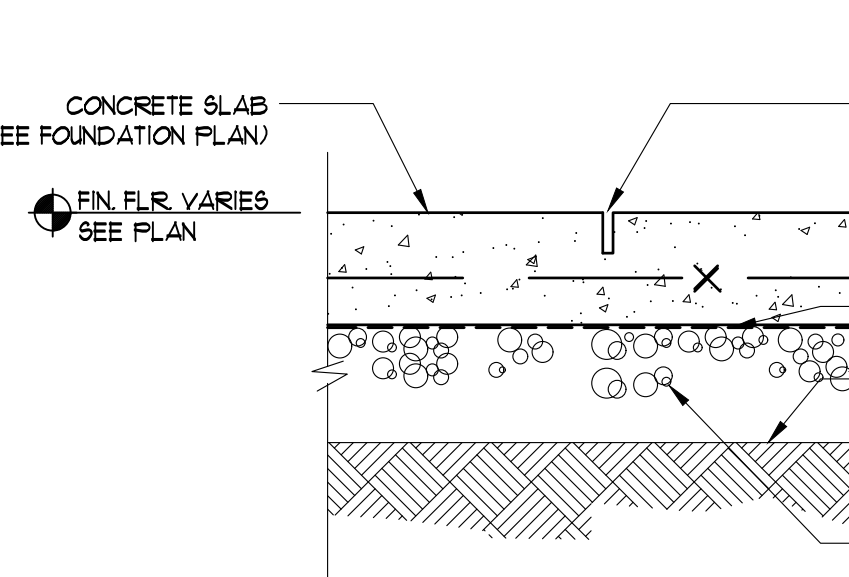



4 TYP. WALL OR BEAM CORNER BAR PLACING DETAIL
NT.S. FILE:

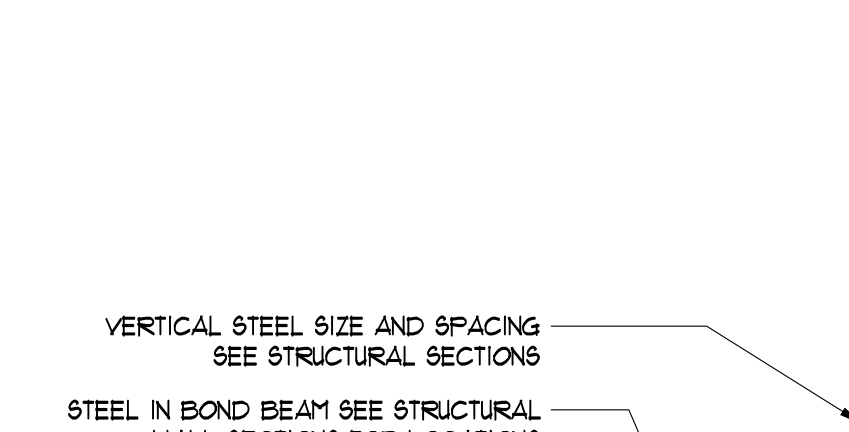


5 WALL CONTROL JOINT DETAIL
NT.S. FILE:

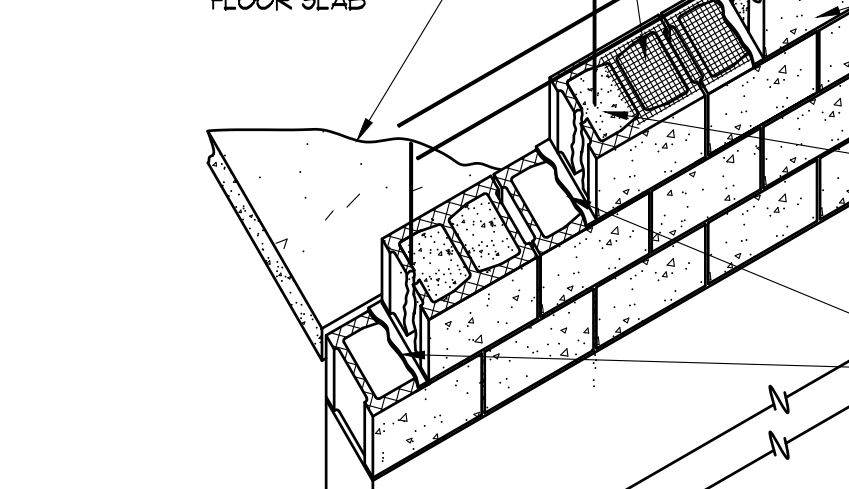


6 TYP. WALL & BOND BEAM REINFORCING DETAIL
NT.S. FILE:

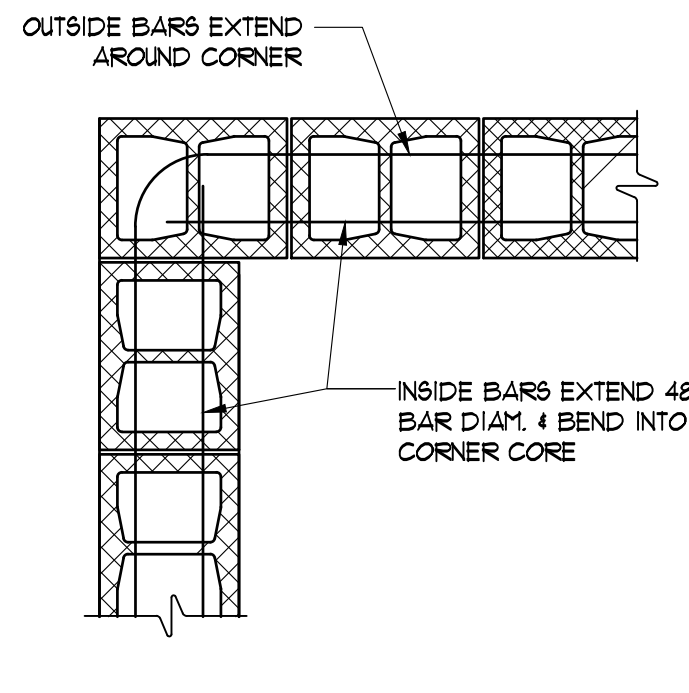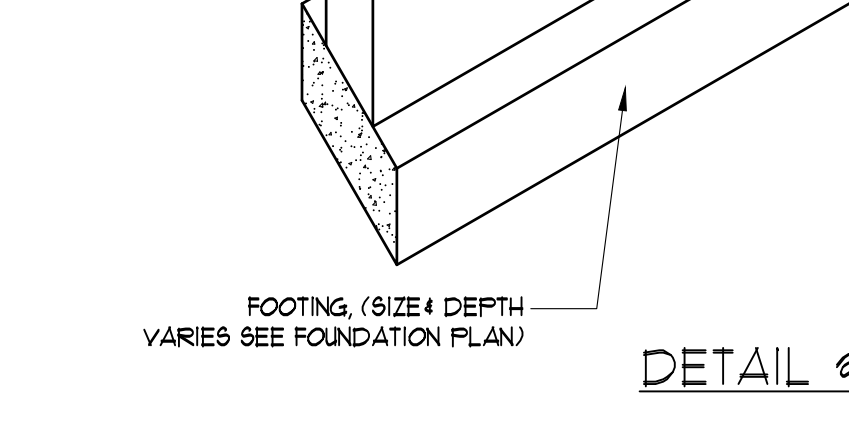

EXTERIOR BOND BEAM

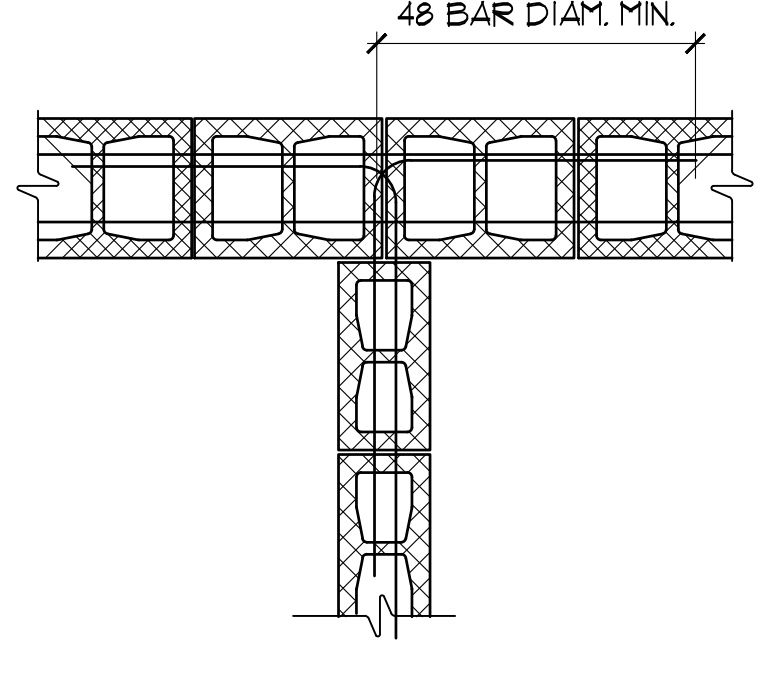


INTERIOR BOND BEAM

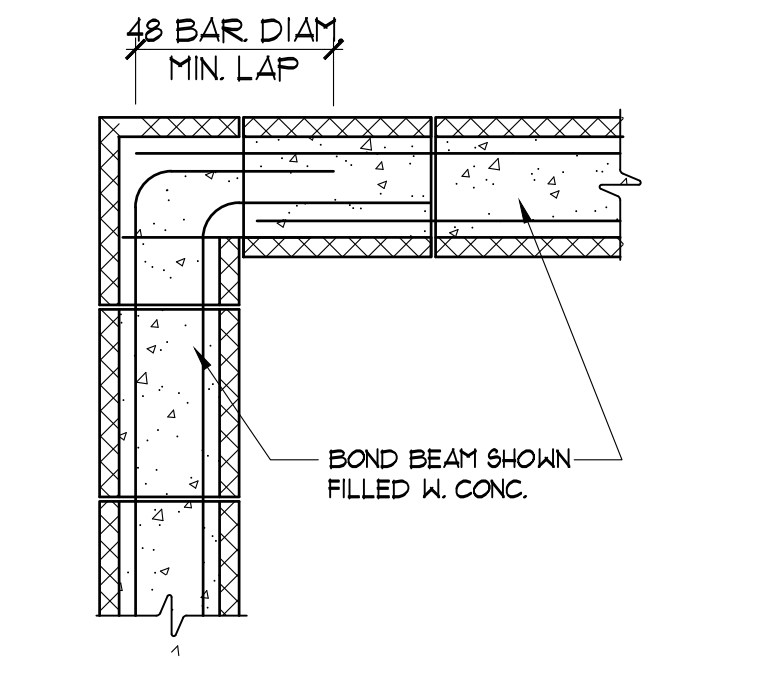

EXTERIOR BOND BEAMS, ALTERNATE DETAILS



DOUBLE TIE

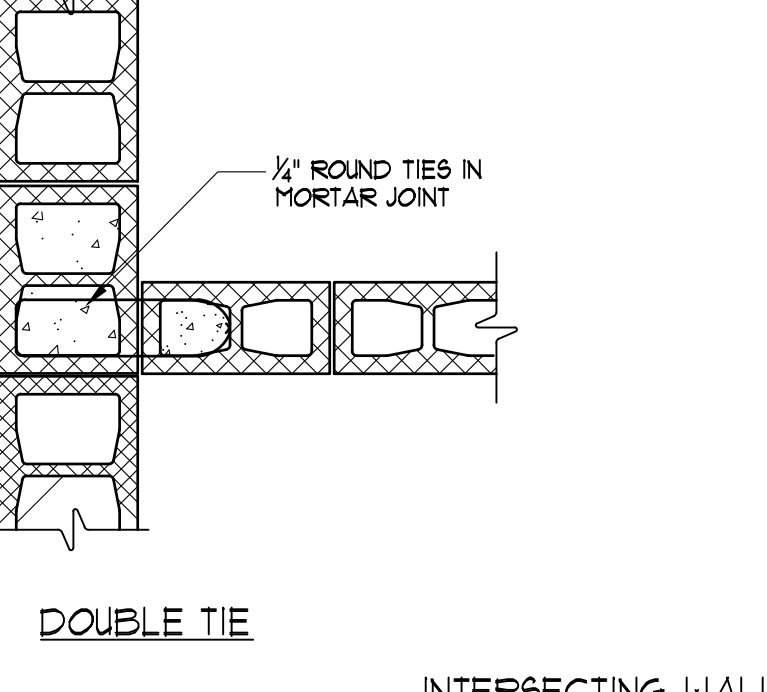

SINGLE TIE

7 TYP. MASONRY DETAILS
NT.S. FILE:




PLAN AT CORNER




PLAN AT INTERSECTION

8 TYP. BRICK VENEER DETAIL & NOTES
NT.S. FILE:

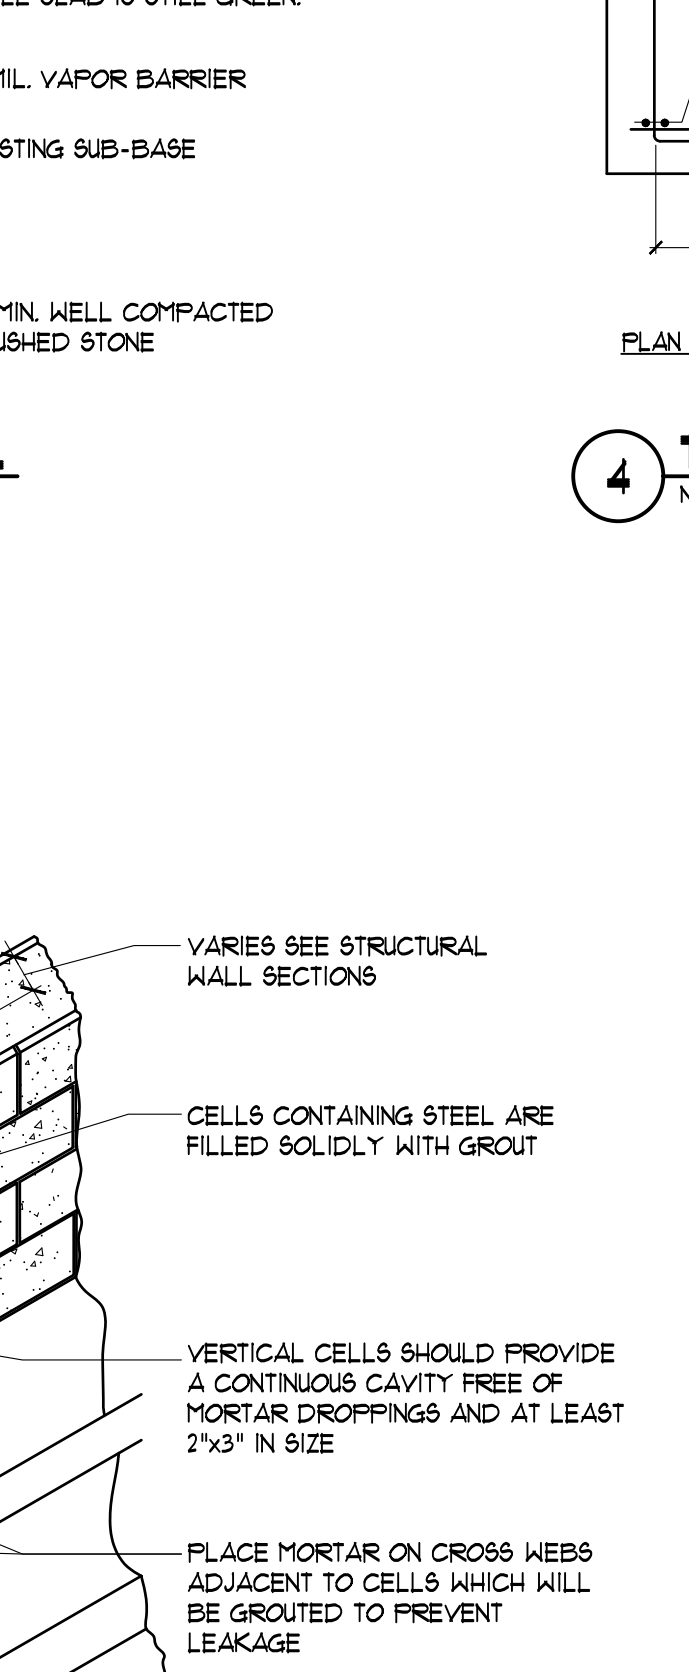


- BRICK WORK NOTES:**
- TIES: ALL TIES MUST BE EMBEDDED AT LEAST 2" INTO THE BED JOINTS OF THE BRICK VENEER. THEY MUST BE SECURELY ATTACHED TO THE STUDS THROUGH THE SHEATHING, AND NOT THE SHEATHING ALONE. ADDITIONAL TIES SHALL BE INSTALLED AT APPROXIMATELY 8' O.C. AT JAMBS AND NEAR EDGES. TIES SHALL BE HOT-DIPPED GALVANIZED IN ACCORDANCE WITH ASTM C 93, CLASS B-3. IN ADDITION, TIES SHOULD NOT HAVE MECHANICAL PLAY IN EXCESS OF 0.02" AND SHALL NOT DEFORM OVER 0.05" FOR A 100# LOAD IN EITHER TENSION OR COMPRESSION. TWO SQUARE FEET MAXIMUM WALL SURFACE AREA PER TIE.
 - MORTAR: USE PORTLAND CEMENT - LIME MORTARS, CONFORMING TO ASTM C 2700 OR BIA M-12, TYPE B.
 - FLASHING: FLASHING MUST BE PLACED AT ALL POINTS WHERE THE WALL IS INTERRUPTED (WINDOW AND DOOR HEADS, SILLS, SHELF ANGLES ETC.) ALSO IT SHOULD BE INSTALLED AT THE TOP AND BOTTOM OF THE WALL.
 - WEEPHOLES: WEEPHOLES SHALL BE PLACED AT ALL FLASHING LOCATIONS, SPACING SHALL NOT EXCEED 24" O.C.
 - 'TYVEK' BUILDING WRAP: LAP ENDS AND EDGES 6" MIN TAPE ALL SEAMS.
 - FILLING OF MORTAR JOINTS: ALL MORTAR JOINTS SHOULD BE COMPLETELY FILLED EXCEPT FOR AIR SPACES, EXPANSION JOINTS, ETC. THEY SHALL BE KEPT CLEAN AND FREE OF MORTAR AND/OR MORTAR DROPPINGS.
 - HORIZONTAL EXPANSION JOINTS: JOINTS SHALL BE PLACED BENEATH EACH ANGLE (WITH COMPRESSIBLE MATERIAL BELOW SHELF ANGLES).

9 CMU CONTROL JOINT @ BOND BEAM
NT.S. FILE:

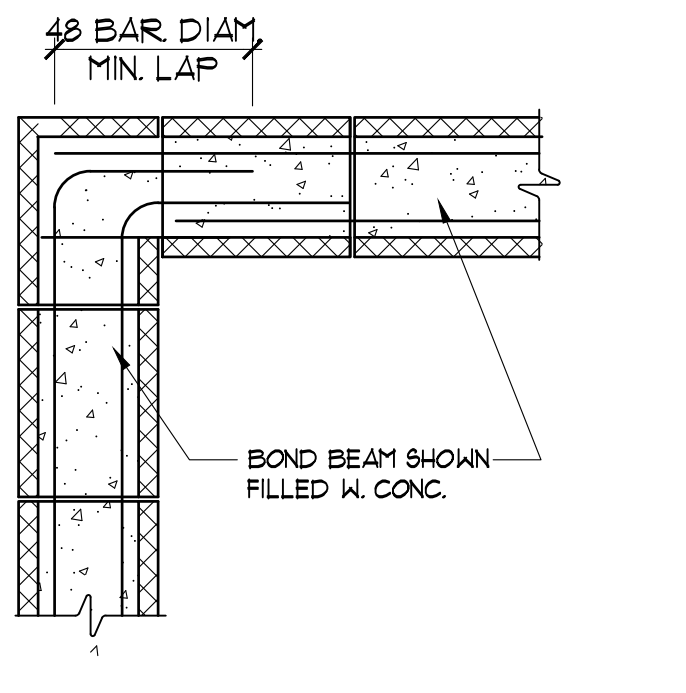


WALL CONTROL JOINT DETAIL

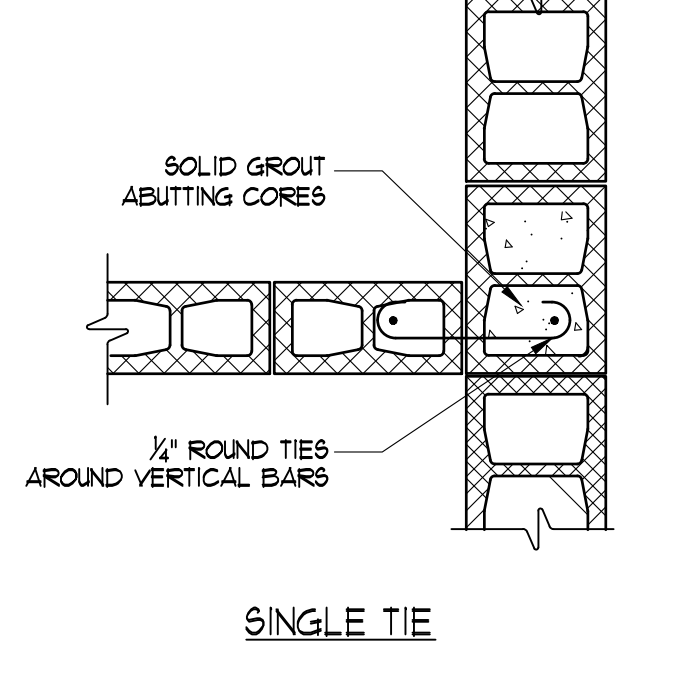


WOOD

- MISCELLANEOUS**
- Provide shop drawings for pre-engineered wood roof trusses, wood framing, and reinforcing for approval before fabrication.
 - Submit concrete mix design to arch/eng. for review prior to start of construction.


10 TYP. WALL TIE (NT.S.)
NOTE: SHAPE OF TIES SHOWN IS GENERIC. SEE SPECIFICATIONS FOR ACTUAL TYPE / CONFIGURATION OF TIES TO BE USED.

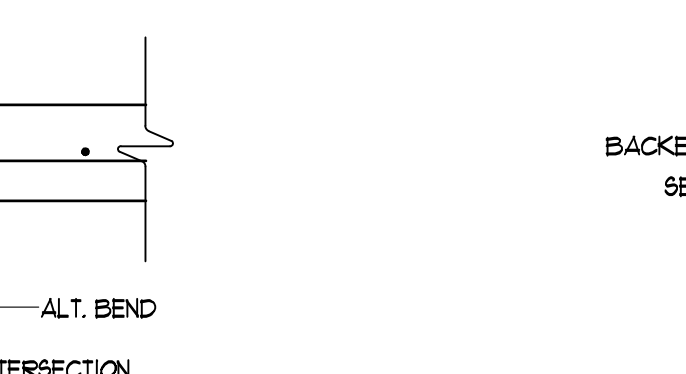


11 TYP. WALL TIE (NT.S.)
NOTE: SHAPE OF TIES SHOWN IS GENERIC. SEE SPECIFICATIONS FOR ACTUAL TYPE / CONFIGURATION OF TIES TO BE USED.

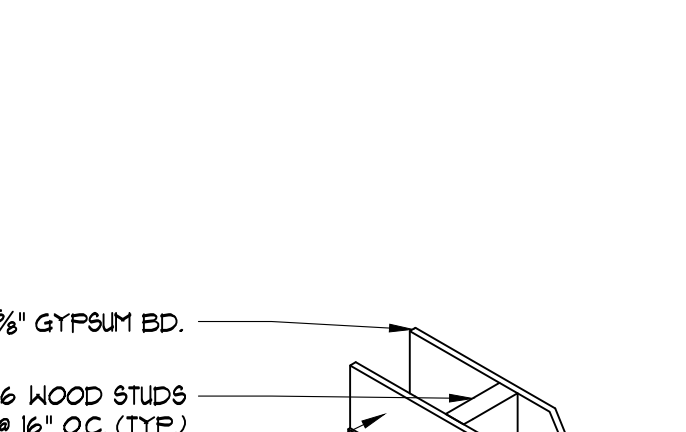

12 TYP. WALL TIE (NT.S.)
NOTE: SHAPE OF TIES SHOWN IS GENERIC. SEE SPECIFICATIONS FOR ACTUAL TYPE / CONFIGURATION OF TIES TO BE USED.

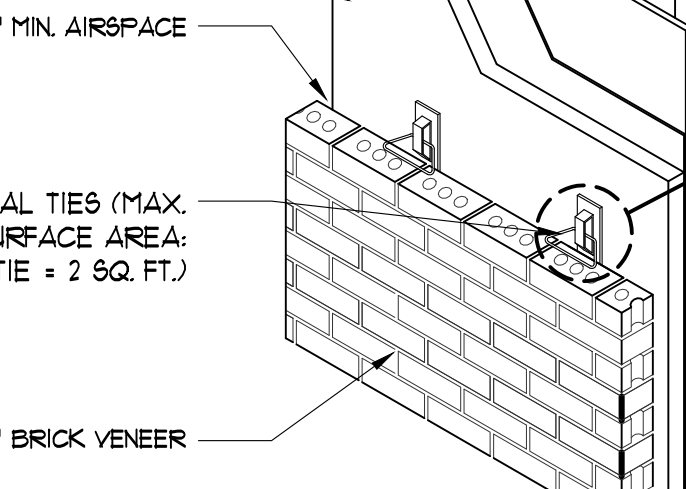

13 TYP. WALL TIE (NT.S.)
NOTE: SHAPE OF TIES SHOWN IS GENERIC. SEE SPECIFICATIONS FOR ACTUAL TYPE / CONFIGURATION OF TIES TO BE USED.

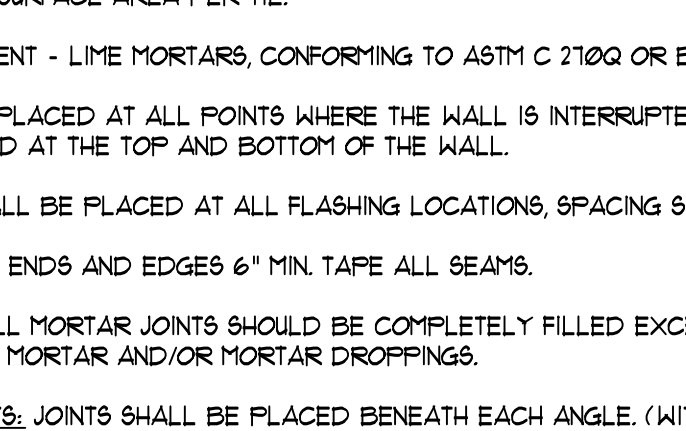

14 TYP. WALL TIE (NT.S.)
NOTE: SHAPE OF TIES SHOWN IS GENERIC. SEE SPECIFICATIONS FOR ACTUAL TYPE / CONFIGURATION OF TIES TO BE USED.



STRUCTURAL NOTES:

I. GENERAL NOTES

- The building code used is the 2018 Residential Code of New York State (2018 RCNYS). All editions of applicable codes and standards shall be those referenced within the RCNYS.
- The General Contractor shall coordinate all Civil, Architectural, Structural, Mechanical, Electrical and Plumbing drawings and report any discrepancies to the engineer prior to construction.
- The contractor shall verify all dimensions and conditions in the field prior to commencing work. If any discrepancies are found within the Structural Drawings and/or Structural Notes, the architect shall govern and the engineer shall be notified of any discrepancies that may exist.
- See architectural drawings for floor elevations, slope and the location of depressed floor areas. The contractor shall compare the structural sections with the architectural sections and report any discrepancy to the Architect prior to building.
- The General Contractor shall provide all necessary temporary shoring and/or bracing during construction to maintain the safety and integrity of all building elements until construction is complete.
- Furring over concrete or conc. masonry is often not shown on structural plans; composite walls are often shown as if they are all CMU or concrete. Do not scale block thickness from structural drawings. See architectural drawings for thickness of block where not dimensioned and for location of masonry within composite walls.

II. CONCRETE

A. MATERIAL PROPERTIES

- Concrete minimum strength in 28 days to be 4000 psi for slabs and footings.
- Bar reinforcing - ASTM A615, Grade 60
Welded wire fabric ASTM A185.

B. INSTALLATION

- Unless otherwise shown, all reinforcing shall be detailed in accordance with ACI 318.
- Unless otherwise noted, reinforcing shall have the following minimum concrete covers: 3" cover where formed and against earth, 2" where formed and against earth, and 1" where formed and not against earth. See ACI Code.
- Unless otherwise shown, reinforcing splices shall be minimum 36 bar diameters.
- Provide 3/4" chamfer at all exposed concrete corners & edges.
- Provide corner bars at all intersections and corners, e.g.: bond beams, grade beams, footings, etc.
- Concrete exposed to freeze-thaw cycles (including but not limited to exterior slabs) shall have 4% - 6% entrained air.
- Special attention shall be given to concrete placed during hot or cold weather. All special practices prescribed by ACI shall be followed during the placement of concrete during special weather conditions.
- Provide curing of concrete slabs immediately after finishing using a sprayed on dispersing-resin liquid curing compound conforming to ASTM C309. All scuffs or abrasions to the curing membrane shall be recoated daily. Other curing methods may be used with approval by the Structural Engineer.

III. CONCRETE MASONRY

A. MATERIAL PROPERTIES

- Concrete block units shall conform to ASTM C90, Type I, Grade N.
- Mortar - ASTM C270, Type S (m=1500 psi)
- Block fill - ASTM C416, course grout (fc=3000 psi)
- Reinforcing:
Bars - ASTM A615, Grade 60
Ladder type masonry joint reinforcing ASTM A82

B. INSTALLATION

- All concrete block work to have "DUR-O-WALL" (ladder type) or equal every 2nd course, or as indicated on drawings.
- Provide control joints in masonry wall at maximum 32 feet on center, or as noted on the drawings.
- Keep cores of reinforced masonry free of mortar droppings, provide cleanouts at base of every core.
- Fill block cores solid under lintels, beam pockets, and all bearing plates with 3000 psi grout.
- Fill block cores solid around all rebar with 3000 psi grout.
- Concrete block masonry shall be set in full mortar bedding.
- Lap splices of reinforcing bars shall be 40 bar diameters but not less than 24".

IV. WOOD

- Wood dimensional lumber to be Hem-Fir #2 (or equal) with minimum NDS reference design values equal to:
Bending (F_b) = 850 psi
Compression Parallel to Grain (F_c) = 1300 psi
Modulus of Elasticity (E) = 1,300,000 psi
Min. Modulus of Elasticity (E_{min}) = 410,000 psi
Shear Parallel to Grain (F_v) = 80 psi
- Microllan / LVL beams to meet minimum reference design values equal to:
Bending (F_b) = 2,600 psi
Compression Parallel to Grain (F_c) = 1,500 psi
Modulus of Elasticity (E) = 2,000,000 psi
Min. Modulus of Elasticity (E_{min}) = 1,016,535 psi
Shear Parallel to Grain (F_v) = 85 psi
- All interior, covered framing lumber to be kiln dried, with a maximum moisture content (MC) of 18%.
- The General Contractor shall reject all poor quality lumber that is not suitable for its intended purpose, regardless of grade.
- Continuously glue and connect all headers with 2 rows of led common nails at 12" o.c. max.
- All interior headers at non-load bearing walls to be 2x6's with 1/2" plywood in between-unless otherwise noted.
- Provide solid blocking under all header supports down to masonry wall or beams.
- Double studs under each end of headers-unless otherwise noted.
- Wood in contact with masonry, conc. or earth or within 1'-0" of grade if exposed shall be pressure treated.
- Wood joists and rafters to have a minimum bearing length of 1'-1/2" on wood or metal, and not less than 3" on masonry or concrete.
- A metal joist/rafter hanger, etc. shall always be provided at face-mounted members.
- Framing anchors, joist hanger, etc. shall be galvanized steel (16 ga. min.) install in strict accordance with mfr's instructions, including mfr's specified fasteners. Provide products by Simpson Co. or approved proposed substitute.
- For exterior walls see framing plan, provide and install 2x6 blocking @ 4'-0" o.c. or at plywood panel edges.
- Wall sheathing at exterior walls: 1/2" exterior grade APA rated CDX plywood.
- Roof sheathing: 1/2" exterior grade APA rated CDX plywood (w/ edge support) w/ 1/4" o.c. (min) into all supports.
- Pre-engineered wood roof trusses @ 24" o.c. design by manufacturer. Trusses shall be designed by a NYS licensed engineer & designed to withstand a 30 psf flat roof snow load, 10 psf dead load for top chord, and 10 psf dead load for bottom chord. Trusses must also be designed for snow drift loads at lower roof conditions and valley locations.

V. MISCELLANEOUS

- Provide shop drawings for pre-engineered wood roof trusses, wood framing, and reinforcing for approval before fabrication.
- Submit concrete mix design to arch/eng. for review prior to start of construction.


STATE OF NEW YORK
OFFICE OF THE ENGINEER
REGISTERED PROFESSIONAL ENGINEER
No. 07020
J. HANLON

HANLON ARCHITECTS
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Fax: 585-385-6388
www.TSE123.com
TSE 20-00-12HA

**KILBOURN PLACE APARTMENTS
BUILDING 1 - GARAGE**
PITTSFORD, NEW YORK


REVISED:
ISSUED FOR PERMIT
DATE: 05-12-2022
STRUCTURAL GENERAL
NOTES, REIN. REQUIREMENTS,
& TYP. STRUCTURAL DETAILS
DRAWING TITLE:
S1
SHEET NO:
PROJECT NO:

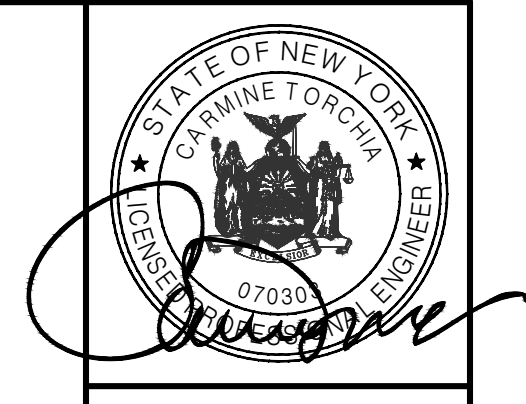

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 P: 585.223.8480
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 625 Panorama Trail
 Suite #210
 Rochester, NY 14625
 www.TSE123.com
 TSE 22-02-12HA

KILBOURN PLACE APARTMENTS
 BUILDING 1 - GARAGE
 PITTSFORD, NEW YORK

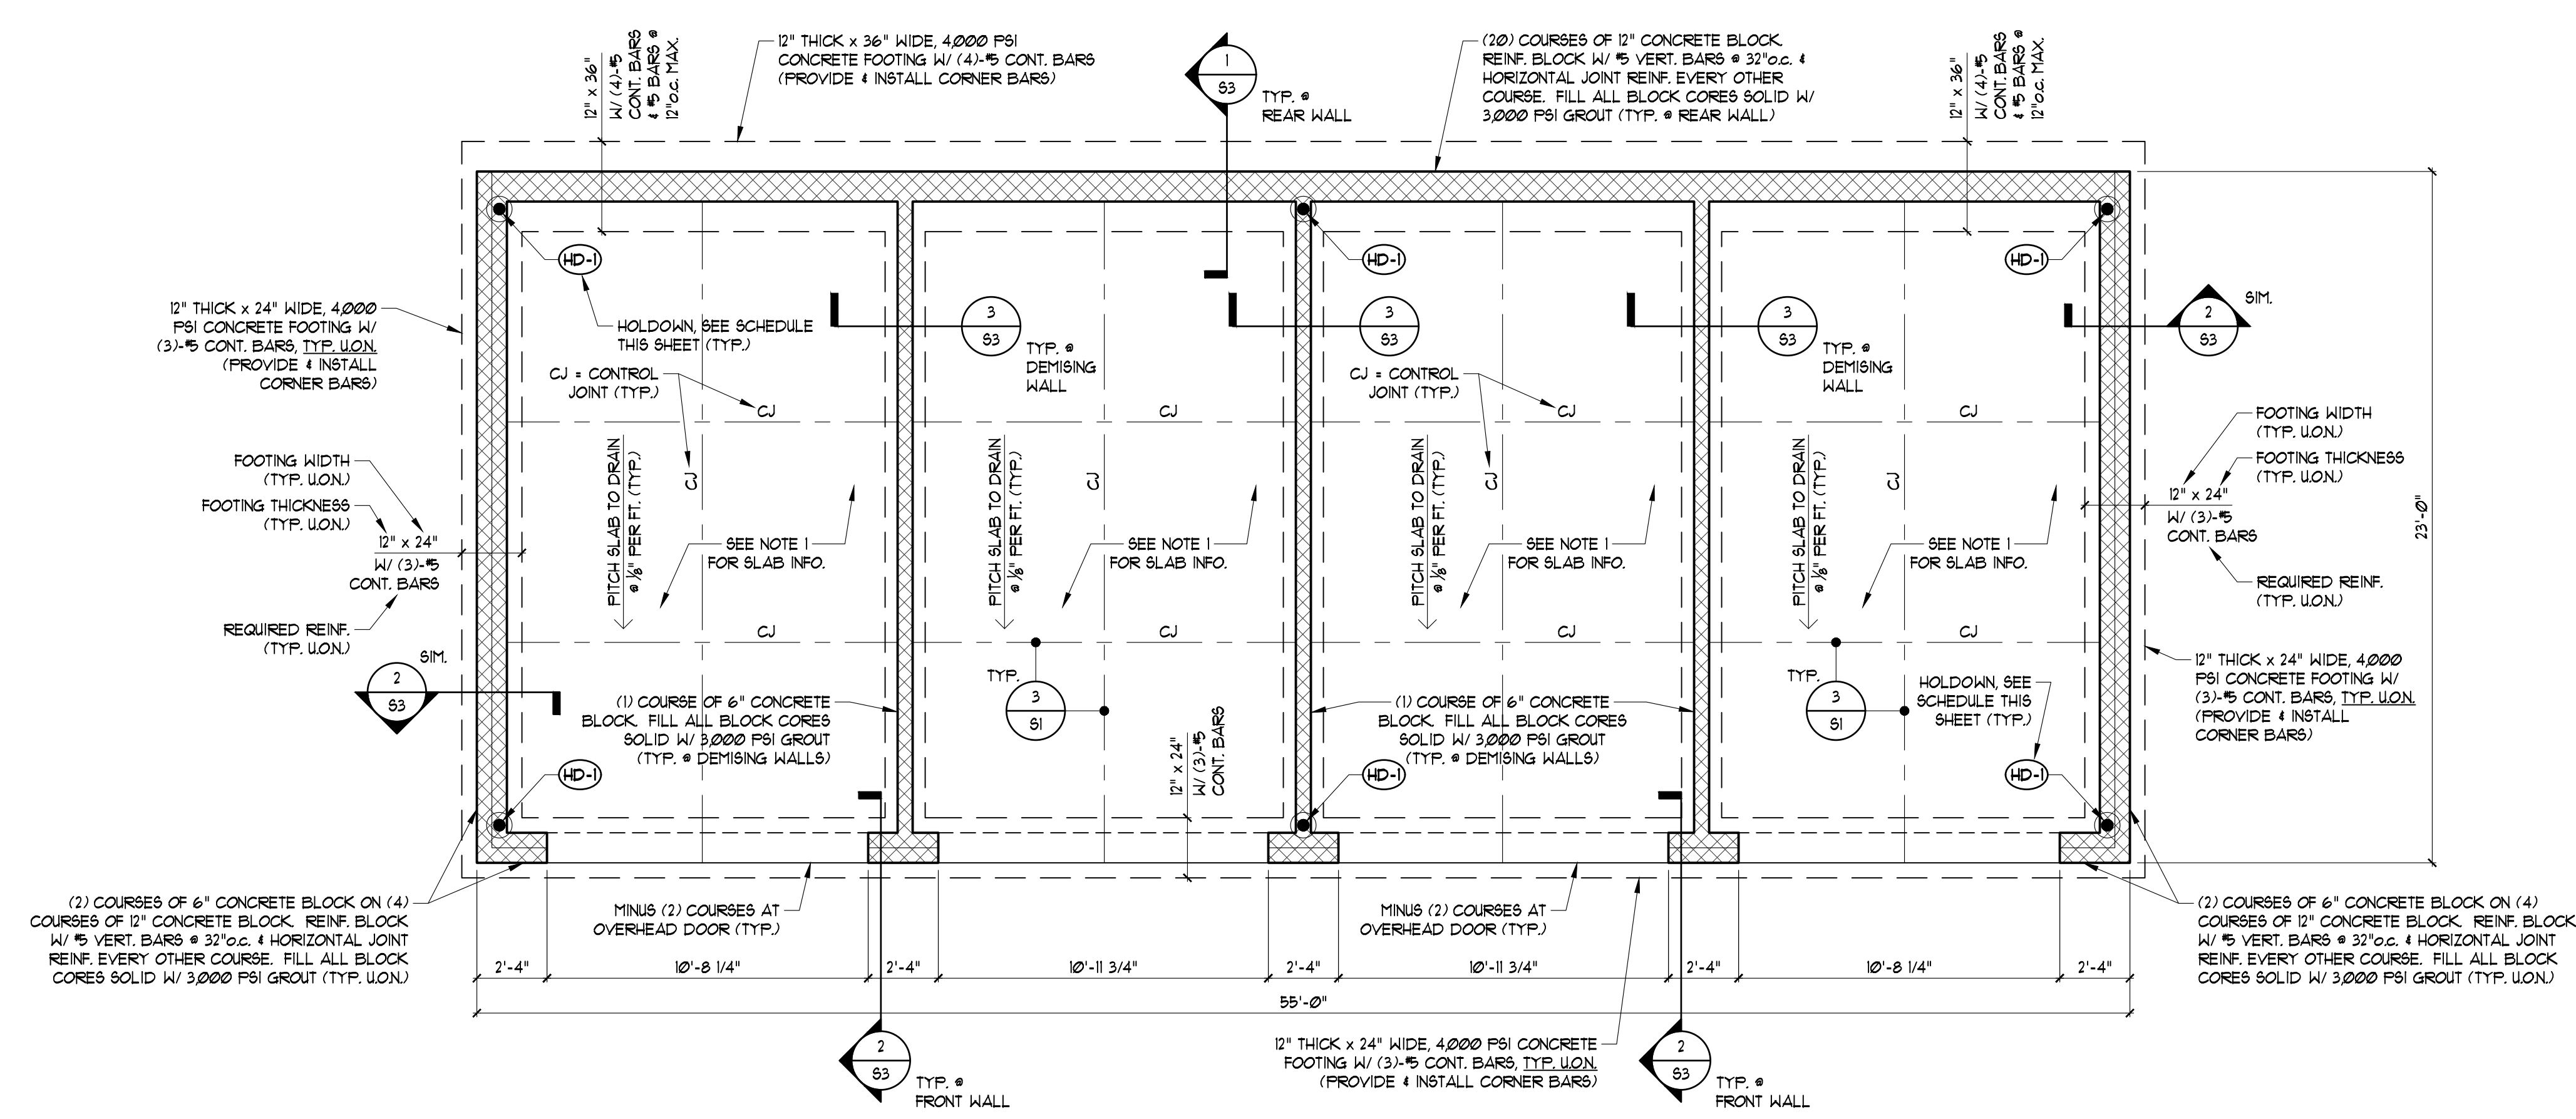

1 FOUNDATION PLAN
 SCALE: 1/4"=1'-0"
 FOUNDATION PLAN NOTES:
 1. GARAGE SLAB TO BE 4" THICK, 4000 PSI CONCRETE W/ 6x6 #10 MESH @ MIDPOINT OF SLAB, OVER 15 MIL VAPOR BARRIER AND 6" MIN. 55% WELL-COMPACTED CRUSHED STONE (TYP.)
 2. SEE ARCHITECTURAL DRAWINGS FOR DIMENSIONS NOT SHOWN HERE. (TYP.)

LEGEND

(SH)	WOOD SHEAR WALL, MARK SEE SCHEDULE THIS SHEET
-----	WOOD SHEAR WALL
(HD)	HOLD-DOWN MARK SEE SCHEDULE THIS SHEET
●	HOLD-DOWN LOCATION SYMBOL SEE FOUNDATION PLAN THIS SHEET

SHEAR WALL SCHEDULE (SH)


MARK	SHEATHING	NAILING		BLOCKING	HOLD-DOWN
		AT PANEL EDGE	AT FIELD		
SH1	7/8" APA-RATED, EXPOSURE 1 SHEATHING	8d @ 6" O.C.	8d @ 12" O.C.	SOLID 2x BLOCKING @ ALL PANEL EDGES	SEE FND. PLAN THIS SHEET

NOTES:
 1. 8d NAILS SHALL BE Ø13/16" x 1-1/2" (COMMON)
 2. FOR STUD INFORMATION AT HOLD-DOWNS, SEE ROOF FRAMING PLAN AND SCHEDULE THIS SHEET.
 3. SHEATHING TO BE TIGHT TO 2x6 WOOD STUDS (ONE SIDE).


HOLD-DOWN SCHEDULE (HD)

MARK	HOLD-DOWN TYPE	MANUFACTURER	MODEL No.	ANCHOR BOLT DIA.	WOOD FASTENER SIZE & ATTACHMENT	MIN. TENSION CAPACITY	STUD PACK AT HOLD-DOWN
HD-1	PRE-DEFLECTED HOLD-DOWN	SIMPSON STRONG-TIE	MD5-SD52.5	5/8"	(14)-1/4" x 2-1/2" SIMPSON SD5 SCREENS	4,340*	(2)-2x6 PIN


NOTES:
 1. FOLLOW ALL MFR. INSTRUCTIONS FOR ATTACHMENT AND INSTALLATION OF HOLD-DOWNS.
 2. USE SIMPSON STRONG-TIE ROD (OR EQ.) THREADED ROD FOR HOLD-DOWN ANCHOR AT DEMISING WALLS. EMBED ANCHOR ROD 8" INTO THICKENED SLAB (W/ A SIMPSON 2½" x 2½" W/4 WASHER PLATE & DOUBLE NUT EMBEDDED WITHIN SLAB) AT EXTERIOR WALLS. EMBED ANCHOR ROD 16" INTO CMU WALL & LOCATE (1)-#5 VERT. BAR IN AN ADJACENT BLOCK CORE

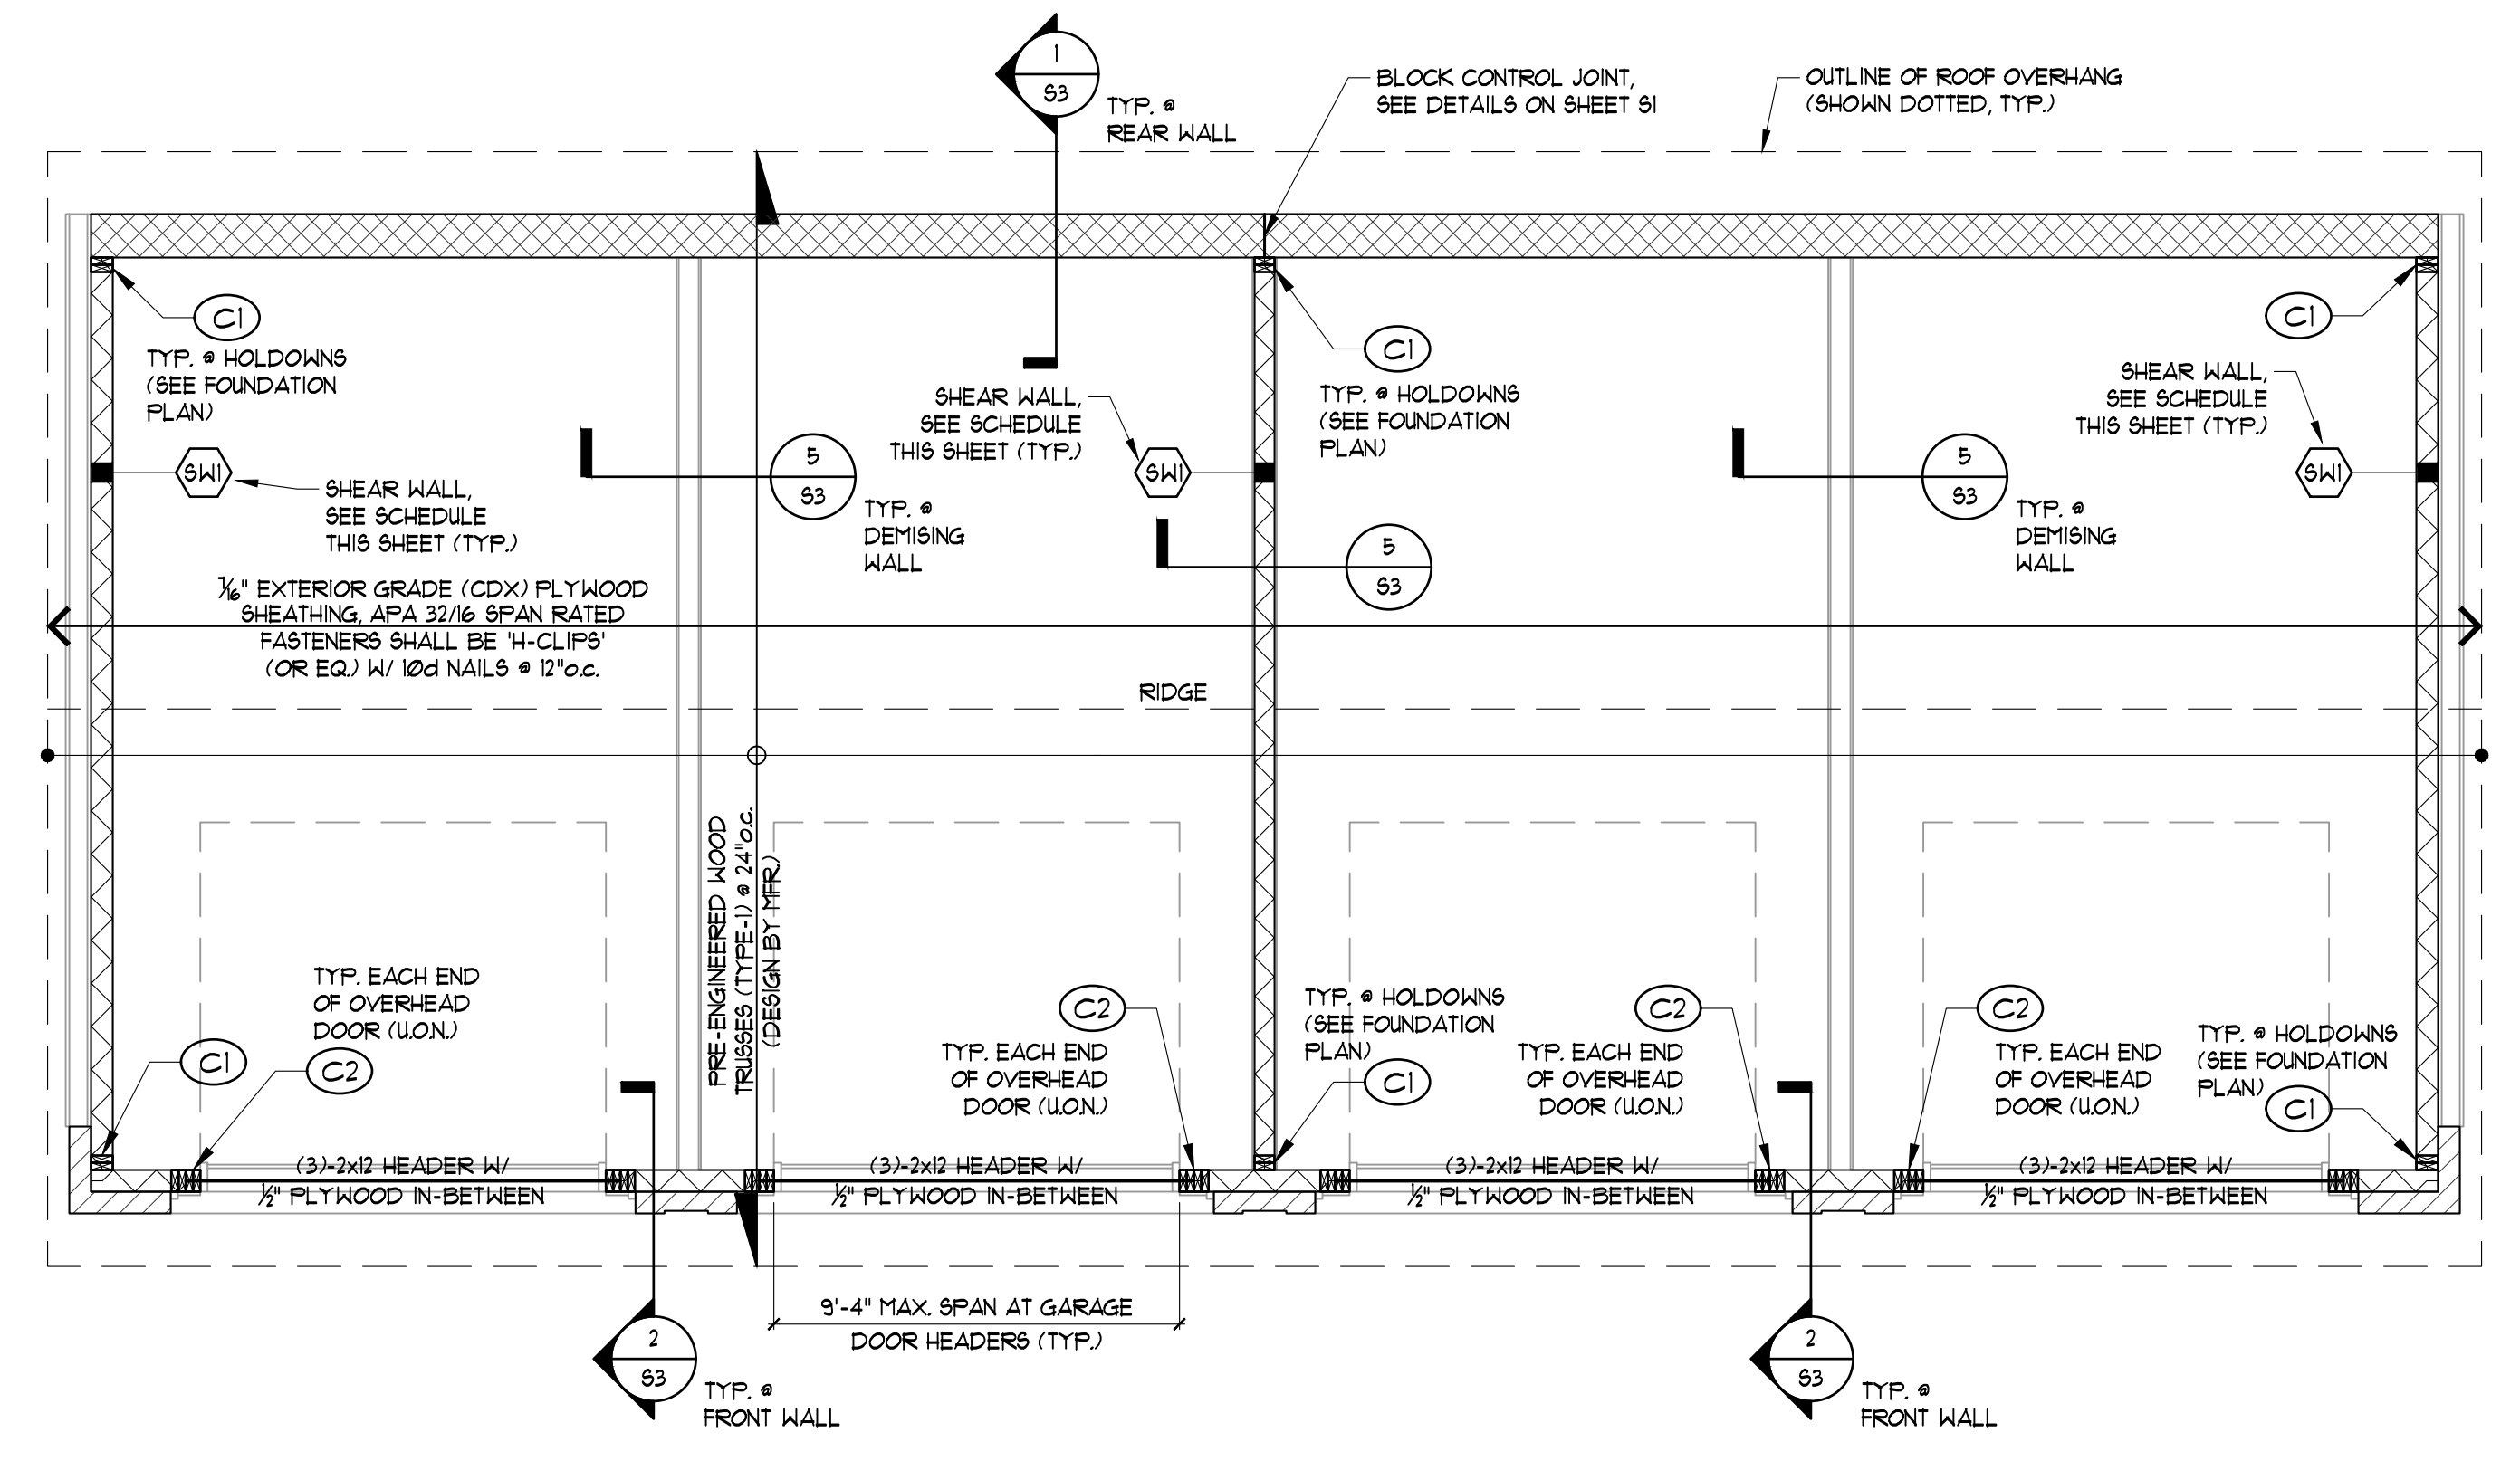

2 ROOF FRAMING PLAN
 SCALE: 1/4"=1'-0"
 ROOF FRAMING PLAN NOTES:
 1. TRUSS MANUFACTURER TO DESIGN PRE-ENGINEERED WOOD TRUSSES FOR THOSE LOADS GIVEN ON SHEET S1, AND SHALL BE SIGNED AND STAMPED BY A PROFESSIONAL ENGINEER CURRENTLY REGISTERED IN THE STATE OF NEW YORK.
 2. SEE ARCHITECTURAL DRAWINGS FOR DIMENSIONS NOT SHOWN HERE. (TYP.)

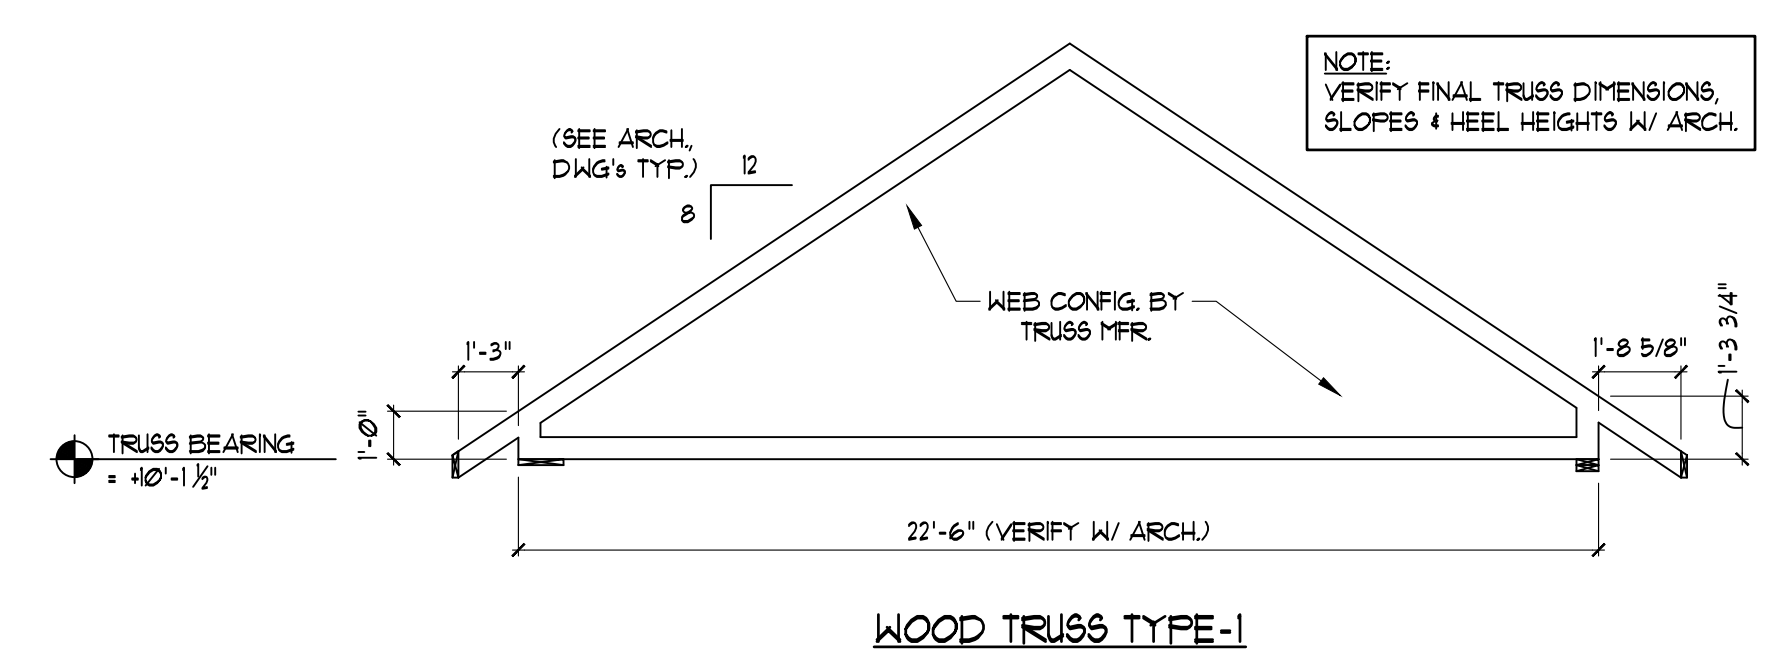

3 TRUSS PROFILE
 SCALE: 1/4"=1'-0"
 FILE:

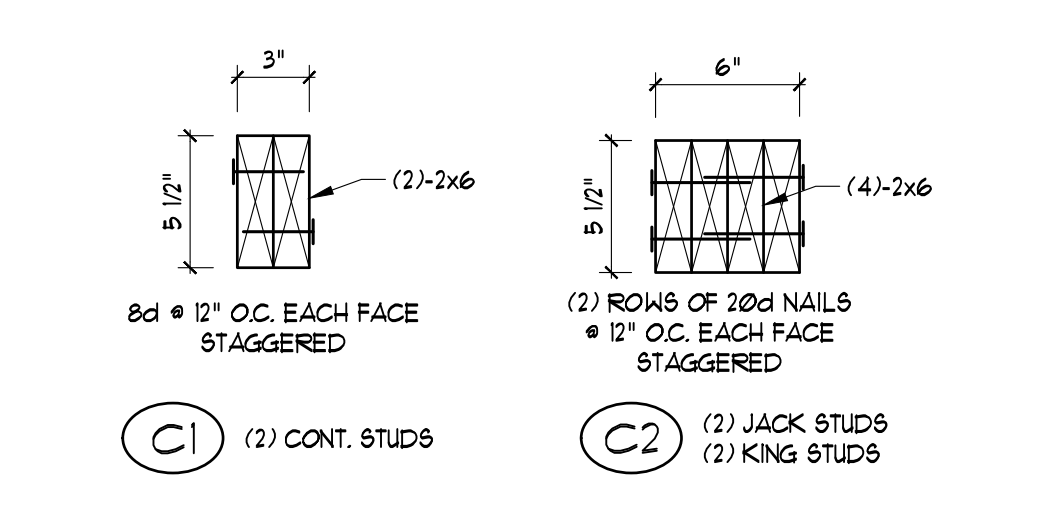

4 WOOD STUD COLUMN DETAIL
 SCALE: 1-1/2"=1'-0"
 FILE:

REVISED:
 ISSUED FOR PERMIT
 DATE: 05-12-2022
 FOUNDATION PLAN
 DRAWING TITLE:
52
 SHEET NO.
 PROJECT NO.



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 TSE 22-02-12HA

**KILBOURN PLACE APARTMENTS
 BUILDING 1 - GARAGE**
 PITTSFORD, NEW YORK

REVISED:
 ISSUED FOR PERMIT
 DATE: 05-12-2022





DETAILS AND SECTIONS


DRAWING TITLE:

S3

SHEET NO.

PROJECT NO.

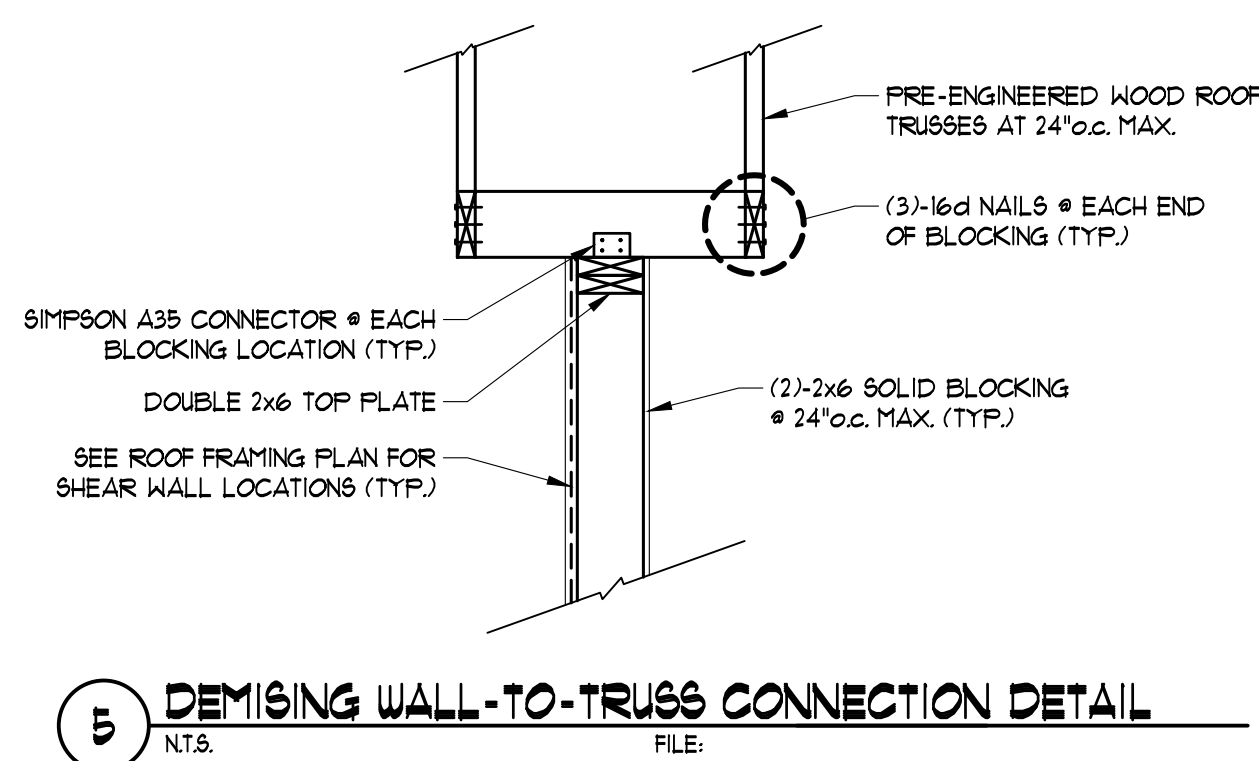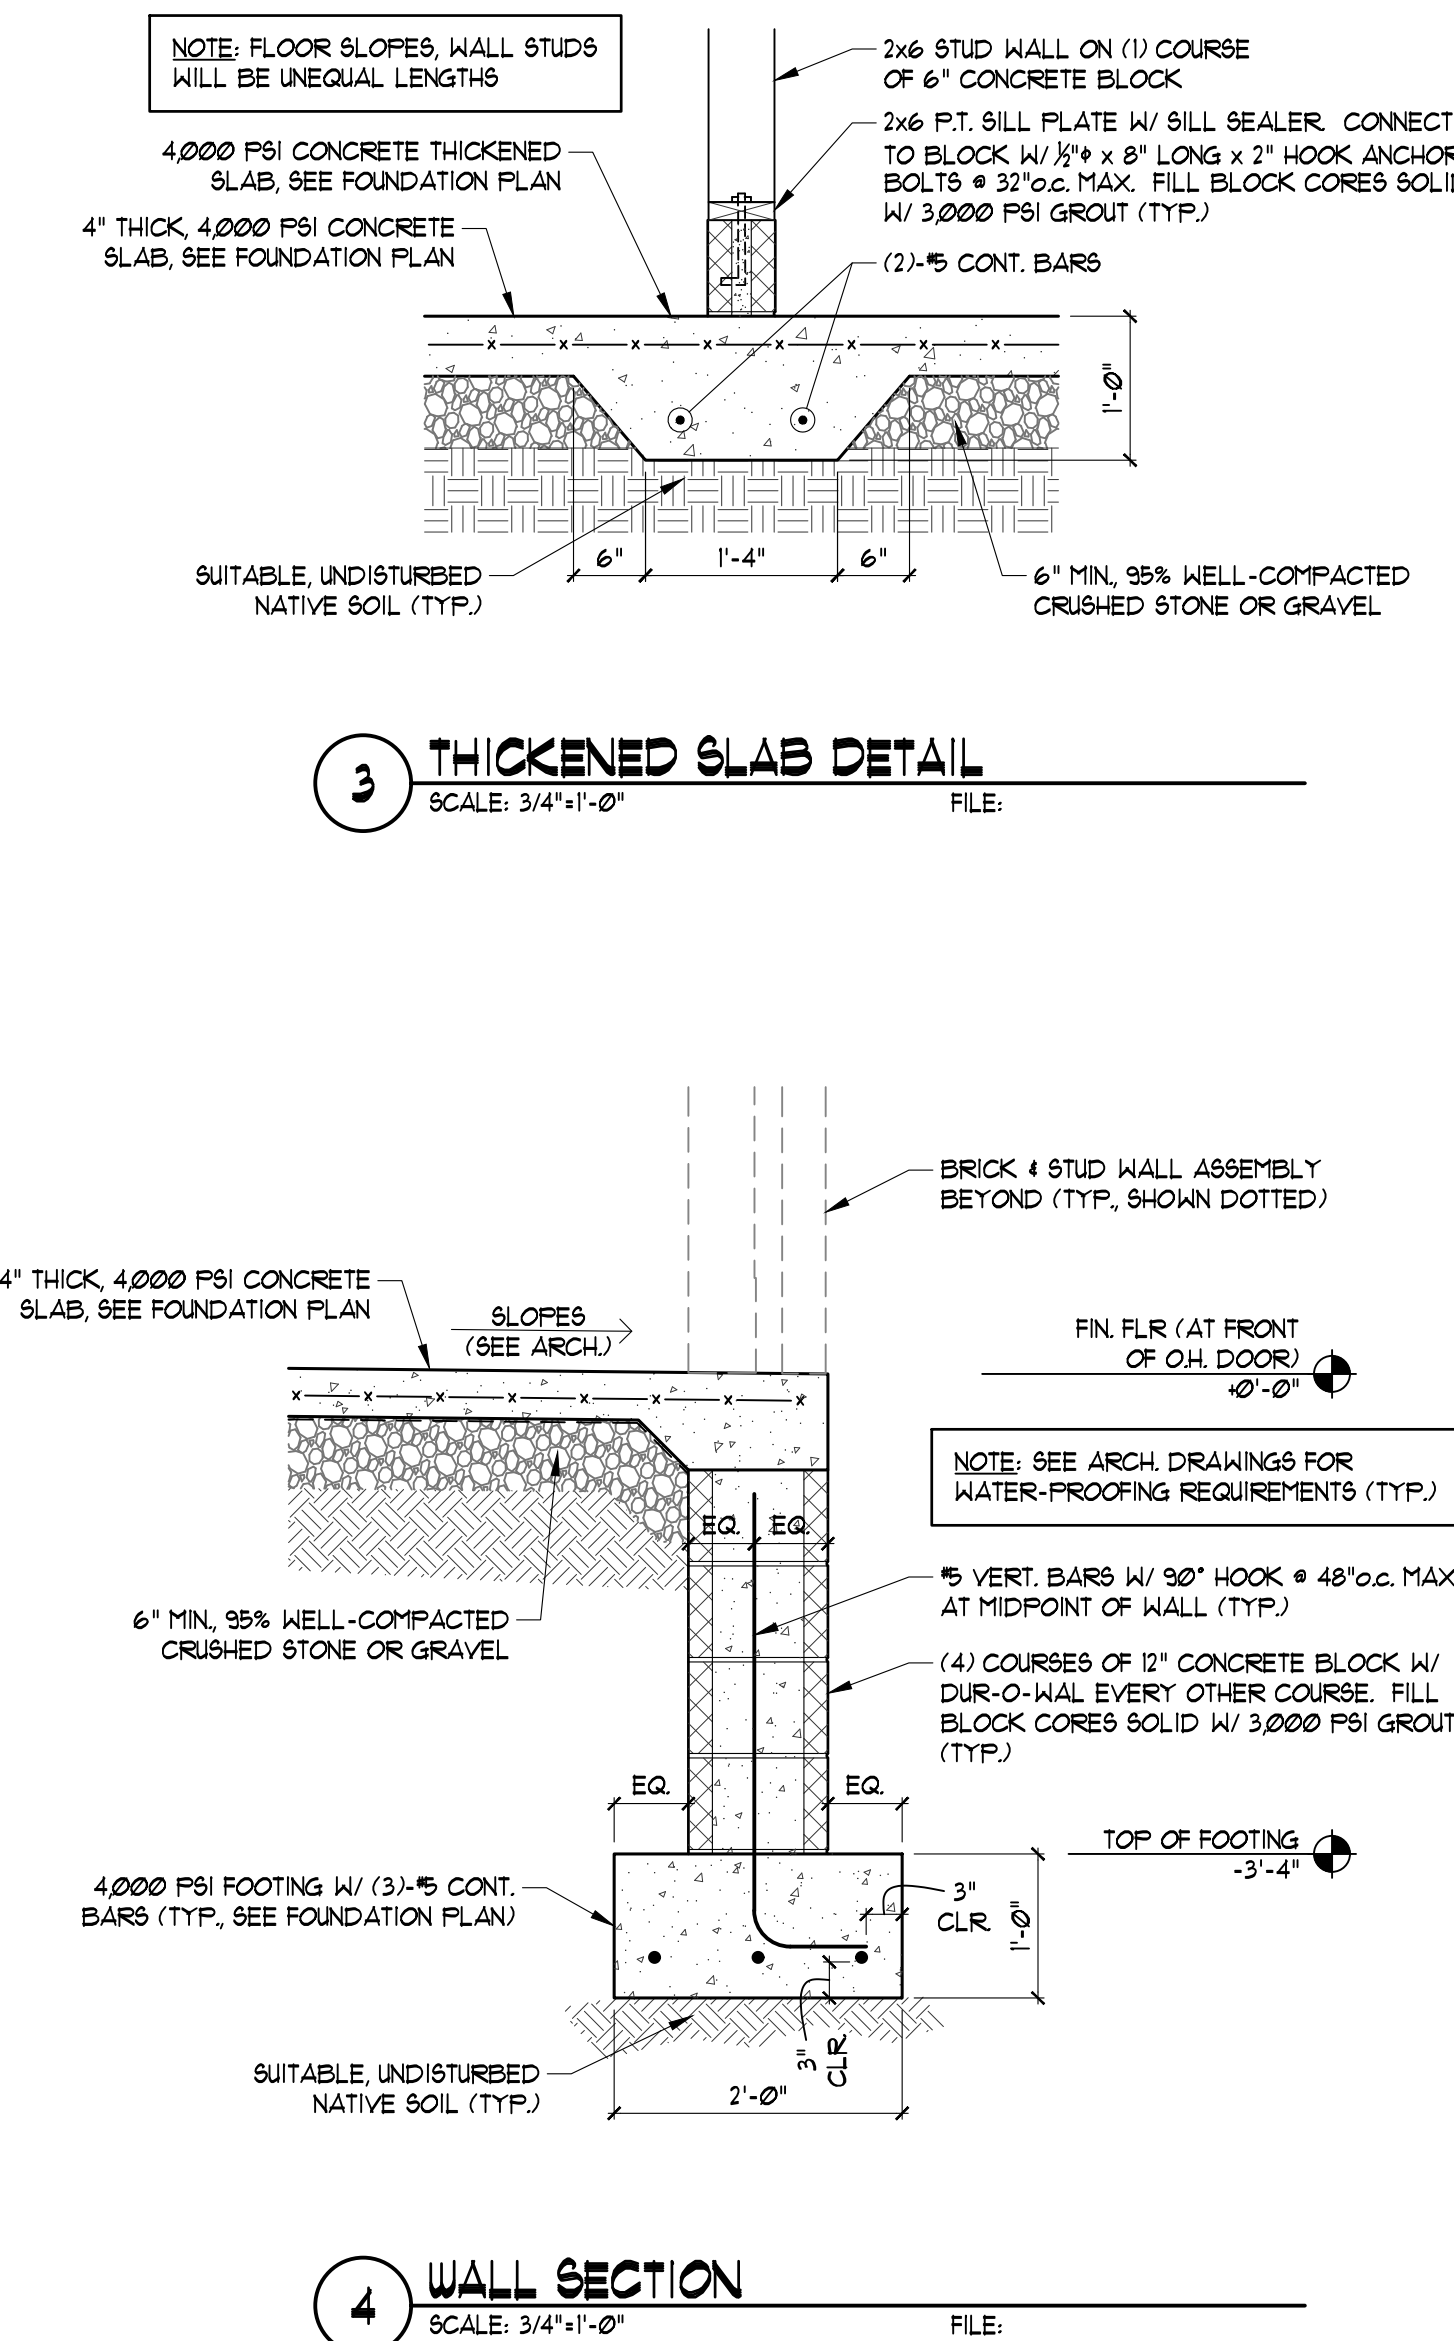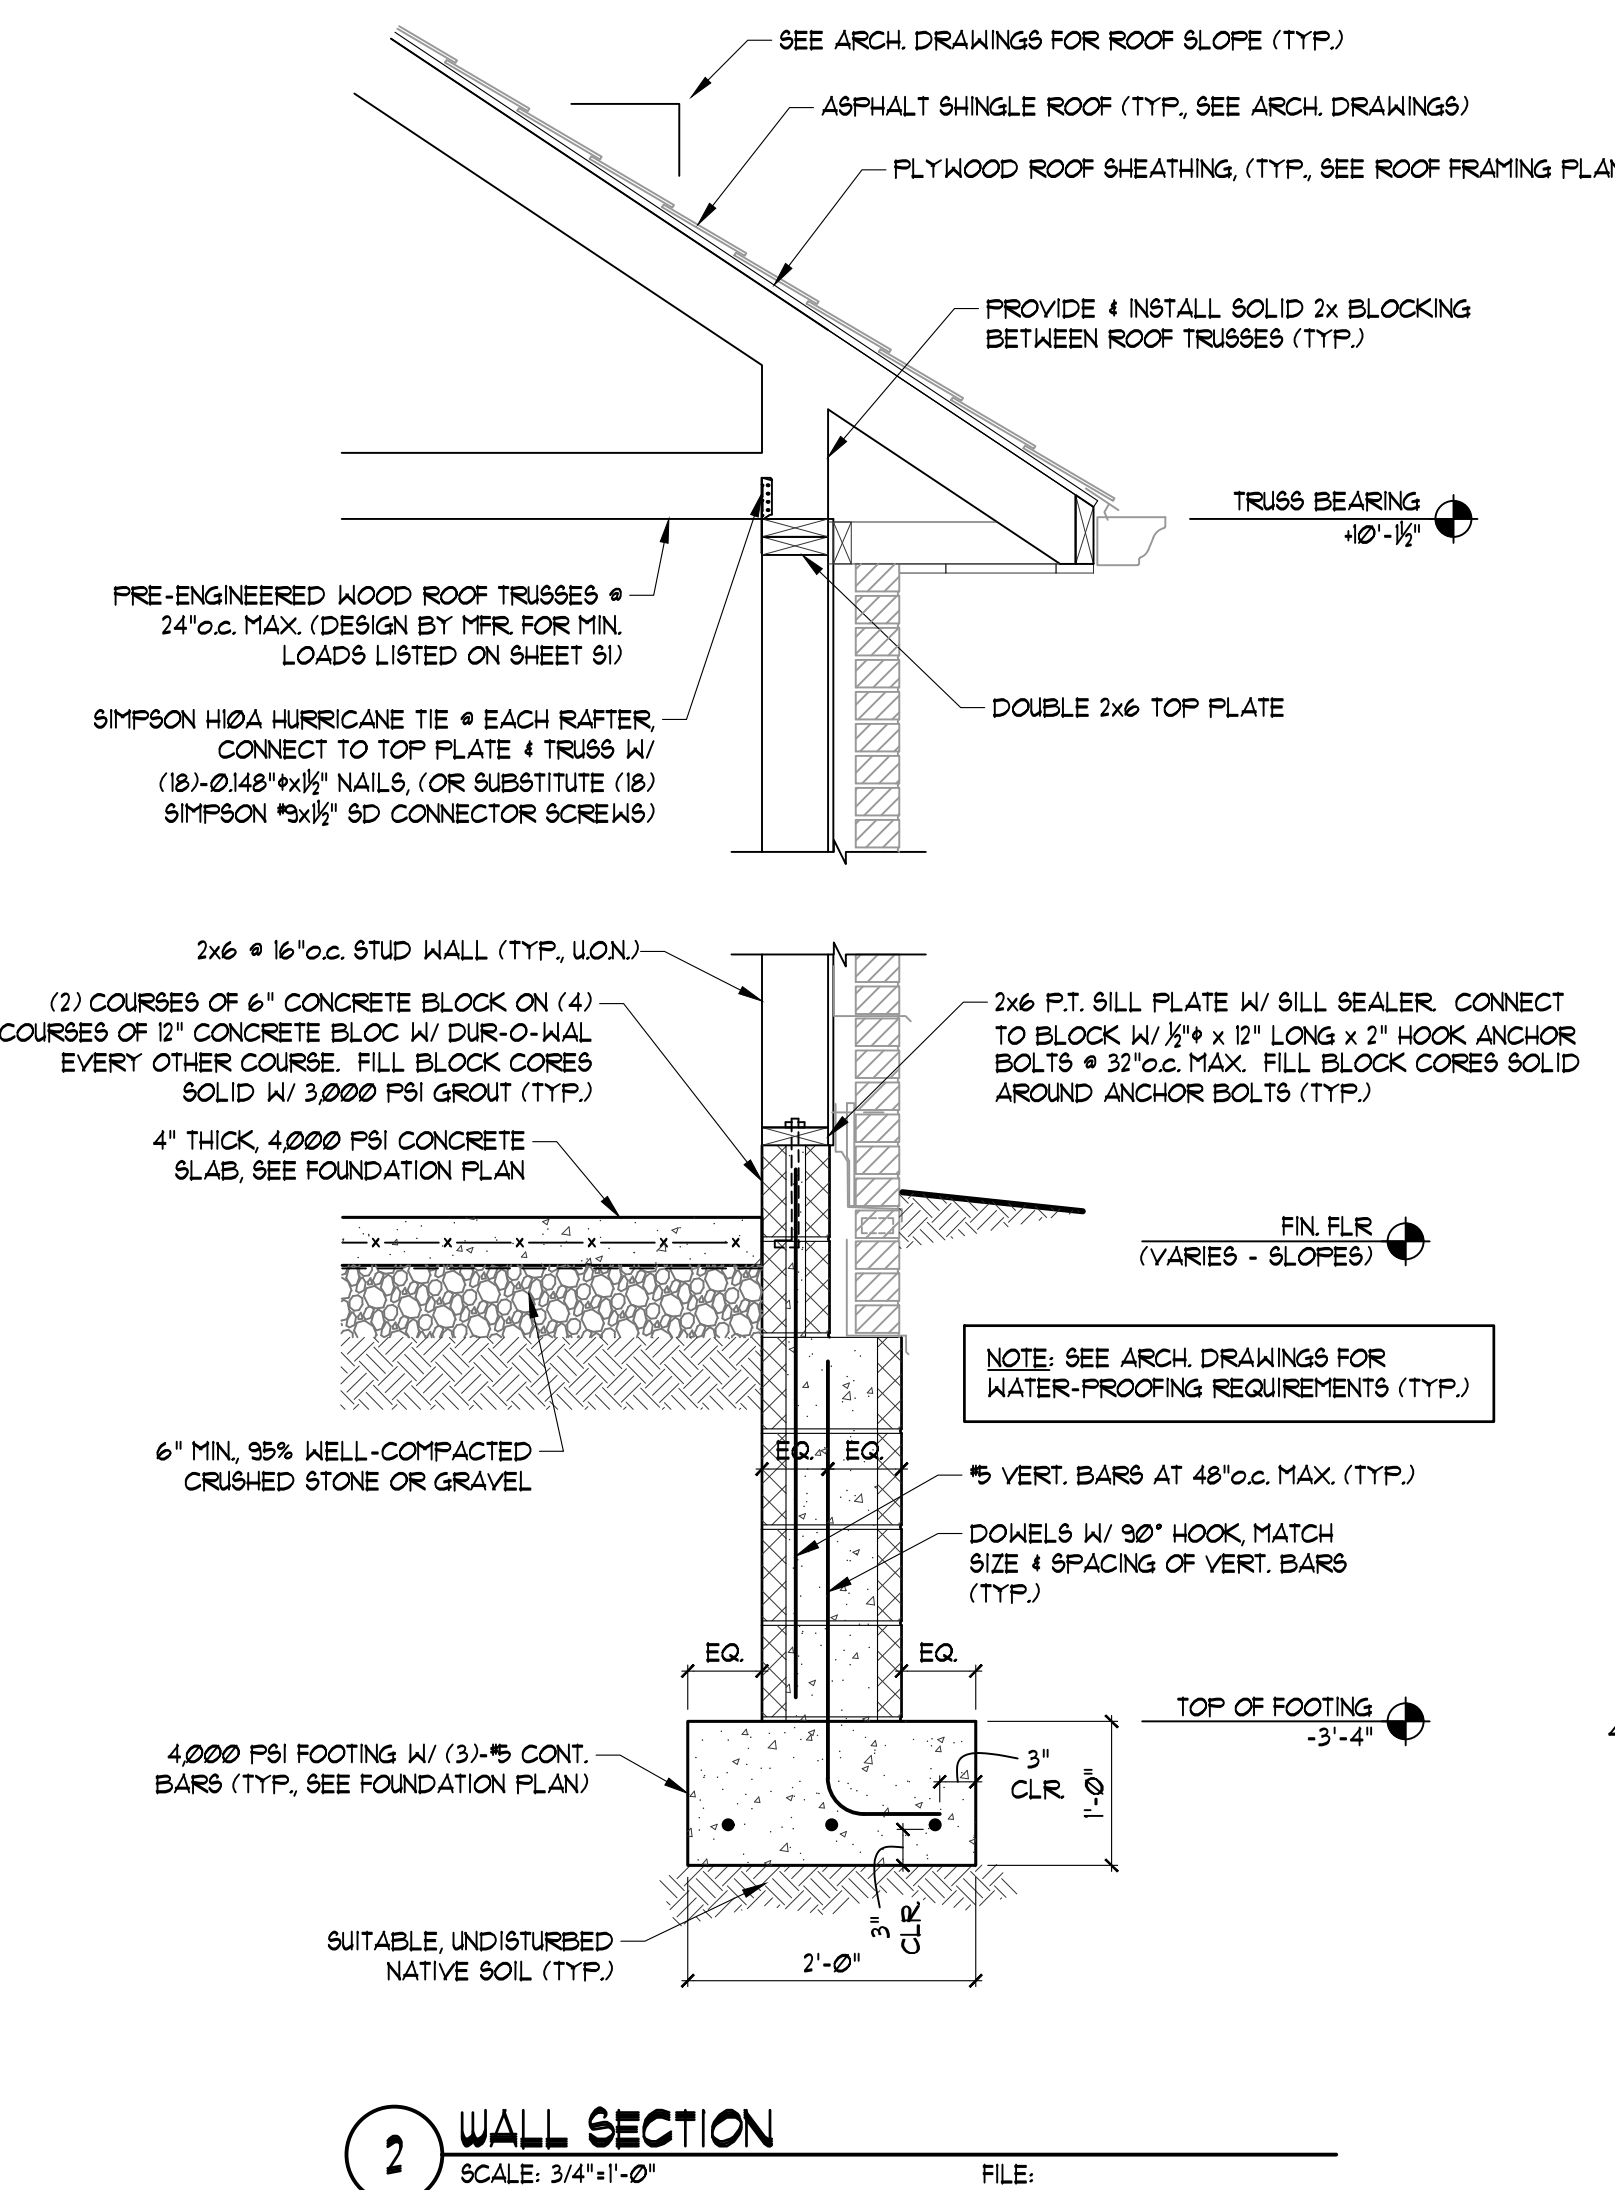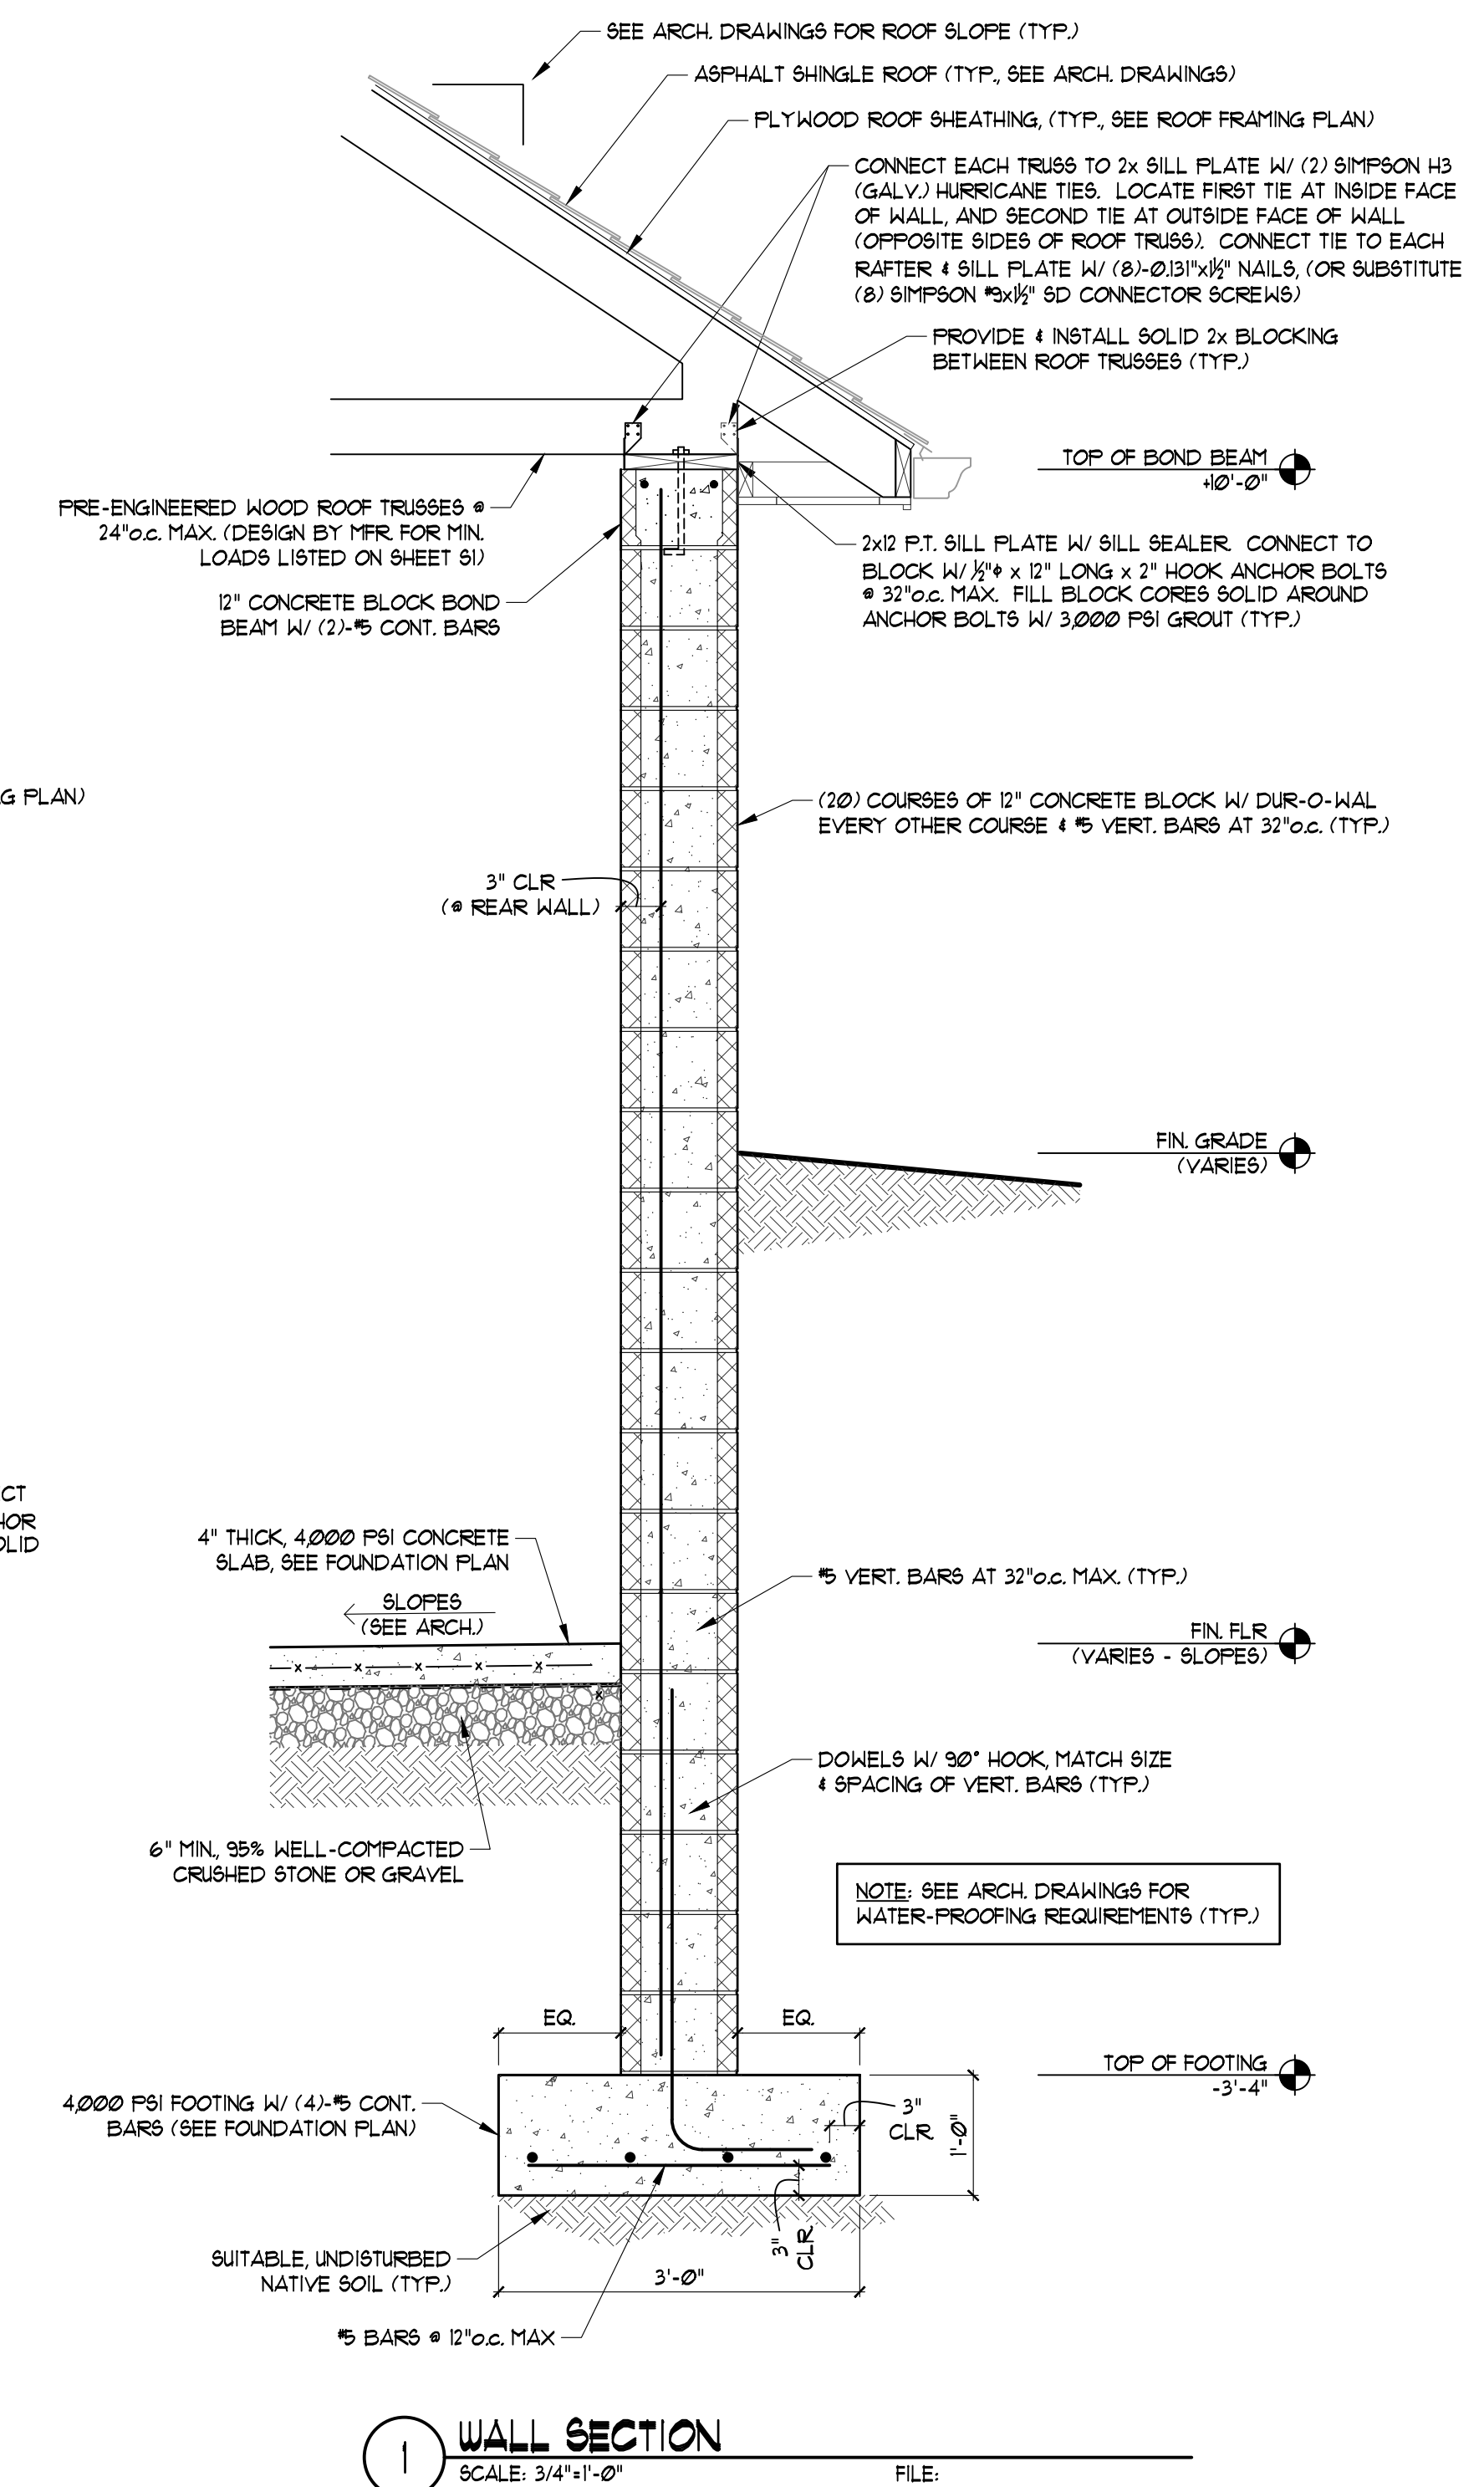

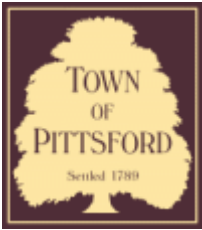

Town of Pittsford

Department of Public Works
11 South Main Street
Pittsford, New York 14534

Permit #
B22-000084

Phone: 585-248-6250
FAX: 585-248-6262

DESIGN REVIEW AND HISTORIC PRESERVATION BOARD REFERRAL OF APPLICATION

Property Address: 93 Kilbourn Road ROCHESTER, NY 14618

Tax ID Number: 138.13-3-8

Zoning District: RN Residential Neighborhood

Owner: Christine Giangreco

Applicant: Christine Giangreco

Application Type:

- | | |
|---|---|
| <input checked="" type="checkbox"/> Residential Design Review
§185-205 (B) | <input type="checkbox"/> Build to Line Adjustment
§185-17 (B) (2) |
| <input type="checkbox"/> Commercial Design Review
§185-205 (B) | <input type="checkbox"/> Building Height Above 30 Feet
§185-17 (M) |
| <input type="checkbox"/> Signage
§185-205 (C) | <input type="checkbox"/> Corner Lot Orientation
§185-17 (K) (3) |
| <input type="checkbox"/> Certificate of Appropriateness
§185-197 | <input type="checkbox"/> Flag Lot Building Line Location
§185-17 (L) (1) (c) |
| <input type="checkbox"/> Landmark Designation
§185-195 (2) | <input type="checkbox"/> Undeveloped Flag Lot Requirements
§185-17 (L) (2) |
| <input type="checkbox"/> Informal Review | |

Project Description: • In accordance with Chapter 64 Article VIII, §64-43 of the Pittsford Town Code, the owner of 93 Kilbourn Road is requesting approval from the Design Review and Historic Preservation Board to demolish the existing 2,220 +/- square foot home at 93 Kilbourn Road and rebuild a new 4210 +/- square foot single family home on the property. Tax Parcel No. 138.13-3-8. This property is Zoned Residential Neighborhood (RN).

Meeting Date: July 14, 2022



Current front



Front wide view



Left side




Right side




Opposite side of road



Property Pictures

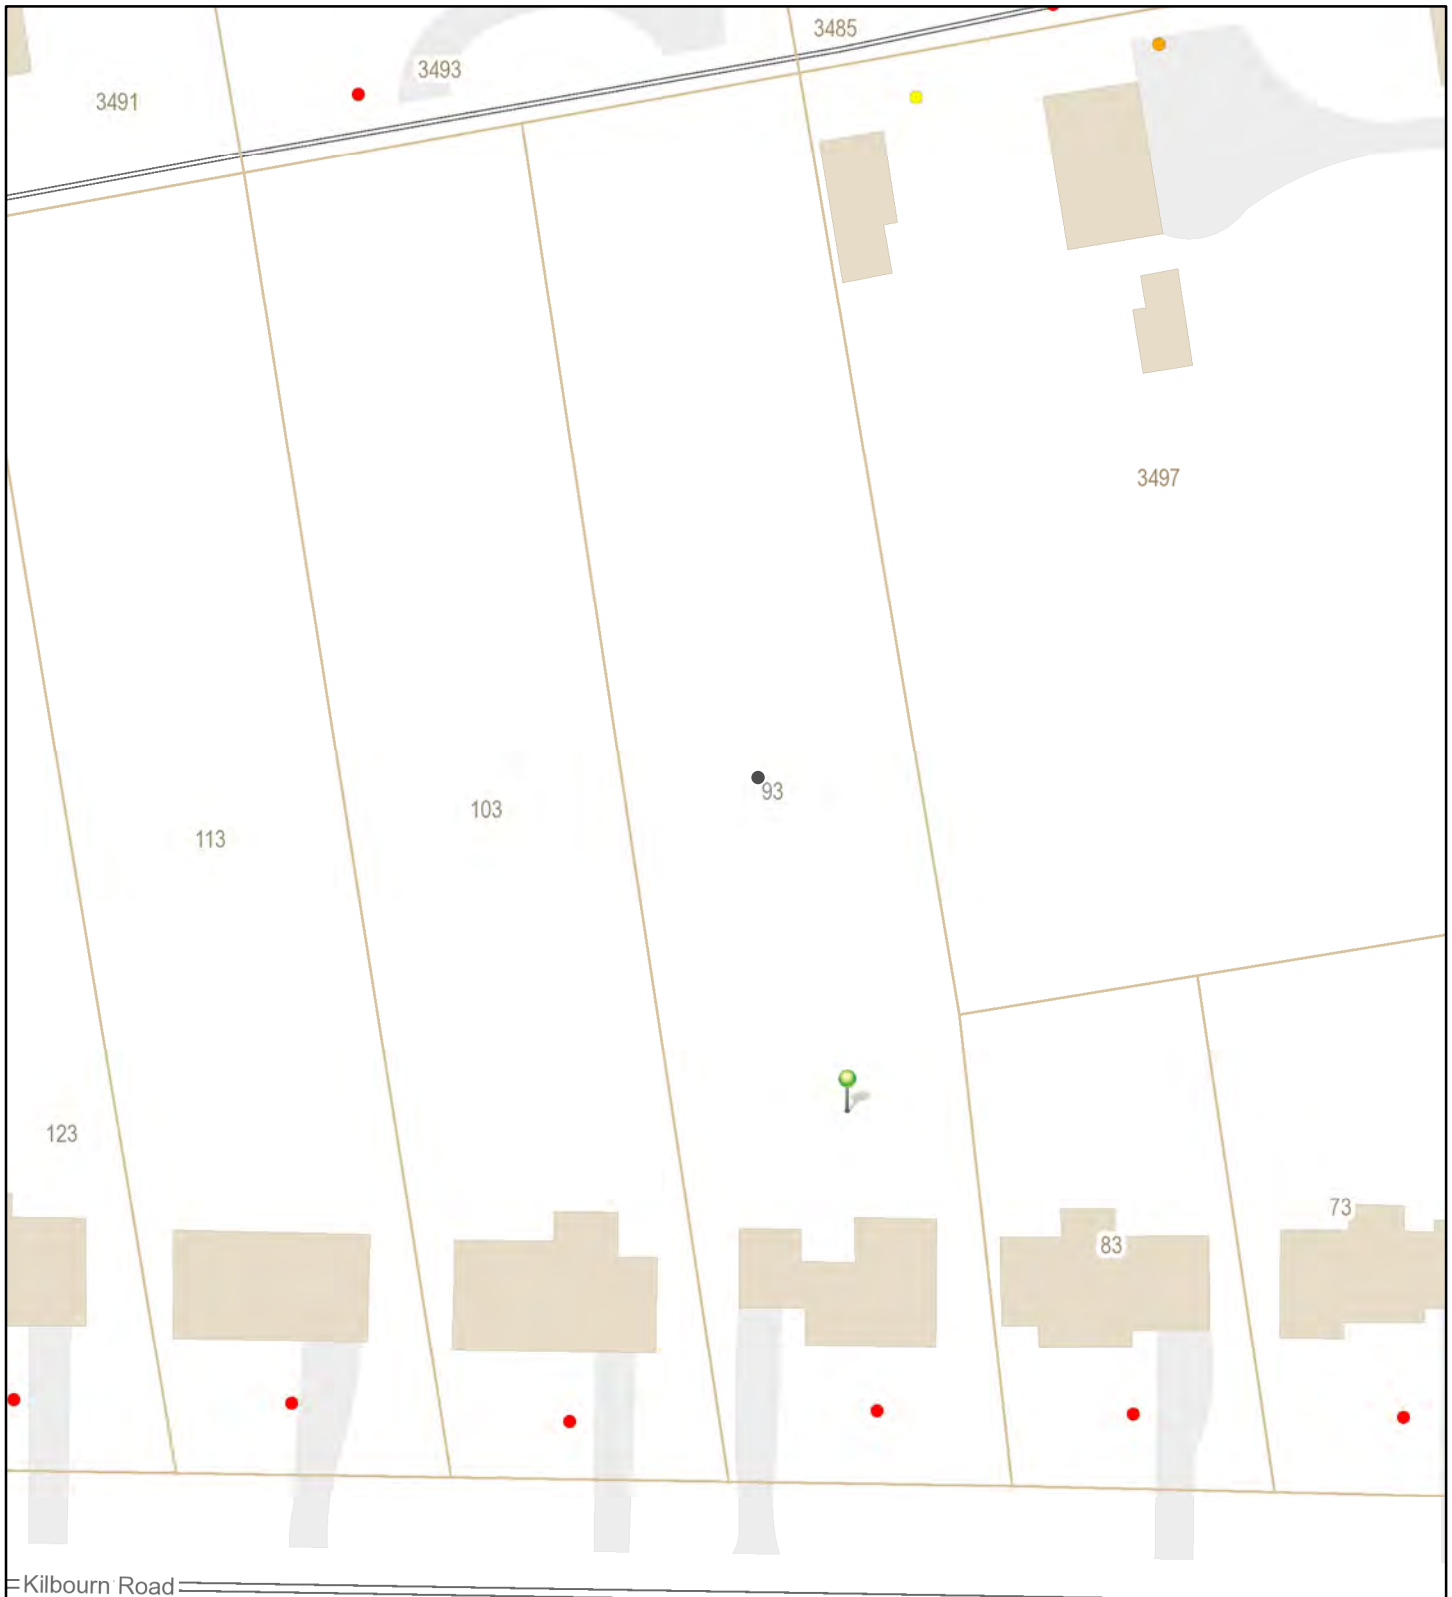

Printed May 18, 2022

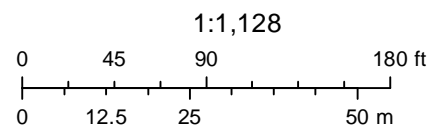


Town of Pittsford GIS

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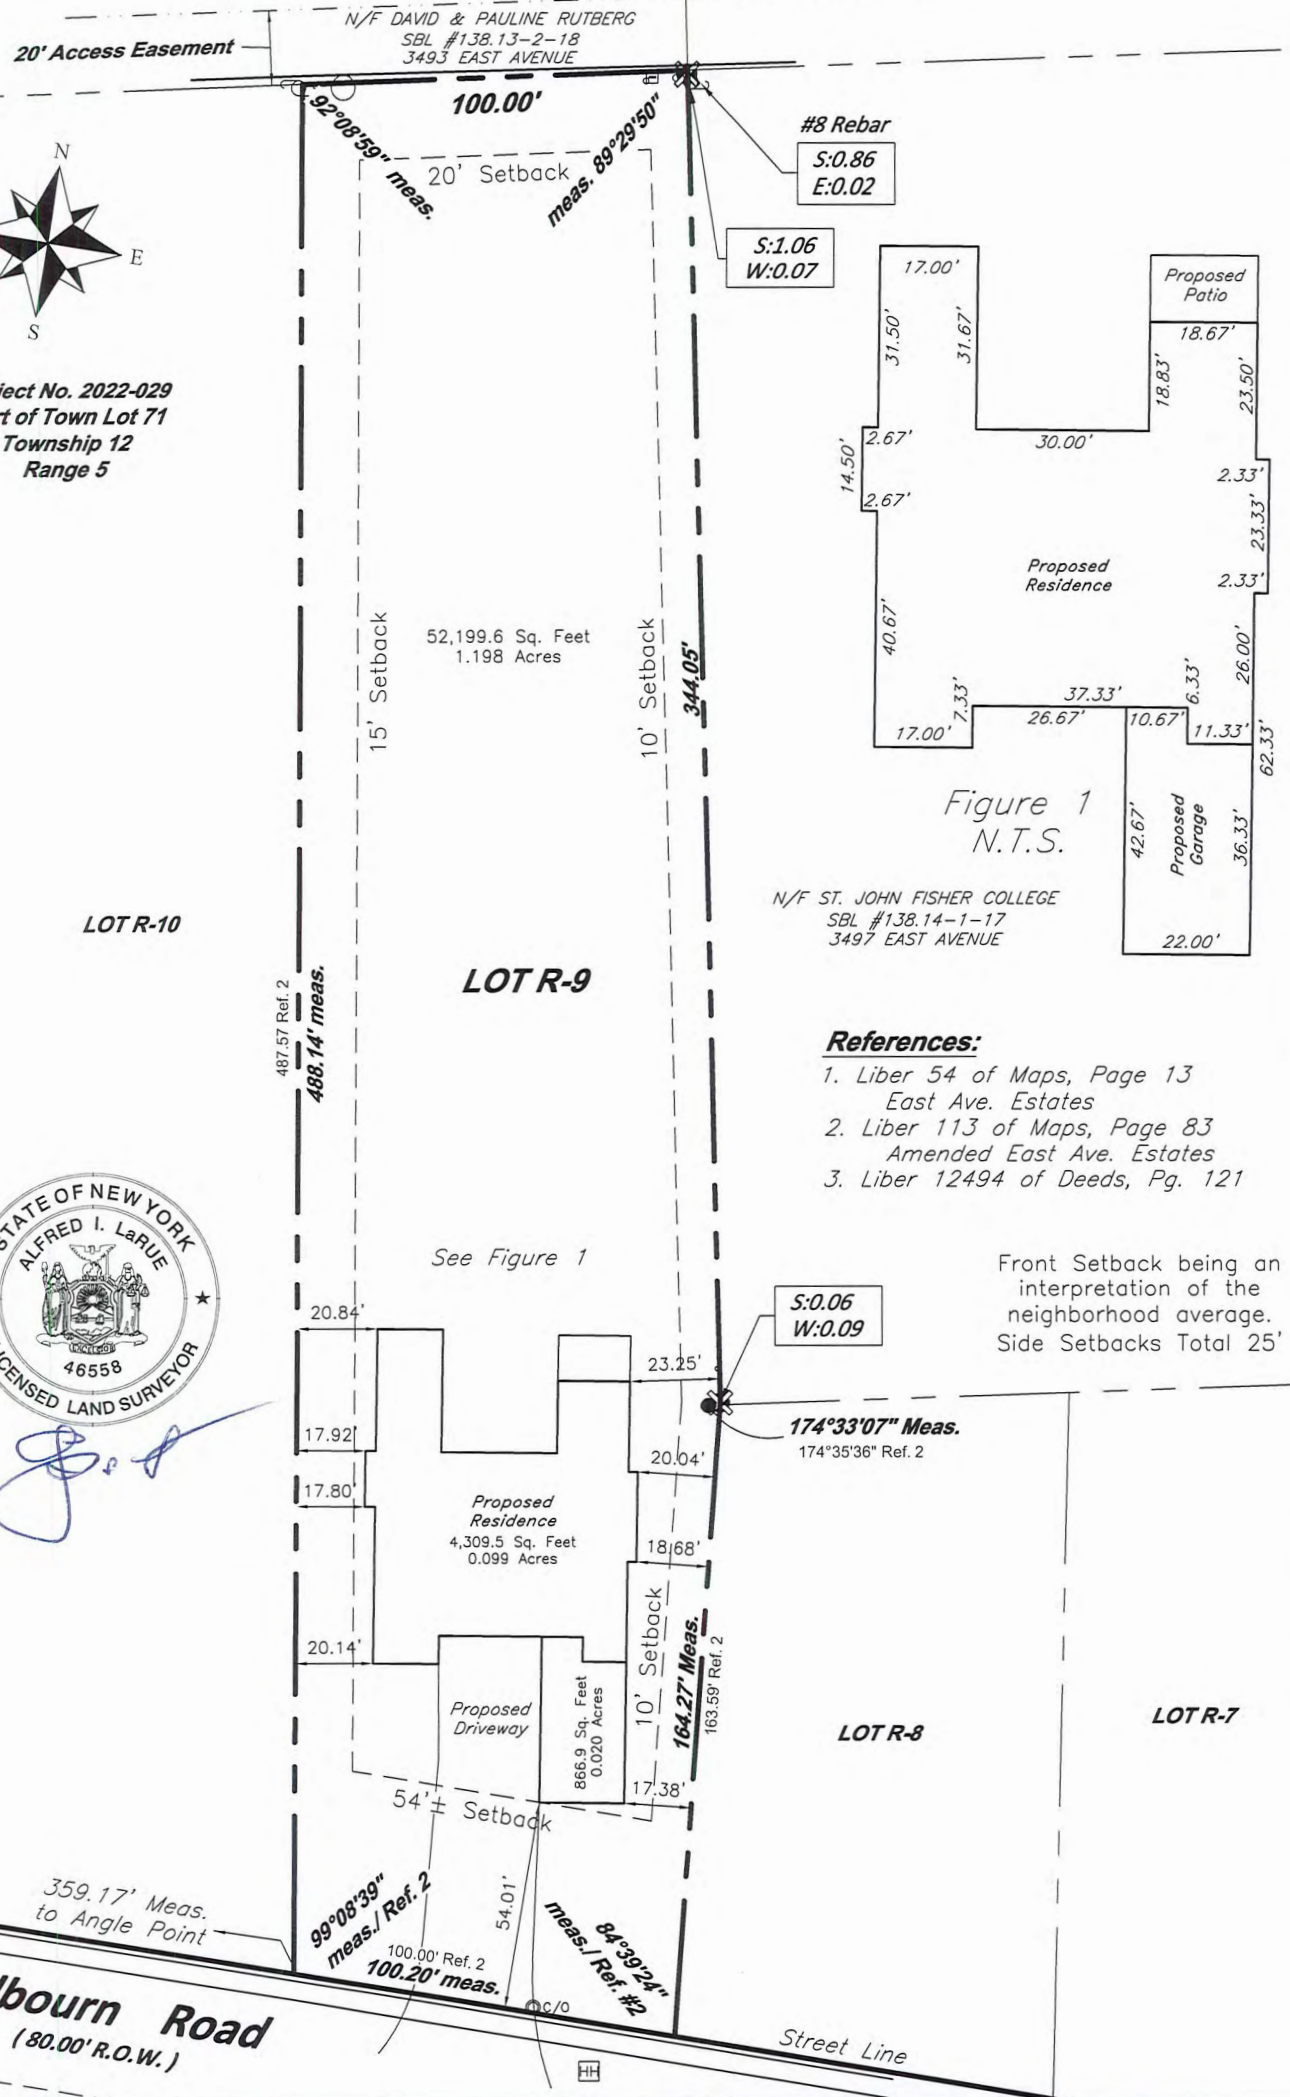
© All Pictometry



Project No. 2022-029
Part of Town Lot 71
Township 12
Range 5

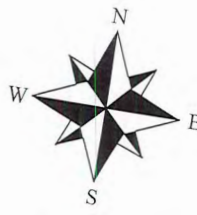

[Handwritten Signature]



#8 Rebar
S:0.86
E:0.02

S:1.06
W:0.07

S:0.06
W:0.09

References:

1. Liber 54 of Maps, Page 13 East Ave. Estates
2. Liber 113 of Maps, Page 83 Amended East Ave. Estates
3. Liber 12494 of Deeds, Pg. 121

Front Setback being an interpretation of the neighborhood average. Side Setbacks Total 25'

Figure 1
N.T.S.

See Figure 1

Kilbourn Road
(80.00' R.O.W.)

PLOT PLAN

PLOT PLAN	
Address 93 KILBOURN ROAD	TOWN OF PITTSFORD
Lot No. R-9	Subdivision AMENDED MAP OF EAST AVE ESTATES
Reference Data Liber 113	of Maps Page 83 Liber 12494 of Deeds Page 121
Client CHRISTINE GIANGRECO	
By ADB Date 5/2/22	Scale 1"=50' No. 138.130-03-03

McMahon LaRue Associates, P. C.
Engineers & Surveyors
822 Holt Road
Webster, NY 14580
(585) 436-1080
www.McMahon-LaRue.com

STANDARD ENERGY NOTES

CONTRACTOR SHALL POST THE ENERGY EFFICIENCY CERTIFICATE FROM REZ CHECK ON A WALL IN THE SPACE WHERE THE FURNACE IS LOCATED, A UTILITY ROOM OR AN APPROVED LOCATION BY THE BUILDING INSPECTOR.

RECESSED LIGHTING
A MINIMUM OF 90 PERCENT OF THE LAMPS IN PERMANENTLY INSTALLED LIGHTING FIXTURES SHALL BE HIGH EFFICACY LAMPS PER SECTION 104.1 OF THE 2020 NY RESIDENTIAL CODE.

RECESSED LUMINAIRES INSTALLED IN THE BUILDING THERMAL ENVELOPE SHALL BE SEALED WITH A GASKET OR CAULK BETWEEN THE HOUSING AND THE INTERIOR WALL COVERING TO LIMIT AIR LEAKAGE BETWEEN CONDITIONED AND UNCONDITIONED SPACES. ALL RECESSED LUMINAIRES SHALL BE IC-RATED AND LABELED AS MEETING ASTM E 283 WHEN TESTED AT 157PSF (7.5PA) PRESSURE DIFFERENTIAL WITH NO MORE THAN 2.0CFM OF AIR MOVEMENT FROM THE CONDITIONED SPACE TO THE CEILING CAVITY.

PROGRAMMABLE THERMOSTAT
CONTRACTOR TO PROVIDE A PROGRAMMABLE THERMOSTAT TO CONTROL THE HVAC SYSTEM PER SECTION 103.11 OF THE 2020 NY RESIDENTIAL CODE.

EACH DWELLING UNIT SHALL HAVE AT LEAST ONE PROGRAMMABLE THERMOSTAT CAPABLE OF AUTOMATICALLY ADJUSTING THE SPACE TEMPERATURE SET POINT OF THE LARGEST HEATING OR COOLING ZONE AND CAPABLE OF CONTROLLING THE HEATING AND COOLING SYSTEM ON A DAILY SCHEDULE TO MAINTAIN DIFFERENT TEMP. SET POINTS AT DIFFERENT TIMES OF THE DAY. THIS THERMOSTAT SHALL INCLUDE THE CAPABILITY TO SET BACK OF TEMP. OPERATE THE SYSTEM TO MAINTAIN ZONE TEMP. DOWN TO 55F OR UP TO 65F. THE THERMOSTAT SHALL INITIALLY BE PROGRAMMED WITH A HEATING TEMP. NO HIGHER THAN 70 F AND A COOLING SET POINT NO LOWER THAN 78 F.

DUCTS
SUPPLY DUCTS IN ATTIC SHALL BE INSULATED TO A MIN OF R-8. ALL OTHER DUCTS SHALL BE INSULATED TO A MIN. OF R-6, UNLESS LOCATED INSIDE THE BUILDING ENVELOPE.

AIR TIGHTNESS AND INSULATION INSTALLATION SHALL BE VERIFIED BY VISUAL INSPECTION PER SECTION 102.4.3.2 OF THE 2020 NY RESIDENTIAL CODE.

IF ANY DUCT WORK IS WITHIN AN EXTERIOR WALL, THE SYSTEM SHALL BE PRESSURE TESTED DURING CONSTRUCTION.

WITH AIR HANDLER INSTALLED: MAX 4CFM/100 SF. OF OCCUPIED SPACE WITHOUT AIR HANDLER: MAX 3CFM/100 SF. OF OCCUPIED SPACE.

ALL JOINTS AND SEAMS OF AIR DUCTS, AIR HANDLER FILTER BOXES AND BUILDING CAVITIES USED AS DUCTS SHALL BE SEALED. TAPES AND MASSES MUST BE LISTED TO UL 188.

BUILDING FRAMING CAVITIES SHALL NOT BE USED AS DUCTS OR PLUMBING.

AUTOMATIC OR GRAVITY DAMPERS SHALL BE INSTALLED ON ANY OUTDOOR AIR INTAKES OR EXHAUST SYSTEMS.

BLOWER DOOR TEST
THE HOME SHALL BE BLOWER DOOR TESTED AND VERIFIED AS HAVING AN AIR LEAKAGE RATE NOT EXCEEDING THREE (3) AIR CHANGES PER HOUR. TESTING BY THIRD PARTY ONLY.

VAPOR RETARDERS
CLASS I OR II (SHEET POLYETHYLENE, KRAFT FACE BATTS, OR LOW PERM PAINT).

VAPOR RETARDERS ARE REQUIRED ON THE INSIDE OF FRAMED WALLS AND CEILING ABOVE GRADE WHERE THE CAVITY IS NOT VENTILATED TO ALLOW MOISTURE TO ESCAPE; THIS DOES NOT INCLUDE BASEMENT WALLS!

GAS FURNACE
GOODMAN OR EQUAL SINGLE STAGE GAS FIRED FURNACE 92% WITH STAINLESS STEEL HEAT EXCHANGER. SINGLE STAGE 12 RPS 1/2HP MOTOR IS A.M.P.

IF THE FURNACE IS A OPEN COMBUSTION UNIT THE FURNACE ROOM MUST BE SEALED FROM THE REST OF THE HOUSE AND HAVE MAKEUP AIR TO IT. CONTRACTOR SHALL SUBMIT MANUFACTURERS FURNACE SUBMITTAL TO TOWN.

HOT WATER HEATER
RHEEM OR EQUAL 40 GALLON, 48 EFF. MIN RECOVERY, 36 GPH AT A 90 DEGREE RISE DIRECT VENT 2 PIPE SYSTEM. PROVIDE HEAT TRAP AND INSULATING BLANKET, ENERGY STAR RATED. CONTRACTOR SHALL SUBMIT MANUFACTURERS HW. HEATER SUBMITTAL TO TOWN.

WINDOWS AND DOORS
WINDOWS, SKYLIGHTS AND SLIDING GLASS DOORS SHALL HAVE AN AIR INFILTRATION RATE OF NO MORE THAN .3 CFM PER SQUARE FOOT AND SWINGING DOORS NO MORE THAN .5 CFM PER SF.

WINDOW U-VALUE .30 OR LESS

SLIDING GLASS DOORS U-VALUE =.30 OR LESS

SOLID INSULATING DOOR U VALUE = .142 OR LESS

KITCHEN EXHAUST HOODS

EXHAUST HOODS WITH CAPACITY GREATER THAN 400 CFM SHALL BE MECHANICALLY OR NATURALLY PROVIDED WITH AN EQUAL AMOUNT OF FRESH MAKE UP AIR. SYSTEMS SHALL BE PROVIDED WITH AT LEAST 1 DAMPER DAMPERS SHALL BE GRAVITY DAMPERS OR ELECTRICALLY OPERATED DAMPERS THAT AUTOMATICALLY OPENS WHEN THE SYSTEM OPERATES.

MECHANICAL VENTILATION

WHOLE HOUSE MECHANICAL VENTILATION SHALL BE REQUIRED BY PROVIDING A METHOD OF SUPPLY AIR AND RETURN OR EXHAUST AIR. THE AMOUNT OF SUPPLY AIR SHOULD BE APPROX. EQUAL TO THE EXHAUST RATE. OUTDOOR AIR DUCTS CONNECTED TO THE RETURN SIDE OF AN AIR HANDLER SHALL BE CONSIDERED AS PROVIDING SUPPLY VENTILATION. A LOCAL EXHAUST FAN, SUCH AS A BATHROOM FAN MAY BE CONSIDERED AS EXHAUST MECHANICAL VENTILATION CAN ALSO BE PROVIDED BY THE INSTALLATION OF A HEAT RECOVERY MAKE UP AIR UNIT, INSTALLED PER CODE AND BY THE MANUFACTURERS DIRECTION.

BATH AND POWDER ROOM EXHAUST FANS SHALL DISCHARGE DIRECTLY TO THE EXTERIOR AND BE INSTALLED WITH A PROGRAMMABLE DIGITAL CONTROL SWITCH PROVIDING A RUN TIME OF 15 MIN PER HOUR AT A MIN. OF 50 CFM PER POWDER ROOM AND BATHROOM.

BATHROOMS AND POWDER ROOMS SHALL HAVE A MIN. EXHAUST CAPACITY OF 50 CFM INTERMITTENT OR 20 CFM CONTINUOUS.

CONTINUOUS WHOLE HOUSE MECHANICAL VENTILATION RATES

DWELLING UNIT FLOOR AREA SF	NUMBER OF BEDROOMS			
	0-1	2-3	4-5	6-7
< 1500	30	45	60	75
1500-3,000	45	60	75	90
3,000-4,500	60	75	90	105

NOTE: IF RUN TIME IS INTERMITTENT AT 25% OF EACH 4-HOUR SEGMENT THE VENTILATION RATE ABOVE SHALL BE MULTIPLIED BY A FACTOR OF 4.

TABLE R403.6.1 WHOLE HOUSE MECHANICAL VENTILATION SYSTEM FAN EFFICACY

FAN LOCATION	AIR FLOW RATE MIN (CFM)	MIN. EFFICACY CFM / WATT	AIR FLOW RATE MAX
HRV OR ERV	ANY	12 CFM/WATT	ANY
RANGE HOODS	ANY	2.6 CFM/WATT	ANY
IN-LINE FANS	ANY	2.6 CFM/WATT	ANY
BATHROOM UTILITY	10	14 CFM/WATT	<90
BATHROOM UTILITY	90	2.6 CFM/WATT	ANY

GENERAL NOTES

DOUBLE FLOOR JOISTS UNDER ALL PARALLEL WALLS 48" OR LONGER.

IF FLUE LOCATION IS NOT SHOWN ON PLANS CONTR. SHALL PROVIDE A 90 AFUE FURNACE TO COMPLY WITH N.Y.S. ENERGY CODE.

HANDRAILS SHALL BE PROVIDED ON AT LEAST ONE SIDE OF EACH STAIRWAY W/ MORE THAN 2 RISERS. HANDRAIL HGT SHALL BE MEASURED ABOVE STIR TREAD NOSING AND SHALL BE BETWEEN 34"-36" HIGH HANDRAILS ADJACENT TO THE WALL SHALL HAVE A SPACE NOT LESS THAN 1 1/2" BETWEEN THE WALL AND HANDRAIL. HANDRAIL SHALL BE CONTINUOUS. GUARDS AT OPENINGS OF STAIRWAYS SHALL BE 36" HIGH WITH VERTICAL RAILS THAT DO NOT ALLOW PASSAGE OF A 4" SPHERE.

GAS ZERO CLEARANCE MANUFACTURERS SPECIFICATIONS SHALL BE SUBMITTED TO THE BUILDING DEPARTMENT.

STAIRWAYS SHALL HAVE A CONTINUOUS RAILING 36" HIGH AND TERMINATE AT A WALL OR NEWEL POST.

SETTING THE BUILDING ELEVATION IS THE RESPONSIBILITY OF THE GENERAL CONTRACTOR AND SHALL COMPLY WITH MUNICIPAL APPROVED SITE PLAN OR SURVEY.

THE CONTRACTOR SHALL INSTALL 5" HIGH NUMBERS ON THE FRONT OF THE BUILDING TO IDENTIFY THE SITE ADDRESS.

GLAZING IN DOORS, STORM DOORS AND SIDELIGHTS IS DEEMED TO BE HAZARDOUS PER SECTION R308.4 OF THE NEW YORK STATE CODE AND SHALL BE IDENTIFIED AS SUCH IN COMPLIANCE WITH SECTION R308.1 DECORATIVE GLASS IS EXEMPT IN SWINGING DOORS AND SIDELIGHTS.

TJI INSTALLATION SHALL CONFORM TO ALL DETAILS AND SPECIFICATIONS OF THE MANUFACTURER. INSTALL ALL REQUIRED FASTENERS AND SOLID BLOCKING AT SUPPORT WALLS. BLOCKING ETC. IF NOT KNOWN CONTACT ARCHITECT.

ALL ENGINEERED FLOOR JOISTS TO BE DESIGNED BY & LAYOUT TO BE DONE BY MANUFACTURER WITH LICENSED N.Y.S. ENGINEER.

ALL EXTERIOR FLOOR CANTILEVERS SHALL RECEIVE 1/2" DRAPRY (OR EQUAL) FINISH AT UNDERSIDE FULL DEPTH ON JOIST AND SOLID BLOCKING AT SUPPORT WALL. INSTALL MIN. R-30 KRAFT FACE BATTS UNLESS NOTED.

BUILDER SHALL VERIFY WITH HOME OWNER ON LOCATION OF 24"X30" ATTIC ACCESS LOCATION.

PROVIDE SLOTTED ROOF TRUSS CLIPS AT ALL INTERIOR PARTITIONS EQUAL TO SIMPSON STC CLIPS.

INSTALL DRYWALL ON CEILING PER THE WOOD TRUSS COUNCIL OF AMERICA FOR PREVENTING PARTITION SEPARATION. REQUEST DETAILS FROM ARCHITECT IF NEEDED.

EXTERIOR BEARING WALL OPENING GREATER THAN 48" REQUIRE 2 JACK STUDS PER SIDE.

INTERIOR BEARING WALL OPENINGS GREATER THAN 48" REQUIRE 2 JACK STUDS PER SIDE.

ALL FRAMING ANGLES SHALL BE 45 DEG. UNLESS NOTED.

PROVIDE SOLID BLOCKING UNDER ALL BEARING POINTS DOWN TO FOUNDATION WALL.

ALL WINDOW R.O. SHALL BE 4"-10 1/2" UNLESS NOTED.

PROVIDE A MIN. OF R-5 RIGID INSULATION WITHIN ALL EXTERIOR WINDOW AND DOOR HEADERS.

ALL NEW ELECTRICAL WORK SHALL COMPLY WITH PART VII OF THE RESIDENTIAL CODE OF NEW YORK STATE FROM TOWN OFFICE WITH FINAL ELECTRICAL INSPECTION APPROVAL.

IN ALL FRAMED WALLS, FLOORS AND ROOF/CEILING COMPRISING ELEMENTS OF THE BUILDING THERMAL ENVELOPE, A VAPOR RETARDER SHALL BE INSTALLED ON THE WARM-IN-WINTER SIDE OF THE INSULATION.

INSULATION ON BASEMENT WALLS SHALL BE COVERED WITH GYPSUM BOARD OR HAVE A FLAME SPREAD INDEX NOT GREATER THAN 25 WITH AN ACCOMPANYING SMOKE DEVELOPED INDEX NOT TO EXCEED 450.

FLASHING SHALL BE INSTALLED IN THE FOLLOWING AREAS: TOP OF EXTERIOR WINDOWS AND DOORS; CHIMNEYS, UNDER AND AT END OF MASONRY, WOOD, METAL COPINGS AND SILLS; AND WHERE EXTERIOR PORCHES, DECKS OR STAIRS ATTACH TO A WALL ASSEMBLY.

SMOKE DETECTORS SHALL BE INSTALLED IN THE FOLLOWING AREAS: IN EACH SLEEPING ROOM IN HALLWAYS ADJACENT TO SLEEPING ROOMS AND AT LEAST ONE ON EACH STORY INCLUDING BASEMENT.

ALL DETECTORS SHALL BE HARD WIRED AND INTERCONNECTED. ALARMS CAN BE INTERCONNECTED WIRELESSLY. LOCATE NOT LESS THAN 3' HORIZONTALLY FROM BATHROOMS WITH SHOWERS OR FROM CEILING FANS. CANNOT BE CLOSER THAN 20' IONIZATION OR 8' PHOTOELECTRIC TO COOKING APPLIANCES.

CARBON MONOXIDE DETECTORS SHALL BE INSTALLED IN THE FOLLOWING LOCATIONS: ON ANY STORY HAVING A SLEEPING AREA, ON ANY STORY WHERE FUEL-BURNING OR SOLID FUEL BURNING APPLIANCES, EQUIPMENT, FIREPLACES OR ATTACHED GARAGES ARE LOCATED.

ALL DETECTORS SHALL BE HARD WIRED AND INTERCONNECTED.

VINYL SIDING UNLESS OTHERWISE SPECIFIED BY THE MANUFACTURERS INSTRUCTIONS SHALL BE FASTENED TO A MIN 1 1/4" NAULABLE SUBSTRATE WITH A 20-INCH SHANK DIA WITH A 3/8" HEAD OR A 1/2" GAGE STAPLE WITH A 3/8"-1/2" CROWN. SPACING SHALL BE 16".

PROVIDE INTERCONNECTED HEAT DETECTOR IN GARAGE PER SECTION R304.2.3 OF THE NEW YORK STATE BLDG. CODE 2020.

ALL WOOD IN CONTACT WITH THE GROUND, EMBEDDED IN CONCRETE IN DIRECT CONTACT WITH THE GROUND SHALL BE APPROVED PRESSURE TREATED WOOD SUITABLE FOR GROUND CONTACT USE.

STAIRS
WIDTH 36" WIDE IN CLEAR WIDTH AT ALL POINTS ABOVE THE PERMITTED HANDRAIL HGT. THE CLEAR WIDTH AT OR BELOW THE HANDRAIL HGT SHALL BE NOT LESS THAN 3 1/2" WHERE A RAILING IS ON ONE SIDE AND 27" WHERE RAILINGS ARE ON BOTH SIDES.

HEADROOM SHALL BE NOT LESS THAN 6'-8"

RISERS THE RISER HGT. SHALL BE A MAX. OF 8 1/4". AT OPEN RISERS, OPENINGS LOCATED MORE THAN 30" ABOVE GRADE OR THE FLOOR BELOW SHALL NOT PERMIT THE PASSAGE OF A 4" INCH DIAMETER SPHERE.

TREADS THE TREAD DEPTH SHALL NOT BE LESS THAN 9"

NOSINGS NOSINGS PROJECTIONS SHALL BE 3/4"-1 1/4" MAX. NOT REQUIRED ON TREAD DEPTH GREATER THAN 1"


HANDRAILS SHALL BE PROVIDED ON AT LEAST ONE SIDE OF STAIRWAYS WITH FOUR OR MORE RISERS. TOP SURFACES OF HANDRAILS AND RAILINGS SHALL BE BETWEEN 34" AND 38" ABOVE TREAD NOSINGS.

WINDOW FALL PROTECTION

PROVIDE WINDOW OPENING CONTROL DEVICE TO PROHIBIT THE PASSAGE OF A 4" SPHERE ON WINDOWS IN WHICH THE SILL IS LESS THAN 24" FROM THE FLOOR AND THE EXTERIOR GRADE IS GREATER THAN 72" BELOW.


THE WINDOW CONTROL DEVICE AFTER OPERATION TO RELEASE THE CONTROL DEVICE ALLOWING THE WINDOW TO FULLY OPEN SHALL NOT REDUCE THE NET CLEAR OPENING OF THE WINDOW TO LESS THAN WHATS REQUIRED IN SECTION 300.2.1.

5.7 SF. CLEAR OPENING IS SF. AT GRADE OR BELOW GRADE OPENING.
NET CLEAR HEIGHT OF 24"
NET CLEAR WIDTH OF 20"

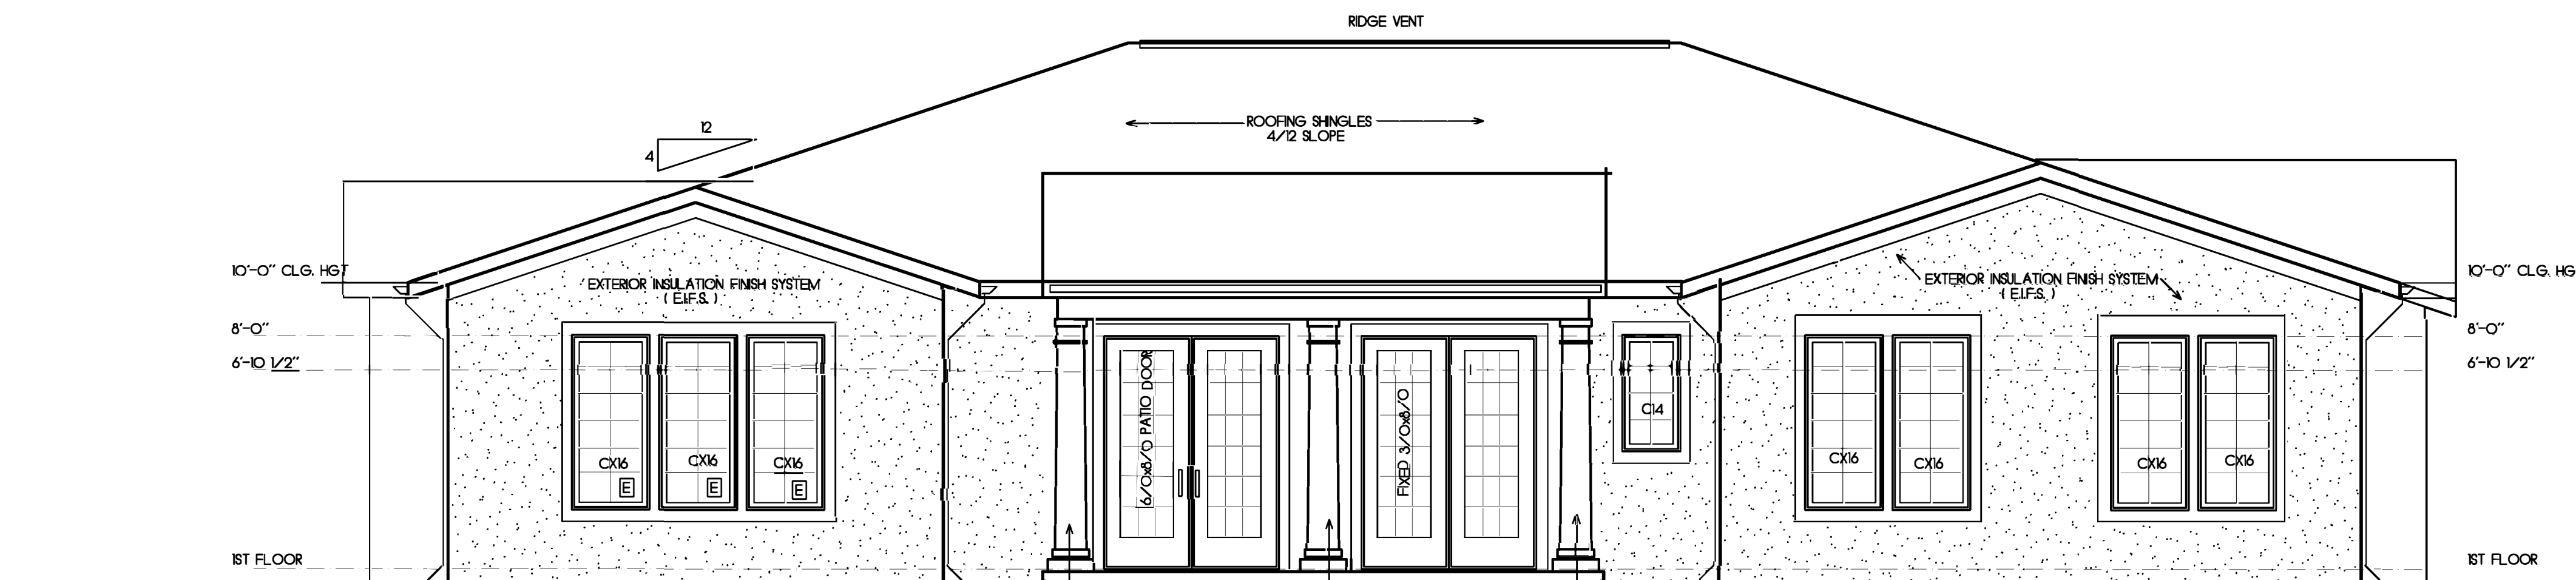

front elevation
1/4"=1'-0"

- ⓔ DENOTES EGRESSIBLE WINDOW UNIT W/ 57 SF. MIN. OPENING, 20" MIN. OPENING WIDTH AND 24" MIN. OPENING HEIGHT
- ⓓ DENOTES TEMPERED GLASS PER R308 OF THE NEW YORK STATE CODE

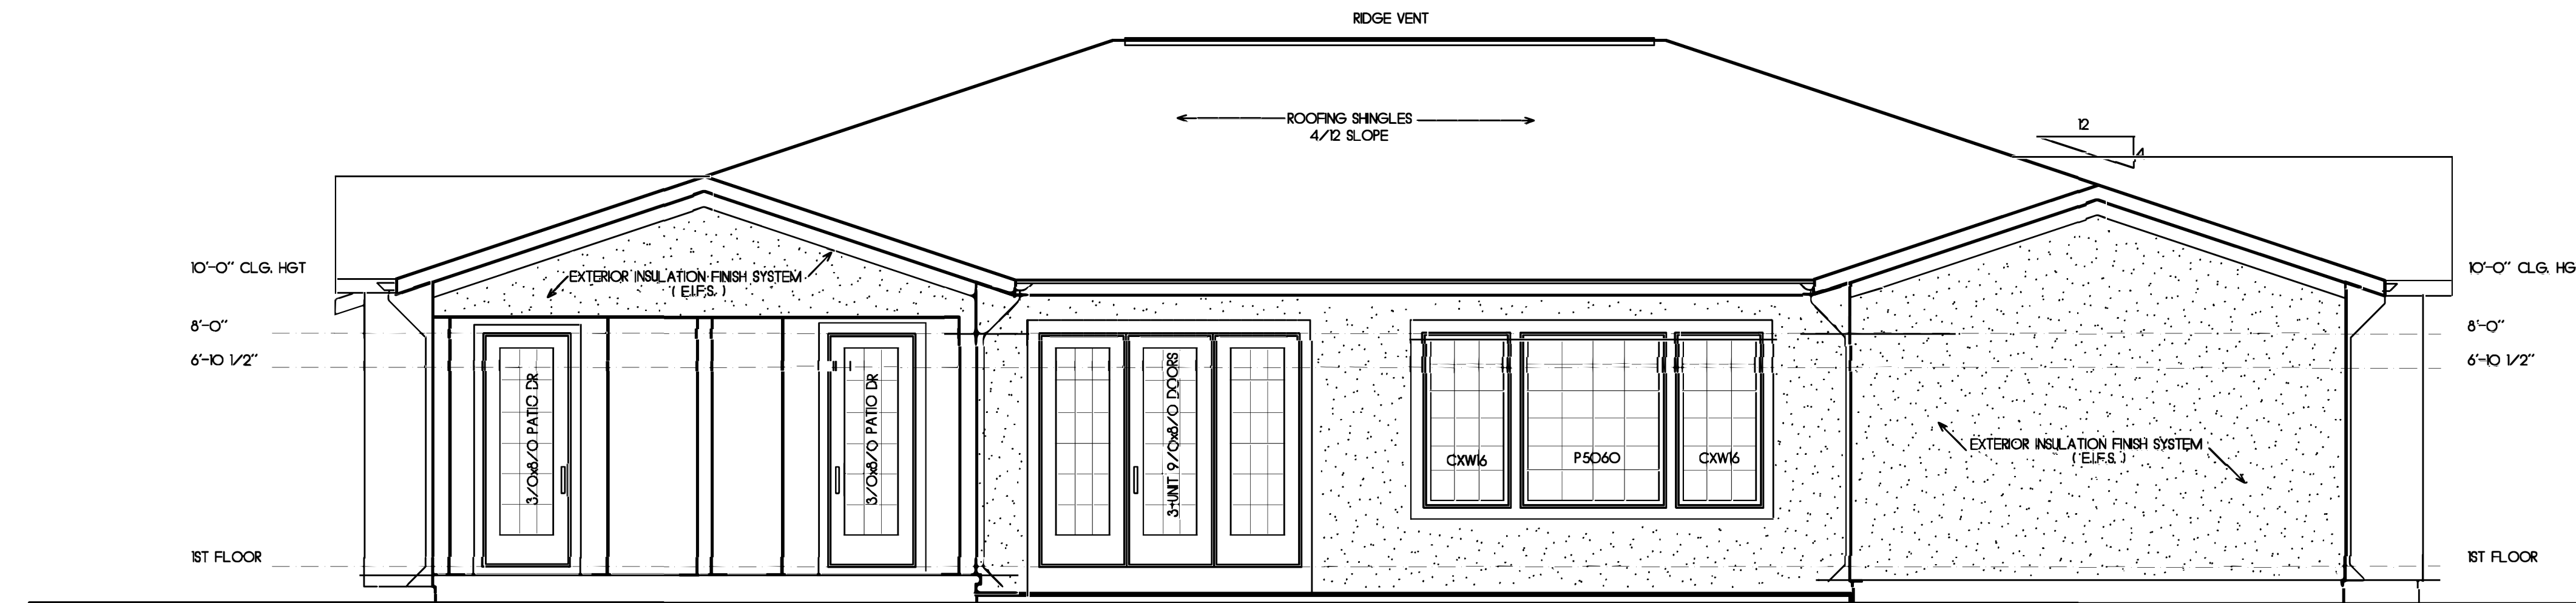

rear elevation
1/4"=1'-0"

AIR BARRIER INSPECTION LIST	
AIR BARRIER & THERMAL BARRIER	EXTERIOR THERMAL ENVELOPE INSULATION FOR FRAMED WALLS IS INSTALLED IN SUBSTANTIAL CONTACT & CONTINUOUS ALIGNMENT WITH BUILDING ENVELOPE AIR BARRIER
	BREAK JOINTS IN THE AIR BARRIER ARE FILLED OR REPAIRED
	AIR PERMEABLE INSULATION IS NOT USED AS A SEALING MATERIAL
	AIR PERMEABLE INSULATION IS INSIDE OF AIR BARRIER
CEILING ATTIC	AIR BARRIER IN ANY DROPPED CEILING/SOFFIT IS SUBSTANTIALLY ALIGNED WITH INSULATION AND GAPS ARE SEALED
WALLS	ATTIC ACCESS (EXCEPT UNVENTED ATTIC KNEE WALL OR STAIR ACCESS) IS SEALED
	CORNERS AND HEADERS ARE INSULATED
	JUNCTIONS OF FOUNDATION AND SILL PLATE ARE SEALED
WINDOWS AND DOORS	SPACE BETWEEN JAMBS AND FRAMING AREA SEALED
RIM JOISTS	RIM JOISTS ARE INSULATED AND INCLUDE AN AIR BARRIER
FLOORS INCLUDING ABOVE GARAGES AND CANTILEVER FLOORS	INSULATION IS INSTALLED TO MAINTAIN PERMANENT CONTACT WITH UNDERSIDE OF SUBFLOOR DECK
	AIR BARRIER IS INSTALLED AT AND EXPOSED EDGE OF INSULATION
CRAWL SPACE WALLS	INSULATION IS PERMANENTLY ATTACHED TO WALLS
	EXPOSED EARTH IN UNVENTED CRAWL COVERED WITH CLASS I VAPOR BARRIER OVERLAP JOINTS & TAPE
SHAFTS, PENETRATIONS	DUCT SHAFTS, UTILITY PENETRATIONS, KNEE WALLS AND FLUE SHAFTS ARE SEALED
NARROW CAVITIES	BATTS IN NARROW CAVITIES ARE CUT TO FIT OR FILLED WITH SPRAY-BLOWN-IN
GARAGE SEPARATION	AIR SEALING IS PROVIDED BETWEEN THE GARAGE AND CONDITIONED SPACES
RECESSED LIGHTING	RECESSED LIGHTS ARE AIR TIGHT, IC RATED AND SEALED TO DRYWALL, UNLESS IN UNCONDITIONED SPACE
PLUMBING AND WIRING	INSULATION IS PLACED BETWEEN OUTSIDE AND PIPES
SHOWER/TUB ON EXTERIOR WALL	SHOWERS AND TUBS ON EXTERIOR WALLS HAVE INSULATION AND AN AIR BARRIER SEPARATING THEM FROM THE EXTERIOR WALL
ELECTRICAL/PHONE BOX ON EXT. WALL	AIR BARRIER EXTENDS BEHIND BOXES OR AIR SEALED TYPE BOXES ARE INSTALLED
COMMON WALL	AIR BARRIER IS INSTALLED IN COMMON WALL BETWEEN UNITS
HVAC REGISTER BOOTS	HVAC REGISTER BOOTS THAT PENETRATE ENVELOPE ARE SEALED TO SUBFLOOR OR DRYWALL
FIREPLACE	FIREPLACE WALLS INCLUDE AN AIR BARRIER

REVISIONS		
No.	DATE	DESCRIPTION

A-4

APRIL 2022




ALA architects

255 EAST AVENUE ROCHESTER, NEW YORK 14604
(585) 704-7347 ALAARC@FRONTIERNET.NET

PROPOSED RESIDENCE
FOR
MR. & MRS. GIANGRECO

#93 KILBOURN ROAD TOWN OF PITTSFORD, NEW YORK

GIANGRECO RESIDENCE

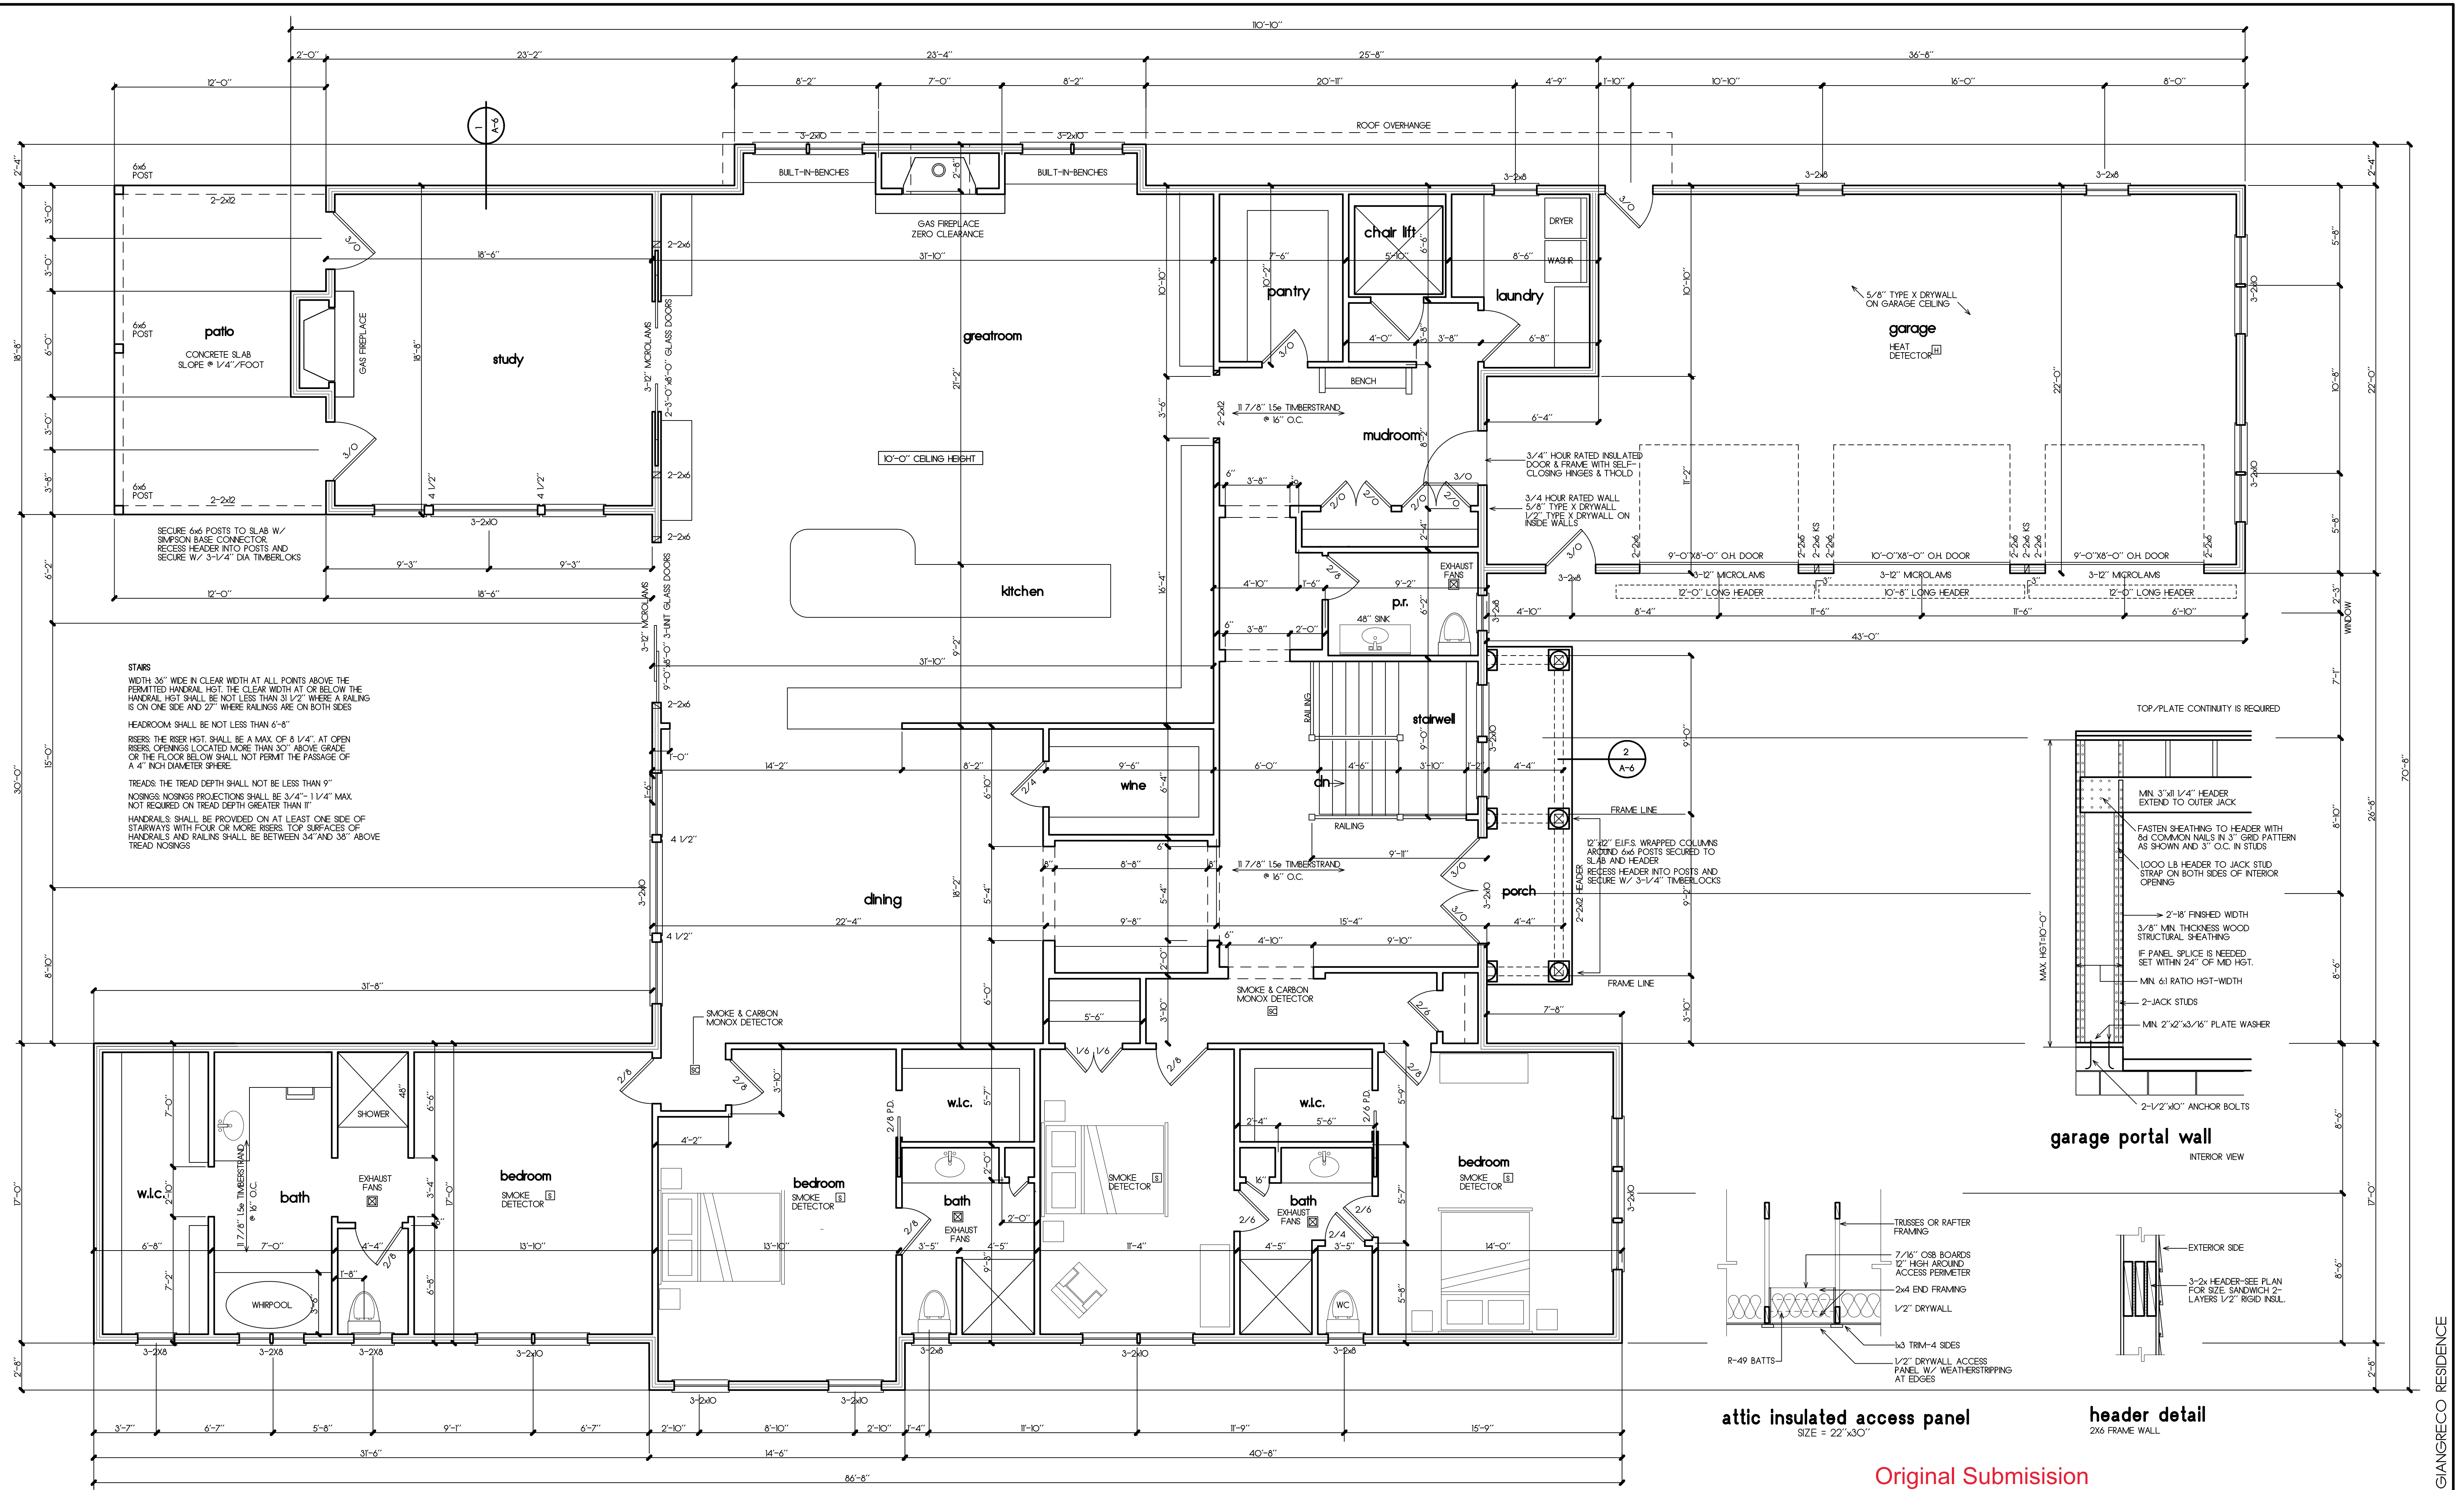

1st floor plan
 1/4"=1'-0"
 4,210 s.f.
 302 lt.

WALL LEGEND

	2x6 FRAMING @ 16" O.C.
	2x4 FRAMING @ 16" O.C.

NYS ENERGY COMPLIANCE NOTE
 THIS HOUSE COMPLIES WITH THE NEW YORK STATE ENERGY
 CODE EFFECTIVE 2020. PLEASE REFER TO ATTACHED
 CALCULATIONS FOR COMPLIANCE INFORMATION

ALA architects
 255 EAST AVENUE ROCHESTER, NEW YORK 14604
 (585) 704-7347 ALAARC@FRONTIERNET.NET

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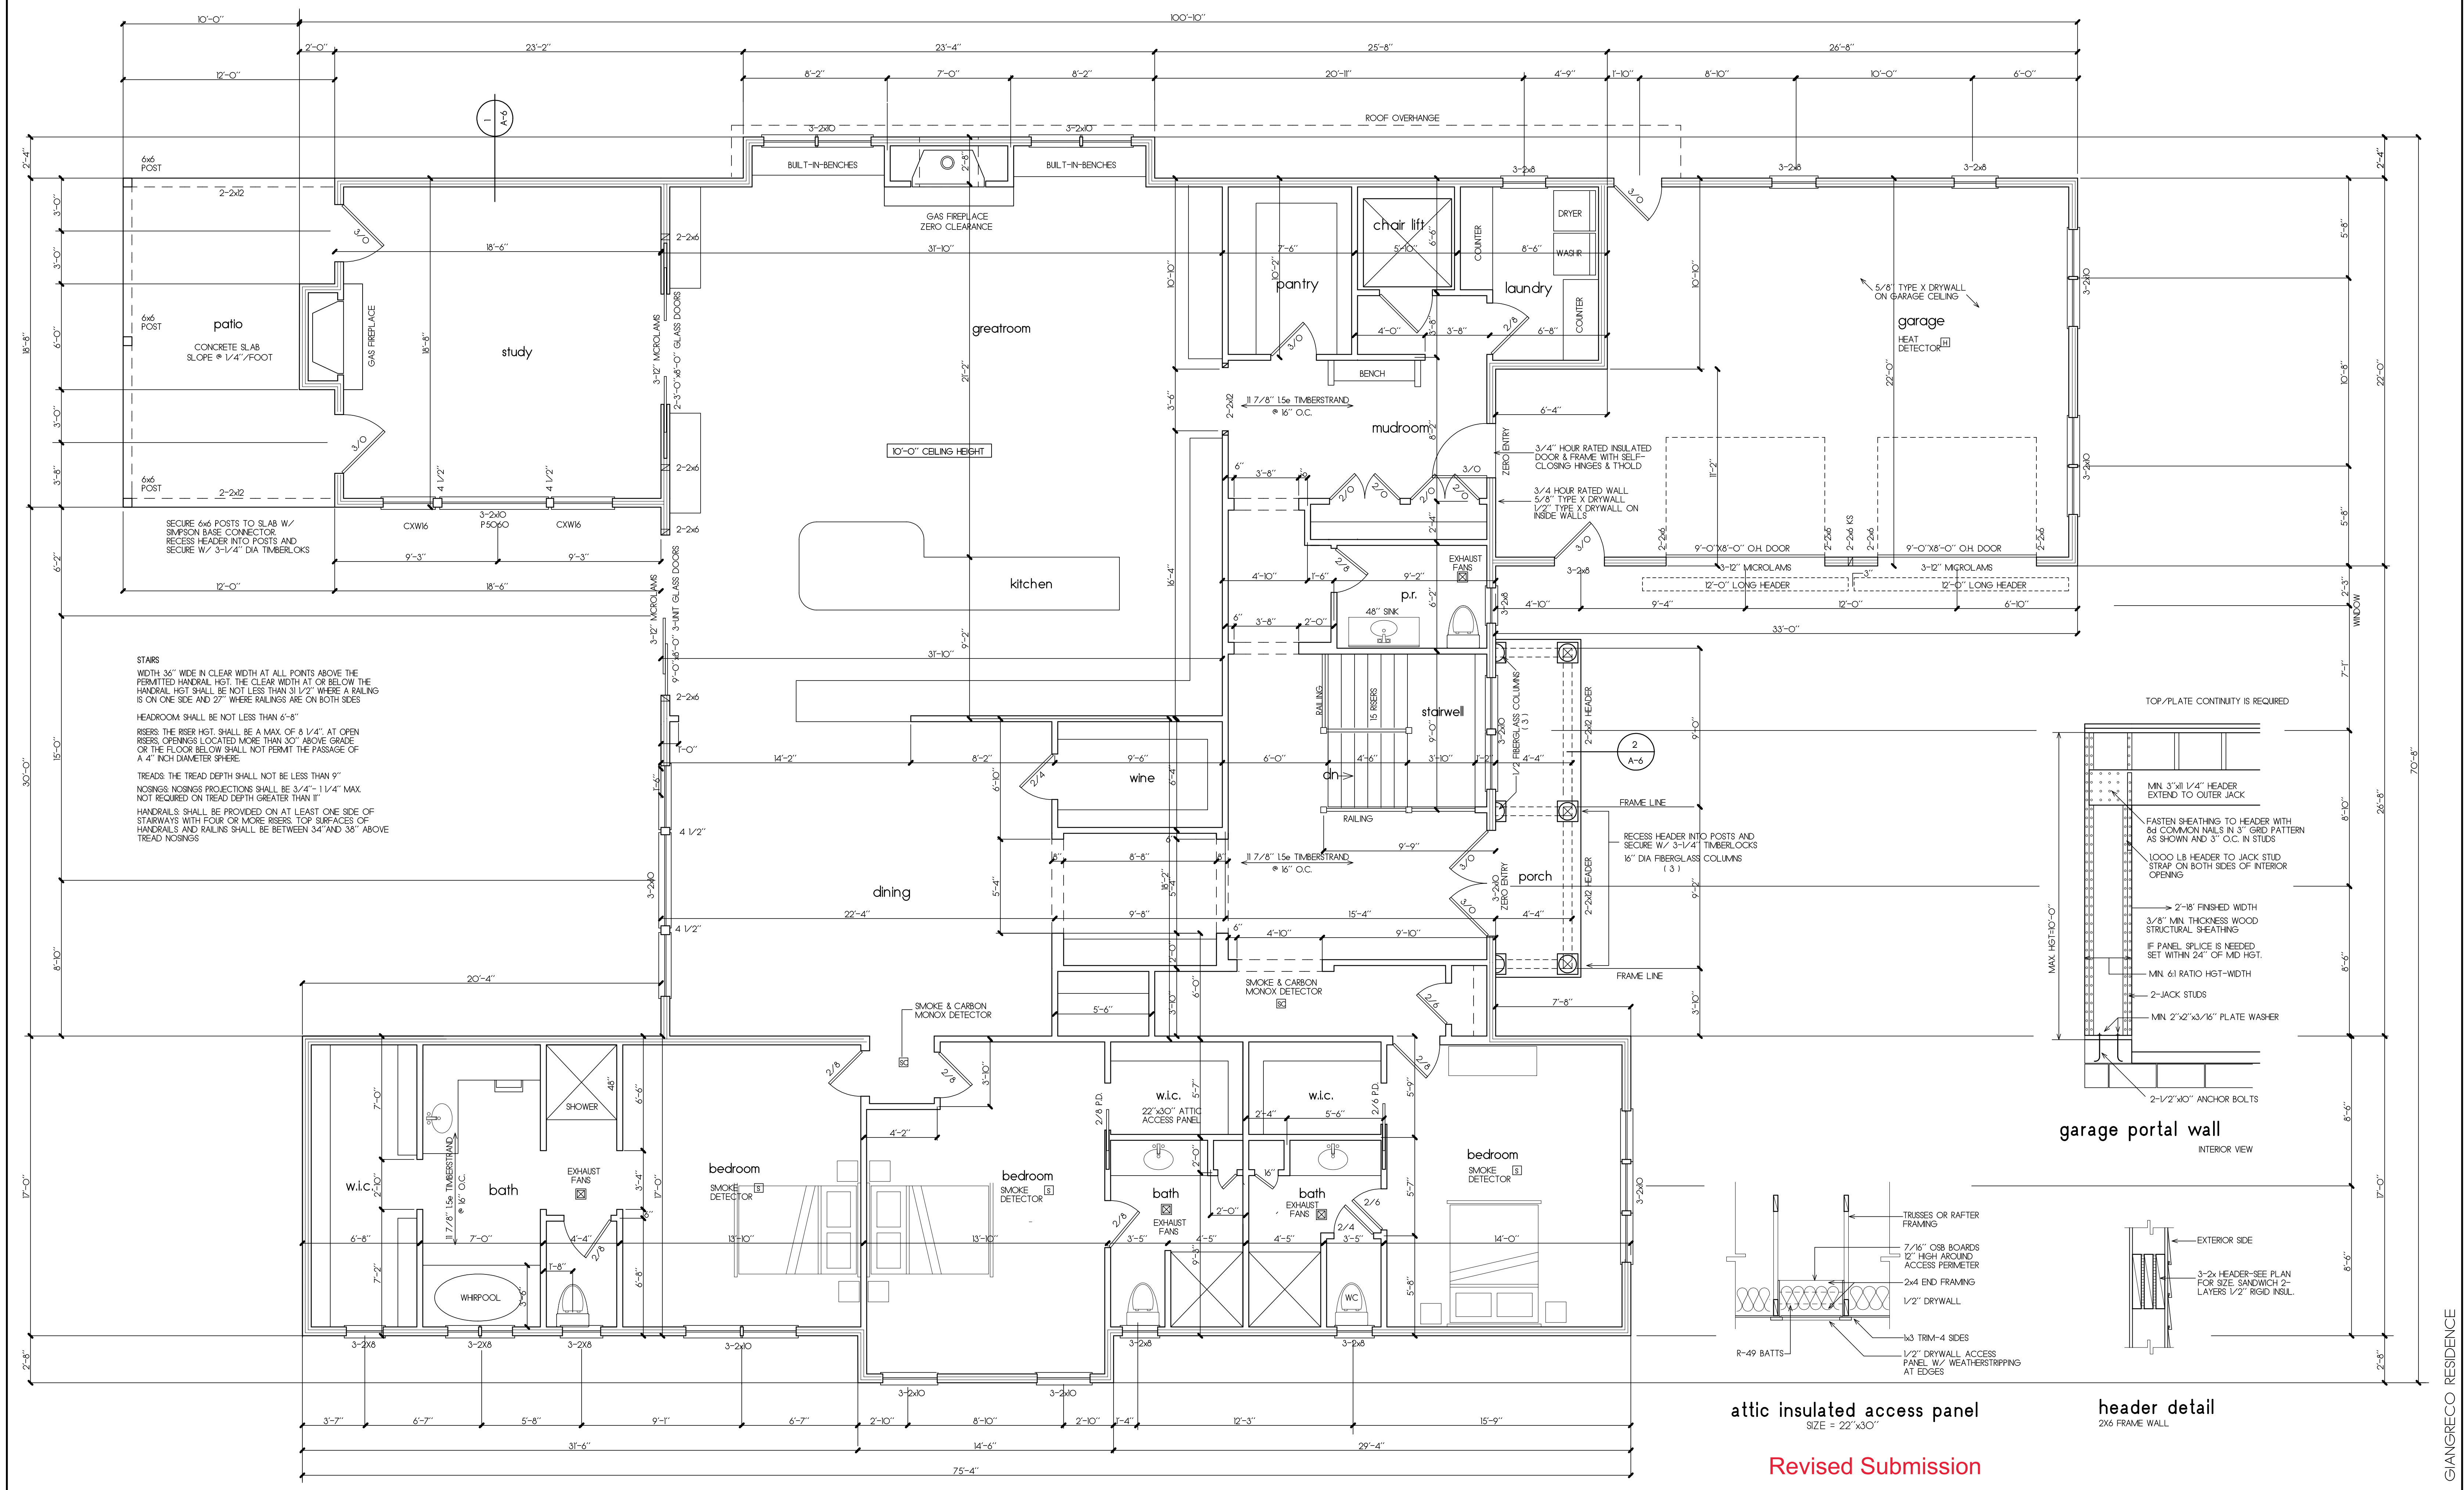
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No.	DATE	DESCRIPTION

A-1
 APRIL 2022

Original Submission

GIANGRECO RESIDENCE



1st floor plan
 1/4"=1'-0"
 4,210 s.f.
 302 II.

WALL LEGEND

	2x6 FRAMING @ 16" O.C.
	2x4 FRAMING @ 16" O.C.

NYS ENERGY COMPLIANCE NOTE
 THIS HOUSE COMPLIES WITH THE NEW YORK STATE ENERGY CODE EFFECTIVE 2000. PLEASE REFER TO ATTACHED CALCULATIONS FOR COMPLIANCE INFORMATION.

ALA architects
 255 EAST AVENUE ROCHESTER, NEW YORK 14604
 (585) 704-7347 ALAARC@FRONTIERNET.NET

PROPOSED RESIDENCE FOR MR. & MRS. GIANGRECO
 #93 KILBOURN ROAD TOWN OF PITTSFORD, NEW YORK



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No.	DATE	DESCRIPTION

A-1
 APRIL 2022

GIANGRECO RESIDENCE

Revised Submission

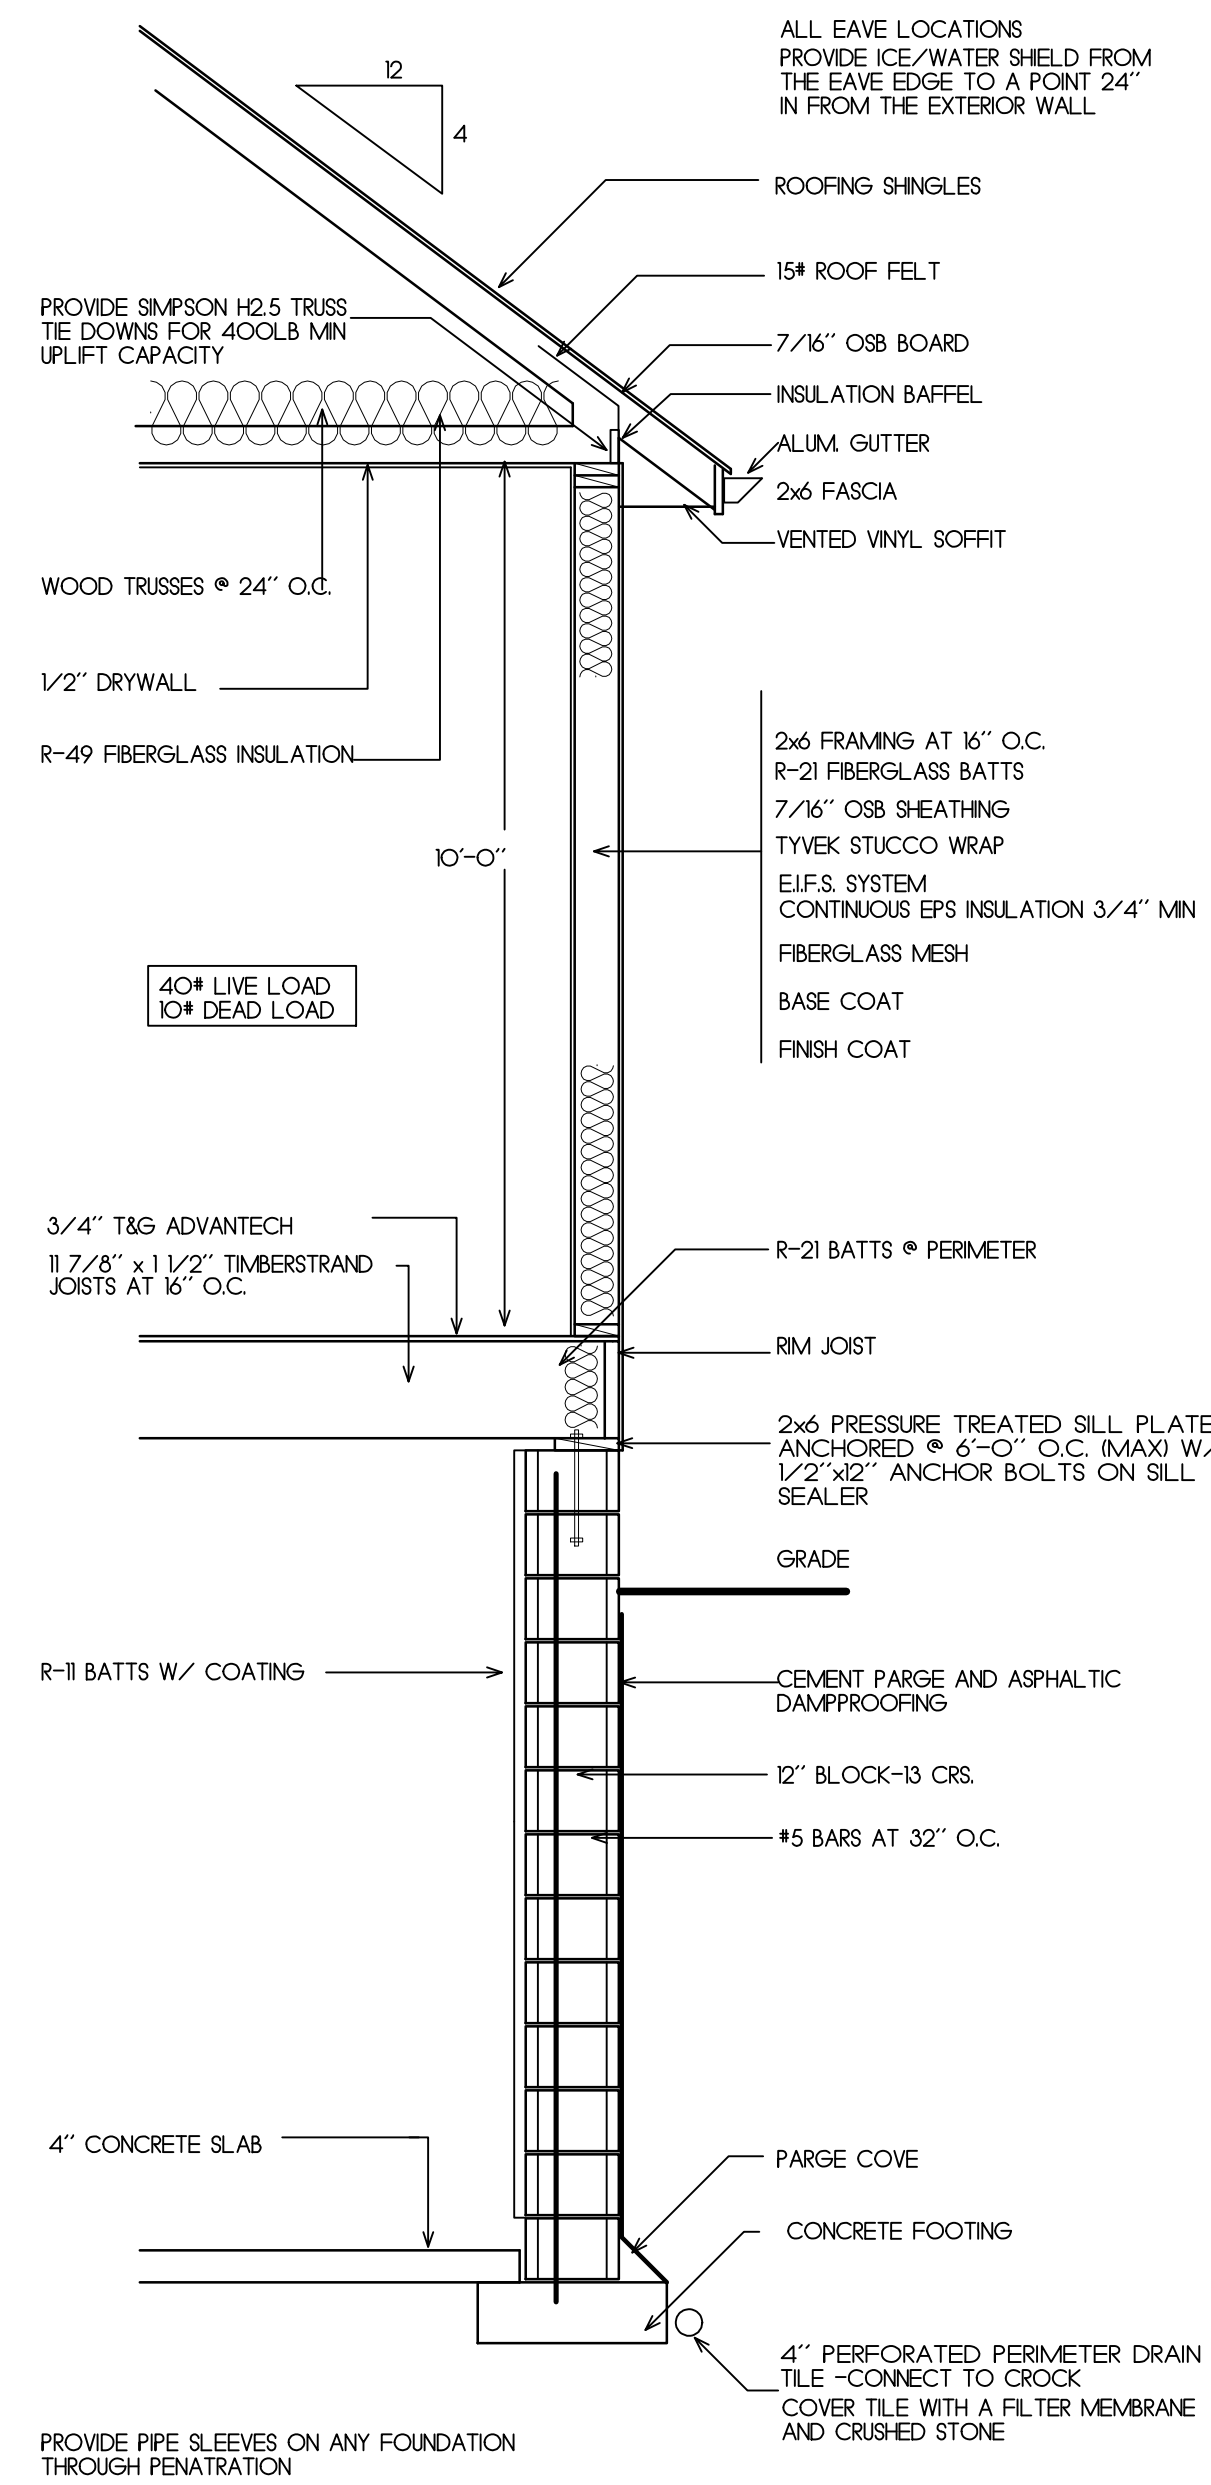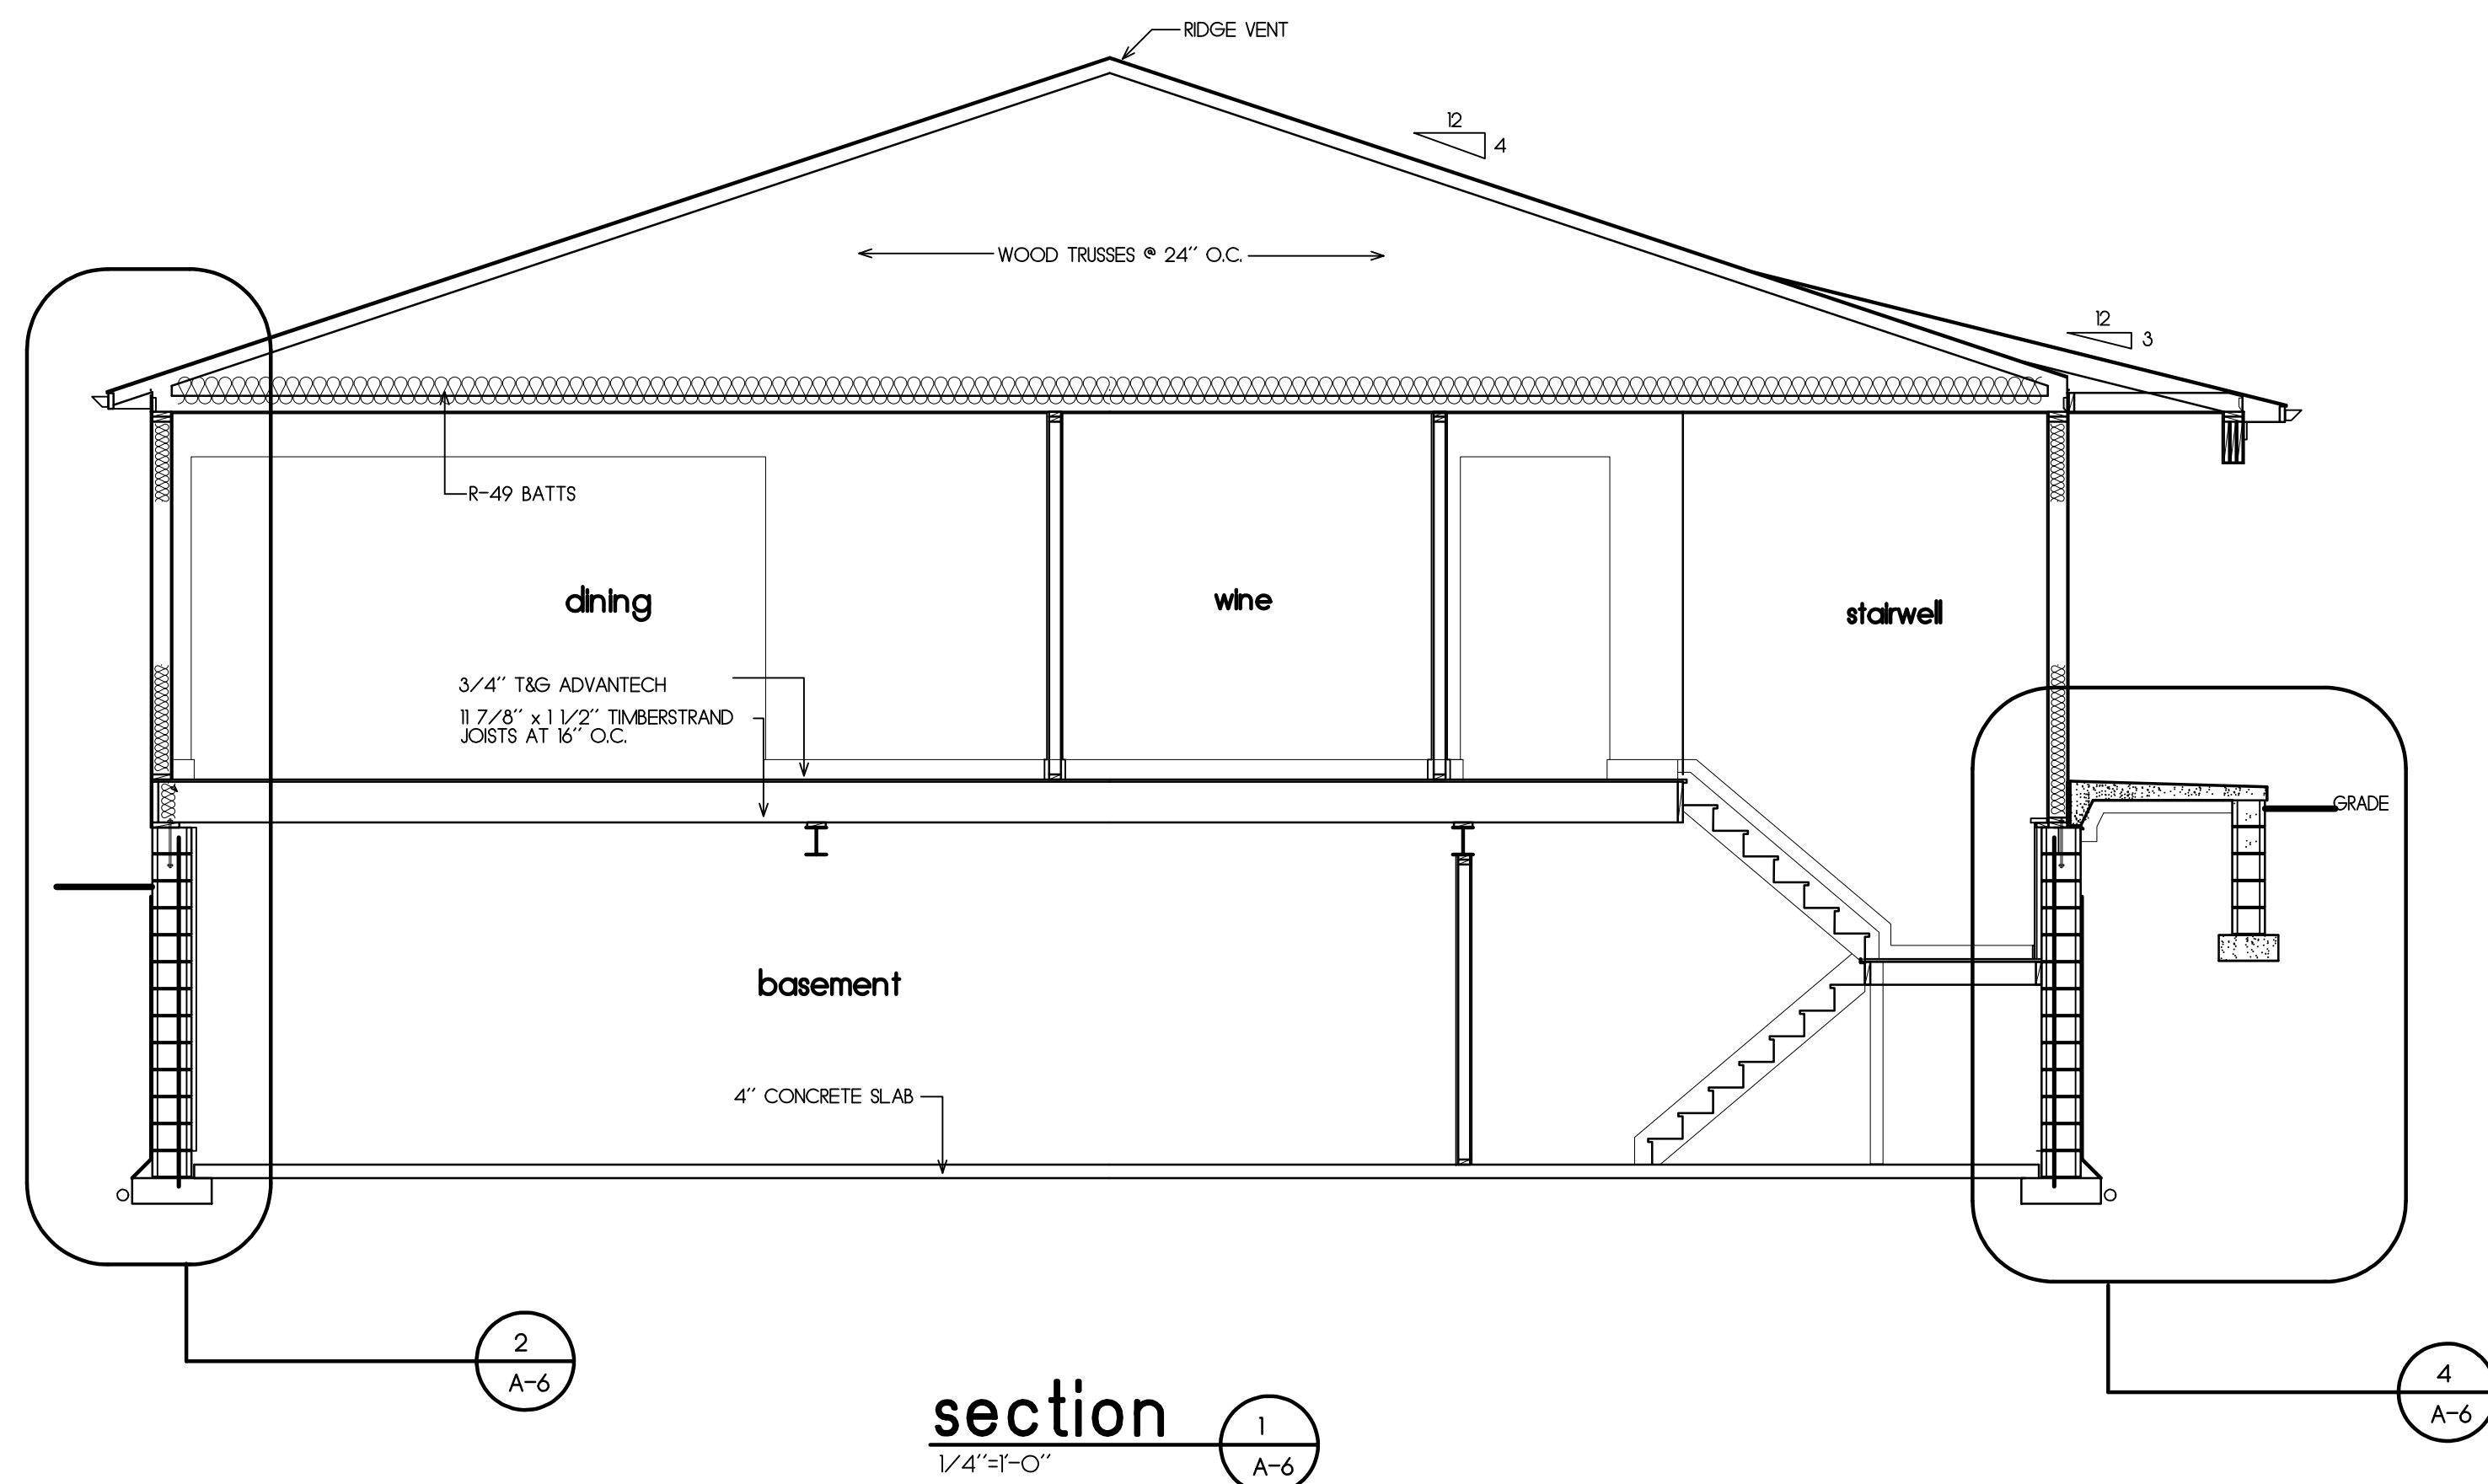

FOUNDATIONS
CONTRACTOR SHALL NOTIFY SITE ENGINEER AND ARCHITECT IF SITE CONDITIONS, SUCH AS ADVERSE GROUND WATER OR SOIL CONDITIONS WARRANT MODIFICATIONS TO THE FOUNDATION DESIGN.
FOOTINGS MAY BE POURED NEAR AGAINST SIDES OF EXCAVATIONS ONLY IF SLOUGHING OR RAVELING DOES NOT OCCUR.
CONTRACTOR SHALL BE RESPONSIBLE FOR ALL TEMPORARY EMBANKMENTS AND EXCAVATIONS.
BACKFILL SHALL NOT BE PLACED AGAINST BASEMENT WALLS UNTIL CONCRETE AND GROUT HAS REACHED SUFFICIENT STRENGTH TO RESIST DAMAGE OR STRUCTURAL FLOOR FRAMING INCLUDING PLYWOOD DECK IS IN PLACE OR SUFFICIENT WALL BRACING IS IN PLACE.

STRUCTURAL BACKFILL
STRUCTURAL BACKFILL OF WELL GRADED SAND AND GRAVEL OR CRUSHER RUN STONE SHALL BE PLACED IN 4" MAX. LIFTS AND COMPACTED TO A MIN. DENSITY OF 95% UNDER SLABS AND BUILDINGS AND 90% ELSEWHERE OF MAX. DENSITY AT OPTIMUM MOISTURE CONTENT PER ASTM D698.
BACKFILL SHALL BE FREE OF EXCESSIVE VEGETATION, DEBRIS OR OTHER DELETERIOUS MATERIALS AND CONTAIN NO PARTICLES LARGER THAN 3" IN DIA. AND NO MORE THAN 10% PASSING THE #200 SEIVE.

FOUNDATION DRAINAGE
DRAINAGE TILE SHALL BE INSTALLED AT OR BELOW THE AREA TO BE PROTECTED AND SHALL DISCHARGE BY GRAVITY TO AN INTERIOR SUMP CROCK OR TO DAYLIGHT. DRAINAGE TILE SHALL BE PLACED ON A MIN. OF 2" OF WASHED GRAVEL. THE DRAINS SHALL BE SURROUNDED BY AN APPROVED FILTER MEMBRANE OR THE FILTER MEMBRANE SHALL COVER THE WASHED GRAVEL OR CRUSHED ROCK COVERING THE DRAIN. THE TILES SHALL BE PLACED ON A MIN. OF 2" OF WASHED GRAVEL OR CRUSHED ROCK NOT LESS THAN ONE SEIVE SIZE LARGER THAN THE TILE JOINT OPENINGS AND COVERED WITH 6" MIN OF THE SAME MATERIAL.

FOOTINGS
FOOTINGS SHALL BE PLACED AT A MIN OF 48" BELOW GRADE UNLESS OTHERWISE SPECIFIED ON THE DRAWINGS.
FINAL 3" OF EXCAVATION SHALL BE REMOVED BY HAND TOOL OPERATIONS IN ORDER TO ASSURE UNDISTURBED BEARING SURFACES.
BOTTOM SURFACE OF FOOTING SHALL NOT SLOPE MORE THAN 1/3 UNLESS OTHERWISE INDICATED ON THE DRAINGS.
NO EXCAVATION SHALL BE MADE LOWER AND CLOSER THAN 1/3 UNLESS INDICATED ON THE DRAWINGS.
FOOTINGS AND SLABS SHALL NOT BE PLACED ON MUDDY OR FROZEN GROUND.
ALL FOOTINGS SHALL BEAR ON FIRM AND CLEAN SOIL. THE SOIL BEARING SHOULD BE VERIFIED AT THE FOOTINGS BY AN ACCEPTED TESTING METHOD.
CONCRETE MASONRY
CONCRETE BLOCK UNITS SHALL CONFORM TO ASTM C90 TYPE I, GRADE N.
MORTAR - ASTM C270, TYPE S (1 in 1500 PSI)
BLOCK FILL - COURSE GROUT 3,000 PSI








FOUNDATION DRAINAGE
BASEMENT AND CRAWL SPACE WALLS SHALL BE WATERPROOFED FROM THE TOP OF THE FOOTING TO FINISH GRADE. WALLS SHALL BE WATERPROOFED WITH ONE OF THE FOLLOWING:
1. TWO PLY HOT MOPPED FELTS
2. 55 LB ROLL ROOFING
3. 6 MIL POLYVINYL CHLORIDE
4. 6 MIL POLYETHYLENE
5. 40 MIL POLYMER MODIFIED ASPHALT
6. 60 MIL FLEXIBLE POLYMER CEMENT
7. 1/8" CEMENT BASED FIBER REINFORCED WATER PROOFING
8. 60 MIL SOLVENT FREE LIQUID APPLIED SYNTHETIC RUBBER.

CONCRETE
FOUNDATION DESIGN IS BASED ON A MIN. SOIL BEARING CAPACITY OF 2,000 PSF. BUILDER SHALL NOTIFY ARCHITECT IF CAPACITY IS LESS.
PROVIDE 6 MIL POLYETHYLENE VAPOR BARRIER UNDER CONCRETE INTERIOR SLABS.
PROVIDE ALL NECESSARY TIE BARS, SPACER BARS, CHAIRS, ETC TO SECURE REINFORCING IN PLACE BEFORE PLACING CONCRETE.

A. STANDARDS-LATEST EDITION OF ACI.
B. DESIGN STRENGTH AT 28 DAYS.

1. FOOTINGS, WALLS AND PIERS-3,000 PSI
2. SLAB ON GRADE-INTERIOR 2,500 PSI
EXTERIOR 3,500 PSI

REINFORCING-
BARS- ASTM A615, GRADE 60
TRUSSED MASONRY JOINT REINFORCING ASTM A82
LAP SPLICES OF REINFORCING BARS SHALL BE 40 BAR DIA BUT NOT LESS THAN 24"
FILL BLOCK CORSE SOLID UNDER LINTELS, BEAM POCKETS, AND ALL BEARING PLATES WITH 3,000 PSI GROUT.
KEEP CORES OF REINFORCED MASONRY FREE OF MORTAR DROPPINGS
ANCHOR BOLTS SHALL CONFORM TO ASTM A-307 AND SHALL BE 1/2" DIA MIN AND 27" LONG. PLACEMENT OF ANCHOR BOLTS SHALL BE 12" FROM END PLATE, 6'-0" O.C. AND MIN. OF 2 ANCHOR BOLTS IN ANY ONE SECTION. LOCATE IN MIDDLE THRD OF PLATE AT LEAST 1 1/8" FROM THE EDGE OF A 2x4 AND 1 3/4" FROM THE EDGE OF A 2x6.

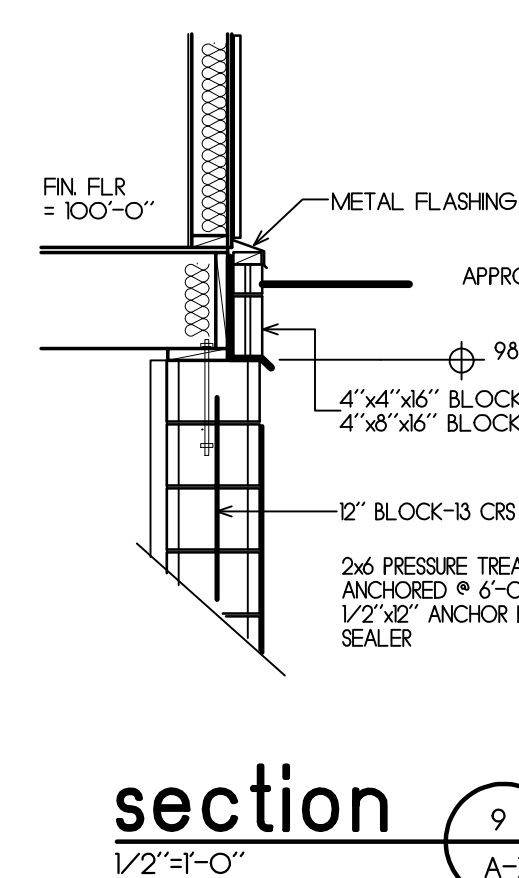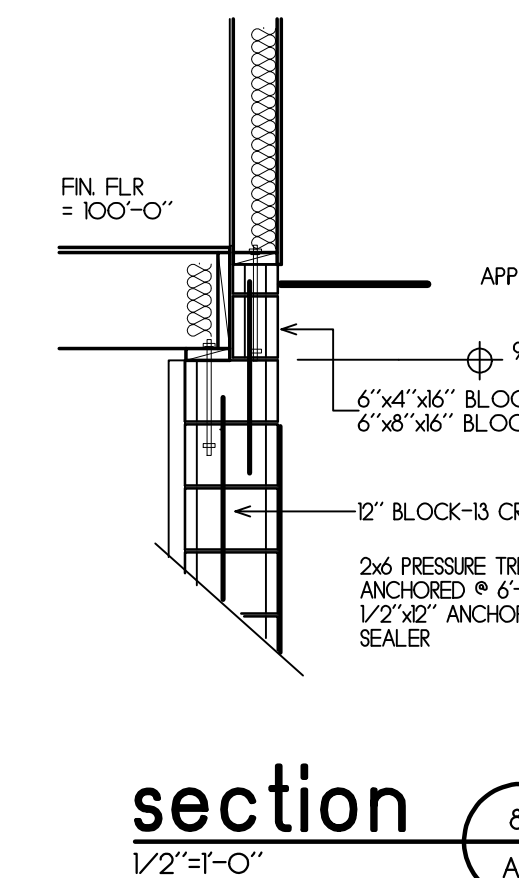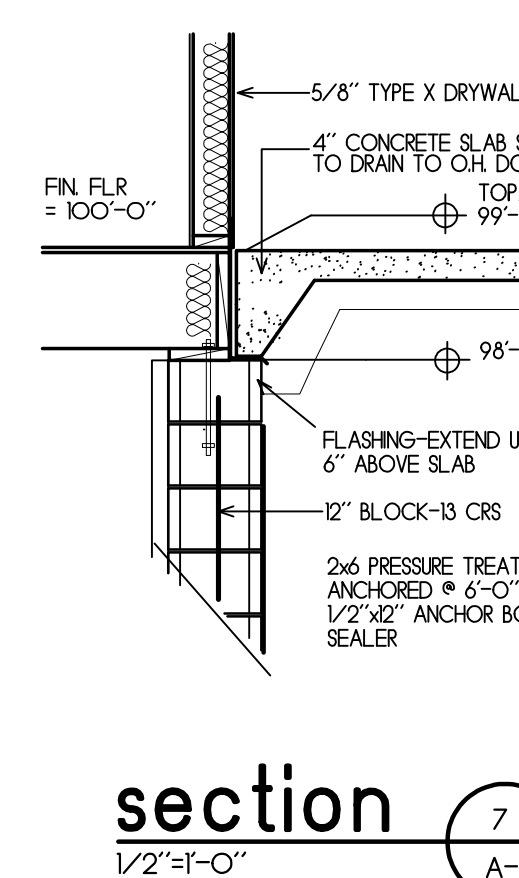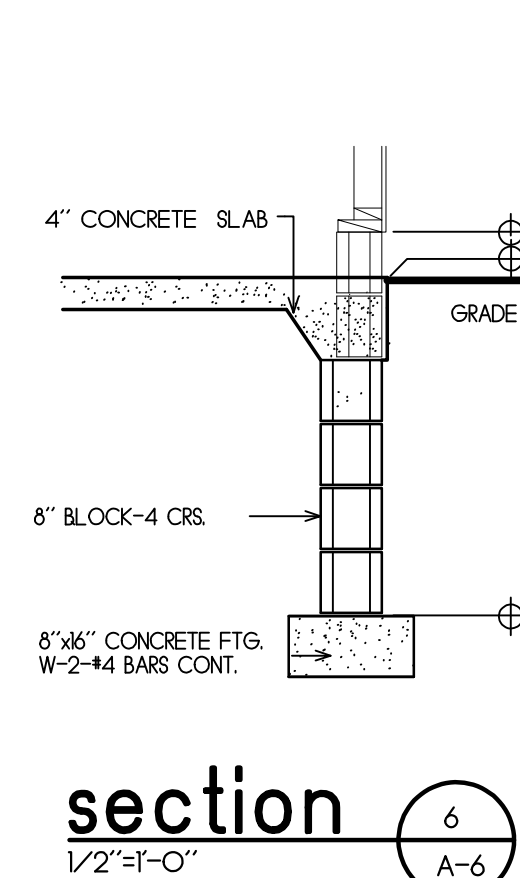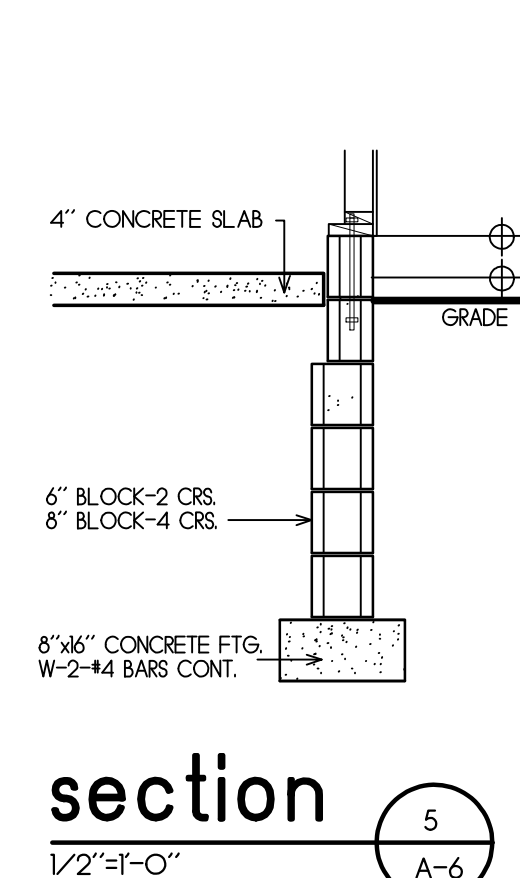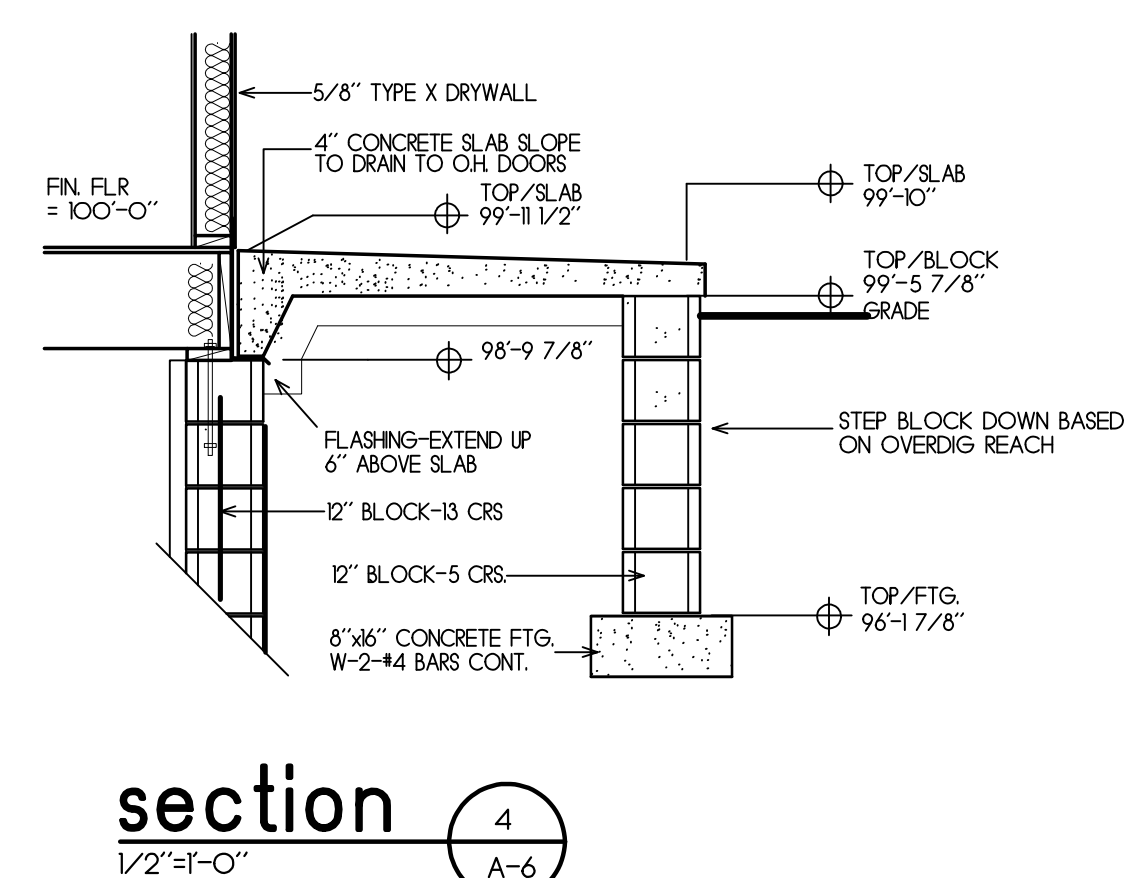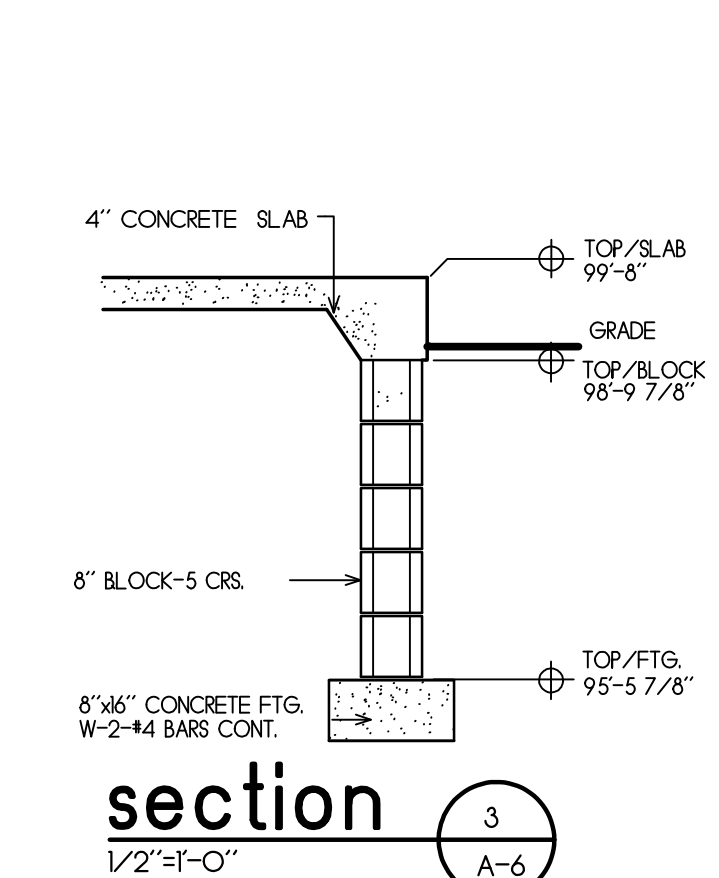

REVISIONS	DATE	DESCRIPTION









3497

93

103

113

123

133

83

73

63

51

41

Kilbourn Rd

136

106

100

94

76

72

70

58

50

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04/03/2021 - 04/06/2021

Proposed Residence
4,300.5 Sq. Feet
0.059 Acres


Proposed Driveway
885.9 Sq. Feet
0.020 Acres

St. Gelboe


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007 Pkt. 2
29th Mass.

Public Notification

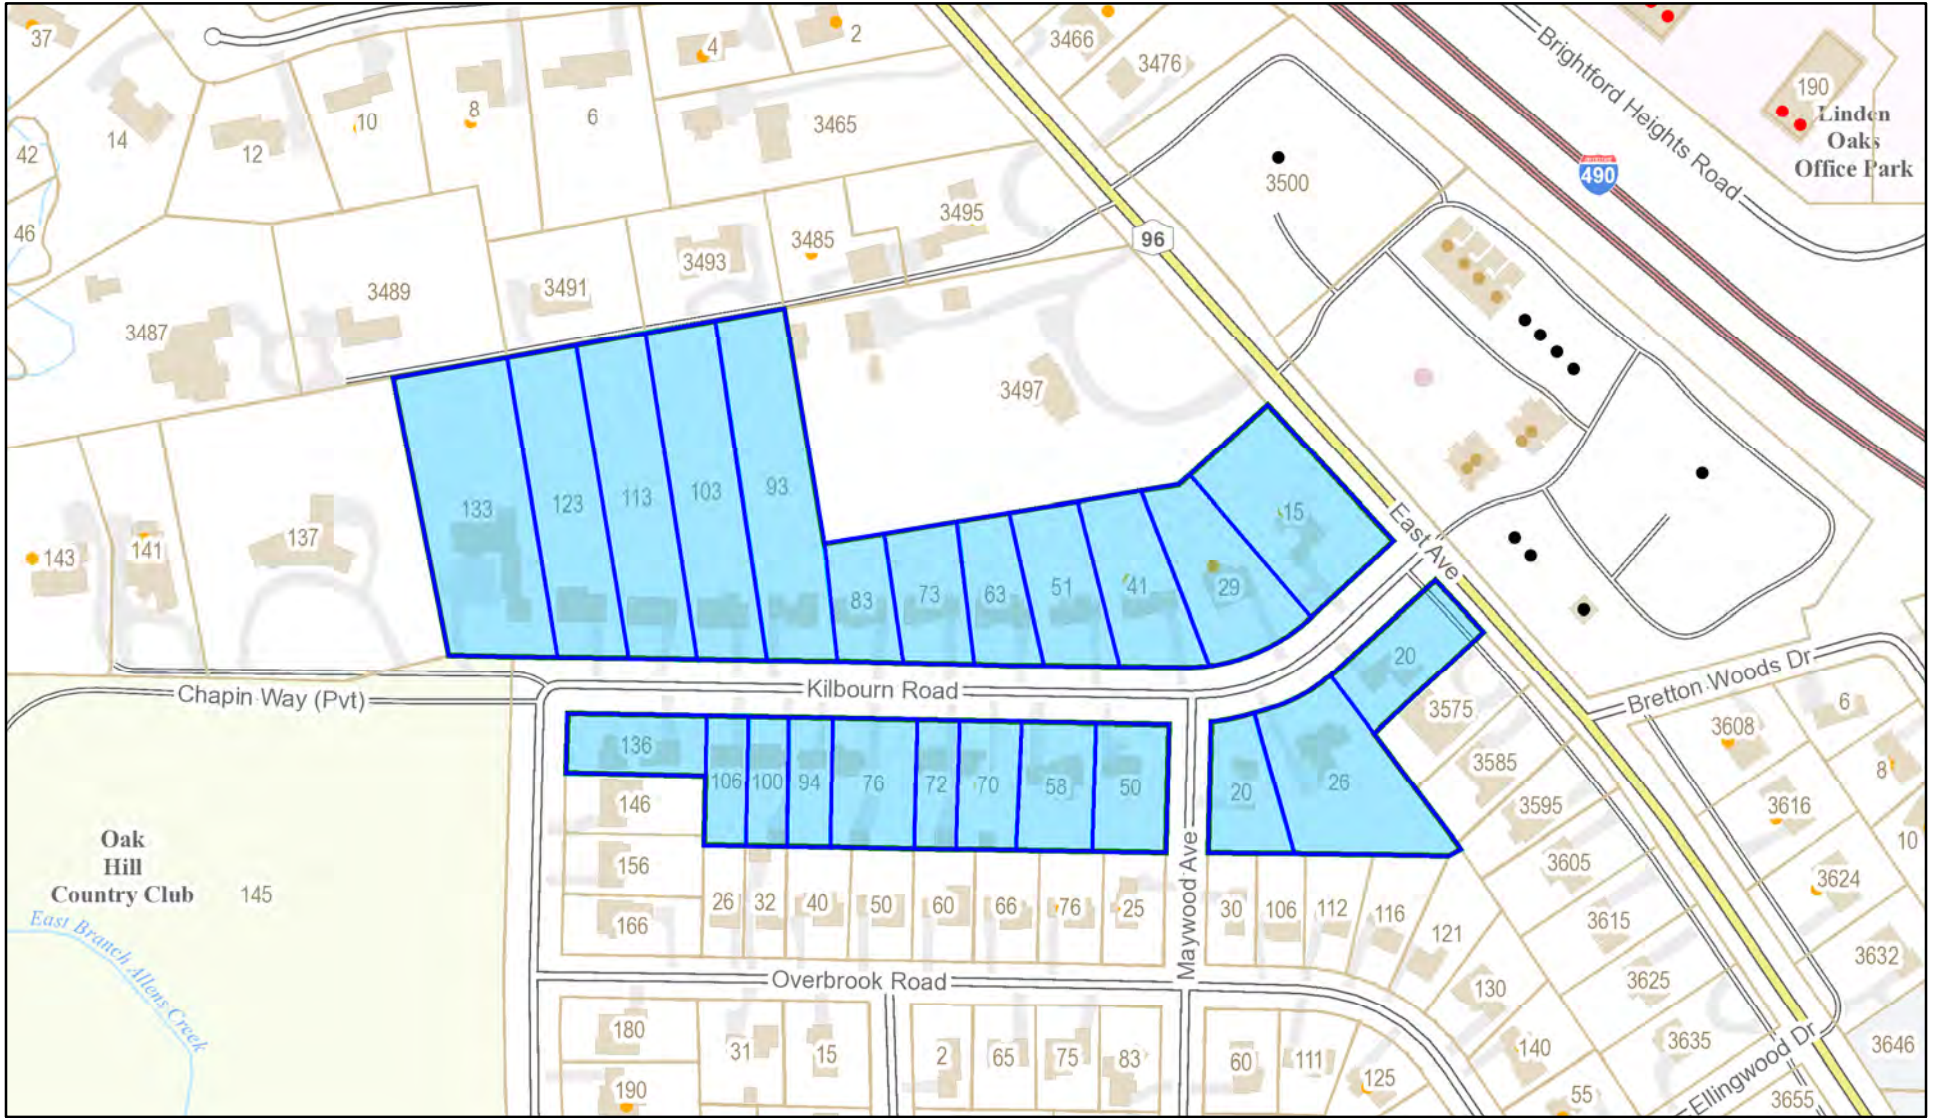

Printed June 7, 2022

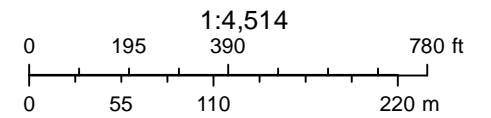

Town of Pittsford GIS

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APPLICATION FOR PERMIT

No. 98
Fee \$ 20.00

To THE TOWN BOARD OF THE TOWN OF PITTSFORD, N. Y.

GENTLEMEN:

The undersigned respectfully petition for a permit to ~~alter~~ erect a Great building on Lot No. R-9 House No. 12593 on the North side of Kilbourn Rd Street, in the East Ave Estates Tract of TOWN OF PITTSFORD, N. Y. This lot is 100 ft. wide in the front and 70 feet wide in the rear and 500 feet deep.

Classified as Res. Zone Class A

NOTICE: A Plan, in duplicate, size 4 1/2" x 7", must be furnished showing the shape of the lot and all dimensions, with the proposed building set in, with all dimensions of same and showing the set back distances from all sides.

The Main Building of 1 stories to be used as a Family Dwelling is to be erected of the following dimensions, pursuant to the plans herewith submitted:

Width <u>48</u> feet	Wing on _____	Side	Width _____ feet	SET BACK <u>50</u> ft.
Depth <u>25</u> feet	Wing on _____	Side	Depth _____ feet	10+ side <u>East</u> ft.
			Width _____ feet	10+ side <u>West</u> ft.
			Depth _____ feet	

The whole occupying a total area of 1155 square feet.

PORCH: Open _____ side, _____ feet wide, _____ feet deep.

GARAGE: An attached garage is to be erected on the West side of the dwelling frame construction, of the following dimensions:

1 Stories, Width 21 feet, Depth 25 feet, Capacity 2 cars.
Located 10+ feet from the West Lot line.
Located _____ feet from the _____ Lot line.

ESTIMATED COST:

Dwelling	\$ _____
Garage	\$ _____
Total:	\$ <u>10,000.00</u>

The undersigned hereby guarantees that said buildings will be constructed and used in accordance with all ordinances of the TOWN OF PITTSFORD and statutes of the State of New York, and the plans annexed hereto are the PLANS RELATING TO THE BUILDINGS HEREIN DESCRIBED AND NO OTHER, and that this property is owned by the undersigned.

All work is to be done in accordance with this application and plans, and no material change therein or in any part of said buildings shall be made without the written consent of the Town Board through its authorized agent.

NOTICE: Construction must be started within 20 days from date of permit. All construction must be completed within 6 months from date of permit. No building to be used until an occupancy permit has been issued.

Architect: Jerome Wood Builder: A. M. Windsor
Yours respectfully,
A. M. Windsor
Owner
230 Kilbourn
Address

STATE OF NEW YORK, } ss:
County of Monroe A. M. Windsor

A. M. Windsor being duly sworn, deposes and says that he is the owner of the above described premises; that he has read the foregoing application for a permit and knows the contents thereof; that the same is true to his own knowledge. That if said application is approved he will comply with all the terms and conditions respecting the issuance of said permit and that said buildings will be erected in accordance with the plans attached to this application; that it will cost not less than the amount set forth herein and that he will comply with all ordinances of the Town of Pittsford and all the statutes of the State of New York in connection with the construction, erection, alterations or use of said buildings.

SWORN to before me, this
day of JUL 23 1951
[Signature]
Notary Public, Commissioner of Deeds

NOTICE: Before any excavation is made within Highway Lines, Check Location of Public Utility Lines and secure permission of Superintendent of Highways. Avoid violating possible Deed or Tract restrictions.

[Handwritten signatures and notes]

REPORT OF PLANNING BOARD

TO THE TOWN BOARD OF THE TOWN OF PITTSFORD:

The Planning Board of the Town of Pittsford, Monroe County, N. Y., to which was referred the application of

..... to erect buildings together with the proper alter fees and plans therefor, does hereby approve disapprove said application and recommends that a permit be granted therefor upon the following terms and conditions:

1. That the Town Board, its agents and employees, may at any time enter upon said premises and inspect said buildings to determine whether the same are being erected or have been erected in accordance with the plans submitted with said application for a permit.
2. That the Town Board may at any time upon notice, revoke said permit for failure to execute the plans.
3. That the said buildings shall be set back and built upon the building line established by the Town Board for the district where such property is located and where such building is to be erected or altered.
4. That the buildings mentioned in said application and plans shall be erected in accordance therewith and shall be used for no other purposes than those specified in said application and plans.
5. That any garage erected upon the premises shall be used solely for private garage purposes and shall not at any time be used for a residence or any other purpose upon said lot.
6. Reasons for disapproval are as follows:

[Faint, mostly illegible text and signatures, possibly a copy of the application or a related document.]

PITTSFORD PLANNING BOARD

By Secretary

PERMIT NUMBER 98

Permission is hereby ~~denied~~ granted to *A. M. Thaddeus*

owner to *Euch* the structures described in the application herein referred to and no other upon the terms and conditions set forth in the recommendation of the Planning Board of the Town of Pittsford, N. Y., and the Zoning Ordinance.


JUL 27 1951

[Signature]
Town Clerk

House area	1207
Garage	<u>525</u>
total area	1732 sq ft

344
76

500 ft approx

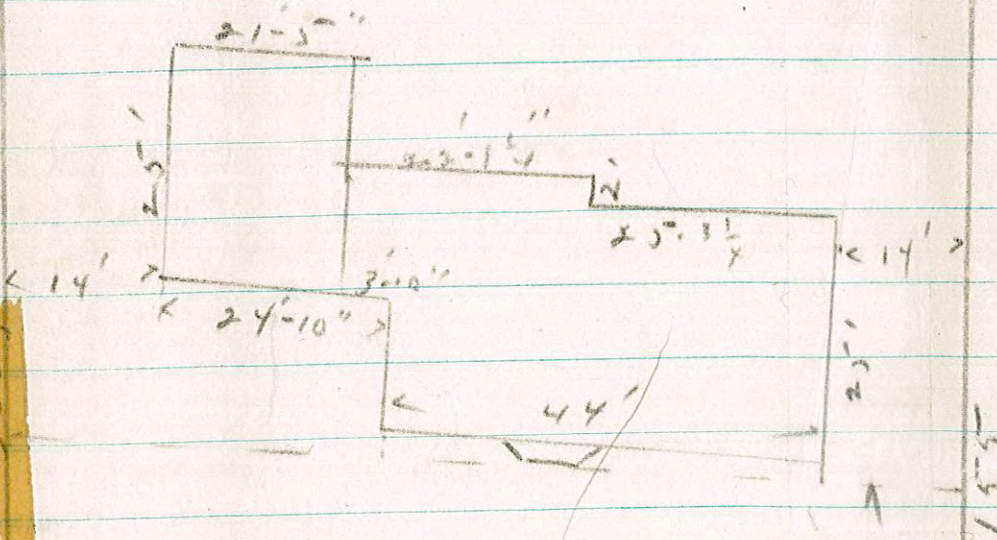

Lot 9 Kilbourn Rd
Re-Sub
100 ft

50 ft