Design Review & Historic Preservation Board Agenda March 25, 2021

HISTORIC PRESERVATION DISCUSSION

RESIDENTIAL APPLICATION FOR REVIEW

• 6 Wild Berry Lane

The Applicant is requesting design review for additions to the kitchen and master bedroom. The kitchen will have a 9 square foot addition to expand on the existing square footage. The bedroom will have an addition of 140 square feet for a walk in closet. The materials will match the existing home.

292 Shoreham Drive

The Applicant is requesting design review for the remodel of an existing enclosed porch and the addition of a covered entry. The enclosed porch is approximately 64 square feet and the covered entry will be approximately 26 square feet.

135 Sylvania Road

The Applicant is requesting design review for the addition of a covered porch. The porch will be approximately 285 square feet and will be constructed on the rear of the home.

49 Charmwood Road

The Applicant is requesting design review for the addition of a covered porch and kitchen expansion. The kitchen addition will be approximately 52 square feet and the covered porch will be approximately 24 square feet.

RESIDENTIAL APPLICATION FOR REVIEW - NEW HOME

• 640 Mendon Center Road

The Applicant is requesting design review for the construction of a one story single family home. The home will be approximately 4104 square feet and located on a large parcel south of the thruway.

2 Eppingwood Trail

The Applicant is requesting design review for the construction of a two story single family home. The home will be approximately 4027 square feet and will be attached to an existing garage. The home will be located in the Malvern Hills Subdivision.

APPLICATION FOR A CERTIFICATE OF APPROPRIATENESS

70 Mitchell Road

The Applicant is requesting a Certificate of Appropriateness, pursuant to Code Section 185-196, for the exterior renovation of a designated historic home. This property is zoned (RN) Residential Neighborhood.

INFORMAL REVIEW

• 3280 Monroe Avenue

The Applicant is requesting informal design review for the exterior alteration and renovation to the existing McDonald's Restaurant. The project consists of alterations to the front, sides, rear and roof of the building.

OTHER - REVIEW OF 3/11/2021 MINUTES

DRHPB Meeting Agenda March 25, 2021 Page 2 of 2

How to view the meeting:

1. Zoom

- In your web browser, go to
- https://townofpittsford.zoom.us/j/81313717412?pwd=UVRCVUd2U05FanJtVHJWQUN2N2UxZz09
- You will be connected to the meeting.

2. Telephone

• You can access the meeting by phone. Use any of the phone numbers below, then enter the meeting ID when prompted. The Meeting ID is **813 1371 7412**. No password is necessary.

(929) 205-6099	(312) 626-6799
(253) 215-8782	(301) 715-8592
(346) 248-7799	(669) 900-6833

Draft

Design Review and Historic Preservation Board Minutes March 11, 2021

PRESENT

Dirk Schneider, Chairman; Paul Whitbeck, John Mitchell, Leticia Fornataro, Kathleen Cristman, Bonnie Salem

ALSO PRESENT

Kevin Beckford, Town Board liaison; Robert Koegel, Town Attorney; Mark Lenzi, Building Inspector; Susan Donnelly, Secretary to the Board

ABSENT

Dave Wigg

Proceedings of a regular meeting of the Pittsford Design Review and Historic Preservation Board were held on Thursday, March 11 at 6:00 P.M. local time. The meeting took place with Board members and applicants participating remotely using Zoom.

Dirk Schneider, Chairman opened the meeting at 6:00 pm.

HISTORIC PRESERVATION DISCUSSION

Bonnie Salem reported that she has been researching a state marker for the recently designated East Street Burying Ground. She reviewed photos of examples of the state markers and potential language for it. Audrey Johnson, Town Historian, is working on obtaining an estimate of cost for this sign. The Town would be responsible for purchasing the sign and funds will need to be requested from the Town Board. The Board agreed that this would be a fitting marker. John Mitchell also suggested as another option placing a natural boulder with a Town historic plaque at the site.

RESIDENTIAL APPLICATION FOR REVIEW

11 Cedarwood Circle

The Applicant is requesting design review for the addition of a mudroom. The existing covered porch will become the new mudroom and will be approximately 21 square feet located on the front of the home.

The homeowner, Bob Sherwood, and contractor, John Carson were present to discuss the application with the Board.

The new mudroom created by enclosing the existing porch will feature stone veneer on the entire surface wall to match the walkway of the home. It was noted that the drawing presented to the Board depicted lap siding.

Paul Whitbeck moved to accept the application as submitted with the clarification that the new wall will be faced with stone veneer.

Leticia Fornataro seconded.

All Ayes.

21 Brookwood Road

The Applicant is requesting design review for the addition of a screened porch. The porch will be approximately 400 square feet and will be located to the rear of the home.

The homeowner, Chris DiPasquale, and Joe DiPasquale were present.

The project was described as a rear bump out to build a screened in porch on an existing patio. The siding will be board and batten.

Dirk Schneider made the suggestion to match the shingles with the architectural shingles of the home.

Leticia Fornataro moved to accept the application as submitted with the recommendation of utilizing architectural shingles on the bump out roof to match the existing structure.

John Mitchell seconded.

All Ayes.

6 Canal Park Place

The Applicant is requesting design review for a covered deck addition and oversized gazebo. The covered deck will be approximately 684 square feet and gazebo will be 450 square feet. The applicant appeared before the Zoning Board of Appeals and was granted a variance for a side setback and an oversized accessory structure.

The homeowner, Scott Cooper, was present to discuss the application with the Board.

Mr. Cooper discussed that the current deck will be demolished. A covered deck and separate open pavilion will be constructed. He clarified for the Board that there will be a door underneath the deck built flush with the siding to appear invisible to provide access to a storage area for pool equipment and furniture. He indicated that the railings will match the existing small deck railing with stainless steel cable horizontal railing. The underneath will be painted to match the siding on the home and the deck will have cedar trim.

Kathleen Cristman moved to accept the application as submitted.

John Mitchell seconded.

All Ayes.

RESIDENTIAL APPLICATION FOR REVIEW - NEW HOME

180 Kilbourn Road

The Applicant is requesting design review for the construction of a new two story home. The home will be approximately 3924 square feet of living space and will be located in the Kilbourn neighborhood. The previous home has been demolished. The applicant did appear before the Zoning Board of Appeals on February 15th and was granted variances for setbacks.

The architect Patrick Morabito was present to discuss this application for a new home.

He indicated that the siding will be board and batten and the stone elements will be cobblestone. He made note that the amount of stone element had been reduced per the Board's suggestion in an informal review. The home will be in the approximate footprint of the prior home. A deck will be above the front door and a full glass door will be on the front. The Board commented that the brackets above

and below the deck are not a necessary element. Mr. Morabito indicated that they were added for architectural interest.

Paul Whitbeck moved to approve the application as submitted.

Dirk Schneider seconded.

All Ayes.

19 Black Wood Circle

The Applicant is requesting design review for the construction of a one story single family home. The home will be approximately 2371 square feet in the Wilshire Hills subdivision.

Jeff Brokaw of Morrell Builders was present to discuss the application with the Board.

He indicated this is a ranch home – the fourth new home on this street.

The Board had no further discussion.

John Mitchell moved to accept the application as submitted.

Kathleen Cristman seconded.

All Ayes.

22 Lexton Way

The Applicant is requesting design review for the construction of a two story single family home. The home will be approximately 1296 square feet on the first floor and 1414 square feet on the second floor. This home will be located in the Wilshire Hills subdivision.

Jeff Brokaw of Morrell Builders was present for this application.

The Board made note that the window above the front porch should be moved up to match the eave line as it appears to be resting on the roof. Mr. Brokaw indicated he would have no problem doing this.

Paul Whitbeck made note of the three textures on the front elevation. Mr. Brokaw indicated this is a sold house and the finishes have been chosen.

Bonnie Salem moved to approve the application as submitted with the recommendation that the second story window above the front porch be raised to accommodate the porch peak.

John Mitchell seconded.

All Ayes.

COMMERCIAL APPLICATION FOR REVIEW - SIGNAGE

3349 Monroe Avenue

The Applicant is requesting design review for the addition of two business identification signs. The front sign will be approximately 73.3 square feet and the sign on the side of the building will be approximately 48.3 square feet. Both signs will identify the "Adelita's Mexican Cocina & Tequila" Restaurant.

Justin Ziemniak of Vital Signs was present.

Mr. Ziemniak described the proposed signs on two elevations of the restaurant property.

All signs will be illuminated per Town Code. The letters are channel lit with a red face.

Letitia Fornataro moved to accept the application for two signs as submitted.

Bonnie Salem seconded.

All Ayes.

OTHER - REVIEW OF 2/25/2021 MINUTES

Dirk Schneider moved to accept the meeting minutes of the February 25, 2021 as submitted.

Kathleen Cristman seconded.

All Ayes.


ADJOURNMENT

Dirk Schneider moved to close the meeting at 7:15 pm.

All Ayes.

Respectfully submitted,

Susan Donnelly Secretary to the Design Review and Historic Preservation Board

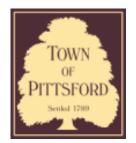

Town of Pittsford

Department of Public Works 11 South Main Street Pittsford, New York 14534

Permit # B21-000046

Phone: 585-248-6250 FAX: 585-248-6262

DESIGN REVIEW AND HISTORIC PRESERVATION BOARD REFERRAL OF APPLICATION

Property Address: 6 Wild Berry Lane PITTSFORD, NY 14534

Tax ID Number: 192.02-2-78

Zoning District: RN Residential Neighborhood

Owner: William Straub

Applicant: Val's Construction

	A	go	ication	Type:
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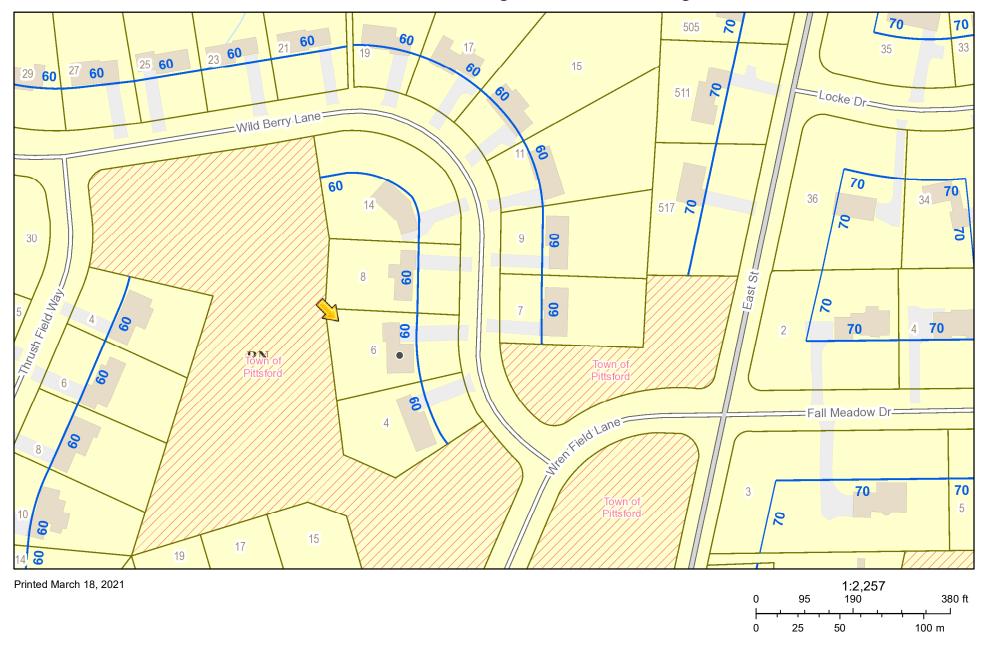
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	Residential Design Review	Build to Line Adjustment
	§185-205 (B)	§185-17 (B) (2)
	Commercial Design Review	Building Height Above 30 Feet
	§185-205 (B)	§185-17 (M)
	Signage	Corner Lot Orientation
	§185-205 (C)	§185-17 (K) (3)
	Certificate of Appropriateness	Flag Lot Building Line Location
	§185-197	§185-17 (L) (1) (c)
	Landmark Designation	Undeveloped Flag Lot Requirements
	§185-195 (2)	§185-17 (L) (2)
	Informal Review	

Project Description: Applicant is requesting design review for the additions to the kitchen and master bedroom. The kitchen will have a 9 square foot addition to expand on the existing square footage. The bedroom will have an addition of 140 square feet for a walk in closet. The materials will match the existing home.

Meeting Date: March 25, 2021



RN Residential Neighborhood Zoning



Town of Pittsford GIS

The information depicted on this map is representational and should be used for general reference purposes only. No warranties, expressed or implied, are provided for the data or its use or its user or its user









NEW YORK STATE ENERGY CODE NOTES:

THIS PROJECT IS DESIGNED TO COMPLY WITH THE "PERSCRIPTIVE" ENERGY CODE COMPLIANCE REQUIREMENTS. CONTRACTOR SHALL PROVIDE AND INSTALL ALL MATERIALS AND COMPONENTS, NECESSARY AND IN A MANNER TO COMPLY WITH THE "PERSCRIPTIVE" REQUIREMENTS OF THE 2015 (IRC) INTERNATIONAL RESIDENTIAL CODE, 2015 INTERNATIONAL ENERGY CODE, 2020 BUILDING CODE OF NY STATE AND 2020 ENERGY CONSERVATION CONSTRUCTION CODE OF NY.

CLIMATE ZONE 5A MINIMUM R - MAXIMUM U VALUES FROM TABLE 402.1.2

FENESTRATION
SKYLIGHTS
CEILING
WOOD FRAMED WALLS
FLOOR

MAX U VALUE = 0.30
MAX U VALUE = 0.55
MIN R VALUE = 49
MIN R VALUE = 21
MIN R VALUE = 30

BASEMENT WALLS

MIN R VALUE = 30

MIN R VALUE = 15 (CONTINUOUS)

A) A MINIMUM OF 75 PERCENT OF THE LAMPS IN PERMANENTLY INSTALLED LIGHTING FIXTURES SHALL BE HIGH-EFFICIANCY LAMPS.

B) RECESSED LUMINARIES INSTALLED IN THE BUILDING THERMAL ENVELOPE SHALL BE SEALED WITH A GASKET OR CAULK BETWEEN THE HOUSING AND THE INTERIOR WALL OR CEILING COVERING TO LIMIT AIR LEAKAGE BETWEEN CONDITIONED AND UNCONDITIONED SPACES.

C) CONTRACTOR SHALL PROVIDE A PROGRAMMABLE THERMOSTAT TO CONTROL

D) ALL DUCTS, AIR HANDLERS, FILTER BOXES AND BUILDING CAVITIES USED AS DUCTS SHALL BE SEALED.

E) ALL CIRCULATING SERVICE HOT WATER PIPING SHALL BE INSULATED TO AT LEAST R-2. CIRCULATING HOT WATER SYSTEMS SHALL INCLUDE AN AUTOMATIC OR READILY ACCESSIBLE MANUAL SWITCH THAT CAN TURN OFF THE HOT WATER CIRCULATING PUMP WHEN THE SYSTEM IS NOT IN USE.

F) ATTIC ACCESS IF REQ. SHALL BE INSULATED WITH THE SAME R VALUE AS THE ATTIC, WEATHER-STRIPPED AND LATCHED.

G) AIR TIGHTNESS AND INSULATION INSTALLATION SHALL BE VERIFIED BY VISUAL INSPECTION.

TABLE N1102.4.2 AIR BARRIER AND INSULATION INSPECTION COMPONENT CRITERIA

COMPONENT	CRITERIA
	EXTERIOR THERMAL ENVELOPE INSULATION FOR FRAMED WALLS IS INSTALLED IN SUBSTANTIAL CONTACT AND CONTINUOUS ALIGNMENT WITH BUILDING ENVELOPE AIR BARRIER
AIR BARRIER AND THERMAL BARRIER	BREAKS OR JOINTS IN THE AIR BARRIER ARE FILLED OR REPAIRED.
	AIR-PERMEABLE INSULATION IS NOT USED AS A SEALING MATERIAL.
	AIR-PERMEABLE INSULATION IS INSIDE OF AN AIR BARRIER
	AIR BARRIER IN ANY DROPPED CEILING/ SOFFIT IS SUBSTANTIALLY ALIGNED WITH INSULATION AND ANY GAPS ARE SEALED
CEILING/ ATTIC	ATTIC ACCESS (EXCEPT UNVENTED ATTIC), KNEE WALL DOOR, ORDROP DOWN STAIR IS SEALED. CORNERS AND HEADERS ARE INSULATED.
WALLS	JUNCTION OF FOUNDATION AND SILL PLATE IS SEALED.
WINDOWS AND DOORS	SPACE BETWEEN WINDOW/ DOOR JAMBS AND FRAMING IS SEALED.
RIM JOISTS	RIM JOISTS ARE INSULATED AND INCLUDE AN AIR BARRIER.
FLOORS (INCLUDING ABOVE-GARAGE AND	INSULATION IS INSTALLED TO MAINTAIN PERMANENT CONTACT WITH UNDERSIDE OF SUBFLOOR DECKING.
CANTILEVERED FLOORS)	AIR BARRIER IS INSTALLED AT ANY EXPOSED EDGE OF INSULATION.
	INSULATION IS PERMANENTLY ATTACHED TO WALLS.
CRAWLSPACE WALLS	EXPOSED EARTH IN UNVENTED CRAWLSPACES IS COVERED WITH CLASS I VAPOR RETARDER WITH OVERLAPPING JOINTS TAPED.
SHAFTS, PENETRATIONS	UTILITY PENETRATIONS, KNEE WALLS AND FLUE SHAFTS OPENING TO EXTERIOR OR UNCONDITIONED SPACE ARE SEALED.
NARROW CAVITIES	BATTS IN NARROW CAVITIES ARE CUT TO FIT, OR NARROW CAVITIES ARE FILLED BY SPRAYED/ BLOWN INSULATION.
GARAGE SEPARATION	AIR SEALING IS PROVIDED BETWEEN THE GARAGE AND CONDITIONED SPACES.
RECESSED LIGHTING	RECESSED LIGHT FIXTURES ARE AIR TIGHT, IC RATED, AND SEALED TO DRYWALL. EXEPTION - FIXTURES IN CONDITIONED SPACE.
	INSULATION IS PLACED BETWEEN OUTSIDE AND PIPES.
PLUMBING & WIRING	BATT INSULATION IS CUT TO FIT AROUND WIRING AND PLUMBING, OR SPRAYED/ BLOWN INSULATION EXTENDS BEHIND PIPING AND WIRING.
SHOWER/ TUB ON EXTERIOR WALLS	SHOWERS AND TUBS ON EXTERIOR WALLS HAVE INSULATION AND AN AIR BARRIER SEPARATING THEM FROM THE EXTERIOR WALL.
ELECTRICAL/ PHONE BOX ON EXTERIOR WALLS	AIR BARRIER EXTENDS BEHIND BOXES OR AIR SEALED-TYPE BOXES ARE INSTALLED.
COMMON WALL	AIR BARRIER IS INSTALLED IN COMMON WALL BETWEEN DWELLING UNITS.
HVAC REGISTER BOOTS	HVAC REGISTER BOOTS THAT PENETRATE BUILDING ENVELOPE ARE SEALED TO SUBFLOOR OR DRYWALL.
FIREPLACE	FIREPLACE WALLS INCLUDE AN AIR BARRIER.

GENERAL NOTES:

1. BUILDING CONTRACTOR AND HIS SUBCONTRACTORS SHALL CONFORM TO LOCAL CONSTRUCTION ORDINANCES AND SHALL VERIFY ALL DIMENSIONS AND CONDITIONS BEFORE PROCEEDING WITH MATERIAL ORDERING OR WORK.

2. WOOD ROOF TRUSSES SHALL BE PROVIDED BY TRUSS MANUFACTURER. MANUFACTURER SHALL PROVIDE SHOP DRAWING BEARING TRUSS SEAL OF A LICENSED ENGINEER. CONTRACTOR SHALL REVIEW SHOP DRAWING AND NOTIFY ARCHITECT OF ANY DISCREPENCIES PRIOR TO ORDERING MATERIAL

3. NOTED DIMENSIONS TAKE PRECEDENCE OVER SCALED DIMENSIONS.

4. THESE DRAWINGS HAVE BEEN PREPARED FOR DESIGN AND STRUCTURAL REFERENCE ONLY. ELECTRICAL, MECHANICAL, PLUMBING AND OTHER BUILDING SYSTEMS ARE THE RESPONSIBILITY OF OTHERS.

5. BEARING CAPACITY OF SOIL IS ASSUMED AT 2000 P.S.F. AND CONTRACTOR SHALL VERIFY PRIOR TO PLACEMENT OF FOOTINGS.

6. ALLOWABLE STRESS OF MATERIALS:

USE OF 1150 P.S.I. (HEM FIR #2 OR BETTER.)

ALL DIMENSIONS TO FACE OF STUD.

A.) CONCRETE- MIN. COMPRESSIVE STRENGTH @ 28 DAYS = 3500 PSI

B.) STRUCTURAL STEEL TO BE ASTM - A36
C.) WOOD JOISTS, BEAMS, HEADERS AND RAFTERS SHALL HAVE AN EXTREME FIBER STRESS IN BENDING (FB) FOR REPETITIVE MEMBER

7. WHERE FIREPLACES ARE SPECIFIED, THEY SHALL HAVE AN OUTSIDE AIR SOURCE FOR COMBUSTION (NA)

COMBUSTION (NA)
WITH A DUCT, DAMPER ECT. & SHALL COMPLY WITH CODE
SECTION R1005. (NA)

8. GLAZING IN DOORS, STORM DOORS, SIDE LIGHTS, SHOWER SPACES AND TUB ENCLOSURES IS DEEMED TO BE HAZARDOUS PER SECTION R308.4 OF THE RESIDENTIAL BUILDING CODE AND SHALL BE IDENTIFIED AS SUCH AND IN COMPLIANCE WITH SECTION R308.1. DECORATIVE GLASS IS EXEMPT IN SWINGING DOORS AND SIDELIGHTS (SEE SECTION R308.4 FOR ADDITIONAL HAZARDOUS LOCATIONS.)

9. DESIGN CRITERIA:

OF THE ALTERATION"

A.) ROOMS OTHER THAN SLEEPING = 40 PSF LIVE LOAD
B.) SLEEPING ROOMS = 30 PSF LIVE LOAD

C.) GROUND SNOW LOAD = 40 PSF
D.) WIND SPEED = 90 MPH, EXPOSURE B
E.) SEISMIC DESIGN CATEGORY - B
F.) WEATHERING - SEVERE

G.) ROOF TIE-DOWN REQUIREMENTS - R802.11 (BASED UPON SPECIFIC ROOF DESIGN) H.) ENERGY COMPLIANCE DETAILS AND PATH - N1101.2.3

I.) FLOOD HAZARD - FIRM - 1992 J.) ROOF TOP CHORD 35 PSF L.L. MIN. BOTTOM CHORD 10 PSF D.L. (U.N.O.)

10. FOOTINGS TO BEAR ON FIRM, LEVEL, UNDISTURBED

NATURAL SOIL FREE FROM FROST, ORGANIC OR LOOSE MATERIAL. OR EXCESSIVE WATER

11. DRAWING ALTERATION:
THE FOLLOWING IS AN EXCERPT FROM THE N.Y.S. EDUCTION
LAW ARTICLE 145. SECTION 7209 AND APPLIES TO THESE
DRAWINGS. "IT IS A VIOLATION OF THIS LAW FOR ANY
PERSON, UNLESS HE IS ACTING UNDER THE DIRECT
SUPERVISION OF A LICENSED PROFESSIONAL ENGINEER
OR ARCHITECT TO ALTER AN ITEM IN ANY WAY. IF AN
ITEM BEARING THE SEAL OF AN ENGINEER OR ARCHITECT
IS ALTERED, THE ALTERING ENGINEER OR ARCHITECT
SHALL AFFIX TO THE ITEM HIS SEAL AND THE NOTATION
"ALTERED BY" FOLLOWED BY HIS SIGNATURE AND THE

DATE OF SUCH ALTERATION AND A SPECIFIC DESCRIPTION

12. TO THE BEST OF MY KNOWLEDGE, BELIEF AND PROFESSIONAL JUDGEMENT, THESE PLANS ARE IN COMPLIANCE WITH THE N.Y.S. ENERGY CONSERVATION CONSTRUCTION CODE AND IECC.

13. PROVIDE CAULKING, WEATHERSTRIPPING AS REQ. (COLOR MATCH SURROUNDING SURFACES)

14. WOOD IN CONTACT W/ MASONRY OR CONC. SHALL BE PRESSURE TREATED SOUTHERN PINE OR EQUAL.

15. ALL CONNECTORS AND FASTENERS IN CONTACT WITH PRESSURE TREATED LUMBER SHALL BE STAINLESS STEEL OR DBL. DIPPED GALV. CERTIFIED FOR SUCH APPLICATIONS

16. WHERE EXISTING WINDOWS OR DOORS ARE REMOVED, INFILL CONSTRUCTION SHALL BE FULLY INSULATED WITH INSULATION HAVING A MIN. R VALUE OF THAT OF THE ADJOINING WALL.

17. CONTRACTOR SHALL VERIFY ALL DIMENSIONS PRIOR TO ORDERING TRUSSES

18. WHERE FOAM INSUL. IS USED, A LETTER FROM THE FOAM INSULATION INSTALLER WILL BE REQUIRED TO CERTIFY THE INSTALLED DEPTH OF INSULATION AND EQUIVALENT R-VALUE. THE LETTER MUST BE ON INSTALLERS LETTERHEAD.

19. PROVIDE HEADERS OVER ALL FRAMED OPENINGS PER SCHEDULE INCLUDING WINDOW & DOOR OPENINGS. MIN. HEADER SIZE AND NUMBER OF JACK STUDS SHALL MEET THE REQUIREMENTS OF THE 2015 INTERNATIONAL RESIDENTIAL

PROVIDE CONT. 1/2" PLYWOOD SPACER (S) AT ALL HEADERS
AS REQUIRED TO MATCH WALL WIDTH

20. FLASHING IS REQUIRED IN THE FOLLOWING LOCATIONS: AT WALL & ROOF INTERSECTIONS AND PROJECTING WOOD TRIM, TOP OF ALL EXTERIOR WINDOWS & DOOR OPENINGS; UNDER AND AT ENDS OF MASONRY, WOOD OR METAL COPINGS & SILLS; AND WHERE EXTERIOR PORCHES, DECKS, OR STAIRS ATTACHED TO A WALL OR FLOOR ASSEMBLY OF WOOD - FRAME CONSTRUCTION. FLASHINGS SHALL BE PROVIDED AS REQUIRED TO COMPLY WITH ALL OF

SECTION R703.4 OF THE 2015 INTERNATIONAL RESIDENTIAL CODE.

21. ROOFING SHALL BE INSTALLED IN ACCORDANCE WITH THE MANUFACTURERS INSTRUCTIONS AND CHAPTER 9 OF THE 2015 INTERNATIONAL RESIDENTIAL CODE.

22. PROVIDE ICE & WATER SHIELD AT ALL EAVES FROM DRIP EDGE TO 5'-0", AND 3'-0" EACH SIDE OF ALL VALLEYS.

23. PROVIDE 6 MIL POLYETHELINE VAPOR BARRIER UNDER SLAB BEHIND GYP. BD. ON WALLS & CEILINGS.

24. PROVIDE HOUSE WRAP OVER ALL SHEATHING AND STRICTLY COMPLY WITH MANUFACTURERS INSTRUCTIONS FOR POSITIVE DRAINAGE, TAPEING, AND ATTACHMENT, ESPECIALLY AT DOORS & WINDOWS.

 $25.\ PROVIDE\ AND/\ OR\ MAINTAIN\ CONTINUOUS\ PERIMETER\ DRAINAGE\ SYSTEM FROM DOWNSPOUTS$

26. CONTRACTOR SHALL REVIEW DRAWINGS AND PROVIDE ALL NECESSARY BLOCKING & SUPPORT UNDER ALL HEADERS & BEAMS TO MAINTAIN A CONTINUOUS LOAD PATH TO FOUNDATION.

27. PROVIDE BLOCKING FOR GRAB BARS AS REQUIRED


DRAWING INDEX:

T-1 TITLE SHEET & NOTES


A-1 FLOOR PLANS A-2 EXTERIOR ELEVATIONS & ROOF FRAMING PLAN

A-3 BUILDING SECTIONS


EXISTING WALLS TO REMAIN NEW WALL EXISTING WALLS TO BE REMOVED EXISTING WALLS TO BE REMOVED EXISTING DOOR NEW DOOR SOLID WOOD SUPPORT UNDER HEADER OR BEAM E EGRESS WINDOW REQUIRED S MOKE DETECTOR (HARDWIRED) PER CODE CO CARBON MONOXIDE DETECTOR CEILING LIGHT W/ FAN CEILING LIGHT HOSE BIB

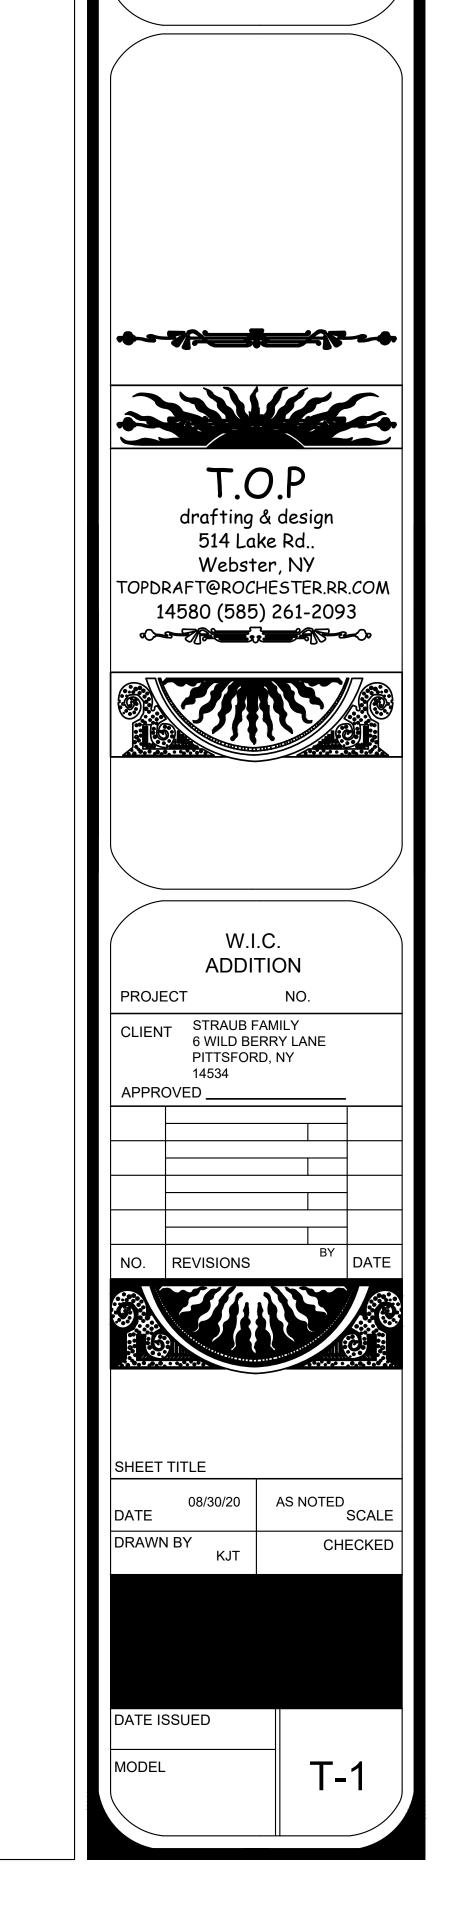


THE STRAUB ADDITION 6 WILD BERRY LANE PITTSFORD, NY 14534

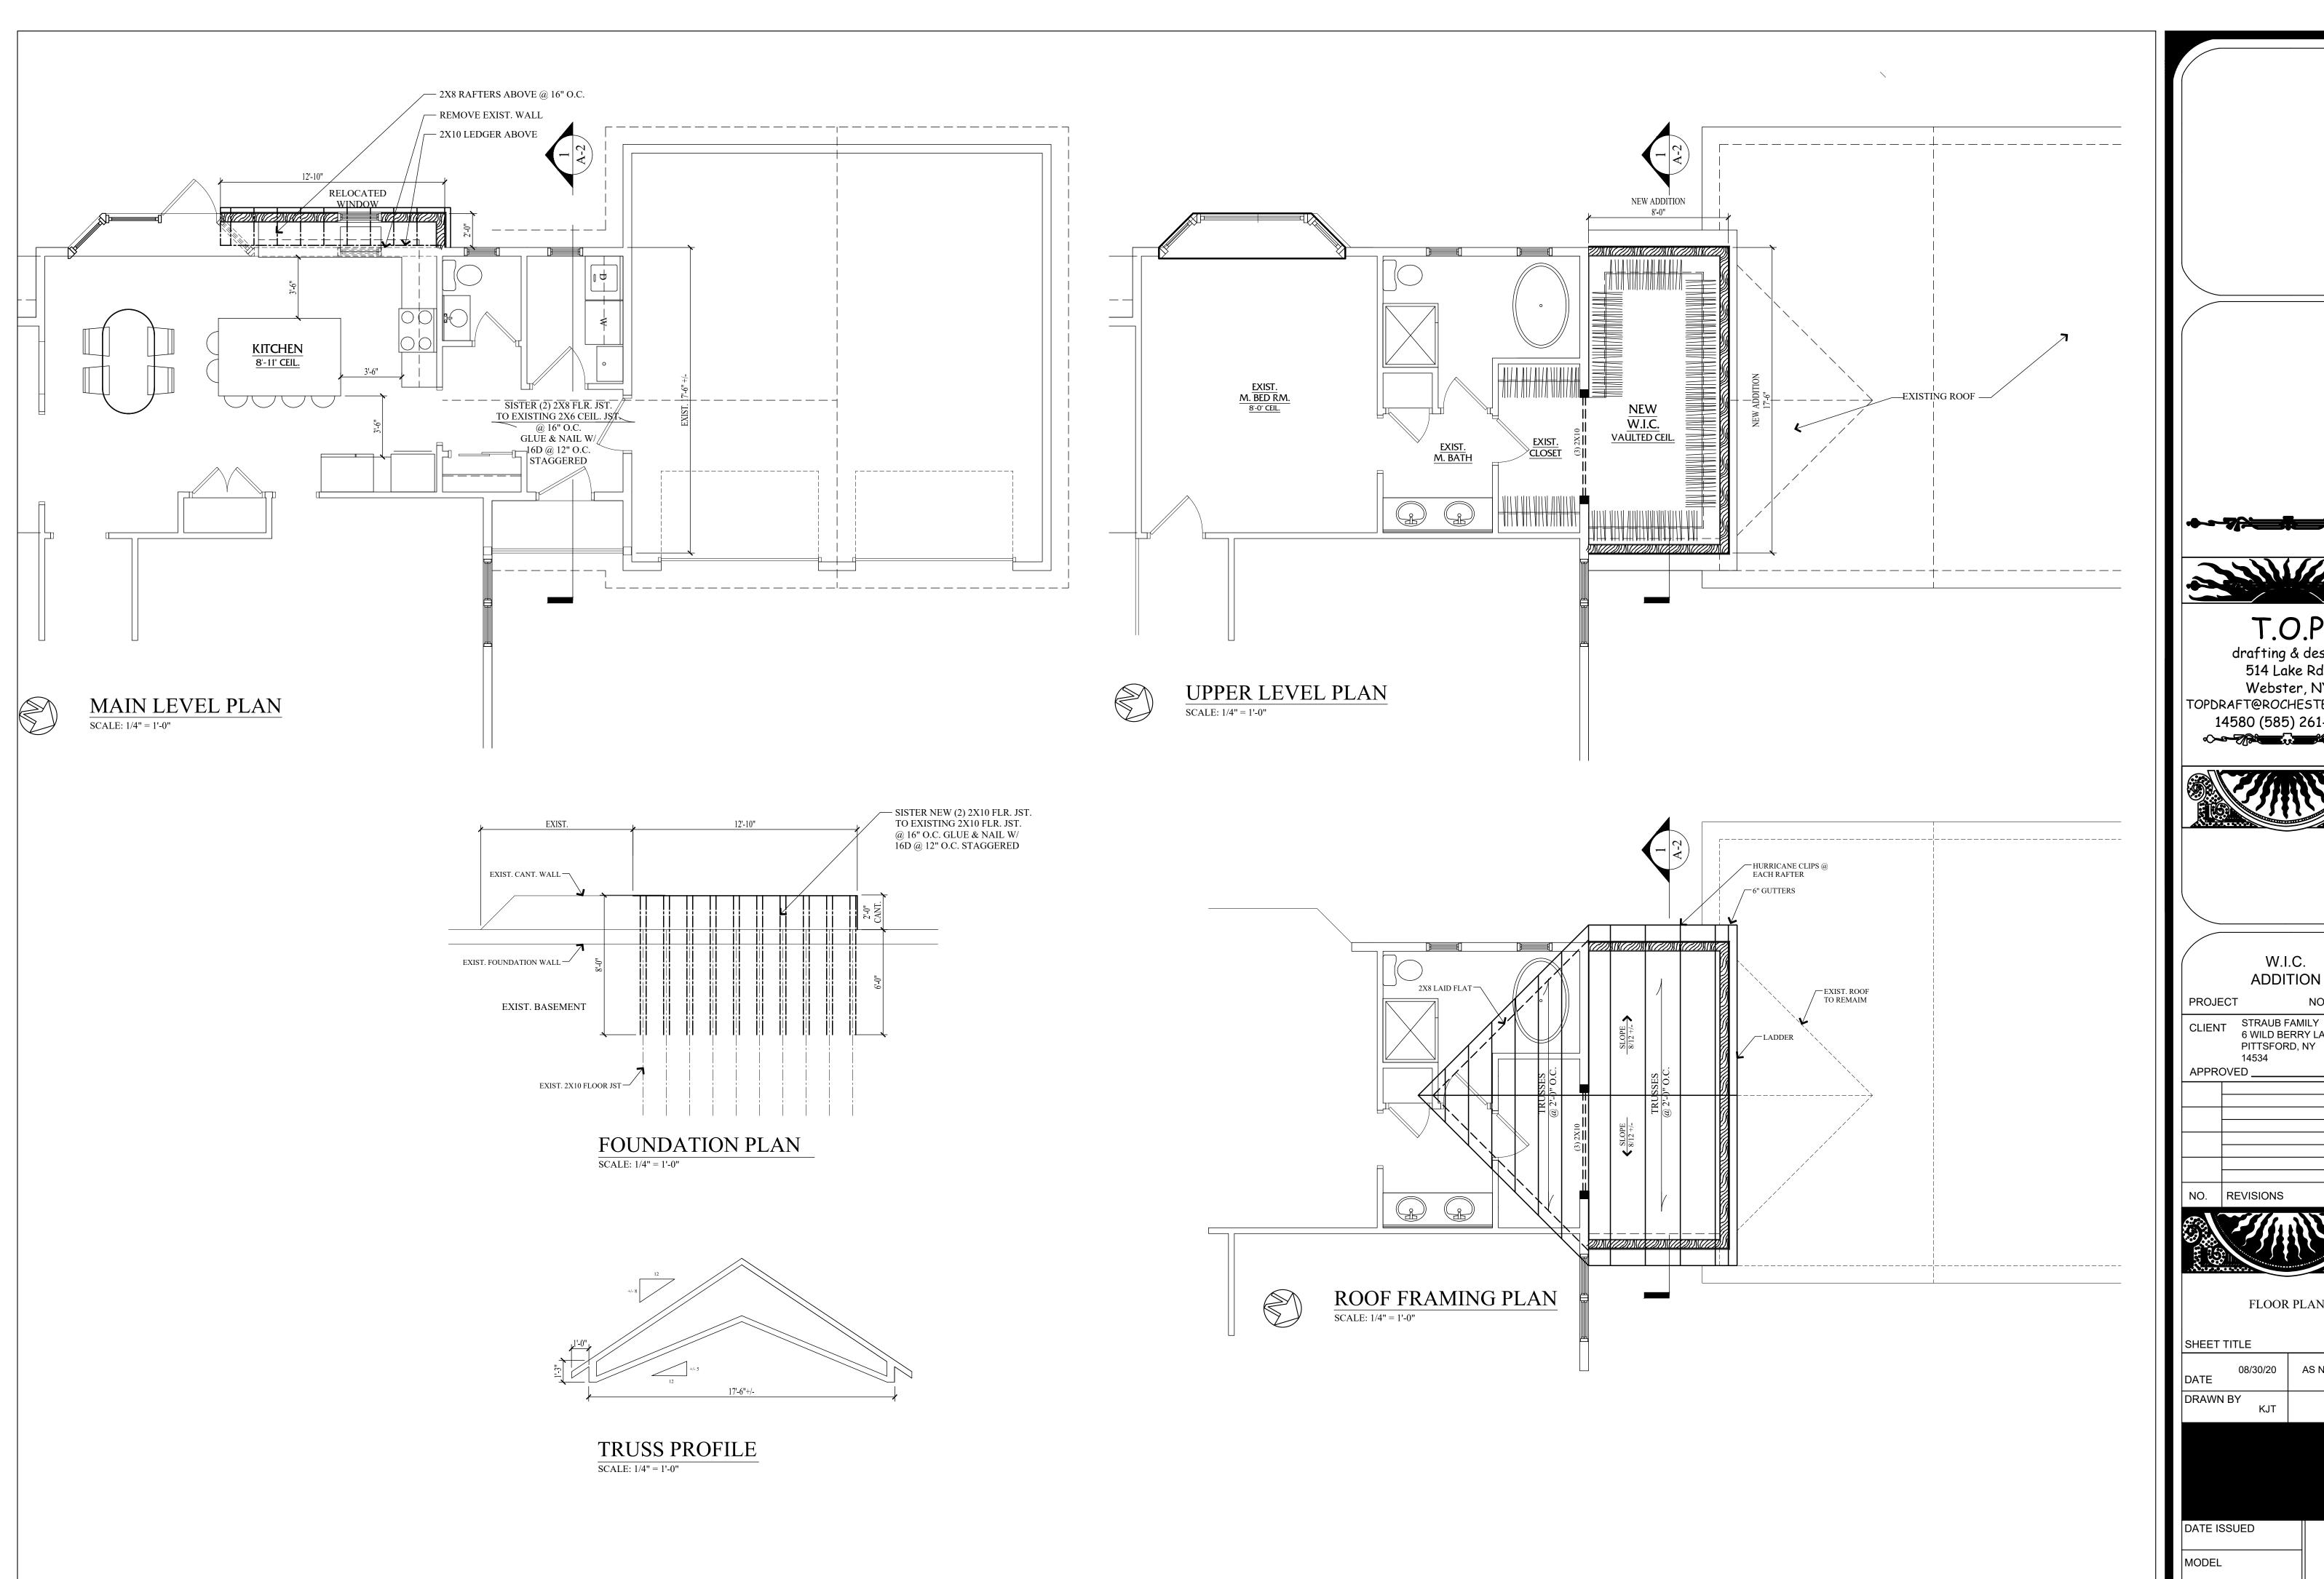




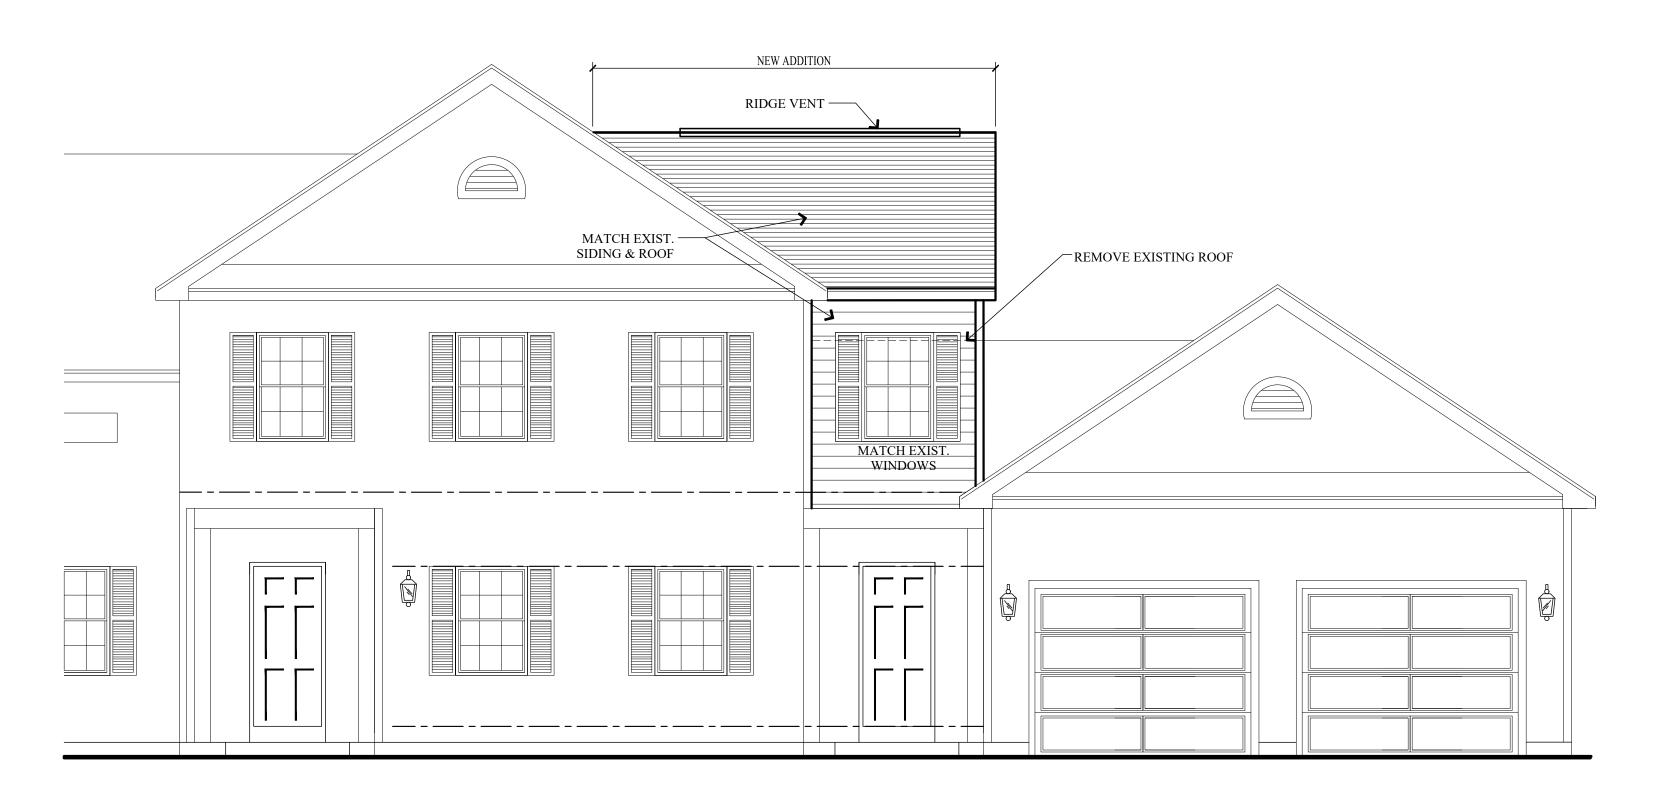

EAST ELEVATION SCALE: 1/4" = 1'-0"

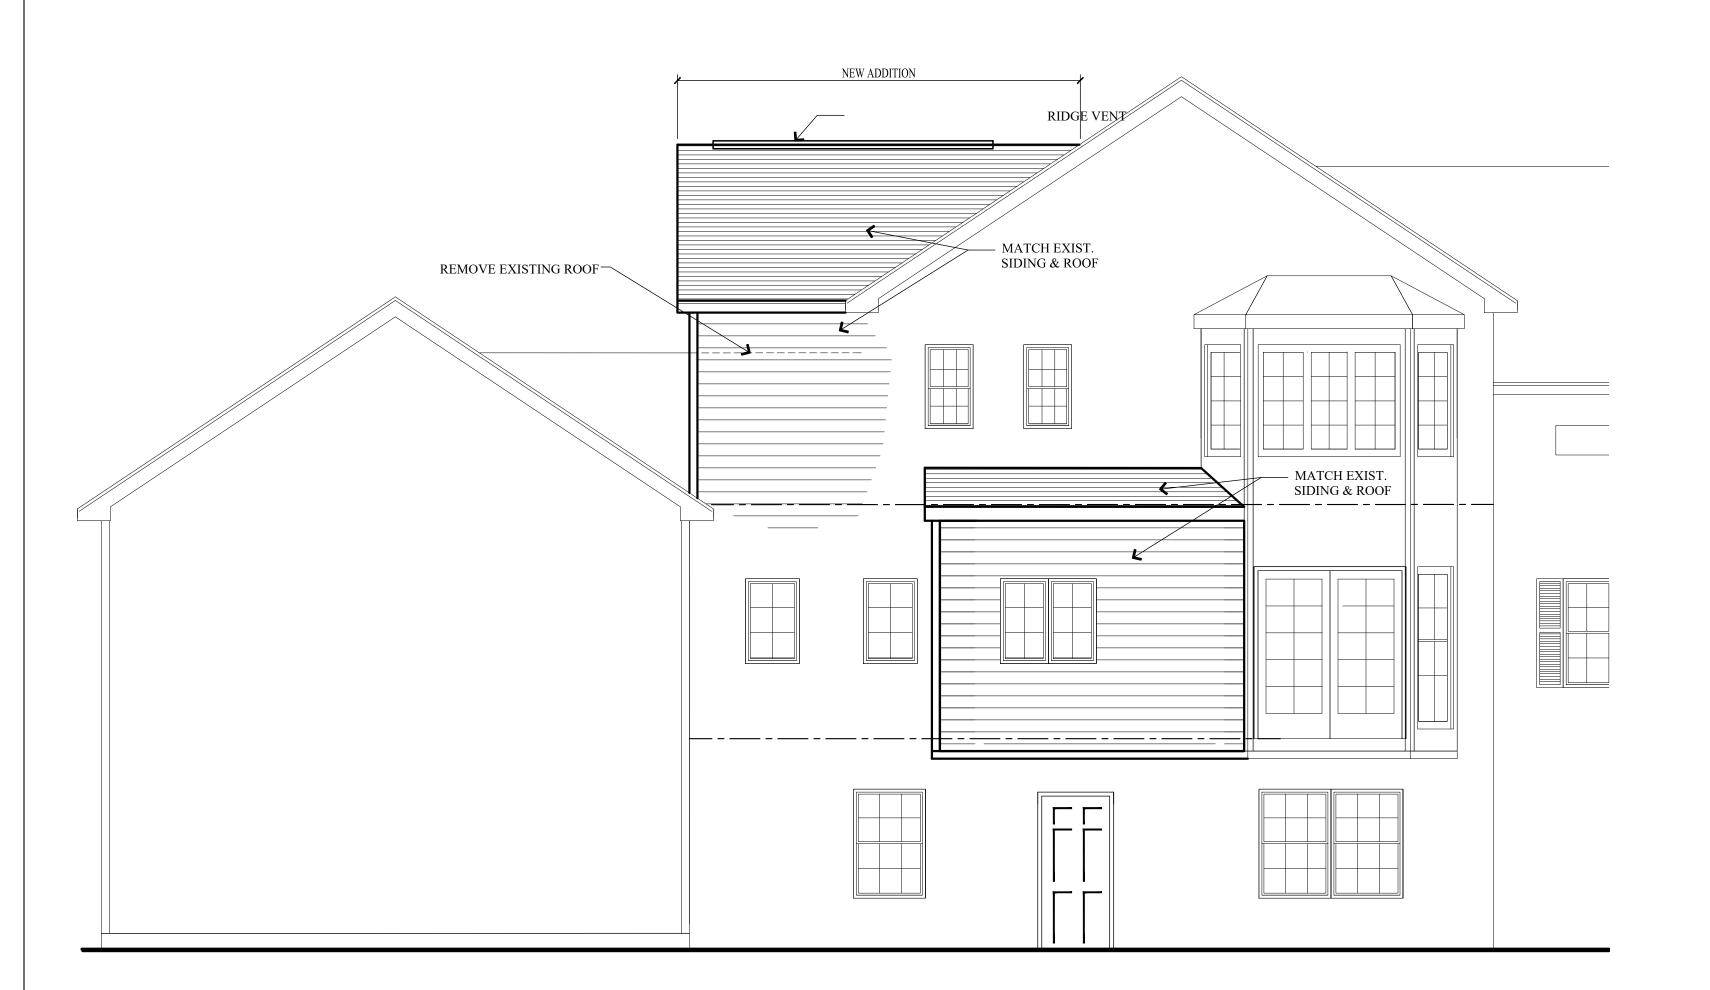

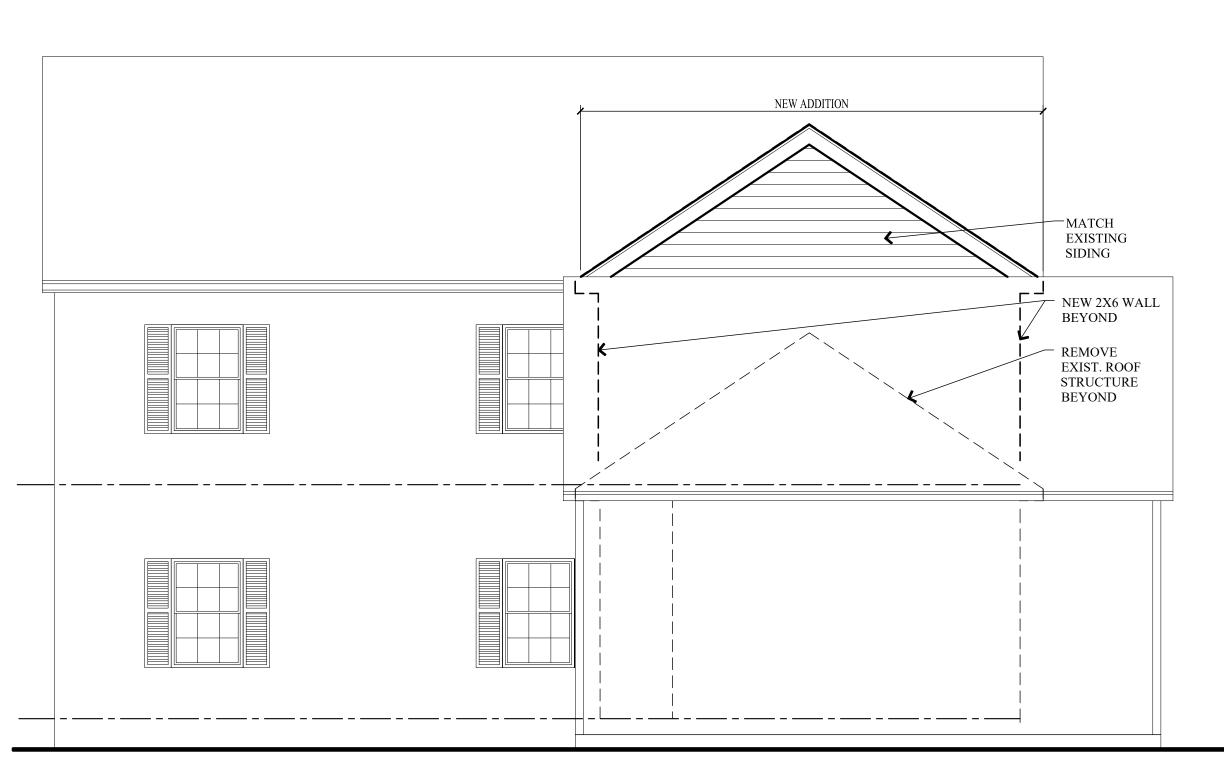



NORTH ELEVATION
SCALE: 1/4" = 1'-0"

WEST ELEVATION

SCALE: 1/4" = 1'-0"

T.O.P drafting & design 514 Lake Rd.. Webster, NY TOPDRAFT@ROCHESTER.RR.COM 14580 (585) 261-2093 W.I.C. ADDITION PROJECT CLIENT STRAUB FAMILY 6 WILD BERRY LANE PITTSFORD, NY APPROVED ___ NO. REVISIONS **ELEVATIONS** SHEET TITLE AS NOTED SCALE DRAWN BY CHECKED DATE ISSUED A-2

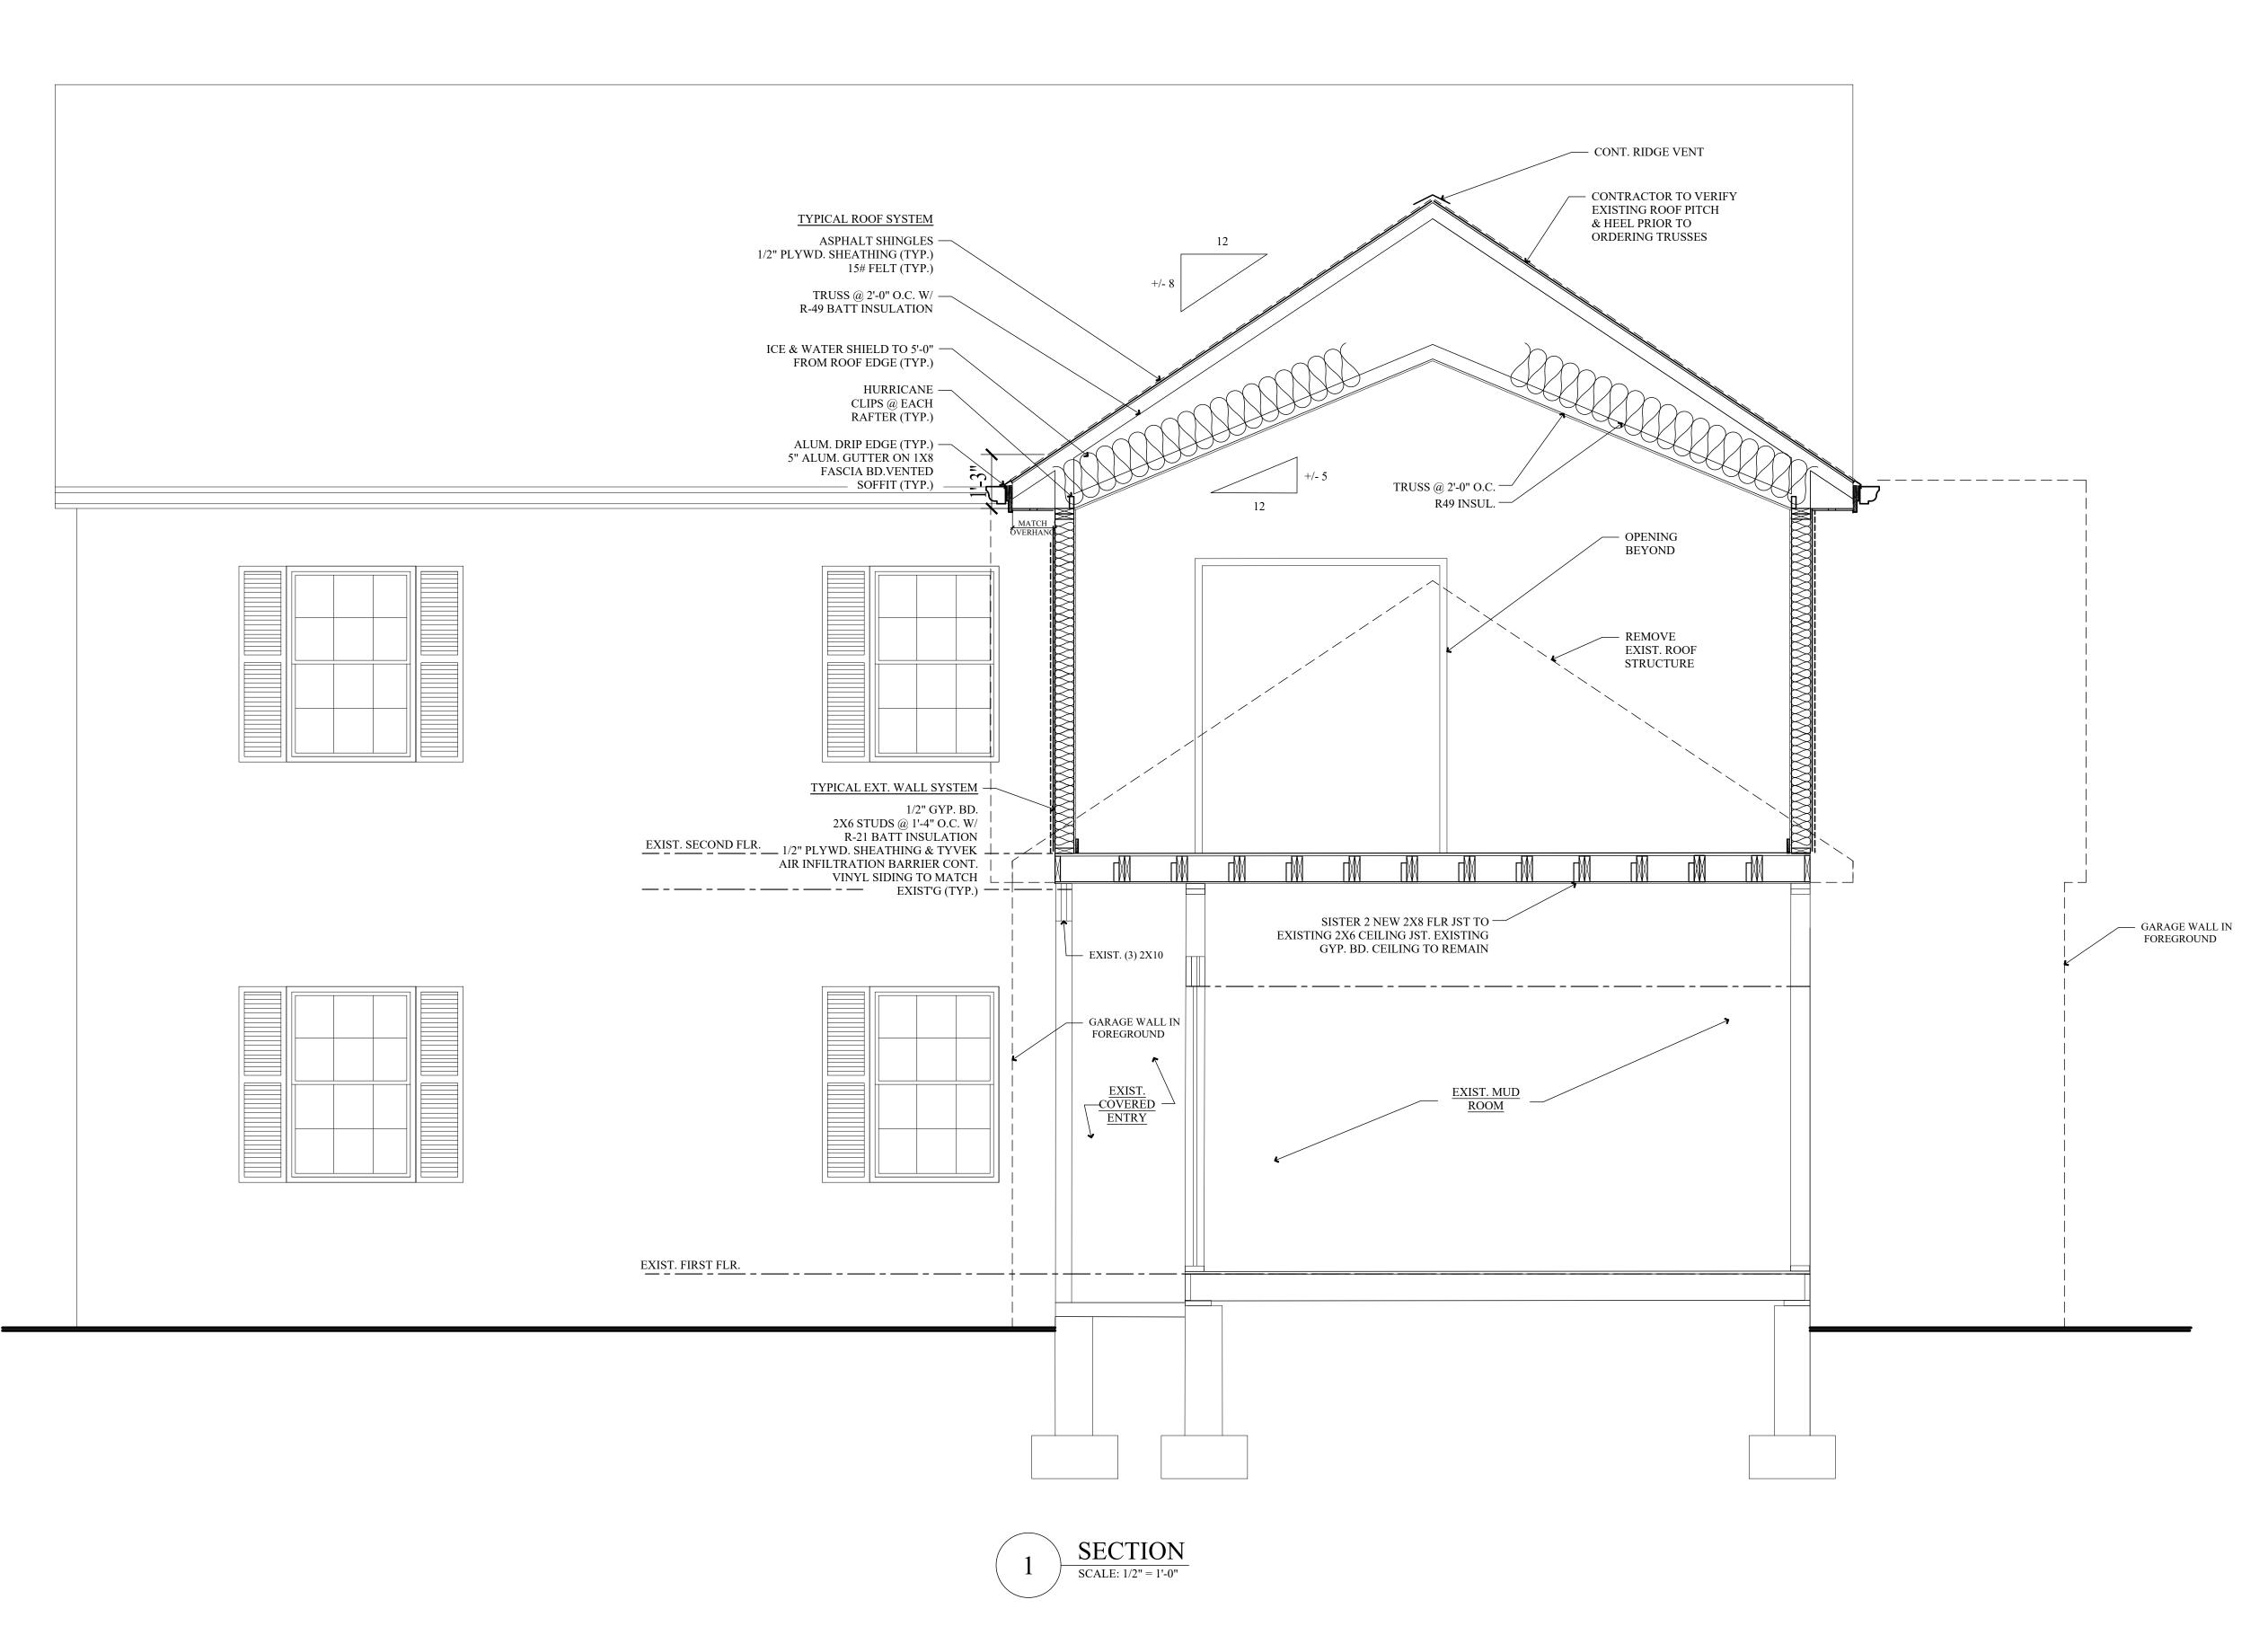


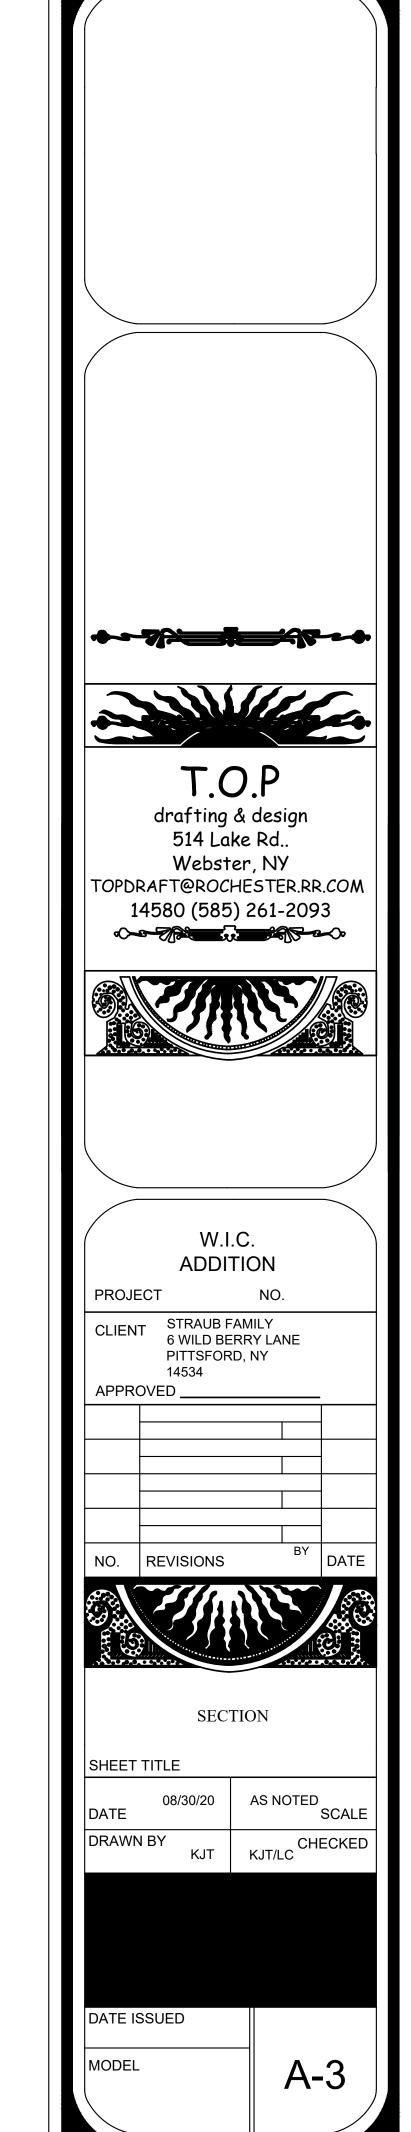







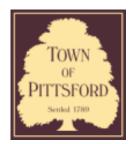

Town of Pittsford

Department of Public Works 11 South Main Street Pittsford, New York 14534

Permit # B21-000053

Phone: 585-248-6250 FAX: 585-248-6262

DESIGN REVIEW AND HISTORIC PRESERVATION BOARD REFERRAL OF APPLICATION

Property Address: 292 Shoreham Drive ROCHESTER, NY 14618

Tax ID Number: 150.08-1-58

Zoning District: RN Residential Neighborhood

Owner: Spilman, Joseph RK

Applicant: Gauger & Swingly Construction Inc.

Application Type:

-1-1-		
✓	Residential Design Review §185-205 (B)	Build to Line Adjustment §185-17 (B) (2)
	Commercial Design Review §185-205 (B)	Building Height Above 30 Feet §185-17 (M)
	Signage §185-205 (C)	Corner Lot Orientation §185-17 (K) (3)
	Certificate of Appropriateness §185-197	Flag Lot Building Line Location §185-17 (L) (1) (c)
	Landmark Designation §185-195 (2)	Undeveloped Flag Lot Requirements §185-17 (L) (2)
	Informal Review	


Project Description: Applicant is requesting design review for the remodel of an existing enclosed porch and the addition of a covered entry. The enclosed porch is approximately 64 square feet and the covered entry will be approximately 26 square feet.

Meeting Date: March 25, 2021




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RN Residential Neighborhood Zoning

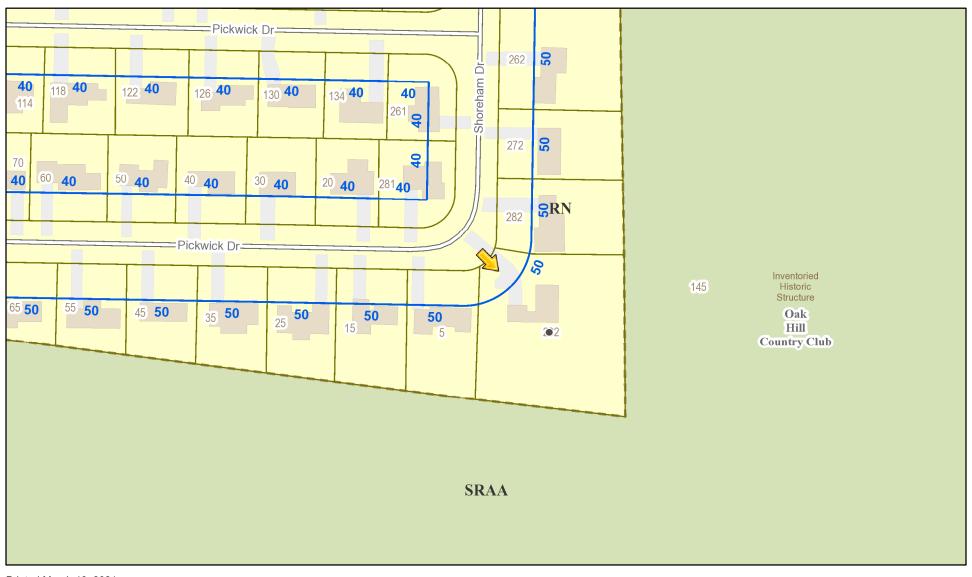


Printed March 18, 2021

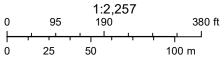

Town of Pittsford GIS

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GENERAL NOTES:

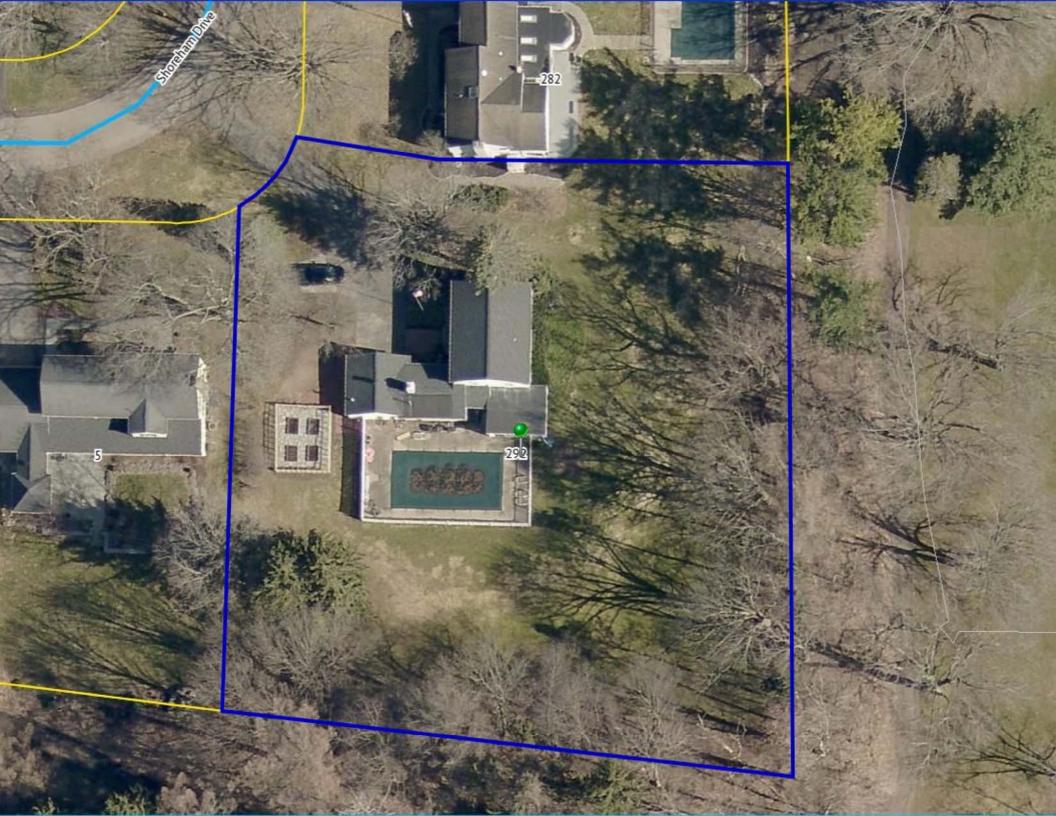- THESE PLANS HAVE BEEN PREPARED TO THE BEST OF THE ARCHITECT'S KNOWLEDGE. BELIEF, AND PROFESSIONAL JUDGMENT IN ACCORDANCE WITH THE 2020 RESIDENTIAL CODE OF NEW YORK STATE AND ENERGY CONSERVATION CODE REQUIREMENTS. THE CONTRACTOR SHALL BE RESPONSIBLE FOR ADAPTING THESE PLANS, IF REQUIRED, TO SUIT THE NEEDS OF THE BUILDING ON THE SITE. PROVIDED THAT THE ALTERATIONS DO NOT VIOLATE THE CODE OR ALTER THE STRUCTURAL INTEGRITY OF THE BUILDING.
- THE CONTRACTOR SHALL BE RESPONSIBLE FOR COMPLIANCE WITH ALL APPLICABLE BUILDING/ELECTRICAL/MECHANICAL/SANITARY AND ENERGY CODES; STATE OR LOCAL THE CONTRACTOR SHALL BE RESPONSIBLE FOR COMPLIANCE WITH THE ENERGY CONSERVATION CODE FOR ALL HVAC EQUIPMENT, HVAC CONTROLS, WATER HEATING EQUIPMENT, PIPE AND DUCT INSULATION, AND FLUORESCENT LAMPS AND BALLASTS.
- THE CONTRACTOR SHALL BE RESPONSIBLE SO THAT BRANDS OF WINDOWS AND DOORS NSTALLED MEET THE NEW YORK STATE ENERGY CONSERVATION CODE REQUIREMENTS. WINDOWS AND / OR DOORS SHOWN ARE INDICATED FOR SIZING ONLY.
- ALL FOOTINGS SHALL REST ON UNDISTURBED VIRGIN SOIL. THE FOOTING/FOUNDATION DESIGN ASSUMES MINIMUM SOIL BEARING PRESSURE TO BE 2000 PSF. CONTRACTOR SHALL BE RESPONSIBLE FOR ALL SUBGRADE CONDITIONS. IF REQUIRED, THE OWNER AND / OR CONTRACTOR SHALL BE RESPONSIBLE FOR HIRING A SOILS ENGINEER TO VERIFY SUBGRADE CONDITIONS AND SUBSTANTIATE ACTUAL BEARING CAPACITY.
- BACKFILL MATERIALS SHALL BE NATIVE SOIL. FOR FILL UNDER THE GARAGE FLOOR OR BASEMENT FLOOR,

PROVIDE SAND/ GRAVEL FILL FOR COMPACTION AS NEEDED


- MINIMUM CONCRETE COMPRESSIVE STRENGTH: 2500 PSI FOOTINGS 2500 PSI FLOOR SLABS
- CONCRETE BLOCK SHALL CONFORM TO ASTM C90 N-1, WALL REINFORCING ASTM A82. ALL MORTAR SHALL CONFORM TO ASTM C270, TYPE S - I PART PORTLAND CEMENT, I/4 PART
- STRUCTURAL STEEL SHALL CONFORM TO ASTM A36. SHOP-PRIME PAINT TT-P-20, TT-P-3IC, TT-P-8G. FABRICATION AND INSTALLATION PER THE LATEST EDITION OF THE AISC
- MINIMUM FIBER STRESS IN BENDING (FB) FOR ALL FRAMING LUMBER TO BE 1150 PSI #2 HEM-FIR OR BETTER. PROVIDE DOUBLE FRAMING MEMBERS UNDER PARTITIONS RUNNING IN
- CONTRACTOR SHALL PAY STRICT ADHERENCE TO MICROLAM MANUFACTURER'S WRITTEN DIRECTIONS FOR CUTTING, DRILLING, NOTCHING, JOINING AND GENERAL INSTALLATION OF
- MOOD TRUSSES SHALL BE DESIGNED BY MANUFACTURER. SUPPLIER SHALL BE RESPONSIBLE FOR INSTALLATION DETAILS

EXTERIOR DECKS

- AND REQUIRED BRIDGING/BRACING. PLYWOOD SHALL CONFORM TO U.S. PRODUCT STANDARD PS - I, THICKNESS AS SHOWN,
- ALL WOOD IN CONTACT WITH CONCRETE OR MASONRY SHALL BE FULLY WOOD PRESERVATIVE-TREATED WITH OSMOSALTS OR WOLMAN SALTS.

APA RATED SHEATHING EXP-I. NAILING AND SPACING PER APA RECOMMENDATIONS FOR

- ALL OPENINGS IN THE BUILDING ENVELOPE (DOORS, WINDOWS, UTILITIES) SHALL BE CAULKED, WEATHER-STRIPPED, OR OTHERWISE SEALED. CORROSION RESISTIVE FLASHING SHALL BE PROVIDED AT THE LOCATIONS ON THE EXTERIOR WALL ENVELOPE PER RESIDENTIAL CODE OF NEW YORK (2020)
- CONTRACTOR SHALL VERIFY ALL NOTES AND DIMENSIONS PRIOR TO CONSTRUCTION.
- CONTRACTOR SHALL BE RESPONSIBLE FOR ALL CONSTRUCTION MEANS, METHODS, TECHNIQUES, SEQUENCES AND SAFETY PRECAUTIONS IN CONNECTION WITH THE WORK
- THESE DRAWINGS HAVE BEEN PREPARED FOR STRUCTURAL INTENT ONLY. ELECTRICAL, MECHANICAL AND OTHER BUILDING SYSTEMS, AS REQUIRED ARE TO BE DESIGNED BY OTHERS.
- THE FOLLOWING DESIGN LOADS HAVE BEEN USED IN THE STRUCTURES DESIGN IN ACCORDANCE WITH THE PRINTED SPAN TABLES IN THE RESIDENTIAL CODE OF NEW YORK STATE (2020). FLOOR LOADS (LIVING AREAS-IST FLOOR) 30 PSF SLEEPING AREAS (2ND FLOOR)
- ALL WORK, MATERIALS, METHODS, EQUIPMENT, ETC. SHALL BE IN STRICT ACCORDANCE WITH THE CONTRACT DOCUMENTS. ALL MATERIALS SHALL BE NEW, UNLESS NOTED OTHERWISE.
- WORK SEQUENCE AND SCHEDULE SHALL BE MUTUALLY AGREED UPON BY BOTH THE OWNER AND THE
- IT IS ASSUMED THAT THE SUBSURFACE CONDITIONS WILL BE EARTH OR SOIL. IF BEDROCK IS ENCOUNTERED, REMOVAL WILL BE CONSIDERED AN ADDITION TO CONTRACT.
- ANY DEMOLITION WORK SHALL BE DONE CAREFULLY. ALL DISTURBED SURFACES TO BE REPAIRED APPROPRIATELY. ALL SALVAGEABLE ITEMS SHALL BE TURNED OVER TO THE OWNER.
- EXAMINATION OF THE SITE SHOULD BE MADE BY ALL CONTRACTORS CONCERNED TO FULLY CONSIDER ALL SITE CONDITIONS WHICH MAY HAVE A BEARING ON THE WORK OF THE ENTIRE PROJECT. SUBMISSION OF A BID IS PRESUMPTIVE EVIDENCE THAT THE BIDDER IS CONVERSANT WITH LOCAL JURISDICTIONS AND HAS MADE DUE ALLOWANCES IN HIS BID FOR ALL CONTINGENCIES. THE OWNER RESERVES THE RIGHT TO
- IT IS THE RESPONSIBILITY OF THE CONTRACTOR TO NOTIFY THE ARCHITECT IN CASE OF ANY OR ALL DEVIATIONS FROM THESE DRAWINGS. THE ARCHITECT SHALL BE HELD HARMLESS AS A RESULT OF ANY UNAUTHORIZED CHANGES TO THESE PLANS. ADDITIONAL FEES MAY OCCUR FOR "AS BUILT" DOCUMENTATION DUE TO CIRCUMSTANCES BEYOND THE ARCHITECT'S CONTROL, OR OWNER / CONTRACTOR CHANGES
- THE CONTRACTOR SHALL OBTAIN AND PAY FOR ALL PERMITS AND APPROVALS REQUIRED BY THE LOCAL ZONING AND BUILDING DEPARTMENTS AND ANY OTHER GOVERNMENTAL AGENCY HAVING JURISDICTION OVER THE WORK. ALL APPLICABLE REGULATIONS SHALL BE ADHERED TO AND CARRIED OUT BY ALL INDIVIDUALS
- THE CONTRACTOR SHALL FURNISH A CERTIFICATE OF INSURANCE INDICATING THE TYPE AND AMOUNTS OF COVERAGE AS REQUIRED BY NEW YORK STATE AND THE LOCAL MUNICIPALITY.
- THE CONTRACTOR SHALL REMOVE ALL RUBBISH AND LEAVE THE COMPLETED PROJECT IN A CLEAN STATE,
- THE CONTRACTOR SHALL GUARANTEE HIS WORK AND HIS SUBCONTRACTOR'S WORK AGAINST FAULTY MATERIALS AND WORKMANSHIP IN ACCORDANCE WITH NEW YORK STATE GENERAL BUSINESS LAW.
- ONLY COPIES FROM THE ORIGINALS OF THESE DRAWINGS MARKED WITH AN ORIGINAL OF THE ARCHITECT'S WET SEAL SHALL BE CONSIDERED TO BE VALID TRUE COPIES.
- BUILDING IS CLASSIFIED AS A ONE FAMILY DWELLING
- SMOKE-DETECTING ALARM DEVICES SHALL BE INSTALLED IN COMPLIANCE WITH SECTION R313.1 OF THE RESIDENTIAL CODE OF NEW YORK STATE (2020) CARBON MONOXIDE ALARM DEVICES SHALL BE INSTALLED IN COMPLIANCE WITH SECTION R313.4 OF THE BUILDING CODE OF NEW YORK STATE (2020)
- PROVIDE A MIN. 3/4 HR. FIRE SEPARATION PER SECTION R309.2 OF THE RESIDENTIAL CODE OF NEW YORK STATE (2020) ALL WALLS AND FLOORS DEMISING RESIDENCE FROM AN ATTACHED GARAGE
- ALL MATERIALS USED IN THIS PROJECT SHALL BE NON-ASBESTOS AND NON-LEAD CONTAINING.

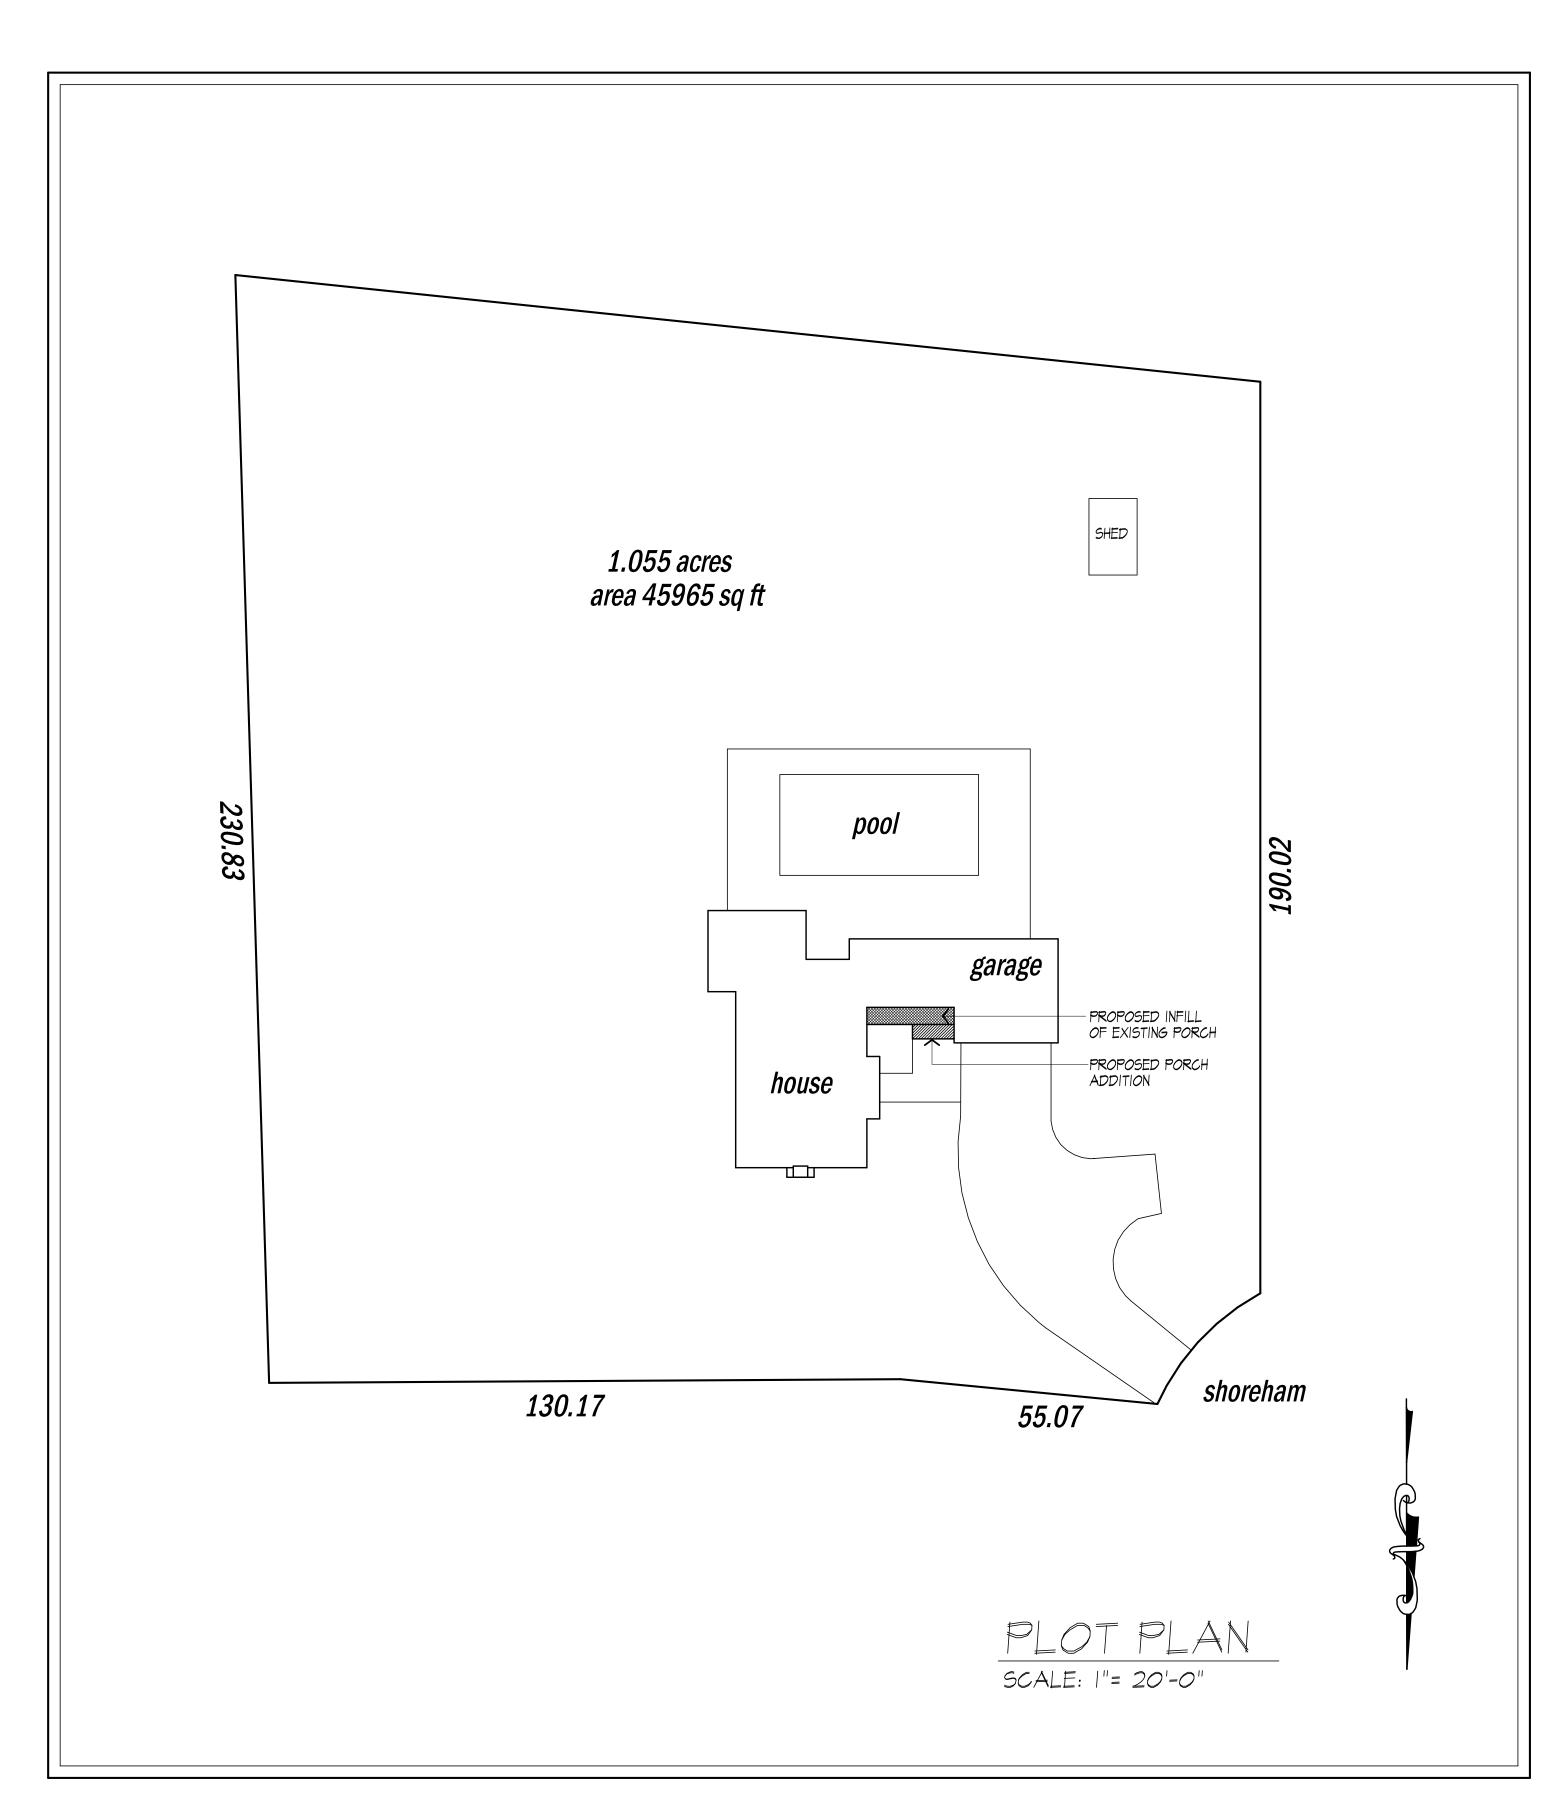

JOE and JESSICA SPILMAN RENOVATION/ADDITION 292 SHOREHAM DR., ROCHESTER, NY

DRAWING INDEX

TITLE PAGE

1ST FLOOR PLAN - proposed and existing

LEFT SIDE ELEVATION - proposed

BUILDING SECTIONS - proposed

WALL SECTION and ROOF PLAN - proposed

ENERGY COMPLIANCE DETAILS & PATH

MEETS OR EXCEEDS PRESCRIPTIVE REQUIREMENTS R402.1.2 (2020 RESIDENTIAL CODE OF NEW YORK STATE) CLIMATE ZONE - 5

	COMPONENT	REQUIRED	PROVIDED
1.	FENESTRATION U-FACTOR	.30	.30
2.	CEILING R-FACTOR	49	49
3.	WOOD FRAME WALL R-VALUE	20 OR 13+5	HIGH DENSITY 21 21/BAND JSTS
4.	FLOOR R-FACTOR	R-30	R-30


2020 INTERNATIONAL ENERGY CONSERVATION CODE (IECC) COMPLIANCE PATH

- I. A MINIMUM OF 75% OF THE LAMPS IN PERMANENTLY INSTALLED LIGHTING FIXTURES SHALL BE HIGH-EFFICIENCY LAMPS PER SECTION 1104.1
- 2. RECESSED LUMINARIES INSTALLED IN THE BUILDING THERMAL ENVELOPE SHALL BE SEALED WITH A GASKET OR CAULK BETWEEN THE HOUSING AND THE INTERIOR WALL OR CEILING COVERING TO LIMIT AIR LEAKAGE BETWEEN CONDITIONED AND
- 3. CONTRACTOR TO PROVIDE A PROGRAMMABLE THERMOSTAT TO CONTROL THE HVAC SYSTEM PER SECTION 1103.1.1
- 4. ALL CIRCULATING SERVICE HOT WATER PIPING SHALL BE INSULATED TO AT LEAST R-2. CIRCULATION HOT WATER SYSTEMS SHALL INCULDE AN AUTOMATIC OR READILY ACCESSIBLE MANUAL SWITCH THAT CAN TURN OFF THE HOT WATER CIRCULATING PUMP WHEN THE SYSTEM IS NOT IN USE. PER SECTION 1103.3.4
- 5. AIR LEAKAGE TEST TO BE CONDUCTED & PERFORMED BY A THIRD PARTY IN COMPLIANCE WITH 1102.4.1.2. AIR LEAKAGE RATE MAY NOT EXCEED 3 ACH (CLIMATE ZONE 5)
- 6. ATTIC ACCESS SHALL BE INSULATED WITH THE SAME R-VALUE AS THE ATTIC, WEATHER STRIPPED AND LATCHED PER SECTION 1102.2.3
- 7. DUCTWORK ON EXTERIOR WALLS IF REQUIRED SHALL BE INSULATED TO A MINUMUM
- 8. MECHANICAL VENTILATION PER SECTION NIIO3.6 TO BE MET WITH CONTINUOUS USE EXHAUST FANS AND MAKE-UP AIR CONTROLS, PER SECTION MI507.3.3 REQUIREMENT.
- 9. MECHANICAL VENTILATION FAN EFFICACY SHALL MEET MINIMUM REQUIREMENTS PER SECTION NIIO3.6.1.
- IO. HEATING AND COOLING EQUIPMENT SHALL BE SIZED IN ACCORDANCE WITH SECTION NIIO3.7 REQUIREMENTS.

UNCONDITIONED SPACES. PER SECTION 1102.4.5

BASIC DESIGN CRITERIA

- I. GROUND SNOW LOAD 40 PSF R301.2 (5)
- 2. WIND SPEED 115 MPH, EXPOSURE B R301.2.1
- 3. SEISMIC DESIGN CATEGORY A R301.2 (2)
- 4. WEATHERING SEVERE
- 5. FROST LINE DEPTH 48"
- 6. TERMITE DAMAGE NONE TO SLIGHT
- 7. DECAY DAMAGE NONE TO SLIGHT
- 8. WINTER DESIGN TEMPERATURE I
- 9. ICE SHIELD UNDERLAYMENT REQUIRED YES 10. FLOOD HAZARD - FIRM - 1992
- II. ROOF TIE DOWN REQUIREMENTS R802.II.I

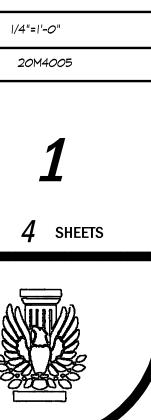

LICENSED IN CO, MA, ME, NV, NY, PA, SC

121 Sully's Trail Pittsford, NY 14534

(585) 264-1330 (585) 264-1333 Fax

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PATRICK J. MORABITO, A.I.A. ARCHITECT P.C.



PROJECT:

RENOVATION/ADDITION 292 SHOREHAM DR. ROCHESTER, NY

CLIENT: JOE AND JESSICA SPILMAN

DRAWING:


DRAWN:

MARCH 2021

SCALE: 1/4"=1'-0"


JOB NO.:

SHEET:

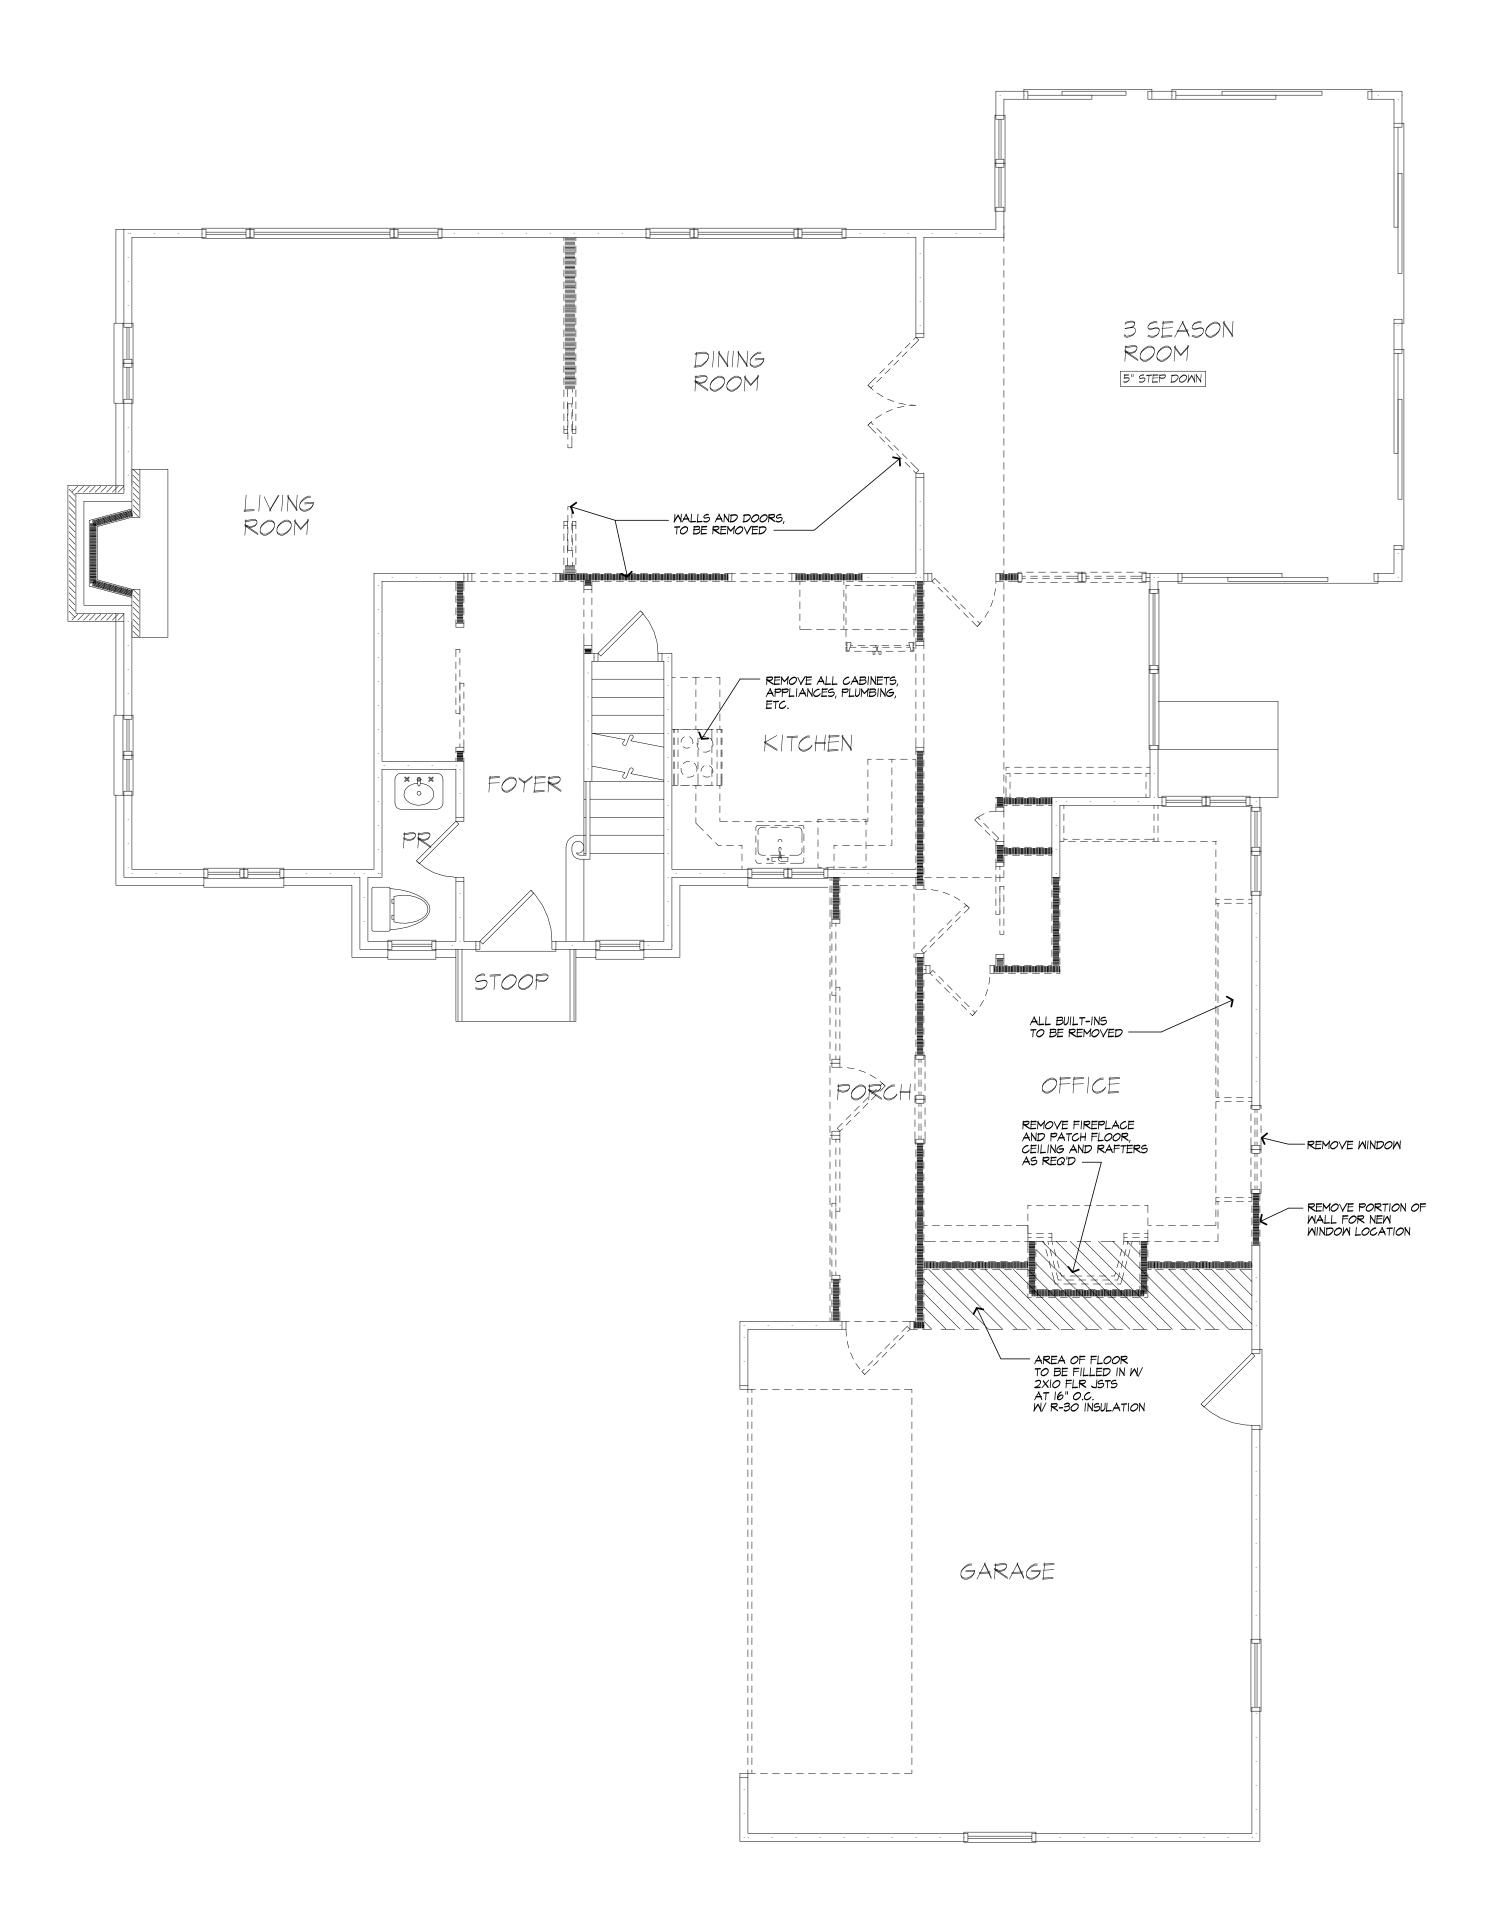

FIRST FLOOR PLAN

EXISTING

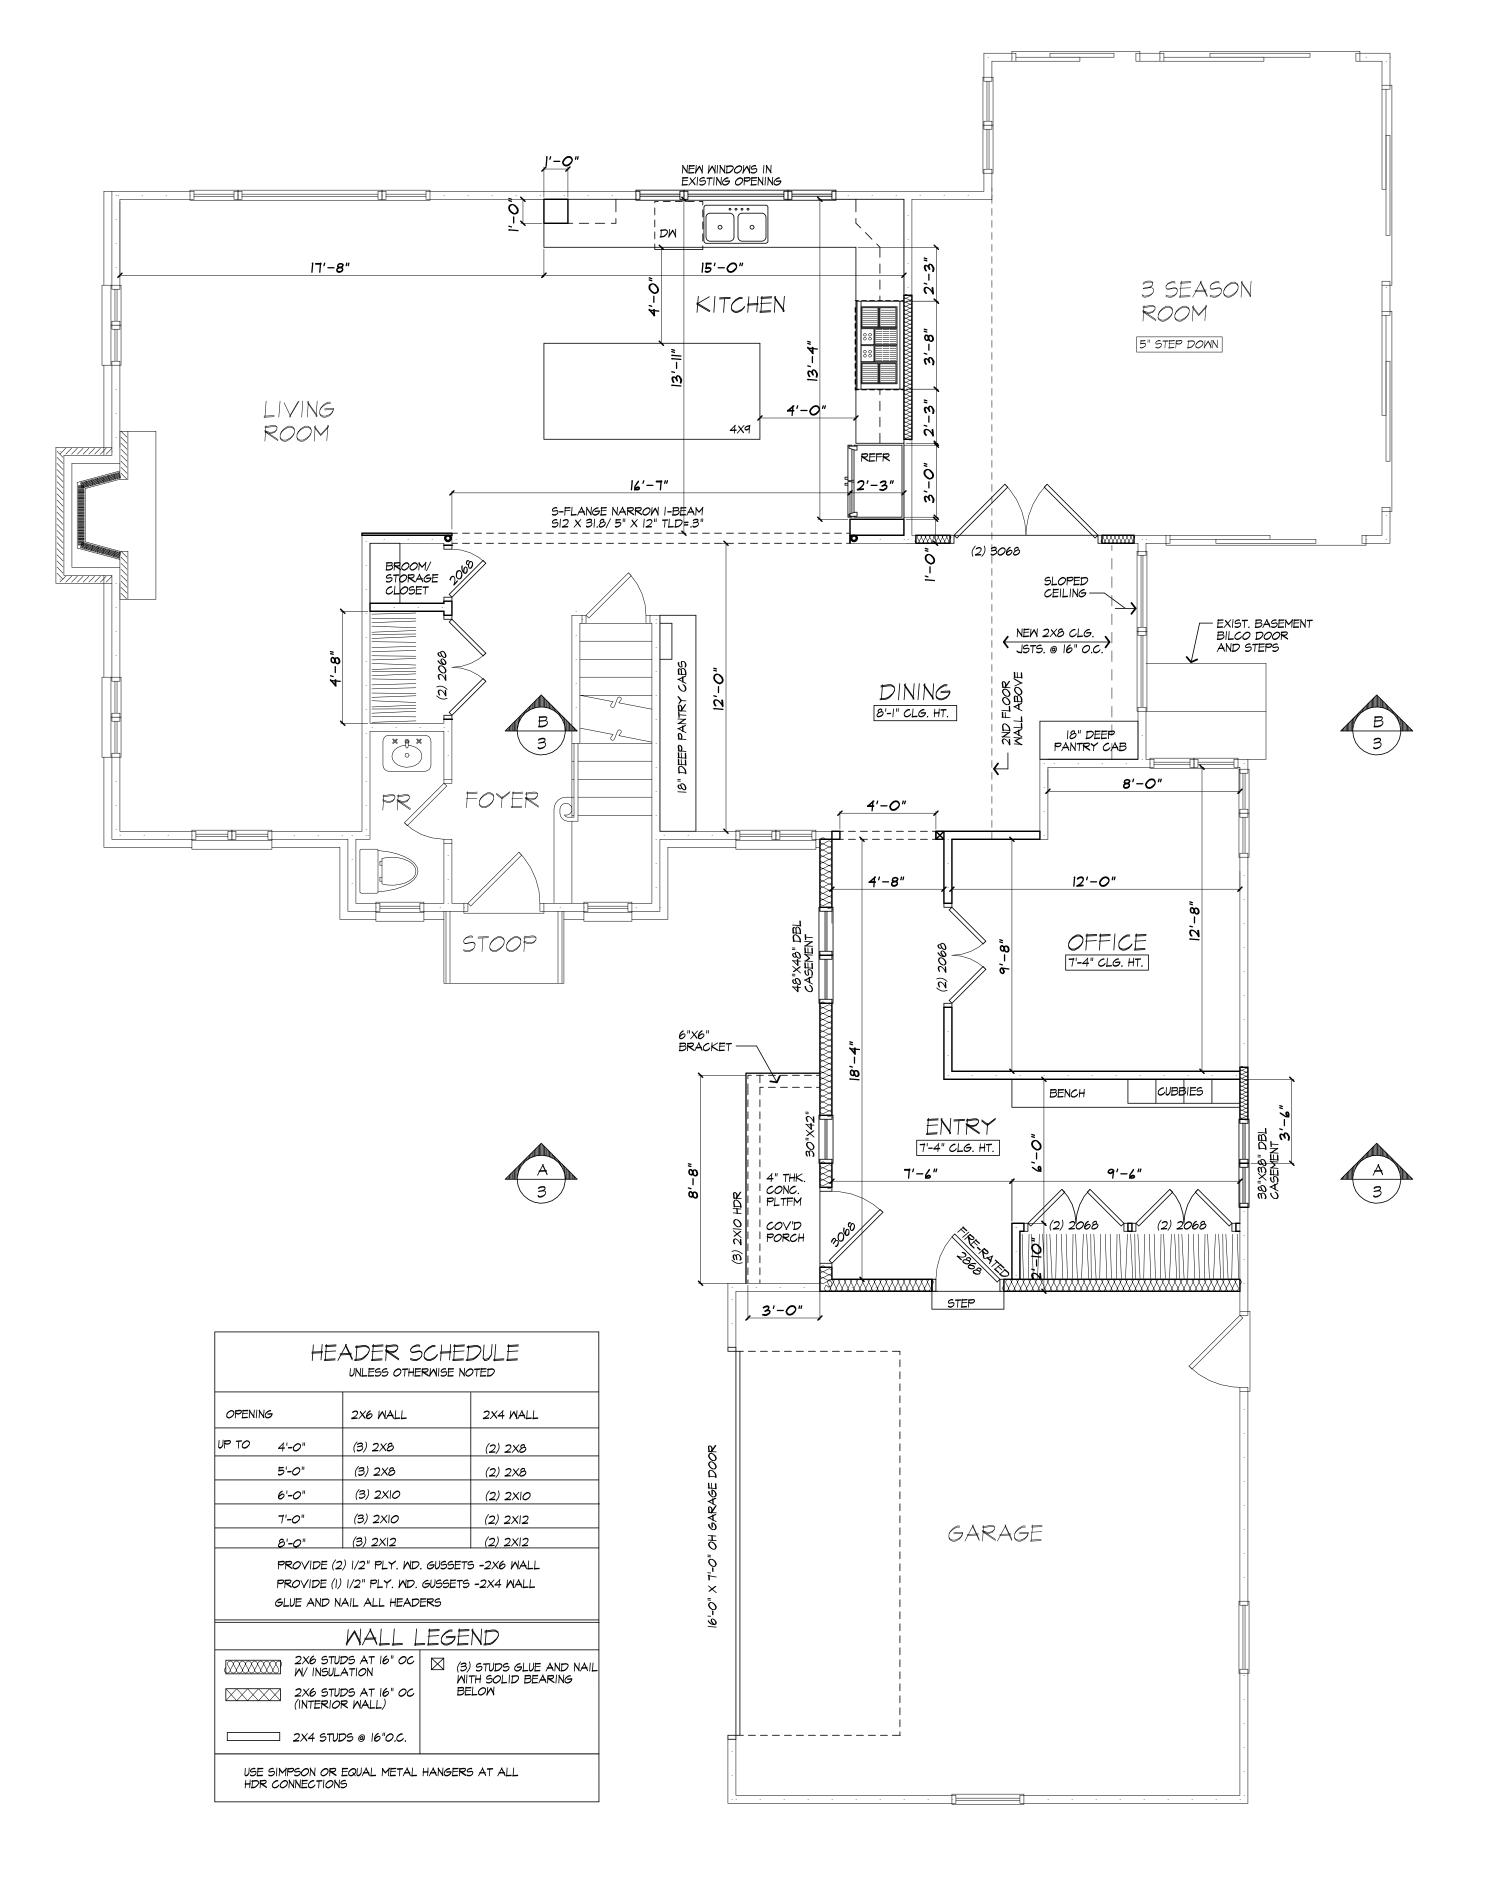

FIRST FLOOR PLAN

PROPOSED

*VERIFY IN FIELD (V.I.F.) LOCATION OF ALL EXISTING WALLS, BEAMS, HEADERS, WINDOWS, DOORS, ETC



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PROJECT:

RENOVATION/ADDITION
292 SHOREHAM DR.
ROCHESTER, NY

CLIENT: JOE AND JESSICA SPILMAN

FIRST FLOOR PLAN EXISTING/PROPOSED

DRAWING:

JL/PM

DATE: MARCH 2021

SCALE: 1/4"=1'-0"

JOB NO.: 20M4005

SHEET:


2


of 4 sheets





LEFT SIDE ELEVATION - PROPOSED

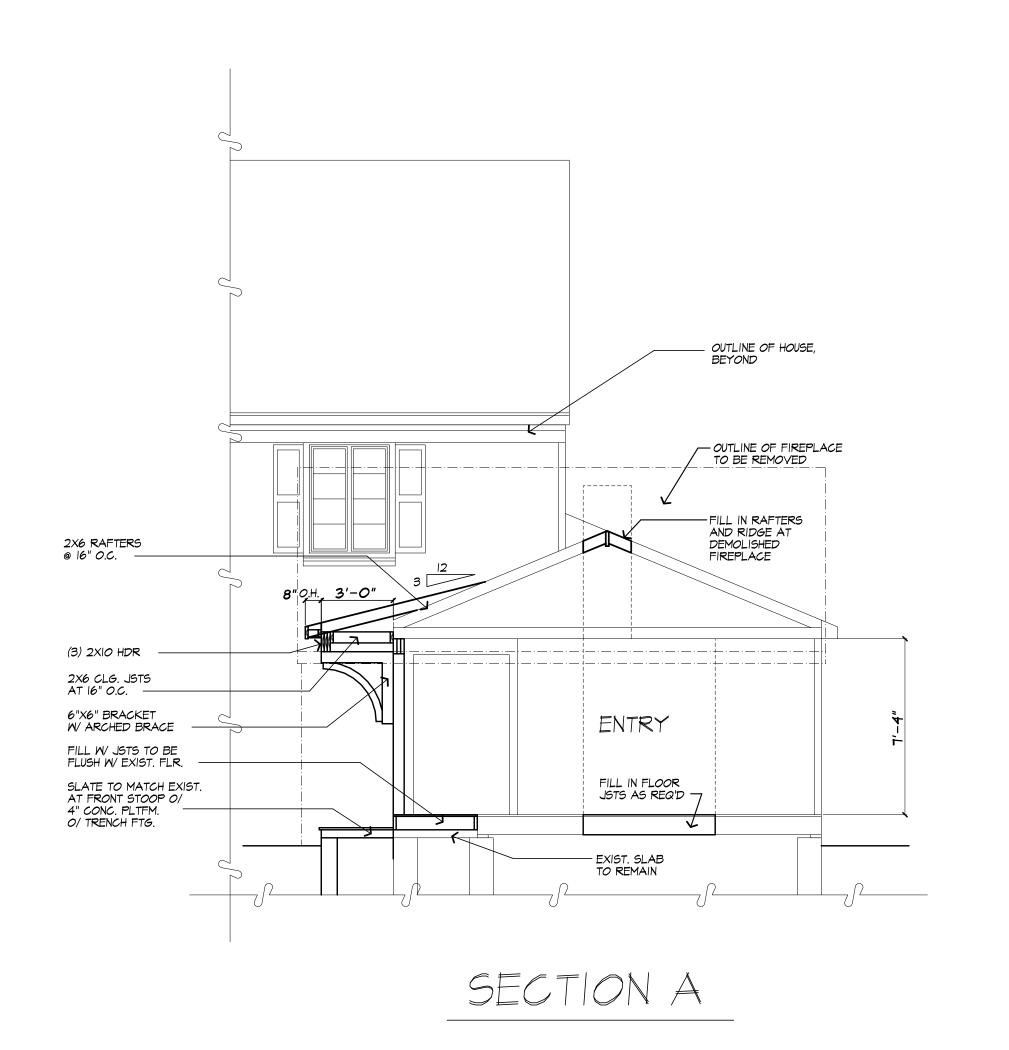

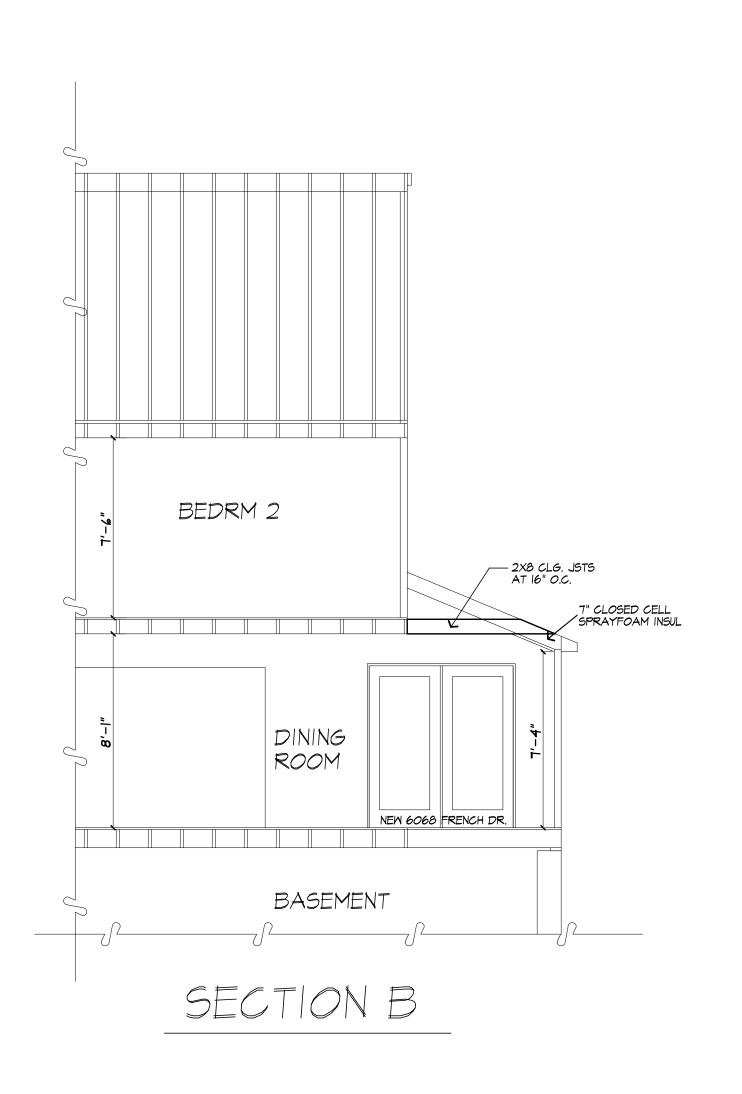



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PROJECT: RENOVATION/ADDITION 292 SHOREHAM DR. ROCHESTER, NY

CLIENT: JOE AND JESSICA SPILMAN

DRAWING: LEFT SIDE ELEVATION - PROPOSED BUILDING SECTIONS - PROPOSED

DRAWN:

MARCH 2021


SCALE: 1/4"=1'-0"

JOB NO.: 20M4005

SHEET:


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TYPICAL WALL SECTION

SCALE: 1/2"=1'-0"

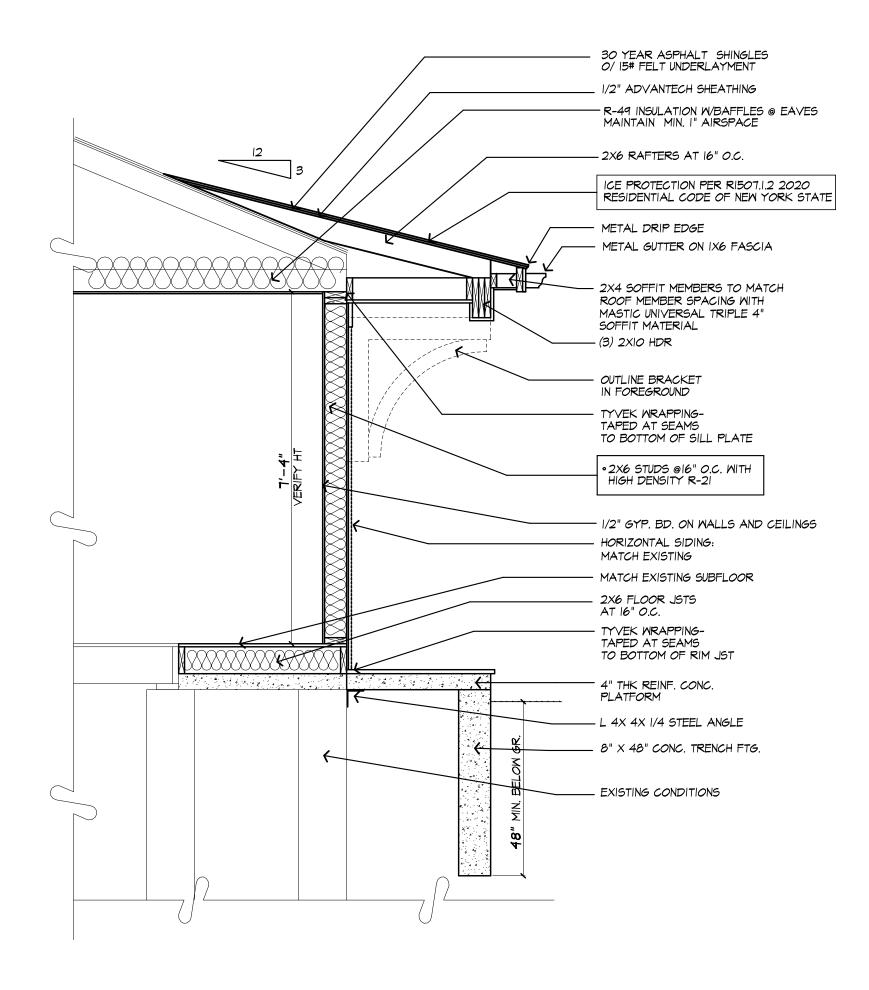

ROOF PLAN - PROPOSED

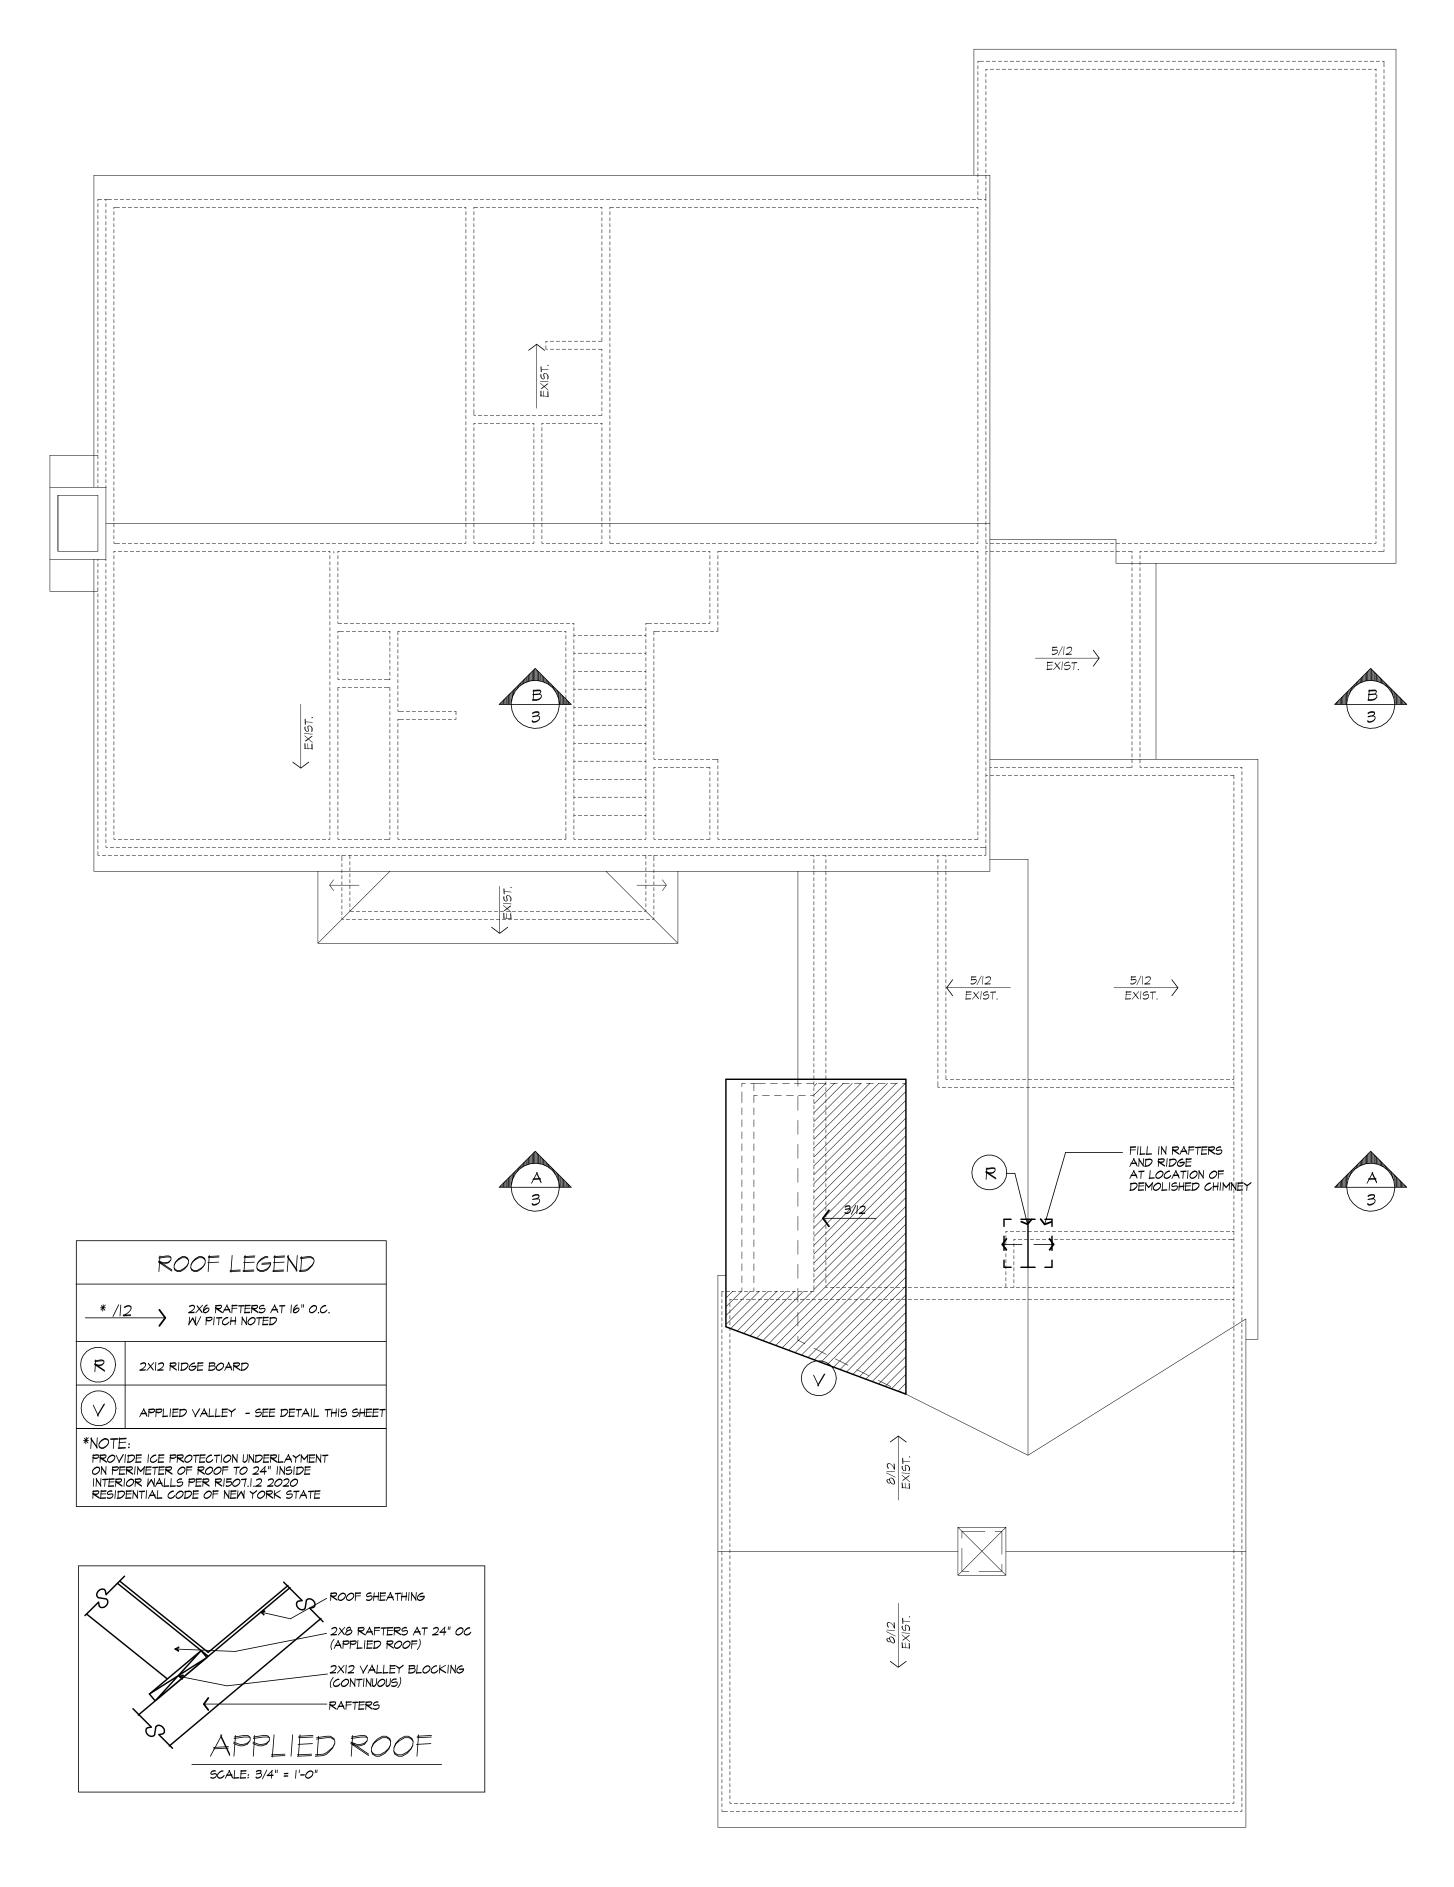

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PROJECT:
RENOVATION/ADDITION
292 SHOREHAM DR.
ROCHESTER, NY

ROCHESTER, NY

CLIENT:

JOE AND JESSICA SPILMAN

WALL SECTION PROPOSED ROOF PLAN

DRAWN:

DRAWING:

JL/PM

DATE: MARCH 2021

SCALE: 1/4"=1'-0"

JOB NO.: 20M4005

SHEET:

4

of 4 sheets















Town of Pittsford

Department of Public Works 11 South Main Street Pittsford, New York 14534

Permit # B21-000054

Phone: 585-248-6250 FAX: 585-248-6262

DESIGN REVIEW AND HISTORIC PRESERVATION BOARD REFERRAL OF APPLICATION

Property Address: 135 Sylvania Road ROCHESTER, NY 14618

Tax ID Number: 151.06-1-7

Zoning District: RN Residential Neighborhood

Owner: Weins, Mary Ellen

Applicant: Stahl Property Associates

Application Type:

application Type:	
Residential Design Review §185-205 (B)	Build to Line Adjustment §185-17 (B) (2)
Commercial Design Review §185-205 (B)	Building Height Above 30 Feet §185-17 (M)
Signage §185-205 (C)	Corner Lot Orientation §185-17 (K) (3)
Certificate of Appropriateness §185-197	Flag Lot Building Line Location §185-17 (L) (1) (c)
Landmark Designation §185-195 (2)	Undeveloped Flag Lot Requirements §185-17 (L) (2)
Informal Review	

Project Description: Applicant is requesting design review for the addition of a covered porch. The porch will be approximately 285 square feet and will be constructed on the rear of the home.


Meeting Date: March 25, 2021



RN Residential Neighborhood Zoning




Printed March 18, 2021

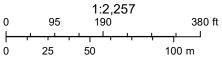

Town of Pittsford GIS

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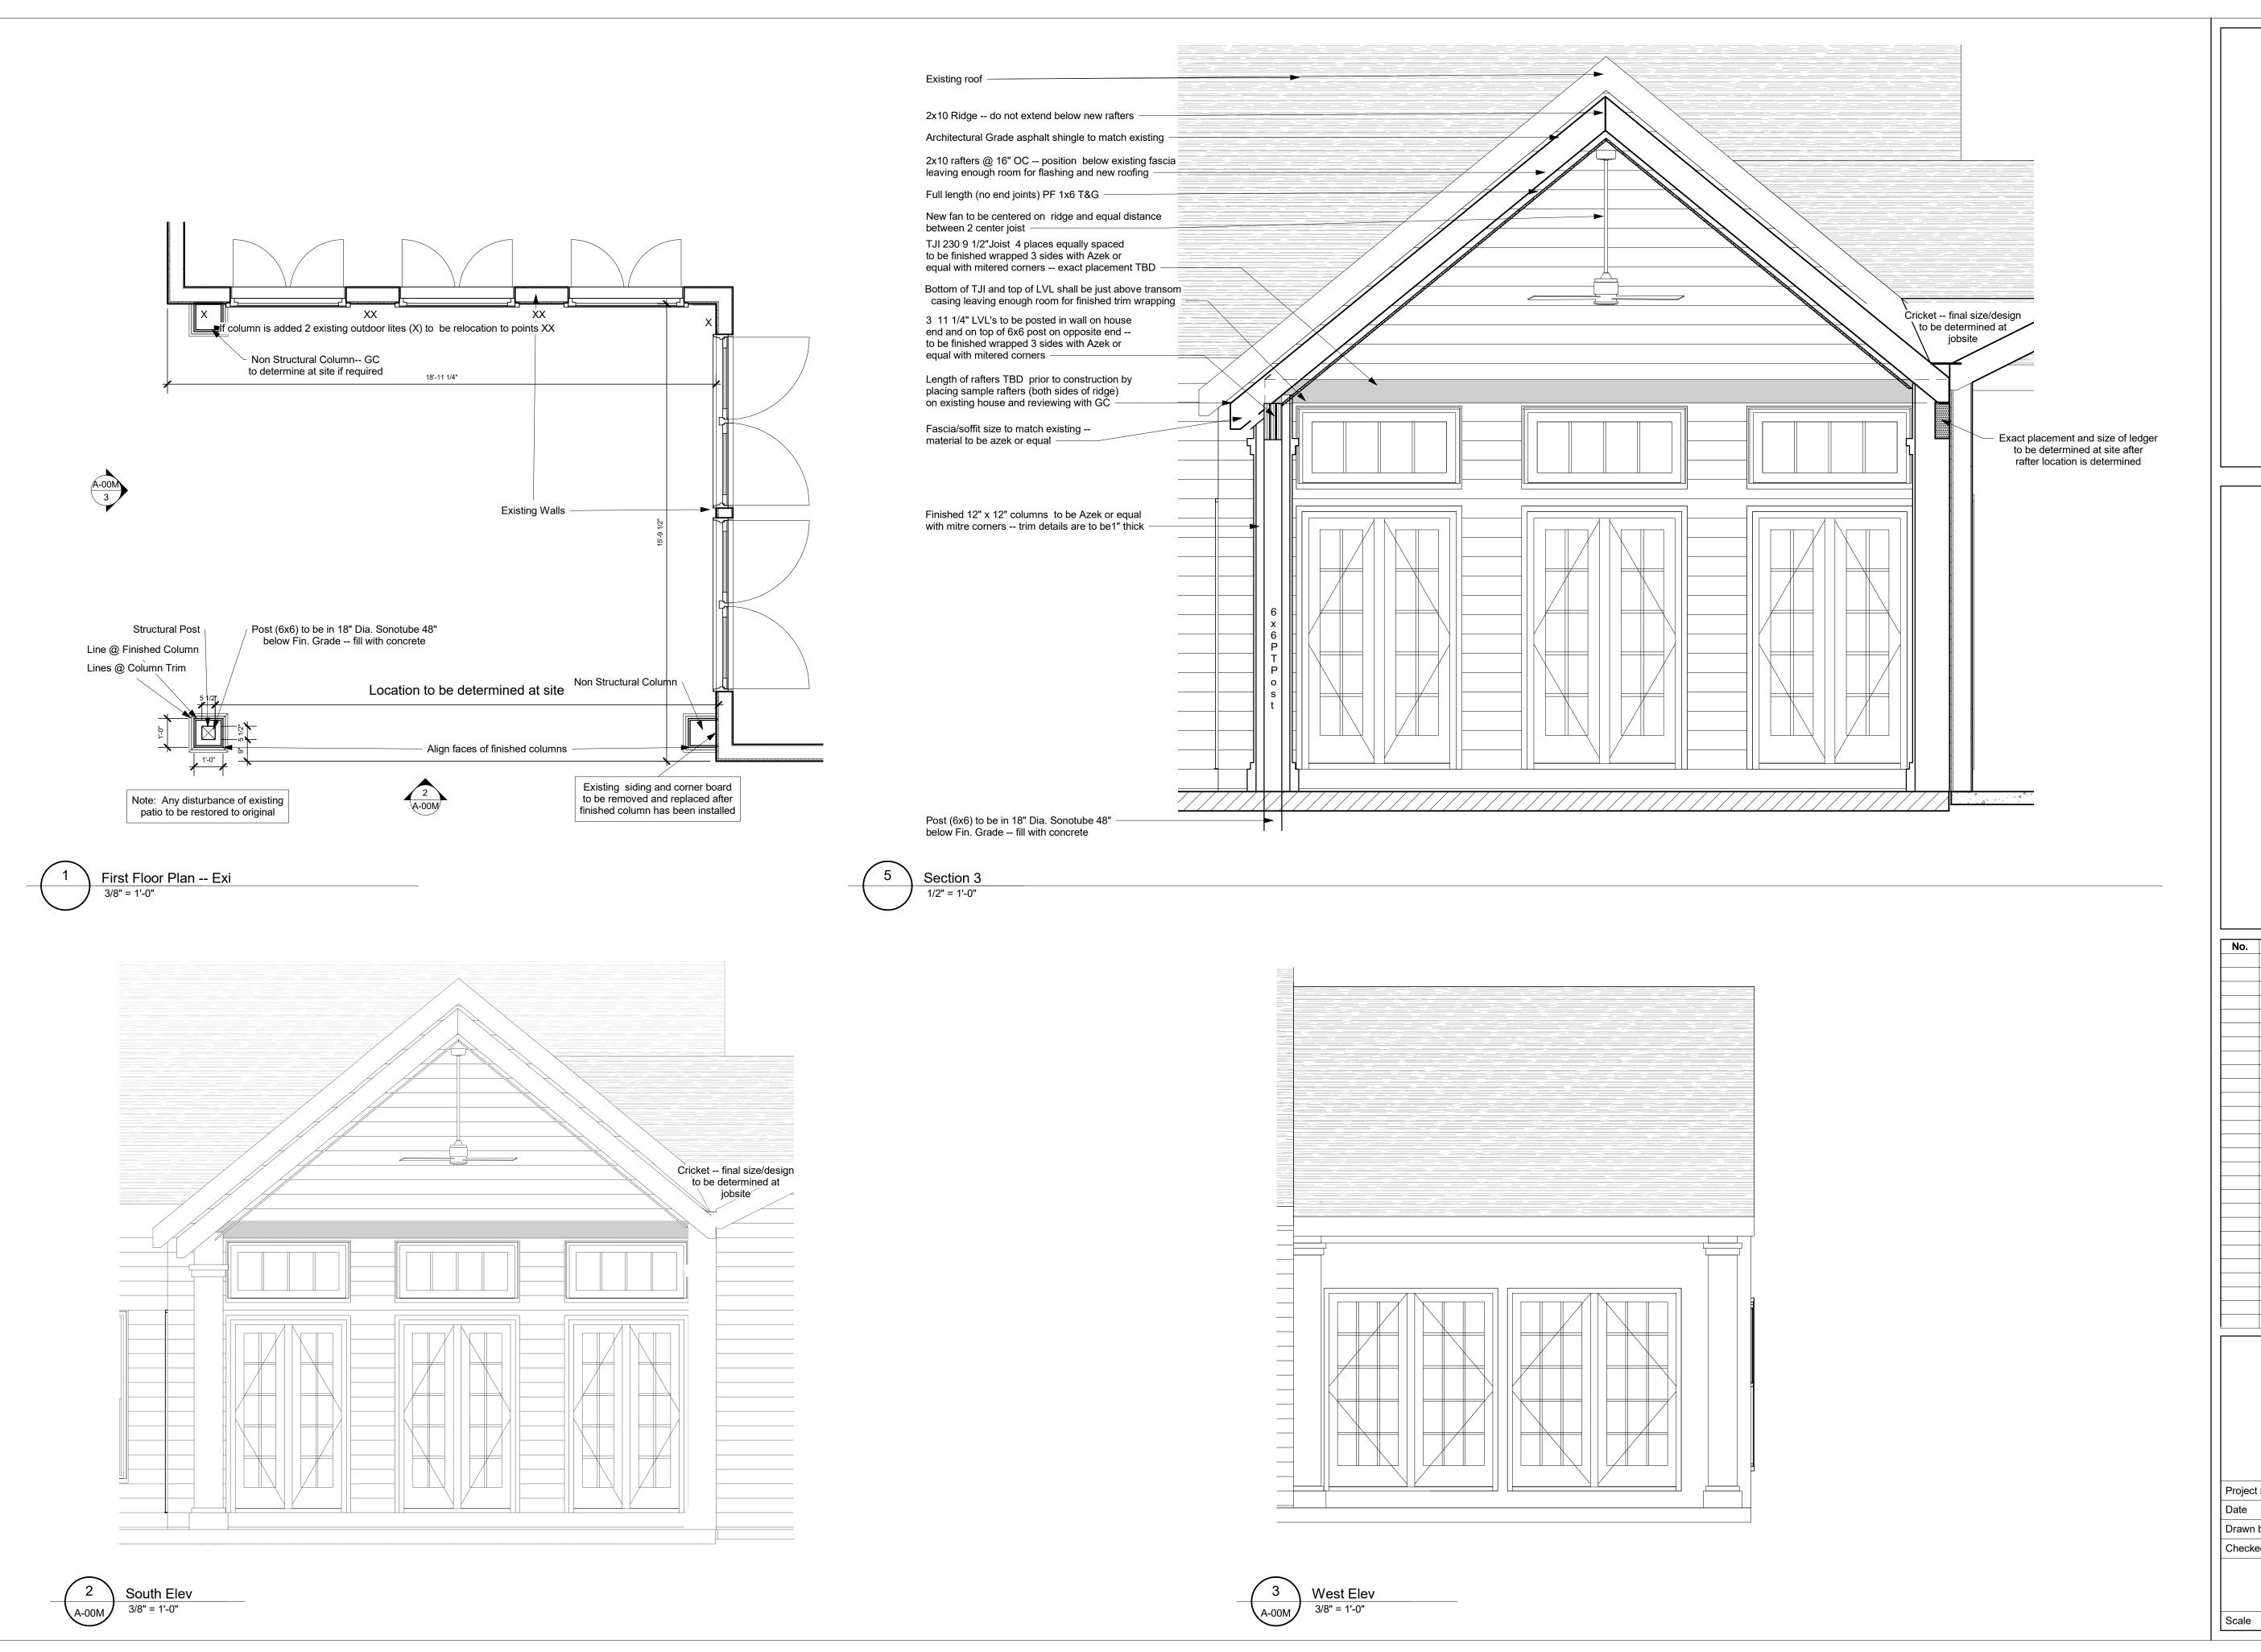


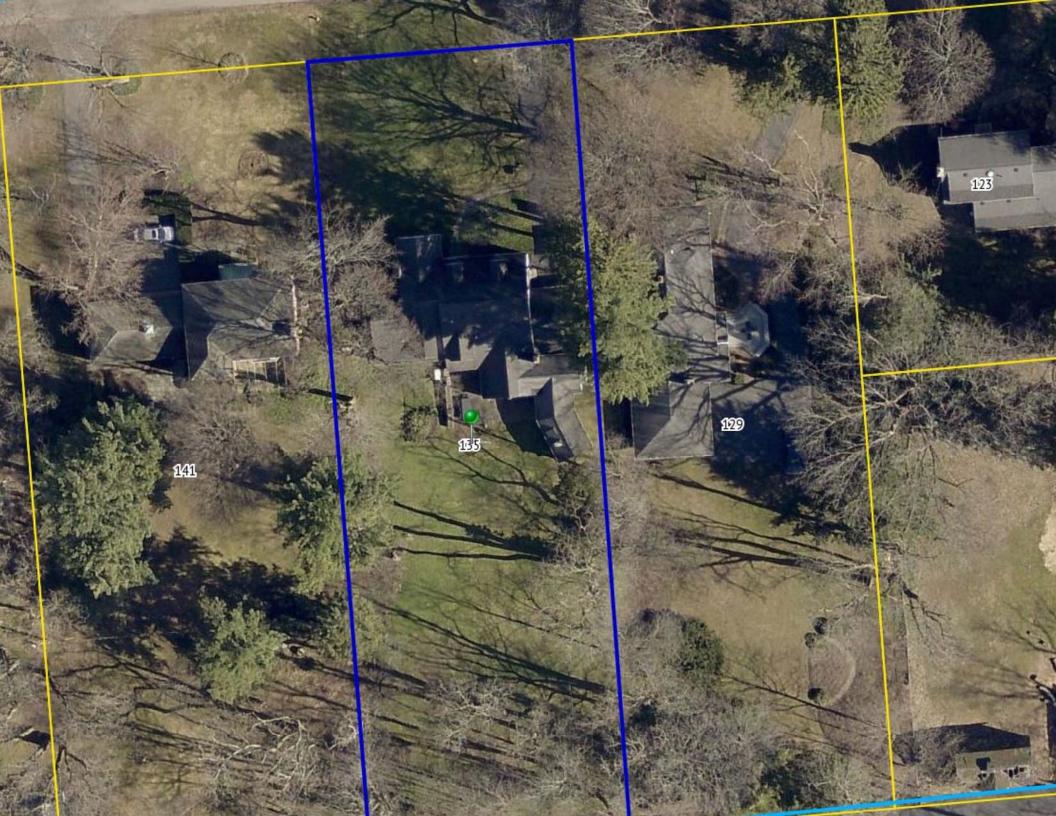DENLUCK-HYDE MAP OF A SURVEY **ENGINEERING & SURVEYING** ASSOCIATES, P.C. LOT 5, JOSEPH A. BENJAMIN SUBDIVISION TOWN OF PITTSFORD MONROE COUNTY, NEW YORK REDATED 4/13/87 5 SOUTH FITZHUGH ST. ROCHESTER, N.Y. CLIENT SUTTON, DELEEUW ET.AL. [14614] PROJECT NO. DATE SCALE PHONE (716) 325-7520 501 1/16/84 84 - 8SYLVANIA 498.95 TO EAST AVE. REVISIONS TO THIS MAP MADE DENLUCK-O'NETILL, P.C. 10:01 5 South Fitzhugh Street Rochester, NY 14614 10,14 ON APRIL 10, 1992. 1.) Revisions to house to 6186 reflect additions 2.) No other changes 1.04 BOUNDARY BLACKTOP PAJEMENT

KNOWLTON









S T A H L PROPERTY ASSOCIATES

Rochester, NY 14618

Telephone (585) 415-9882

PORCH ADDITION

No. Description Date

MISC DWGS

 Project number
 1128

 Date
 03/12/2021

 Drawn by
 GAS

 Checked by
 KB


A-00M

As indicated







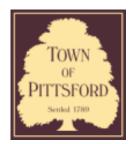

Town of Pittsford

Department of Public Works 11 South Main Street Pittsford, New York 14534

Permit # B21-000051

Phone: 585-248-6250 FAX: 585-248-6262

DESIGN REVIEW AND HISTORIC PRESERVATION BOARD REFERRAL OF APPLICATION

Property Address: 49 Charmwood Road PITTSFORD, NY 14534

Tax ID Number: 151.12-2-60

Zoning District: RN Residential Neighborhood

Owner: Shearer, Sally M Applicant: Roger Dirks

Α	aa	lic	atio	n T	ype:
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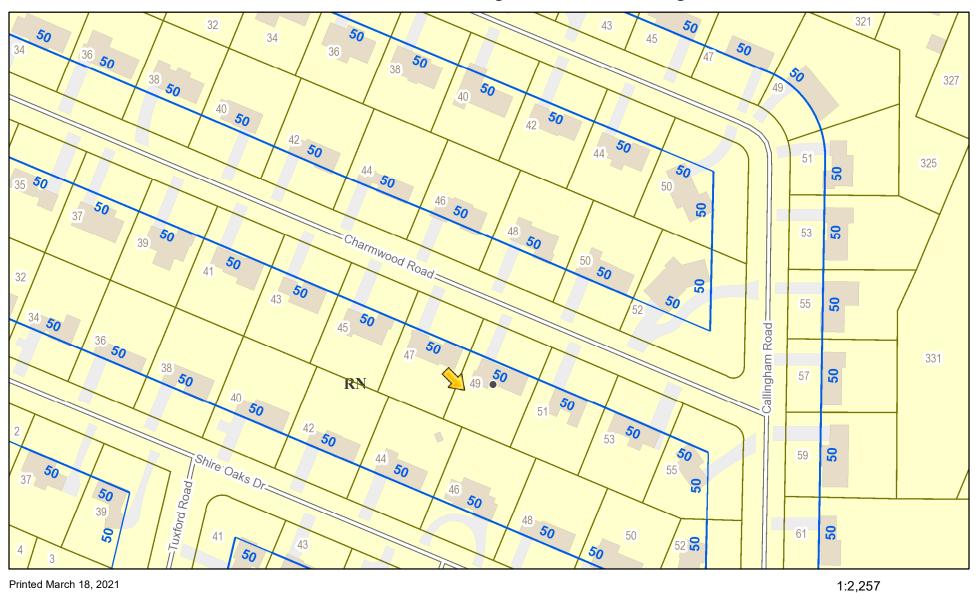
· []		
✓	Residential Design Review §185-205 (B)	Build to Line Adjustment §185-17 (B) (2)
	Commercial Design Review §185-205 (B)	Building Height Above 30 Feet §185-17 (M)
	Signage §185-205 (C)	Corner Lot Orientation §185-17 (K) (3)
	Certificate of Appropriateness §185-197	Flag Lot Building Line Location §185-17 (L) (1) (c)
	Landmark Designation §185-195 (2)	Undeveloped Flag Lot Requirements §185-17 (L) (2)
	Informal Review	

Project Description: Applicant is requesting design review for the addition of a covered porch and kitchen expansion. The kitchen addition will be approximately 52 square feet and the covered porch will be approximately 24 square feet.

Meeting Date: March 25, 2021



RN Residential Neighborhood Zoning



Town of Pittsford GIS

95

25

190

50

380 ft


100 m



area of enlargement (just to front of garage) a small portion of garage and up to front stoop X 2'X 27

CHARMWOOD ROAD (60')

STREET LINE

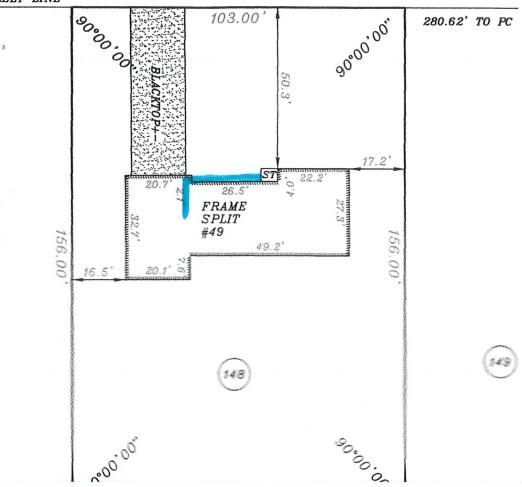

EMBOSSED SEAL SHALL NOT BE CONSIDERED A TRUE AND VALID COPY"
"UNAUTHORIZED ALTERATION AND/OR ADDITION TO A MAP BEARING A
LICENSED LAND SURVEYORS SEAL IS A VIOLATION OF SECTION 7209 OF
THE NEW YORK STATE EDICATION LAN"
"CERTIFICATIONS LISTED HEREON SHALL RUN ONLY TO THE PERSON
FOR WHOM THE SURVEY WAS PREPARED, AND ON HIS HER BEHALF
TO THE TITLE COMPANY, COVERMENTAL AGENCY AND LEADING
INSTITUTION LISTED HEREON, AND TO ASSIGNEES OF THE LENDING
INSTITUTION, CERTIFICATIONS ARE NOT TRANSFERRABLE TO SUBSEQUENT
OWNERS OR THEIR INSTITUTIONS"
"UNLESS SHOWN OR NOTED, THE LOCATION OF LANDSCAPING PEATURES
WAS NOT DETERMINED BY THIS SURVEY"
"THIS MAP WAS PREPARED FROM NOTES OF AN INSTRUMENT SURVEY AND
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RECORD NOT REFERENCED"
"UNLESS NOTED MISSING/LOST CORNERS NOT SET AS PART OF THIS PROJECT

I, WILLIAM A. SEYMOUR, LS#050465 CERTIFY THIS MAP WAS MADE FEBRUARY 11, 2015 FROM NOTES OF AN INSTRUMENT SURVEY COMPLETED ON FEBRUARY 11, 2015


INSTRUMENT SURVEY CHARMWOOD

BEING LOT 148, SHERWOOD SUBDIVISION, SECTION D TOWN OF PITTSFORD MONROE COUNTY, NEW YORK STATE

FILE: 2015-3733

SCALE: 1"=30'

WILLIAM A. SEYMOUR, LICENSED LAND SURVEYOR 2055 KENYON ROAD, ONTARIO, NEW YORK 14519 TEL: 1-315-524-9073 FAX: 1-315-524-8954

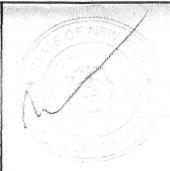

NOTES (GENERAL NOTES TO BE APPLIED AS NEEDED TO THIS REMODELING PROJECT)

- (I.) BUILDING IS CLASSIFIED AS A ONE FAMILY DWELLING. THE 2020 CODE SHALL PREVAIL AND BUILDING CONTRACTOR IS RESPONSIBLE FOR COMPLIANCE REGARDLESS OF ANY MISSING OR INCOMPLETE DETAILS OR NOTES ON THE DRAWINGS.
- (3.) THE 2020 ENERGY CONSERVATION CODE SHALL PREVAIL AND BUILDING CONTRACTOR IS RESPONSIBLE FOR COMPLIANCE REGARDLESS OF ANY MISSING OR INCOMPLETE DETAILS OR NOTES
- (4.) BUILDING CONTRACTOR AND HIS SUBCONTRACTORS SHALL CONFORM TO LOCAL CONSTRUCTION ORDINANCES AND SHALL VERTILE ALL DIMENSIONS AND CONDITIONS BEFORE PROCEEDING
- (5.) ROOF TRUSS ENGINEERING AND SIZES DETERMINED BY AND ARE THE SOLE RESPONSIBILITY OF THE MANUFACTURER. (MFR)
- (6.) NOTED DIMENSIONS TAKE PRECEDENCE OVER SCALED DIMENSIONS.
- (7.) THESE DRAWINGS HAVE BEEN PREPARED FOR DESIGN AND STRUCTURAL REFERENCE ONLY. ELECTRICAL, MECHANICAL, PLUMBING, AND OTHER BUILDING SYSTEMS IF ANY, ARE TO BE PREPARED BY AND ARE THE
- (8.) BEARING CAPACITY OF SOIL IS ASSUMED AT 2000 P.S.F. AND CONTRACTOR SHALL VERIFY PRIOR TO PLACEMENT OF FOOTINGS.
- (9.) ALLOWABLE STRESSES OF MATERIALS: (THE WEATHERING POTENTIAL FOR CONCRETE IS ASSUMED TO BE SEVERE. SEE

RESPONSIBILITY OF OTHERS.

- A.) CONCRETE (R402.2) MIN. COMPRESSIVE STRENGTH @ 28 DAYS PSI = F00TINGS: 2500 PSI BASEMENT SLAB: 2500 PSI (W FIBER REINF. ADDITIVE, OPTIONAL) GARAGE & PORCH SLABS: 3500 PSI (AIR-ENTRAINED) BASEMENT WALLS: 3000 PSI (AIR-ENTRAINED WHERE EXPOSED TO WEATHER)

 POURED CONC. SHALL BE PROTECTED FROM FREEZE/THAW DURING CONST-
- RUCTION, OR AIR ENTRAINED CONC. MUST BE USED. (TABLE R402.2, NOTE 2.)
- B.) STRUCTURAL STEEL TO BE ASTM A36 C.) WOOD JOISTS, BEAMS, HEADERS, AND RAFTERS SHALL HAVE AN EXTREME FIBER STRESS IN BENDING (FB) WITH REPETITIVE MEMBER USE OF 1150 P.S.I. (HEM FIR #2 OR BETTER.)
- IO.) FIREPLACES SHALL HAVE AN OUTSIDE AIR SOURCE FOR COMBUSTION WITH A DUCT, DAMPER ETC. & SHALL COMPLY WITH CODE SECTION RIOOI-RIO66 AS APPLICABLE.
- (II.) SETTING THE BUILDING ELEVATION IS THE RESPONSIBILITY OF THE GENERAL CONTRACTOR AND SHALL COMPLY WITH R403.1.7.3 OF THE 2015 INTERNATIONAL RESIDENTIAL CODE
- (12.) THE CONTRACTOR SHALL INSTALL 4" HIGH NUMBERS ON THE FRONT OF THIS BUILDING TO IDENTIFY THE SITE ADDRESS. (SEE SECTION R319.)

- (13.) GLAZING IN DOORS, STORM DOORS, SIDELIGHTS, SHOWER SPACES, AND TUB ENCLOSURES IS DEEMED TO BE HAZARDOUS PER SECTION R308.4 OF THE 2020 CODE AND SHALL BE IDENTIFIED AS SUCH IN COMPLIANCE WITH SECTION R 308.1. DECORATIVE GLASS IS EXEMPT IN SWINGING DOORS AND SIDELIGHTS (SEE SECTION R308.4 FOR ADDITIONAL HAZARDOUS LOCATIONS).
- (14.) DESIGN CRITERIA:
 - A.) ROOMS OTHER THAN SLEEPING = 40 PSF LIVE LOAD
 B.) SLEEPING ROOMS = 30 PSF LIVE LOAD
 C.) GROUND SNOW LOAD = 40 PSF (FIG R301.2(6)) WIND SPEED - 90 MPH, EXPOSURE B SEISMIC DESIGN CATEGORY - A OR B - R301.2(2)
 - MEATHERING SEVERE FROST LINE DEPTH - 42"
 TERMITE DAMAGE - CONTACT LOCAL JURISDICTION
 - DECAY DAMAGE NONE TO SLIGHT WINTER DESIGN TEMPERATURE - (I) DEGREE K.) ICE BARRIER IS REQUIRED
 - ROOF TIE-DOWN REQUIREMENTS R802.II (BASED UPON SPECIFIC ROOF DESIGN)
 M.) ENERGY COMPLIANCE DETAILS AND PATH - NIIOI.IS
- (15.) FOOTINGS TO BEAR ON FIRM, LEVEL, UNDISTURBED NATURAL SOIL, FREE FROM FROST OR LOOSE MATERIAL
- THE FOLLOWING IS AN EXCERPT FROM THE N.Y.S. EDUCATION LAW ARTICLE 145. SECTION 7209 AND APPLIES TO THESE DRAWINGS. "IT IS A VIOLATION OF THIS LAW FOR ANY PERSON, UNLESS HE IS ACTING UNDER THE DIRECT SUPERVISION OF A LICENSED PROFESSIONAL ENGINEER OR ARCHITECT TO ALTER AN ITEM IN ANY WAY. IF AN ITEM BEARING THE SEAL OF AN ENGINEER OR ARCHITECT IS ALTERED, THE ALTERING ENGINEER OR ARCHITECT SHALL AFFIX TO THE ITEM HIS SEAL AND THE NOTATION "ALTERED BY" FOLLOWED BY HIS SIGNATURE AND THE DATE OF SUCH ALTERATION AND A SPECIFIC DESCRIPTION OF THE ALTERATION."
- (17.) WHERE LOCAL EXHAUST OR WHOLE-HOUSE MECHANICAL VENTILATION IS PROVIDED, THE EQUIPMENT SHELL BE DESIGNED IN ACCORDANCE WITH SECTION MISOT OF THE
- (18.) "CODE" SHALL MEAN THE 2020 RESIDENTIAL CODE OF NEW YORK STATE. "ENERGY CONSERVATION CODE" OR "ENERGY CODE" SHALL MEAN CHAPTER II OF THE CODE.
- (19.) TO THE BEST OF MY KNOWLEDGE, BELIEF AND PROFESSIONAL JUDGEMENT, THESE PLANS ARE IN COMPLIANCE WITH THE ENERGY CONSERVATION CODE.

ENERGY CONSERVATION, CHAPTER II, ENERGY EFFICIENCY

- A MINIMUM OF 90 PERCENT OF THE LAMPS IN PERMANENTLY
 INSTALLED LIGHTING FIXTURES SHALL BE HIGH-EFFICACY LAMPS PER
- RECESSED LUMINARIES INSTALLED IN THE BUILDING THERMAL ENVELOPE SHALL BE SEALED WITH A GASKET OR CAULK BETWEEN THE HOUSING AND THE INTERIOR WALL OR CEILING COVERING TO LIMIT AIR LEAGE BETWEEN CONDITIONED AND UNCONDITIONED SPACES PER SECTION NIIO2.4.5
- 3. CONTRACTOR TO PROVIDE A PROGRAMMABLE THERMOSTAT TO CONTROL THE HVAC SYSTEM PER SECTION NIIO3.I.I
- 4. ALL DUCTS, AIR HANDLERS, FILTER BOXES SHALL BE SEALED PER SECTION NITO3.3.2.
- 5. ALL CIRCULATING SERVICE HOT WATER PIPING SHALL BE INSULATED TO AT LEAST R-3. CIRCULATING HOT WATER SYSTEMS SHALL INCLUDE AN AUTOMATIC OR READILY ACCESSIBLE MANUAL SWITCH THAT CAN TURN OFF THE HOT WATER CIRCULATING PUMP WHEN THE SYSTEM IS NOT IN USE. PER SECTION NIIO3.5
- 6. ATTIC ACCESS SHALL BE INSULATED WITH THE SAME R-VALUE AS THE ATTIC, WEATHER-STRIPPED AND LATCHED PER SECTION NIIO2.2.4
- AIR TIGHTNESS AND INSULATION INSTALLATION SHALL BE PER MANUFACTURERS INSTRUCTIONS AND CRITERIA LISTED IN SECTIONS NIIO2.4.1 THROUGH NIIO2.4.6.
- 8 THE STRUCTURE SHALL BE TESTED AND VERIFIED AS HAVING AN AIR LEAKAGE RATE NOT EXCEEDING 3 AIR CHANGES PER HOUR. CONDUCT TEST ACCORDING TO ASTM E779 OR ASTM E1827 OR NET/ICC 380 AND REPORTED AT A PRESSURE OF 0.2 INCH W.G. COMPLY WITH NIIO2.4.1.2.
- THE CONTRACTORS AND SUB-CONTRACTORS SHALL BE FAMILIAR WITH THE ENERGY CODE AND EXPERIENCED IN PERFORMING WORK THAT COMPLIES WITH ALL ASPECTS OF THE ENERGY CODE. THESE NOTES ARE NOT INTENDED TO BE ALL INCLUSIVE.

ADDITION

49 CHARMWOOD RD, PITTSFORD, NEW YORK

SALLY SHEARER, HOMEOWNER

ENERGY CODE COMPLIANCE PATH: SEE ATTACHED RES CHECK COMPLIANCE CERTIFICATE

SYMBOLS

MALL SECTIONS	MALL SECTION NO. DIRECTION THAT SECTION IS TAKEN SHEET ON WHICH SECTION IS DRAWN	CONTROLLED HGT.	TOP OF PLATE
<u>CROSS SECTIONS</u>	DIRECTION NO. DIRECTION THAT SECTION IS TAKEN SHEET ON WHICH	<u>ROOMS</u>	FINISH SCHEDULE)
	SECTION IS DRAWN DETAIL NO.	<u>Doors</u>	DOOR NO. HARDWARE GROUP (SEE DOOR SCHEDULE)
<u>DETAILS</u>	SHEET ON WHICH DETAIL IS DRAWN	<u>MINDOMS</u>	MINDOW NO. (SEE WINDOW SCHEDULE)
<u>ELEVATIONS</u>	ELEVATION NO. DIRECTION THAT ELEVATION IS TAKEN SHEET ON WHICH ELEVATION IS DRAWN	<u>REVISIONS</u>	POINTS TO ITEM REVISED REVISION NO. (SEE REVISION CHART ON THIS SHEET)

ABBREVIATIONS

APPROX	-APPROXIMATE	FT (')	-F00T	OPNG	-OPENING
&	-AND	FTG	-FOOTING	O/A	-OVERALL
@	-AT	FDN	-FOUNDATION	O.H.D	-OVERHEAD DOOR
BM	-BEAM	GYP	-GYPSUM	O/ HANG	-OVERHANG
BLK	-BLOCK	HND'CP	-HANDICAP	0/	-OVER
BD	-BOARD	HGT	-HEIGHT	OPT	-OPTIONAL
BLDG	-BUILDING	HM	-HOT WATER	P.D.R	-POWDER ROOM
BTR	-BETTER	HDR	-HEADER	PSF	-POUNDS PER SQ. F
CLG	-CEILING	IN (")	-INCH	PSI	-POUNDS PER SQ. IN
CL	-CENTERLINE	INCL	-INCLUDE	P.T.	-PRESSURE TREATEI
COL	-COLUMN	INFO	-INFORMATION	PLY'WD	-PLYWOOD
CONC	-CONCRETE	ID	-INSIDE DIAMETER	REQ'D	-REQUIRED
CONT	-CONTINUOUS	INSUL	-INSULATION	RM	-ROOM
COMM	-COMMERCIAL	INT	-INTERIOR	RES	-RESIDENTIAL
CRS	-COURSES	IECC	-INTERNATIONAL ENERGY	R'S	-RISERS
DL	-DEAD LOAD		CONSERVATION CODE	RD & SH	-ROD & SHELF
DIA	-DIAMETER	IRC	-INTERNATIONAL RESIDENTIAL CODE	5	-SOUTH
DBL	-DOUBLE	JT	-JOINT	SKY'LT	-SKYLIGHT
DN	-DOWN	JSTS	-JOISTS	SH	-SHELF
DMG	-DRAWING	LT	-LIGHT	SH'S	-SHELVES
DIM	-DIMENSION	LL	-LIVE LOAD	STOR	-STORAGE
ELEC	-ELECTRIC	MFR	-MANUFACTURER	STL	-STEEL
EXP	-EXPANSION	MAX	-MAXIMUM	SUSP	-SUSPENDED
EXT	-EXTERIOR	MECH	-MECHANICAL	SYN	-SYNTHETIC
FT (')	-FEET	MTL	-METAL	T'S	-TREADS
FIN	-FINISH	MIN	-MINIMUM	(TYP)	-TYPICAL
FLR	-FLOOR	MISC	-MISCELLANEOUS	T\$6	-TONGUE & GROOVE
I ST	-FIRST	N	-NORTH	W/	-MITH
FLUOR	-FLUORESCENT	NTS	-NOT TO SCALE	W/O	-WITHOUT
		NO	-NUMBER		

TABLE N1102.4.1.1 (402.4.1.1) AIR BARRIER AND INSULATION INSTALLATION COMPONENT AIR BARRIER CRITERIA INSULATION INSTALLATION CRITERIA continuous air barrier shall be installed in the building r-permeable insulation shall not be used as a sealing General requirements The exterior thermal envelope contains a continuous air Breaks or joints in the air barrier shall be sealed. The air barrier in any dropped ceiling/soffit shall be aligned with the insulation and any gaps in the air barrier ne insulation in any dropped ceiling/soffit shall be Ceiling/attic aligned with the air barrier. Access openings, drop down stairs or knee wall doors to nconditioned attic spaces shall be sealed. Cavities within corners and headers of frame walls shall be insulated by completely filling the cavity with The junction of the foundation and sill plate shall be sealed. material having a thermal resistance of R-3 per incl The junction of the top plate and the top of exterior walls shall be sealed. Exterior thermal envelope insulation for framed walls Knee walls shall be sealed. shall be installed in substantial contact and continuou ignment with the air barrier. The space between window/door jambs and framing, and Vindows, skylights and doors kylights and framing shall be sealed. Rim joists shall be insulated Rim joists shall include the air barrier. Floor framing cavity insulation shall be installed to maintain permanent contact with the underside of subfloor decking, or floor framing cavity insulation Floors (including above garage The air barrier shall be installed at any exposed edge shall be permitted to be in contact with the top side of heathing, or continuous insulation installed on the and cantilevered floors) underside of floor framing; and extends from the pottom to the top of all perimeter floor framing exposed earth in unvented crawl spaces shall be covered Where provided instead of floor insulation, insulation Crawl space walls with a Class I vapor retarder with overlapping joints taped. shall be permanently attached to the crawl space walls Duct shafts, utility penetrations, and flue shafts opening to exterior or unconditioned space shall be sealed. Shafts, penetrations Batts in narrow cavities shall be cut to fit or narrow Narrow cavities cavities shall be filled by insulation that on installation adily conforms to the available cavity space. Air sealing shall be provided between the garage and Sarage separation Recessed light fixtures installed in the building Recessed light fixtures installed in the building thermal lecessed lighting nvelope shall be sealed to the drywall. ermal envelope shall be air tight and IC rated. Batt insulation shall be cut neatly to fit around wiring and plumbing in exterior walls, or insulation that on Plumbing and wiring stallation readily conforms to available space shall xtend behind piping and wiring. he air barrier installed at exterior walls adjacent to Exterior walls adjacent to showers and tubs shall be showers and tubs shall separate them from the showers and hower/tub on exterior wall lectrical/phone box on exterior The air barrier shall be installed behind electrical or communication boxes or air-sealed boxes shall be installed. IVAC register boots that penetrate building thermal IVAC register boots envelope shall be sealed to the subfloor or drywall. When required to be sealed, concealed fire sprinklers shall only be sealed in a manner that is recommended by the manufacturer. Caulking or other adhesive sealants shall not Concealed sprinklers be used to fill voids between fire sprinkler cover plates and walls or ceilings. a. In addition, inspection of log walls shall be in accordance with the provisions of ICC 400.

GENERAL NOTES

- CONTRACTOR SHALL COMPLY WITH ALL STATE AND O LOCAL CODES WHICH PERTAIN TO THE CONSTRUCTION
- CONTRACTOR SHALL VERIFY EXISTING STRUCTURAL CONDITIONS AND DIMENSIONS PRIOR TO DEMOLITION AND / OR CONSTRUCTION
- CONTRACTOR SHALL PROVIDE ANY NECESSARY BRACING, TEMPORARY FRAMING SUPPORTS (SHORING), AND UNDER-
- PINNING OF EXISTING STRUCTURE AS REQUIRED CONTRACTOR SHALL CO-ORDINATE THE INSTALLATION OF NEW AND / OR USE OF RELOCATED DOORS, AND
- WINDOWS WITH HOMEOWNER
- CONTRACTOR SHALL (WHERE POSSIBLE) MATCH PLATE HEIGHTS, SUBFLOORS, AND WINDOW ROUGH OPENING HEIGHTS TO MAINTAIN CONTINUITY
- WHERE POSSIBLE MATCH CONCRETE BLOCK COURSES AT NEW AND EXISTING FOUNDATION WALLS MINIMUM GRADE COVER AT ALL CONCRETE FOOTINGS
- INFILL EXISTING EXPOSED EXTERIOR FRAMING CAVITIES FULL WITH INSULATION
- MINIMUM R MAXIMUM U VALUES MAX U VALUE = 0.30 FENESTRATION

DESIGNS, P.C

STEVEN L. CARINI, P.E.

1387 FAIRPORT ROAD FAIRPORT, NY 14450-2002 PH. (585) 223-6420

www.carinidesigns.com

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with manufacturer's installation instructions and all applicable codes.

RESIDENTIAL ADDITION

49 CHARMWOOD ROAD PITTSFORD, NEW YORK


SALLY SHEARER

Drawing Title:


COVER SHEET & NOTES


TJM / SMK | SLC

MARCH, 2021

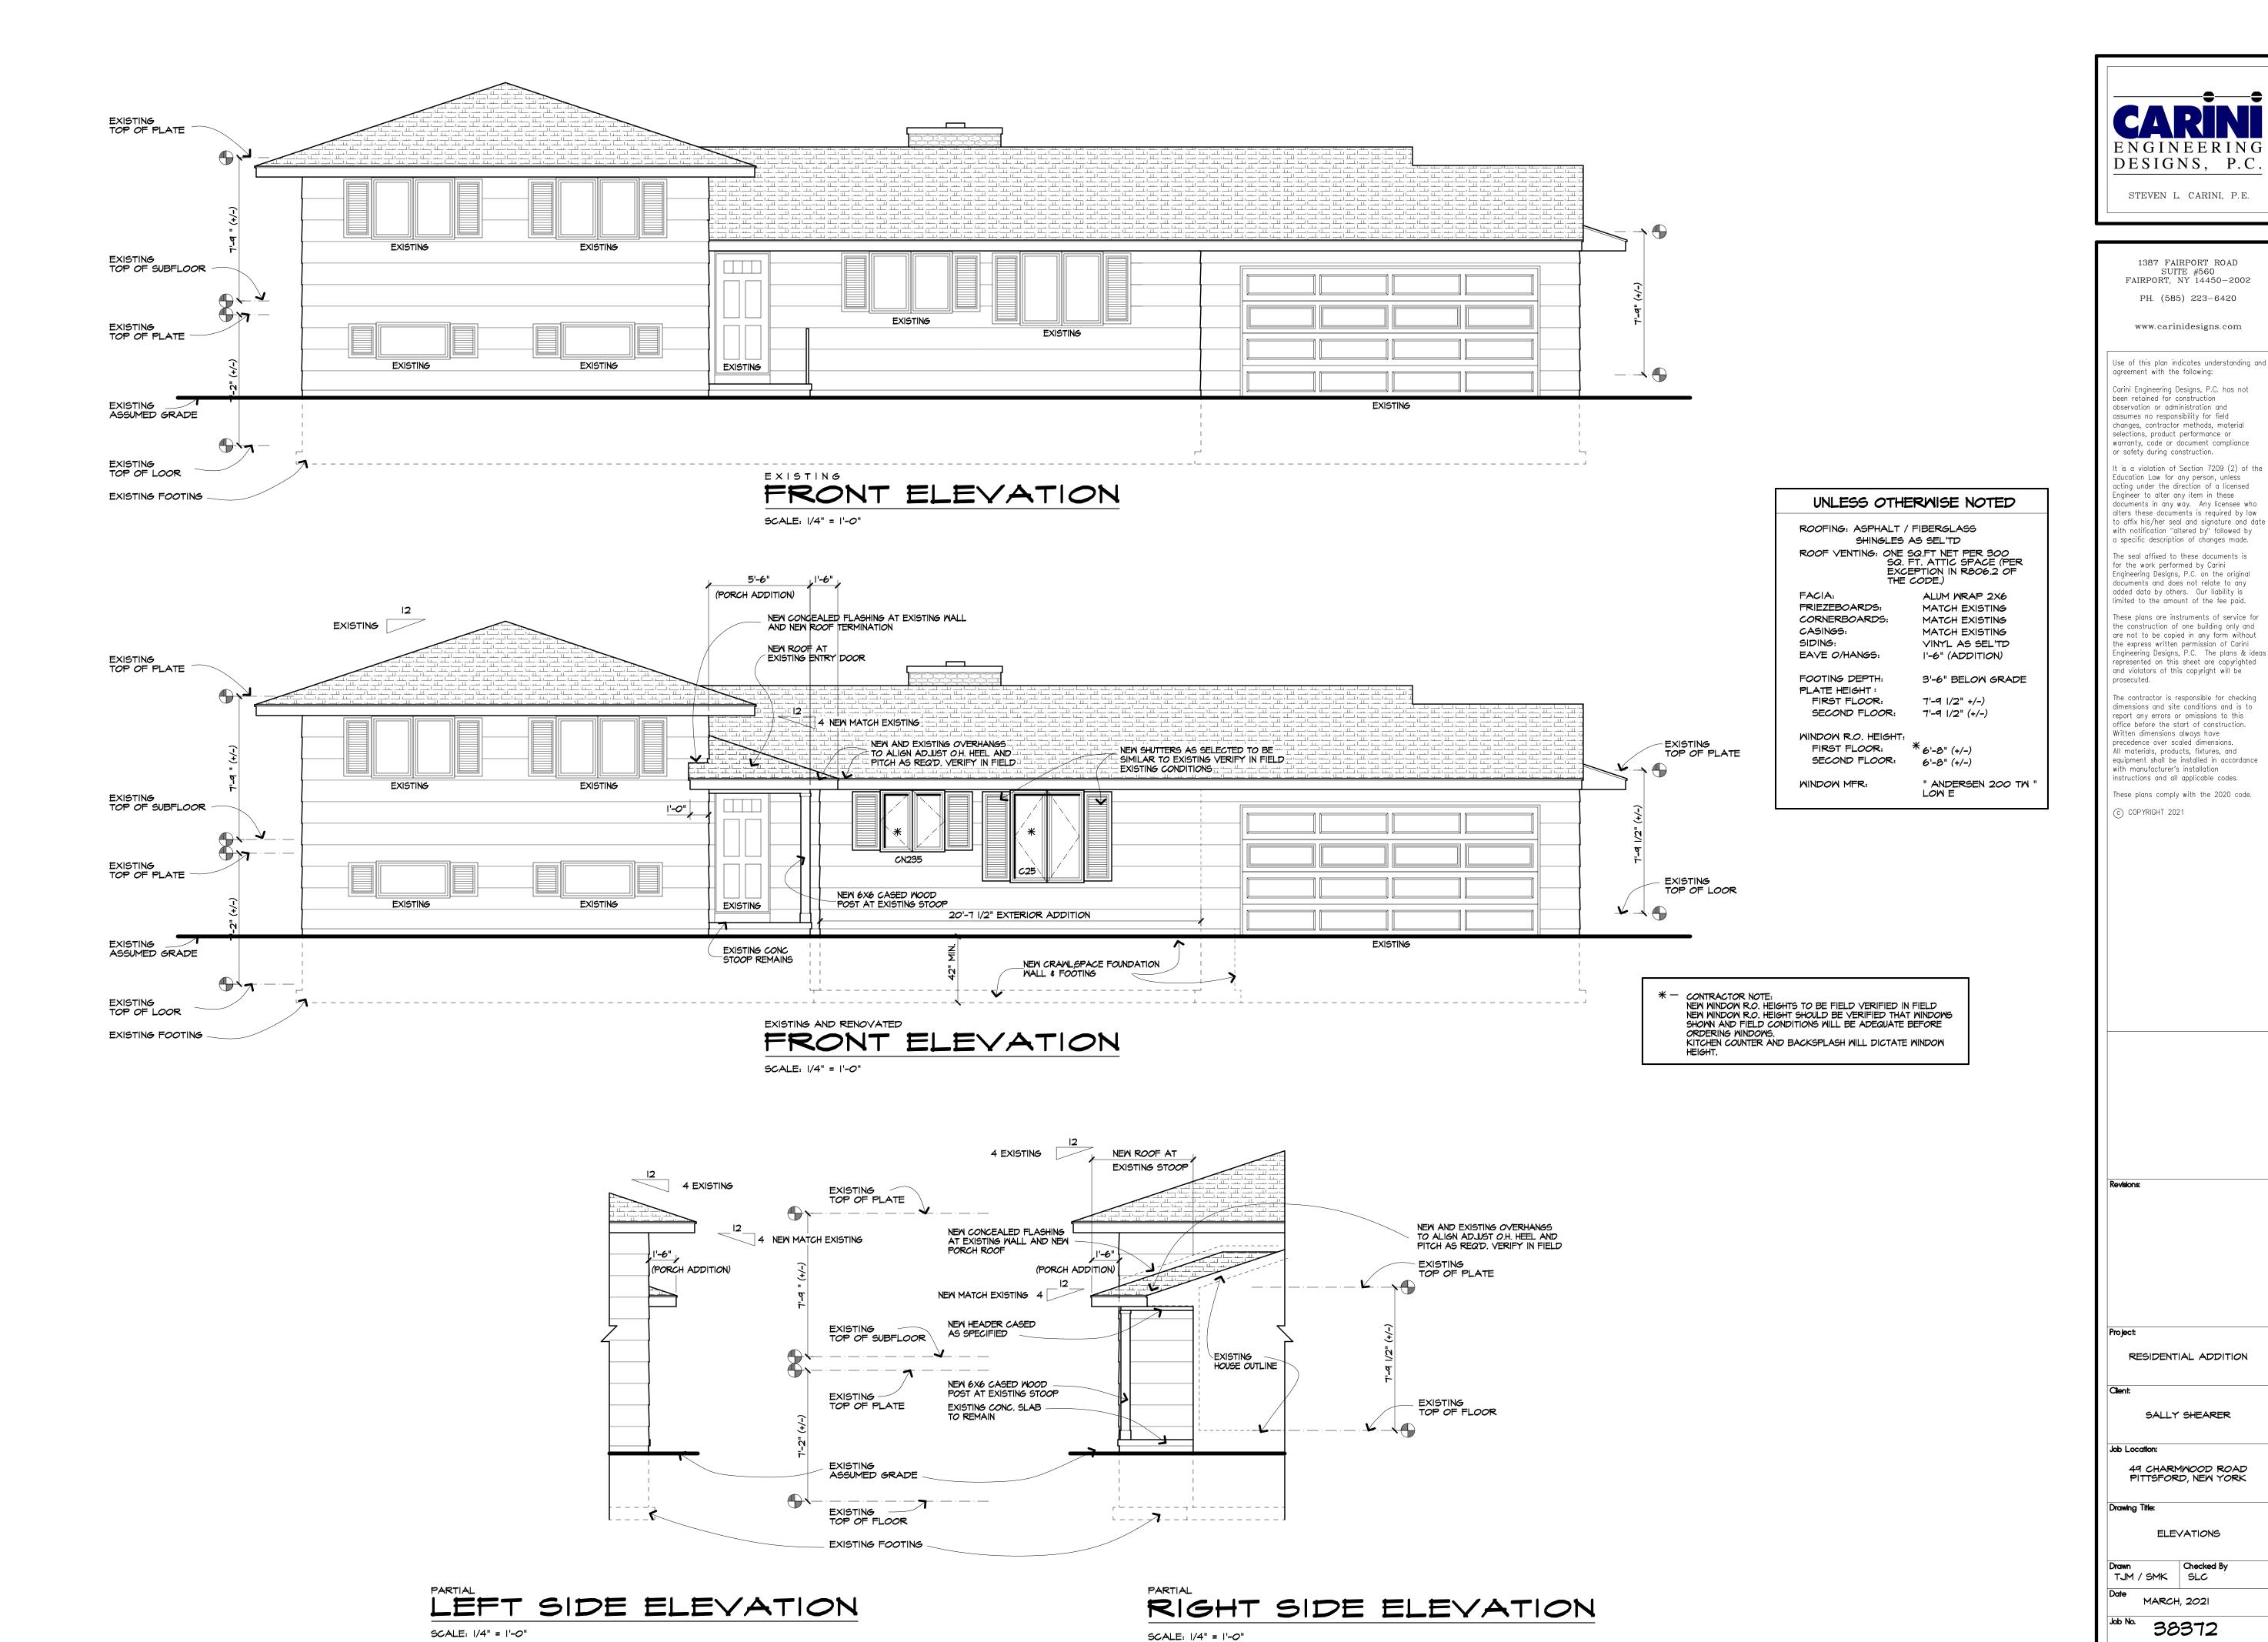

ELEVATIONS

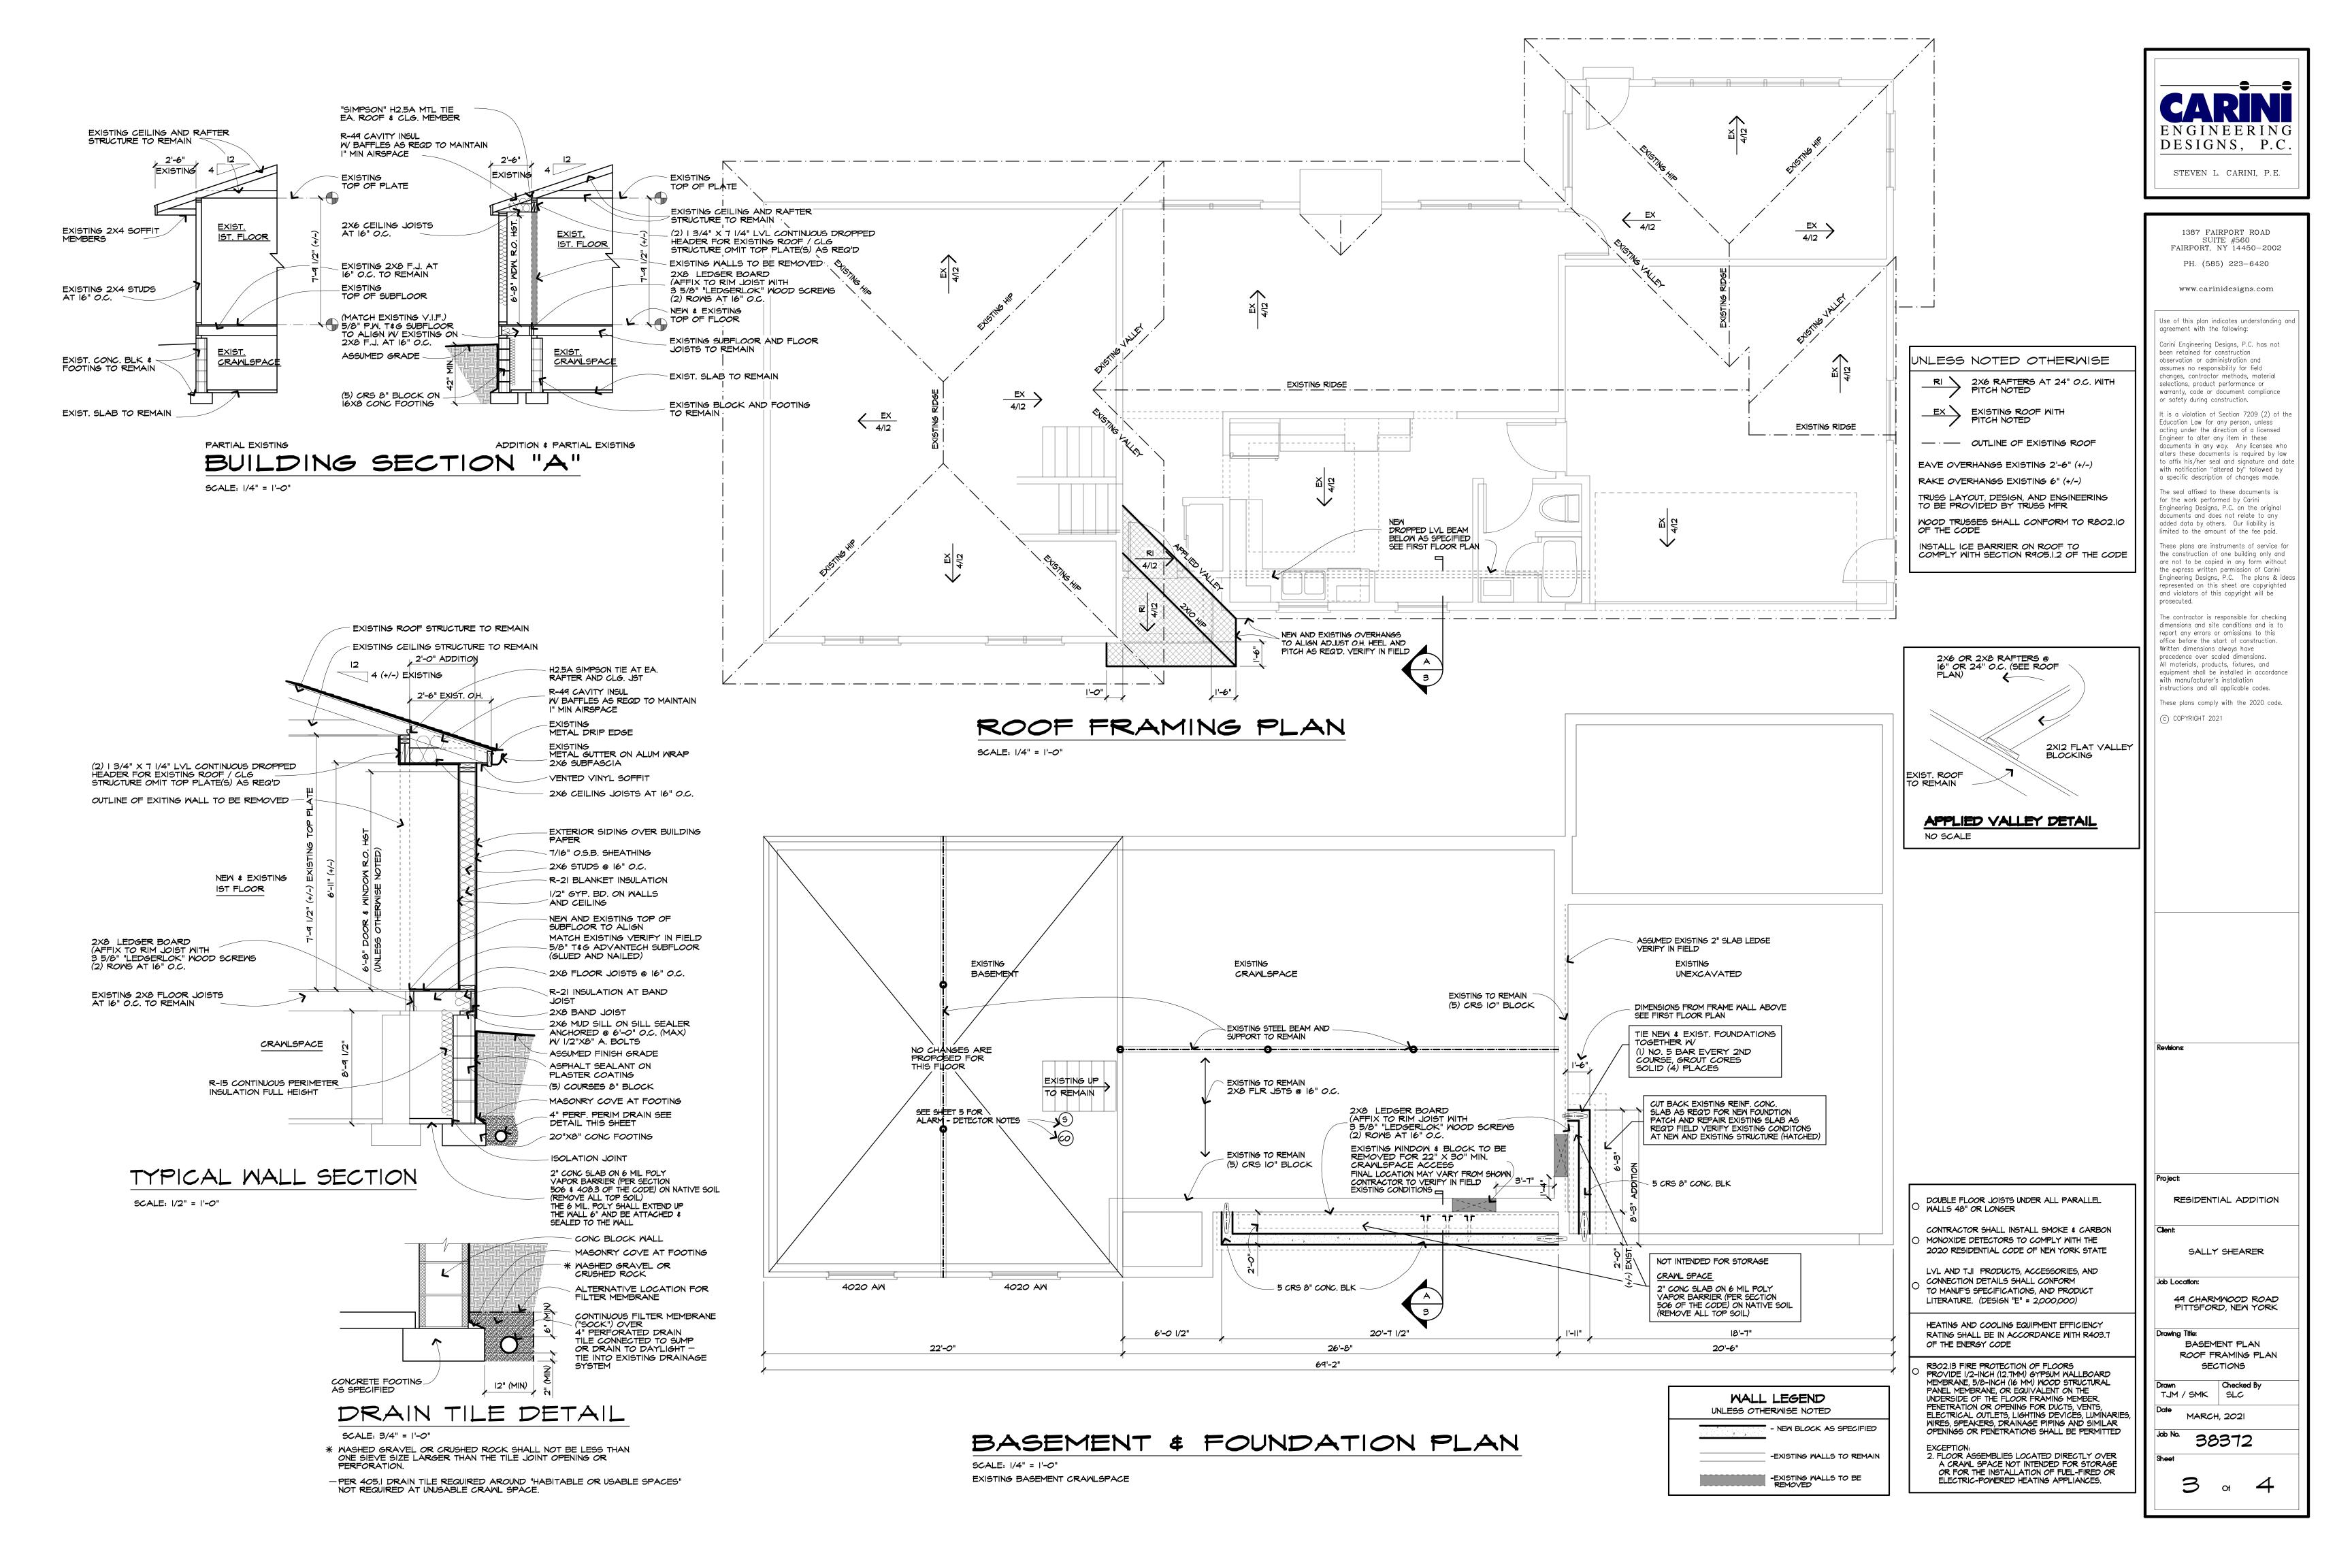

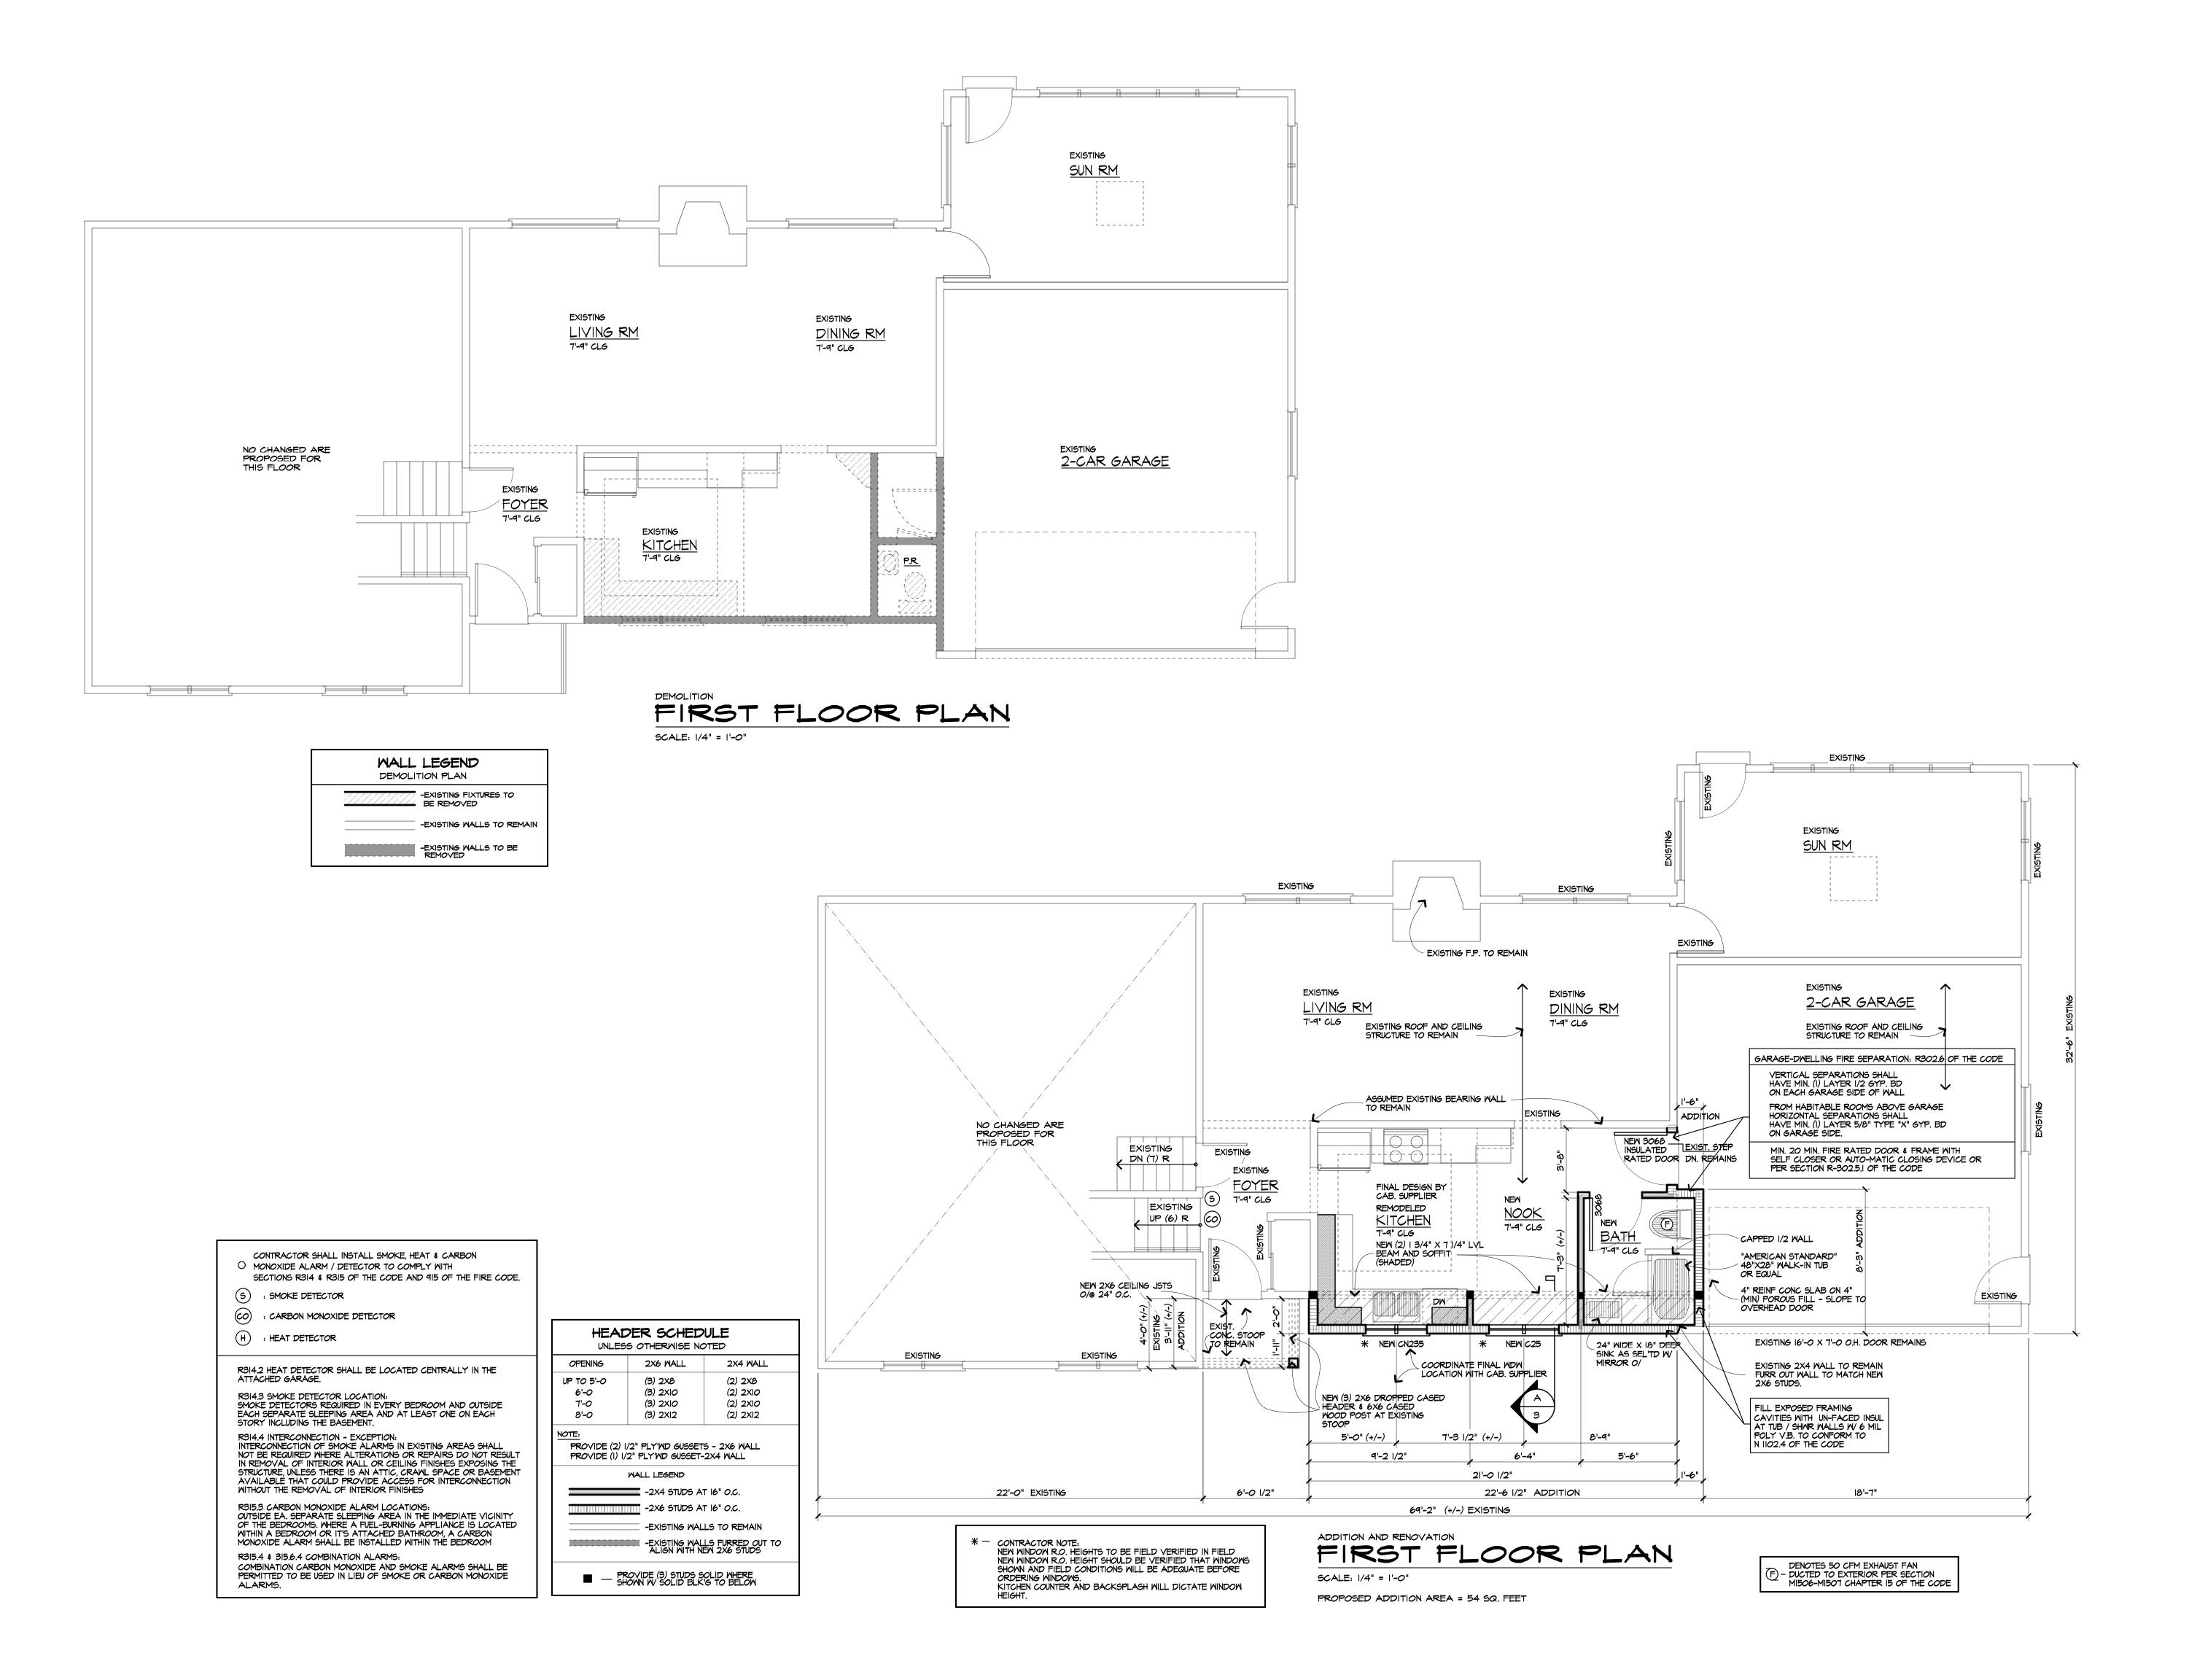



STEVEN L. CARINI, P.E.

1387 FAIRPORT ROAD SUITE #560 FAIRPORT, NY 14450–2002 PH. (585) 223-6420

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RESIDENTIAL ADDITION

SALLY SHEARER

49 CHARMWOOD ROAD PITTSFORD, NEW YORK

Drawing Title:

FIRST FLOOR PLAN

TJM / SMK SLC

MARCH, 2021

38372









Town of Pittsford

Department of Public Works 11 South Main Street Pittsford, New York 14534

Permit # B21-000055

Phone: 585-248-6250 FAX: 585-248-6262

DESIGN REVIEW AND HISTORIC PRESERVATION BOARD REFERRAL OF APPLICATION

Property Address: 640 Mendon Center Road PITTSFORD, NY 14534

Tax ID Number: 191.02-1-22

Zoning District: RRSP Rural Residential South Pittsford

Owner: Sunil Prasad

Applicant: Morton Buildings


Application Type:

אאי	neation type:	
✓	Residential Design Review §185-205 (B)	Build to Line Adjustment §185-17 (B) (2)
	Commercial Design Review §185-205 (B)	Building Height Above 30 Feet §185-17 (M)
	Signage §185-205 (C)	Corner Lot Orientation §185-17 (K) (3)
	Certificate of Appropriateness §185-197	Flag Lot Building Line Location §185-17 (L) (1) (c)
	Landmark Designation §185-195 (2)	Undeveloped Flag Lot Requirements §185-17 (L) (2)
	Informal Review	


Project Description: Applicant is requesting design review for the construction of a one story single family home. The home will be approximately 4104 square feet and located on a large parcel south of the thruway.

Meeting Date: March 25, 2021

RN Residential Neighborhood Zoning

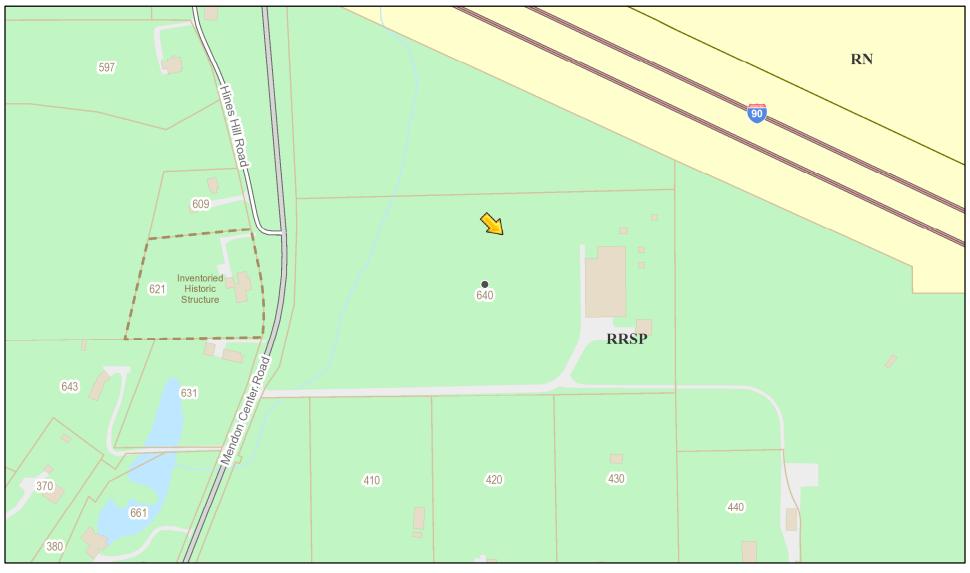


Printed March 18, 2021

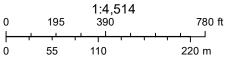

Town of Pittsford GIS

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072-104996


DS GS FAMILY FARM, LLC

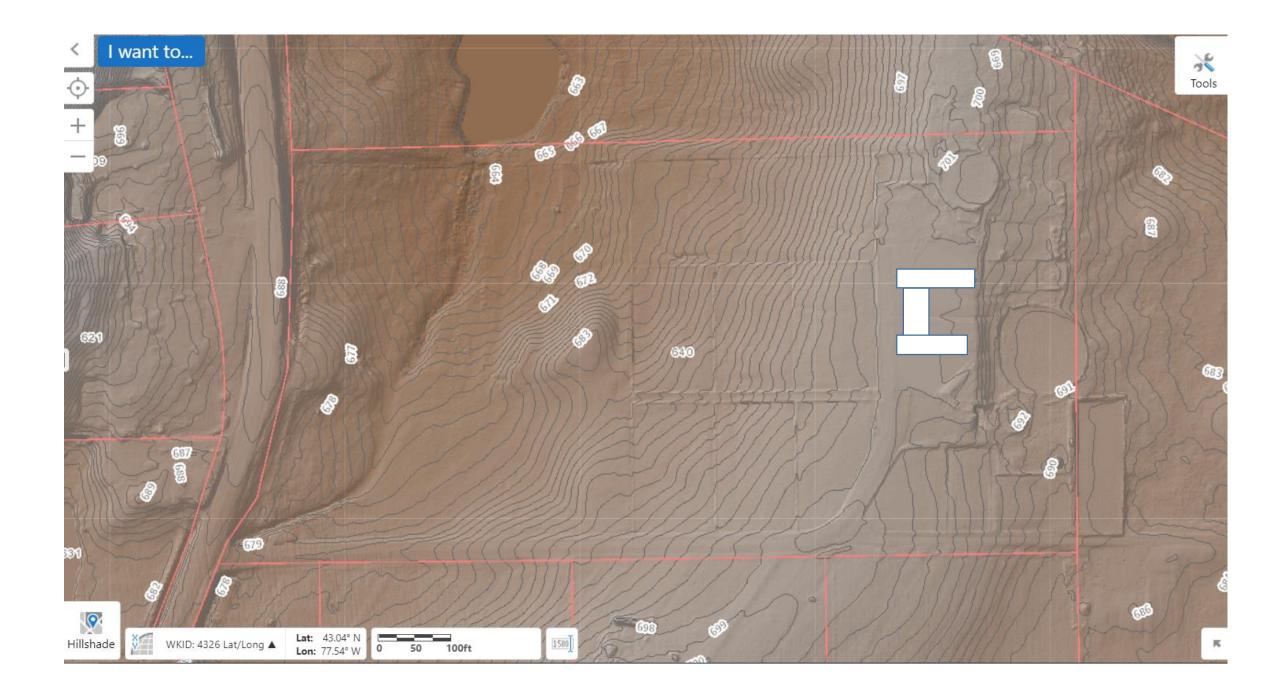DRAWN BY: S. JOHNSON 3/15/2021 CHECKED BY: --DATE: REVISED DATE: --REVISED DATE: --REVISED DATE: --

REVISED DATE: ---

SCALE: AS NOTED SHEET NO.

S2 OF S2

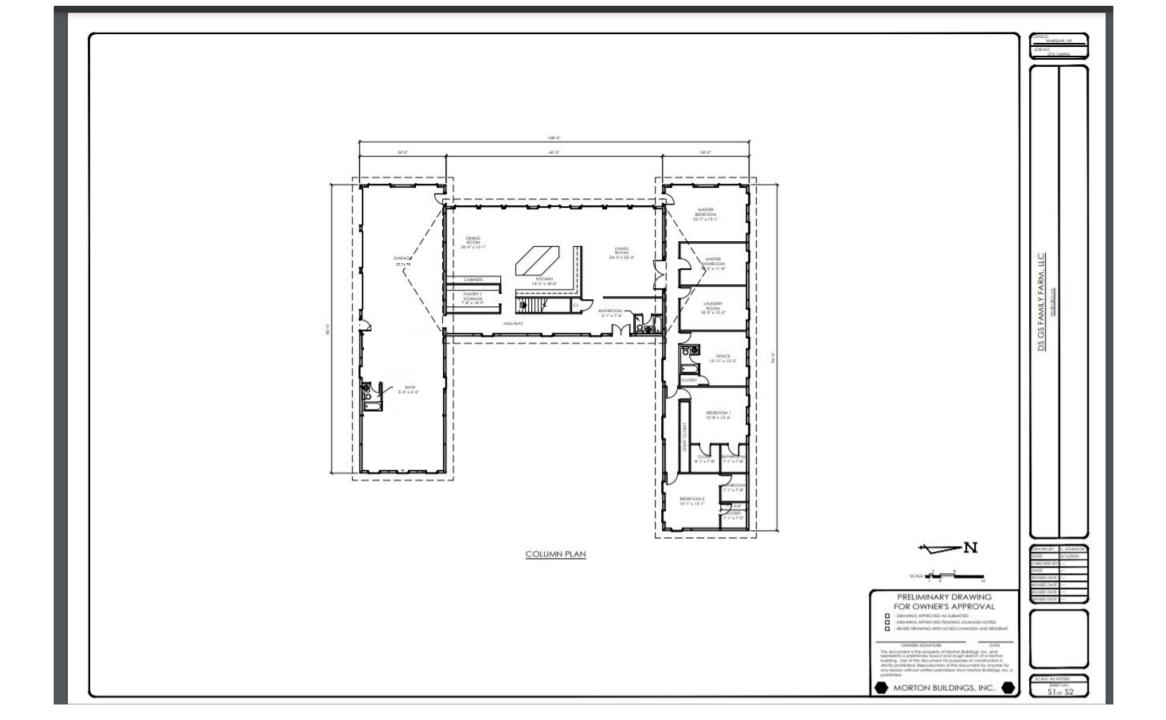

Job: Date: Page:

B072104996 3/16/2021 3 of 7

South and East Walls



Job: Date: Page:


B072104996 3/16/2021 4 of 7

North and West Walls




Job: B072104996 Date: 3/16/2021 Page: 5 of 7

306 36'x14'x60' (#1) Column Plan

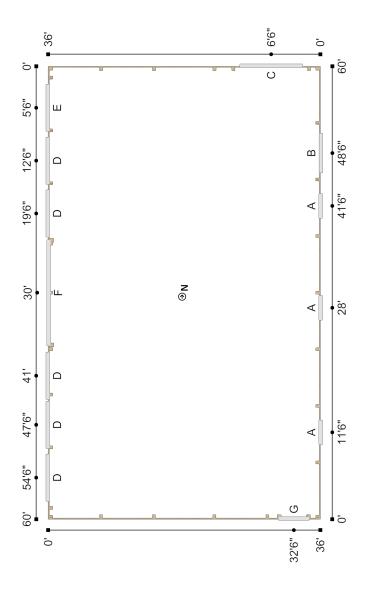


Job: B072104996 Date: 3/16/2021 Page: 6 of 7

306 24'x12'x80' (#2) Column Plan

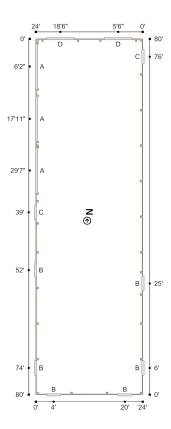

Job: B072104996 Date: 3/16/2021 Page: 7 of 7


306 24'x12'x96' (#3) Column Plan

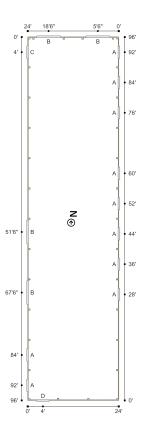







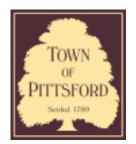

Town of Pittsford

Department of Public Works 11 South Main Street Pittsford, New York 14534

Permit # B21-000052

Phone: 585-248-6250 FAX: 585-248-6262

DESIGN REVIEW AND HISTORIC PRESERVATION BOARD REFERRAL OF APPLICATION

Property Address: 2 Epping Wood Trail PITTSFORD, NY 14534

Tax ID Number: 178.03-3-6.1

Zoning District: RN Residential Neighborhood

Owner: Ketmar Development Corp
Applicant: Ketmar Development Corp

Application Type:


-P P		
✓	Residential Design Review §185-205 (B)	Build to Line Adjustment §185-17 (B) (2)
	Commercial Design Review §185-205 (B)	Building Height Above 30 Feet §185-17 (M)
	Signage §185-205 (C)	Corner Lot Orientation §185-17 (K) (3)
	Certificate of Appropriateness §185-197	Flag Lot Building Line Location §185-17 (L) (1) (c)
	Landmark Designation §185-195 (2)	Undeveloped Flag Lot Requirements §185-17 (L) (2)
	Informal Review	

Project Description: Applicant is requesting design review for the construction of a two story single family home. The home will be approximately 4027 square feet and will be attached to an existing garage. The home will be located in the Malvern Hills Subdivision.

Meeting Date: March 25, 2021





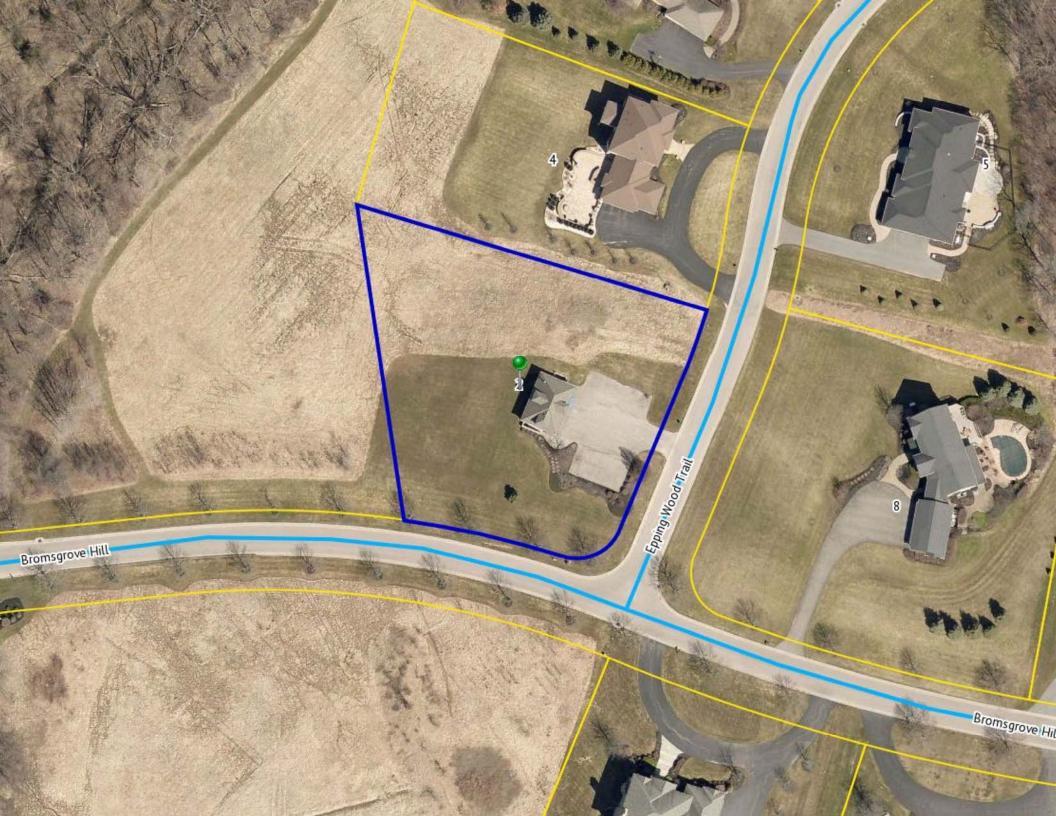

RN Residential Neighborhood Zoning




Town of Pittsford GIS

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REFERENCE(S)

- 1) LIBER 304 OF MAPS, PAGE 12
- 2) LIBER 336 OF MAPS, PAGE 28

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"Only copies from the original of this survey marked with an original of the land surveyor's embossed seal shall be considered to be a valid true copy."

APPROVED BY:

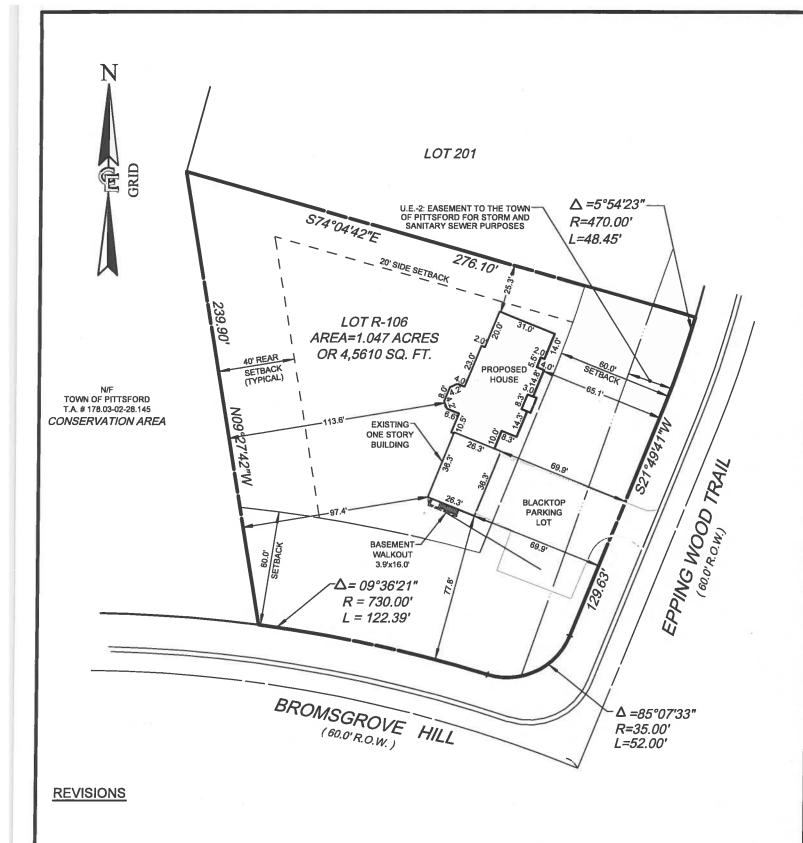DWG FILE: H:\job\892\survey\INST\INST-\frac{\text{SPERCKS}}{\text{DWG}} \text{Wg} \text{PLOTTED: Mor 17, 2021 - 10: 25AM} \text{REAR:}



SITE DATA

PROPOSED UNDER 278

MINIMUM LOT AREA MINIMUM FRONT SETBACK MINIMUM SIDE SETBACK MINIMUM REAR SETBACK (ABUTTING OPEN SPACE) 39,204 sq. ft. (0.9 ACERS)

60 feet 20 feet

= 40 feet MAIN STRUCTURE = 10 feet ACCESSORY STRUCTURE



COSTICH **ENGINEERING** Civil **ENGINEERING**

LAND SURVEYING

 LANDSCAPE ARCHITECTURE

217 LAKE AVENUE ROCHESTER, NY 14608 (585) 458-3020

PLOT PLAN

MALVERN HILLS SECTION ONE

LOT NUMBER

106

PITTSFORD

SUBDIVISION:


COUNTY **MONROE**

STATE **NEW YORK**

SCALE: DATE: 1"=50" MARCH 17, 2001 DWG. NUMBER 892-106

GENERAL NOTES:

- THESE PLANS HAVE BEEN PREPARED TO THE BEST OF THE ARCHITECT'S KNOWLEDGE, BELIEF, AND PROFESSIONAL JUDGMENT IN ACCORDANCE WITH THE 2020 RESIDENTIAL CODE OF NEW YORK STATE AND ENERGY CONSERVATION CODE REQUIREMENTS. THE CONTRACTOR SHALL BE RESPONSIBLE FOR ADAPTING THESE PLANS, IF REQUIRED, TO SUIT THE NEEDS OF THE BUILDING ON THE SITE. PROVIDED THAT THE ALTERATIONS DO NOT VIOLATE THE CODE OR ALTER THE STRUCTURAL INTEGRITY OF THE BUILDING.
- THE CONTRACTOR SHALL BE RESPONSIBLE FOR COMPLIANCE WITH ALL APPLICABLE BUILDING/ELECTRICAL/MECHANICAL/SANITARY AND ENERGY CODES; STATE OR LOCAL. THE CONTRACTOR SHALL BE RESPONSIBLE FOR COMPLIANCE WITH THE ENERGY CONSERVATION CODE FOR ALL HVAC EQUIPMENT, HVAC CONTROLS, WATER HEATING EQUIPMENT, PIPE AND DUCT INSULATION, AND FLUORESCENT LAMPS AND BALLASTS.
- THE CONTRACTOR SHALL BE RESPONSIBLE SO THAT BRANDS OF WINDOWS AND DOORS INSTALLED MEET THE NEW YORK STATE ENERGY CONSERVATION CODE REQUIREMENTS. WINDOWS AND / OR DOORS SHOWN ARE INDICATED FOR SIZING ONLY.
- ALL FOOTINGS SHALL REST ON UNDISTURBED VIRGIN SOIL. THE FOOTING/FOUNDATION DESIGN ASSUMES MINIMUM SOIL BEARING PRESSURE TO BE 2000 PSF. CONTRACTOR SHALL BE RESPONSIBLE FOR ALL SUBGRADE CONDITIONS. IF REQUIRED, THE OWNER AND / OR CONTRACTOR SHALL BE RESPONSIBLE FOR HIRING A SOILS ENGINEER TO VERIFY SUBGRADE CONDITIONS AND SUBSTANTIATE ACTUAL BEARING CAPACITY.
- BACKFILL MATERIALS SHALL BE NATIVE SOIL. FOR FILL UNDER THE GARAGE FLOOR OR BASEMENT FLOOR, PROVIDE SAND/ GRAVEL FILL FOR COMPACTION AS NEEDED
- MINIMUM CONCRETE COMPRESSIVE STRENGTH:
- 2500 PSI FOOTINGS 2500 PSI FLOOR SLABS 3500 PSI GARAGE
- CONCRETE BLOCK SHALL CONFORM TO ASTM C90 N-I, WALL REINFORCING ASTM A82. ALL MORTAR SHALL CONFORM TO ASTM C270, TYPE S - I PART PORTLAND CEMENT, I/4 PART
- STRUCTURAL STEEL SHALL CONFORM TO ASTM A36. SHOP-PRIME PAINT TT-P-20, TT-P-3IC, TT-P-86. FABRICATION AND INSTALLATION PER THE LATEST EDITION OF THE AISC
- MINIMUM FIBER STRESS IN BENDING (FB) FOR ALL FRAMING LUMBER TO BE 1150 PSI #2 HEM-FIR OR BETTER. PROVIDE DOUBLE FRAMING MEMBERS UNDER PARTITIONS RUNNING IN
- CONTRACTOR SHALL PAY STRICT ADHERENCE TO MICROLAM MANUFACTURER'S WRITTEN DIRECTIONS FOR CUTTING, DRILLING, NOTCHING, JOINING AND GENERAL INSTALLATION OF
- WOOD TRUSSES SHALL BE DESIGNED BY MANUFACTURER. SUPPLIER SHALL BE RESPONSIBLE FOR INSTALLATION DETAILS
- PLYWOOD SHALL CONFORM TO U.S. PRODUCT STANDARD PS I, THICKNESS AS SHOWN, APA RATED SHEATHING EXP-1. NAILING AND SPACING PER APA RECOMMENDATIONS FOR
- ALL WOOD IN CONTACT WITH CONCRETE OR MASONRY SHALL BE FULLY WOOD PRESERVATIVE-TREATED WITH OSMOSALTS OR WOLMAN SALTS.
- ALL OPENINGS IN THE BUILDING ENVELOPE (DOORS, WINDOWS, UTILITIES) SHALL BE CAULKED, WEATHER-STRIPPED, OR OTHERWISE SEALED. CORROSION RESISTIVE FLASHING SHALL BE PROVIDED AT THE LOCATIONS ON THE EXTERIOR WALL ENVELOPE PER RESIDENTIAL CODE OF NEW YORK (2020)
- CONTRACTOR SHALL VERIFY ALL NOTES AND DIMENSIONS PRIOR TO CONSTRUCTION. THESE DRAWINGS ARE NOT TO BE SCALED - USE DIMENSIONS GIVEN.
- CONTRACTOR SHALL BE RESPONSIBLE FOR ALL CONSTRUCTION MEANS, METHODS, TECHNIQUES, SEQUENCES AND SAFETY PRECAUTIONS IN CONNECTION WITH THE WORK
- THESE DRAWINGS HAVE BEEN PREPARED FOR STRUCTURAL INTENT ONLY. ELECTRICAL, MECHANICAL AND OTHER BUILDING SYSTEMS, AS REQUIRED ARE TO BE DESIGNED BY OTHERS.
- THE FOLLOWING DESIGN LOADS HAVE BEEN USED IN THE STRUCTURES DESIGN IN ACCORDANCE WITH THE PRINTED SPAN TABLES IN THE RESIDENTIAL CODE OF NEW YORK STATE (2020). FLOOR LOADS (LIVING AREAS-IST FLOOR) 30 PSF SLEEPING AREAS (2ND FLOOR) EXTERIOR DECKS
- ALL WORK, MATERIALS, METHODS, EQUIPMENT, ETC. SHALL BE IN STRICT ACCORDANCE WITH THE CONTRACT DOCUMENTS. ALL MATERIALS SHALL BE NEW, UNLESS NOTED OTHERWISE.
- MORK SEQUENCE AND SCHEDULE SHALL BE MUTUALLY AGREED UPON BY BOTH THE OWNER AND THE CONTRACTOR.
- IT IS ASSUMED THAT THE SUBSURFACE CONDITIONS WILL BE EARTH OR SOIL. IF BEDROCK IS ENCOUNTERED, REMOVAL WILL BE CONSIDERED AN ADDITION TO CONTRACT.
- ANY DEMOLITION WORK SHALL BE DONE CAREFULLY. ALL DISTURBED SURFACES TO BE REPAIRED APPROPRIATELY. ALL SALVAGEABLE ITEMS SHALL BE TURNED OVER TO THE OWNER.
- EXAMINATION OF THE SITE SHOULD BE MADE BY ALL CONTRACTORS CONCERNED TO FULLY CONSIDER ALL SITE CONDITIONS WHICH MAY HAVE A BEARING ON THE WORK OF THE ENTIRE PROJECT. SUBMISSION OF A BID IS PRESUMPTIVE EVIDENCE THAT THE BIDDER IS CONVERSANT WITH LOCAL JURISDICTIONS AND HAS MADE DUE ALLOWANCES IN HIS BID FOR ALL CONTINGENCIES. THE OWNER RESERVES THE RIGHT TO REJECT ANY OR ALL BIDS.
- 24. IT IS THE RESPONSIBILITY OF THE CONTRACTOR TO NOTIFY THE ARCHITECT IN CASE OF ANY OR ALL DEVIATIONS FROM THESE DRAWINGS. THE ARCHITECT SHALL BE HELD HARMLESS AS A RESULT OF ANY UNAUTHORIZED CHANGES TO THESE PLANS. ADDITIONAL FEES MAY OCCUR FOR "AS BUILT" DOCUMENTATION DUE TO CIRCUMSTANCES BEYOND THE ARCHITECT'S CONTROL, OR OWNER / CONTRACTOR CHANGES
- THE CONTRACTOR SHALL OBTAIN AND PAY FOR ALL PERMITS AND APPROVALS REQUIRED BY THE LOCAL ZONING AND BUILDING DEPARTMENTS AND ANY OTHER GOVERNMENTAL AGENCY HAVING JURISDICTION OVER THE WORK. ALL APPLICABLE REGULATIONS SHALL BE ADHERED TO AND CARRIED OUT BY ALL INDIVIDUALS UNDER THIS CONTRACT.
- THE CONTRACTOR SHALL FURNISH A CERTIFICATE OF INSURANCE INDICATING THE TYPE AND AMOUNTS OF COVERAGE AS REQUIRED BY NEW YORK STATE AND THE LOCAL MUNICIPALITY.
- THE CONTRACTOR SHALL REMOVE ALL RUBBISH AND LEAVE THE COMPLETED PROJECT IN A CLEAN STATE, SATISFACTORY TO THE OWNER.
- THE CONTRACTOR SHALL GUARANTEE HIS WORK AND HIS SUBCONTRACTOR'S WORK AGAINST FAULTY MATERIALS AND WORKMANSHIP IN ACCORDANCE WITH NEW YORK STATE GENERAL BUSINESS LAW.
- ONLY COPIES FROM THE ORIGINALS OF THESE DRAWINGS MARKED WITH AN ORIGINAL OF THE ARCHITECT'S
- WET SEAL SHALL BE CONSIDERED TO BE VALID TRUE COPIES. 30. BUILDING IS CLASSIFIED AS A ONE FAMILY DWELLING
- SMOKE-DETECTING ALARM DEVICES SHALL BE INSTALLED IN COMPLIANCE WITH SECTION R314.3 OF THE RESIDENTIAL CODE OF NEW YORK STATE (2020) CARBON MONOXIDE ALARM DEVICES SHALL BE INSTALLED IN COMPLIANCE WITH SECTION 915 FCNYS
- PROVIDE A MIN. 3/4 HR. FIRE SEPARATION PER SECTION R309.2 OF THE RESIDENTIAL CODE OF NEW YORK STATE (2020) ALL WALLS AND FLOORS DEMISING RESIDENCE FROM AN ATTACHED GARAGE
- ALL MATERIALS USED IN THIS PROJECT SHALL BE NON-ASBESTOS AND NON-LEAD CONTAINING.

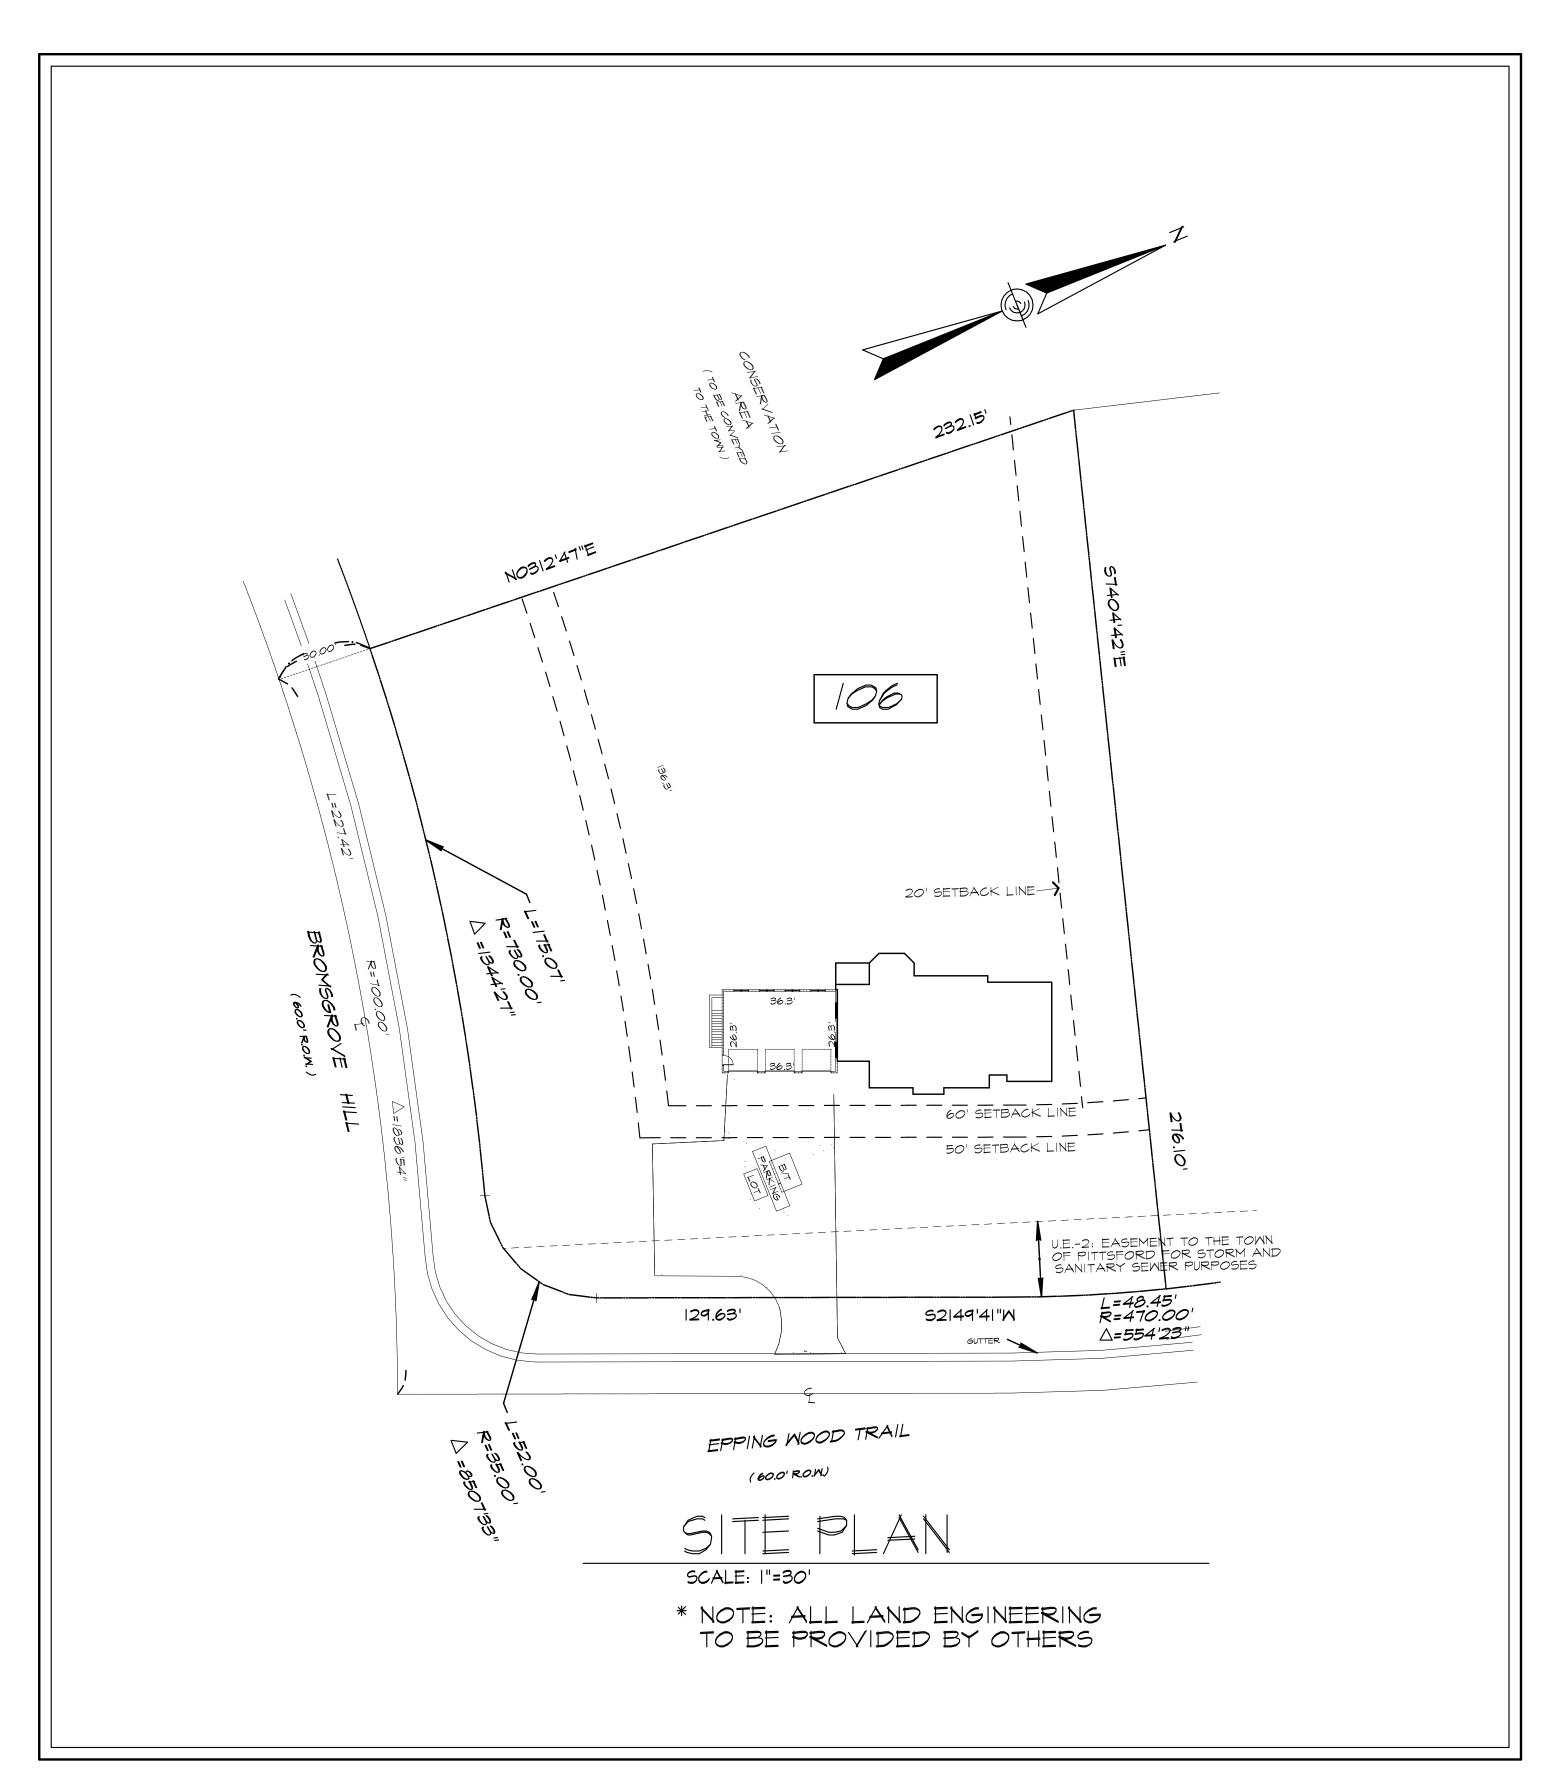

KETONIS RESIDENCE

LOT 106 MALVERN HILLS

KETMAR DEVELOPMENT CORP

DRAWING INDEX

1	TITLE PAGE
2	FRONT ELEVATION
3	LEFT & RIGHT SIDE ELEVATIONS
4	REAR ELEVATION
5	BASEMENT & FOUNDATION PLAN
5a	FINISHED BASEMENT PLAN
6	FIRST FLOOR PLAN
7	SECOND FLOOR PLAN
8	ROOF PLAN
9	BUILDING SECTIONS
10	BUILDING SECTIONS
11	BUILDING SECTIONS
12	WALL SECTION & TYPICAL DETAILS

ENERGY COMPLIANCE DETAILS & PATH

MEETS OR EXCEEDS PRESCRIPTIVE REQUIREMENTS R402.1.2 (2020 RESIDENTIAL CODE OF NEW YORK STATE) CLIMATE ZONE - 5

COMPONENT	REQUIRED	PROVIDED
I. FENESTRATION U-FACTOR	.30	.30
2. CEILING R-FACTOR	49	49
3. WOOD FRAME WALL R-VALUE	20 OR 13+5	HIGH DENSITY 21 21/BAND JSTS
4. FLOOR R-FACTOR	R-30	R-30
5. BASEMENT CONCRETE WALL R-VALUE	15 CONTINUOUS OR 19 CAVITY FULL HEIGHT	R-15 CONTINUOUS FULL HEIGHT
6. SLAB R-FACTOR	R-10@24" R-5 SLAB EDGE	R-I <i>0</i> @24" R-5 SLAB <i>EDG</i> E
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2020 INTERNATIONAL ENERGY CONSERVATION CODE (IECC) COMPLIANCE PATH

- I. A MINIMUM OF 75% OF THE LAMPS IN PERMANENTLY INSTALLED LIGHTING FIXTURES SHALL BE HIGH-EFFICIENCY LAMPS PER SECTION 1104.1
- 2. RECESSED LUMINARIES INSTALLED IN THE BUILDING THERMAL ENVELOPE SHALL BE SEALED WITH A GASKET OR CAULK BETWEEN THE HOUSING AND THE INTERIOR WALL OR CEILING COVERING TO LIMIT AIR LEAKAGE BETWEEN CONDITIONED AND UNCONDITIONED SPACES. PER SECTION 1102.4.5
- 3. CONTRACTOR TO PROVIDE A PROGRAMMABLE THERMOSTAT TO CONTROL THE HVAC SYSTEM PER SECTION 1103.1.1
- 4. ALL CIRCULATING SERVICE HOT WATER PIPING SHALL BE INSULATED TO AT LEAST R-2. CIRCULATION HOT WATER SYSTEMS SHALL INCULDE AN AUTOMATIC OR READILY ACCESSIBLE MANUAL SWITCH THAT CAN TURN OFF THE HOT WATER CIRCULATING PUMP WHEN THE SYSTEM IS NOT IN USE. PER SECTION 1103.3.4
- 5. AIR LEAKAGE TEST TO BE CONDUCTED & PERFORMED BY A THIRD PARTY IN COMPLIANCE WITH 1102.4.1.2. AIR LEAKAGE RATE MAY NOT EXCEED 3 ACH (CLIMATE ZONE 5)
- 6. ATTIC ACCESS SHALL BE INSULATED WITH THE SAME R-VALUE AS THE ATTIC, WEATHER STRIPPED AND LATCHED PER SECTION 1102.2.3
- 7. DUCTWORK ON EXTERIOR WALLS IF REQUIRED SHALL BE INSULATED TO A MINUMUM OF R-6 PER 1103.2.1
- 8. MECHANICAL VENTILATION PER SECTION NIIO3.6 TO BE MET WITH CONTINUOUS USE EXHAUST FANS AND MAKE-UP AIR CONTROLS, PER SECTION MI507.3.3 REQUIREMENT.
- 9. MECHANICAL VENTILATION FAN EFFICACY SHALL MEET MINIMUM REQUIREMENTS PER SECTION NIIO3.6.1.
- IO. HEATING AND COOLING EQUIPMENT SHALL BE SIZED IN ACCORDANCE WITH SECTION NIIO3.7 REQUIREMENTS.

BASIC DESIGN CRITERIA

- I. GROUND SNOW LOAD 40 PSF
- 2. WIND SPEED 115 MPH, EXPOSURE B R301.2.1
- 3. SEISMIC DESIGN CATEGORY A R301.2 (2)
- 4. WEATHERING SEVERE
- 5. FROST LINE DEPTH 48"
- 6. TERMITE DAMAGE NONE TO SLIGHT
- 7. DECAY DAMAGE NONE TO SLIGHT
- 8. WINTER DESIGN TEMPERATURE -
- 9. ICE SHIELD UNDERLAYMENT REQUIRED YES
- 10. FLOOD HAZARD FIRM 1992
- II. ROOF TIE DOWN REQUIREMENTS R802.II.I



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MARCH 16, 2021

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KETONIS RESIDENCE LOT 106 MALVERN HILLS

CLIENT:

KETMAR DEVELOPMENT CORP

DRAWING:

CHECKED: AIAMLA MARCH 2021

SCALE: 1/4"=1'-0"

JOB NO.:

SHEET:

12 SHEETS





UNLESS OTHERWISE NOTED

ROOFING: 25 YR GUARANTEE ASPHALT SHINGLES

ROOF VENTING: CONTINUOUS RIDGE VENT

FASCIAS: 8" FRIEZEBDS: 8"

CORNERBDS: N/A

Casings: 6"

SIDING: HORIZ, AS SELECTED

OVERHANGS: 16"

RAKE OVERHANGS: N/A MIN FTG. DEPTH: 4'-0"

CLG HT: IST FLOOR: 10'-1 1-8"

2ND FLOOR: 8'-1 1/8"

MINDOM UNIT HT.

IST FLOOR: 7'-0"

2ND FLOOR: 7'-0"

WINDOW MFR: AS SELECTED (PROVIDE SAFETY GLAZING PER R.308.4)



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KETONIS RESIDENCE LOT 106 MALVERN HILLS

KETMAR DEVELOPMENT CORP

DRAWING:

FRONT ELEVATION

CHECKED:


AIAMLA DATE: MARCH 2021

SCALE: 1/4"=1'-0"

JOB NO.:

SHEET:



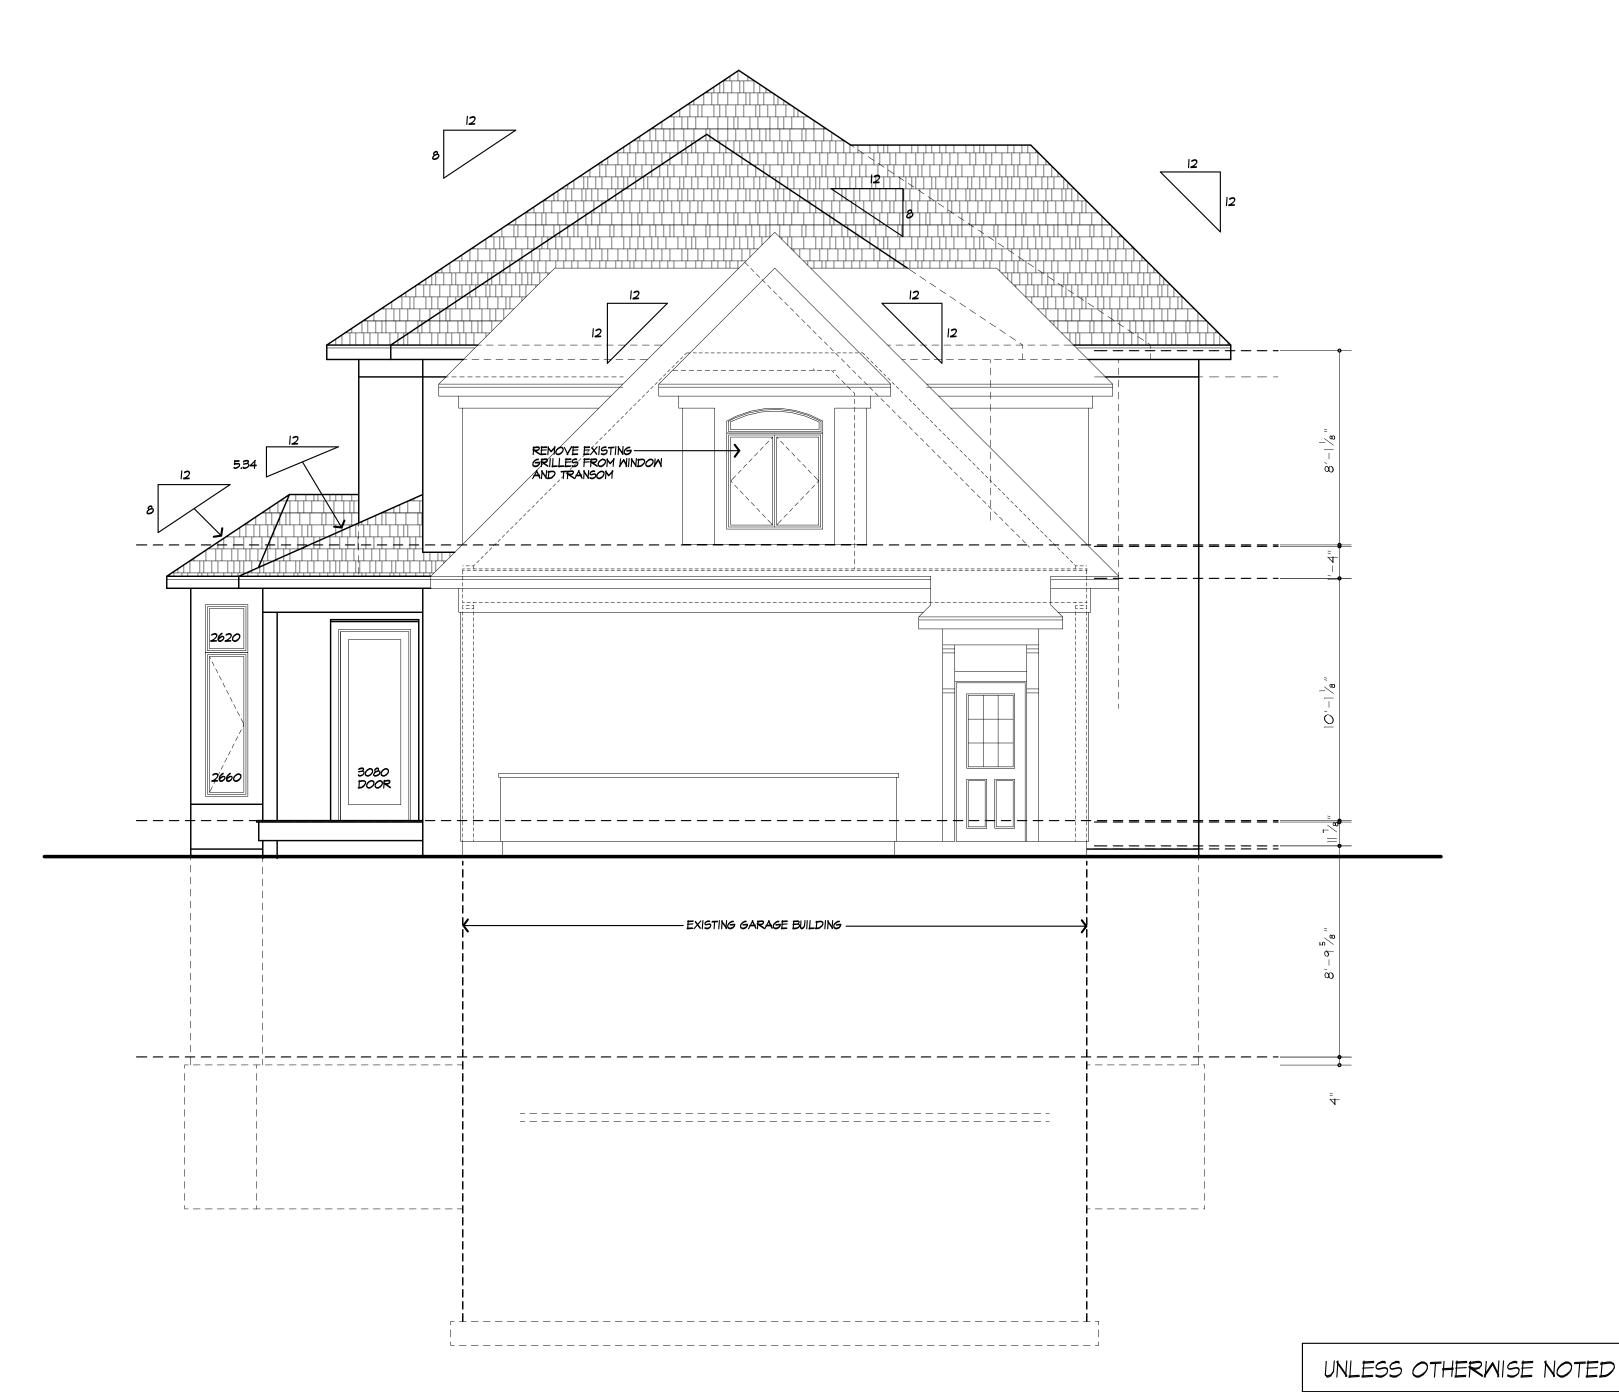

-----2620 ------

LEFT SIDE ELEVATION

ROOFING: 25 YR GUARANTEE ASPHALT SHINGLES

ROOF VENTING: CONTINUOUS RIDGE VENT

FASCIAS: 8"

FRIEZEBDS: 8"

CORNERBDS: N/A

CASINGS: 6"

SIDING: HORIZ, AS SELECTED

OVERHANGS: 16"

RAKE OVERHANGS: N/A

MIN FTG. DEPTH: 4'-0"

CLG HT:

IST FLOOR: 10'-1 1-8"

2ND FLOOR: 8'-1 1/8"

WINDOW UNIT HT.

IST FLOOR: 1'-0"

2ND FLOOR: 7'-0"

WINDOW MFR: AS SELECTED
(PROVIDE SAFETY GLAZING PER R.308.4)

RIGHT SIDE ELEVATION



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PROJECT:
KETONIS RESIDENCE
LOT 106 MALVERN HILLS

CLIENT:

KETMAR DEVELOPMENT CORP

DRAWING:

LEFT/ RIGHT SIDE ELEVATIONS

DRAWN: CHECKED:

PJMAIA X

DATE: MARCH 2021

SCALE: 1/4"=1'-0"

JOB NO.: 20M3976


SHEET:

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PROJECT:
KETONIS RESIDENCE
LOT 106 MALVERN HILLS

CLIENT:

KETMAR DEVELOPMENT CORP

DRAWING:
REAR ELEVATION

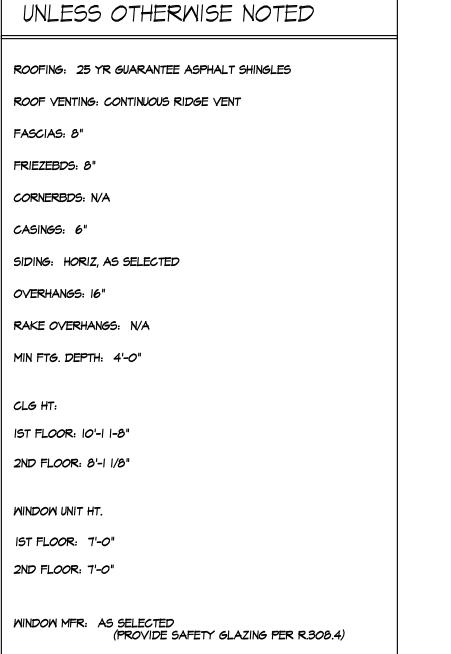DRAWN: CHECKED:

PJMAIA X

DATE: MARCH 2021

SCALE: 1/4"=1'-0"


JOB NO.: 20M3976

SHEET:

4

OF 12 SHEE



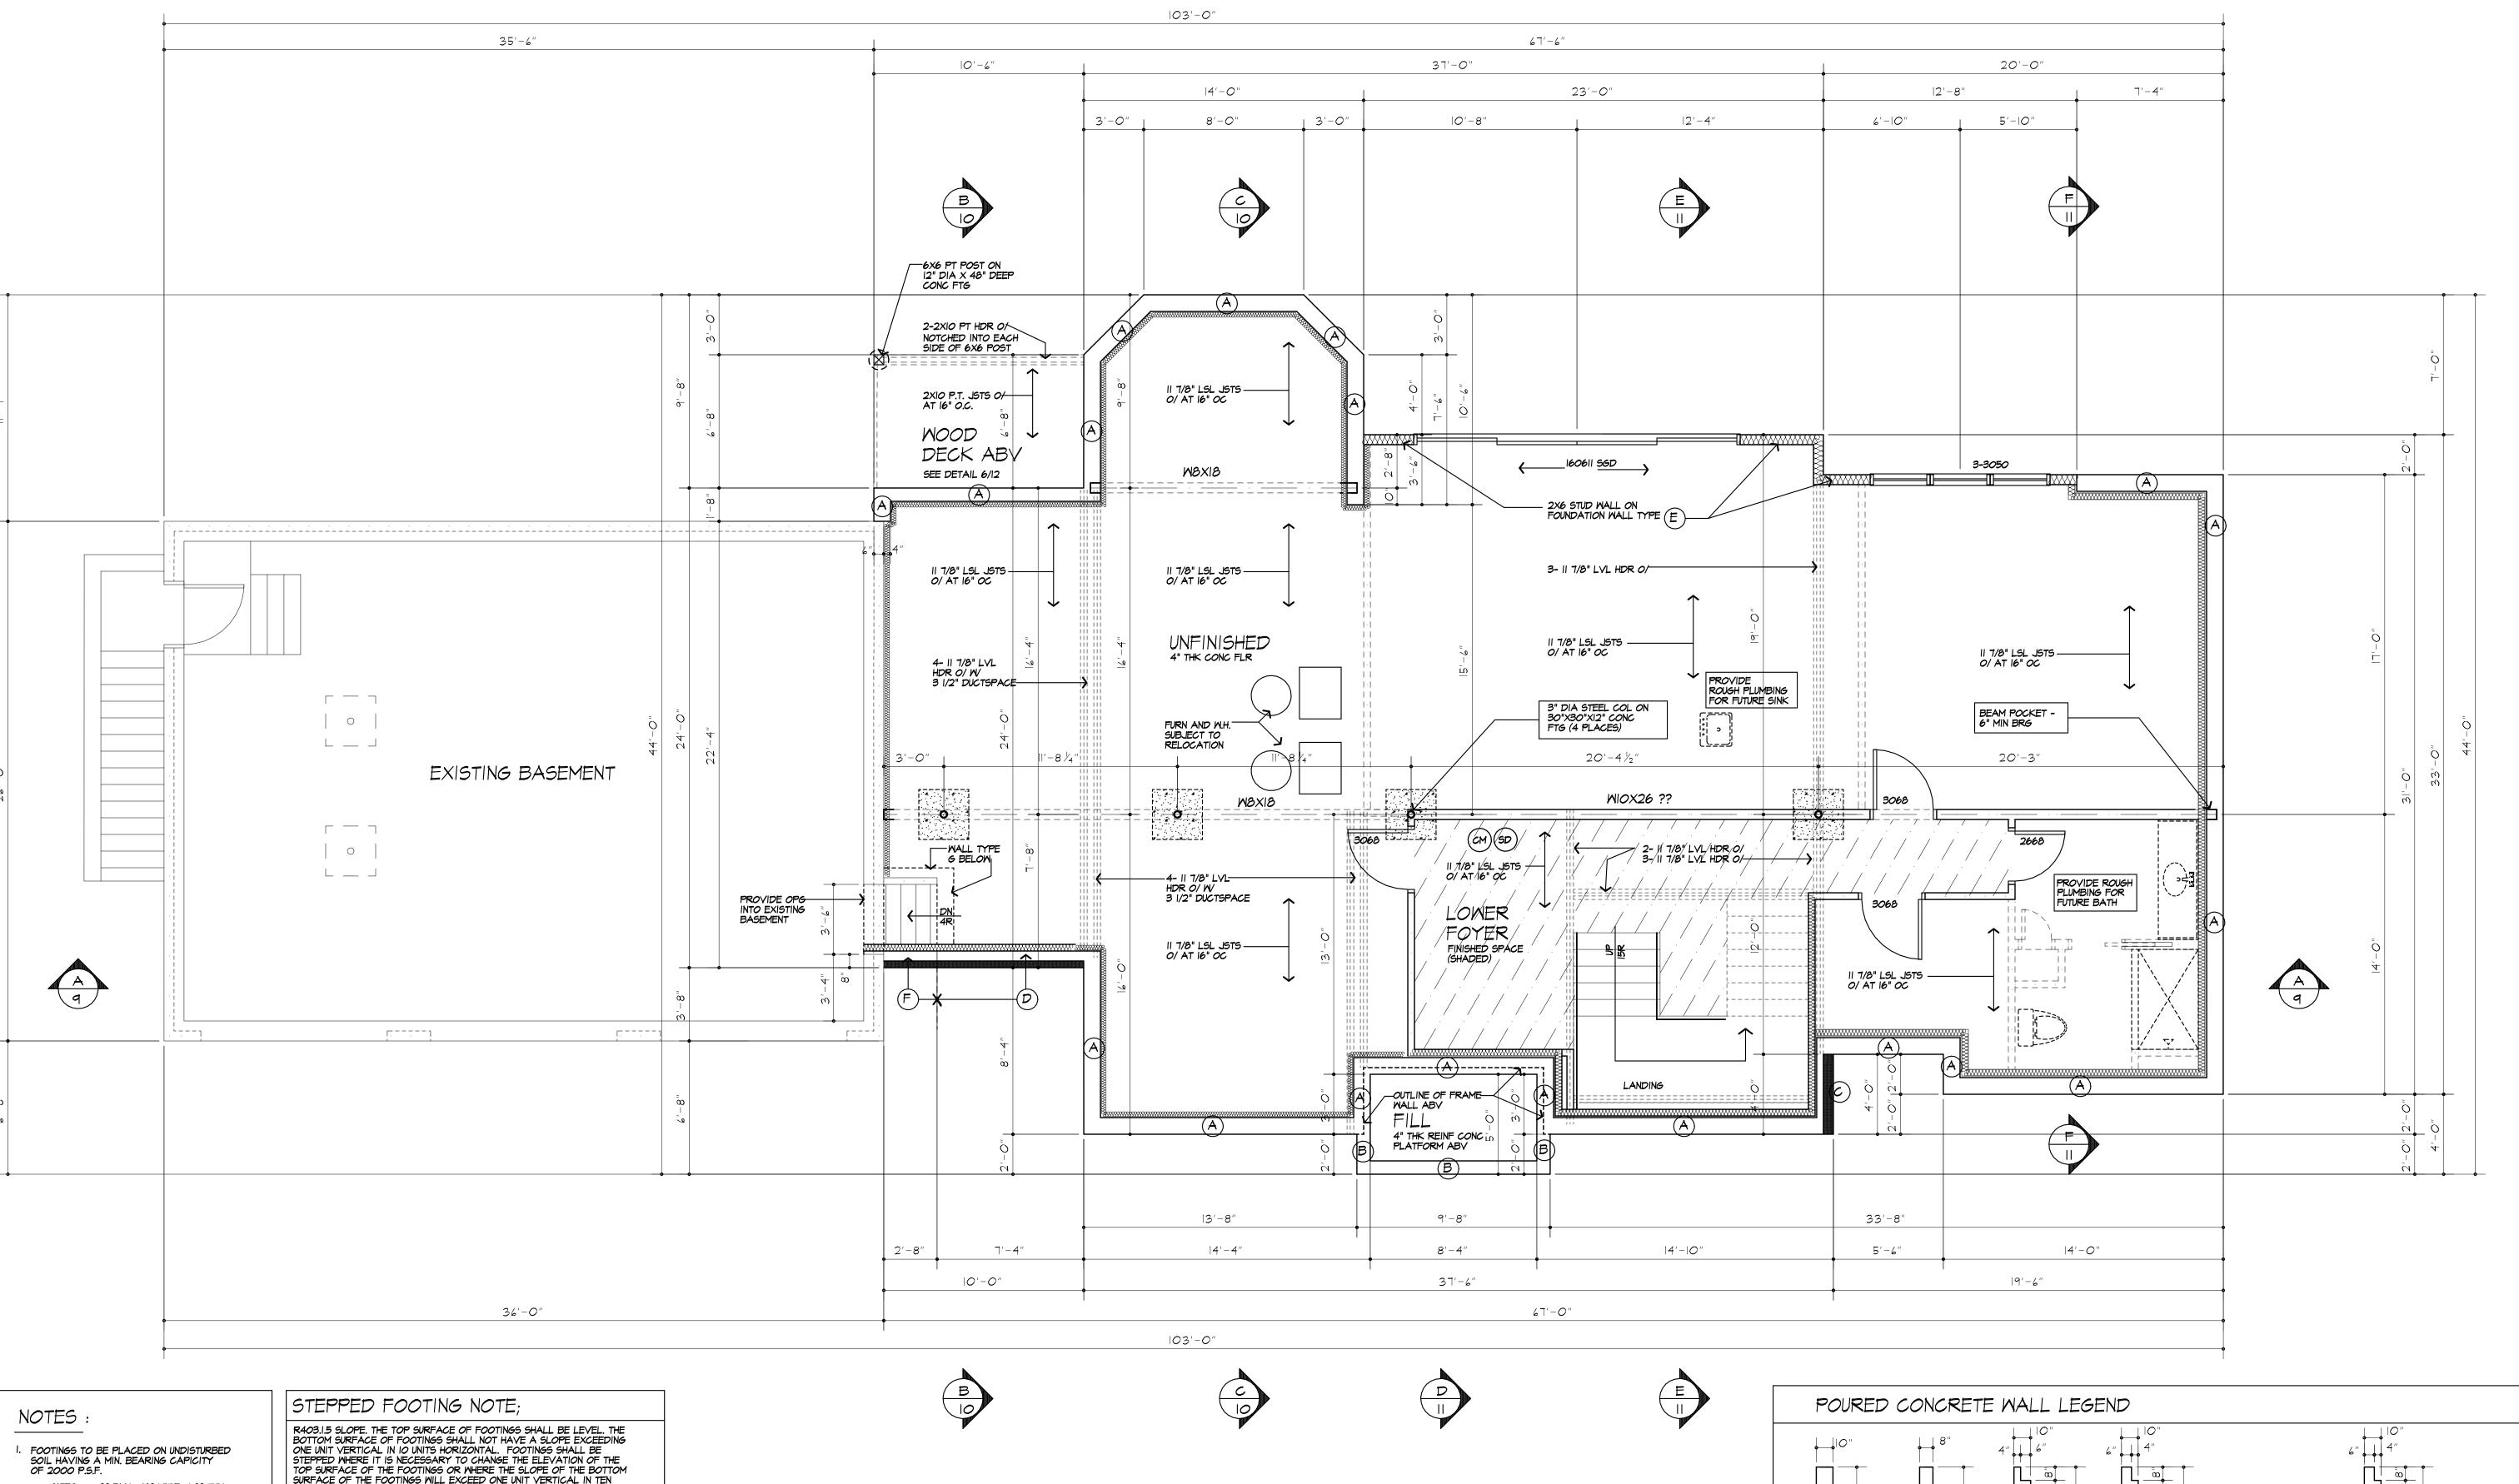

SIZES: 8" BLK.- 16" WIDE X 8" THK.

12" BLK.- 20" WIDE X 8" THK. (GARAGE) 8" BLK. - 16" WIDE X 12" THK. 2. MIN. CONC. COMPRESSIVE STRENGTH IN 28 DAYS: FOOTINGS: 2500 P.S.I. FLOOR SLABS: 2500 P.S.I.

- GARAGE: 3500 P.S.I. 3. PROVIDE DOUBLE JOISTS UNDER ALL WALLS PARALLEL TO JOIST DIRECTION
- 4. PROVIDE CROSS BRIDGING AT MID SPAN OF FLOOR FRAMING
- 5. ALL STEEL SIZES ARE TO BE STANDARD STRUCTURAL STEEL PER AISC.
- 6. PROVIDE #5 REINFORCING RODS AT 48" O.C. VERTICAL & #5 RODS AT 24" O.C. HORIZONTAL AT ALL AREAS OF UNBALANCED BACK FILL HT OF 7'-0"

R403.1.5 SLOPE. THE TOP SURFACE OF FOOTINGS SHALL BE LEVEL. THE BOTTOM SURFACE OF FOOTINGS SHALL NOT HAVE A SLOPE EXCEEDING ONE UNIT VERTICAL IN 10 UNITS HORIZONTAL. FOOTINGS SHALL BE STEPPED WHERE IT IS NECESSARY TO CHANGE THE ELEVATION OF THE TOP SURFACE OF THE FOOTINGS OR WHERE THE SLOPE OF THE BOTTOM SURFACE OF THE FOOTINGS WILL EXCEED ONE UNIT VERTICAL IN TEN UNITS HORIZONTAL (10% SLOPE)

FIRE PROTECTION REQUIREMENTS PER 302.13

1/2" GYPSUM BOARD OR 5/8" THK STRUCTURAL PANEL APPLIED TO BOTTOM OF 1-JOISTS. PENETRATIONS FOR DUCTWORK, PLUMBING OR ELECTRICAL OR OTHER SIMILAR PENETRATIONS ARE PERMITTED BY THIS CODE SECTION. APPLIED OVER ENGINEERED FLOOR JOISTS (I-JOISTS)

- I. FLOOR ASSEMBLIES LOCATED OVER BASEMENT PROTECTED BY AN APPROVED AUTOMATIC SPRINKLER SYSTEM INSTALLED IN COMPLIANCE WITH SECTION 2904 (2015 IRC) OR NFPA ISD
- 2. FLOOR ASSEMBLY IS DIMENSIONAL LUMBER OR STRUCTURAL COMPOSITE LUMBER EQUAL TO OR GREATER THAN NOMINAL 2X IO SIZE.

ALTERNATE FIRST FLOOR JOISTS: 2X 12 AT 16"O.C.

1 3/4" X 11 7/8" LSL AT 16" O.C. 3. I JOISTS ARE PROVIDED WITH AN APPROVED COATING THAT DEMONSTRATES EQUIVILENT

FIRE PROTECTION PERFORMANCE.

BASEMENT AND FOUNDATION PLAN

9' HIGH (X 10" THK) POURED CONC FOUNDATION WALL

* FLR JST SERIES & LAYOUT TO BE PROVIDED BY MANUFACTURER, SUBMIT SHOP DRAWINGS TO ARCHITECT FOR APPROVAL PRIOR TO CONSTRUCTION

**PROVIDE SIMPSON OR EQUAL JOIST HANGERS AT ALL HDR CONNECTIONS OF WOOD FRAMING

SD SMOKE DETECTOR	CM CARBON MONOXIDE DETECTOR
-------------------	-----------------------------

ALL LIFE SAFTEY SYSTEMS TO BE INSTALLED IN ACCORDANCE WITH 780 CMR 5313



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MARCH 16, 2021

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KETONIS RESIDENCE LOT 106 MALVERN HILLS

CLIENT:

DRAWING: BASEMENT / FOUNDATION PLAN


KETMAR DEVELOPMENT CORP

	DRAWN:		CHECKED:					
	PJMAIA		×					
	DATE:	MARCH 2021						
	SCALE:	1/4'	'= '-O"					
1								

JOB NO.: 20M3976 SHEET:





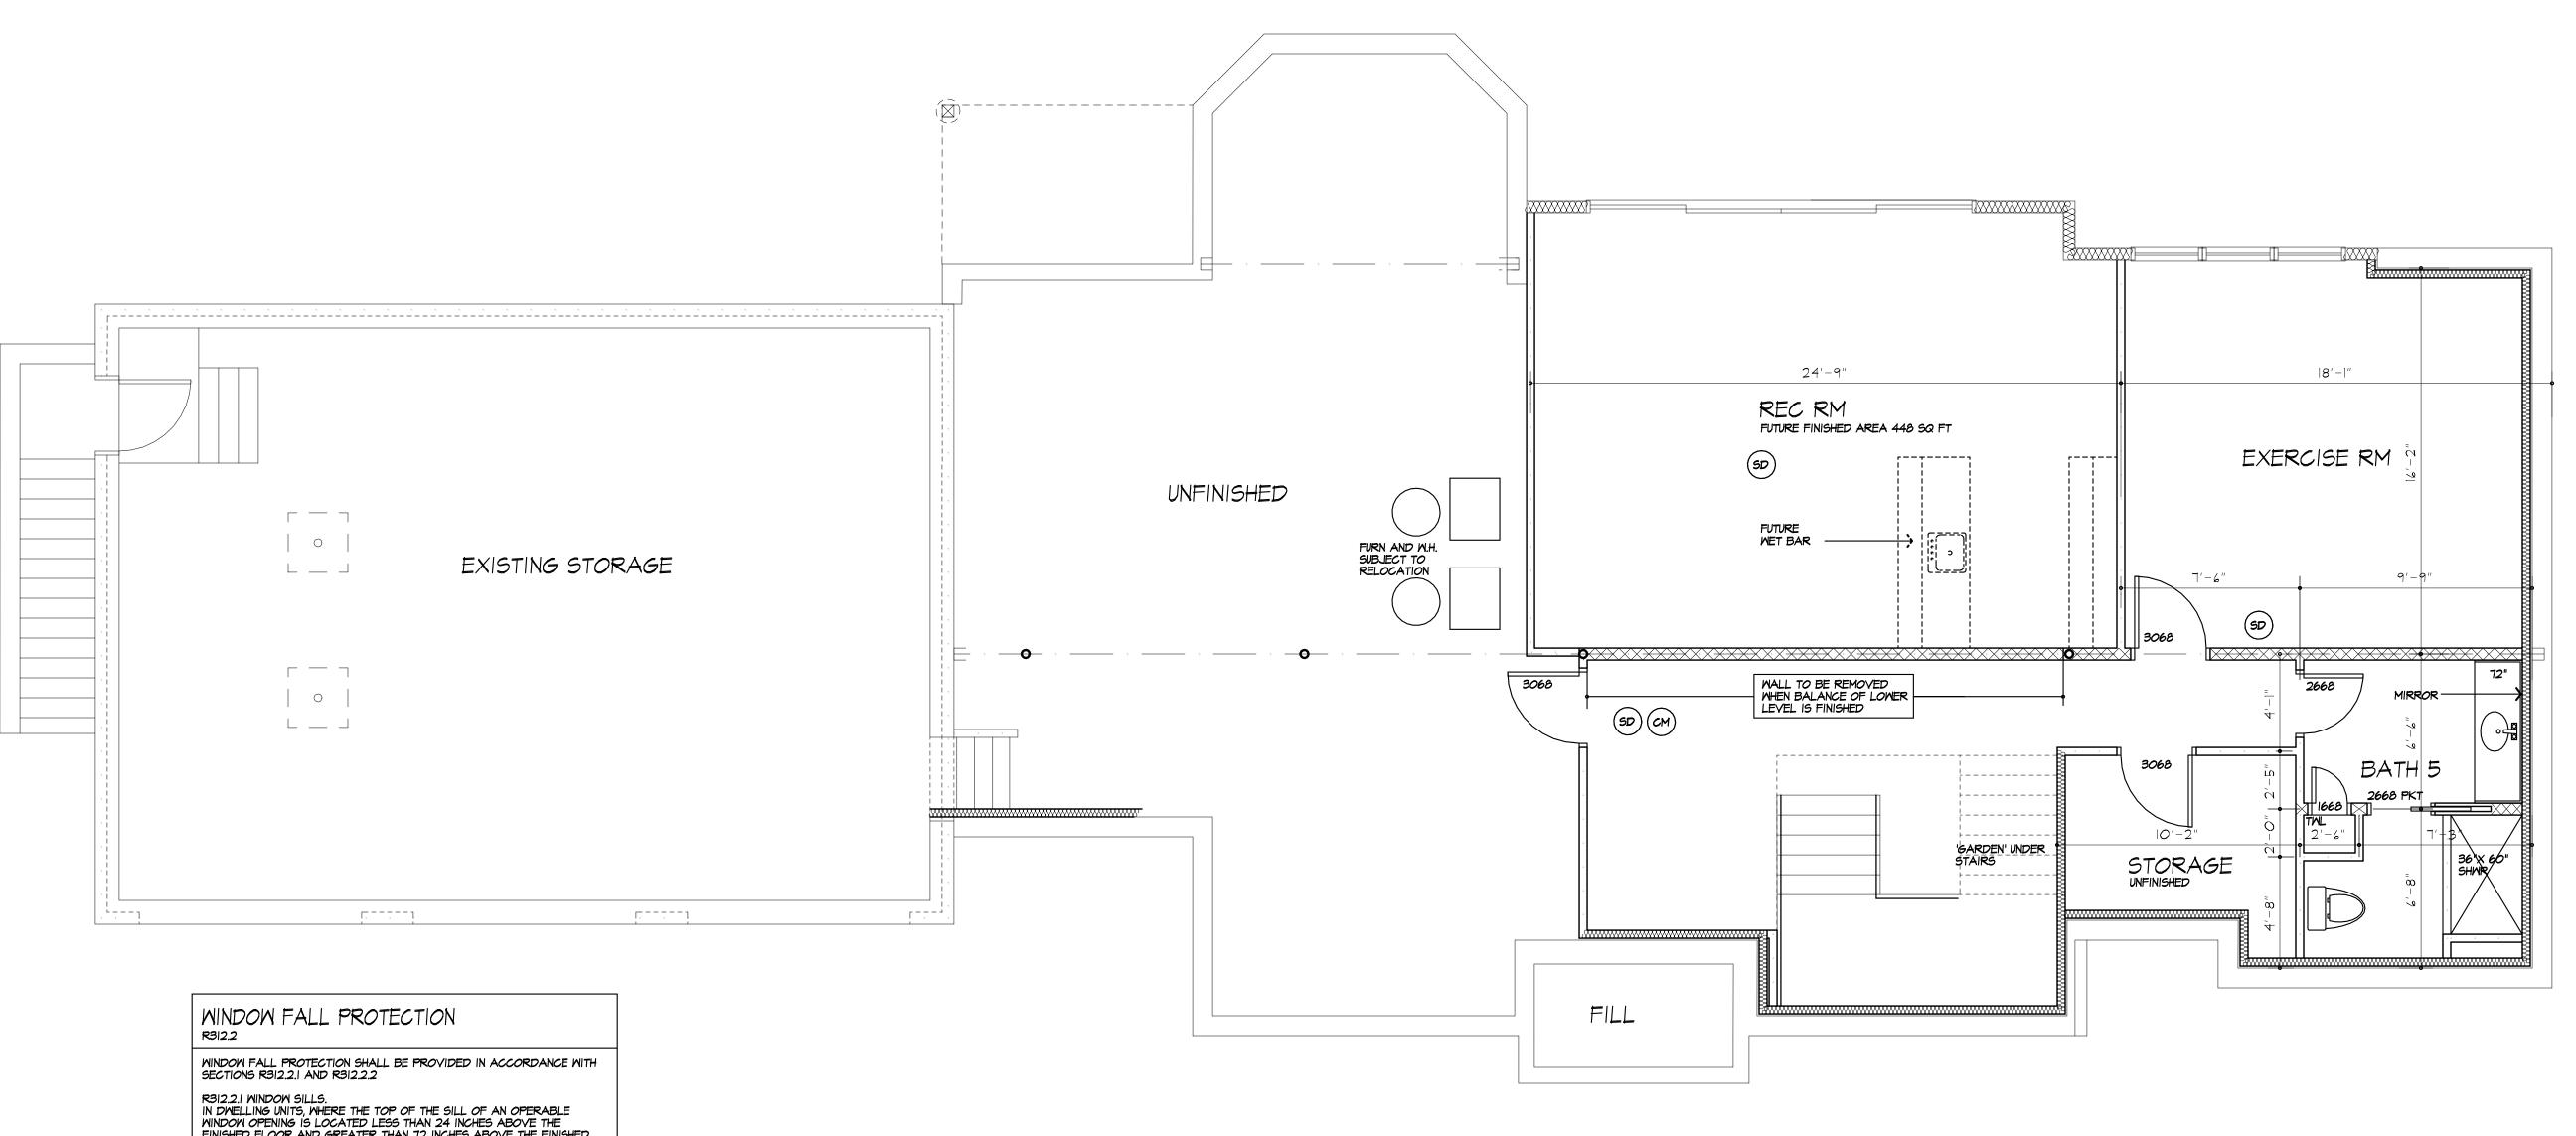

FINISHED FLOOR AND GREATER THAN 72 INCHES ABOVE THE FINISHED GRADE OR OTHER SURFACE BELOW ON THE EXTERIOR OF THE BUILDING, THE OPERABLE WINDOW SHALL COMPLY WITH ONE OF THE

I. OPERABLE WINDOWS WITH OPENINGS THAT WILL NOT ALLOW A 4-INCH-DIAMETER (102 MM) SPHERE TO PASS THROUGH THE OPENING WHERE THE OPENING IS IN ITS LARGEST OPENED POSITION. 2.0PERABLE MINDOWS THAT ARE PROVIDED WITH MINDOW FALL PREVENTION DEVICES THAT COMPLY WITH ASTM F 2090.

3.0PERABLE WINDOWS THAT ARE PROVIDED WITH WINDOW OPENING CONTROL DEVICES THAT COMPLY WITH SECTION R312.2.2.

R312.2.2 WINDOW OPENING CONTROL DEVICES. WINDOW OPENING CONTROL DEVICES SHALL COMPLY WITH ASTM F 2090. THE WINDOW OPENING CONTROL DEVICE, AFTER OPERATION TO RELEASE THE CONTROL DEVICE ALLOWING THE WINDOW TO FULLY OPEN, SHALL NOT REDUCE THE NET CLEAR OPENING AREA OF THE WINDOW UNIT TO LESS THAN THE AREA REQUIRED BY SECTION R310.2.1.

WINDOW GLAZING

WINDOW GLAZING SHALL BE PROVIDED IN ALL HAZARDOUS LOCATIONS IN ACCORDANCE WITH SECTION R308

R308.4.1 GLAZING IN DOORS

GLAZING IN FIXED AND OPERABLE PANELS OF SWINGING, SLIDING AND BIFOLD DOORS SHALL BE CONSIDERED TO BE A HAZARDOUS LOCATION.

EXCEPTIONS:

I. GLAZED OPENINGS OF A SIZE THROUGH WHICH A 3" DIA SPHERE IS UNABLE TO PASS 2. DECORATIVE GLAZING

R308.4.7 GLAZING ADJACENT TO THE BOTTOM STAIR LANDING GLAZING ADJACENT TO THE LANDING AT THE BOTTOM OF A STAIRWAY WHERE THE GLAZING IS LESS THAN 36" ABOVE THE LANDING AND WITHIN A 60" HORIZONTAL ARC LESS THAN 180 DEGREES FROM THE BOTTOM TREAD NOSING SHALL BE CONSIDERED TO BE A HAZARDOUS LOCATION.

I. WHERE GLAZING IS ADJACENT TO A WALKING SURFACE AND A HORIZONTAL RAIL IS INSTALLED AT 34" TO 38" ABOVE THE WALKING SURFACE 2. GLAZING 36" OR MORE MEASURED HORIZONTALLY FROM THE WALKING SURFACE

EXHAUST DUCTS AND EXHAUST OPENINGS M 1506.2 DUCT LENGTH THE LENGTH OF EXHAUST AND SUPPLY DUCTS USED WITH VENTILATING EQUIPMENT SHALL NOT EXCEED THE LENGTHS DETERMINED IN ACCORDANCE WITH TABLE MI506.2 EXCEPTION: DUCT LENGTH SHALL NOT BE LIMITED WHERE THE DUCT SYSTEM COMPLIES WITH THE MANUFACTURER'S DESIGN CRITERIA OR WHERE THE FLOW RATE OF THE INSTALLED VENTLATING EQUIPMENT IS VERIFIED BY THE INSTALLER OR APPROVED THRID PARTY USING A FLOW HOOD, FLOW GRID OR OTHER AIRFLOW MEASURING DEVICE TABLE M 1506.2 - DUCT LENGTH DUCT TYPE SMOOTH WALL DUCT FAN AIRFLOW RATING CFM @ 0.25 INCH MC A 50 80 100 125 150 200 250 300 50 80 100 125 150 200 250 300 MAXIMUM LENGTH C, D, E DIAMETER (INCHES) 8 AND ABOVE FOR SI: I FOOT = 304.6 MM A. FAN AIRFLON SHALL BE IN ACCORDANCE WITH ANSI/AMCA 2IO-ANSI/ASHRAE SI B. FOR NONCIRCULAR DUCTS, CALCULATE THE DIAMETER AS FOUR TIMES THE CROSS SECTIONAL AREA DIVIDED BY THE PERIMETER C. THE TABLE ASSUMES THAT ELBONIS ARE NOT USED, FIFTEEN FEET OF ALLOWABLE DUCT LENGTH SHALL BE DEDUCTED FOR EACH ELBOW INSTALLED IN THE DUCT RUN D. NL = NO LIMIT ON DUCT LENGTH OF THIS SIZE E. X = NOT ALLOWED. ANY LENGTH OF DUCT OF THIS SIZE WITH ASSUMED TURNS AND FITTINGS WILL EXCEED THE RATED PRESSURE DROP

FINISHED BASEMENT PLAN

FINISHED AREA: 745 S.F. FUTURE FINISHED AREA (REC RM): 448 S.F.

CM CARBON MONOXIDE DETECTOR (SD) SMOKE DETECTOR ALL LIFE SAFTEY SYSTEMS TO BE INSTALLED IN ACCORDANCE WITH 180 CMR 5313

SMOKE & CARBON MONOXIDE ALARM LOCATIONS R314/R315

R314.3 LC IN THE FC 2. OUTSIE VICINITY STORY C INCLUDIN DWELLING AN INTER A SMOKI FOR THE LEVEL IS WHEN MO INSTALLI DEVICES THE ACTUATION OF ONE ALARM WILL ACTIVATE ALL OF THE ALARMS IN THE INDIVIDUAL UNIT.

R3I5.3 REQUIRED LOCATIONS. CARBON MONOXIDE ALARMS SHALL BE PROVIDED IN THE FOLLOWING LOCATIONS: I. WITHIN EACH DWELLING UNIT ON EACH STORY CONTAINING A SLEEPING AREA, WITHIN 15 FEET OF THE SLEEPING AREA. MORE THAN ONE CARBON MONOXIDE ALARM SHALL BE PROVIDED WHERE NECESSARY TO ASSURE THAT NO SLEEPING AREA ON A STORY IS MORE THAN 10 FEET AWAY FROM A CARBON MONOXIDE ALARM. 2. ON ANY STORY OF A DWELLING UNIT THAT CONTAINS A CARBON MONOXIDE SOURCE.

LOCATION, SMOKE ALARMS SHALL BE INSTALLED
FOLLOWING LOCATIONS: I. IN EACH SLEEPING ROOM.
IDE EACH SEPARATE SLEEPING AREA IN THE IMMEDIATE
Y OF THE BEDROOMS. 3. ON EACH ADDITIONAL
OF THE DWELLING, INCLUDING BASEMENTS BUT NOT
NG CRAWL SPACES AND UNINHABITABLE ATTICS. IN
NGS OR DWELLING UNITS WITH SPLIT LEVELS AND WITHOUT
RVENING DOOR BETWEEN THE ADJACENT LEVELS,
CE ALARM INSTALLED ON THE UPPER LEVEL SHALL SUFFICE
E ADJACENT LOWER LEVEL PROVIDED THAT THE LOWER
IS LESS THAN ONE FULL STORY BELOW THE UPPER LEVEL.
ORE THAN ONE SMOKE ALARM IS REQUIRED TO BE
ED WITHIN AN INDIVIDUAL DWELLING UNIT THE ALARM
S SHALL BE INTERCONNECTED IN SUCH A MANNER THAT
TIATION OF ONE ALARM WILL ACTIVATE ALL OF THE ALARMS

2X6 STUDS AT 16" OC (3) STUDS GLUE AND NAIL 2X6 STUDS AT 16" OC 2X4 STUDS @ 16"O.C.

OPENING

IUP TO 4'-0"

5'-0"

6'-0"

7'-0"

USE SIMPSON OR EQUAL METAL HANGERS AT ALL HDR CONNECTIONS

HEADER SCHEDULE

2X6 WALL

(3) 2X8

(3) 2X8

(3) 2XIO

(3) 2XIO

GLUE AND NAIL ALL HEADERS

PROVIDE (2) 1/2" PLY. WD. GUSSETS -2X6 WALL

PROVIDE (I) 1/2" PLY. WD. GUSSETS -2X4 WALL

WALL LEGEND

8'-0" (3) 2XI2

UNLESS OTHERWISE NOTED

2X4 WALL

(2) 2X8

(2) 2XB

(2) 2XIO

(2) 2XI2

WITH SOLID BEARING



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AS WELL AS THE ARRANGEMENT AND COMPOSITIO OF SPACES AND ELEMENTS OF THE DESIGN. UNDER SUCH PROTECTION, UNAUTHORIZED USE HEREIN, CAN LEGALLY RESULT IN THE CESSATION OF CONSTRUCTION OR BUILDINGS BEING SEIZED AND/OR MONETARY COMPENSATION TO PATRICK J. MORABITO, A.I.A. ARCHITECT P.C.

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MARCH 16, 2021

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KETONIS RESIDENCE LOT 106 MALVERN HILLS

CLIENT:

DRAWING:

KETMAR DEVELOPMENT CORP

FINISHED BASEMENT PLAN

DRAWN:

AIAMLA	×							
DATE:	MARCH 2021							
SCALE:	1/4"=1'-0"							
IOD NO	4 0 10 474							


20M3976 JOB NO.:

SHEET:

CHECKED:

of 12 sheets



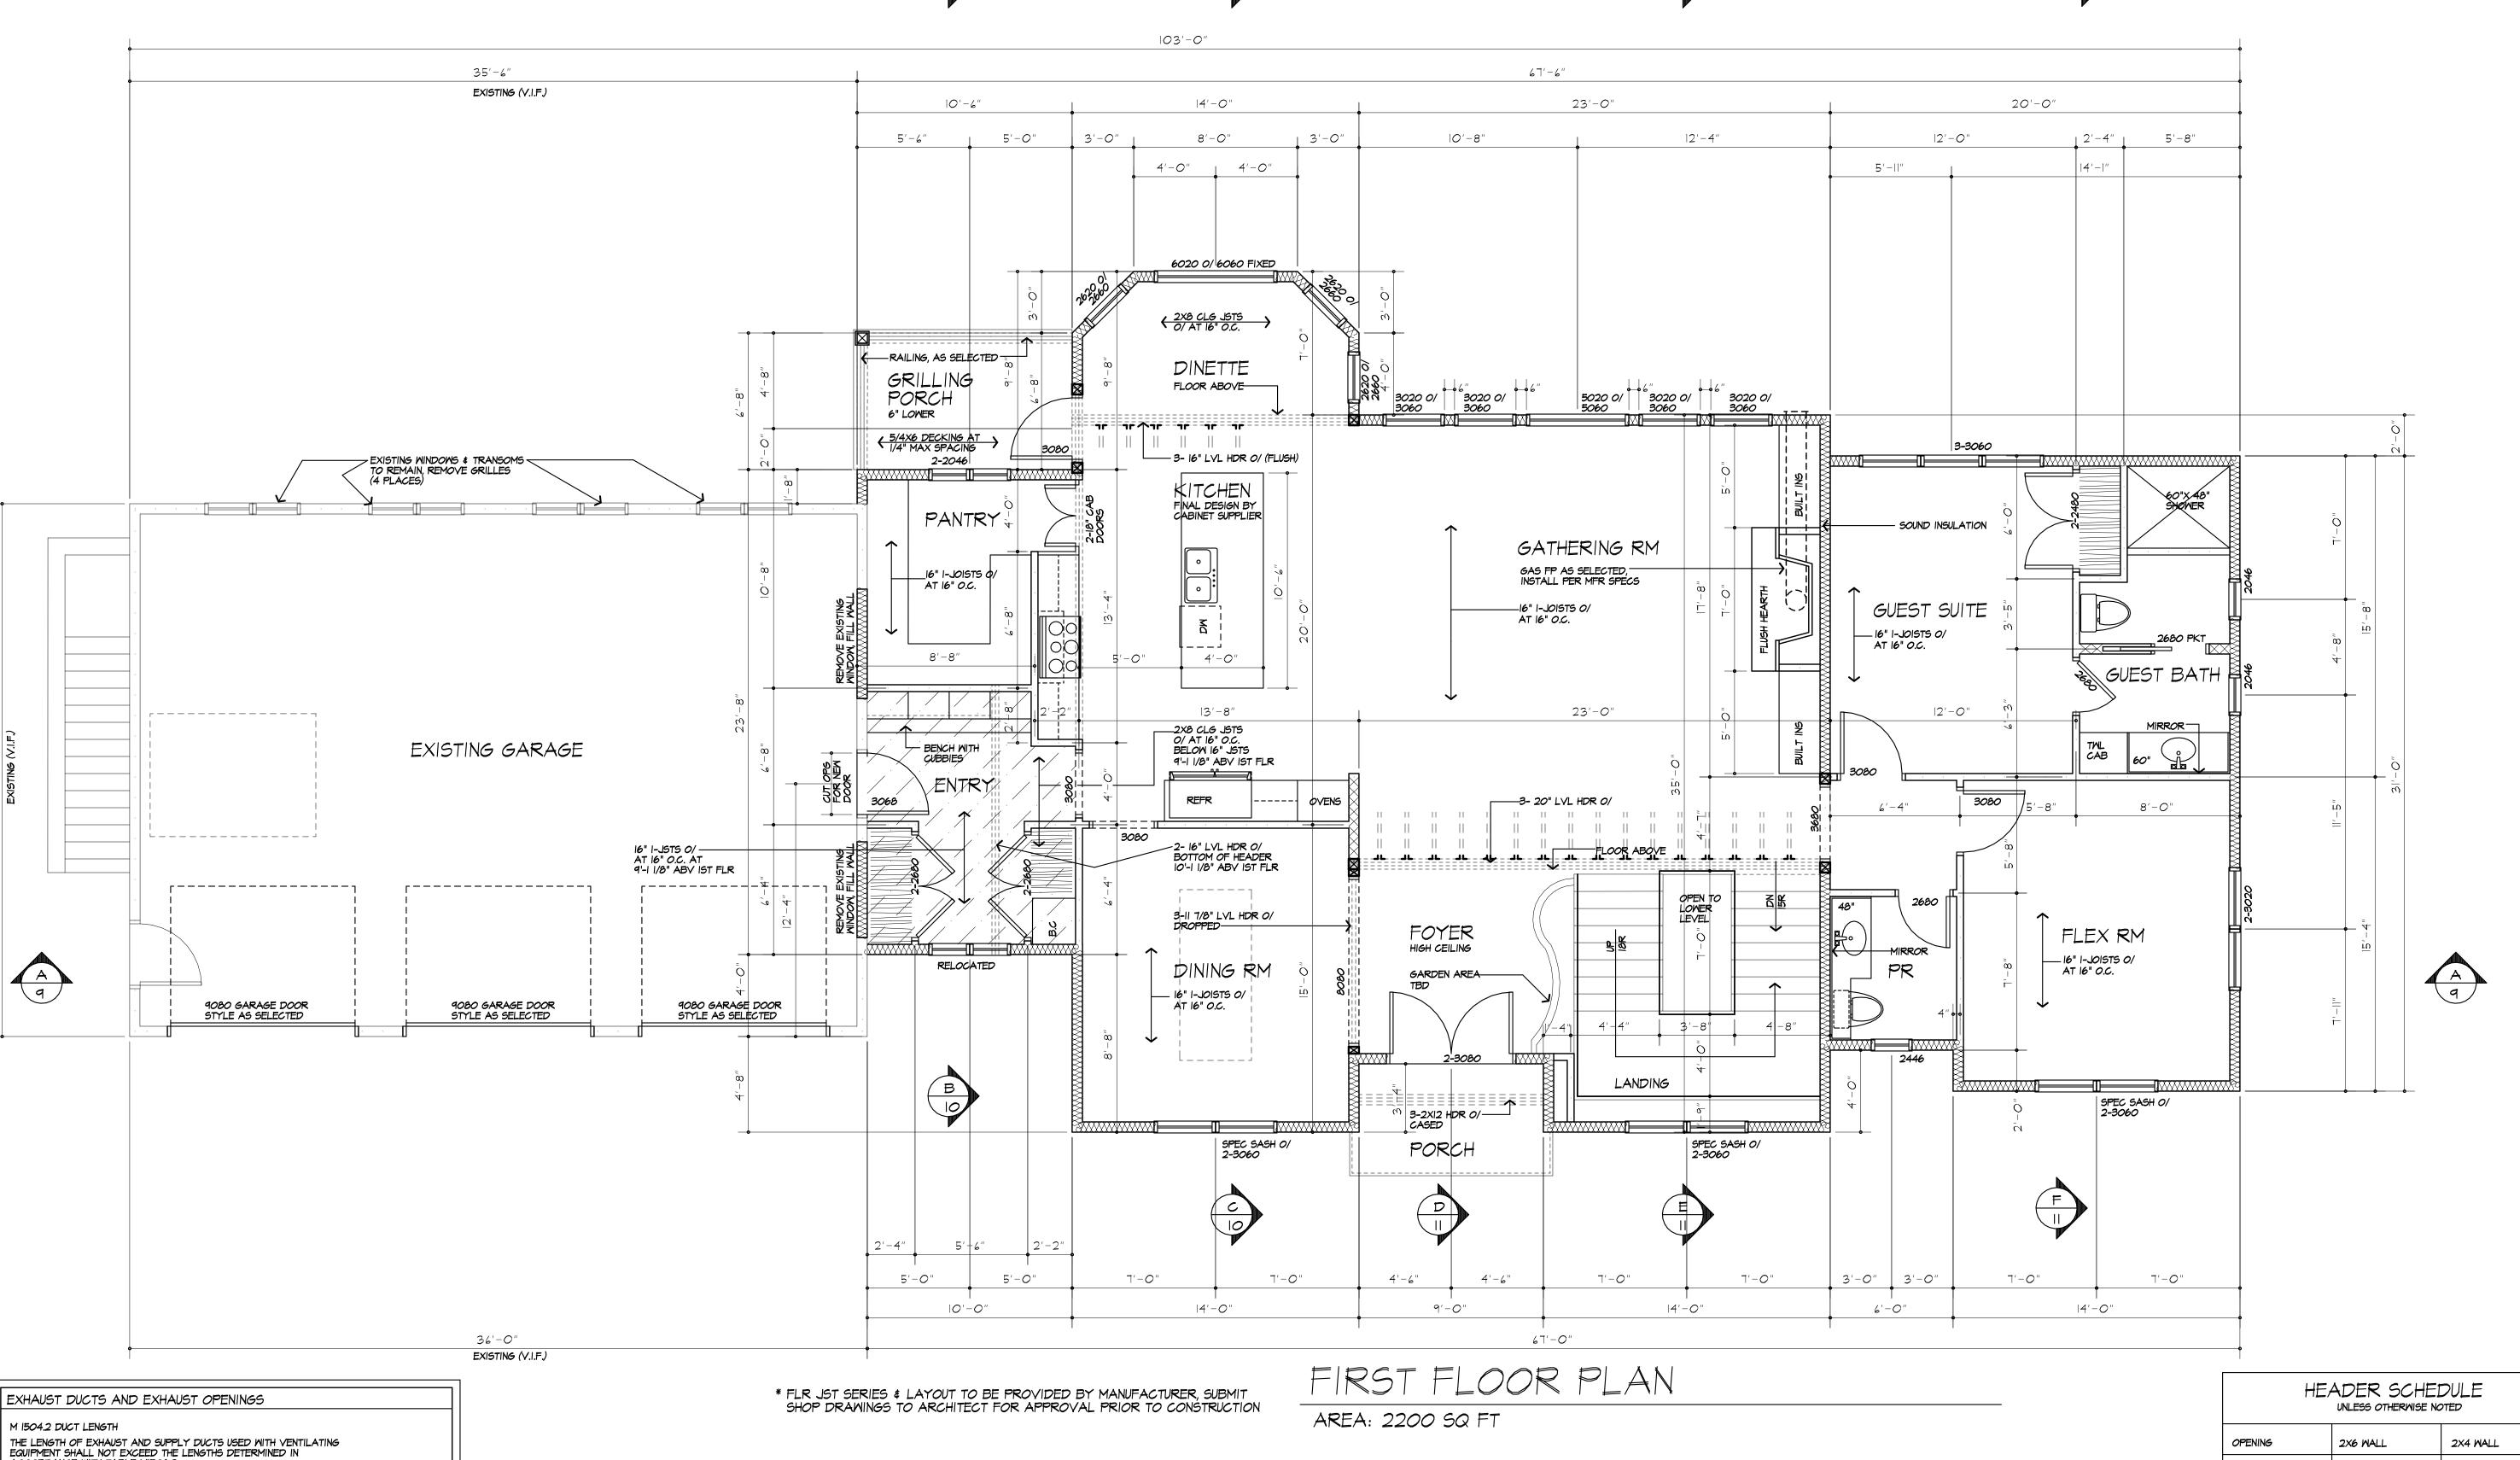

M 1504.2 DUCT LENGTH EQUIPMENT SHALL NOT EXCEED THE LENGTHS DETERMINED IN ACCORDANCE WITH TABLE MISO6.2 EXCEPTION: DUCT LENGTH SHALL NOT BE LIMITED WHERE THE DUCT SYSTEM COMPLIES WITH THE MANUFACTURER'S DESIGN CRITERIA OR WHERE THE FLOW RATE OF THE INSTALLED VENTLATING EQUIPMENT IS VERIFIED BY THE INSTALLER OR APPROVED THRID PARTY USING A FLOW HOOD, FLOW GRID OR OTHER AIRFLOW MEASURING DEVICE TABLE M 1504.2 - DUCT LENGTH SMOOTH WALL DUCT FAN AIRFLOW RATING CFM @ 0.25 INCH WC A 50 80 100 125 150 200 250 300 50 80 100 125 150 200 250 300 MAXIMUM LENGTH C, D, E DIAMETER E (INCHES) 8 AND ABOVE FOR SI: | FOOT = 304.8 MM A. FAN AIRFLOW SHALL BE IN ACCORDANCE WITH ANSI/AMCA 210-ANSI/ASHRAE 51 B. FOR NONCIRCULAR DUCTS, CALCILLATE THE DIAMETER AS FOUR TIMES THE CROSS SECTIONAL AREA DIVIDED BY THE PERIMETER C. THE TABLE ASSUMES THAT ELBOMS ARE NOT USED. FIFTEEN FEET OF ALLOWABLE DUCT LENGTH SHALL BE DEDUCTED FOR EACH

E. X = NO LIMIT ON DUCT LENGTH OF THIS SIZE

E. X = NOT ALLOWED. ANY LENGTH OF DUCT OF THIS SIZE WITH ASSUMED TURNS AND FITTINGS WILL EXCEED THE RATED PRESSURE DROP

WINDOW FALL PROTECTION

WINDOW FALL PROTECTION SHALL BE PROVIDED IN ACCORDANCE WITH SECTIONS R312.2.1 AND R312.2.2

IN DWELLING UNITS, WHERE THE TOP OF THE SILL OF AN OPERABLE WINDOW OPENING IS LOCATED LESS THAN 24 INCHES ABOVE THE FINISHED FLOOR AND GREATER THAN 12 INCHES ABOVE THE FINISHED GRADE OR OTHER SURFACE BELOW ON THE EXTERIOR OF THE BUILDING, THE OPERABLE WINDOW SHALL COMPLY WITH ONE OF THE . OPERABLE WINDOWS WITH OPENINGS THAT WILL NOT ALLOW A

4-INCH-DIAMETER (IO2 MM) SPHERE TO PASS THROUGH THE OPENING WHERE THE OPENING IS IN ITS LARGEST OPENED POSITION.

2.OPERABLE WINDOWS THAT ARE PROVIDED WITH WINDOW FALL PREVENTION DEVICES THAT COMPLY WITH ASTM F 2090. 3.0PERABLE WINDOWS THAT ARE PROVIDED WITH WINDOW OPENING CONTROL DEVICES THAT COMPLY WITH SECTION R312.2.2. R312.2.2 WINDOW OPENING CONTROL DEVICES. WINDOW OPENING

CONTROL DEVICES SHALL COMPLY WITH ASTM F 2090. THE WINDOW OPENING CONTROL DEVICE, AFTER OPERATION TO RELEASE THE CONTROL DEVICE ALLOWING THE WINDOW TO FULLY OPEN, SHALL NOT REDUCE THE NET CLEAR OPENING AREA OF THE WINDOW UNIT TO LESS THAN THE AREA REQUIRED BY SECTION R310.2.1.

WINDOW GLAZING

WINDOW GLAZING SHALL BE PROVIDED IN ALL HAZARDOUS LOCATIONS IN ACCORDANCE WITH SECTION R308

R308.4.1 GLAZING IN DOORS GLAZING IN FIXED AND OPERABLE PANELS OF SMINGING, SLIDING AND BIFOLD DOORS SHALL BE CONSIDERED TO BE A HAZARDOUS LOCATION. EXCEPTIONS: I. GLAZED OPENINGS OF A SIZE THROUGH WHICH A 3" DIA SPHERE IS UNABLE TO PASS
2. DECORATIVE GLAZING

R308.4.7 GLAZING ADJACENT TO THE BOTTOM STAIR LANDING GLAZING ADJACENT TO THE LANDING AT THE BOTTOM OF A STAIRWAY WHERE THE GLAZING IS LESS THAN 36" ABOVE THE LANDING AND WITHIN A 60" HORIZONTAL ARC LESS THAN 180 DEGREES FROM THE BOTTOM TREAD NOSING SHALL BE CONSIDERED TO BE A HAZARDOUS LOCATION.

I. WHERE GLAZING IS ADJACENT TO A WALKING SURFACE AND A HORIZONTAL RAIL IS INSTALLED AT 34" TO 38" ABOVE THE WALKING SURFACE 2. GLAZING 36" OR MORE MEASURED HORIZONTALLY FROM THE WALKING SURFACE

SMOKE & CARBON MONOXIDE ALARM LOCATIONS

R314.3 LOCATION. SMOKE ALARMS SHALL BE INSTALLED IN THE FOLLOWING LOCATIONS: I. IN EACH SLEEPING ROOM. 2. OUTSIDE EACH SEPARATE SLEEPING AREA IN THE IMMEDIATE VICINITY OF THE BEDROOMS. 3. ON EACH ADDITIONAL STORY OF THE DWELLING, INCLUDING BASEMENTS BUT NOT INCLUDING CRAWL SPACES AND UNINHABITABLE ATTICS. IN DWELLINGS OR DWELLING UNITS WITH SPLIT LEVELS AND WITHOUT AN INTERVENING DOOR BETWEEN THE ADJACENT LEVELS, A SMOKE ALARM INSTALLED ON THE UPPER LEVEL SHALL SUFFICE FOR THE ADJACENT LOWER LEVEL PROVIDED IN THE UPPER LOWER LEVEL IS LESS THAN ONE FULL STORY BELOW THE UPPER LEVEL. WHEN MORE THAN ONE SMOKE ALARM IS REQUIRED TO BE INSTALLED WITHIN AN INDIVIDUAL DWELLING UNIT THE ALARM DEVICES SHALL BE INTERCONNECTED IN SUCH A MANNER THAT THE ACTUATION OF ONE ALARM WILL ACTIVATE ALL OF THE ALARMS IN THE INDIVIDUAL UNIT.

R315.3 REQUIRED LOCATIONS. CARBON MONOXIDE ALARMS SHALL BE PROVIDED IN THE FOLLOWING LOCATIONS: I. WITHIN EACH DWELLING UNIT ON EACH STORY CONTAINING A SLEEPING AREA, WITHIN 10 FEET OF THE SLEEPING AREA. MORE THAN ONE CARBON MONOXIDE ALARM SHALL BE PROVIDED WHERE NECESSARY TO ASSURE THAT NO SLEEPING AREA ON A STORY IS MORE THAN IO FEET AWAY FROM A CARBON MONOXIDE ALARM. 2. ON ANY STORY OF A DWELLING UNIT THAT CONTAINS A CARBON MONOXIDE SOURCE.

HEADER SCHEDULE UNLESS OTHERWISE NOTED											
ENIN	6	2X6 WALL	2X4 WALL								
0	4'-0"	(3) 2X8	(2) 2×8								
	5'-0"	(3) 2X8	(2) 2X8								
	6'-0"	(3) 2XIO	(2) 2XIO								

(2) 2XI2

(3) 2XI2 8'-0" PROVIDE (2) 1/2" PLY. MD. GUSSETS -2X6 WALL PROVIDE (1) 1/2" PLY. MD. GUSSETS -2X4 WALL GLUE AND NAIL ALL HEADERS

(3) 2XIO

7'-0"

WALL L	EG	END
2X6 STUDS AT 16" OC W INSULATION	\boxtimes	(3) STUDS GLUE AND NAIL WITH SOLID BEARING
2X6 STUDS AT 16" OC (INTERIOR WALL)		BELOW - OMIT TOP PLTS
(INTERIOR MALL)		PROVIDE DOUBLE JACK STUDS AT OPENINGS
2X4 STUDS @ 16"O.C.		LARGER THAN 4'0"

CUSTOM WINDOW SIZES ARE TO BE VERIFIED BY FIELD MEASURMENTS.

USE SIMPSON OR EQUAL METAL HANGERS AT ALL HDR CONNECTIONS



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KETONIS RESIDENCE LOT 106 MALVERN HILLS

CLIENT: KETMAR DEVELOPMENT CORP


DRAWING: FIRST FLOOR PLAN

DRAWN:		CHECKED:
PJMAIA		×
DATE:	MAF	RCH 2021
SCALE:	1/4"	'=I'-O"
JOB NO.:	201	M3976

SHEET:

12 SHEETS



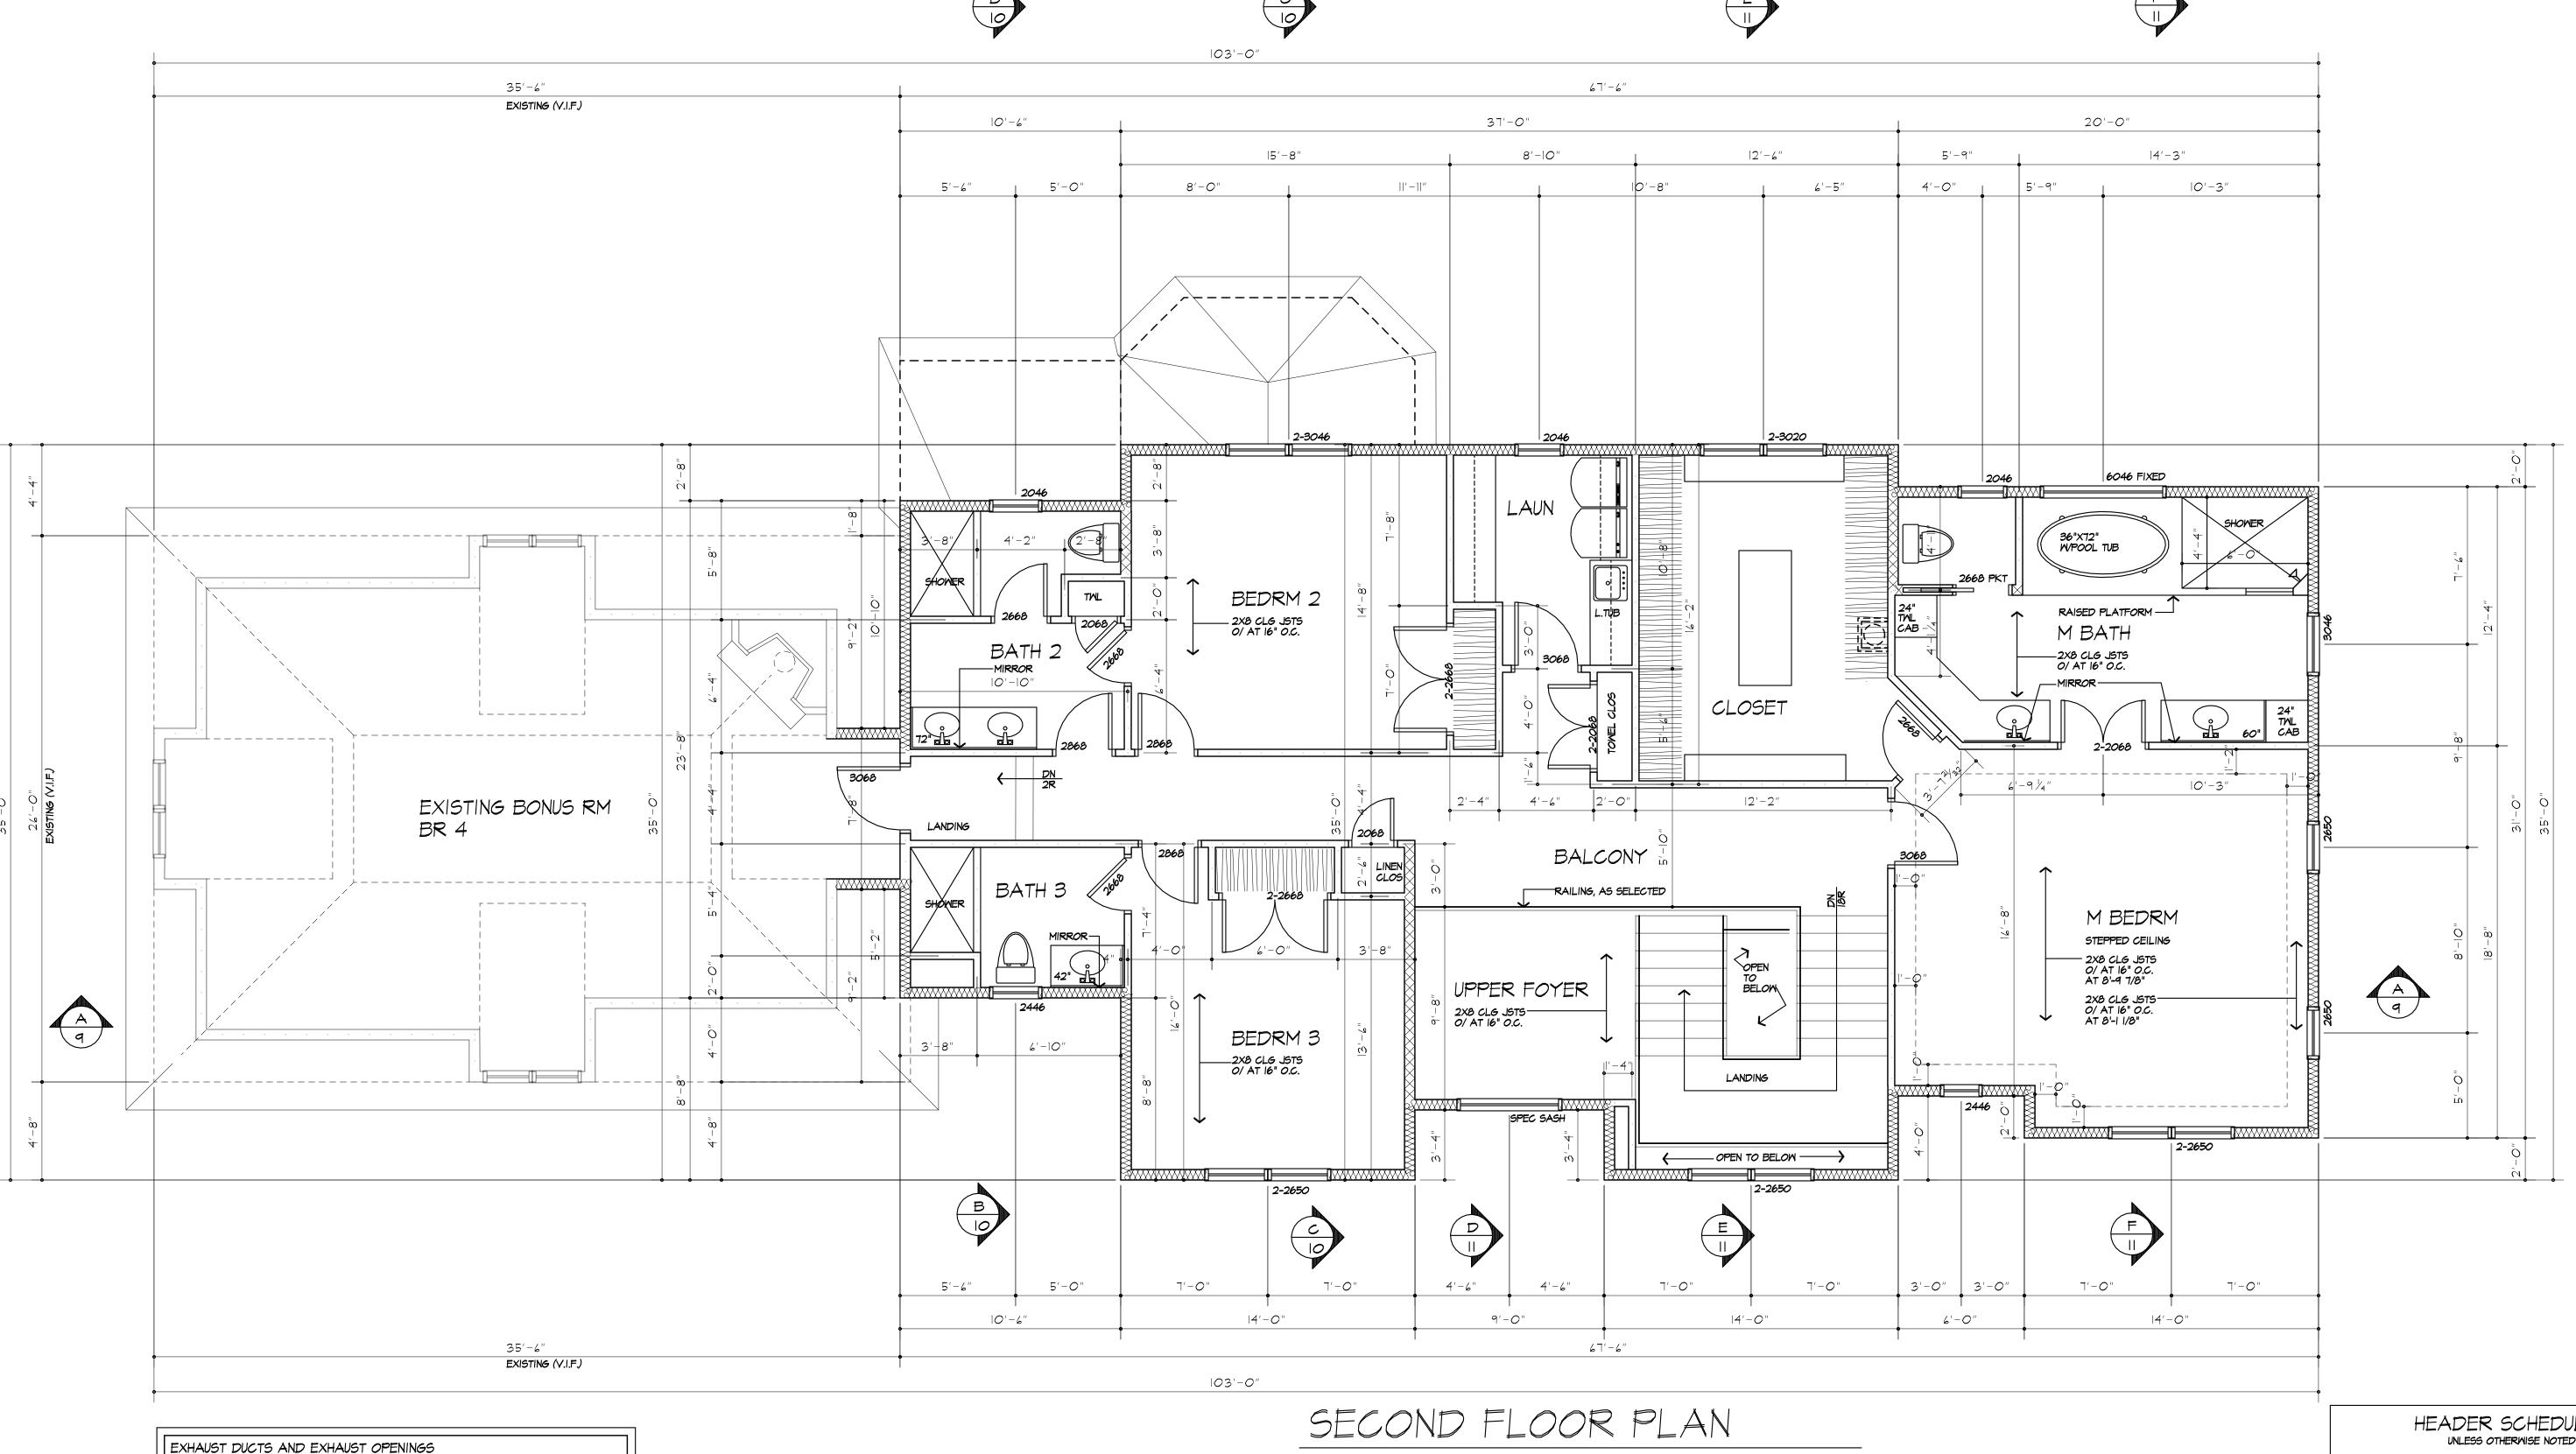

AREA: 1860 SQ FT (FLOOR AREA) (PLUS 698 S.F. EXISTING BONUS RM)

EQUIPMENT SHALL NOT E ACCORDANCE WITH TAE EXCEPTION: DUCT I COMPLIES WITH THE FLOW RATE OF THE INSTALLER OR APPI OR OTHER AIRFLOW	BLE M ENG MAN INST ROVE MEA	11500 TH S JUFA ALL ED T ASUR	5.2 HALL CTUR ED V HRID	NO ER'S ENTI	T BE DES LATII	: LIM SIGN NG E	ITED CRI QUIP	MHE TERI, MEN	RE A OF	VER	ERE IFIEL	THE BY	THE			
DUCT TYPE	FLEX DUCT SMOOTH WALL DUCT															
FAN AIRFLOW RATING CFM @ 0.25 INCH WC A	50	80	100	125	150	200	250	300	50	80	100	125	150	200	250	300
DIAMETER ^B (INCHES)					M	IAXIN	1UM I		TH C	, D, E						
3	Х	Х	Х	Х	Х	х	Х	х	5	Х	Х	Х	Х	х	х	Х
4	56	4	X	Х	×	х	Х	Х	114	31	Ю	×	Х	×	×	Х
5	NL	81	42	16	2	Х	Х	Х	Ę	152	91	51	28	4	X	Х
6	NL	NL	158	91	55	18	ı	Х	NL	NL	NL	168	112	53	25	9
7	NL	NL	NL	NL	161	78	40	19	NL	ХL	N	NL	N	148	88	54
8 AND ABOVE	NL	NL	NL	NL	NL	189	Ш	69	NL	NL	NL	NL	NL	NL	198	133
5 / 110 / UU 1 L	_ '-	176	145	14	74-	10-1	""	01	14	146	146	14	145	145	110	100

DUCT TYPE			FLEX	(DU	ST			SMOOTH WALL DUCT								
FAN AIRFLOW RATING CFM @ 0.25 INCH WC A	50	80	100	125	150	200	250	300	50	80	100	125	150	200	250	300
DIAMETER ^B (INCHES)	MAXIMUM LENGTH C, D, E (FEET)															
3	Х	Х	Х	X	Х	Х	X	X	5	Х	X	X	X	X	X	X
4	56	4	Х	Х	Х	Х	Х	Х	114	31	10	Х	Х	Х	Х	Х
5	NL	81	42	16	2	Х	Х	Х	Z	152	91	51	28	4	Х	Х
6	NL	NL	158	91	55	18	ı	Х	NL	NL	NL	168	II2	53	25	9
7	NL	NL	NL	NL	161	78	40	19	NL	NL	NL	NL	NL	148	88	54
8 AND ABOVE	NL	NL	NL	NL	NL	189	Ш	69	NL	NL	NL	NL	NL	NL	198	133

E. X = NOT ALLOWED. ANY LENGTH OF DUCT OF THIS SIZE WITH ASSUMED TURNS AND FITTINGS WILL EXCEED THE RATED PRESSURE DROP

R3 2,2	
WINDOW FALL PROTECTION SHALL BE PROVIDED IN ACCORDANCE WITH SECTIONS R312.2.1 AND R312.2.2	
R3 2.2.1 WINDOW SILLS. IN DWELLING UNITS, WHERE THE TOP OF THE SILL OF AN OPERABLE WINDOW OPENING IS LOCATED LESS THAN 24 INCHES ABOVE THE EINIGHED ELOOP, AND SPEATER THAN 72 INCHES ABOVE THE EINIGHED	

WINDOW FALL PROTECTION

FINISHED FLOOR AND GREATER THAN 12 INCHES ABOVE THE FINISHED GRADE OR OTHER SURFACE BELOW ON THE EXTERIOR OF THE BUILDING, THE OPERABLE WINDOW SHALL COMPLY WITH ONE OF THE I. OPERABLE WINDOWS WITH OPENINGS THAT WILL NOT ALLOW A 4-INCH-DIAMETER (102 MM) SPHERE TO PASS THROUGH THE OPENING WHERE THE OPENING IS IN ITS LARGEST OPENED POSITION. 2.OPERABLE WINDOWS THAT ARE PROVIDED WITH WINDOW FALL PREVENTION DEVICES THAT COMPLY WITH ASTM F 2090. 3.OPERABLE WINDOWS THAT ARE PROVIDED WITH WINDOW OPENING

CONTROL DEVICES THAT COMPLY WITH SECTION R312.2.2.

R312.2.2 WINDOW OPENING CONTROL DEVICES. WINDOW OPENING CONTROL DEVICES SHALL COMPLY WITH ASTM F 2090. THE WINDOW OPENING CONTROL DEVICE, AFTER OPERATION TO RELEASE THE CONTROL DEVICE ALLOWING THE WINDOW TO FULLY OPEN, SHALL NOT REDUCE THE NET CLEAR OPENING AREA OF THE WINDOW UNIT TO LESS THAN THE AREA REQUIRED BY SECTION R310.2.1.

MINDOW GLAZING

WINDOW GLAZING SHALL BE PROVIDED IN ALL HAZARDOUS LOCATIONS IN ACCORDANCE WITH SECTION R308 R308.4.1 GLAZING IN DOORS

GLAZING IN FIXED AND OPERABLE PANELS OF SWINGING, SLIDING AND BIFOLD DOORS SHALL BE CONSIDERED TO BE A HAZARDOUS LOCATION. EXCEPTIONS: I. GLAZED OPENINGS OF A SIZE THROUGH WHICH A 3" DIA SPHERE IS UNABLE TO PASS
2. DECORATIVE GLAZING

R308.4.7 GLAZING ADJACENT TO THE BOTTOM STAIR LANDING GLAZING ADJACENT TO THE LANDING AT THE BOTTOM OF A STAIRWAY WHERE THE GLAZING IS LESS THAN 36" ABOVE THE LANDING AND WITHIN A 60" HORIZONTAL ARC LESS THAN 180 DEGREES FROM THE BOTTOM TREAD NOSING SHALL BE CONSIDERED TO BE A HAZARDOUS LOCATION.

I. WHERE GLAZING IS ADJACENT TO A WALKING SURFACE AND A HORIZONTAL RAIL IS INSTALLED AT 34" TO 38" ABOVE THE WALKING SURFACE 2. GLAZING 36" OR MORE MEASURED HORIZONTALLY FROM THE WALKING SURFACE

SMOKE & CARBON MONOXIDE ALARM LOCATIONS

R314.3 LOCATION. SMOKE ALARMS SHALL BE INSTALLED
IN THE FOLLOWING LOCATIONS: I. IN EACH SLEEPING ROOM.
2. OUTSIDE EACH SEPARATE SLEEPING AREA IN THE IMMEDIATE VICINITY OF THE BEDROOMS. 3. ON EACH ADDITIONAL STORY OF THE DWELLING, INCLUDING BASEMENTS BUT NOT INCLUDING CRAWL SPACES AND UNINHABITABLE ATTICS. IN DWELLINGS OR DWELLING UNITS WITH SPLIT LEVELS AND WITHOUT AN INTERVENING DOOR BETWEEN THE ADJACENT LEVELS, A SMOKE ALARM INSTALLED ON THE UPPER LEVEL SHALL SUFFICE FOR THE ADJACENT LOWER LEVEL PROVIDED THAT THE LOWER LEVEL IS LEGG THAN ONE BUILL STORY BELOW THE LOWER LEVEL IS LESS THAN ONE FULL STORY BELOW THE UPPER LEVEL. WHEN MORE THAN ONE SMOKE ALARM IS REQUIRED TO BE INSTALLED WITHIN AN INDIVIDUAL DWELLING UNIT THE ALARM DEVICES SHALL BE INTERCONNECTED IN SUCH A MANNER THAT THE ACTUATION OF ONE ALARM WILL ACTIVATE ALL OF THE ALARMS IN THE INDIVIDUAL UNIT.

R315.3 REQUIRED LOCATIONS, CARBON MONOXIDE ALARMS SHALL BE PROVIDED IN THE FOLLOWING LOCATIONS: I. WITHIN EACH DWELLING UNIT ON EACH STORY CONTAINING A SLEEPING AREA, WITHIN 10 FEET OF THE SLEEPING AREA, MORE THAN ONE CARBON MONOXIDE ALARM SHALL BE PROVIDED WHERE NECESSARY TO ASSURE THAT NO SLEEPING AREA ON A STORY IS MORE THAN 10 FEET AWAY FROM A CARBON MONOXIDE ALARM. 2. ON ANY STORY OF A DWELLING UNIT THAT CONTAINS A CARBON MONOXIDE SOURCE.

HEADER SCHEDULE UNLESS OTHERWISE NOTED

OPENIN	16	2X6 WALL	2X4 WALL
IP TO	4'-0"	(3) 2X8	(2) 2X8
	5'-0"	(3) 2X8	(2) 2X8
	6'-0"	(3) 2XIO	(2) 2XIO
	7'-0"	(3) 2XIO	(2) 2XI2
	8'-0"	(3) 2XI2	(2) 2XI2

0-0 (3) 2/12	(2/ 2/12
PROVIDE (2) 1/2" PLY. MD. GUS	CETC OVE MALL
PROVIDE (2) 1/2 PET. NO. 000	SLIS -ZAO MALL
PROVIDE (I) 1/2" PLY. WD. GUSS	ETS -2X4 WALL
GLUE AND NAIL ALL HEADERS	
A	
	NII)

WALL L	_EG	END
2X6 STUDS AT 16" OC W/ INSULATION	\boxtimes	WITH SOLID BEARI
2X6 STUDS AT 16" OC (INTERIOR WALL)		BELOW
2X4 STUDS @ 16"O.C.		(3) STUDS GLUE AN

USE SIMPSON OR EQUAL METAL HANGERS AT ALL HDR CONNECTIONS

PROVIDE MINIMUM 22" X 30" ATTIC ACCESS PANEL TO COMPLY WITH R807.1 LOCATION TO BE DETERMINED STATES FOR TOWNER



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AS WELL AS THE ARRANGEMENT AND COMPOSITIO

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MARCH 16, 2021

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KETONIS RESIDENCE LOT 106 MALVERN HILLS

CLIENT:


KETMAR DEVELOPMENT CORP

DRAWING: SECOND FLOOR PLAN

DRAWN:		CHECKED:
AIAMLA		X
DATE:	MAF	RCH 2021
SCALE:	1/4"	'= '-O"
JOB NO.:	201	M3976
SHEET:		

of 12 SHEETS



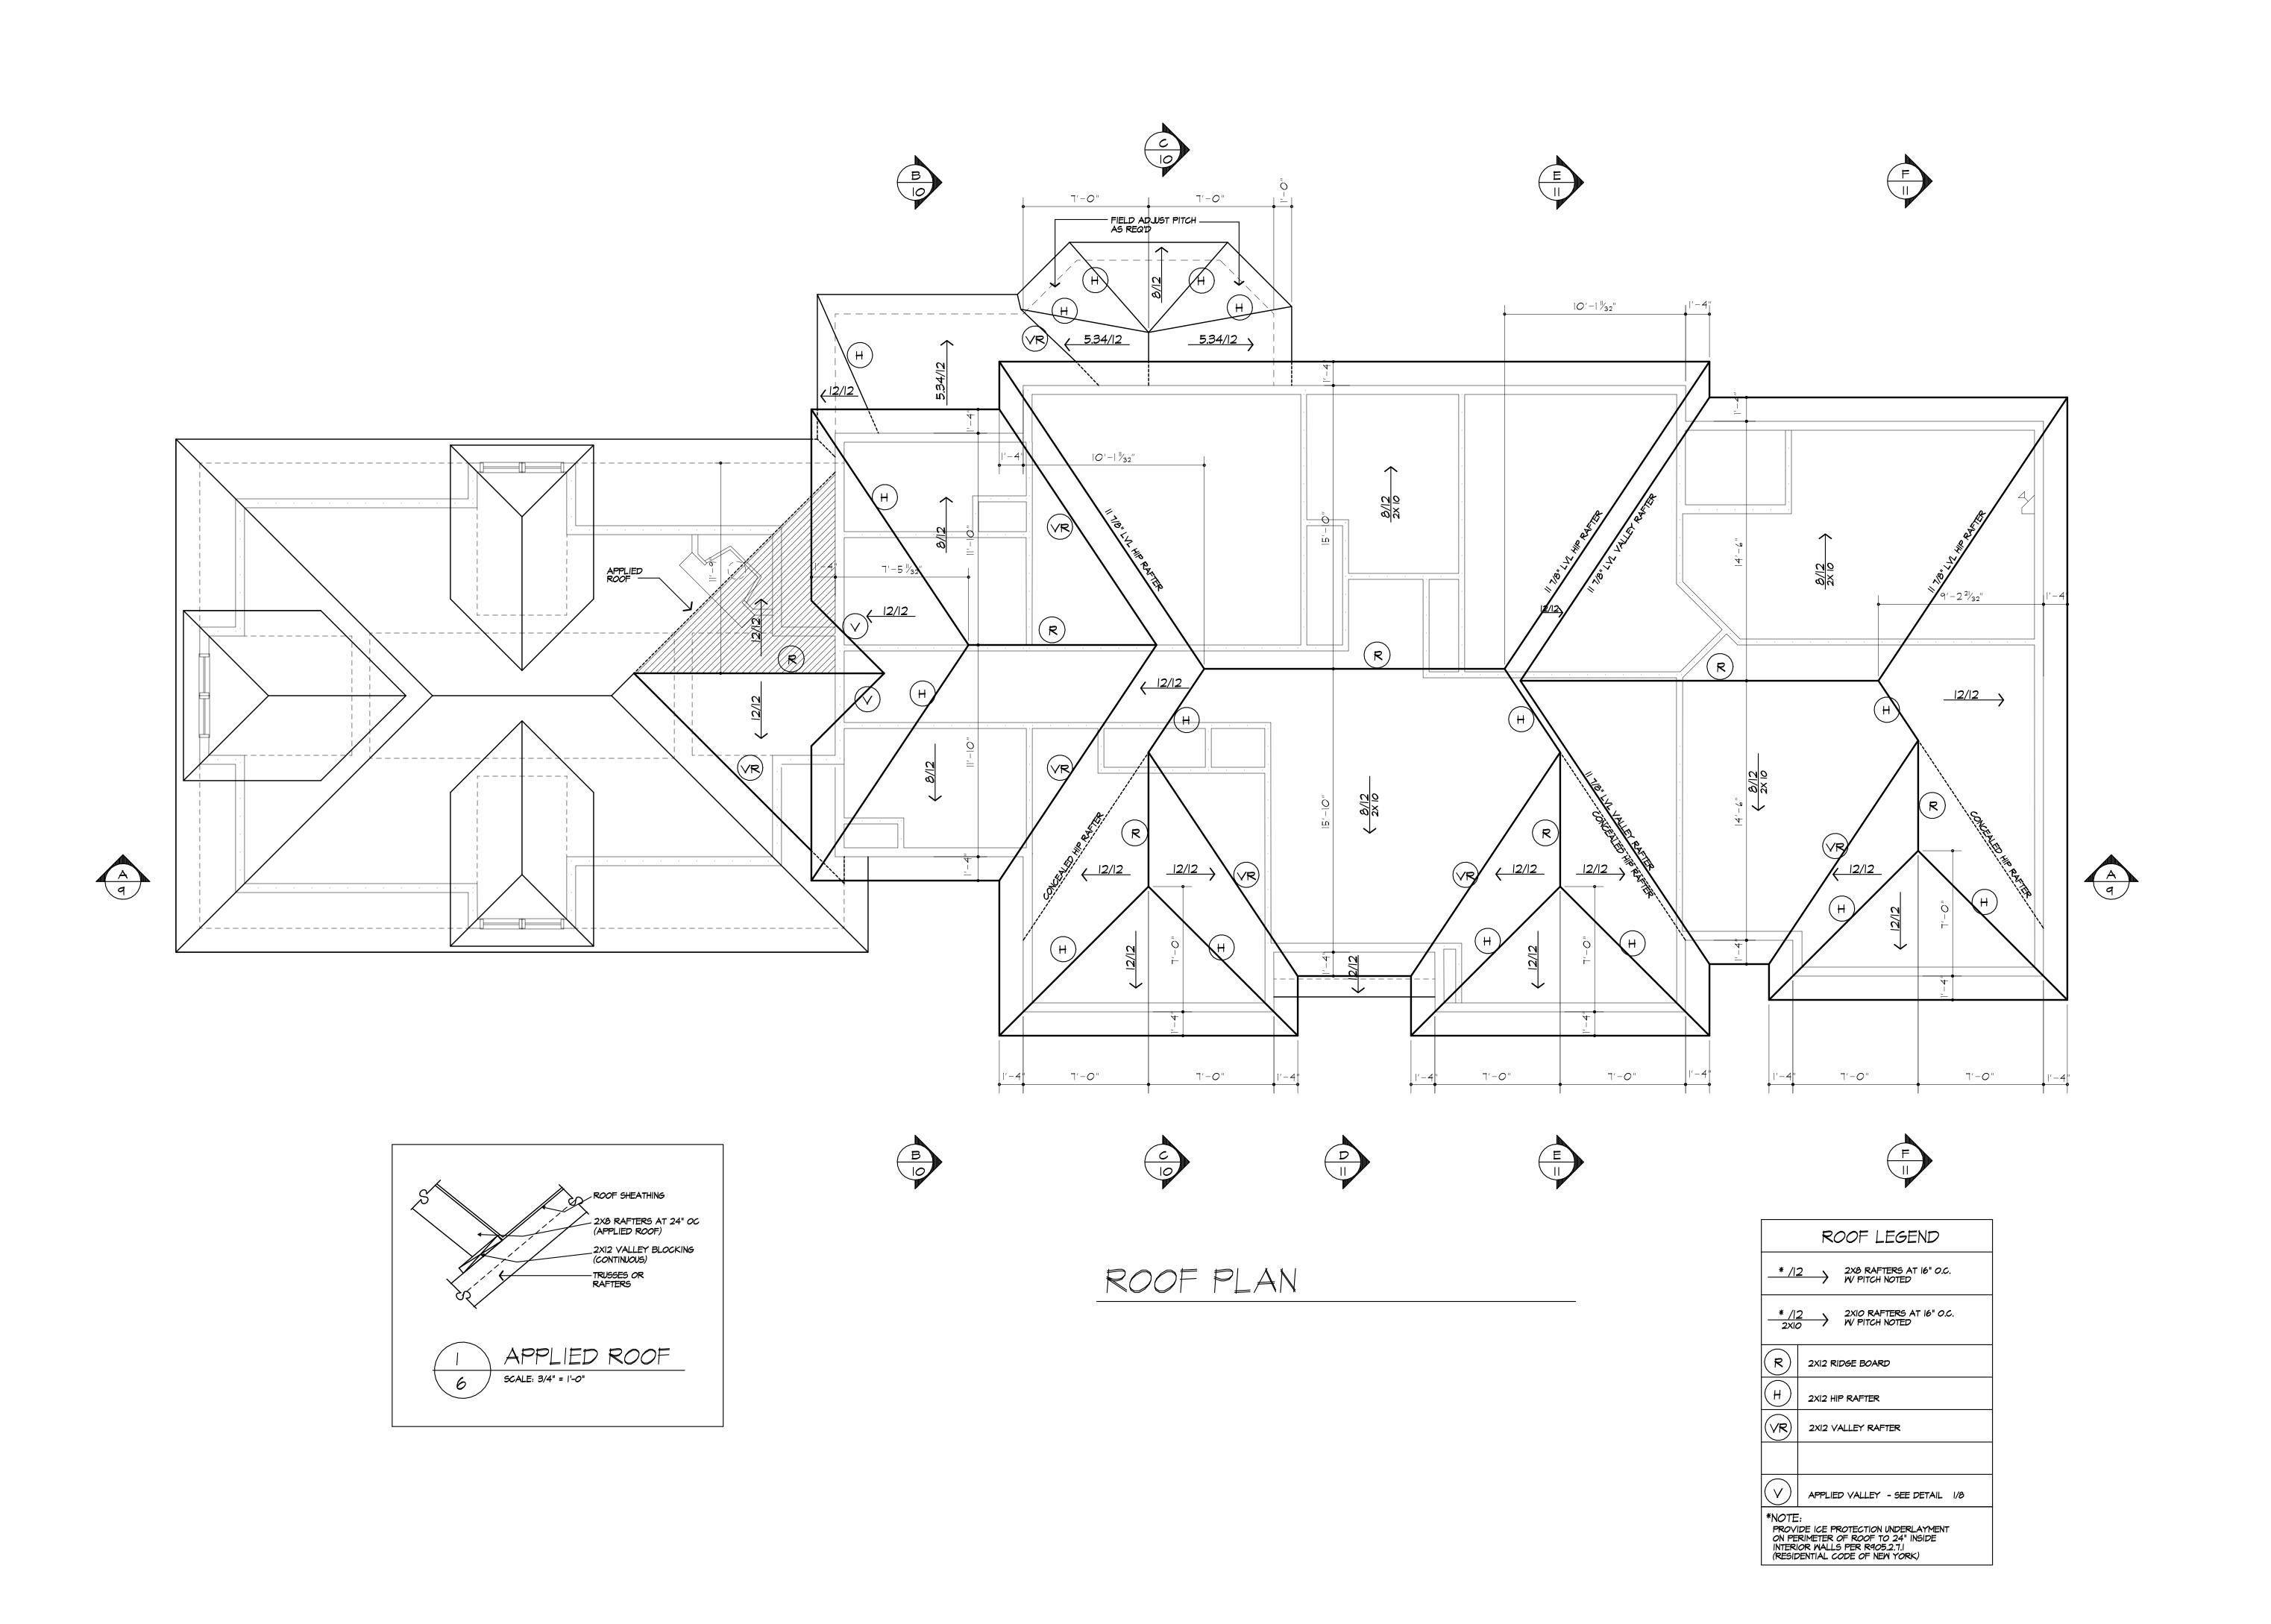



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MARCH 16, 2021

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PROJECT:
KETONIS RESIDENCE
LOT 106 MALVERN HILLS

CLIENT:

KETMAR DEVELOPMENT CORP

DRAWING:

DRAWN: CHECKED:

DATE: MARCH 2021

SCALE: 1/4"=1'-0"


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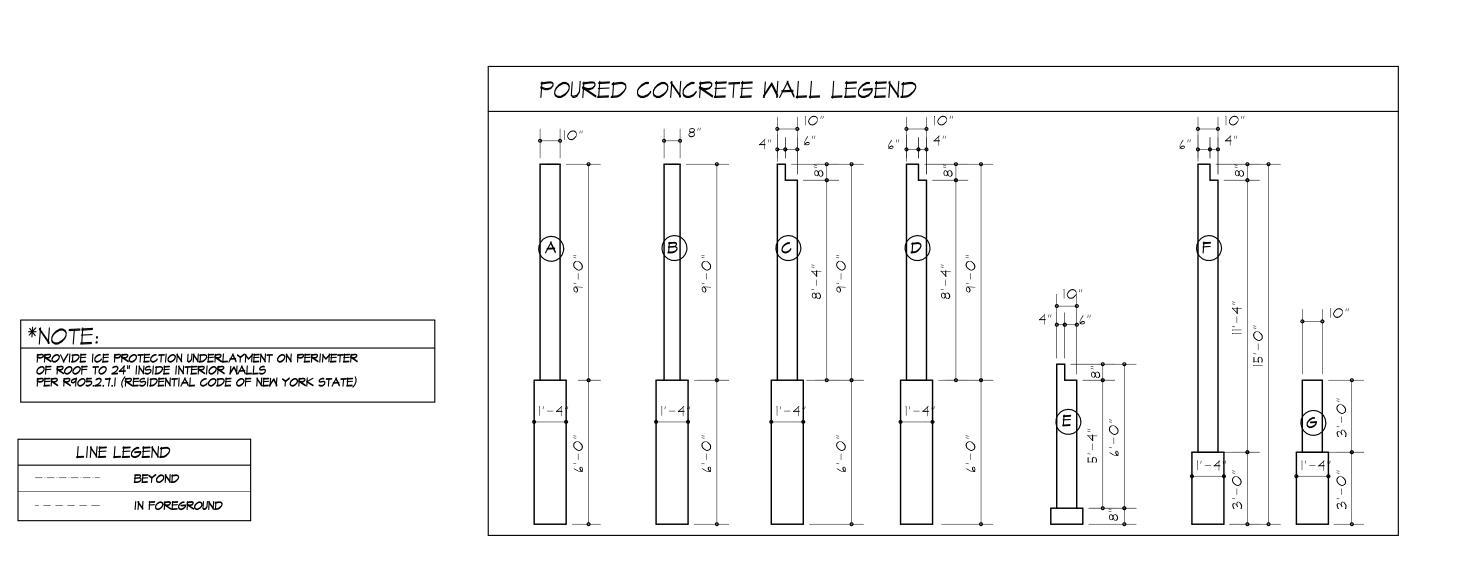
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PROJECT: KETONIS RESIDENCE LOT 106 MALVERN HILLS

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BUILDING SECTIONS

DRAWN: CHECKED:

PJMAIA X

DATE: MARCH 2021
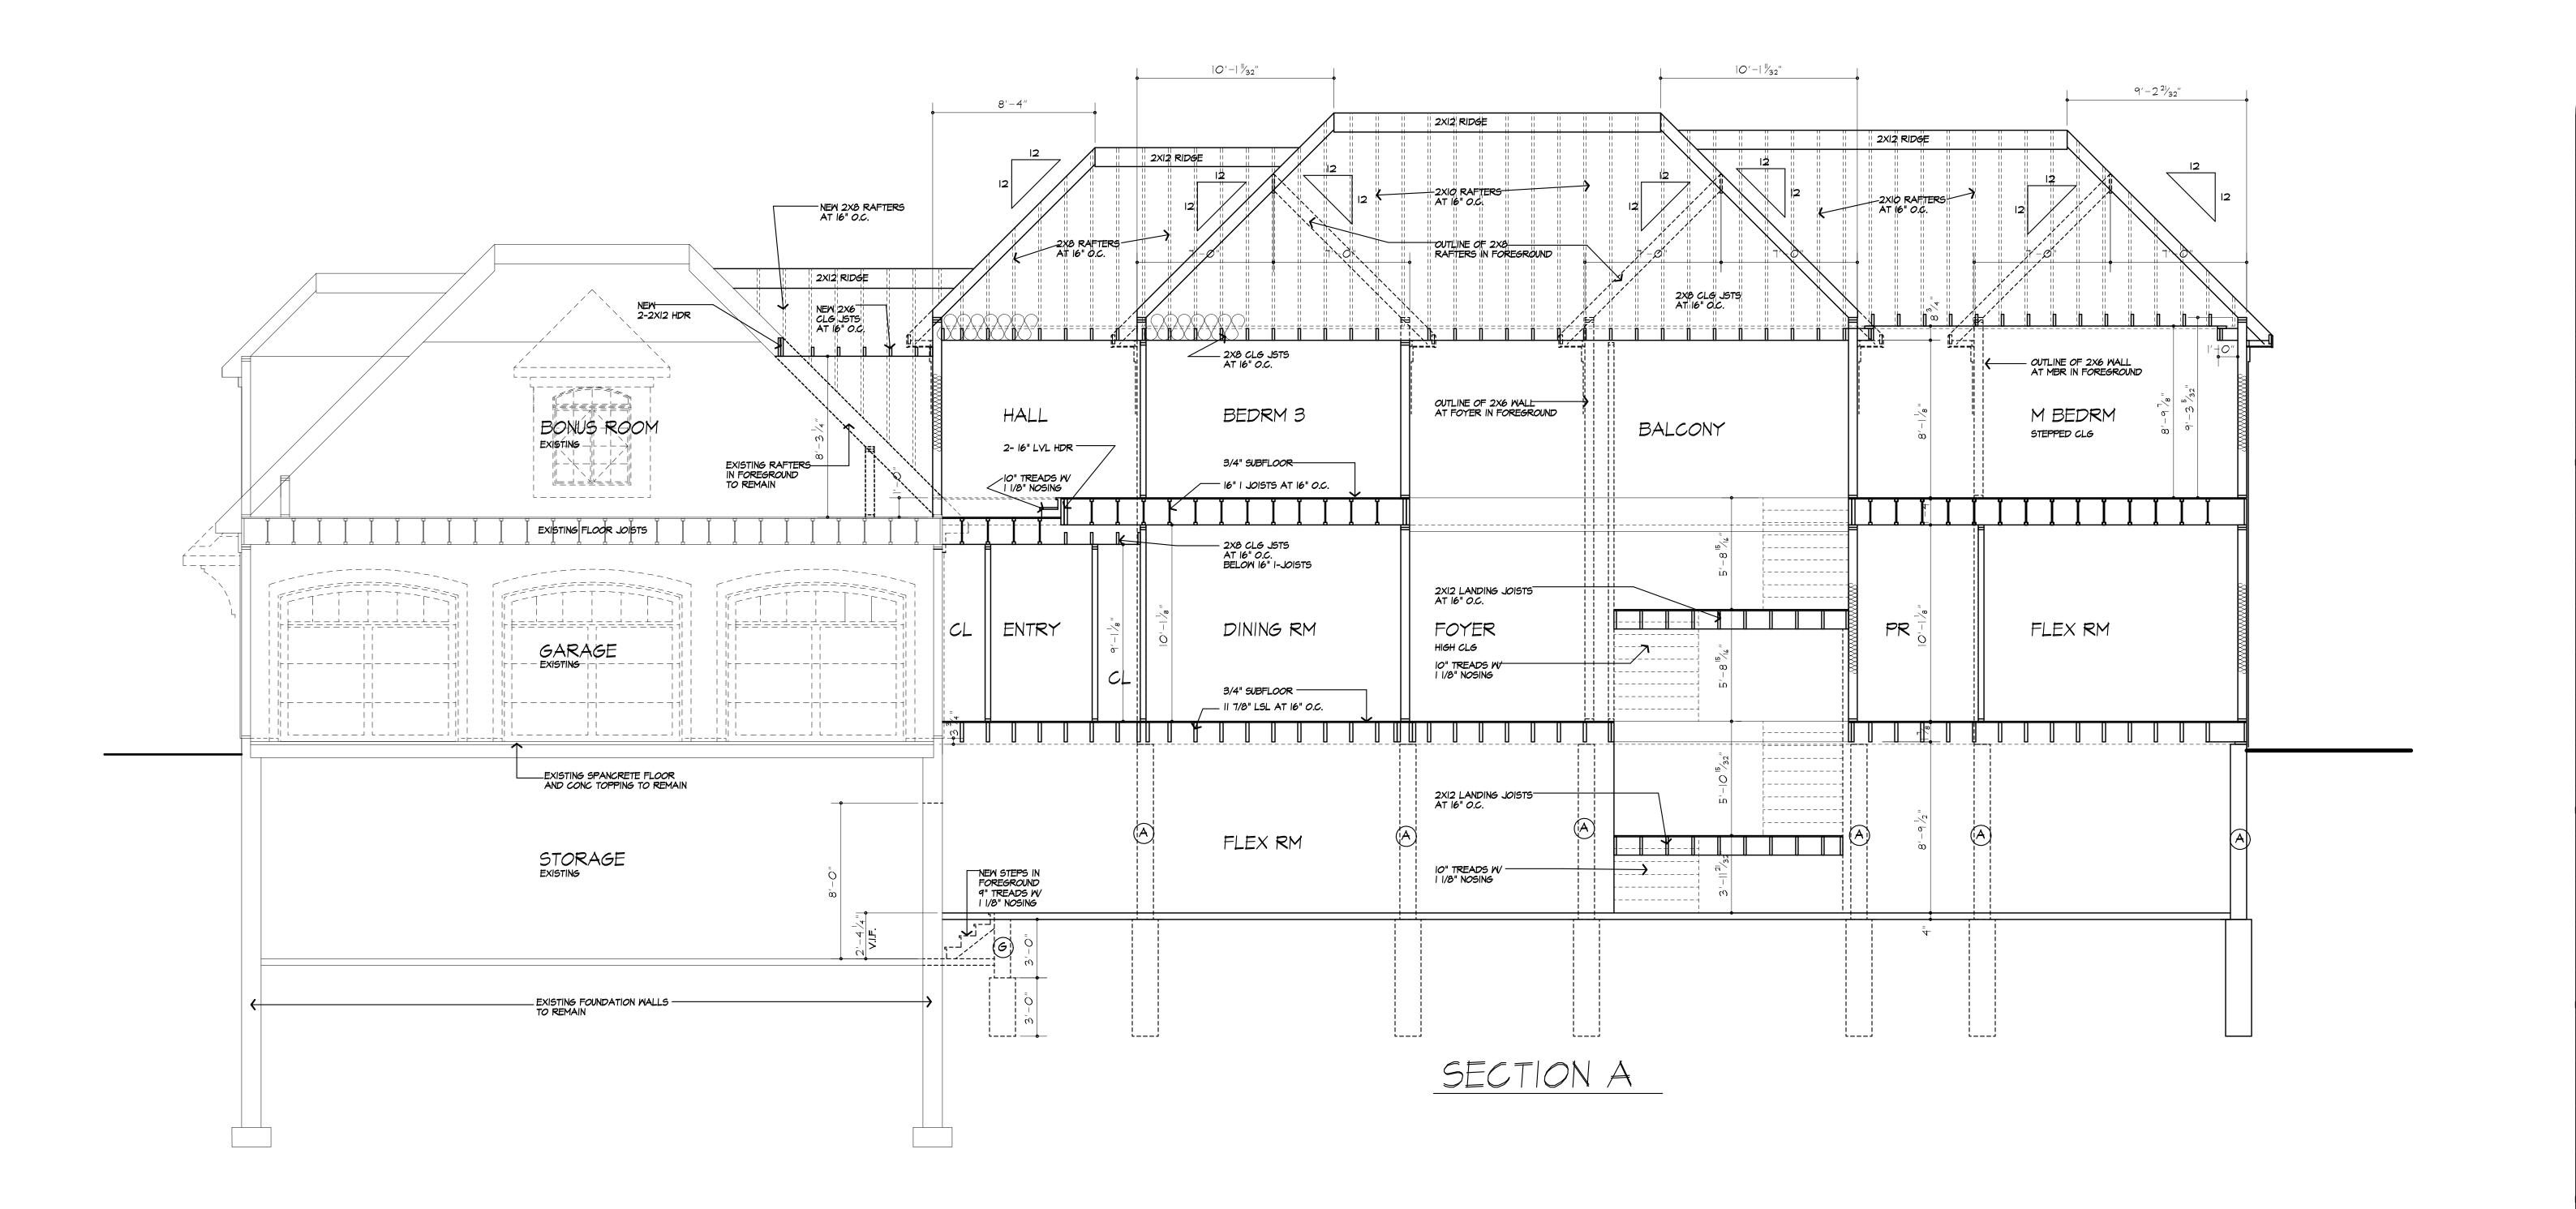
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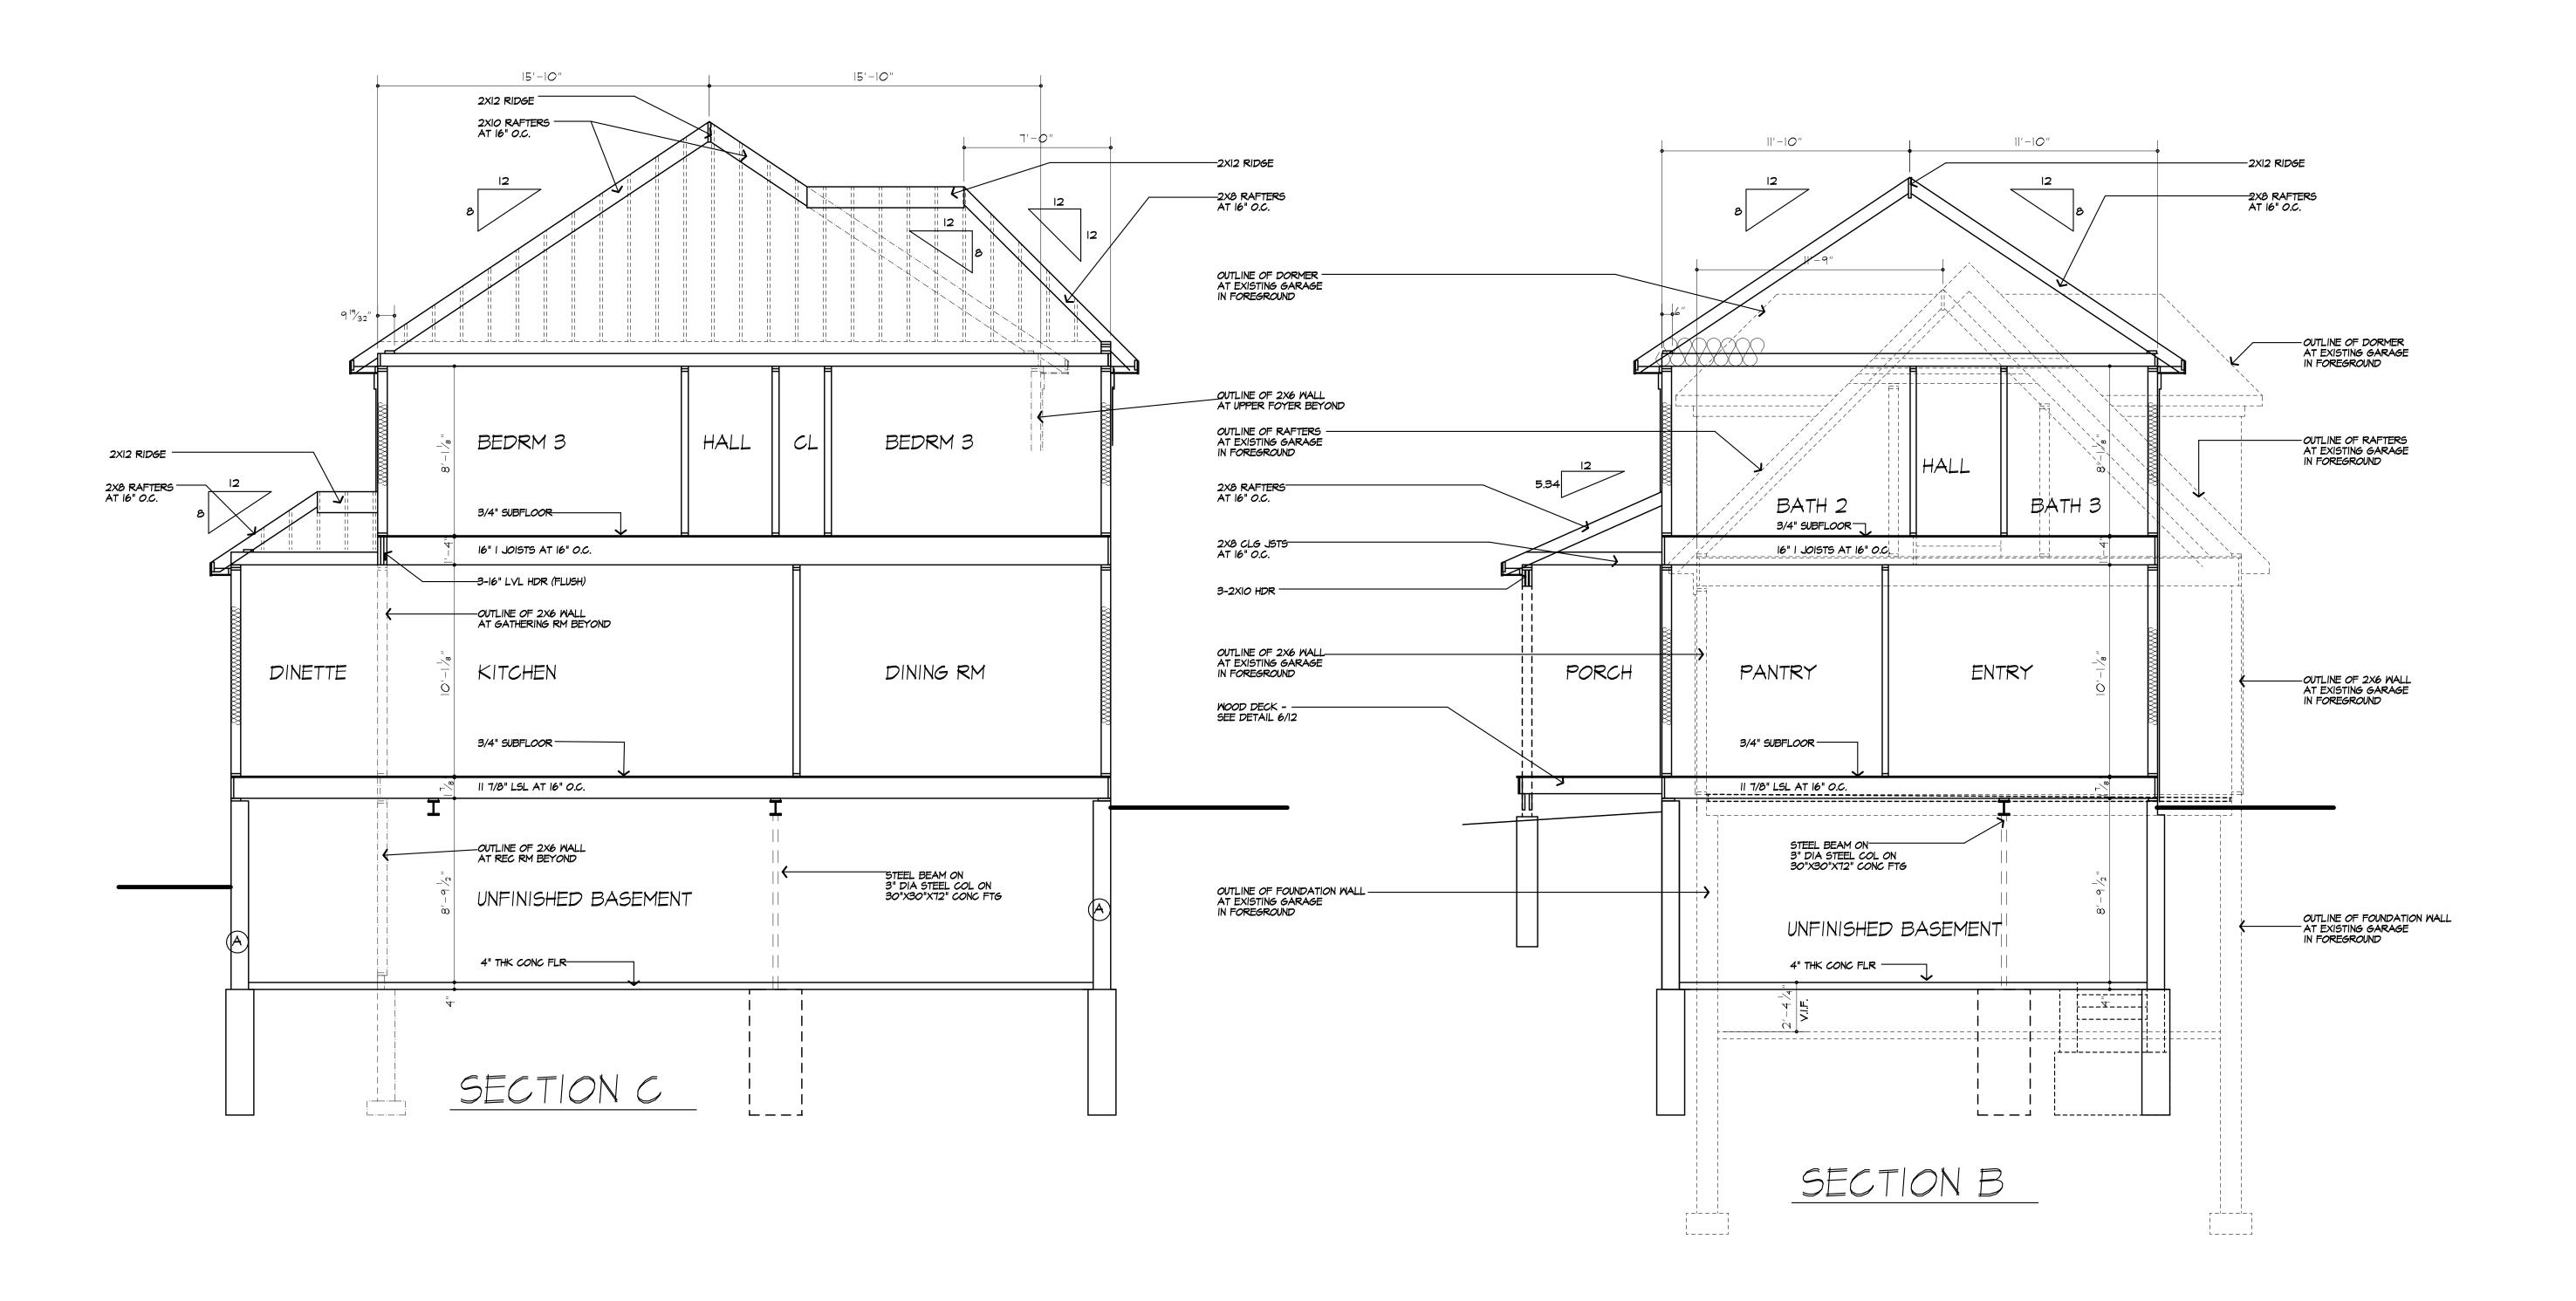
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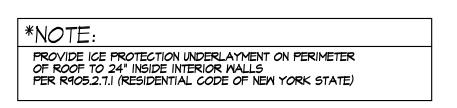
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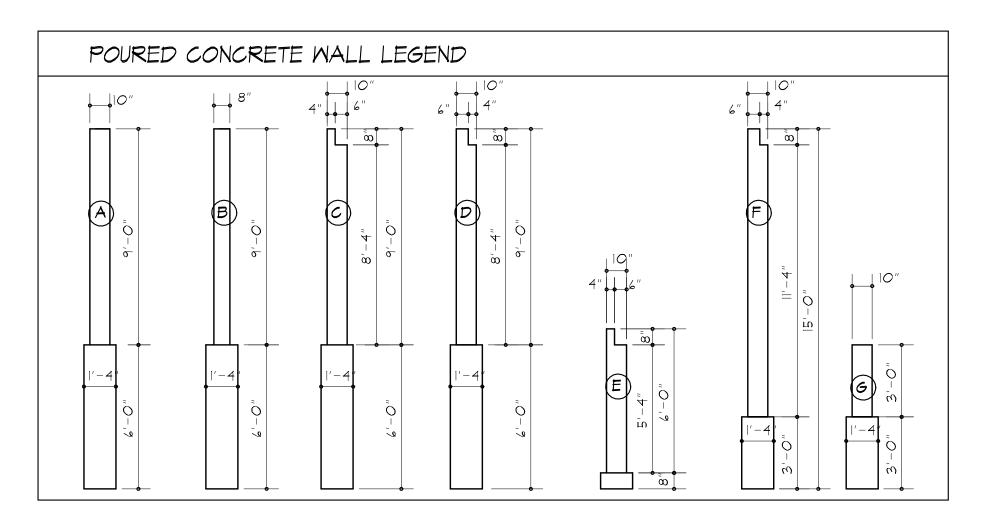
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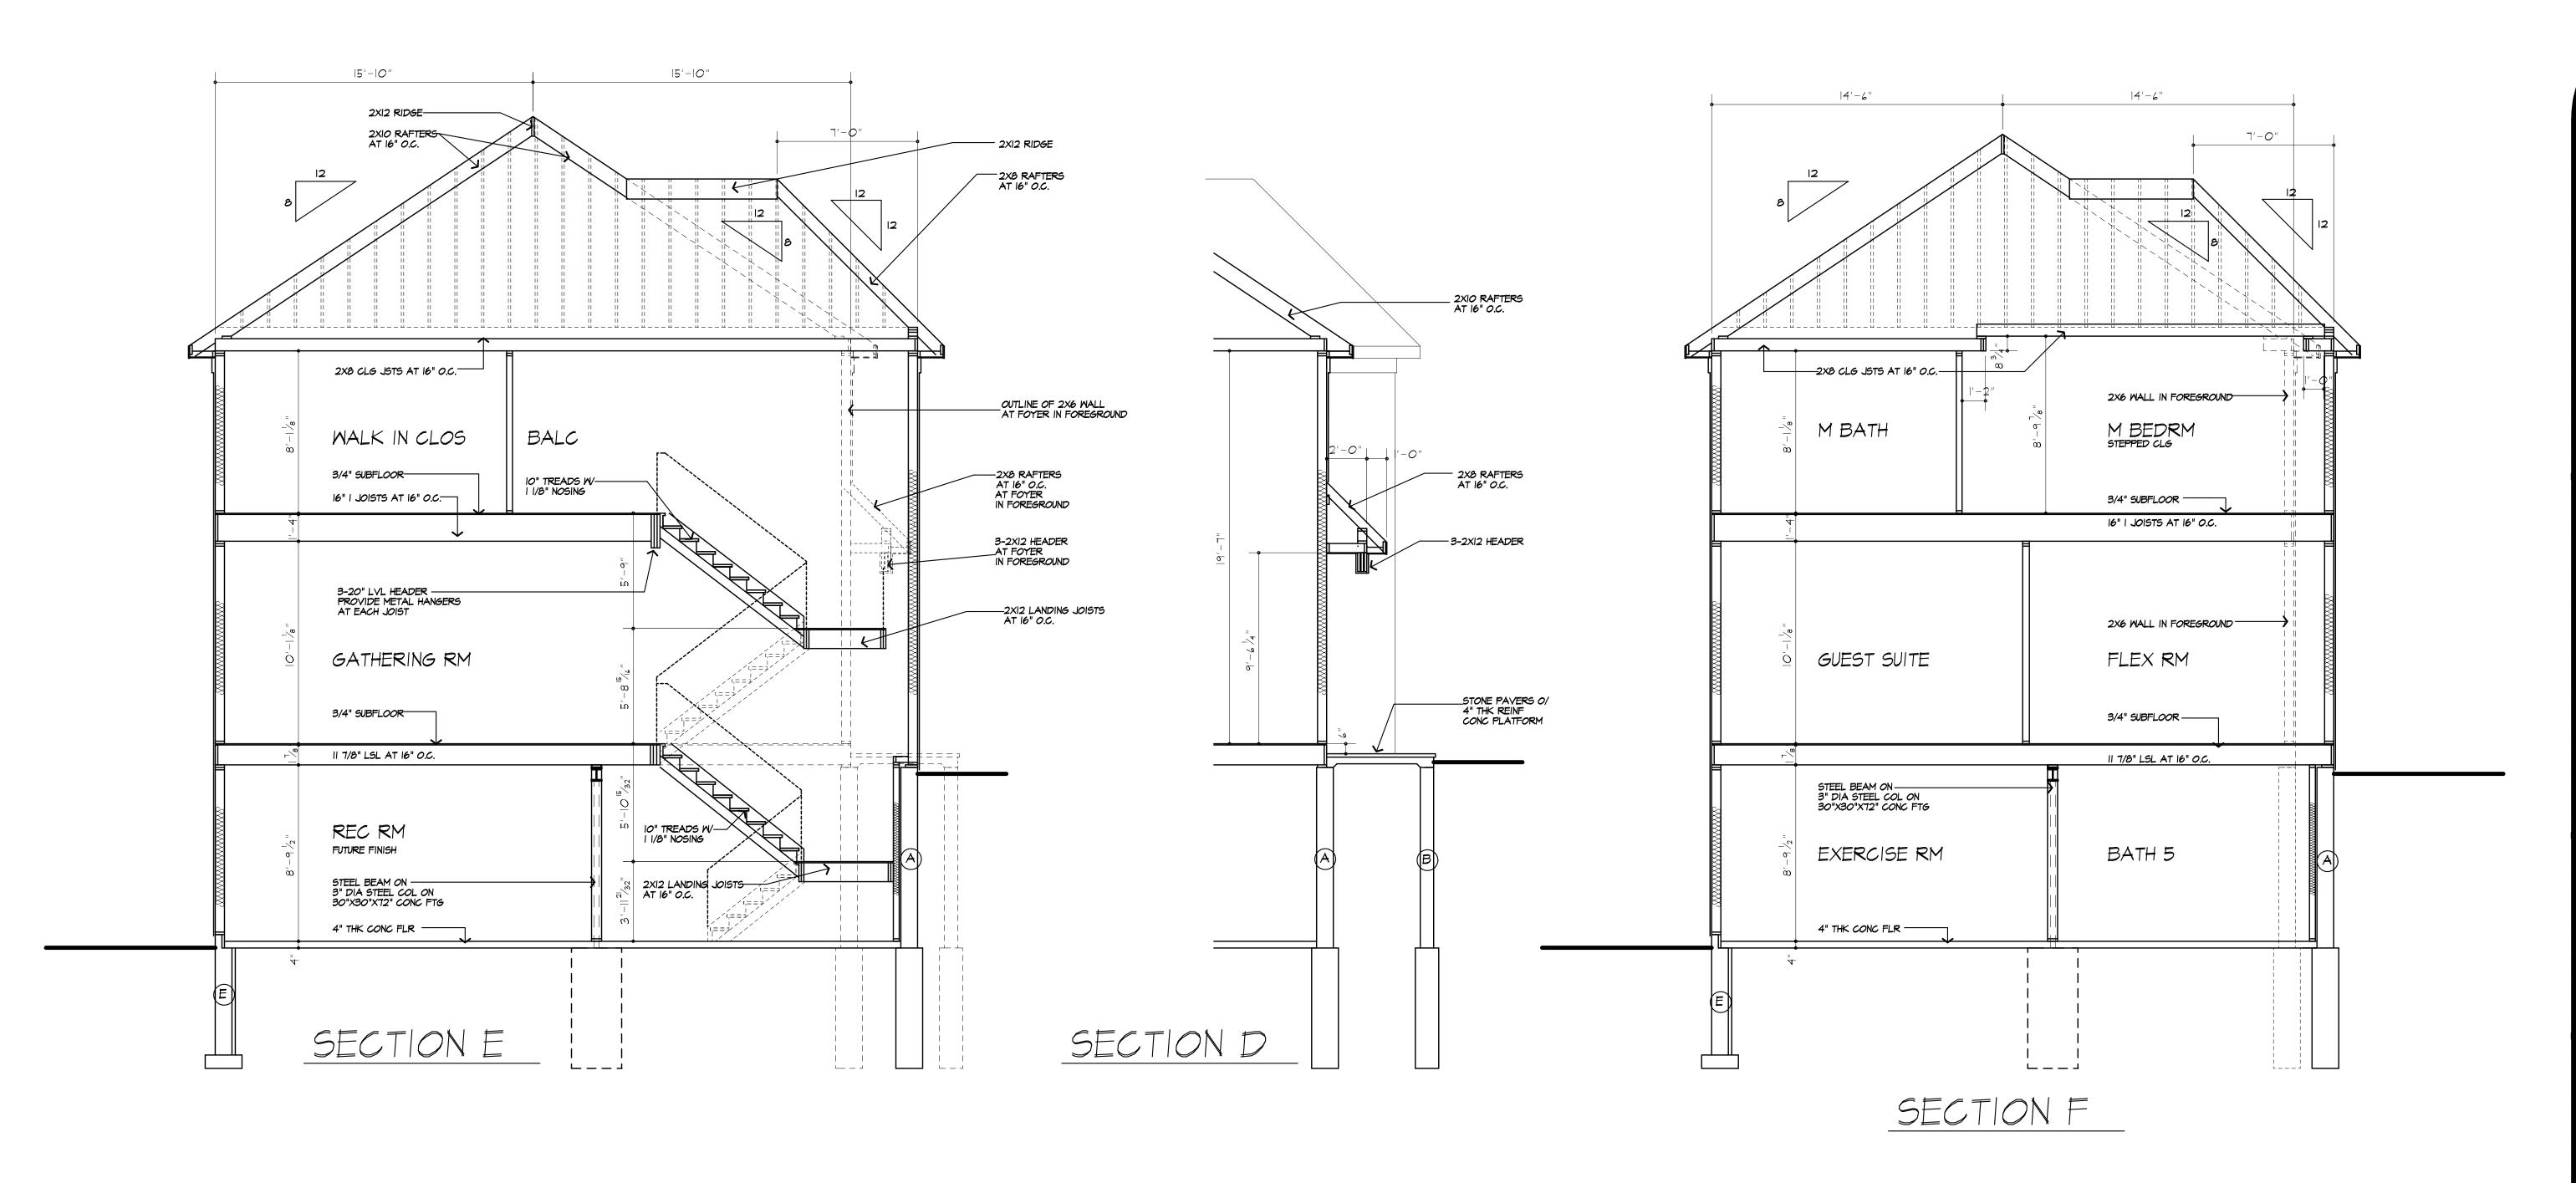
CHECKED: AIAMLA DATE: MARCH 2021


SCALE: 1/4"=1'-0" 20M3976

JOB NO.: SHEET:

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*NOTE: PROVIDE ICE PROTECTION UNDERLAYMENT ON PERIMETER OF ROOF TO 24" INSIDE INTERIOR WALLS PER R905.2.7.1 (RESIDENTIAL CODE OF NEW YORK STATE)

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	BEYOND					
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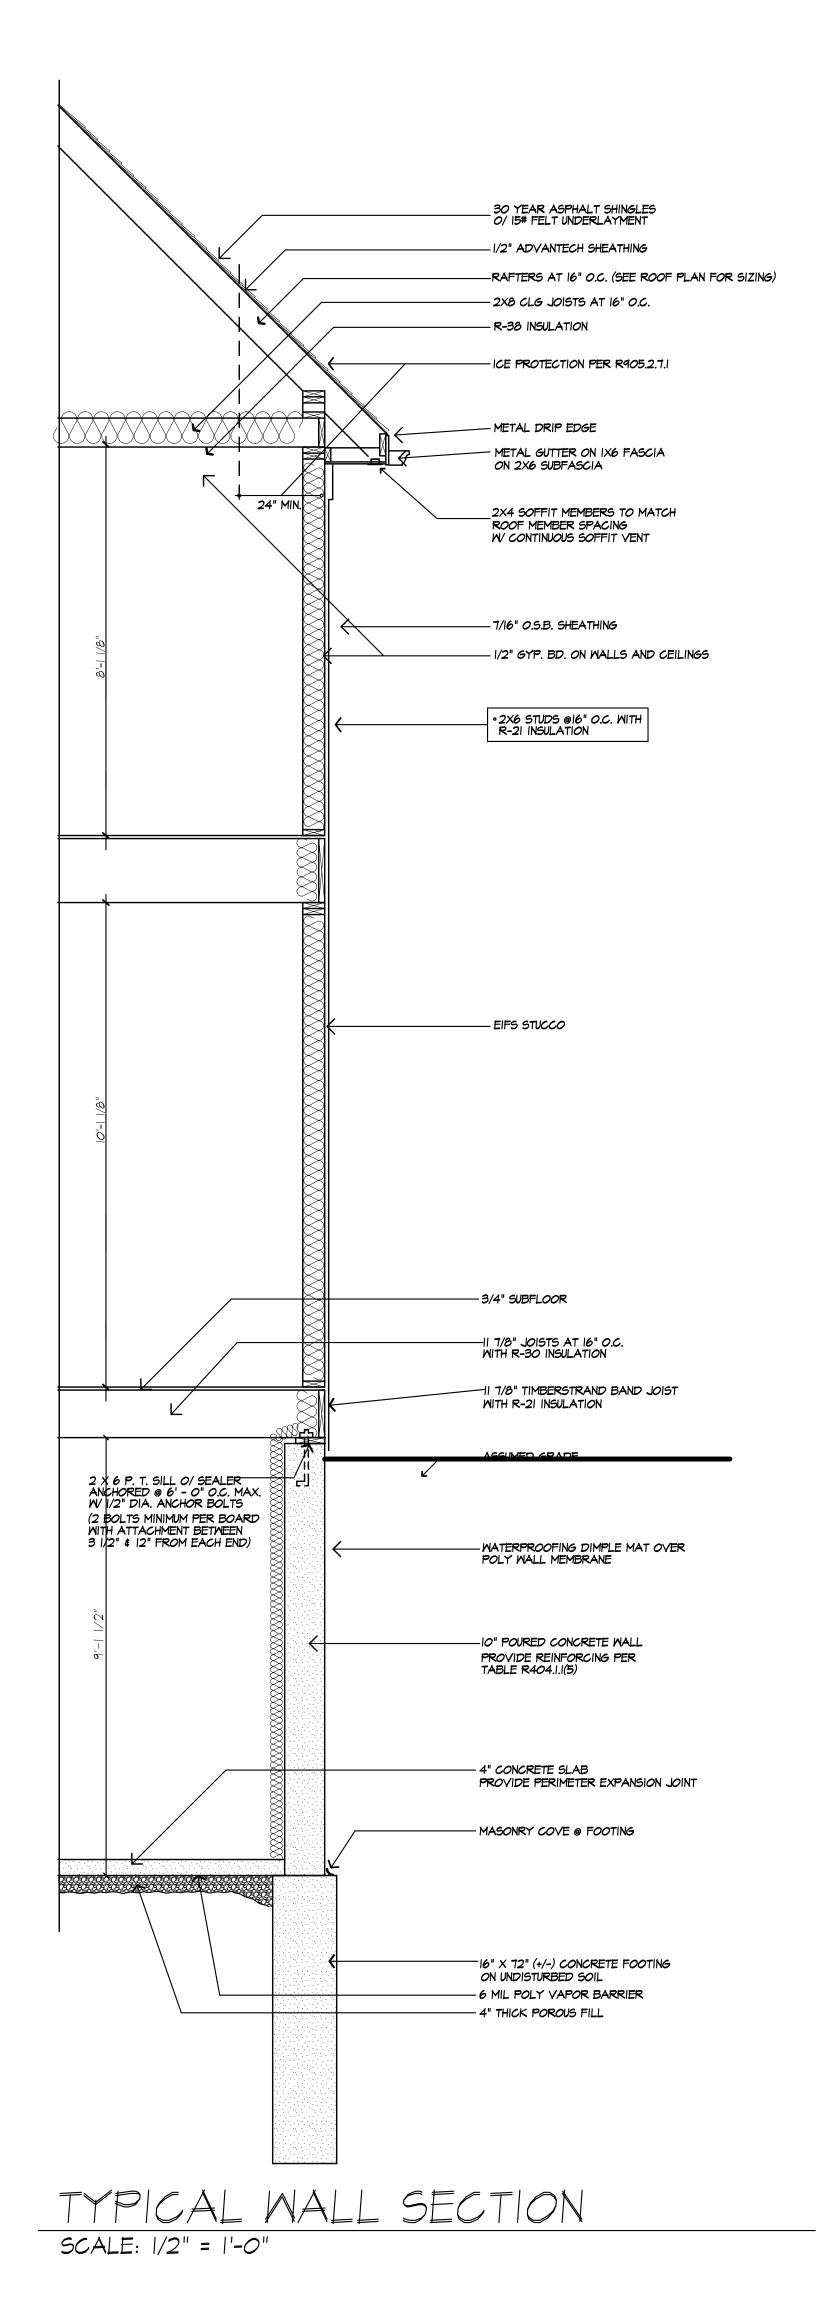
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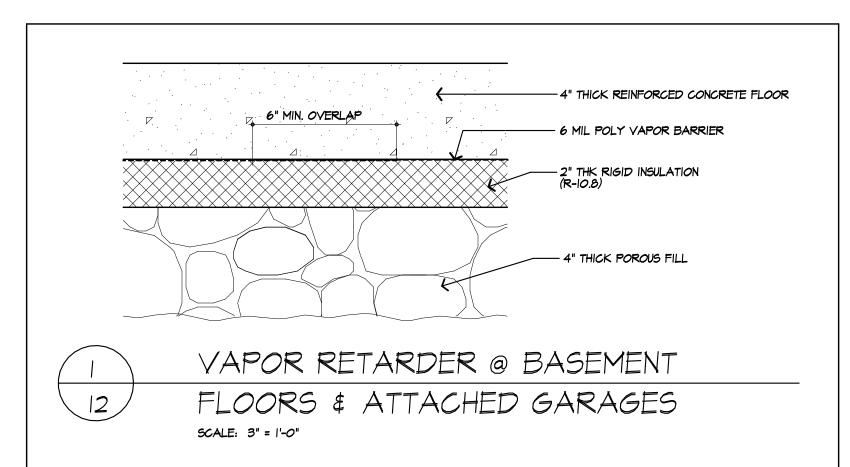
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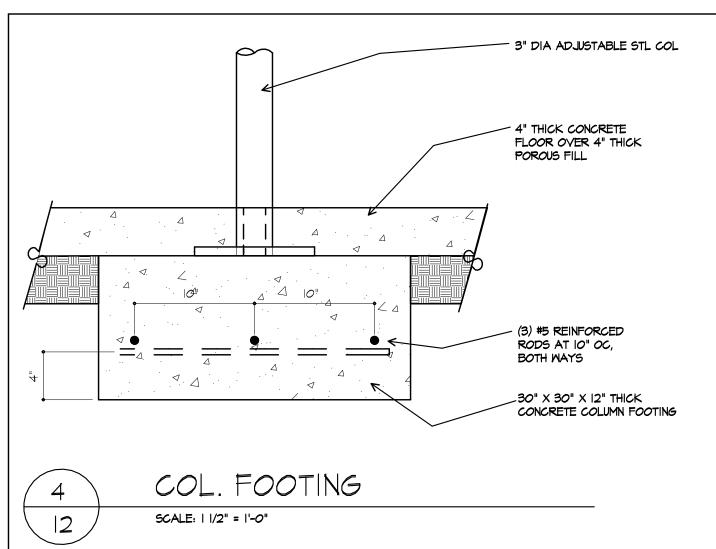
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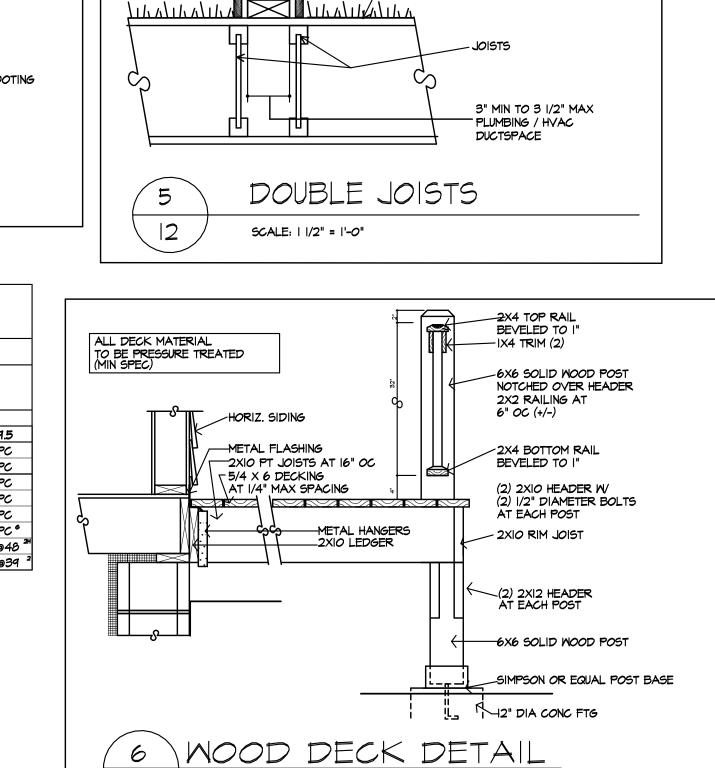




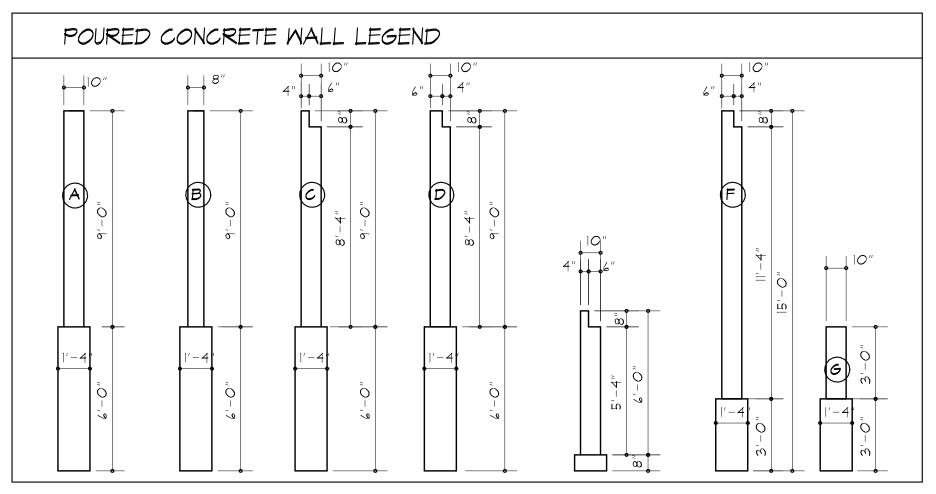

		MINIMUM VERTICAL REINFORCEMENT SIZE AND SPACING (C, D, E, F, L)											
			SOIL	CLASSES	(A) A	ND DESIGN	LATERAL	SOIL (PSF I	PER FOOT	OF DEPTH	ı		
MALL	HEIGHT OF UNBALANCED	HEIGHT OF GW, GP, SW NBALANCED AND SP SOILS			GM, GC, SM, SM- SC AND ML SOILS			SC, ML-CL AND INORGANIC CL SOILS					
HEIGHT	BACKFILL (E)		30					45 60					
						MIN	NIMUM MA	LL THICKI	NESS				
		5.5	7.5	9.5	11.5	5.5	7.5	9.5	4 .5	5.5	7.5	9.5	9.5
5'-0"	4'-0" OR LESS	PC	PC	PC	PC	PC	PC	PC	PC	PC	PC	PC	PC
	5'-0"	PC	PC	PC	PC	PC	PC	PC	PC	PC	PC	PC	PC
	4'-0" OR LESS	PC	PC	PC	PC	PC	PC	PC	PC	PC	PC	PC	PC
9'-0"	5'-0"	PC	PC	PC	PC	#4@35 ²	PC °	PC	PC	#5@40 ²	PC	PC =	PC
	6'-0"	#4@34 ²	PC °	PC	PC	#6@48 2	PC	PC	PC	#6@36 ²	#5@39	PC 6	PC
	7'-0"	#5@36 ²	PC	PC	PC	#6@34 ²	#5@37 ²	PC	PC	#6@33 ²	#6@38	² #5@37	PC °
	8'-0"	#6@38 ²	#5@41 2	PC°	PC	#6@33 ²	#6@38	² #5@37 ²	PC °	#6@24 ²	#7@39	#6@39	*#4@48 ^{2H}
	9'-0"	#6@34 ²	#6@46 ²	PC	PC	#6@26 ²	#7@41 ²	#6941 2	PC	#6@19 2	#7@31 2		#6@39 ²

- FOR SI: | INCH = 25.4 MM, | FOOT = 304.8 MM, | POUND PER SQUARE FOOT = 0.0479 KPA; I POUND PER SQUARE FOOT PER FOOT =
- A. SOIL CLASSES ARE IN ACCORDANCE WITH THE UNITED SOIL CLASSIFICATION SYSTEM. REFER TO TABLE R405.1
- B. UNBALANCED BACKFILL HEIGHT IS THE DIFFERENCE IN HEIGHT OF THE EXTERIOR AND INTERIOR FINISH GROUND LEVELS, WHERE THERE IS AN INTERIOR CONCRETE SLAB, THE UNBALANCED BACKFILL HEIGHT SHALL BE MEASURED FROM THE EXTERIOR FINISH GROUND LEVEL TO THE TOP OF THE INTERIOR CONCRETE SLAB.
- C. THE SIZE AND SPACING OF VERTICAL REINFORCEMENT SHOWN IN THE TABLE IS BASED ON THE USE OF REINFORCEMENT WITH A MINIMUM YIELD STRENGTH OF 60,000 PSI. VERTICAL REINFORCEMENT WITH A MINIMUM YIELD STRENGTH OF 40,000 PSI OR 50,000 PSI IS PERMITTED, PROVIDED THE SAME SIZE BAR IS USED AND THE SPACING SHOWN IN THE TABLE IS REDUCED BY MULTIPLYING THE SPACING BY 0.67 OR 0.83, RESPECTIVELY.
- D. VERTICAL REINFORCEMENT, WHEN REQUIRED, SHALL BE PLACED NEAREST THE INSIDE FACE OF THE WALL A DISTANCE D FROM THE OUTSIDE FACE (SOIL SIDE) OF THE WALL. THE DISTANCE D IS EQUAL TO THE WALL THICKNESS, T, MINUS 1.25 INCHES PLUS ONE-HALF THE BAR DIAMETER, DB (D = T - (1.25 + DB/2), THE REINFORCEMENT SHALL BE PLACED WITHIN A TOLERANCE OF 3/8 INCH WHERE D IS LESS THAN OR EQUAL TO 8 INCHES, OR 1/2 INCH WHERE D IS GREATER THAN 8 INCHES.
- E. IN LIEU OF THE REINFORCEMENT SHOWN, SMALLER REINFORCING BAR SIZES AND CLOSER SPACINGS RESULTING IN AN EQUIVALENT CROSS-SECTIONAL AREA OF REINFORCEMENT PER LINEAR FOOT OF
- F. CONCRETE COVER FOR REINFORCEMENT MEASURED FROM THE INSIDE FACE OF THE WALL SHALL NOT BE LESS THAN 3/4 INCH. CONCRETE COVER FOR REINFORCEMENT MEASURED FROM THE OUTSIDE FACE OF THE WALL SHALL NOT BE LESS THAN 11/2 INCHES FOR NO. 5 BARS AND SMALLER, AND NOT LESS THAN 2 INCHES FOR LARGER BARS.
- G. THE MINIMUM THICKNESS IS PERMITTED TO BE REDUCED 2 INCHES, PROVIDED THE MINIMUM SPECIFIED COMPRESSIVE STRENGTH OF CONCRETE F 'C, IS 4,000 PSI.
- H. A PLAIN CONCRETE WALL WITH A MINIMUM THICKNESS OF 11.5 INCHES IS PERMITTED, PROVIDED MINIMUM SPECIFIED COMPRESSIVE STRENGTH OF CONCRETE, F 'C , IS 3,500 PSI.
- I. CONCRETE SHALL HAVE A SPECIFIED COMPRESSIVE STRENGTH OF NOT LESS THAN 2,500 PSI AT 28 DAYS, UNLESS A HIGHER STRENGTH IS REQUIRED BY NOTE G OR H.
- J. "DR" MEANS DESIGN IS REQUIRED IN ACCORDANCE WITH ACI 318 OR ACI 332.
- K. "PC" MEANS PLAIN CONCRETE.
- L. WHERE VERTICAL REINFORCEMENT IS REQUIRED, HORIZONTAL REINFORCEMENT SHALL BE PROVIDED IN ACCORDANCE WITH THE REQUIREMENTS OF SECTION R404.4.6.2 FOR ICF FOUNDATION WALLS.



SCALE: 3/4" = 1"-0"

AIR BARRIER DETAIL

~2X4 STUD WALL PARALLEL

TO JOIST DIRECTION

BAND/RIM JOIST

SCALE: | |/2" = |'-0"

12


TYVEK INFILTRATION BARRIER

TAPE ALL SEAMS

TYVEK TAPE

CAULK BEHIND BOTTOM

EDGE OF SHEATHING

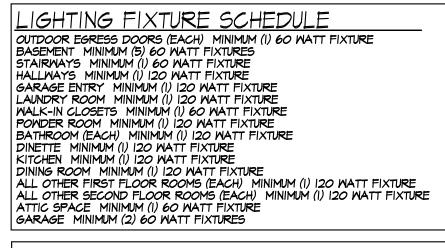

IGHTING FIXTURE CONTROL NARRATIVE AT LEAST ONE WALL SWITCH-CONTROLLED LIGHTING OUTLET SHALL BE INSTALLED IN EVERY HABITABLE ROOM AND BATHROOM. AT LEAST ONE WALL-SMITCH-CONTROLLED LIGHTING OUTLET SHALL BE INSTALLED IN HALLWAYS, STAIRWAYS, ATTACHED GARAGES, AND DETACHED GARAGES WITH ELECTRICAL POWER. AT LEAST ONE WALL-SWITCH-CONTROLLED LIGHTING OUTLET SHALL BE INSTALLED TO PROVIDE ILLUMINATION ON THE EXTERIOR SIDE OF EACH OUTDOOR EGRESS DOOR HAVING GRADE LEVEL ACCESS, INCLUDING OUTDOOR EGRESS DOORS FOR ATTACHED AND DETACHED GARAGES WITH ELECTRICAL POWER, WHERE ONE OR MORE LIGHTING OUTLETS ARE INSTALLED FOR INTERIOR STAIRWAYS, THERE SHALL BE A WALL SWITCH AT EACH FLOOR LEVEL AND LANDING LEVEL THAT INCLUDES AN ENTRYMAY TO CONTROL THE LIGHTING OUTLETS WHERE THE STAIRWAY BETWEEN FLOOR LEVELS HAS SIX OR MORE RISERS. IN ATTICS, UNDER-FLOOR SPACES, UTILITY ROOMS AND BASEMENTS, AT LEAST ONE LIGHTING OUTLET SHALL BE INSTALLED WHERE THESE SPACES ARE USED FOR STORAGE OR CONTAIN EQUIPMENT REQUIRING SERVICING. SUCH LIGHTING OUTLET SHALL BE CONTROLLED BY A WALL SWITCH OR SHALL HAVE AN INTEGRAL SWITCH. AT LEAST ONE POINT OF CONTROL SHALL BE AT THE USUAL POINT OF ENTRY TO THESE SPACES. THE LIGHTING OUTLET SHALL BE PROVIDED AT OR NEAR THE EQUIPMENT REQUIRING SERVICING.

TYPICAL NOTES I.) DOOR MANUFACTURER: PELLA OR EQUAL 2.) WINDOW AND DOOR AIR INFILTRATION PELLA WINDOWS: OR EQUAL DOUBLE HUNG 0.30 CFM

CASEMENT, AMNING, FIXED 0.05 CFM DOORS: 0.30 CFM OR LESS SLIDING 0.10 CFM IN-SWING HINGED 0.15 CFM 3.) GAS FIREPLACE(S): HEAT-N-GLO 6000C DIRECT VENT

- TIGHT FITTING NON CUMBUSTABLE FIREPLACE DOORS TO CONTROL INFILTRATION LOSSES SHALL BE INSTALLED ON FIREPLACE OPENINGS- FIREPLACES SHALL BE PROVIDED WITH A SOURCE OF COMBUSTION AIR AS REQUIRED BY THE RESIDENTIAL CODE OF NEW YORK STATE
- 4.) JOINTS IN DUCT SYSTEM SEALED WITH MASTIC, TAPE OR GASKETING. 5.) CLASS II VAPOR RETARDER ON INTERIOR OF CEILINGS AND 2X6 FRAMED
- 6.) MECHANICAL SYSTEM PIPING CAPABLE OF CARRYING FLUIDS ABOVE 105F OR BELOW 55F SHALL BE INSULATED TO A MINIMUM OF R-3.
- 7.) BUILDING CAVITIES SHALL NOT BE USED FOR SUPPLY DUCTS.
- 8.) DAMPERS INSTALLED ON ALL OUTDOOR INTAKE AND EXHAUST OPENINGS 9.) THE AIR HANDLER AND ALL DUCTS SHALL BE LOCATED WITHIN THE CONDITIONED SPACE. IF ANY DUCTWORK IS LOCATED COMPLETELY OUTSIDE OF THE CONDITIONED SPACE THE DUCT TIGHTNESS SHALL BE

VERIFIED PER SECTION 403.2.2 OF THE 2010 ENERGY CONSERVATION

IO.) ANY SUPPLY DUCTS IN THE ATTICS SHALL BE INSULATED TO A MINIMUM OF R-8. ALL OTHER DUCTS LOCATED COMPLETELY OUTSIDE OF THE BUILDING THERMAL ENVELOPE SHALL BE INSULATED TO A MINIMUM OF R-6. II.) THERE ARE NOT TO BE WATER SUPPLY LINES IN THE EXTERIOR WALLS

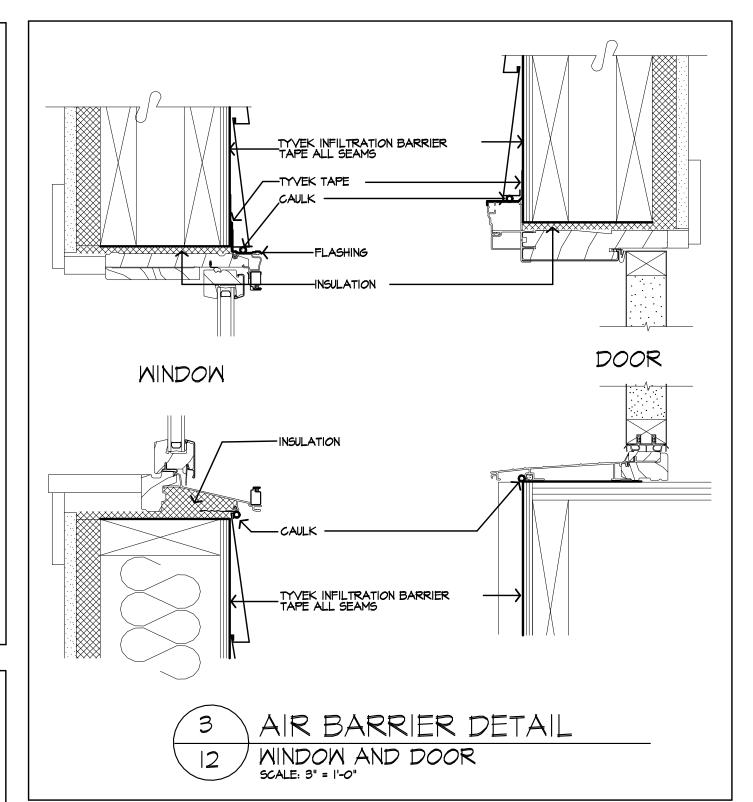


TABLE NIIO2.4.2 AIR BARRIER AND INSULATION INSPECTION

COMPONENT	CRITERIA
AIR BARRIER AND THERMAL BARRIER	EXTERIOR THERMAL ENVELOPE INSULATION FOR FRAMED WALLS IS INSULATED IN SUBSTANTIAL CONTACT AND CONTINOUS ALIGNMENT WITH BUILDING ENVELOPE AIR BARRIER
	BREAKS OR JOINTS IN THE AIR BARRIER ARE FILLED OR REPAIRED
	AIR PERMEABLE INSULATION IS NOT USED AS A SEALING MATERIAL
	AIR PERMEABLE INSULATION IS INSIDE OF AN AIR BARRIER
CEILING/ATTIC	AIR BARRIER IN ANY DROPPED CEILING OR SOFFIT IS SUBSTANTIALLY ALIGNED WITH INSULATION AND ANY GAPS ARE SEALED
WALLS	CORNERS AND HEADERS ARE INSULATED
	JUNCTION OF FOUNDATION AND SILL PLATE IS SEALED
WINDOWS AND DOORS	SPACE BETWEEN WINDOW AND DOOR JAMS AND FRAMING IS SEALED
RIM JOISTS	RIM JOISTS ARE INSULATED AND INCLUDE AN AIR BARRIER
FLOORS - INCLUDING ABOVE GARAGE AND CANTILEVERED FLOORS	INSULATION IS INSTALLED TO MAINTAIN PERMANENT CONTACT WITH UNDERSIDE OF SUBFLOOR DECKING
DANTILLY LINED I LOOKS	AIR BARRIER IS INSTALLED AT ANY EXPOSED EDGE OF INSULATION
CRAWL-SPACE WALLS	INSULATION IS PERMANENTLY ATTACHED TO WALLS
	EXPOSED EARTH IN UNVENTED CRAWL SPACES IS COVERED WITH CLASS I VAPOR RETARDER WITH OVERLAPPING JOINTS TAPED
SHAFTS PENETRATIONS	DUCT SHAFTS, UTILITY PENETRATIONS, KNEE WALLS AND FLUE SHAFTS OPENING TO EXTERIOR OR UNCONDITIONED SPACE ARE SEALED
NARROW CAVITIES	BATTS IN NARROW CAVITIES ARE CUT TO FIT, OR NARROW CAVITIES ARE FILLED BY SPRAYED/BLOWN INSULATION
GARAGE SEPARATION	AIR SEALING IS PROVIDED BETWEEN GARAGE AND CONDITIONED SPACES
RECESSED LIGHTING	RECESSED LIGHT FIXTURES ARE AIR TIGHT, IC RATED, AND SEALED TO DRYWALL. EXCEPTION; FIXTURES IN CONDITIONED SPACE
PLUMBING AND WIRING	INSULATION IS PLACED BETWEEN OUTSIDE AND PIPES
	BATT INSULATION IS CUT TO FIT AROUND WIRING AND PLUMBING, OR SPRAYED/BLOWN INSULATION EXTENDS BEHIND PIPING AND WIRING
SHOWER OR TUB ON EXTERIOR WALL	SHOWERS AND TUBS ON EXTERIOR WALLS HAVE INSULATION AND AN AIR BARRIER SEPARATING THEM FROM THE EXISTING WALL
ELECTRICAL OR PHONE BOX ON EXTERIOR WALLS	AIR BARRIER EXTENDS BEHIND BOXES OR AIR SEALED-TYPE BOXES ARE INSTALLED
COMMON WALL	AIR BARRIER IS INSTALLED IN COMMON WALL BETWEEN DWELLING UNITS
HVAC REGISTER BOOTS	HVAC REGISTER BOOTS THAT PENETRATE BUILDING ENVELOPE ARE SEALED TO SUBFLOOR OR DRYWALL

SMOKE & CARBON MONOXIDE ALARM LOCATIONS

R3I3.I.I LOCATION. SMOKE ALARMS SHALL BE INSTALLED IN THE FOLLOWING LOCATIONS: I. IN EACH SLEEPING ROOM. 2. OUTSIDE EACH SEPARATE SLEEPING AREA IN THE IMMEDIATE VICINITY OF THE BEDROOMS. 3. ON EACH ADDITIONAL STORY OF THE DWELLING, INCLUDING BASEMENTS BUT NOT INCLUDING CRAWL SPACES AND UNINHABITABLE ATTICS. IN DWELLINGS OR DWELLING UNITS WITH SPLIT LEVELS AND WITHOUT AN INTERVENING DOOR BETWEEN THE ADJACENT LEVELS, A SMOKE ALARM INSTALLED ON THE UPPER LEVEL SHALL SUFFICE FOR THE ADJACENT LOWER LEVEL PROVIDED THAT THE LOWER LEVEL IS LESS THAN ONE FULL STORY BELOW THE UPPER LEVEL WHEN MORE THAN ONE SMOKE ALARM IS REQUIRED TO BE INSTALLED WITHIN AN INDIVIDUAL DWELLING UNIT THE ALARM DEVICES SHALL BE INTERCONNECTED IN SUCH A MANNER THAT THE ACTUATION OF ONE ALARM WILL ACTIVATE ALL OF THE ALARMS IN THE INDIVIDUAL UNIT.

R313.4.2 REQUIRED LOCATIONS. CARBON MONOXIDE ALARMS SHALL BE PROVIDED IN THE FOLLOWING LOCATIONS: I. WITHIN EACH DWELLING UNIT ON EACH STORY CONTAINING A SLEEPING AREA, WITHIN 15 FEET OF THE SLEEPING AREA. MORE THAN ONE CARBON MONOXIDE ALARM SHALL BE PROVIDED WHERE NECESSARY TO ASSURE THAT NO SLEEPING AREA ON A STORY IS MORE THAN IS FEET AWAY FROM A CARBON MONOXIDE ALARM. 2. ON ANY STORY OF A DWELLING UNIT THAT CONTAINS A CARBON MONOXIDE SOURCE.



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WALL SECTIONS

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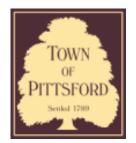
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Town of Pittsford

Department of Public Works 11 South Main Street Pittsford, New York 14534

Permit # CA21-000001

Phone: 585-248-6250 FAX: 585-248-6262

DESIGN REVIEW AND HISTORIC PRESERVATION BOARD REFERRAL OF APPLICATION

Property Address: 70 Mitchell Road PITTSFORD, NY 14534

Tax ID Number: 164.11-2-16.1

Zoning District: RN Residential Neighborhood

Owner: Holcombe, P. Scott Applicant: Holcombe, P. Scott

Α	aa	lic	atio	n T	ype
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rppiicati	on type.	
	dential Design Review 35-205 (B)	Build to Line Adjustment §185-17 (B) (2)
Com	nmercial Design Review 35-205 (B)	Building Height Above 30 Feet §185-17 (M)
Sign §18	age 85-205 (C)	Corner Lot Orientation §185-17 (K) (3)
	ificate of Appropriateness 35-197	Flag Lot Building Line Location §185-17 (L) (1) (c)
§18	dmark Designation 35-195 (2)	Undeveloped Flag Lot Requirements §185-17 (L) (2)
Infor	mal Review	

Project Description: Applicant is requesting a Certificate of Appropriateness, pursuant to Code Section 185-196, for the exterior renovation of a designated historic home. This property is zoned (RN) Residential Neighborhood.

Meeting Date: March 25, 2021



TOWN OF PITTSFORD

Design Review & Historic Preservation Board Application for Certificate of Appropriateness


		Case#_(COFA 20	21-0001			
Property A	Address: 70 M	itchell Road Pi	ttsford NY	14534			
Тах Ассо	unt Number: 16	64.11-2-16.1					
Applicant'	s Name: Kath	leen and Scott	Holcombe				
Address:	70 Mitchell Roa	ad			Phone:	797-5086	
	Pittsford	Street N	Y	14534	_	kathleencholcombed	@gmail.com
	City	S	tate	Zip Code	_ = 111411.	-	
Applicant' Owner:		perty: Lessee:				ase Offer:	
Owner (if a	other than above):						-
Address:		Street			_ Phone:		
		Street					
	City	Si	tate	Zip Code	_ E-mail:		
Has the O	wner been conta	acted by the Ap	plicant?	Yes		No	
Application	n prepared by:	(owners.)					
Address:		Street			Phone:		
		Street	_				
	City	01	tate	Zin Codo	_ E-mail:		
	Ony		tate	Zip Code			
Project De	sign Profession	al (if Available):	Todd Mare	otta/Carini E	Engineerir	ng Designs	, P.C.
Address:	1387 Fairport F	Rd Suite 560			Phone:	223-6420	
	Fairport	Street NY	/	14450	E-mail:	tmarotta@carin	idesigns.c
	City	St	tate	Zip Code			

8.	Project Co	ontractor <i>(if A</i>	/ailable):	Falcon Reno	vations		
	Address:	3 Newcomb	Drive			Phone:	775-1245
		Hilton		Street NY	14468	F	falcon4renovations@gmial.com
		Ci	ty	State	Zip Code	E-maii:	
9.	Present us	se of Propert	y: Stora	age			
10.	Zoning Dis	strict of Prop	erty: Pit	ttsford			
11.	_	perty located ⊠	in a Tov No 【	vn Designated	Historic District	?	
12.	Is the prop	perty listed or	_	tional Registry ⊠	of Historic Plac	es?	
13.	Will State application Yes	or Federal Fin for Tax Cre	dits or o	e used in this ther State and	project, or will th Federal benefit	ne project ros?	esult in an
	If Yes, ple	ase explain:					
14.	Proposed	Exterior Imp	ovemen	its:			
	A. Desc proje	cribe all exter ect materials	ior archi and finis	tectural improv hes; attach ad	vements propos ditional sheets i	ed with this f necessary	project (include v):
		or (to replace (canal side)		there is curren	tly a window)		


	B.	changes in landscaping	յ, significant p ape materials	ents proposed with this project lant material alterations, and ot such as driveways and retainin	her improvements
	N/A				
15.	If the impro	structure is a Commerc ovements proposed at th	cial Property o ne project site	pen to the Public, please descri (attach additional sheets if nece	be all interior essary).
	N/A				
16.	Addit	tional materials submitte	d with this app	olication (if available):	
] Parcel map	\boxtimes	Architectural elevations	
	\boxtimes	Photographs	\boxtimes	Architectural plans	
		Other materials			
App	olicant	Certification:			
		ify to the best of my kno plete and accurate.	wledge that th	e information supplied on this a	ipplication is
		Sign	ature of applicant		Date
Ow	ner Co	nsent:			
			he owner, doe	es the owner concur with this ap	pplication?
	Ye				
	IT '	Yes, owner's signature:			



RN Residential Neighborhood Zoning

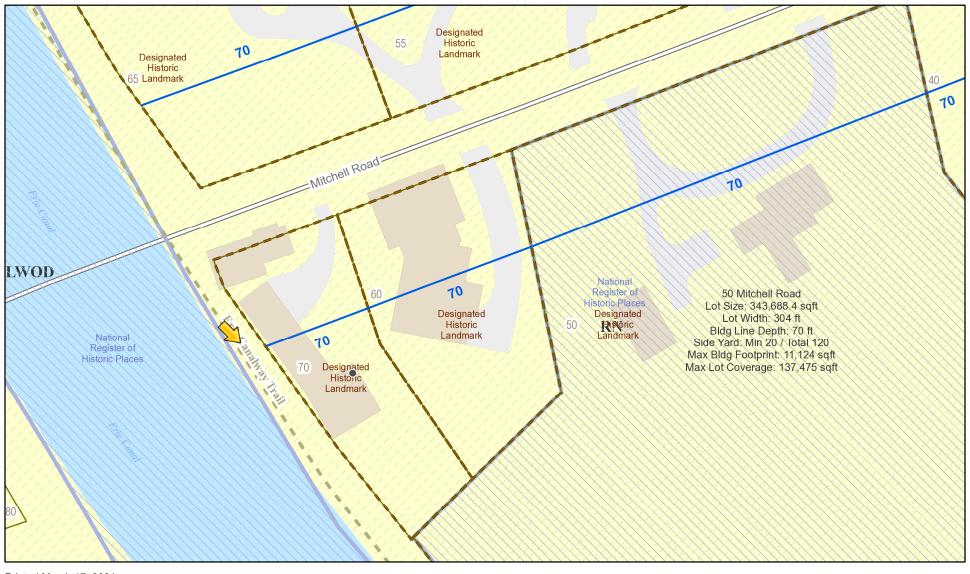

Printed March 17, 2021

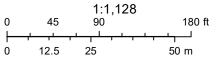

Town of Pittsford GIS



70 Mitchell Road

APPLICATION FOR CERTIFICATE OF APPROPRIATENESS



This is the exterior wall that will remain: it will be built up to the rafters and the window on the left will be replaced with a door.

The same exterior wall...

...the view is approximately a third of the way toward the road.


This is the view of that wall nearly to the road.



This is the canal side from the Mitchell Road bridge.
The exterior wall of the renovation is from the behind the 3 trees to left of the small window (the 'x' is approximately the center of the).

The exterior wall will be repaired, not replaced.

This is the same view of the canal side exterior wall with a person on the tow path. There is a considerable elevation from the path to the exterior wall.

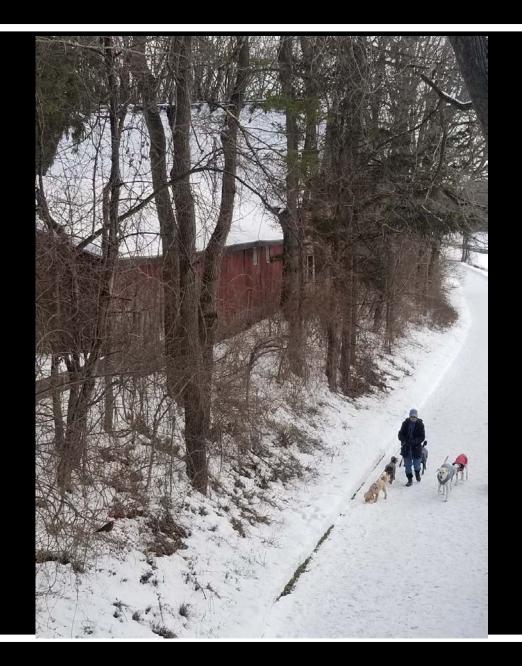



This is the view on the tow path approaching the bridge.

This the view in summer from the path looking directly up at the exterior wall.



Materials:


Door and windows: <u>Therma-Tru Benchmark Doors</u> 36-in x 80-in Fiberglass Half Lite Ready to paint Unfinished Prehung Single Front Door with Brickmould






JELD-WEN V-2500 35.5-in x 71.5-in x 2.905-in Jamb Vinyl New Construction Egress Black Double Hung Window ENERGY STAR Northern Zone ENERGY STAR North/Central Zone ENERGY STAR South/Central Zone ENERGY STAR Southern Zone

Item #2485860Model #LOWOLJW240200014

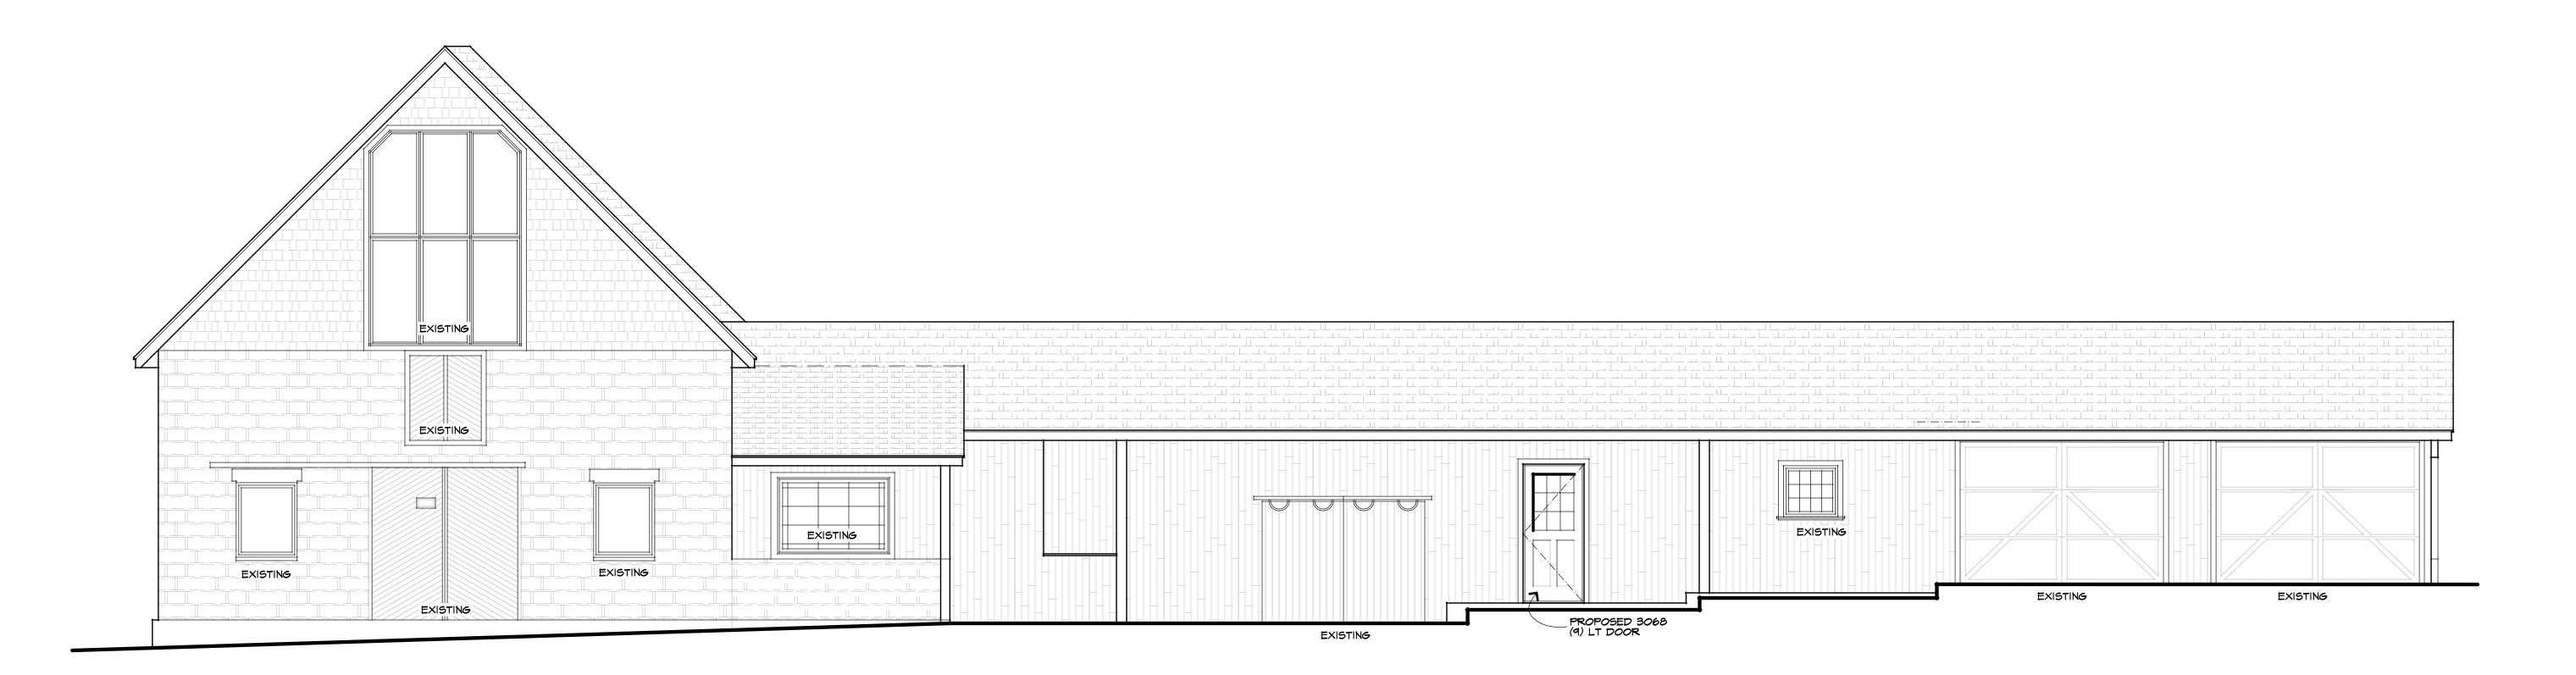

EAST ELEVATION

SCALE: 1/4" = 1'-0"

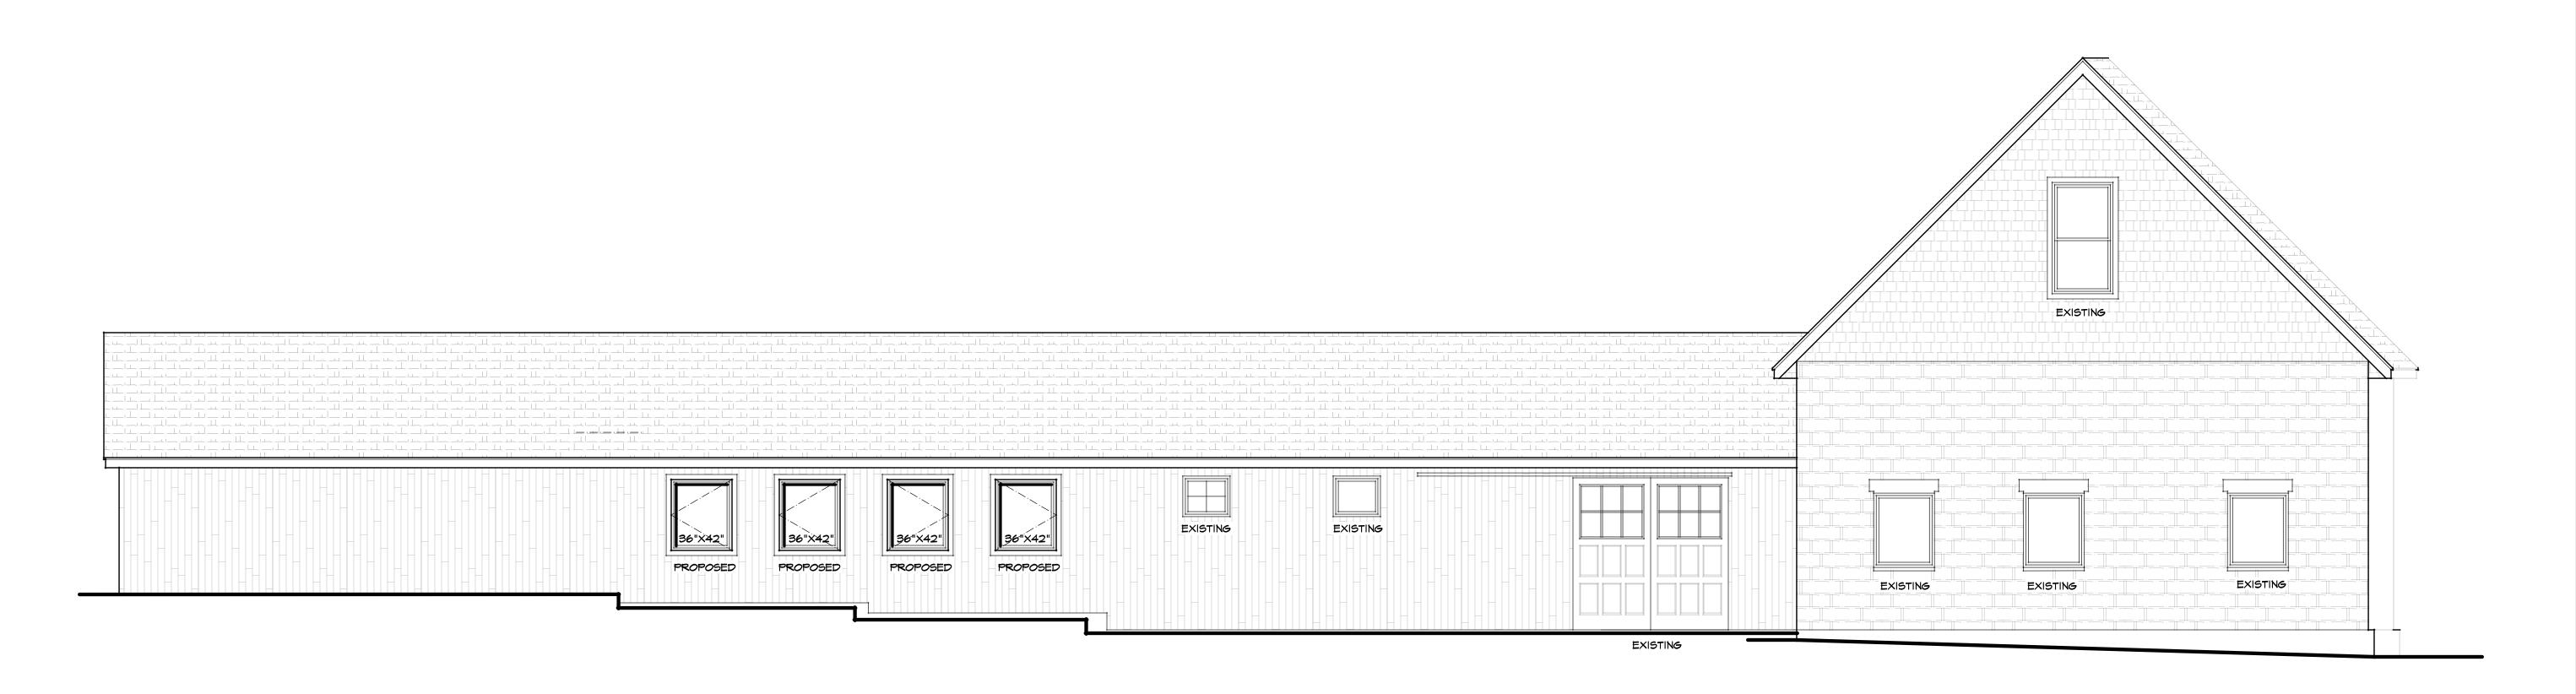

MEST ELEVATION

SCALE: 1/4" = 1'-0"



1387 FAIRPORT ROAD SUITE #560 FAIRPORT, NY 14450–2002 PH. (585) 223–6420

Use of this plan indicates understanding and agreement with the following:

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Carini Engineering Designs, P.C. has not been retained for construction observation or administration and assumes no responsibility for field changes, contractor methods, material selections, product performance or warranty, code or document compliance or safety during construction.

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The seal affixed to these documents is for the work performed by Carini Engineering Designs, P.C. on the original documents and does not relate to any added data by others. Our liability is limited to the amount of the fee paid.

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These plans comply with the 2020 code.

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Revision

Project:

INTERIOR REMODEL

SCOTT & KATHLEEN HOLCOMBE

70 MITCHELL ROAD PITTSFORD, NEW YORK

Drawing Title:

ELEVATIONS

Orawn Checked B

NOVEMBER, 2020

BUILDING SECTION "A"

SCALE: 1/4" = 1'-0"



STEVEN L. CARINI, P.E.

1387 FAIRPORT ROAD SUITE #560 FAIRPORT, NY 14450-2002 PH. (585) 223-6420

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Education Law for any person, unless acting under the direction of a licensed Engineer to alter any item in these documents in any way. Any licensee who alters these documents is required by law to affix his/her seal and signature and date with notification "altered by" followed by a specific description of changes made.

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These plans comply with the 2020 code.

Revisions:

Project:

INTERIOR REMODEL

SCOTT & KATHLEEN HOLCOMBE

Job Location:

70 MITCHELL ROAD
PITTSFORD, NEW YORK


Drawing Title:

FIRST FLOOR PLAN

Checked By

Oate NOVEMBER, 2020

* No. 38376

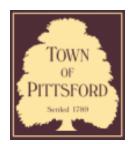

Town of Pittsford

Department of Public Works 11 South Main Street Pittsford, New York 14534

Permit # C21-000009

Phone: 585-248-6250 FAX: 585-248-6262

DESIGN REVIEW AND HISTORIC PRESERVATION BOARD REFERRAL OF APPLICATION

Property Address: 3280 Monroe Avenue ROCHESTER, NY 14618

Tax ID Number: 150.12-1-12
Zoning District: C Commercial
Owner: Mc Donald's Corp
Applicant: Mc Donald's Corp

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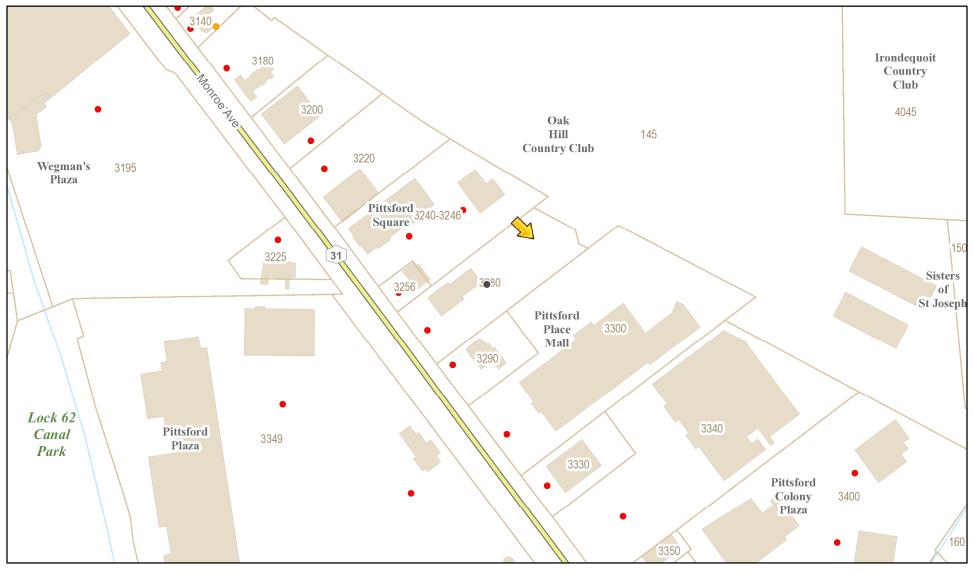
П	Residential Design Review		Build to Line Adjustment
ш	§185-205 (B)	ш	§185-17 (B) (2)
	Commercial Design Review		Building Height Above 30 Feet
ш	§185-205 (B)		§185-17 (M)
	Signage		Corner Lot Orientation
Ш	§185-205 (C)	Ш	§185-17 (K) (3)
	Certificate of Appropriateness		Flag Lot Building Line Location
ш	§185-197		§185-17 (L) (1) (c)
	Landmark Designation		Undeveloped Flag Lot Requirements
Ш	§185-195 (2)		§185-17 (L) (2)
✓	Informal Review		

Project Description: The applicant is requesting informal Design Review for the exterior alteration and renovation to the existing McDonald's Restaurant. The project consists of alterations to the front, sides, rear and roof of the building. Please review the attached section of the Monroe Avenue Design Guidelines providing guidance on flat roofs.


Meeting Date: March 25, 2021



Property Pictures



3/18/2021, 4:38:18 PM

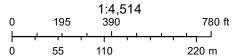

Town of Pittsford GIS

The information depicted on this map is representational and should be used for general reference purposes only. No warranties, expressed or implied, are provided for the data or its use or interpretation.



Acdonald's

3280 MONROE A VENUE TOWN OF PITTSFORD, MONROE COUNTY NEW YORK

DESIGN CONSULTANTS

CIVIL

T.Y. LIN INTERNATIONAL ENGINEERING & ARCHITECTURE 255 EAST AVENUE ROCHESTER, NEW YORK 14604 ATTN: Randy Bebout, Project Manager (585) 512-2000

LICENSED SURVEYOR


C.T. MALE ASSOCIATES
ENGINEERING, SURVEYING, ARCHITECTURE
& LANDSCAPE ARCHITECTURE, D.P.C.
200 GATEWAY PARK DRIVE
BLDG. C, P.O. BOX 3246
SYRACUSE, NEW YORK 13220-3246
ATTN: David M. Sliski, P.L.S.
(315) 458-6498

APPROVAL AGENCIES

TOWN OF PITTSFORD PLANNING BOARD
11 S. MAIN STREET
PITTSFORD, NEW YORK 14534
ATTN: Doug DeRue, Director of Planning, Zoning, & Development
(585) 428-6250

TOWN OF PITTSFORD DESIGN REVIEW AND HISTORIC PRESERVATION BOARD 11 S. MAIN STREET PITTSFORD, NEW YORK 14534 ATTN: Dirk Schneider, Chairman (585) 428-6250

NYS DEPARTMENT OF TRANSPORTATION - REGION 4 1530 JEFFERSON ROAD ROCHESTER, NEW YORK 14623 ATTN: Jeff Frank (585) 272-3473

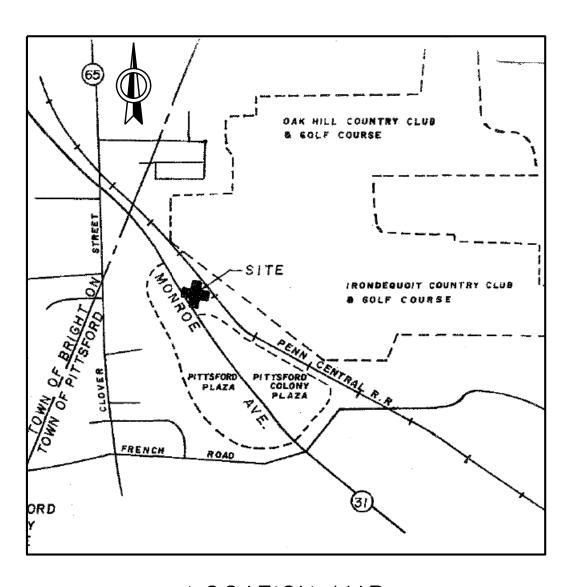


LOCATION MAP

NOT TO SCALE

F	RE	VIS	SIC	NS	\sim	DWG. NO.	DESCRIPTION	SHE	FT	NO
6	5	4	3	2	1	DWO. 140.	DESCINI TION			110.
						T-1	TITLE SHEET	1	of	16
						TM-1	TOPOGRAPHIC SURVEY MAP	2	of	16
						C-0	DEMOLITION PLAN	3	of	16
						C-1	SITE PLAN	4	of	16
						C-1A	DRIVE-THRU LAYOUT PLAN (NOT INCLUDED)	5	of	16
						C-1B	ACCESSIBLE SIDEWALK PLAN - 1 (NOT INCLUDED)	6	of	16
						C-1C	ACCESSIBLE SIDEWALK PLAN - 2 (NOT INCLUDED)	7	of	16
						C-1D	ACCESSIBLE SIDEWALK DETAILS (NOT INCLUDED)	8	of	16
						C-2	GRADING PLAN	9	of	16
						C-3	UTILITY PLAN	10	of	16
						C-4	LANDSCAPE PLAN	11	of	16
						CD-1	CONSTRUCTION DETAILS - 1	12	of	16
						CD-2	CONSTRUCTION DETAILS - 2	13	of	16
						CD-3	CONSTRUCTION DETAILS - 3	14	of	16
						CD-4	CONSTRUCTION DETAILS - 4	15	of	16
						CD-5	DUMPSTER ENCLOSURE DETAILS	16	of	16

OWNER

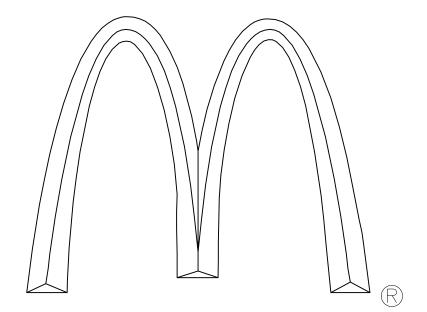

McDONALD'S USA, LLC STAMFORD FIELD OFFICE 645 EAST MAIN STREET, 2ND FLOOR STAMFORD, CT 06901 (518) 610–5917



3280 MONROE AVENUE TOWN OF PITTSFORD, MONROE COUNTY NEW YORK

T-Y-LININTERNATIONAL

255 EAST AVENUE ROCHESTER, NY 14604 (585) 512–2000 43.7218.00 RLB

DATE: DRWN. BY:

03/03/21 XDM

SCALE: CHKD. BY:

NO SCALE RLB


DRAWING NO:

T-1

SHEET NO.

1 OF 16

STATE SITE CODE: 037-0759 /NSN: #06168

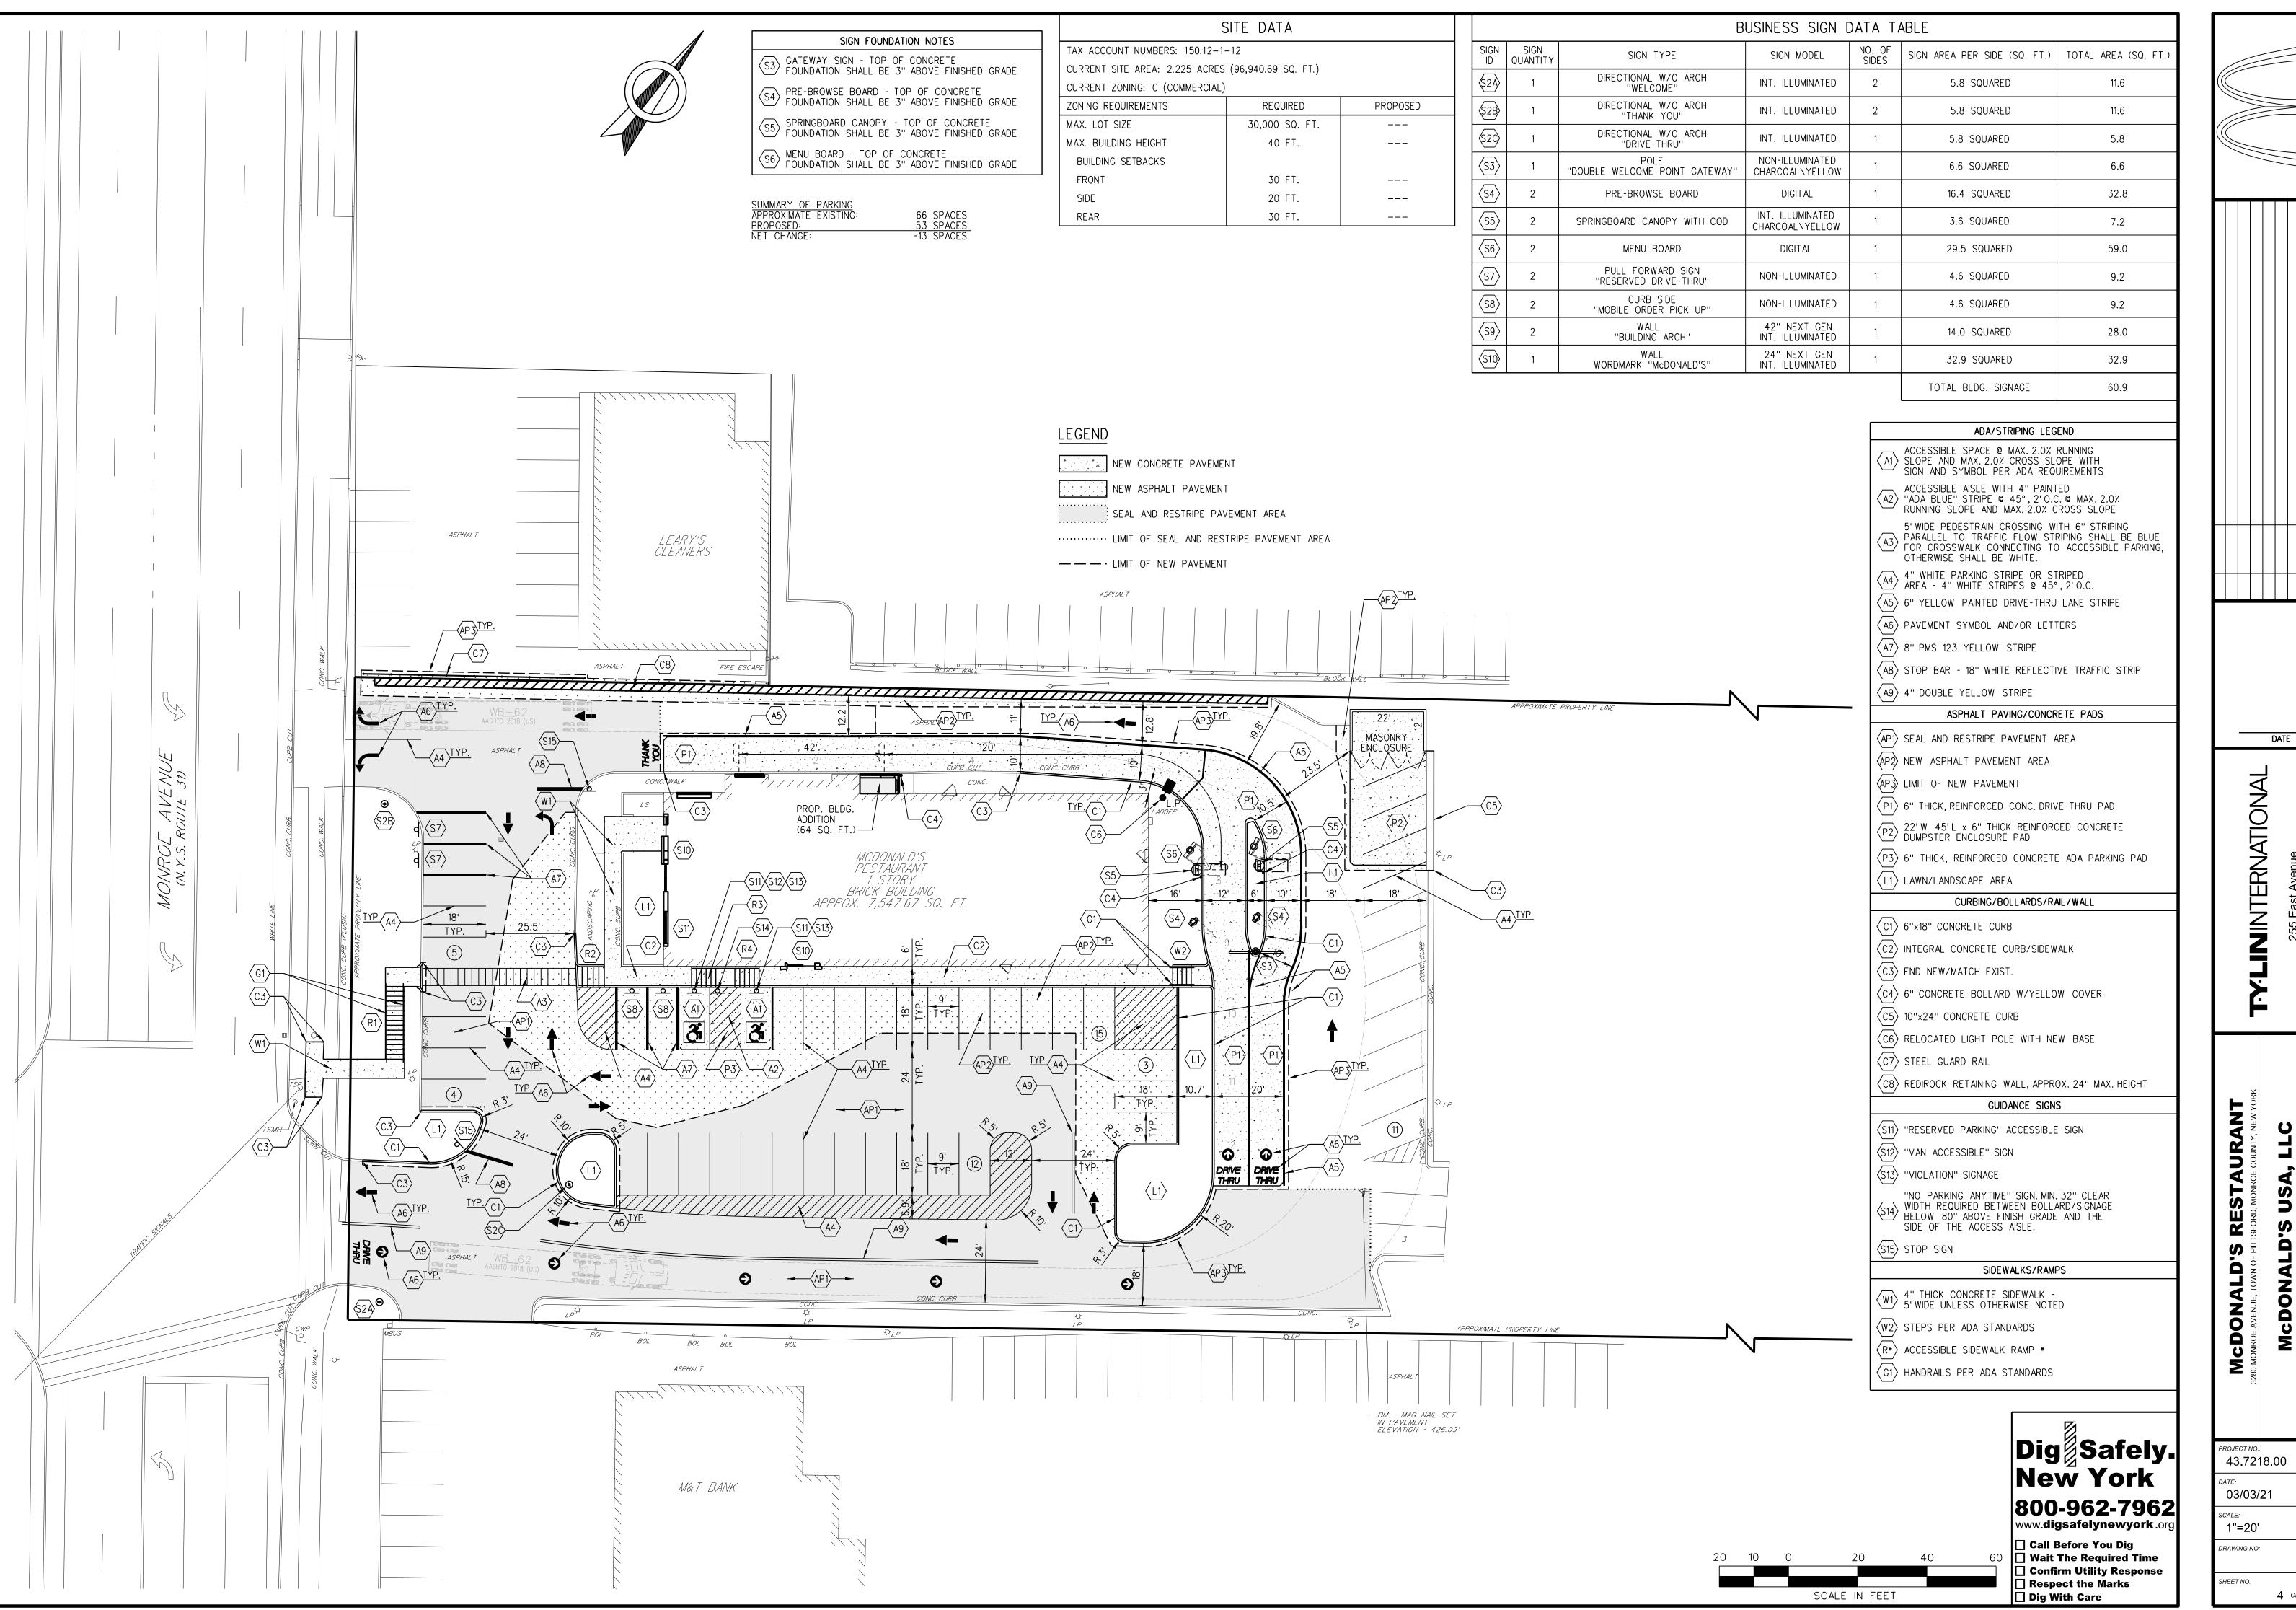



DATE INTERN. CDONALD RLB

XDM

CHKD. BY:

RLB

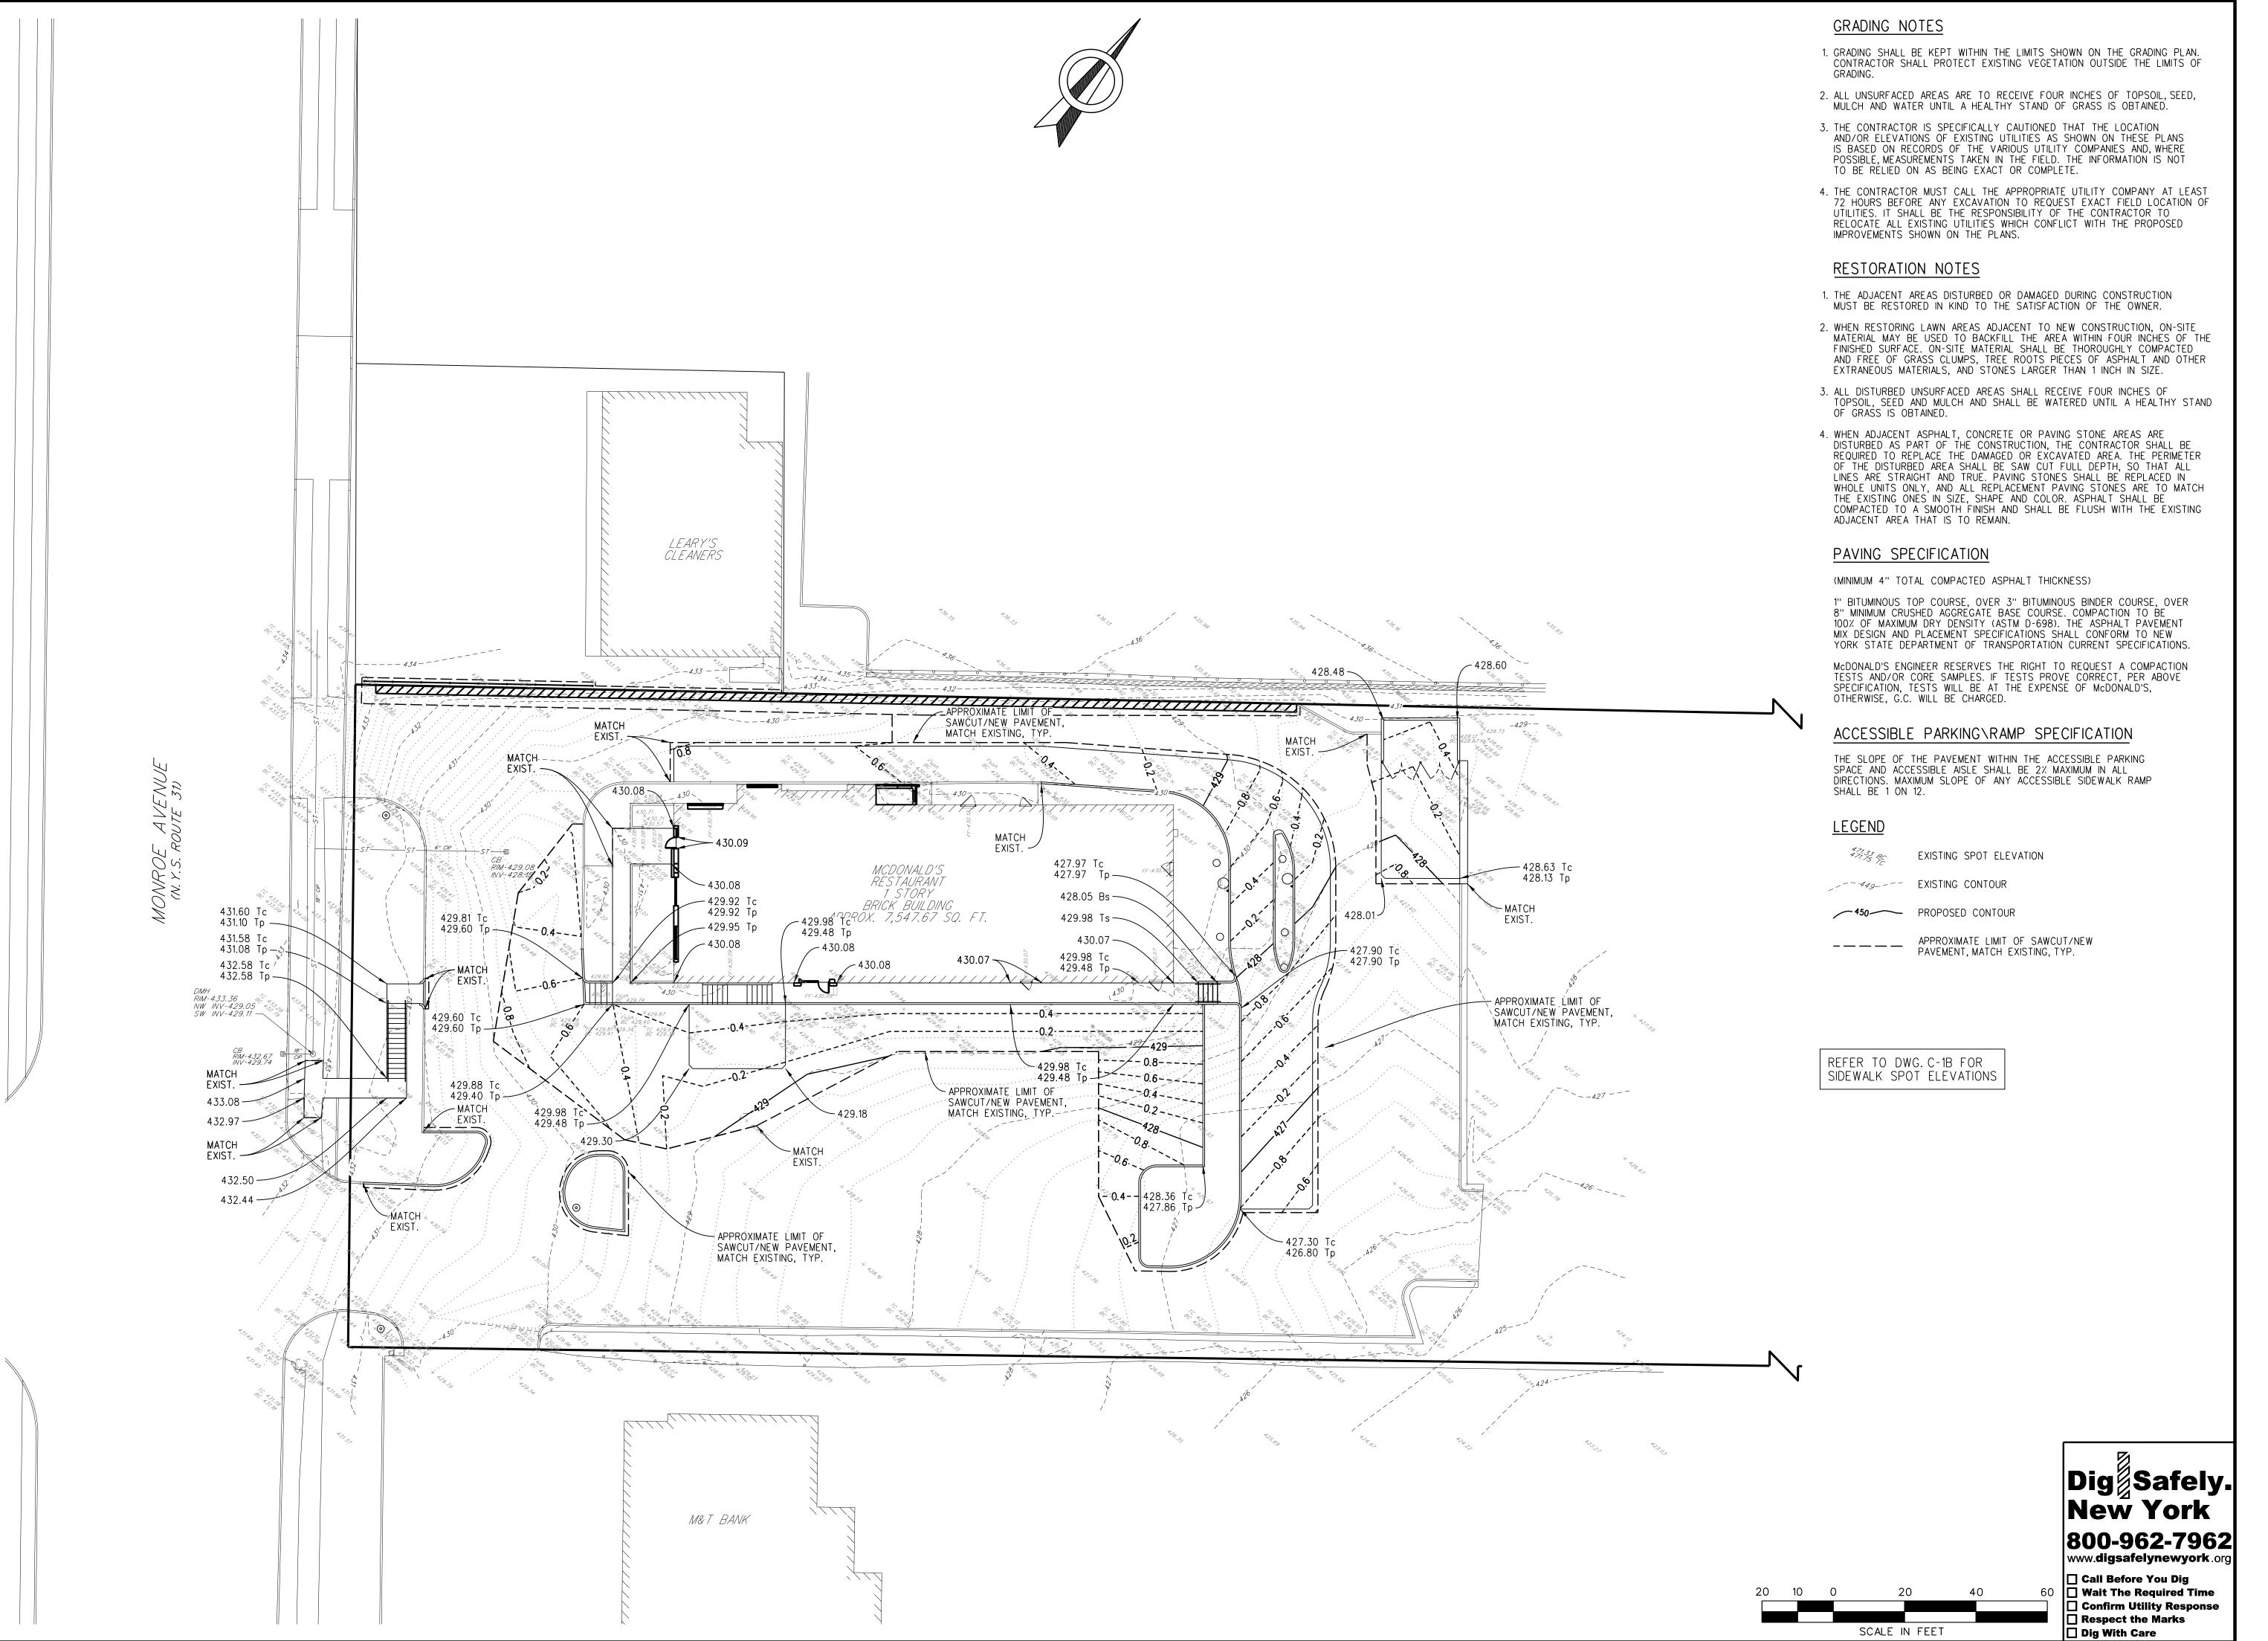

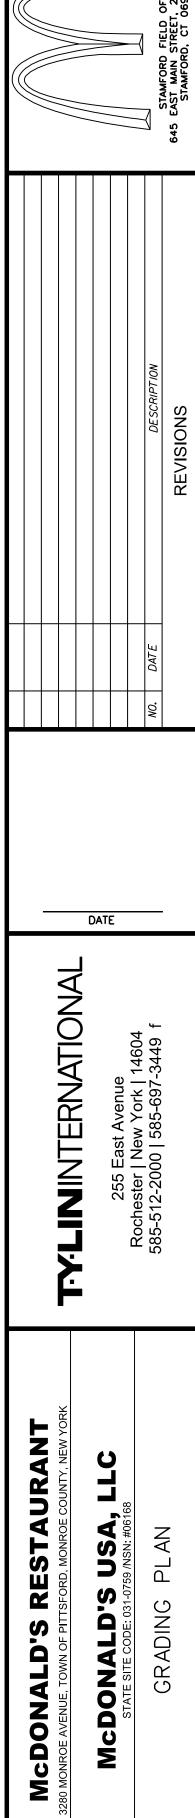

PROJECT NO.: 43.7218.00

03/03/21

1"=20'


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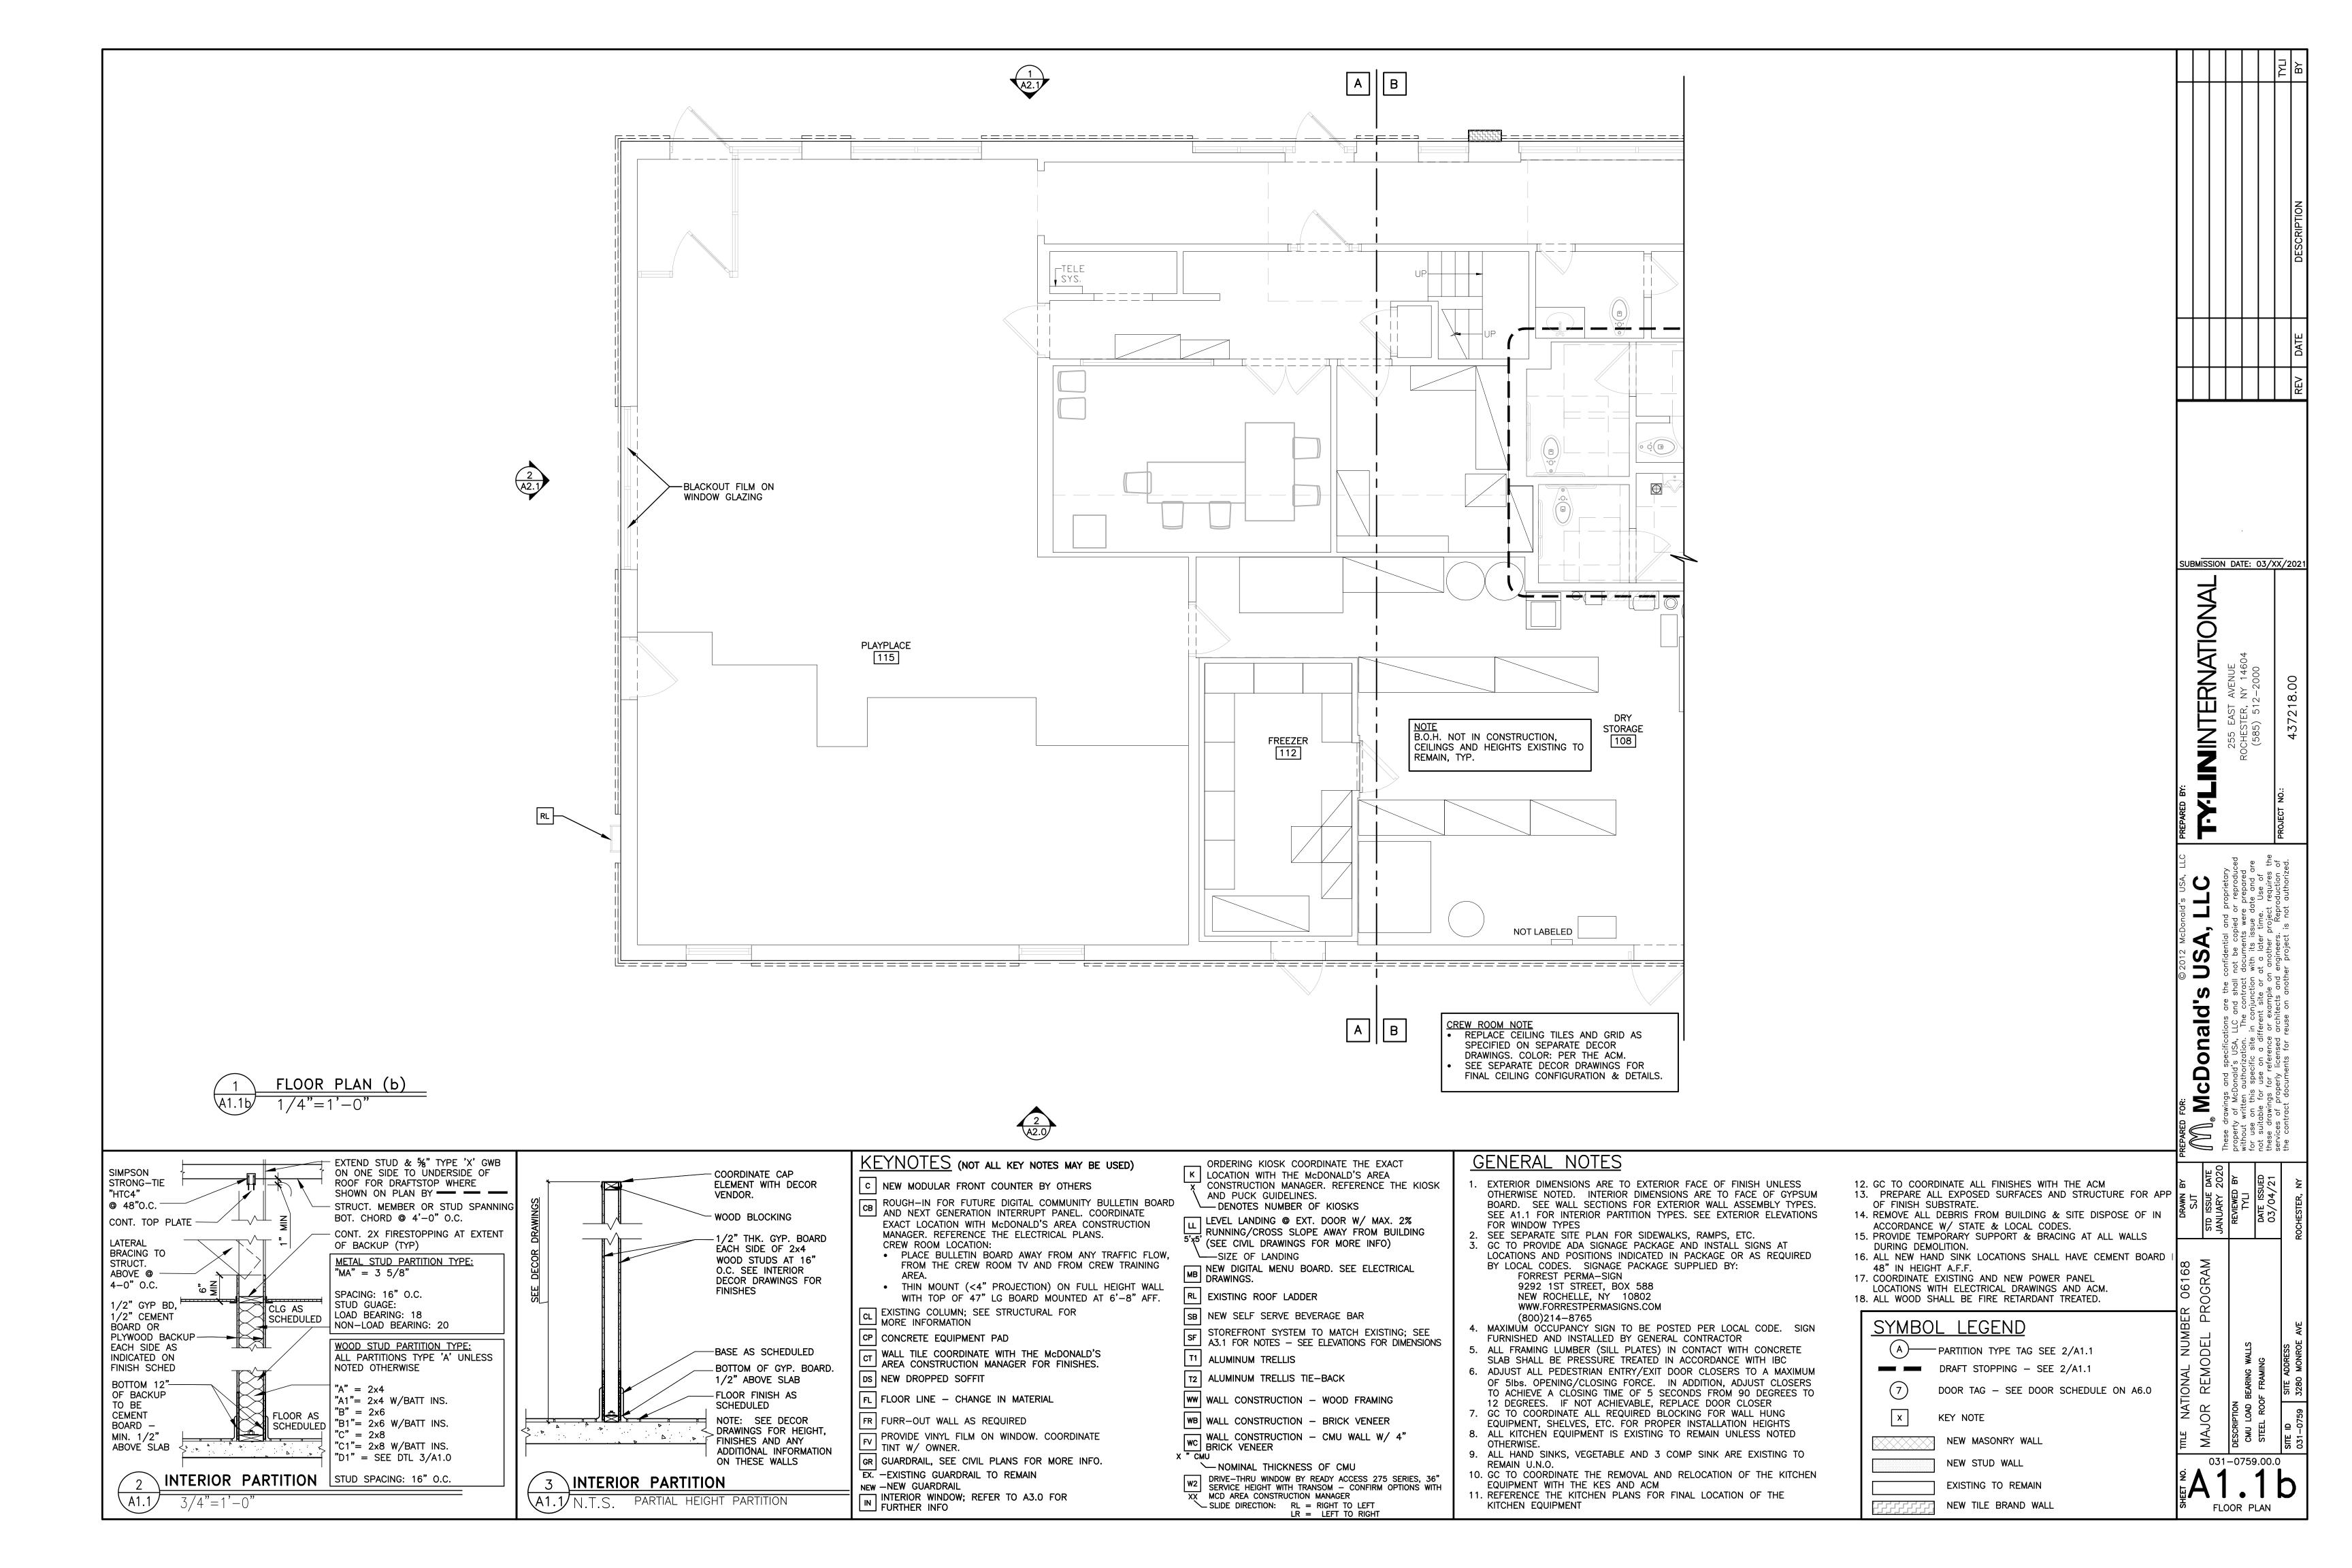
RLB


XDM


CHKD. BY:

RLB




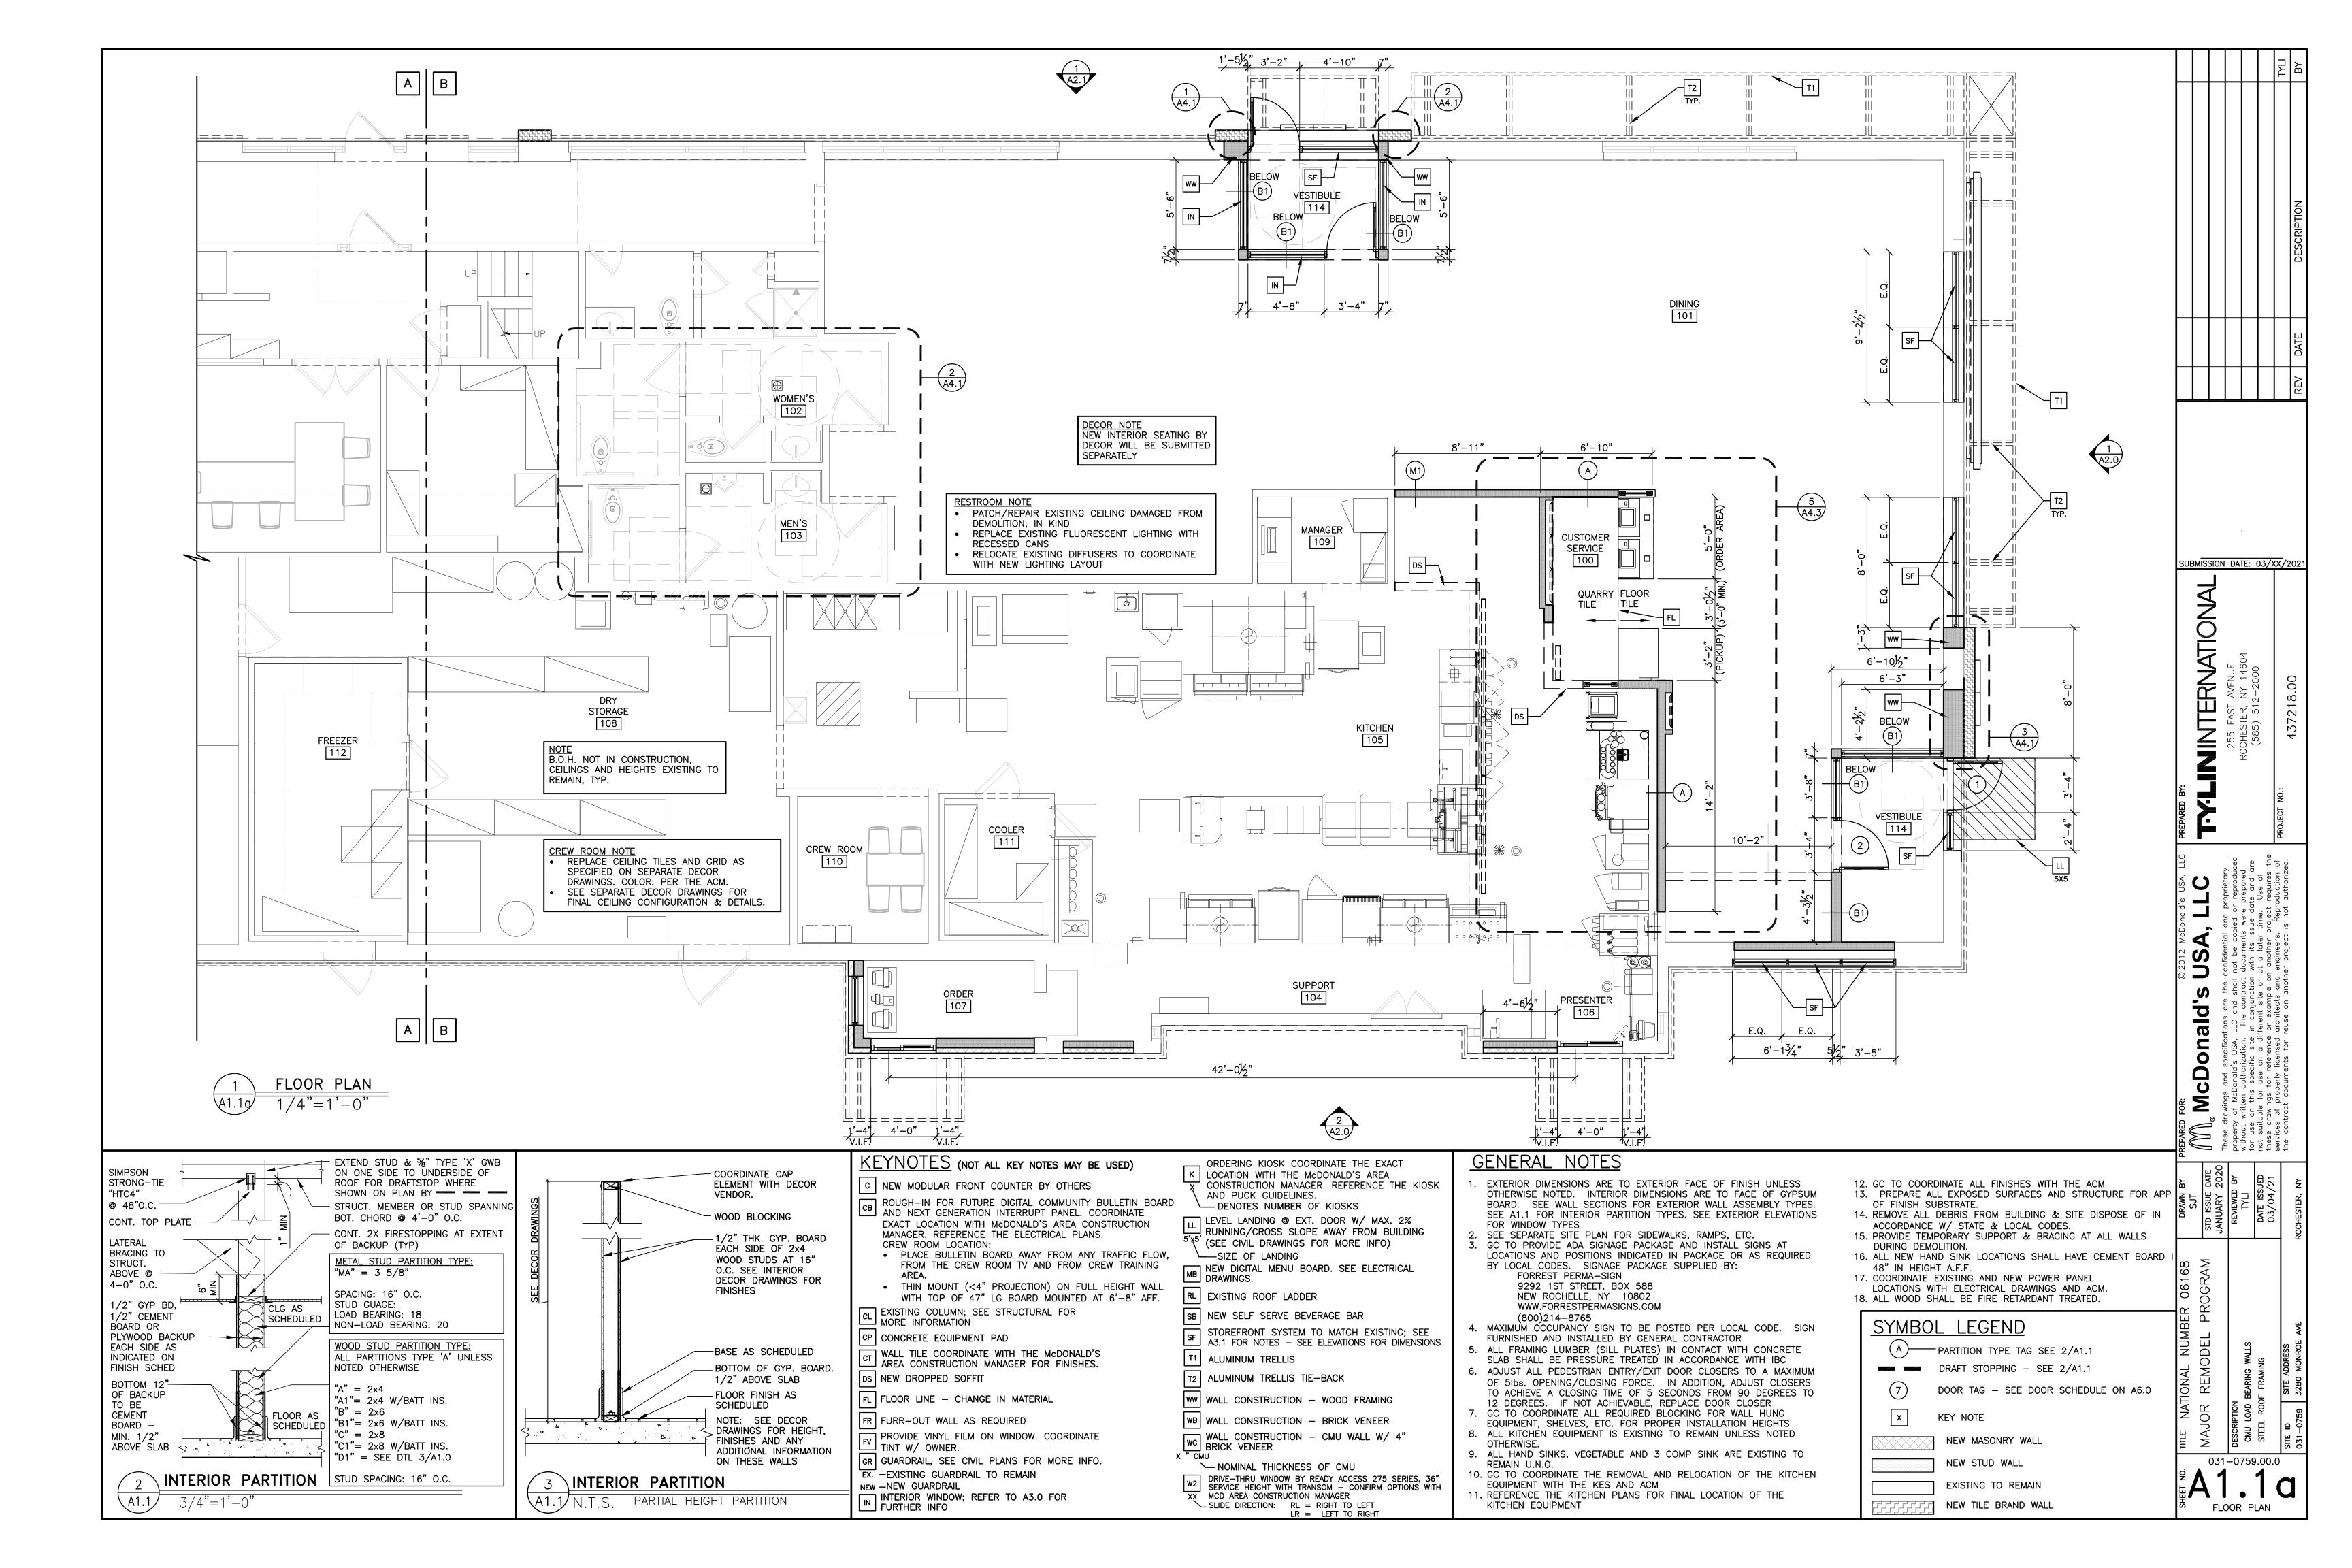

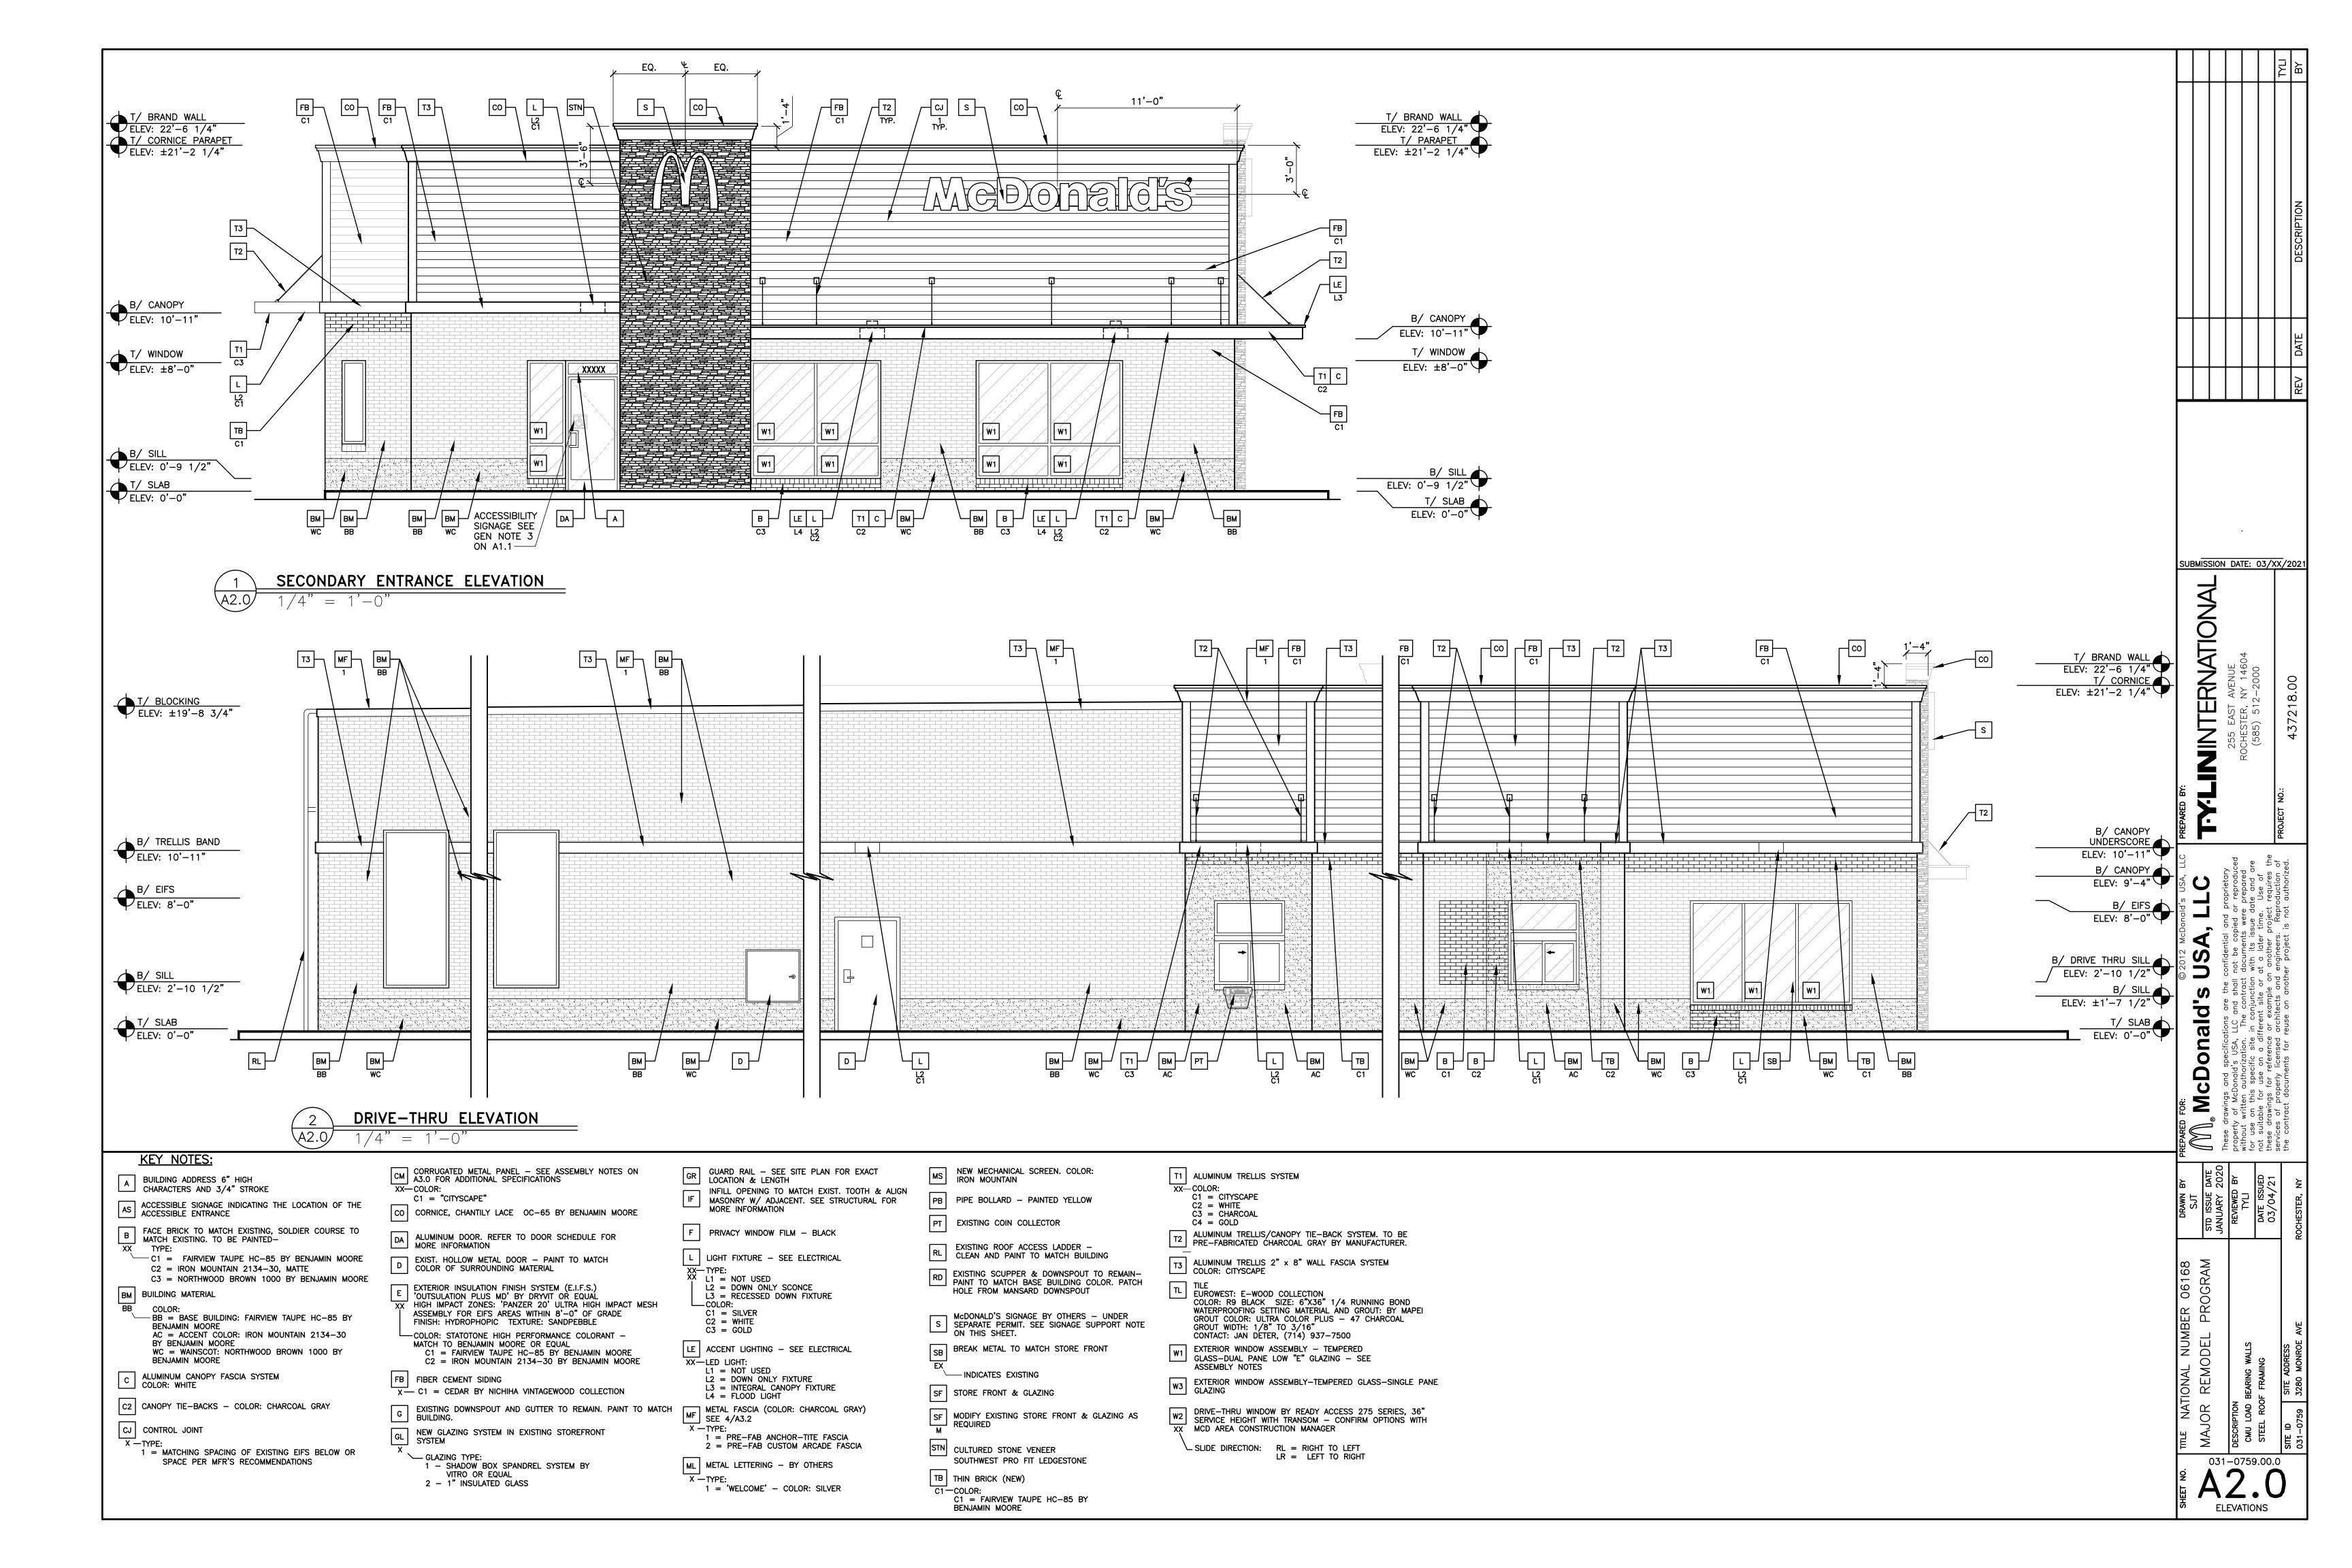

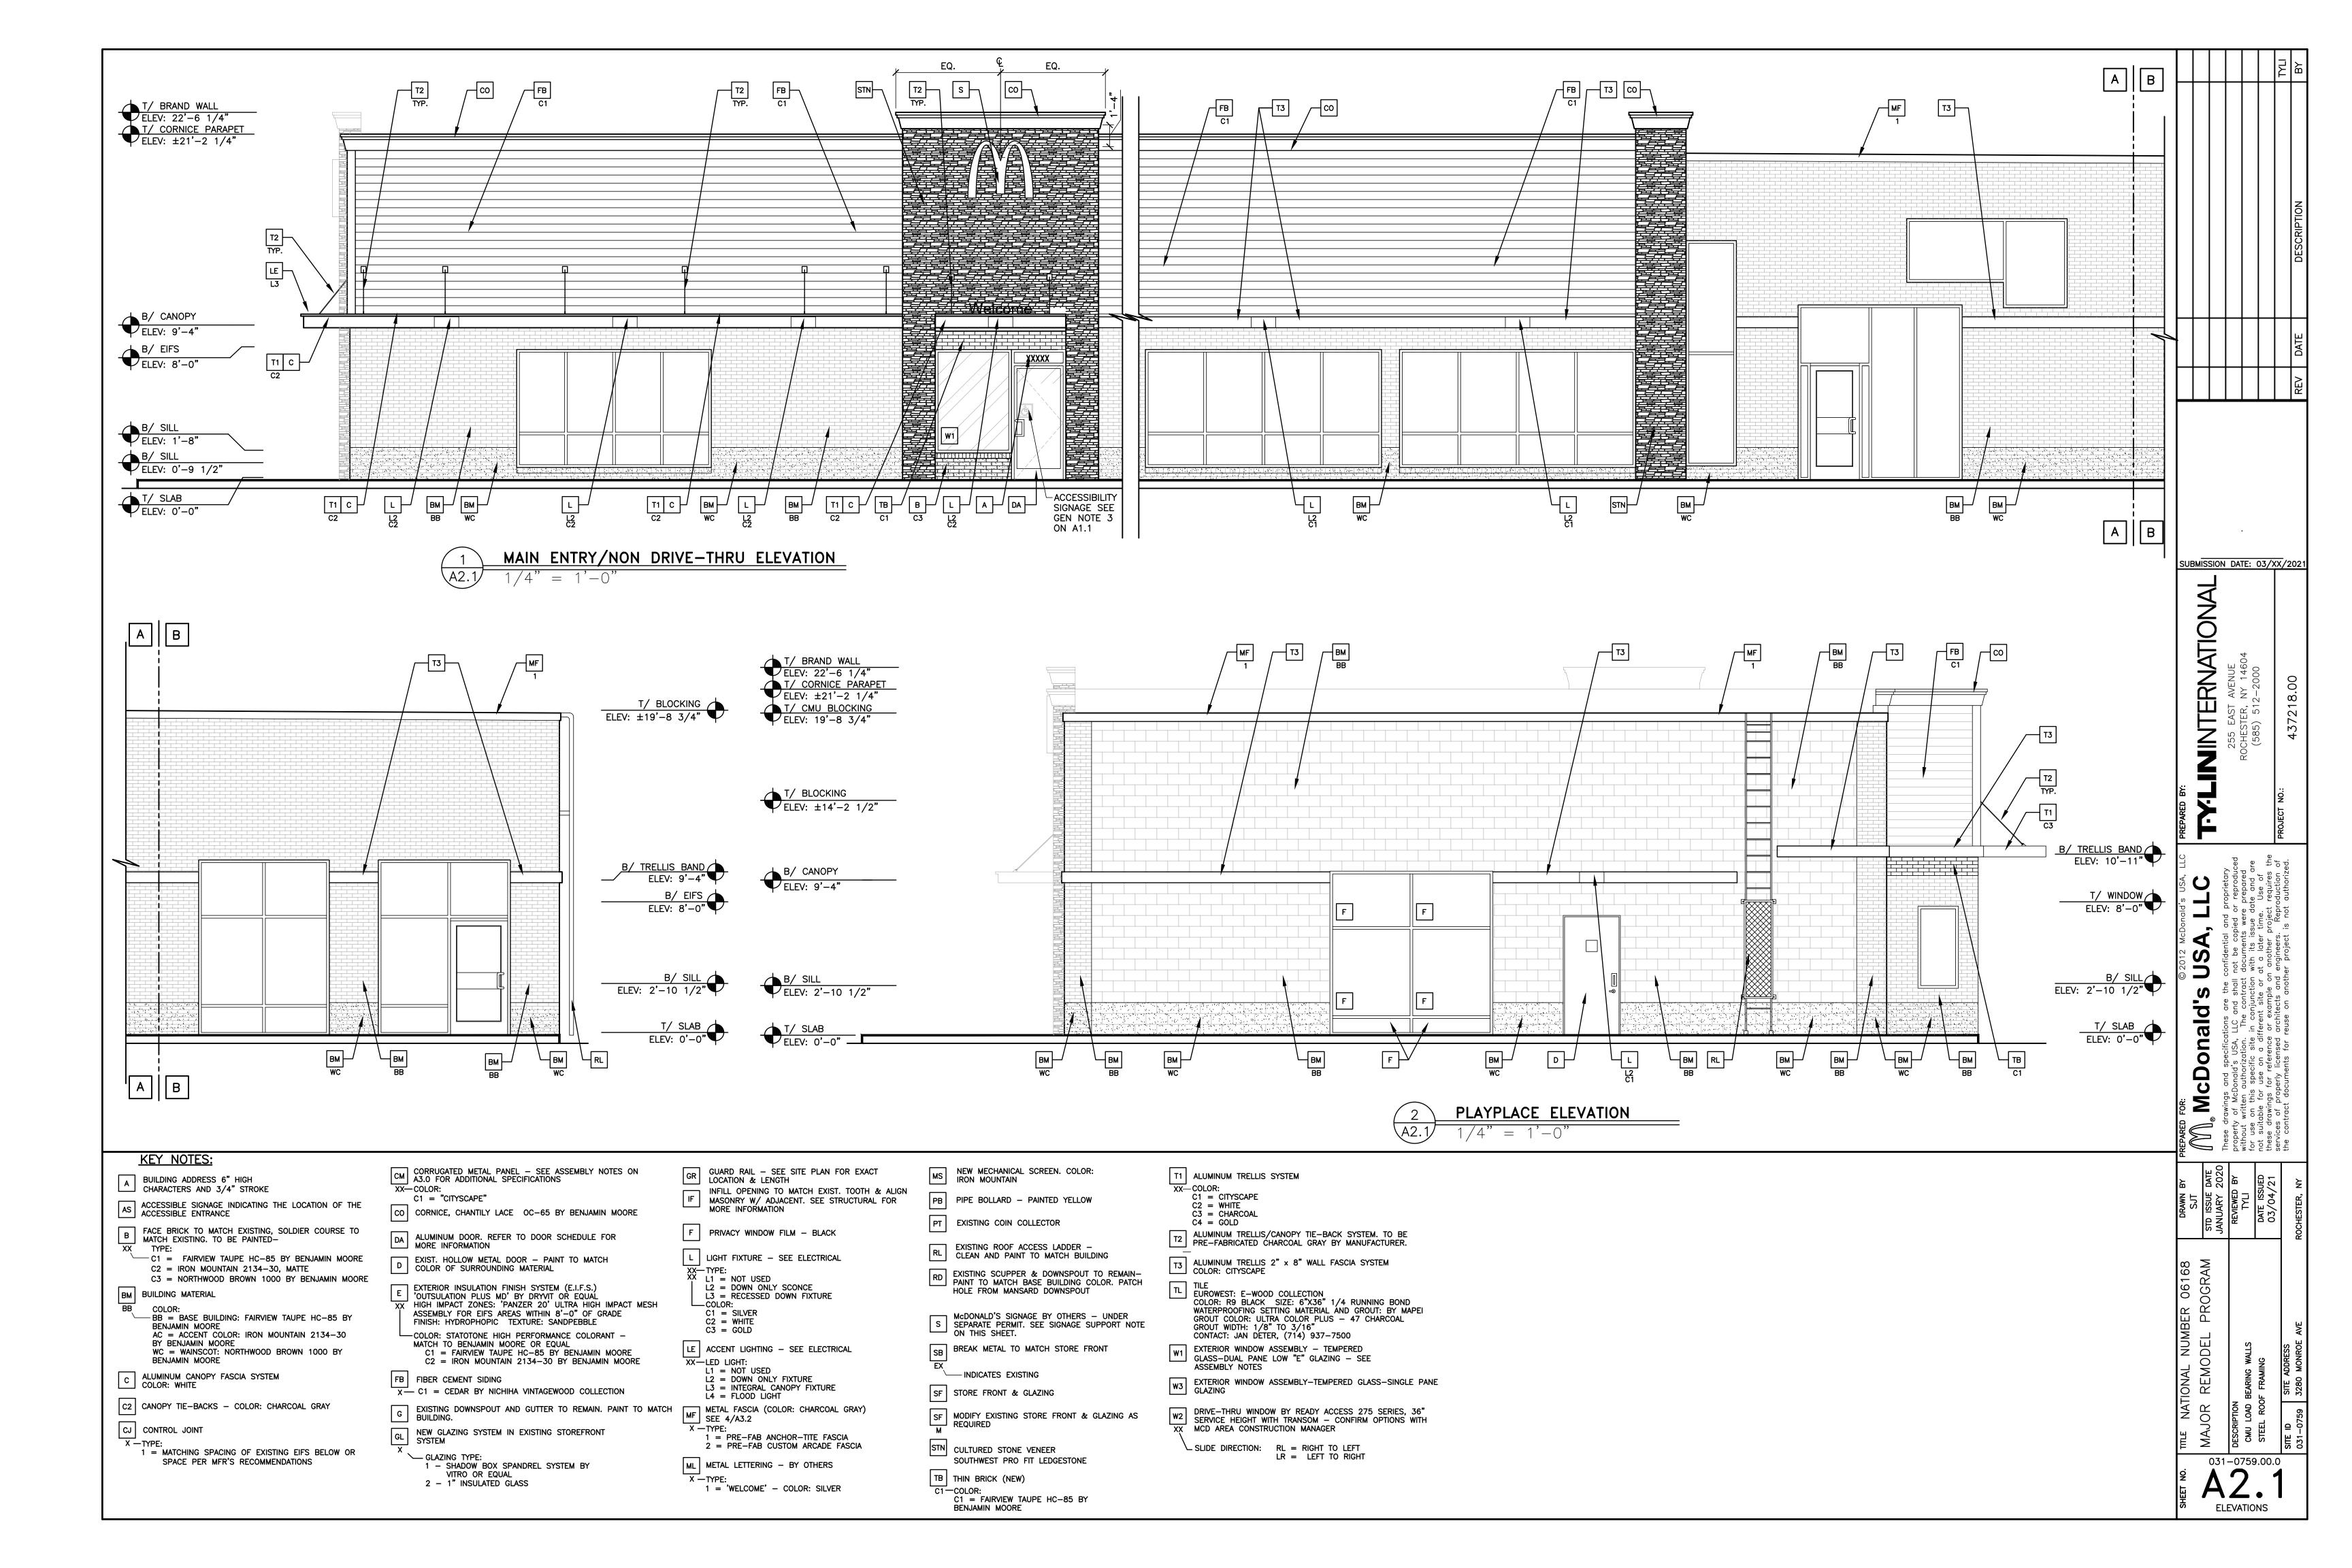



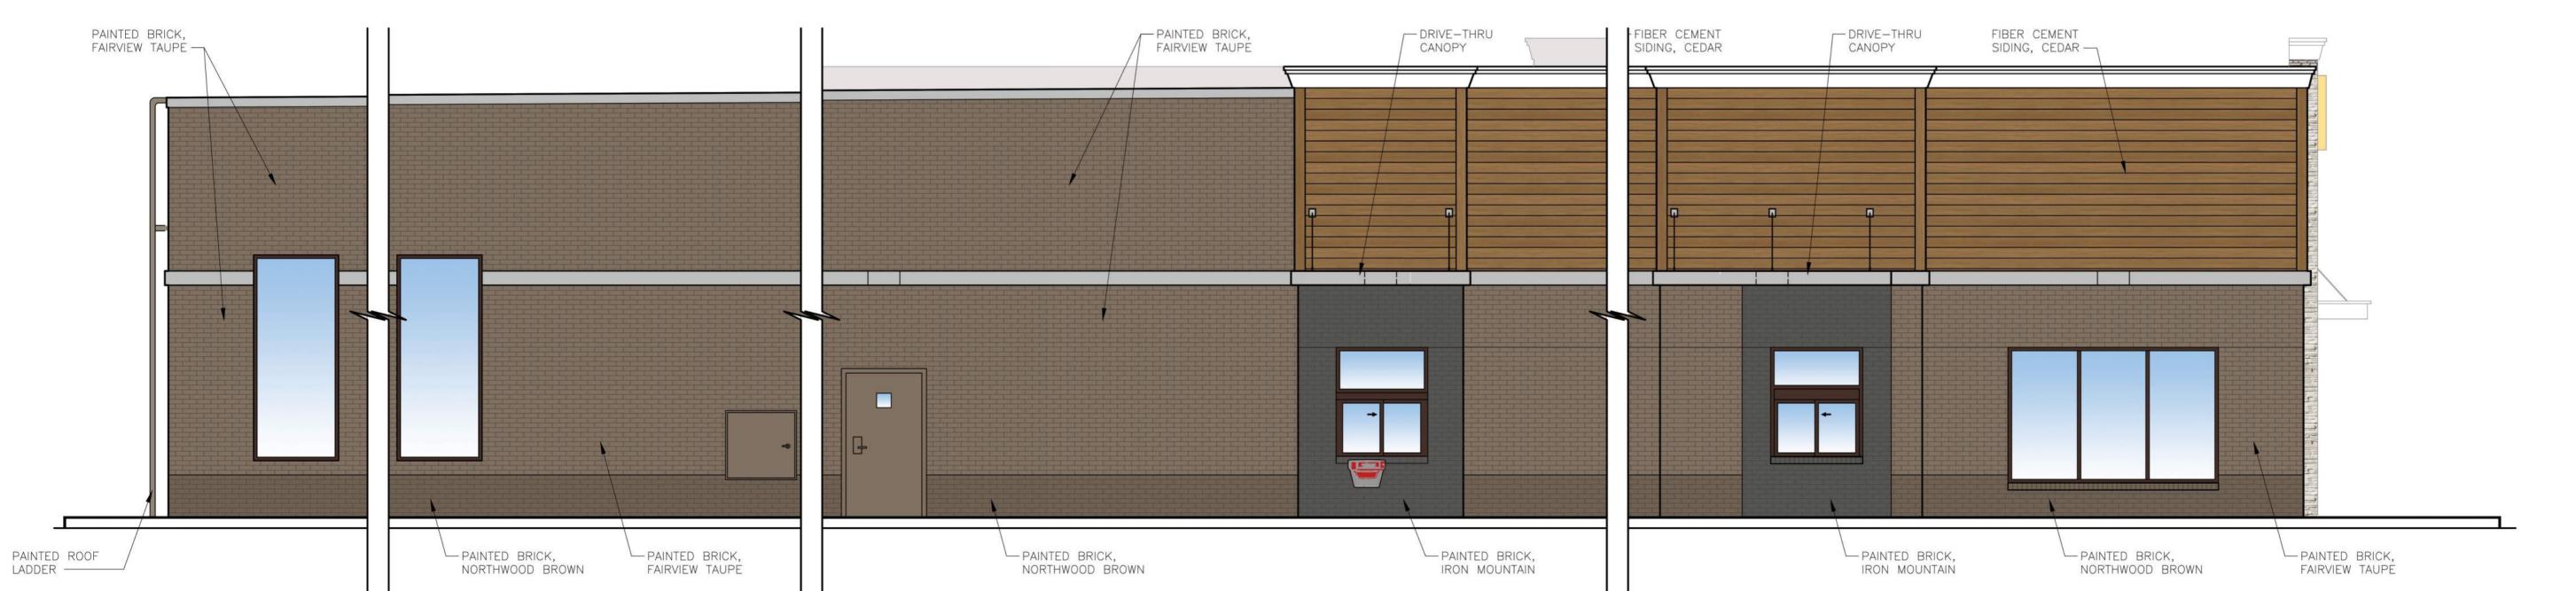

SHEET NO.	TITLE NATIO	NATIONAL NUMBER 06168	DRAWN BY	PREPARED FOR: © 2012 McDonald's USA, LLC PREPARED BY:		SUE			
F	Μ	JOR REMODEL PROGRAM	STD ISSUE DATE	McDonald's USA. LLC	IVINCITAINMENT	RMISS			
4			JANUARY 2020	These drawings and specifications are the confidential and proprietary	֝֝֝֟֝֝֝֟֝֝֡֟֝	SION			
2	DESCRIPTION		REVIEWED BY	property of McDonald's USA, LLC and shall not be copied or reproduced		DA			
759 • •	CMU	LOAD BEARING WALLS	ΠΉ	without written authorization. The contract documents were prepared for use on this specific site in conjunction with its issue date and are	(585) 512_2000	rF:			
.00. NS	STEEL ROOF FRAMING	FRAMING	DATE ISSUED	not suitable for use on a different site or at a later time. Use of these drawings for reference or example on another project requires the	(202) 215 2000	XX/)			
Ď	SITE ID	SITE ADDRESS		services of properly licensed architects and engineers. Reproduction of the contract documents for reuse on another project is not authorized.		<u> </u>			
	-0759	3280 MONROE AVE	ROCHESTER, NY		43/218.00		REV	DATE	DESCRIPTION



031-0759.00.0 **A2.1** ELEVATIONS to the public realm of the street and to screen parking areas.

General Architectural Standards

- New construction shall feature elements such as open or enclosed porches, colonnades, patios or plazas and landscape amenities which are at a human scale.
- Old and new structures should appear as a comprehensive sequence in size and shape.
 This can be achieved through the use of architectural detailing to create variety and interest on new buildings.
- The design of new construction shall creatively reflect traditional elements of the local vernacular architecture, be compatible with (materials and pedestrian elements, building mass, scale, roof slopes, proportion and size of openings, architectural styles and details, and overall development density etc.), and positively contribute to the overall organization and architectural theme of the corridor and not detract from it.
- Buildings, building alterations and plantings shall form a definitive edge to the street instead of a dominance of pavement and parking lots.

Building Height

- Within the sub-area 2-story buildings are preferred. Where feasible, several smaller 2-story buildings shall be placed along, and relate to, the corridor's internal streets.
- 3-story buildings, where feasible, are also permitted. These buildings may be located at corner lots, at the intersection of Monroe Avenue and any internal street, and as a terminus to any intersection, as feasible.

Roof Lines

- Extensive use of very steep, or flat or very low pitched roofs shall be avoided.
- Where flat roofs are used they shall be capped by a structural expression of the facade, not a false roof front.
- Sloping roofs shall be broken up by the use of dormers and gables to give the facade more visual prominence.
- Longer buildings shall provide fluctuations in the roofline which are designed to break up the facade, and make entryways more prominent.